

FIRE PROTECTION PARTIAL GROUND FLOOR PLAN SCALE: 1/4"=1'-0"

REFER TO BASE BLDG PERMIT DRAWINGS FOR CONTINUATION OF ALL UTILITIES.





ALLAN T. SHULMAN ARCHITECT, P.A.

REVISIONS

10.29.09 CMB

12.10.09 CMB


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REVISIONS



SOHO BEACH HOUSE
4385 COLLINS AVENUE, MIAMI BEACH, FL, 33140


JOB NO. 05035

1ST & 7TH FLR KITCHENS

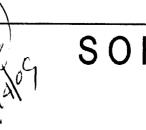CONSTRUCTION DOCUMENTS

F-1.0

09.15.2009

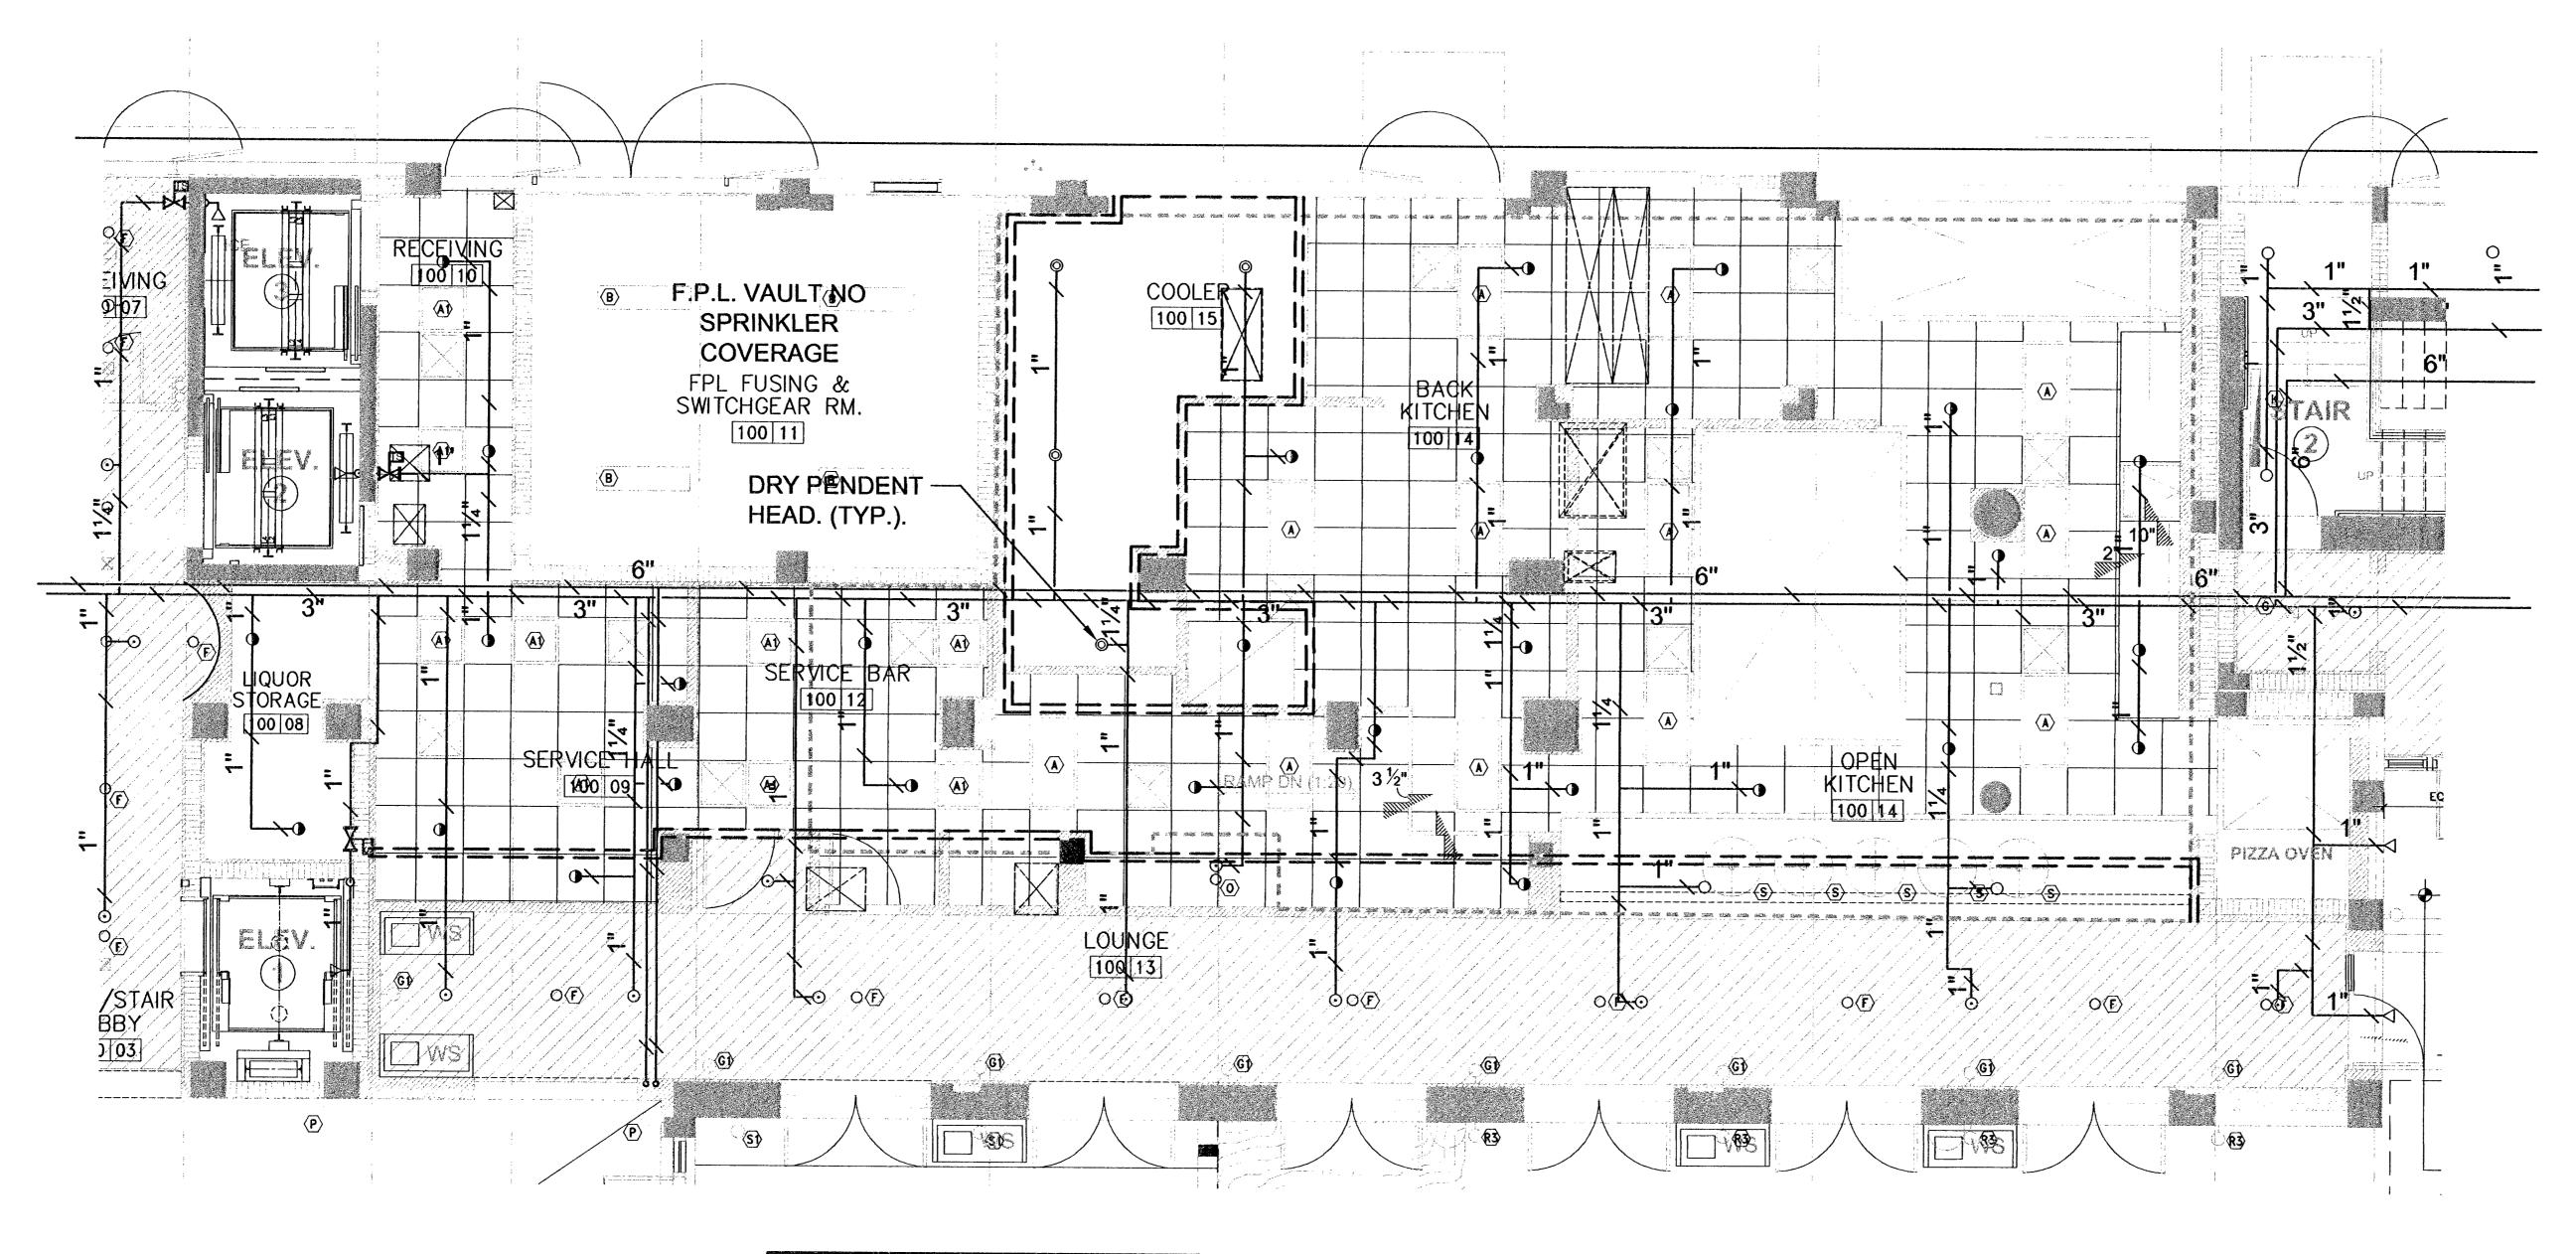


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FIRE PROTECTION GROUND FLOOR PLAN
SCALE: 1/4"=1'-0"






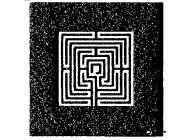

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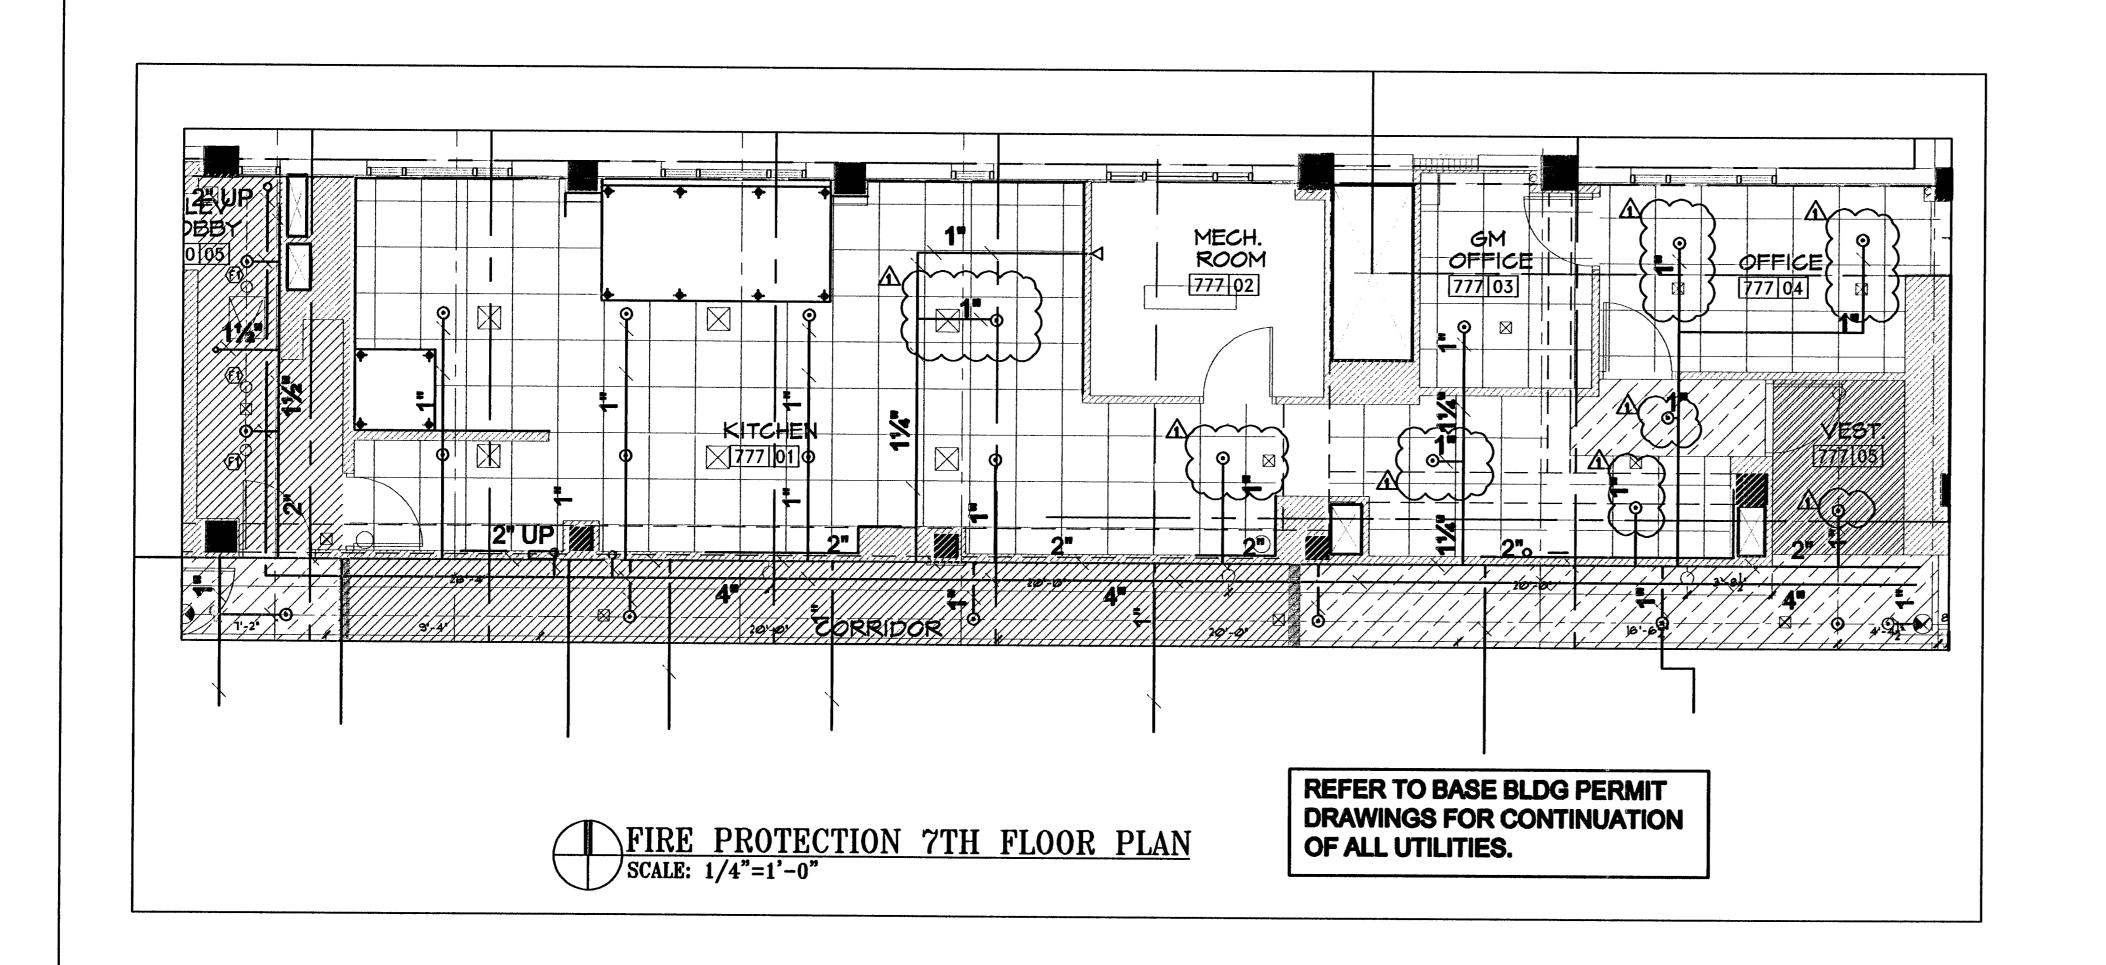
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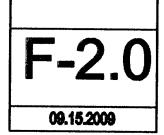



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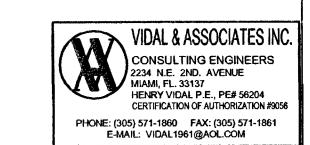
REVISIONS	REVISIONS
10.08.09 COMMENTS	

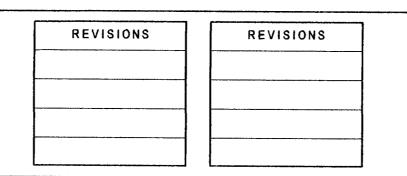SOHO BEACH HOUSE
4385 COLLING AVENUE, MIAMI BEACH, FL, 33140
JOB NO. 05035 1ST & 7TH FLOOR KITCHENS **CONSTRUCTION DOCUMENTS**





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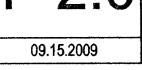
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REVISIONS	REVISIONS

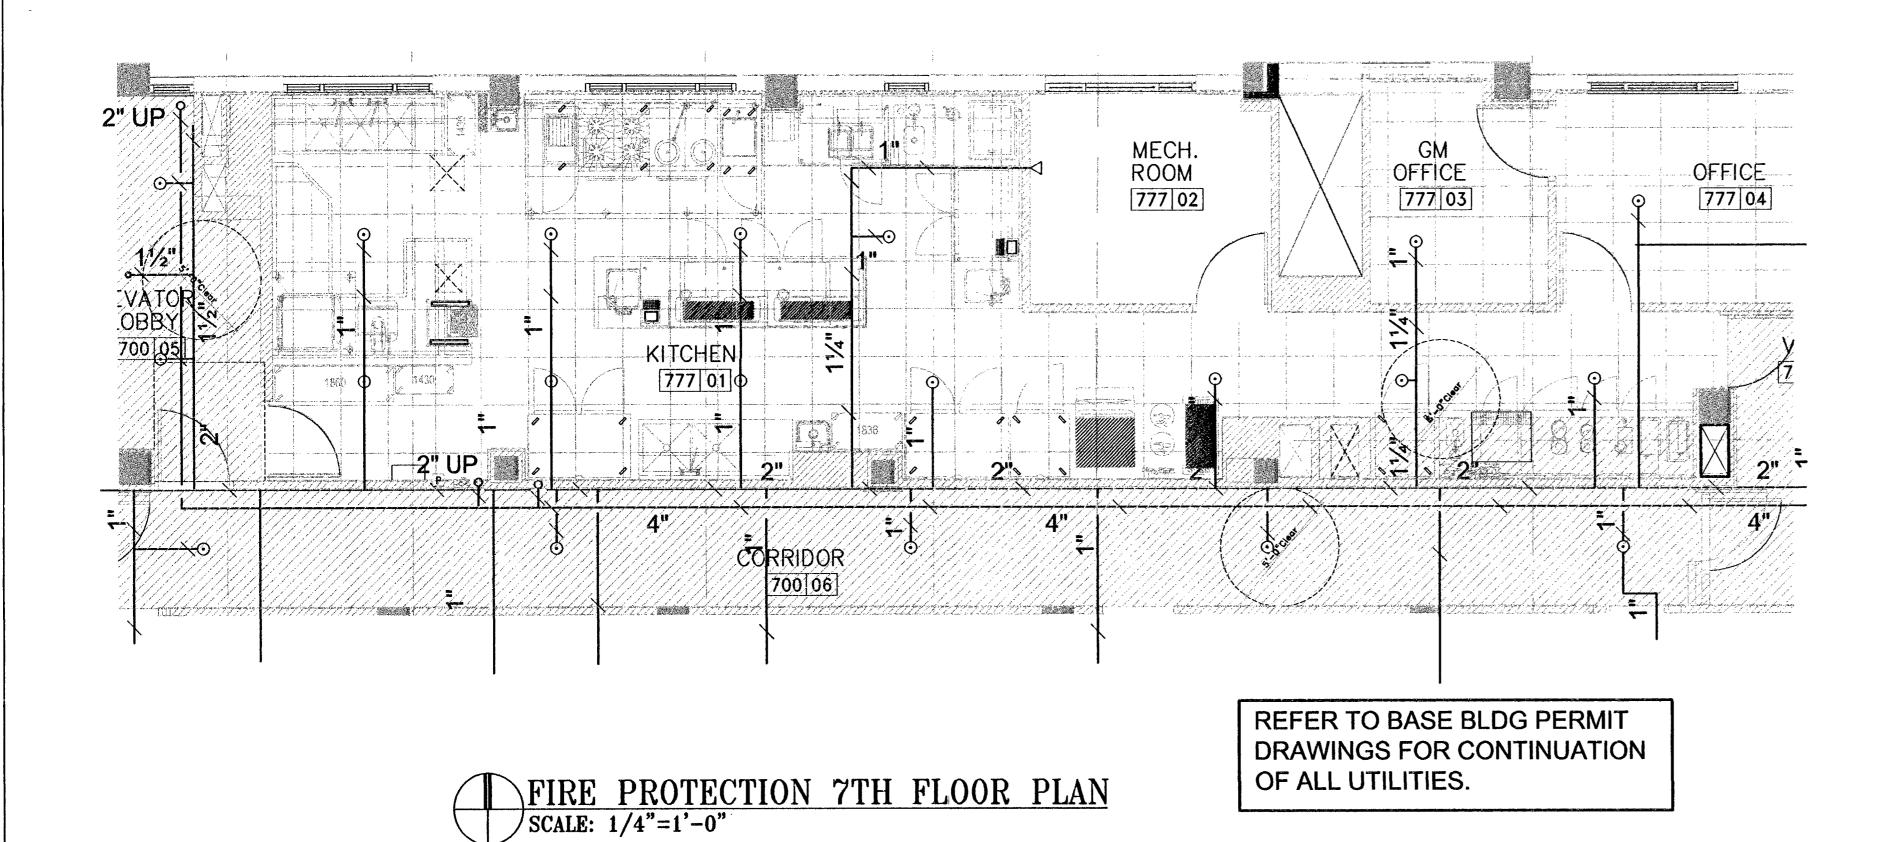4385 COLLINS AVENUE, MIAMI BEACH, FL, 33140 JOB NO. 05035

1ST & 7TH FLOOR KITCHENS
CONSTRUCTION DOCUMENTS



FIRE P	ROTECTION LEGEND
SYMBOL	DESCRIPTION
	FIRE PROTECTION PIPE
7	CHECK VALVE
Ш	CAPPED PIPE
M	GATE VALVE
₫	GATE VALVE IN VERTICAL
C DN	PIPE DOWN
O UP	PIPE UP
\(FIRE DEPARTMENT CONNECTION
`@ FS TS	FLOW SWITCH
PIV	POST INDICATOR VALVE WITH TAMPER SWITCH
TS	TAMPER SWITCH
IS IS BFP	BACK FLOW PREVENTER
	HYDRAULIC CALC. REFERENCE POINT
UG	UNDERGROUND
ABV.	ABOVE
CLG	CEILING
ТҮР	TYPICAL

SPECIFICATIONS:

- 1. A FULL COVERAGE FIRE SPRINKLER SYSTEM SHALL BE INSTALLED IN ACCORDANCE WITH THE REQUIREMENTS OF NFPA13, FLORIDA BUILDING CODE & UNDERWRITERS INSURANCE
- 2. ALL SPRINKLER SYSTEM EQUIPMENT AND DEVICES SHALL BE LISTED BY FM & UL FOR SERVICE INTENDED. FOR SPRINKLER HEADS CHARACTERISTICS REFER TO FIRE SPRINKLER SCHEDULE THIS SHEET.
- CONTRACTOR TO OBTAIN APPROVAL FROM OWNER REP. FOR SPRINKLER HEAD STYLE TO BE INSTALLED IN COVERED AREAS PRIOR TO INSTALLATION. SEE SCHEDULE.
- ARRANGEMENT AND LOCATION OF SPRINKLER HEAD & EQUIPMENT SHALL BE AS INDICATED ON DRAWINGS AND SUBJECT TO CONTRACTOR SUBMITTALS.
- 5. DETAILED DRAWINGS OF PROPOSED DEPARTURES DUE TO ACTUAL FIELD CONDITIONS OR OTHER CAUSES SHALL BE SUBMITTED TO THE ARCHITECT/ENGINEER FOR APPROVAL.
- 6. PIPING: INTERIOR ABOVE GROUND SHALL BE ASTM A 53-73 OR A-106 STANDARD WEIGHT, SCHEDULE 10 BLACK STEEL PIPE WITH ROLLED MECHANICAL COUPLINGS OR XL BLACK STEEL PIPE AS PER NFPA 13 AND UL APPROVED FOR FIRE SPRINKLER SERVICE. UNDERGROUND PIPING: SHALL BE DUCTILE IRON TO MEET AWWAC-900 STANDARDS OR PVC PRESSURE PIPES CLASS 150DR-18 AS MFG. BY J-M BLUE BRUTE. CONFIRM WITH CIVIL ENGINEER'S SPECIFICATIONS.
- 7. MAXIMUM DISTANCE BETWEEN HANGERS SHALL BE AS PER NFPA-13 TABLE 6-2.2..
- 8. FIRE SPRINKLER SYSTEM TO BE HYDROSTATIC ALLY TESTED AT 200 PSI FOR 2 HRS MINIMUM.
- 9. HYDRAULIC CALCULATIONS AND PIPE SIZES ARE BASED ON THE PRELIMINARY FLOW TEST: STATIC PRESSURE: 50 PSI; RESIDUAL PRESSURE: 40 PSI AT 1200 GPM WATER FLOW. CONTRACTOR SHALL CONFIRM WATER FLOW TEST DATA BEFORE COMMENCING ANY WORK AND MAY VARY PIPE SIZES IN ACCORDANCE WITH ACTUAL FLOW TEST OBTAINED.
- BEFORE COMMENCING ANY WORK CONTRACTOR SHALL COORDINATE EXACT LOCATION AND POINT OF CONNECTION TO STREET WATER MAIN. REFER TO CIVIL DRAWINGS AND OBTAIN APPROVAL FROM FIRE MARSHALL OFFICE AND LOCAL AUTHORITIES HAVING JURISDICTION.
- 11. BACK FLOW PREVENTOR TO THE BUILDING SHALL BE EXECUTED BY A FLORIDA STATE FIRE SPRINKLER INSTALLATION INCLUDING UNDERGROUND SUPPLY PIPING FROM CERTIFIED FIRE PROTECTION CONTRACTOR.
- 12. PROVIDE SPARE SPRINKLER HEADS IN BOX AS PER NFPA-13 PARAGRAPH (3-2.9) IN ACCESSIBLE LOCATION IN MAINTENANCE OFFICE.
- 13. CONTRACTOR TO SUBMIT SHOP DRAWINGS TO A/E OFFICES FOR APPROVAL.
- 14. SINCE THIS BUILDING IS LOCATED NEAR TO OCEAN ALL EXPOSED PIPING; HANGERS SHALL CORROSION PROTECTED WITH A PROTECTIVE COATING AS HOT DIP GALVANIC LAYER.
- 15. CONTRACTOR TO PROVIDE SPRINKLER SHOP DRAWINGS TO BE APPROVED BY AHJ AS A SEPARATE PERMIT.

	FIRI	S SP	RINI	KLER	HEAD	SCHEDULE		
SYMBOL	DESCRIPTION	SIZE	"K"	TEMP	FINISH	COVERAGE	MFGMODEL	REMARK
0	PENDANT SPRINKLER HEAD	1/2"	5.6	155°F	WHITE	15'x15' LIGHT HAZARD	TYCO SERIES LFII	DROP CEILING AREA. RESIDENTIAL QUICK RESPONSE (CONCEALED)
>	SIDE WALL SPRINKLER HEAD	1/2"	5.6	165°F	WHITE	16'x20' MAXIMUM 23 GPM @ 30 PSI	TYCO SERIES LFII	SEMI RECESSED, QUICK RESPONSE RESIDENTIAL.
0	UPRIGHT SPRINKLER HEAD	1/2"	5.6	165°F	BRONZE	15'x15' LIGHT HAZARD AREAS 13'x10' ORDINARY HAZARD AREAS	TYCO SERIES TY-FRB	AREAS WITHOUT DROP CEILING. QUICK RESPONSE
•	SEMI-RECESSED PENDANT SPRINKLER HEAD	1/2"	5.6	165°F	BRONZE	15'x15' LIGHT HAZARD AREAS 13'x10' ORDINARY HAZARD AREAS	TYCO SERIES TY-FRB	SEMI RECESSED, QUICK RESPONSE
D	WINDOW SPRINKLER	1/2"	5.6	165°F	BRONZE	8' MAXIMUM DISTANCE BETWEEN SPRINKLERS.	TYCO SERIES WS	FINISH TO BE SLECTED BY ARCHITECT
•	DRYPENDANT SPRINKLER HEAD	1/2"	5.6	155°F	BRONZE	13'x10' ORDINARY HAZARD	TYCO SERIES DS-1	AREAS WITHOUT DROP CEILING. QUICK RESPONSE

NOTE: FOR STYLE & COLOR REFER TO ARCHITECTURAL DWGS.








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1ST & 7TH FLOOR KITCHENS CONSTRUCTION DOCUMENTS



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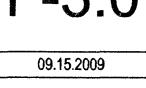
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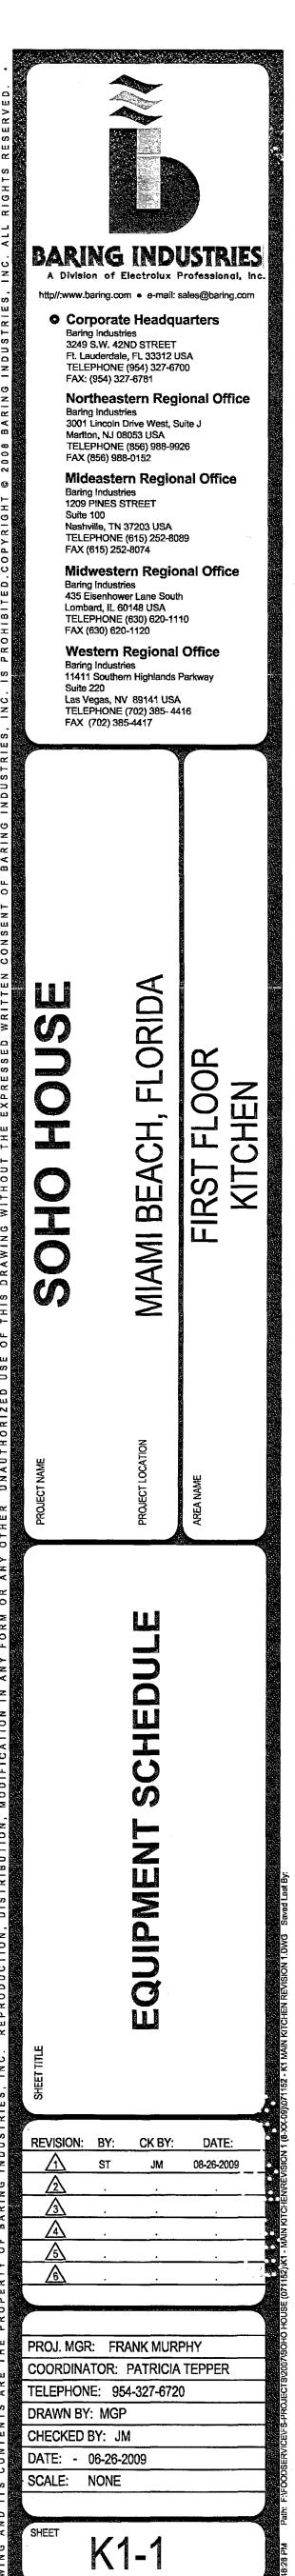
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4385 COLLINS AVENUE, MIAMI BEACH, FL, 33140 JOB NO. 05035


1ST & 7TH FLOOR KITCHENS
CONSTRUCTION DOCUMENTS

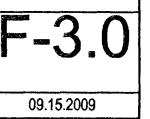

ITEM	DESCRIPTION	MANUFACTURER	MODEL NUMBER	EQUIPMENT REMARKS			TING EQUIPMEN RE- LOCATE REMO		ELECTRIC		WATER HOT COLD	DRAIN IN-DIRECT DIRECT	GAS SIZE M	COOLING WATER BTU/ SUPPLY RETUR	LITILITY REMARKS	TE
	009 Baring Industries						LOCATE			TYPE NUMBER			H	DUR [
1-001	1 MARBLE TOP PICK-UP COUNTER 2 5-20R GFCI DUPLEX RECEPTACLE	FLORIDA STAINLESS FABRICATORS	CUSTOM	MARBLE TOP BY OTHERS; SEE SHOP DWG CONVENIENCE	X			120 1	16	DIRECT					EC TO CONNECT POWER TO RECEPTACLES IN EQUIPMENT	1-0
	2 5-20R GFCI DUPLEX RECEPTACLE			F/1-003				120 1	16	DIRECT					DEDICATED CIRCUIT W/ISOLATED GROUND; EC TO CONNECT POWER TO RECEPTACLES IN EQUIPMENT	
	2 2-DOOR REFRIGERATED BASE							120 1	2.1			1/2"			REFRIGERATION CONNECTED TO 1-208	
	2 HEATED PLATE CABINET 2 CATEGORY-5 DATA PORT			W/SLIDING BI-PASS DOORS F/1-003	X			120 1	4.2	JB						
1-001A 1-001B	1 KNEE WALL 2 WASTE CONTAINER	GENERAL CONTRACTOR RUBBERMAID	CUSTOM 2957		X											1-00
1-002	SPARE															1-00
1-003	7 POS SYSTEM PRINTER				X			120 1	4	C/P 5-15P					REQUIRES EMPTY JB/CONDUIT F/CATEGORY-5 DATA INTERFACE; EC TO VERIFY UTILITY & CONNECTION REQUIREMENTS	1-00
1-004 1-005	1 EXHAUST HOOD 1 FIRE SUPPRESSION SYSTEM	HALTON COMPANY ANSUL	KVE P 102	SEE SHOP DWG WALL MTD W/TOP OF CABINET AGAINST FINISHED CLG; SEE HALTON SHOP DWG	X			120 1	2.1	JB					1,200 CFM EXHAUST; LIGHTING ON SAME POWER CIRCUIT AS 1-016	1-00
		ANOUL	11-102		^										SERVES 1-004 & 1-016	1-00
1-005A 1-006	1 REMOTE PULL STATION 8 PENDANT-TYPE HEAT LAMP	ANSUL MERCO/SAVORY	4835 775-C	SURFACE MTD @ 48" AFF W/CLEAR BULB; CLG HUNG W/BOTTOM OF SHADE @ 18" ABOVE CTR TOP	X			120 1	21	DIRECT					EC TO VERIFY LOCATION W/LOCAL FIRE OFFICIAL PRIOR TO ROUGH-IN	1-00 1-00
1-007	5 HAND SINK	ADVANCE TABCO	7-PS-81	W/K-175 ELECTRONIC FAUCET, SOAP & TOWEL DISPENSER; WALL MTD W/TOP @	X			120 1	1	C/P 5-15P	1/2" 1/2"	1-1/2"			P-TRAP PROVIDED BY BARING/INSTALLED BY PC	1-00
1-008	SPARE			34" AFF												1-00
1-009	1 COOKING SUITE	ELECTROLUX PROFESSIONAL	CUSTOM	SEE SHOP DWG	Х			120/208 3	156	DIRECT	1/2"	(2) 2"	1-1/4" 2	0.4	PRE-WIRED TO LOAD CENTER; GAS PRV PROVIDED BY BARING/INSTALLED BY P	
1-010					·											1-01
1-011 1-012	3 COUNTER TOP CHEESE MELTER 1 MOBILE 48" WOOD-BURNING CHAR-BROILER	JADE RANGE	JLB-48		X			208 1	14	C/P 6-15P					POWER CONNECTED TO RECEPTACLES IN1-009	1-0 ⁻
1-013	1 EXHAUST HOOD	HALTON COMPANY	KVE	SEE SHOP DWG	X			120 1	5.0	JB					4,048 CFM EXHAUST; LIGHTING ON SAME POWER CIRCUIT AS 1-015 & 1-046	1-0
1-014 1-015	1 EXHAUST HOOD	HALTON COMPANY	KVE	SEE SHOP DWG	X			120 1	2.9	JB					2,821 CFM EXHAUST; LIGHTING ON SAME POWER CIRCUIT AS 1-013 & 1-046	1-0°
1-016 1-017	1 EXHAUST HOOD SPARE	HALTON COMPANY	KVE	SEE SHOP DWG	X			120 1	2.1	JB					2,844 CFM EXHAUST; LIGHTING ON SAME POWER CIRCUIT AS 1-004	1-0
1-017	1 MARBLE TOP PREP COUNTER	FLORIDA STAINLESS FABRICATORS	сиѕтом	MARBLE TOP BY OTHERS; SEE SHOP DWG	X			120 1	(4) 16						(4) 5-20R GFCI RECEPTACLES PRE-WIRED TO (1) JB	1-0 ⁻
F	2 2-DOOR REFRIGERATED BASE REFRIGERATED INGREDIENT RAIL (RAISED, ANGLED)							120 1 120 1	2.1	JB JB		1/2"			REFRIGERATION CONNECTED TO 1-208 REFRIGERATION CONNECTED TO 1-208	
1-019	1 WALL SHELF	FLORIDA STAINLESS FABRICATORS	CUSTOM	WALL MTD @ 60" AFF	X					DIDECT						1-0
1-020	1 MARBLE TOP BAKER'S TABLE	FLORIDA STAINLESS FABRICATORS	CUSTOM	W/2-TIER OVERSHELF SUPERSTRUCTURE; MARBLE TOP BY OTHERS; SEE SHOP DWG	X			120 1	16	DIRECT					EC TO CONNECT POWER TO RECEPTACLE IN EQUIPMENT	1-02
-020A	5 WALL SHELF	FLORIDA STAINLESS FABRICATORS	CUSTOM	WALL MTD @ 12", 24", 36", 48", & 60" AFF; SEE SHOP DWG	X											1-02
020B -021	4 WALL SHELF 1 MOBILE 2-COMPARTMENT COOK & HOLD OVEN	FLORIDA STAINLESS FABRICATORS ALTO-SHAAM	CUSTOM 1000-TH-II	WALL MTD @ 12", 24", 36",& 48" AFF; SEE SHOP DWG	X			120 1	(2) 16.8	(2) C/P 5-20P						1-02 1-02
1-022	1 MARBLE TOP PREP COUNTER	FLORIDA STAINLESS FABRICATORS	CUSTOM	W/UTILITY SERVICE CHASE & 2-TIER OVERSHELF SUPERSTRUCTURE; MARBLE TOP BY OTHERS; SEE SHOP DWG	X				(2) 16	JB					EC TO CONNECT POWER TO RECEPTACLES IN EQUIPMENT	1-0%
	1 2-SECTION PASS-THROUGH REFRIGERATED BASE			TOT DE OTTLERO, OLL OHOL DING				120 1	4	JB		1/2"			REFRIGERATION CONNECTED TO 1-208	
1-023	REFRIGERATED INGREDIENT RAIL (RAISED, FLAT) WOOD FIRED PIZZA OVEN	MUGNAINI	140 PA		X			120 1	1	JB		1"			REFRIGERATION CONNECTED TO 1-208	1-02
1-024	1 FOOD WARMER	HATCO	GRA-48D3	W/INFINTE CONTROL	X			120 1	13.3	PIGTAIL					PRE-WIRED TO JB IN MECHANICAL SPACE OF 1-022	1-02
1-025 1-026	1 MICROWAVE OVEN	PANASONIC	NE-1054		X			120 1	13.4	C/P 5-15P						1-02 1-02
-027 027A	1 WALL SHELF 1 WALL SHELF	FLORIDA STAINLESS FABRICATORS FLORIDA STAINLESS FABRICATORS	CUSTOM CUSTOM	WALL MTD @ 60" AFF WALL MTD @ 60" AFF	X											1-0
-028	1 MARBLE TOP WORK COUNTER	FLORIDA STAINLESS FABRICATORS FLORIDA STAINLESS FABRICATORS	CUSTOM	MARBLE TOP BY OTHERS; SEE SHOP DWG	X			120 1	(2) 16	JB					5-20R GFCI RECEPTACLES PRE-WIRED TO (1) JB	1-02
	1 2-DOOR REFRIGERATED BASE 1 1-DOOR FREEZER BASE							120 1 120 1	2.1	JB JB		1/2"			REFRIGERATION CONNECTED TO 1-208 REFRIGERATION CONNECTED TO 1-208	\exists
	1 REFRIGERATED INGREDIENT RAIL (RAISED, ANGLED)							120 1	1	JB		1"			REFRIGERATION CONNECTED TO 1-208	
1-029 1-030	1 DIPPERWELL W/FAUCET SPARE	FISHER MANUFACTURING	3041		X						3/8"	1-1/2"				1-02
1-031	1 PASS-THROUGH SHELF & FRAME	FLORIDA STAINLESS FABRICATORS	CUSTOM	SEE SHOP DWG	Х			100	(0) 10							1-03
1-032	1 MARBLE TOP WORK COUNTER W/DROP-IN SINK 2 2-DOOR REFRIGERATED BASE	FLORIDA STAINLESS FABRICATORS	CUSTOM	MARBLE TOP BY OTHERS; SEE SHOP DWG	X			120 1 120 1	(2) 16 2.1	JB		1-1/2" 1/2"			EC TO CONNECT POWER TO RECEPTACLES IN EQUIPMENT REFRIGERATION CONNECTED TO 1-208	1-0
1-032A 1-033	1 DECK PRE-RINSE SPRAY	T & S BRASS & BRONZE WORKS	B-0113	W/B-0156 ADD-ON FAUCET & B-0109-01 WALL BRACKET	Х						1/2" 1/2"				BACKFLOW PREVENTION DEVICE PROVIDED/INSTALLED BY PC	1-03
1-034	1 VACUUM PACKAGING MACHINE	BERKEL COMPANY	350D		X			120 1		C/P 5-20P						1-03 1-03
1-035 1-036	1 FOOD PROCESSOR 1 FLOOR TROUGH W/REMOVABLE GRATE	FLORIDA STAINLESS FABRICATORS	601368 CUSTOM	SEE SHOP DWG	X			120 1	6.3	C/P 5-15P		3"				1-03 1-03
1-037	1 FIRE SUPPRESSION SYSTEM	ANSUL	R-102	WALL MTD W/TOP OF CABINET AGAINST FINISHED CLG; SEE HALTON SHOP DWG	Х										SERVES 1-013, 1-015 & 1-046; MECHANICAL GAS VALVE PROVIDED BY	1-03
1-037A	1 REMOTE PULL STATION	ANSUL	4835	RECESSED IN BLDG WALL @ 48" AFF	X										BARING/INSTALLED BY PC EC TO VERIFY LOCATION W/LOCAL FIRE OFFICIAL PRIOR TO ROUGH-IN	1-03
1-038 1-039	1 5-QUART MIXER 1 WALL SHELF W/UTENSIL RACK	KITCHEN AID FLORIDA STAINLESS FABRICATORS	KM25G0XWH CUSTOM	WALL MTD @ 66" AFF	X			120 1	3.8	C/P 5-15P						1-03
I-039A	1 WALL SHELF W/UTENSIL RACK	FLORIDA STAINLESS FABRICATORS	CUSTOM	WALL MTD @ 66" AFF	X											1-03
1-040 1-041	SPARE 1 3-COMPARTMENT SINK	FLORIDA STAINLESS FABRICATORS	CUSTOM	SEE SHOP DWG	X	-						(3) 1-1/2"				1-04 1-04
1-041A	1 BACKSPLASH FAUCET	T & S BRASS & BRONZE WORKS	B-0290	W/B-WH6 WRIST HANDLES	X						3/4" 3/4"				DAOVELOW BDEVENTON BEVOLETIES	1-04
041B 2 - 1-043		T & S BRASS & BRONZE WORKS	B-02187-01	W/B-0158 ADD-ON FAUCET & B-0109-01 WALL BRACKET	X						1/2" 1/2"				BACKFLOW PREVENTION DEVICE PROVIDED/INSTALLED BY PC	1-04 1-042 -
1-044 1-045	1 COUNTER TOP PASTA MACHINE 1 MOBILE TOOL CABINET	LA MONFERRINA LISTA INTERNATIONAL	PNUOVA MP0600-0402FA-M		X			208 3	4.32	DIRECT					EC TO PROVIDE/INSTALL 48" CORD W/15-15P PLUG	1-04
-046	1 EXHAUST HOOD	HALTON COMPANY	OX	SEE SHOP DWG	X			120 1	7.5	JB					4,290 CFM EXHAUST; LIGHTING ON SAME POWER CIRCUIT AS 1-013 & 1-015	1-04 1-04
1-047 1-048	SPARE 1 FLOOR TROUGH W/REMOVABLE GRATE	FLORIDA STAINLESS FABRICATORS	CUSTOM	SEE SHOP DWG	X							3"				1-04 1-04
-049	1 EQUIPMENT STAND	FLORIDA STAINLESS FABRICATORS	CUSTOM	SEE SHOP DWG	X											1-04
-050 -051	SPARE 1 COUNTER TOP 40-QUART STEAM-JACKETED TILTING KETTLE	GROEN	TDB-40	W/DBL PANTRY PRE-RINSE SPRAY FAUCET & MTG BRACKET	х			208 3	30	DIRECT	1/2" 1/2"				BACKFLOW PREVENTION DEVICE PROVIDED/INSTALLED BY PC	1-05 1-05
052 053	1 COUNTER TOP 40-QUART BRAISING PAN	GROEN	TD/FPC CUSTOM	W/DBL PANTRY FAUCET	X			208 3	16		1/2" 1/2"					1-0
)54	1 S/S WALL PANELS SPARE	FLORIDA STAINLESS FABRICATORS	CUSTOM	SEE SHOP DWG	^		<u> </u>				<u> </u>					1-0 1-0
-055 -056	1 40-QUART MIXER SPARE	HOBART	HL400	W/TIMER	X			208 3	5.6	DIRECT						1-05
1-057	3 MOBILE INGREDIENT BIN	RUBBERMAID	3600-88	W/COVER	Х											1-05 1-05
058 059	SPARE 1 12" GRIDDLE TOP RANGE W/CABINET BASE	MONTAGUE COMPANY	12-8T	W/SHS-12 BACKGUARD, SGL HIGH SHELF & (2) CASTERS & 1-1/4" FRONT	X								1-1/4"	0	GAS SUPPLY THROUGH INLET ON 1-061	1-05 1-05
1	SPARE			MANIFOLD; IN BATTERY W/1-061 & 1-063; SEE SHOP DRAWING												
nen	SPARE 1 36" 2-FRENCH TOP RANGE W/OVEN	MONTAGUE COMPANY	136-9A	W/O BACKGUARD F/RANGE MOUNT SALAMANDER; W/(2) CASTERS, 1-1/4" FRONT	x								1" 1	0	GAS PRV PROVIDED BY BARING INSTALLED BY PC	1-0
	, I			MANIFOLD & REAR GAS CONNECTION; IN BATTERY W/1-059 & 1-063; SEE SHOP DRAWING												
		DORMONT MANUFACTURING	16100BPQ2S-48	1" X 48"; NOT SHOWN ON DWG	X											1-06
-061 061A	1 FLEX GAS LINE W/QUICK DISCONNECT & RESTRAINT	MONTAGUE COMPANY	SB36-HB	W/BACKGUARD; MTD TO 1-061; SEE SHOP DRAWING	Х								1/2"	2	W/INTERCONNECTING GAS LINE TO 1-061; GAS SUPPLY THROUGH INLET ON 1-061	
1-061 -061A	1 FLEX GAS LINE W/QUICK DISCONNECT & RESTRAINT 1 36" SALAMANDER BROILER	_	9-S	W/SHS-9 BACKGUARD, SGL HIGH SHELF, (2) CASTERS & 1-1/4" FRONT MANIFOLD	X	1										1-06
1-061 -061A 1-062		MONTAGUE COMPANY		W/R END CAP; IN BATTERY W/1-059 & 1-061; SEE SHOP DRAWING	X	-		120 1	7.2	C/P 5-15P		<u> </u>	1/2" 1	5	GAS PRV PROVIDED BY BARING INSTALLED BY PC	1-06
-061A -062 I-063	1 36" SALAMANDER BROILER	MONTAGUE COMPANY MONTAGUE COMPANY	115A		1	 				-2. 3 101					2	1-06
1-061 -061A 1-062 1-063	1 36" SALAMANDER BROILER 1 9" SPREADER CABINET		115A 1650BPQ2S-48	W/MOBILE STAND & RACK GUIDES 1/2" X 48"; NOT SHOWN ON DWG	Х		į l	_ 1	1	. 1		•	<u> </u>	. 1	1	1
-061 -061A -062 -063	1 36" SALAMANDER BROILER 1 9" SPREADER CABINET 1 1-COMPARTMENT CONVECTION OVEN	MONTAGUE COMPANY		W/MOBILE STAND & RACK GUIDES	Х											
1-061 -061A 1-062 1-063	1 36" SALAMANDER BROILER 1 9" SPREADER CABINET 1 1-COMPARTMENT CONVECTION OVEN	MONTAGUE COMPANY		W/MOBILE STAND & RACK GUIDES	X											
1-061A 1-062 1-063 1-064	1 36" SALAMANDER BROILER 1 9" SPREADER CABINET 1 1-COMPARTMENT CONVECTION OVEN	MONTAGUE COMPANY		W/MOBILE STAND & RACK GUIDES	X											
1-060 1-061 1-061A 1-062 1-063 1-064 1-064A	1 36" SALAMANDER BROILER 1 9" SPREADER CABINET 1 1-COMPARTMENT CONVECTION OVEN	MONTAGUE COMPANY		W/MOBILE STAND & RACK GUIDES	X		Dr			CONIAL AITE						
1-061A 1-062 1-063 1-064 1-064A	1 36" SALAMANDER BROILER 1 9" SPREADER CABINET 1 1-COMPARTMENT CONVECTION OVEN	MONTAGUE COMPANY	1650BPQ2S-48	W/MOBILE STAND & RACK GUIDES	BARING OTHERS	S REMAIN	N RE- LOCATE REMOV	/E VOLTS PHAS	SE AMPS	CONN NEMA TYPE NUMBER	HOT COLD	IN-DIRECT DIRECT	SIZE ME HC	TU/ UR SUPPLY RETUR	UTILITY REMARKS	ITE



ITEM	<u>/ _</u>	DESCRIPTION	MANUFACTURER	MODEL NUMBER	EQUIPMENT REMARKS	PROVIDED BY	EXISTING EQUIPMENT		ELECTRICAL	WATER	DRA	AIN	GAS	COOLING WATER		1757
			WANDI ACTOILLI	INIODEL NOMBER	EQUIPIVIENT REIVIARNS	BARING OTHERS	REMAIN RE- LOCATE REMOVE	VOLTS PH	ASE AMPS CONN NEMA	R HOT COL	.D IN-DIRECT	DIRECT	SIZE MBTU/	SUPPLY RETUR	UTILITY REMARKS	ITEM
1-065	1	ring Industries BLAST CHILLER/SHOCK FREEZER	IRINOX USA	HCMA 51.20	W/CASTERS & SELF-CONTAINED REFRIGERATION	X		208	1 7 C/P L6-20P		1-1/2"					1-065
1-066 1-067	1	COUNTER TOP ICE CREAM BATCH FREEZER WALK-IN COOLER	CARPIGIANI BALLY REFRIGERATED BOXES	LB-100B	SEE SHOP DWG	X		208	1 14 DIRECT						EC TO PROVIDE/INSTALL 48" CORD W/L6-20P PLUG	1-066
1-067A 1-068		WALK-IN FREEZER WALK-IN COOLER EVAPORATOR COIL	BALLY REFRIGERATED BOXES BOHN	CUSTOM CUSTOM ADT120AEK	SEE SHOP DWG	X		120	1 2.9 JB							1-067A
1-069 - 1-0 1-071	070	SPARE			SEE OMNI SHOP DWG	X		120	1 2 DIRECT		3/4"				REFRIGERATION CONNECTED TO 1-208	1-068 1-069 - 1-070
1-071A	1	WALK-IN FREEZER EVAPORATOR COIL DRAIN LINE HEATER	BOHN	LET075BEK	SEE OMNI SHOP DWG FLEXIBLE SELF-REGULATING TYPE @ 3 WATTS/FT; NOT SHOWN ON DWG	X EC		208	1 7.8 DIRECT 1 2 JB		3/4"				REFRIGERATION CONNECTED TO & POWER SUPPLY FR/1-208 POWER SUPPLY FR/1-208	1-071 1-071A
1-072 1-073	2	MOBILE 4-TIER COLD STORAGE SHELVING UNIT MOBILE PAN RACK	INTERMETRO INDUSTRIES INTERMETRO INDUSTRIES	METROMAX Q RS1		X										1-072
1-074 1-075		SPARE ELECTRIC INSECT KILLER	GARDNER PRODUCTS	A C 060	MALL NTD WIDOTTON O AGE LET											1-073
1-076	1	SOILED DISHTABLE	FLORIDA STAINLESS FABRICATORS	AG-969 CUSTOM	WALL MTD W/BOTTOM @ 48" AFF W/2-SIDED ANGLED DISHRACK SHELF SUPERSTRUCTURE; SEE SHOP DWG	X X		120	1 1 C/P 5-15P		1"				EC TO VERIFY UTILITY & CONNECTIONS REQUIREMENTS	1-075 1-076
1-077 1-078	1	MOBILE 4-TIER CLEAN DISH SHELVING UNIT	INTERMETRO INDUSTRIES	SUPER ERECTA	SUPER ADJUSTABLE; METROSEAL 3	X										1-077 1-078
1-079	2	UNDERCOUNTER DISHMACHINE	HOBART	LXiH	W/70 DEG F TEMPERATURE RISE WATER BOOSTER HEATER	X		120/208	1 37.7 DIRECT	3/4"	3/4"				MINIMUM 110 DEG F WATER SUPPLY; WATER HAMMER ARRESTOR	1-079
1-080 1-081		DISH RACK DOLLY FLOOR TROUGH W/REMOVABLE GRATE	INTERMETRO INDUSTRIES	CBH-2121C	W/HANDLE	Х									PROVIDED/INSTALLED BY PC	1-080
1-082	1	CLEAN DISHTABLE W/UNPOWERED CONVEYOR	FLORIDA STAINLESS FABRICATORS FLORIDA STAINLESS FABRICATORS	CUSTOM CUSTOM	SEE SHOP DWG SEE SHOP DWG	X					(2) 1-1/2"	(2) 3"				1-081 1-082
1-083		SCRAP COLLECTOR	SALVAJOR	S914	W/MACHINE MTD MSS-LD CONTROL PANEL	х		208	3 3.2 DIRECT	1/2" 1/2"	"	2"			BACKFLOW PREVENTION DEVICE & WATER HAMMER ARRESTOR	1-083
1-084 1-085		DECK PRE-RINSE SPRAY SERVICE FAUCET	T & S BRASS & BRONZE WORKS		W/B-0109-01 WALL BRACKET	Х				1/2" 1/2"					PROVIDED/INSTALLED BY PC BACKFLOW PREVENTION DEVICE PROVIDED/INSTALLED BY PC	1-084
1-086	2	VENT DUCT	T & S BRASS & BRONZE WORKS FLORIDA STAINLESS FABRICATORS	CUSTOM	W/INTEGRAL VACUUM BREAKER; WALL MTD W/INLETS @ 24" AFF SEE SHOP DWG	X				1/2" 1/2"	N				200 CFM EXHAUST @ LOAD END & 400 CFM EXHAUST @ UNLOAD END	1-085 1-086
1-087	1	DISHMACHINE	HOBART	C44A	W/ELECTRIC TANK HEAT, SIGL POINT ELECTRICAL CONNECTION; VENT FAN CONTROL; TABLE LIMIT SWITCH & (2) VENT HOODS	Х		480 (3 28.2 DIRECT		2"					1-087
	1	30KW WATER BOOSTER HEATER			== ================================			480 3	3 40.1 DIRECT	3/4"					MINIMUM 110 DEG F WATER SUPPLY; WATER HAMMER ARRESTOR PROVIDED I	BY
1-087A		DRAIN WATER TEMPERING KIT	HOBART	DTW1	MTD @ DRAIN OUTLET OF 1-087; NOT SHOWN ON DWG	X		208	1 2 DIRECT	1/2"	1				BARING/INSTALLED BY PC	1-087A
1-088 1-089 - 1-09	92	ANGLED DISHRACK SHELF SPARE	FLORIDA STAINLESS FABRICATORS	CUSTOM	WALL MTD W/BOTTOM @ 60"; SEE SHOP DWG	Х										1-088 1-089 - 1-092
1-093 \(\square\) 1-094 - 1-09		5-TIER DRY STORAGE SHELVING UNIT SPARE	INTERMETRO INDUSTRIES	METROMAX Q		Х										1-093
1-096	1	WALL SHELF	FLORIDA STAINLESS FABRICATORS	CUSTOM	WALL MTD @ 66" AFF	X										1-094 - 1-095 1-096
1-097 1-097A		WORK COUNTER W/SINK DECK FAUCET	FLORIDA STAINLESS FABRICATORS T & S BRASS & BRONZE WORKS	CUSTOM B-0221	SEE SHOP DWG W/12" SWING SPOUT	X				1/2" 1/2"	1-1/2"					1-097
\(\) 1-098 \(\) 1-099	1	SPARE PREP COUNTER W/SINK & HAND SINK	FLORIDA STAINLESS FABRICATORS	CUSTOM						1/2 1/2						1-098
1-099A		DECK FAUCET	T & S BRASS & BRONZE WORKS	B-0221	SEE SHOP DWG W/12" SWING SPOUT	X				1/2" 1/2"	1-1/2"	1-1/2"			"P" TRAP PROVIDED/INSTALLED BY PC	1-099 1-099A
1-099B 1-100	1	DECK FAUCET WALL SHELF	T & S BRASS & BRONZE WORKS FLORIDA STAINLESS FABRICATORS	B-0325 CUSTOM	W/SWIVEL GOOSENECK SPOUT WALL MTD @ 66" AFF	X				1/2" 1/2"						1-099B
1-101		COUNTER TOP ACCELERATED COOKING OVEN MOBILE 2-DOOR U/C REFRIGERATOR	TURBOCHEF SILVER KING	C3		X		208	1 35 C/P 6-50P							1-100
1-103	1	MOBILE 1-DOOR U/C REFRIGERATOR	SILVER KING	SKR27	W/SELF-CONTAINED REFRIGERATION W/SELF-CONTAINED REFRIGERATION	X		120 120	1 3.1 C/P 5-15P 1 2.2 C/P 5-15P							1-102 1-103
1-104		PANINI GRILL WALL SHELF	EQUIPEX FLORIDA STAINLESS FABRICATORS	MAJESTIC CUSTOM	WALL MTD @ 66" AFF	X		208	1 18 C/P L6-30P							1-104
1-106 1-107		WALL SHELF JUICE COUNTER W/SINK	FLORIDA STAINLESS FABRICATORS FLORIDA STAINLESS FABRICATORS	CUSTOM	WALL MTD @ 66" AFF	X										1-105
1-107A		DECK FAUCET	T & S BRASS & BRONZE WORKS	B-0221	SEE SHOP DWG W/12" SWING SPOUT	X				1/2" 1/2"	1-1/2"					1-107 1-107A
1-108 1-109	1	SPARE ORANGE JUICER	SANTOS	32	WCASTERS	Y		120	1 5 DIRECT						EC TO PROVIDE 48" CORD W/NEMA 5-15P PLUG	1-108
1-110		FOOD WARMER COLD PICK-UP COUNTER	HATCO FLORIDA STAINLESS FABRICATORS	GRAH-42 CUSTOM	W/INFINITE CONTROL BUILT INTO 1-112	X		120 1	1 7.92 PIGTAIL						LOTOT NOVIDE 40 COND WINLING 5-131 T LOG	1-110
1-112		2-TIER HOT PICK-UP STATION	FLORIDA STAINLESS FABRICATORS		SEE SHOP DWG SUSPENDED FR/STRUCTURE ABOVE; BOTTOM SHELF MTD @ 54" AFF; SEE SHOP	X										1-111 1-112
1-113		SPARE			DWG											1_113
1-114 1-115		CENTRAL WATER TREATMENT/FILTRATION SYSTEM FLOOR TROUGH W/REMOVABLE GRATE	EVERPURE FLORIDA STAINLESS FABRICATORS	EV9437-11 CUSTOM	W/LOW PRESSURE ALARM; WALL MTD W/INLET @ 80" AFF SEE SHOP DWG	X		120 1	1 2 C/P 5-15P	3/4"					SERVES 1-116 & 1-117	1-114
1-116	1	FLAKE ICE MACHINE	HOSHIZAKI	F-801MWH	SEE SHOP DIVIG	X		120 1	1 11.5 DIRECT	1/2"	' 3/4"	3"			ICE MAKING WATER SUPPLY THROUGH BLDG WALL FR/1-114	1-115 1-116
1-117 1-118	1	CUBE ICE MACHINE ICE BIN	MANITOWOC FOLLETT	SY-1205W SG1325S-60		X		208 1	1 25 DIRECT	3/8"	(2) 1/2"				ICE MAKING WATER SUPPLY THROUGH BLDG WALL FR/1-114	1-117 1-118
1-119 1-120		SPARE ICE BIN	HOSHIZAKI		W/LEGS & HS-2032 & HS-2035 TOP KITS						2740					1-119
1-121	1	FLOOR TROUGH W/REMOVABLE GRATE	FLORIDA STAINLESS FABRICATORS	CUSTOM	SEE SHOP DWG	X					3/4	3"				1-120 1-121
1-122 1-22A	3	MOBILE 4-TIER COLD STORAGE SHELVING UNIT 4-TIER COLD STORAGE SHELVING UNIT	INTERMETRO INDUSTRIES INTERMETRO INDUSTRIES	SUPER ERECTA SUPER ERECTA	S/S	X										1-122 1-122A
1-123 1-124	I I	WALK-IN COOLER WALK-IN COOLER EVAPORATOR COIL	BALLY REFRIGERATED BOXES BOHN	CUSTOM	SEE SHOP DWG SEE OMNI SHOP DWG	X		120 1	3.44 JB 2 DIRECT		3/A#				DEEDICEDATION CONNECTED TO 4 200	1-123
1-125	1	MOP SINK				PC		120 1	2 DIKEUI		3/4"	3"			REFRIGERATION CONNECTED TO 1-208 PC TO VERIFY UTILITY & CONNECTION REQUIREMENTS	1-124 1-125
1-125A 1-126	1	MOP SINK FAUCET WORK COUNTER	FLORIDA STAINLESS FABRICATORS	CUSTOM	WALL MTD W/INLETS @ 36" AFF SEE SHOP DWG	X PC				1/2" 1/2"					PC TO VERIFY UTILITY & CONNECTION REQUIREMENTS	1-125A 1-126
1-127 1-128		WALL CABINET MOBILE RECEIVING SCALE	ADVANCE TABCO DETECTO		WALL MTD W/BOTTOM @ 51" AFF W/AC ADAPTER	X		120 4	2 C/P 5-15P							1-127
1-129	1	WORK COUNTER 1-DOOR REACH-IN REFRIGERATOR	MILLWORK	CUSTOM		^ X		120 1								1-128 1-129
1-130	1 :	2-DOOR REACH-IN REFRIGERATOR	TRAULSEN TRAULSEN	RHT232WUT-FHS	W/SELF-CONTAINED REFRIGERATION & FULL HT DOOR W/SELF-CONTAINED REFRIGERATION & FULL HT DOOR	X		120 1 120 1	8 C/P 5-15P 11.1 C/P 5-15P							1-130 1-131
1-132 1-133	1	2-DOOR REACH-IN FREEZER WALL SHELF	TRAULSEN MILLWORK	RLT232WUT-FHS	W/SELF-CONTAINED REFRIGERATION & FULL HT DOOR WALL MTD @ 66" AFF	Х		120 1	14.9 C/P 5-20P							1-132
1-134		18" 2-DOOR WORKTOP REFRIGERATOR	DELFIELD		W/SELF-CONTAINED REFRIGERATION	X		120 1	4 C/P 5-15P							1-133 1-134
		DECODIDATION				BARING OTHERS	REMAIN RE- LOCATE REMOVE	VOLTS PHA	SE AMPS CONN NEMA TYPE NUMBER	HOT COLE	D IN-DIRECT	DIRECT S	SIZE MBTU/ HOUR	SUPPLY RETURN	N	
ITEM	Q	DESCRIPTION	MANUFACTURER	MODEL NUMBER	EQUIPMENT REMARKS		EXISTING EQUIPMENT		ELECTRICAL	<u> </u>	DRA	L	GAS	COOLING	TT TT / TT	ITEM
ī						I LUONIDED DI	LAISTING EQUIPMENT	1	LLLUIRIUAL	WATER	I UKA	VIIV	CAO	WATER		Ī

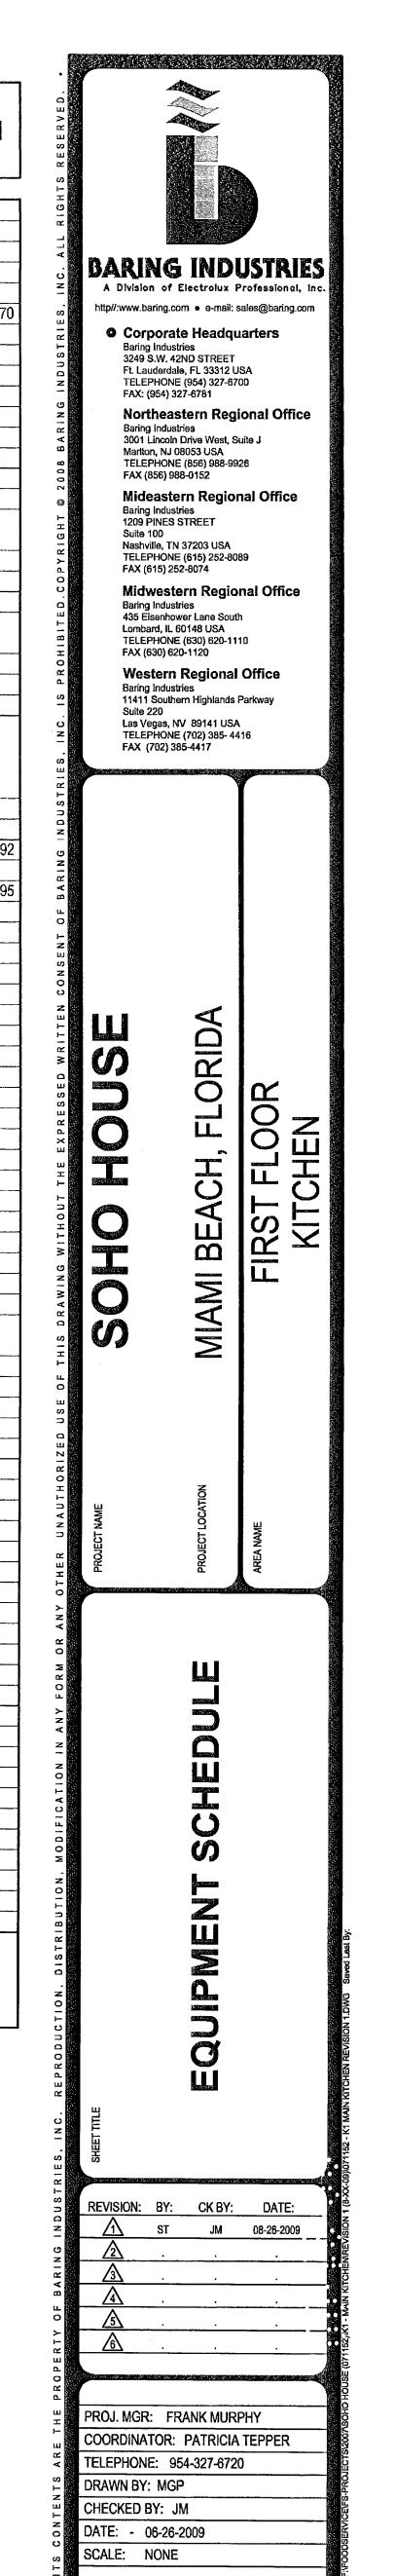

GENERAL NOTES

- REFER TO THE PROJECT ARCHITECTURAL, ELECTRICAL, INTERIOR DESIGN, MECHANICAL & PLUMBING DRAWINGS FOR ACTUAL CONSTRUCTION CONDITIONS & DETAILS.
- 2. M. IUFACTURER'S SHOP DRAWINGS & SPECIFICATION SHEETS ARE PROVIDED BY BARING INDUSTRIES & ARE TO BE CONSIDERED A PART
- OF THESE DRAWINGS.

 3. BUILDING WALLS & DIMENSIONS MATCH THE ARCHITECTURAL
- DRAWINGS PROVIDED TO BARING UNLESS OTHERWISE NOTED.

 4. THESE DRAWINGS INDICATE THE EXTENT OF WORK INCLUDED IN BARING INDUSTRIES' SCOPE OF WORK & DO NOT NECESSARILY
- COMPLETION OF THE PROJECT CONTRACT DOCUMENTS.

 UTILITY & CONNECTION REQUIREMENTS & BUILDING SPECIAL CONDITIONS FOR EQUIPMENT NOT PROVIDED BY BARRING INDUSTRIES.

INCLUDE WORK REQUIRED FOR THE FULL PERFORMANCE &

ARE TO BE VERIFIED WITH THE PROVIDER BY THE APPLICABLE GENERAL, ELECTRICAL, MECHANICAL & PLUMBING CONTRACTORS.

DIMENSIONS ARE FROM SURFACE OF FINISHED WALLS, FLOORS,

- CEILINGS & COLUMN CENTERLINES, DIMENSIONS ARE TO BE VERIFIED BY ALL CONTRACTORS PRIOR TO COMMENCING ANY WORK.
- UNLESS OTHERWISE NOTED.

 8. ALL WORK SHALL BE EXECUTED IN ACCORDANCE WITH APPLICABLE
- FEDERAL, STATE & LOCAL CODES & ANY GOVERNING OFFICIAL HAVING JURISDICTION.
- IN THE EVENT IT IS NECESSARY TO DEVIATE FROM BARING'S DRAWINGS, THE CONTRACTOR SHALL NOTIFY BARING INDUSTRIES IN WRITING PRIOR TO MAKING THE DEVIATION.
- ELECTRICAL & MECHANICAL UTILITY SERVICES & CONNECTIONS HAVE
 BEEN LOCATED TO SUIT THE REQUIREMENTS OF THE FOODSERVICE
 FOLIPMENT
- 11. CONNECTION REQUIREMENTS, CONNECTED LOAD & CONSUMPTION VALUES IN THE EQUIPMENT SCHEDULE ARE FOR (1) UNIT. TO DETERMINE THE TOTAL REQUIREMENTS, MULTIPLY BY THE QUANTITY
- IN THE EQUIPMENT SCHEDULE.

 12. ROUGH-IN SIZES & LOCATIONS SHOWN IN THESE DRAWINGS ARE BASED ON INFORMATION PROVIDED TO BARING, ACTUAL SIZES & LOCATIONS MAY VARY DEPENDING ON PREVAILING CODES,
- STANDARDS & SITE CONDITIONS.

 13. QUARRY TILE FLOORS SHALL BE ACID WASHED & THOROUGHLY
 FLUSHED WITH CLEAN WATER PRIOR TO THE DELIVERY &
 SET-IN-PLACE OF ANY FOODSERVICE EQUIPMENT. DAMAGE CAUSED
 BY ACID BASED CLEANING/ETCHING AGENTS ARE NOT COVERED
- UNDER ANY WARRANTY.

 14. THE GENERAL CONTRACTOR SHALL PROVIDE PENETRATIONS & OPENINGS SIZED TO FIT EQUIPMENT SHOWN IN THESE DRAWINGS.
- OPENINGS SIZED TO FIT EQUIPMENT SHOWN IN THESE DRAWING


 15. PRIOR TO DELIVERY & SET-IN-PLACE OF ANY FOODSERVICE
 EQUIPMENT, THE GENERAL CONTRACTOR SHALL PROVIDE THE


FOLLOWING MINIMUM BUILDING READINESS ITEMS:


- A. CEILING GRIDS INSTALLED.


 B. LIGHTING FIXTURES INSTALLED & WIRED.
- C. HVAC DIFFUSERS & DUCTWORK INSTALLED.
 D. FLOOR ACID WASHED & BROOM SWEPT.
- E. WALL FINISHES INSTALLED ON EXPOSED WALL SURFACES.
 F. ELECTRICAL WIRING PULLED TO ROUGH-IN LOCATIONS SHOWN IN
- THESE DRAWINGS.
 G. PLUMBING PIPING INSTALLED TO ROUGH-IN LOCATIONS SHOWN IN
- THESE DRAWINGS.

 H. GAS, STEAM & WATER PIPING PRESSURE TESTED & FLUSHED FREE OF FOREIGN MATTER.

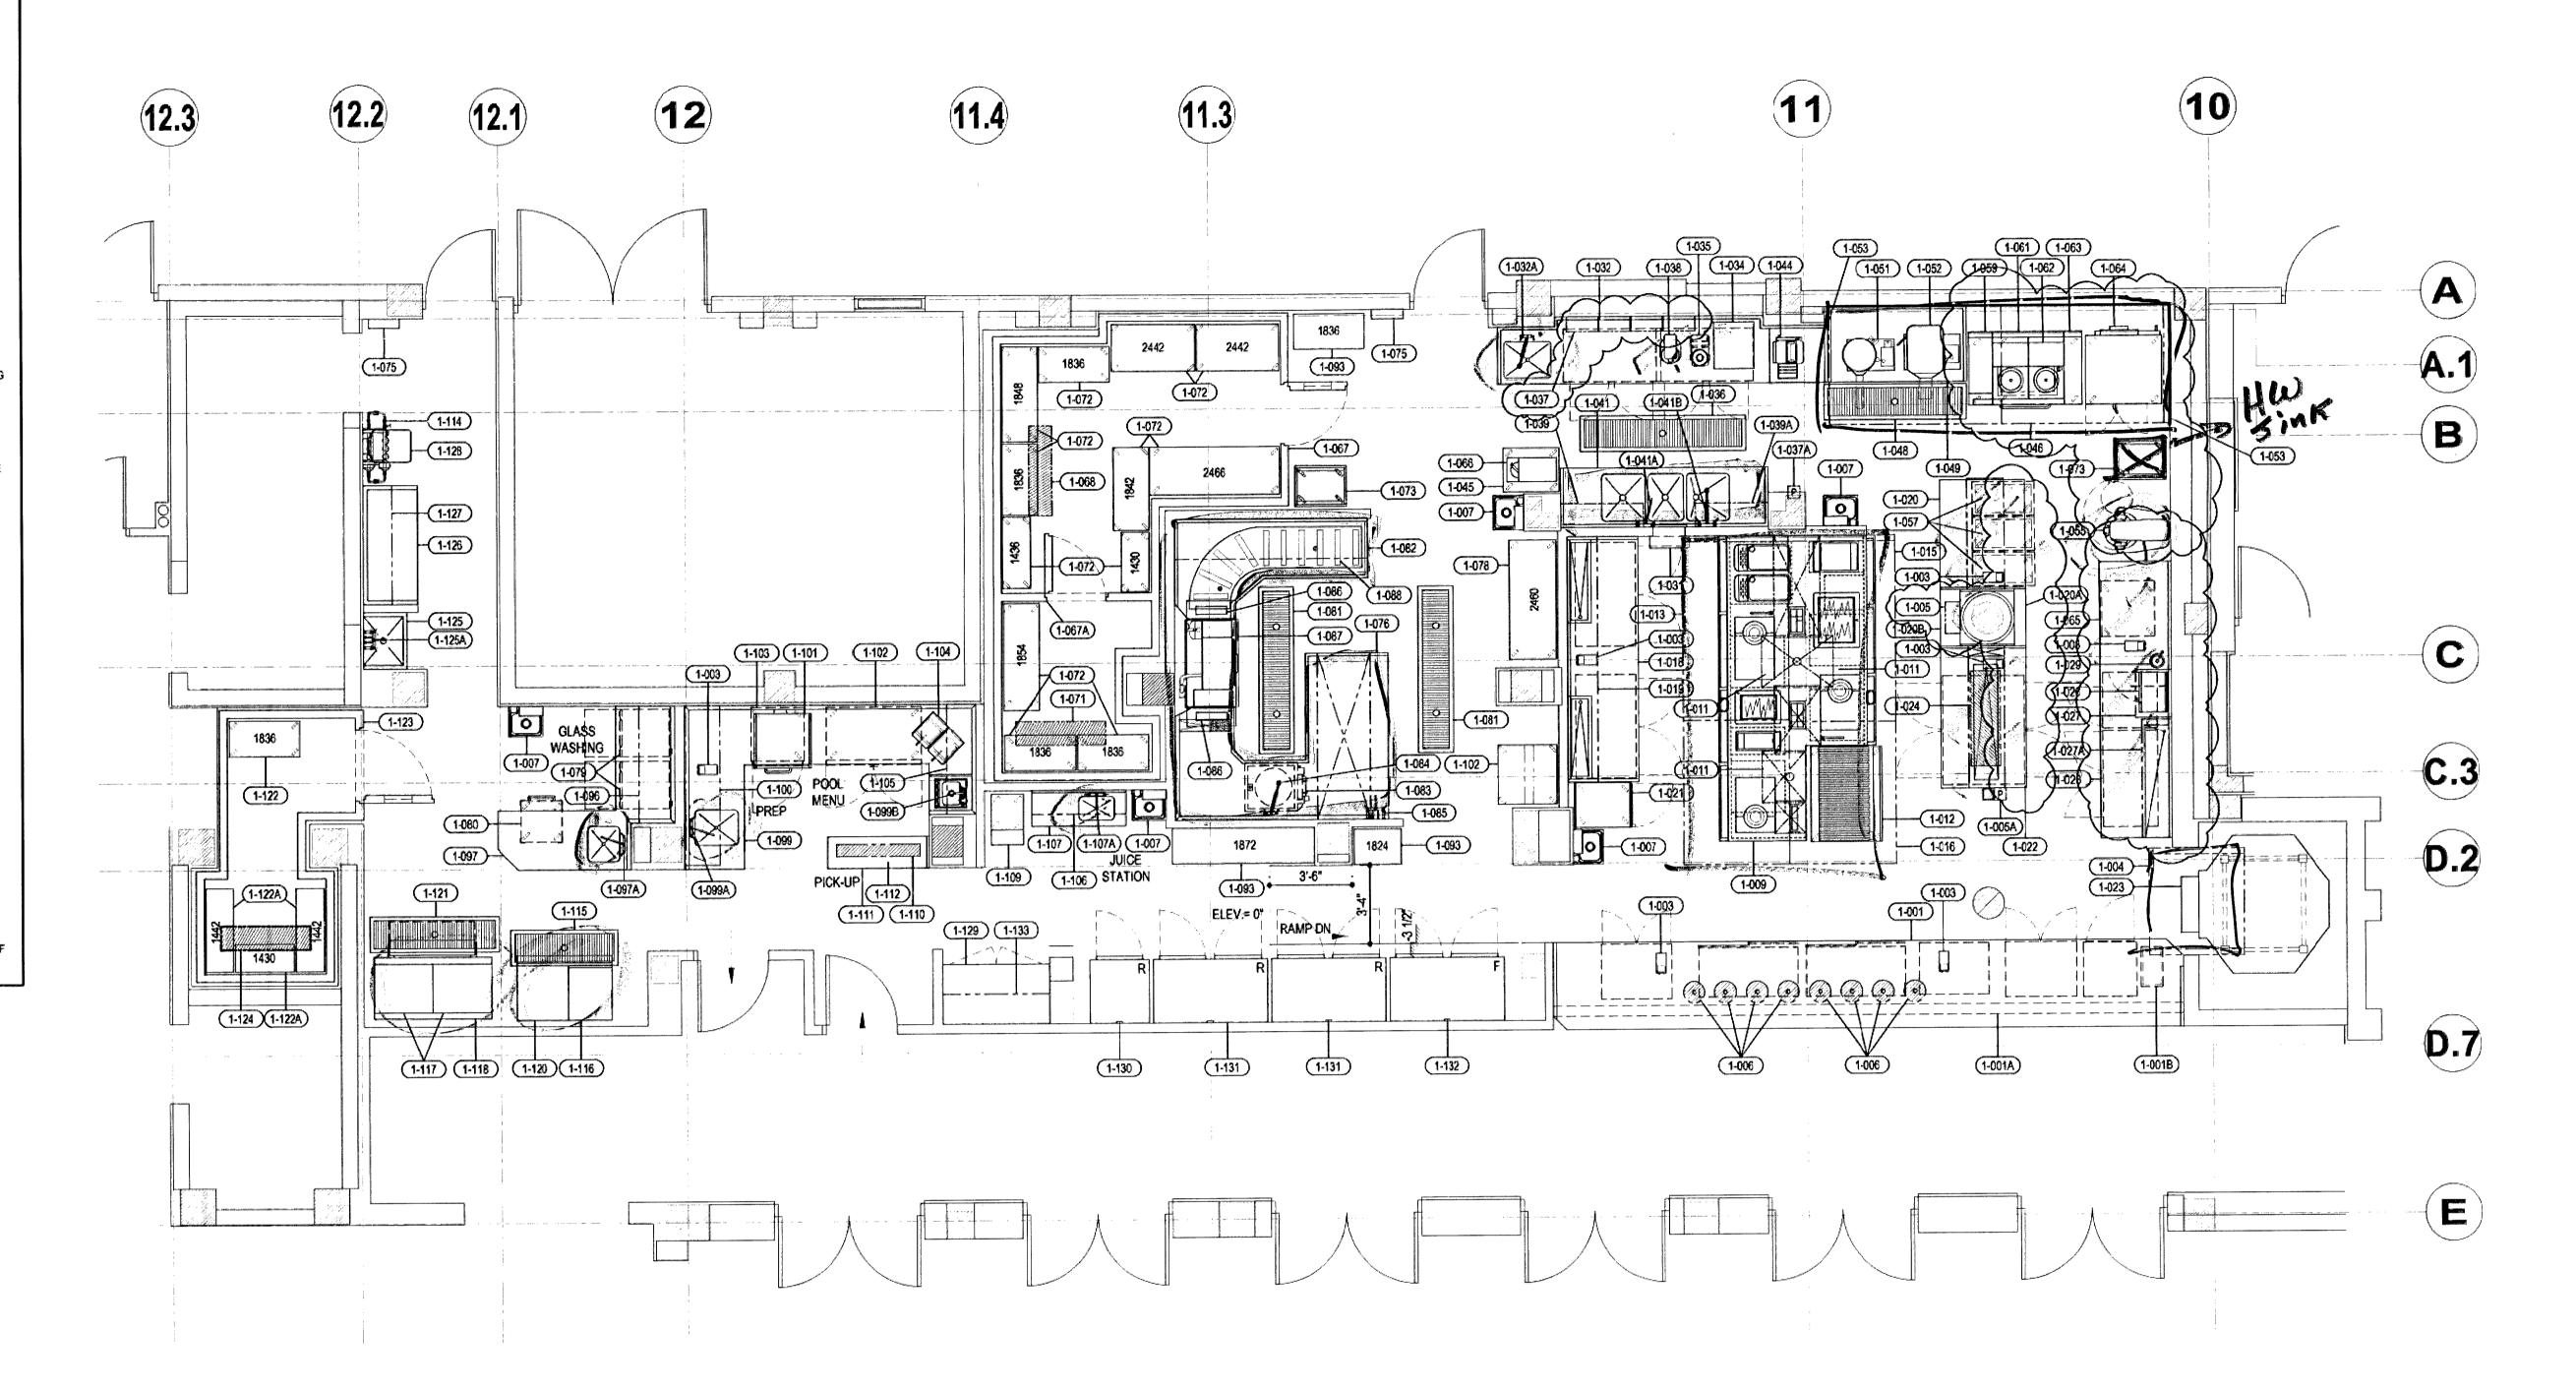

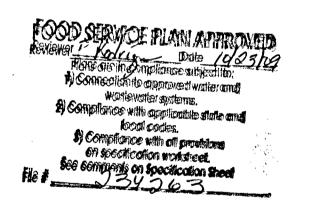

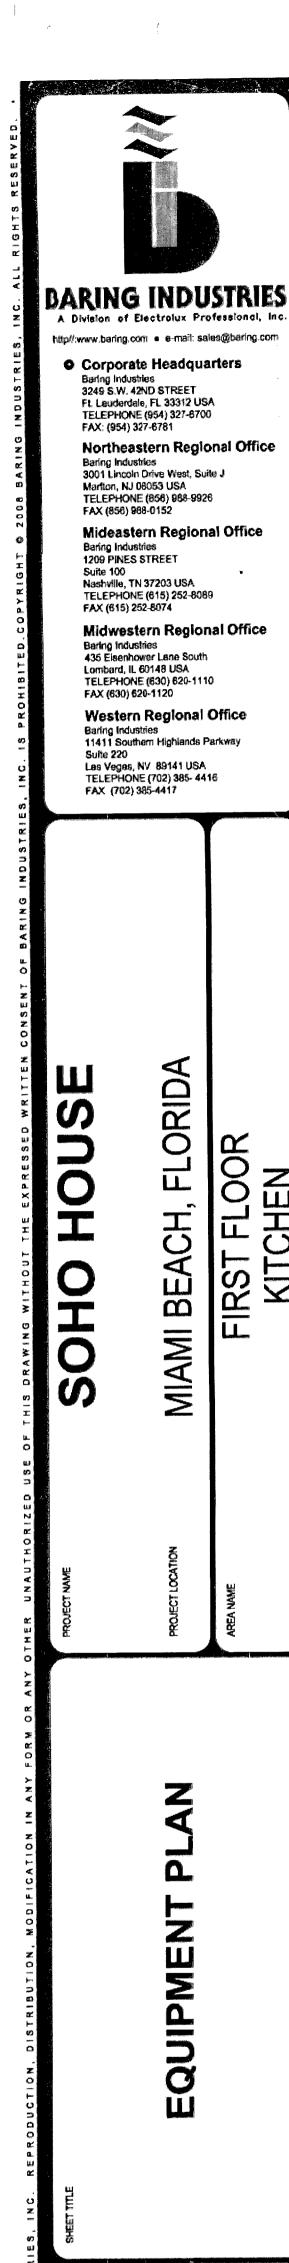

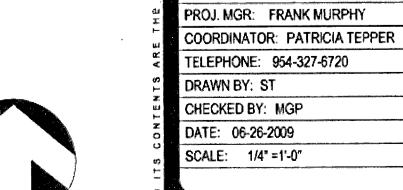

No. No.

GENERAL NOTES


- REFER TO THE PROJECT ARCHITECTURAL, ELECTRICAL, INTERIOR DESIGN, MECHANICAL & PLUMBING DRAWINGS FOR ACTUAL CONSTRUCTION CONDITIONS & DETAILS.
- 2. MANUFACTURER'S SHOP DRAWINGS & SPECIFICATION SHEETS ARE PROVIDED BY BARING INDUSTRIES & ARE TO BE CONSIDERED A PART OF THESE DRAWINGS.
- 3. BUILDING WALLS & DIMENSIONS MATCH THE ARCHITECTURAL DRAWINGS PROVIDED TO BARING UNLESS OTHERWISE NOTED.


 4. THESE DRAWINGS INDICATE THE EXTENT OF WORK INCLUDED IN BARING INDUSTRIES' SCOPE OF WORK & DO NOT NECESSARILY INCLUDE WORK REQUIRED FOR THE FULL PERFORMANCE & COMPLETION OF THE PROJECT CONTRACT DOCUMENTS.
- 5. UTILITY & CONNECTION REQUIREMENTS & BUILDING SPECIAL CONDITIONS FOR EQUIPMENT NOT PROVIDED BY BARING INDUSTRIES ARE TO BE VERIFIED WITH THE PROVIDER BY THE APPLICABLE GENERAL, ELECTRICAL, MECHANICAL & PLUMBING CONTRACTORS.
- DIMENSIONS ARE FROM SURFACE OF FINISHED WALLS, FLOORS, CEILINGS & COLUMN CENTERLINES. DIMENSIONS ARE TO BE VERIFIED BY ALL CONTRACTORS PRIOR TO COMMENCING ANY WORK.
- 7. DIMENSIONS ARE CLEAR FINISHED SURFACE TO FINISHED SURFACE UNLESS OTHERWISE NOTED.
- ALL WORK SHALL BE EXECUTED IN ACCORDANCE WITH APPLICABLE FEDERAL, STATE & LOCAL CODES & ANY GOVERNING OFFICIAL HAVING JURISDICTION.
- IN THE EVENT IT IS NECESSARY TO DEVIATE FROM BARING'S
 DRAWINGS, THE CONTRACTOR SHALL NOTIFY BARING INDUSTRIES IN
 WRITING PRIOR TO MAKING THE DEVIATION.
- 10. ELECTRICAL & MECHANICAL UTILITY SERVICES & CONNECTIONS HAVE BEEN LOCATED TO SUIT THE REQUIREMENTS OF THE FOODSERVICE
- 11. CONNECTION REQUIREMENTS, CONNECTED LOAD & CONSUMPTION VALUES IN THE EQUIPMENT SCHEDULE ARE FOR (1) UNIT. TO DETERMINE THE TOTAL REQUIREMENTS, MULTIPLY BY THE QUANTITY IN THE EQUIPMENT SCHEDULE.
- 12. ROUGH-IN SIZES & LOCATIONS SHOWN IN THESE DRAWINGS ARE BASED ON INFORMATION PROVIDED TO BARING. ACTUAL SIZES & LOCATIONS MAY VARY DEPENDING ON PREVAILING CODES,
- STANDARDS & SITE CONDITIONS.


 13. QUARRY TILE FLOORS SHALL BE ACID WASHED & THOROUGHLY FLUSHED WITH CLEAN WATER PRIOR TO THE DELIVERY & SET-IN-PLACE OF ANY FOODSERVICE EQUIPMENT. DAMAGE CAUSED BY ACID BASED CLEANING/ETCHING AGENTS ARE NOT COVERED UNDER ANY WARRANTY.
- 14. THE GENERAL CONTRACTOR SHALL PROVIDE PENETRATIONS & OPENINGS SIZED TO FIT EQUIPMENT SHOWN IN THESE DRAWINGS.
- 15. PRIOR TO DELIVERY & SET-IN-PLACE OF ANY FOODSERVICE EQUIPMENT, THE GENERAL CONTRACTOR SHALL PROVIDE THE FOLLOWING MINIMUM BUILDING READINESS ITEMS:
- A. CEILING GRIDS INSTALLED.
 B. LIGHTING FIXTURES INSTALLED & WIRED.
- B. LIGHTING FIXTURES INSTALLED & WIRED.
 C. HVAC DIFFUSERS & DUCTWORK INSTALLED.
- D. FLOOR ACID WASHED & BROOM SWEPT.


 E. WALL FINISHES INSTALLED ON EXPOSED WALL SURFACES.


 F. FLECTRICAL WIRING PULLED TO BOLICH IN LOCATIONS SHOWING.
- F. ELECTRICAL WIRING PULLED TO ROUGH-IN LOCATIONS SHOWN IN THESE DRAWINGS.
 G. PLUMBING PIPING INSTALLED TO ROUGH-IN LOCATIONS SHOWN IN
- G. PLUMBING PIPING INSTALLED TO ROUGH-IN LOCATIONS SHOWN IN THESE DRAWINGS.
 H. GAS, STEAM & WATER PIPING PRESSURE TESTED & FLUSHED FREE OF FOREIGN MATTER.

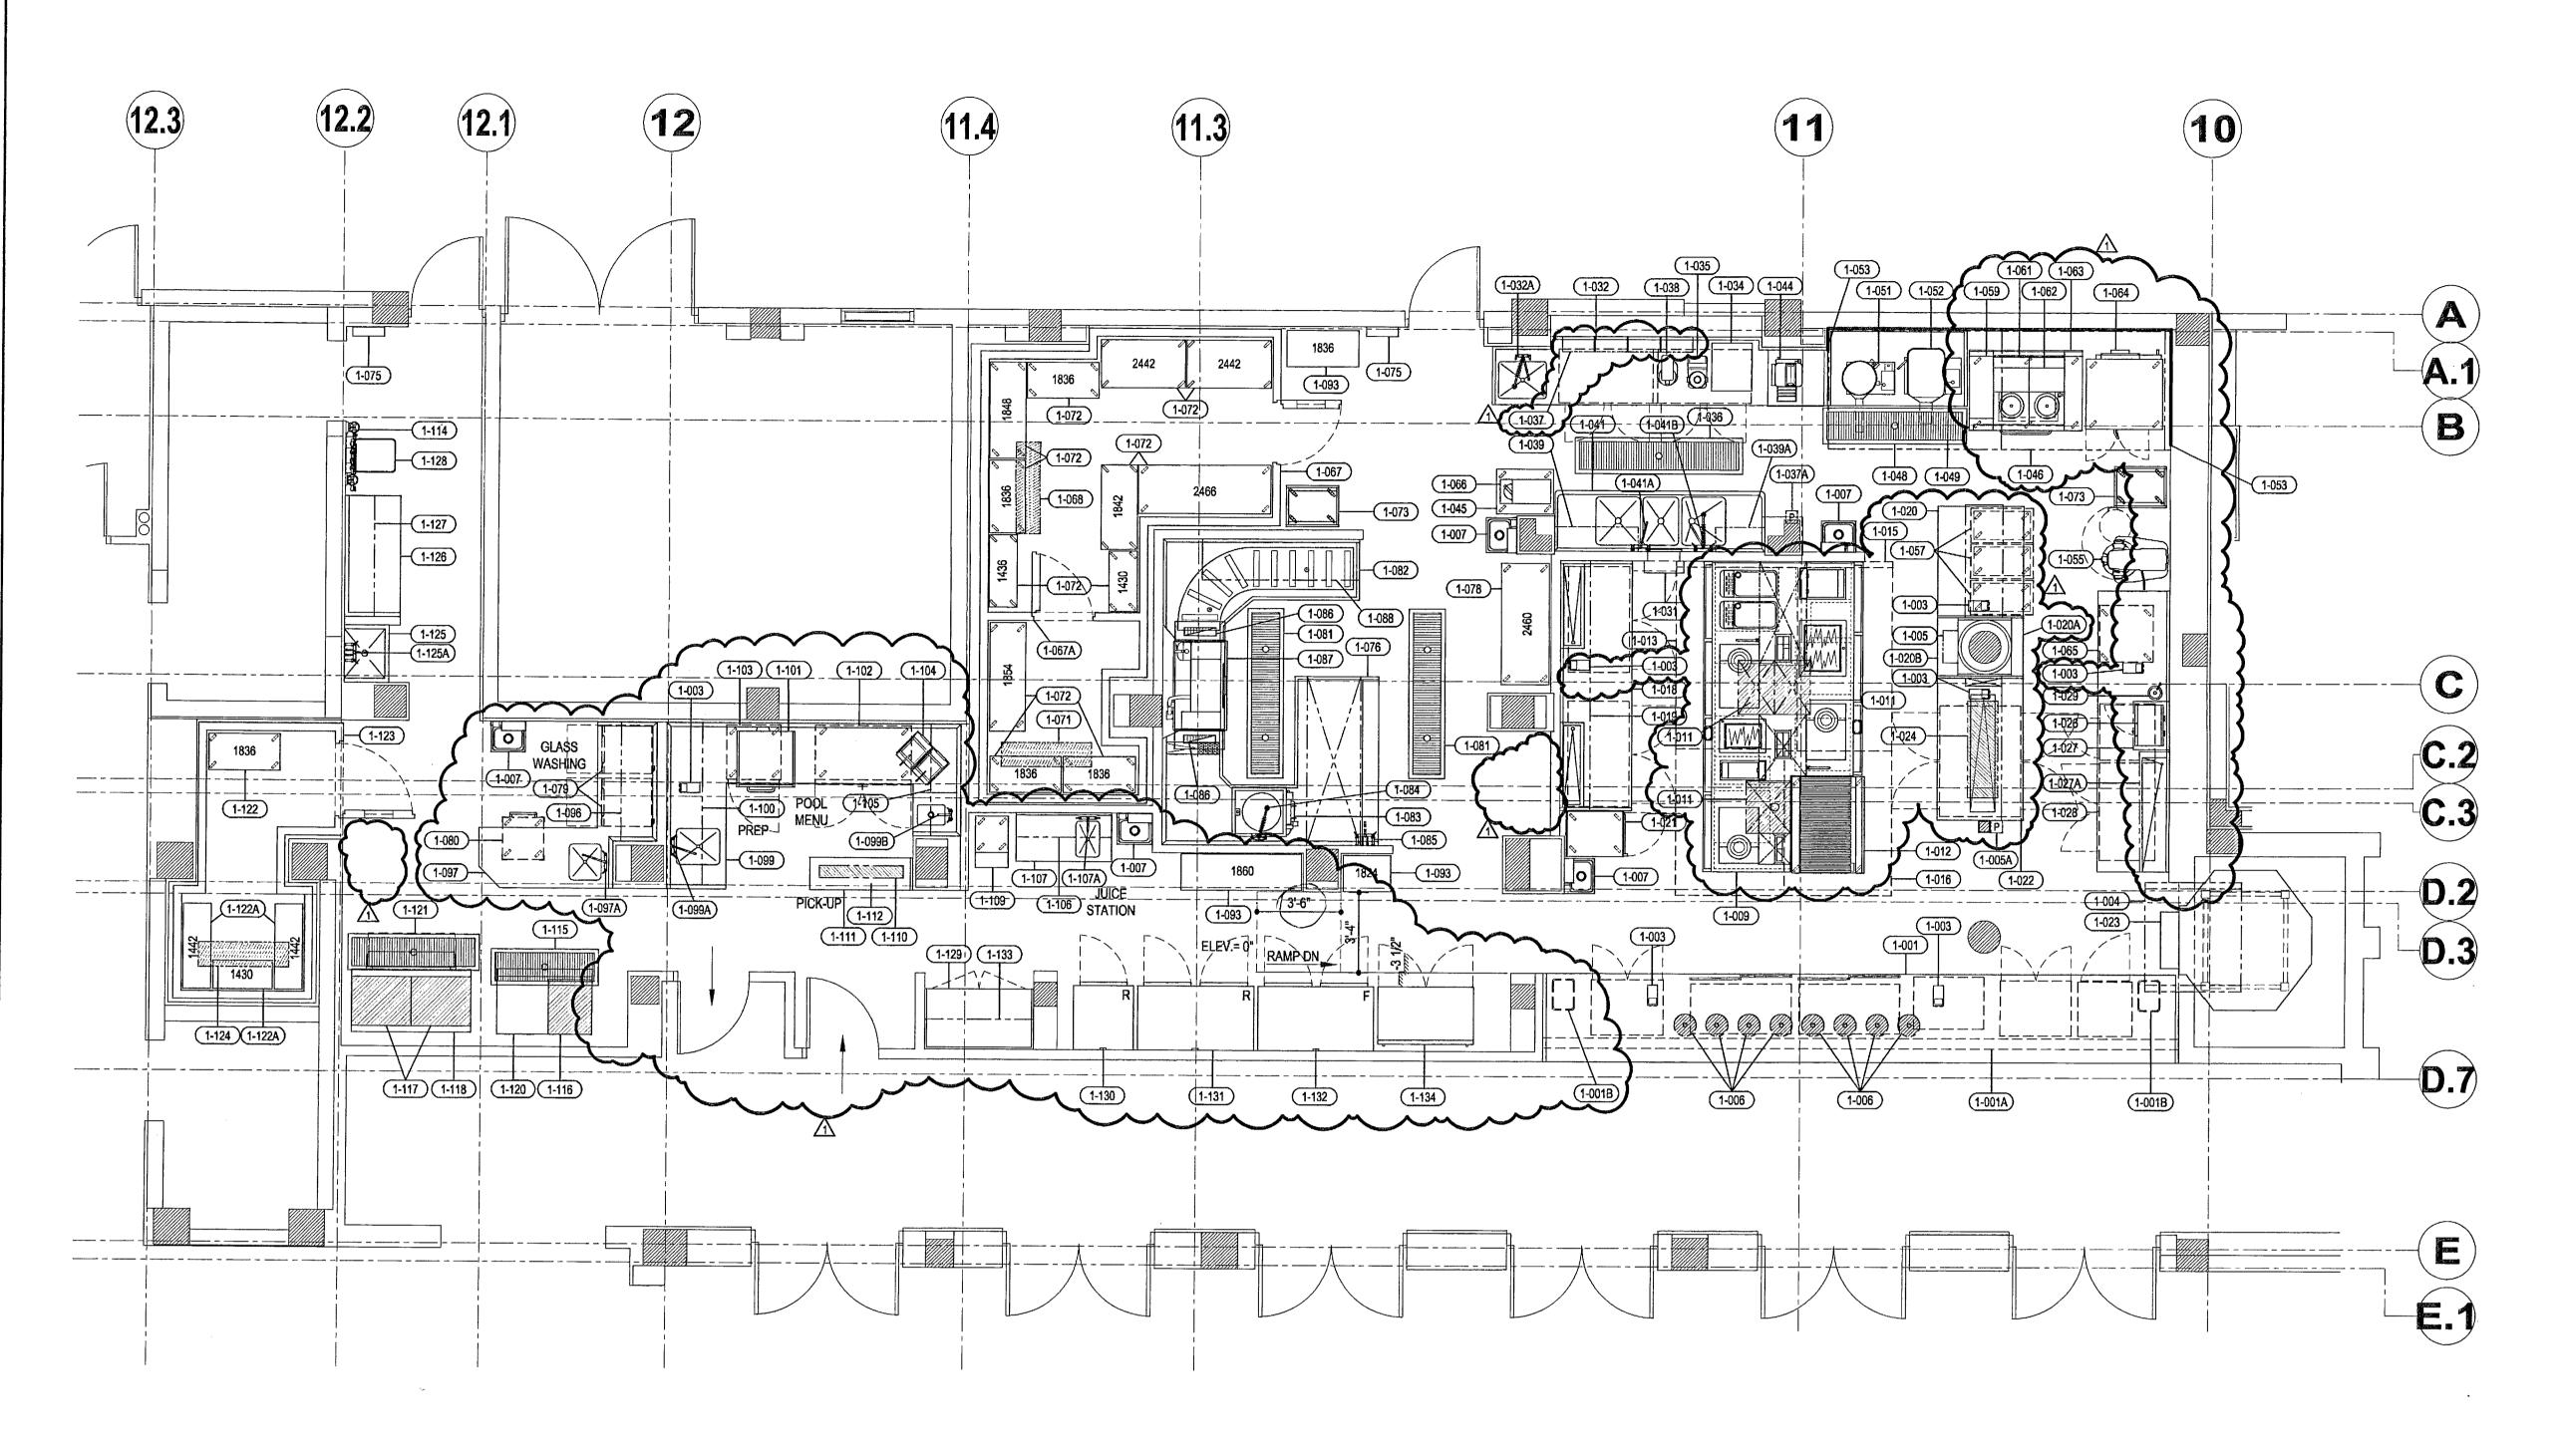

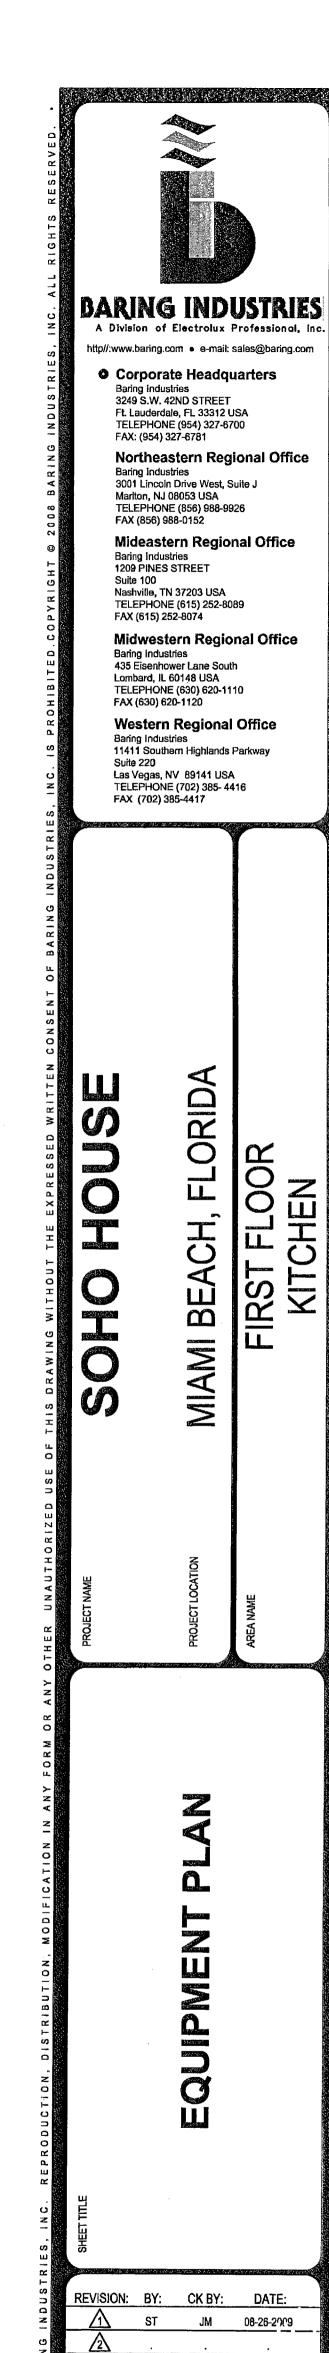

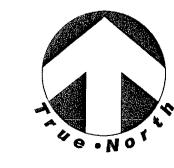

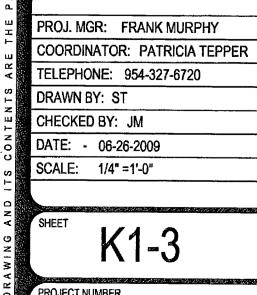

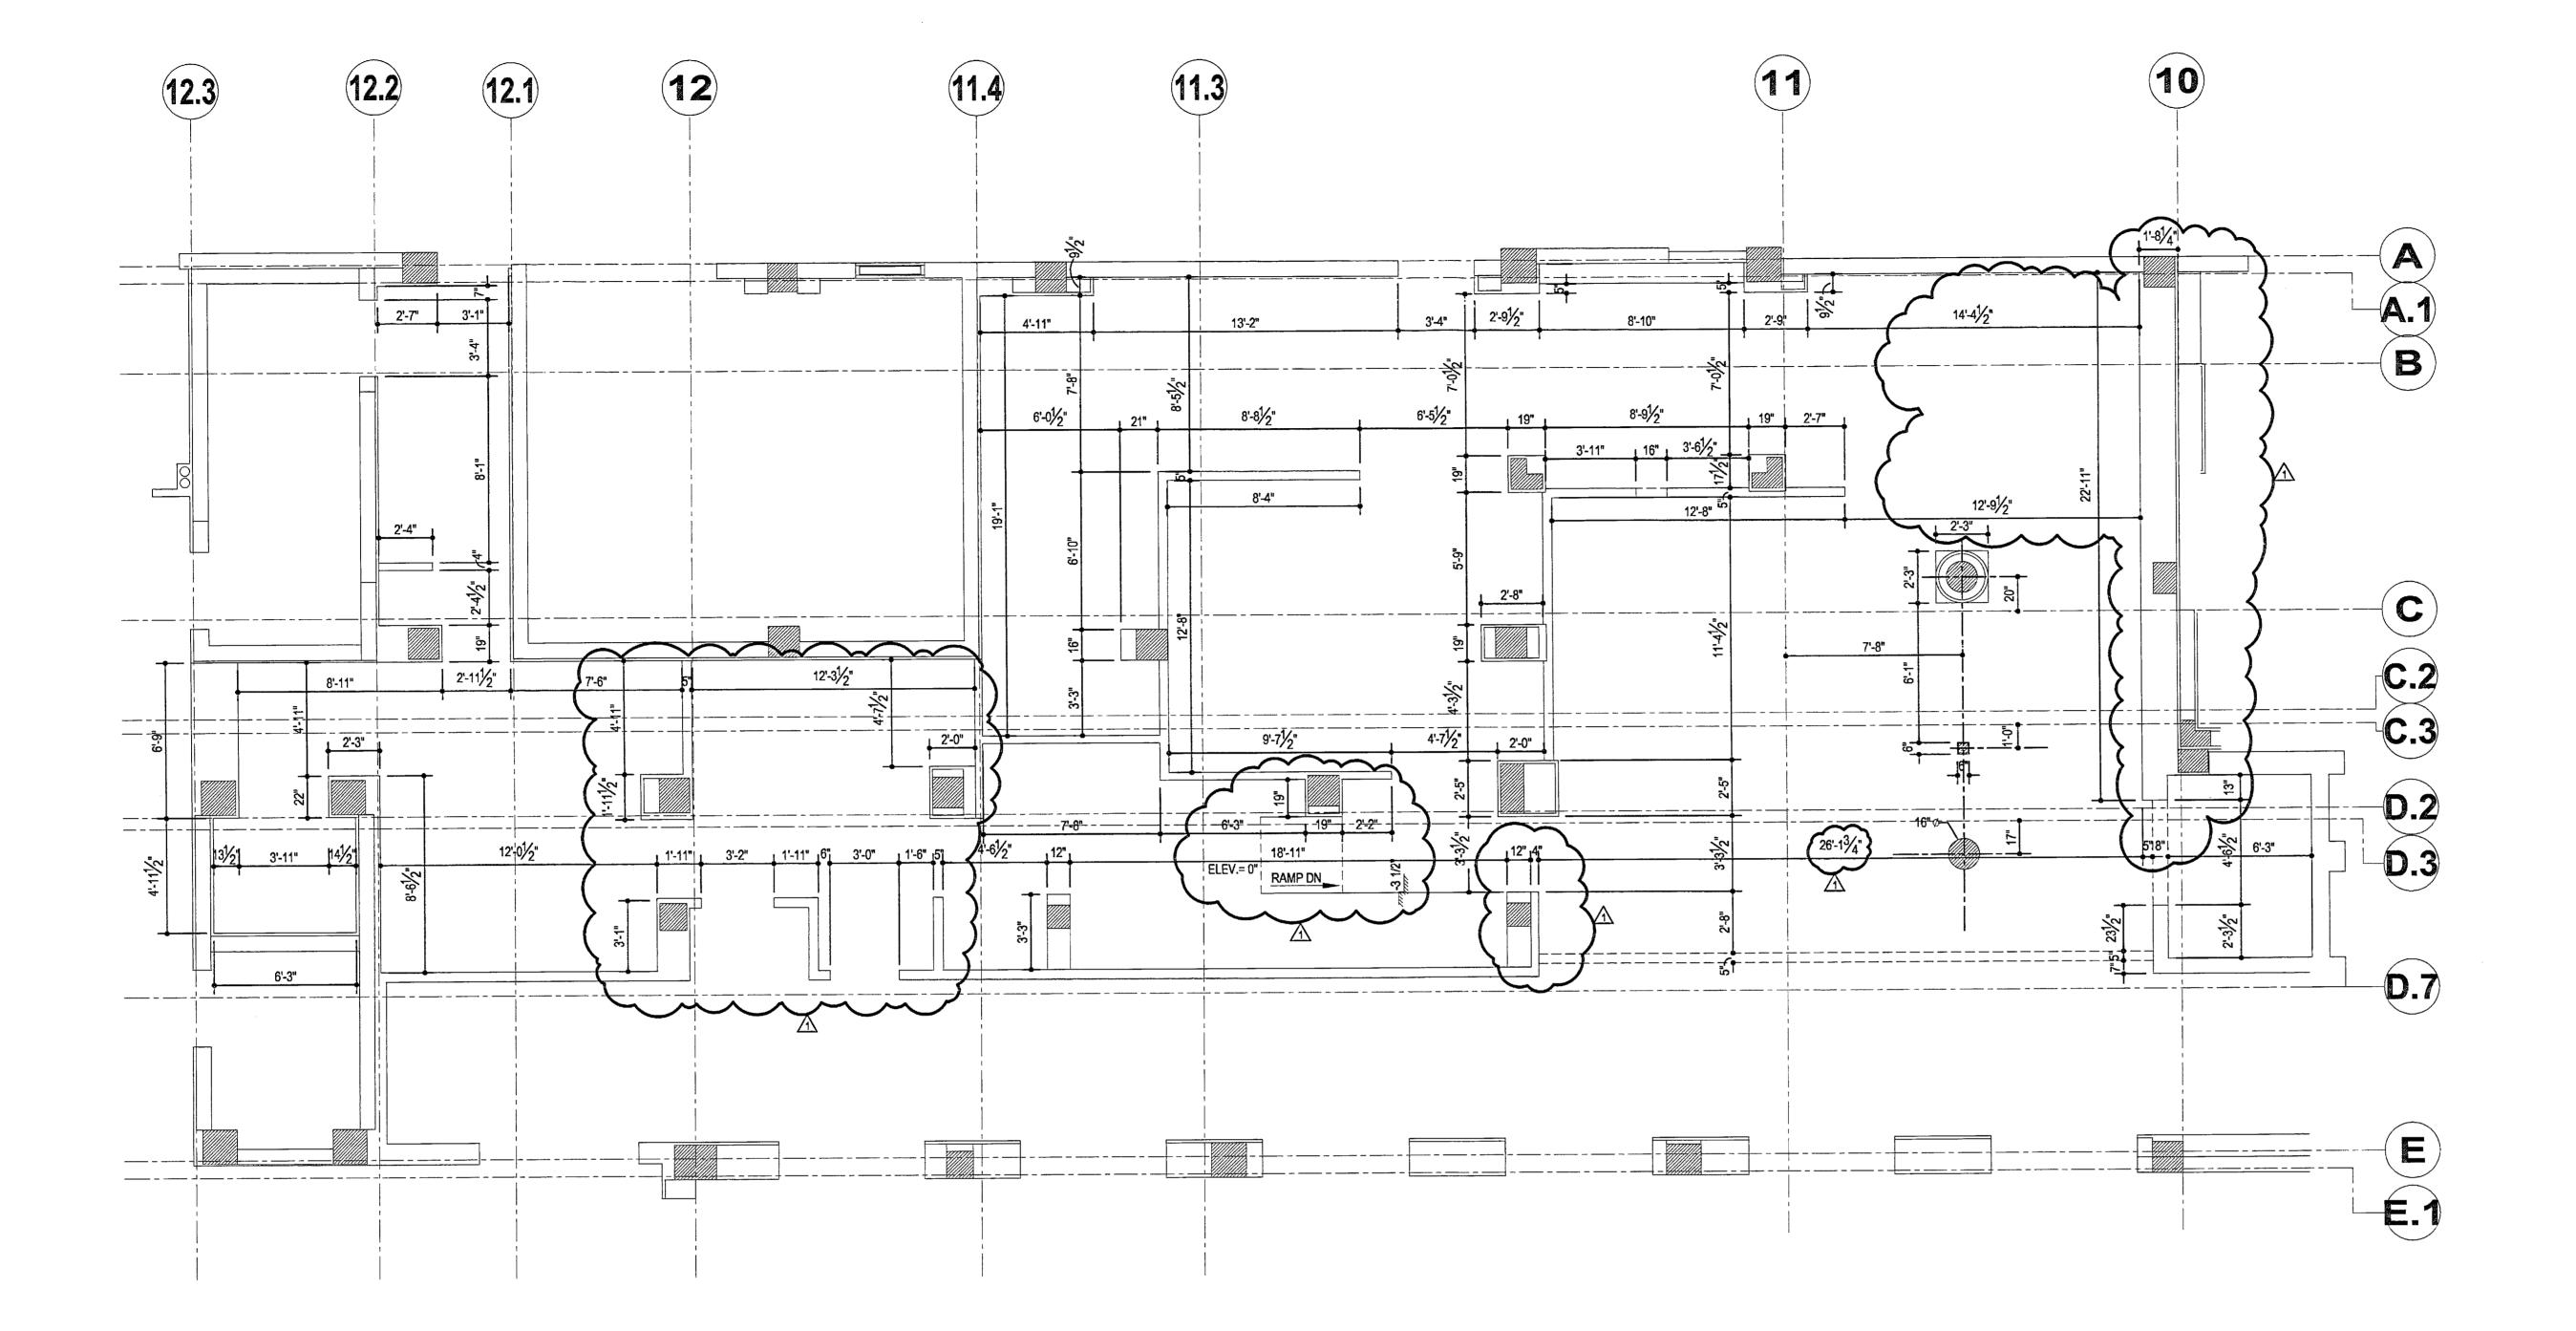






CHECKED BY: JM

DATE: - 06-26-2009

SCALE: 1/4" =1'-0"

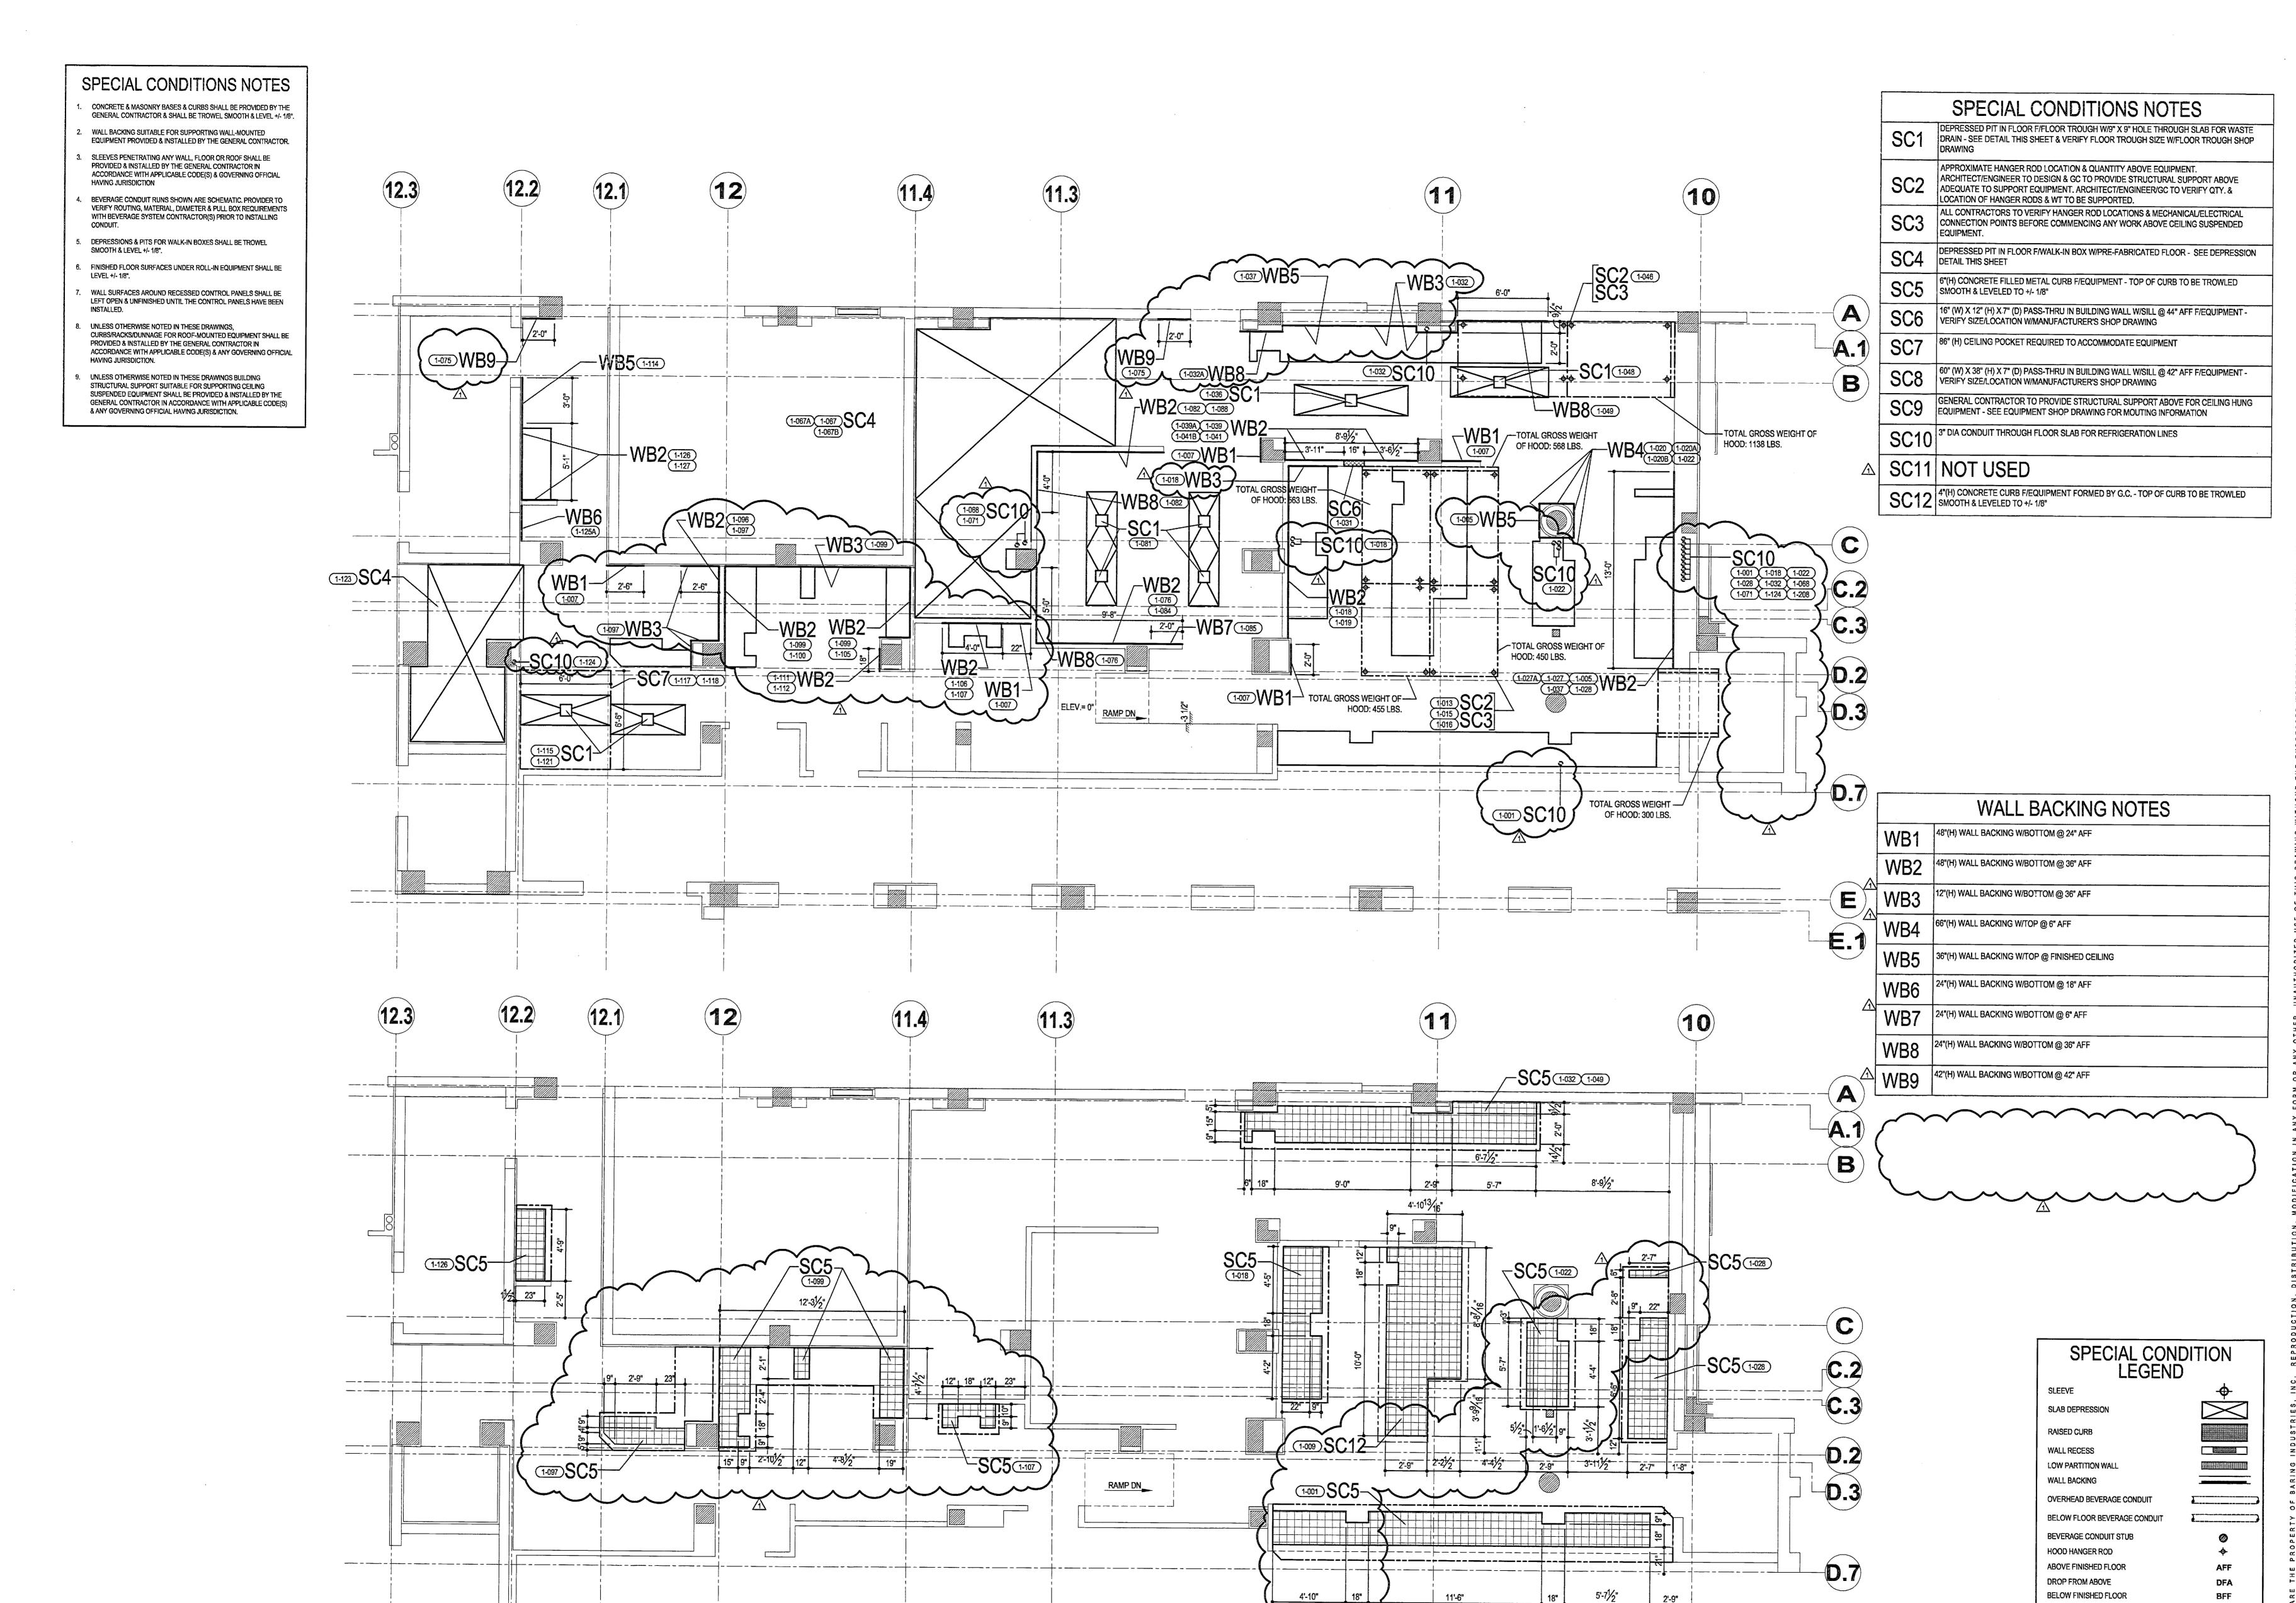



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FAX (630) 620-1120 Western Regional Office 11411 Southern Highlands Parkway Las Vegas, NV 89141 USA TELEPHONE (702) 385- 4416

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MIAMI BEACH

FLORIDA

REVISION: BY: CK BY: DATE: ST JM 08-26-2003

PROJ. MGR: FRANK MURPHY COORDINATOR: PATRICIA TEPPER TELEPHONE: 954-327-6720 DRAWN BY: ST CHECKED BY: JM DATE: - 06-26-2009

SCALE: 1/4" =1'-0"



- UTILITIES SHOWN ARE THE MINIMUM REQUIRED FOR THE FOODSERVICE EQUIPMENT. LOCATION, QUANTITY & SIZE OF ADDITIONAL UTILITIES, IF DESIRED/REQUIRED, ARE TO BE PROVIDED BY OTHERS.
- 2. FINAL CONNECTIONS TO EQUIPMENT, INTER-CONNECTIONS BETWEEN COMPONENTS & INSTALLING DRAINS/FAUCETS ARE INCLUDED IN THE PLUMBING CONTRACTOR'S SCOPE OF WORK.
- 3. UNLESS OTHERWISE NOTED IN THESE DRAWINGS, COMPONENTS SUCH AS (BUT NOT LIMITED TO) PIPE, TRAPS, VALVES, WATER HAMMER ARRESTORS, PRESSURE REDUCING VALVES, PRESSURE REGULATING VALVES & GUAGES SHALL BE PROVIDED & INSTALLED BY THE PLUMBING CONTRACTOR.
- UNLESS OTHERWISE NOTED IN THESE DRAWINGS OR AS RESTRICTED BY CODE, UTILITIES SHALL BE CONCEALED IN & STUBBED OUT OF BUILDING WALLS.
- 5. COMPONENTS SUCH AS (BUT NOT LIMITED TO) TRAPS, VALVES, WATER HAMMER ARRESTORS, PRESSURE REDUCING VALVES, PRESSURE REGULATING VALVES & GUAGES SHALL BE LOCATED SO THAT THEY DO NOT INTERFERE WITH THE OPERATION OF THE EQUIPMENT.
- 6. UNLESS OTHERWISE NOTED IN THESE DRAWINGS, WATER PRESSURE AT CONNECTION POINTS ON THE EQUIPMENT SHALL NOT EXCEED:
- A. 25 PSI FOR DISHMACHINES & WATER BOOSTER HEATERSB. 50 PSI FOR ALL OTHER EQUIPMENT

REQUIREMENTS.

POINT ON THE EQUIPMENT.

- & SHALL COMPLY WITH THE MANUFACTUER'S WATER FLOW
- UNLESS OTHERWISE NOTED IN THESE DRAWINGS, HOT WATER SUPPLY TO DISH & WAREWASHING EQUIPMENT & WATER BOOSTER HEATERS SHALL BE 120 DEG F (+/- 5 DEG F) AT THE CONNECTION
- THE PLUMBING CONTRACTOR SHALL PROVIDE A WATER HAMMER ARRESTOR AT ALL WATER HEATERS AND DISHMACHINE/WATER BOOSTER HEATER LOCATIONS.

DEVICES AS REQUIRED BY APPLICABLE CODE(S) AND GOVERNING

- 9. UNLESS OTHERWISE NOTED IN THESE DRAWINGS, THE PLUMBING
 CONTRACTOR SHALL PROVIDE & INSTALL BACKFLOW PREVENTION
- OFFICIALS HAVING JURISDICTION.

 10. EXPOSED PORTIONS OF CHILLED/COOLING WATER & HOT WATER
- 11. GAS, STEAM & WATER PIPING SHALL BE BE PRESSURE TESTED, FLUSHED FREE OF FOREIGN MATTER & LINE STRAINERS CLEANED BY THE PLUMBING CONTRACTOR PRIOR TO CONNECTION TO THE EQUIPMENT.

PIPING SHALL BE INSULATED BY THE PLUMBING CONTRACTOR.

ACCESSIBLE & COVER(S) REMOVED WITHOUT INTERFEREING IN THE OPERATION OF THE EQUIPMENT OR WITH ANY ELECTRICAL, MECHANICAL OR PLUMBING UTILITY.

2. GREASE TRAPS ARE TO BE LOCATED & INSTALLED SO THEY ARE

- 13. CONDENSATE DRAIN PIPING SHALL BE TRAPPED OUTSIDE OF THE REFRIGERATED COMPARTMENT & EXTENDED TO AN INDIRECT BUILDING WASTE DRAIN.
- 14. CONDENSATE DRAIN PIPING FROM WALK-IN EVAPORATOR COILS SHALL BE PROVIDED, INSTALLED & INSULATED BY THE PLUMBING
- 15. UNLESS OTHERWISE NOTED IN THESE DRAWINGS, CONDENSATE DRAIN PIPING FROM REFRIGERATED EQUIPMENT NOT EQUIPPED WITH A CONDENSATE EVAPORATOR SHALL BE PROVIDED & INSTALLED BY

THE PLUMBING CONTRACTOR.


- 16. DRAIN PIPING FROM WASTE DISPOSAL EQUIPMENT SUCH AS DISPOSERS/PULPERS SHALL BE PROVIDED WITH CLEAN-OUT FITTINGS.
 17. PLUMBING CONTRACTOR TO PROVIDE & INSTALL A MAIN FUEL GAS
- GOVERNING OFFICIAL HAVING JURISDICTION.

 18. UNLESS OTHERWISE NOTED IN THESE DRAWINGS, FUEL GAS
- SOLENOID SHUT-OFF VALVE(S) FOR FOODSERVICE EQUIPMENT PROVIDED BY BARING ARE PROVIDED BY BARING & INSTALLED BY THE PLUMBING CONTRACTOR.

20. BARING INDUSTRIES RECOMMENDS THAT FUEL GAS SERVICE BE

- UNLESS PERMITTED BY APPLICABLE CODE(S) FUEL GAS PIPING TO PILOT BURNERS ON EQUIPMENT SHALL SHALL NOT BY-PASS A FUEL GAS SOLENOID SHUT-OFF VALVE.
- PROVIDED VIA A LOOPED DISTRIBUTION SYSTEM. THE SIZE OF THE LOOP SHALL BE DETERMINED BY THE PROJECT ARCHITECT/ENGINEER.

 21. DRAIN PIPING FROM ANY EQUIPMENT USING/GENERATING STEAM
- SHALL BE OF MATERIALS & UTILIZING INSTALLATION METHODS TO ACCOMMODATE TEMPERATURES ABOVE 212 DEG F.
- 22. BARING INDUSTRIES RECOMMENDS THAT STEAM SUPPLY & CONDENSATE RETURN BE PROVIDED VIA LOOPED SYSTEMS. THE SIZE OF THE LOOPS SHALL BE DETERMINED BY THE PROJECT
- 23. BARING INDUSTRIES RECOMMENDS THAT CHILLED/COOLING WATER SUPPLY & RETURNS BE PROVIDED VIA LOOPED SYSTEMS. THE SIZE OF THE LOOPS SHALL BE DETERMINED BY THE PROJECT ARCHITECT/ENGINEER.

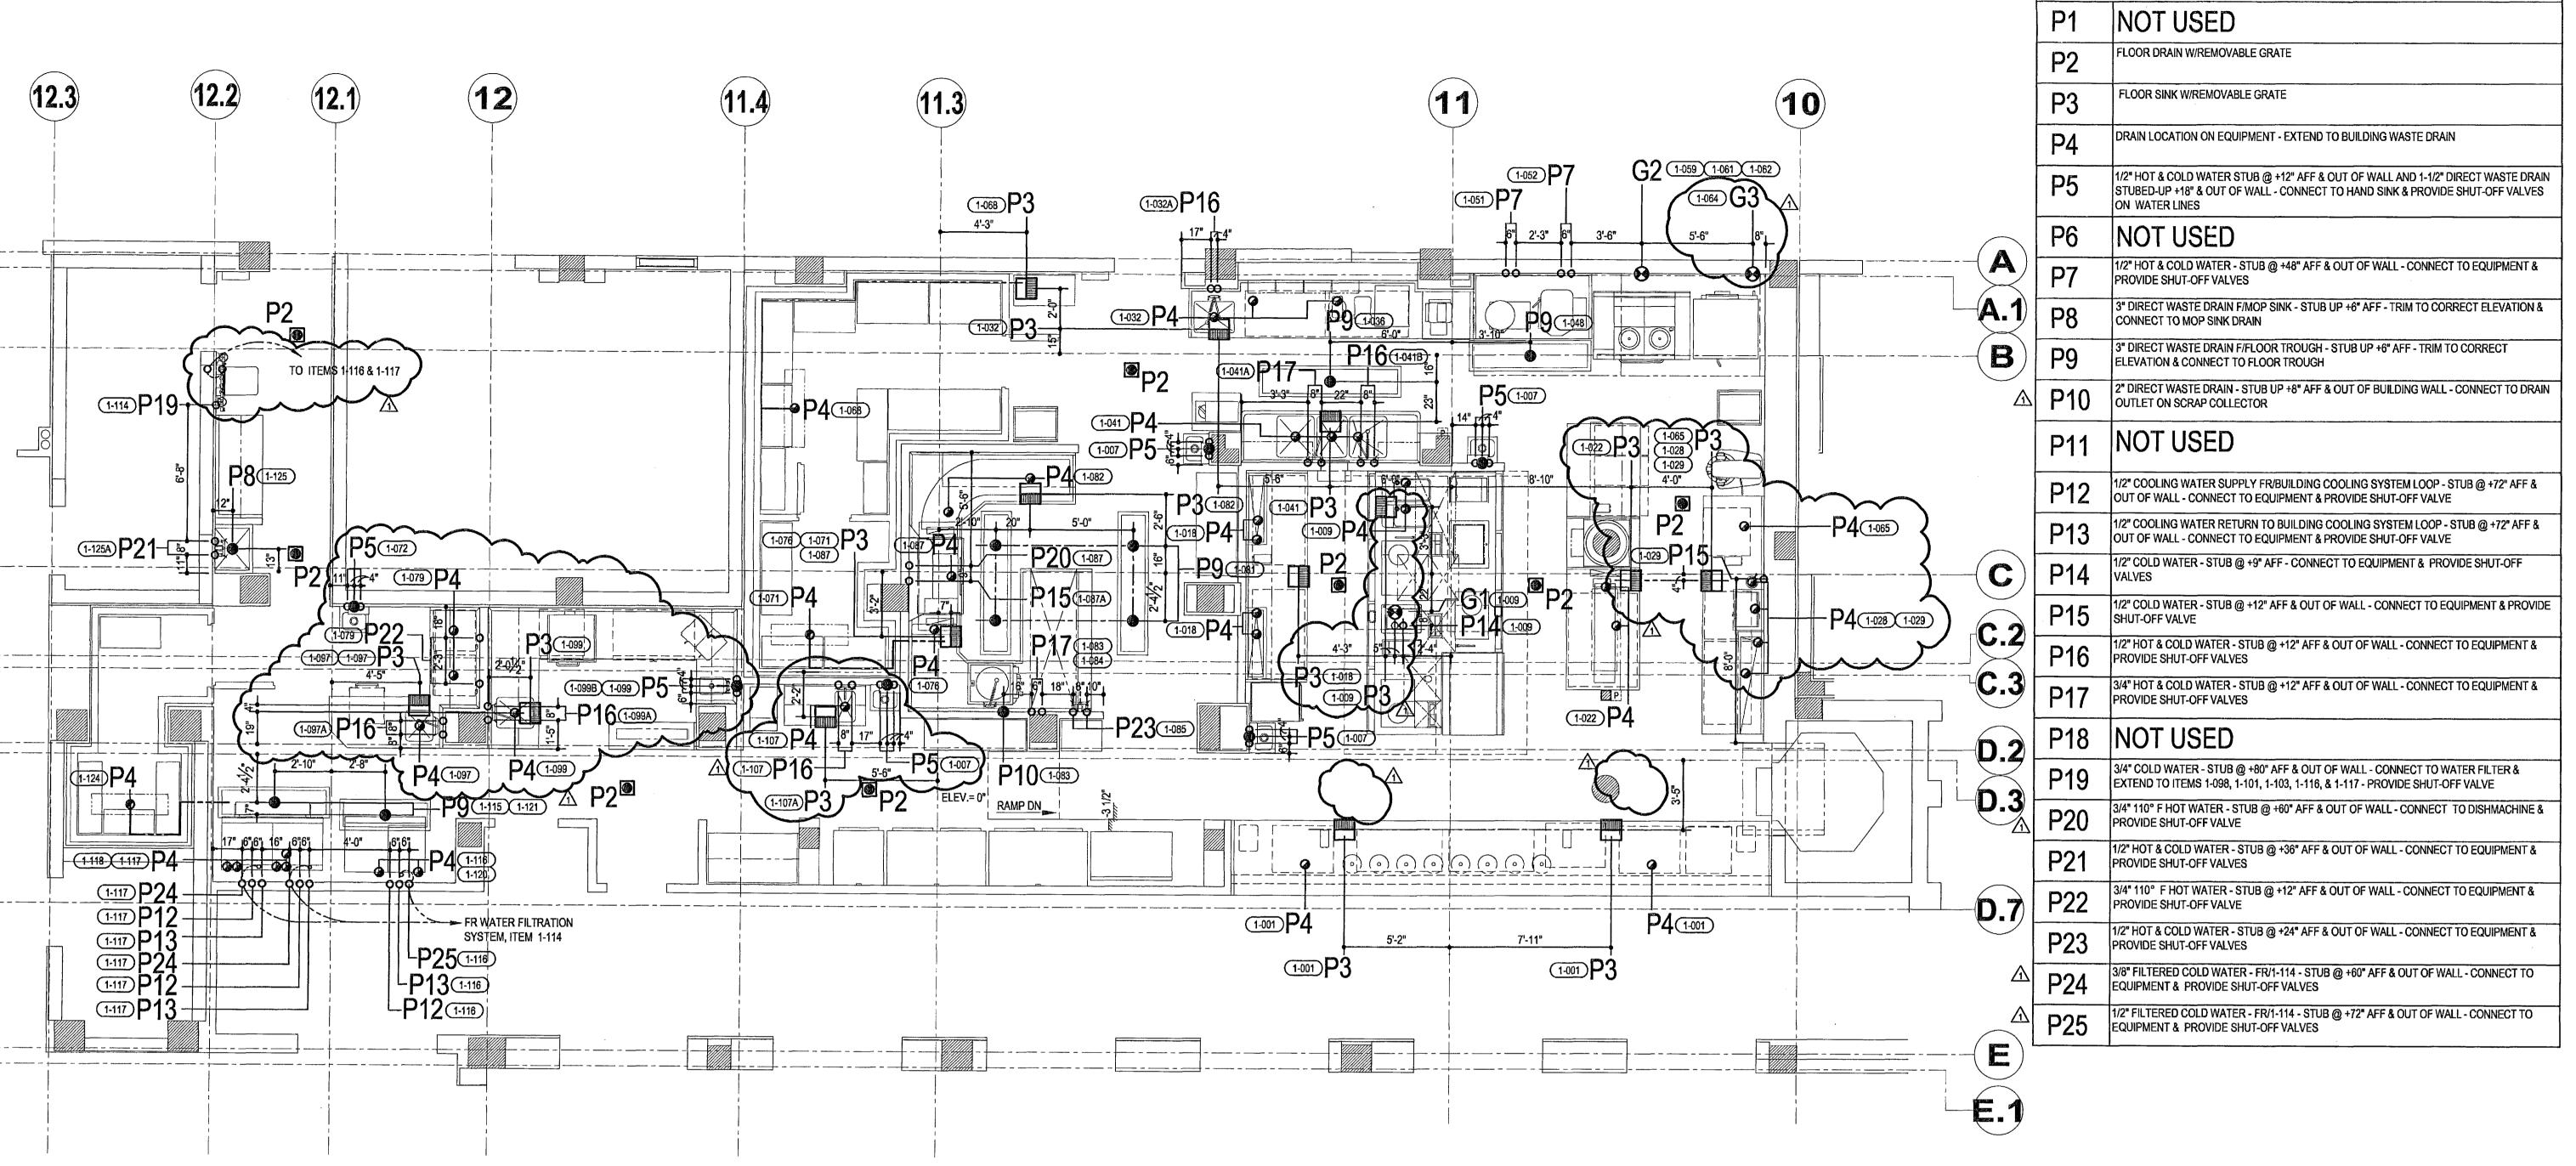



GAS ROUGH-IN SCHEDULE

1"NATURAL GAS - STUB @ +24" AFF & OUT OF BUILDING WALL - CONNECT TO EQUIPMENT THROUGH PRESSURE REGULATOR & FLEXIBLE GAS LINE W/QUICK

REGULATOR & PROVIDE SHUT-OFF

DISCONNECT- PROVIDE SHUT-OFF

1 1/4" NATURAL GAS - STUB @ +12" AFF - CONNECT TO EQUIPMENT THROUGH PRESSURE

1/2" NATURAL GAS - STUB @ +24" AFF & OUT OF BUILDING WALL - CONNECT TO EQUIPMENT THROUGH PRESSURE REGULATOR & FLEXIBLE GAS LINE W/QUICK DISCONNECT & PROVIDE

PLUMBING ROUGH-IN SCHEDULE

COLD WATER CW HOT WATER HW COOLING WATER SUPPLY CWS CWR COOLING WATER RETURN BUILDING DIRECT WASTE DRAIN DW 🚳 INDIRECT WASTE DRAIN LOCATION IW 🍎 ON EQUIPMENT HUB DRAIN/AIR GAP DRAIN HD/AGD 💿 FLOOR DRAIN FUNNEL-TYPE FLOOR DRAIN FTFD FLOOR SINK FS STEAM SUPPLY CONDENSATE RETURN CR 0 GAS COMPRESSED AIR CA ABOVE FINISH FLOOR AFF DROP FROM ABOVE DFA BELOW FINISH FLOOR BFF DONREDSANIE CORMONAPING PIPING _____





PROJ. MGR: FRANK MURPHY

TELEPHONE: 954-327-6720

DRAWN BY: ST

CHECKED BY: JM

DATE: - 06-26-2009

SCALE: 1/4" =1'-0"

PROJECT NUMBER

COORDINATOR: PATRICIA TEPPER

REFRIGERATION & VENTILATION NOTES

- 1. SLEEVES PENETRATING ANY WALL, FLOOR OR ROOF SHALL BE PROVIDED & INSTALLED BY THE GENERAL CONTRACTOR IN ACCORDANCE WITH APPLICABLE CODE(S) & ANY GOVERNING OFFICIAL
- HAVING JURISDICTION.


 REFRIGERATION LINE RUNS SHOWN ARE SCHEMATIC. ACTUAL ROUTING TO BE DETERMINED BY JOB SITE CONDITIONS,


REFRIGERATION SYSTEM INSTALLER & THE GENERAL CONTRACTOR.

- 3. UNLESS OTHERWISE NOTED IN THESE DRAWINGS, CURBS/RACKS/DUNNAGE FOR ROOF-MOUNTED EQUIPMENT SHALL BE PROVIDED & INSTALLED BY THE GENERAL CONTRACTOR IN ACCORDANCE WITH APPLICABLE CODE(S) & ANY GOVERNING OFFICIAL HAVING JURISDICTION.
- 4. UNLESS OTHERWISE NOTED IN THESE DRAWINGS, EXHAUST VENTILATORS SHALL BE HUNG WITH THE BOTTOM OF THE VENTILATOR @ 80° AFF.
- HVAC CONTRACTOR SHALL MAKE CONNECTIONS BETWEEN EXHAUST VENTILATORS & DUCT WORK FULLY WELDED & LIQUID TIGHT.
- VENTILATORS & DUCT WORK FULLY WELDED & LIQUID TIGHT.

 HVAC CONTRACTOR SHALL PROVIDE & INSTALL DUCTWORK, FANS &
- CURBS REQUIRED FOR A COMPLETE & FUNCTIONING SYSTEM.

 SYSTEM START-UP & AIR BALANCE IS INCLUDED IN THE HVAC
 CONTRACTOR'S SCOPE OF WORK.

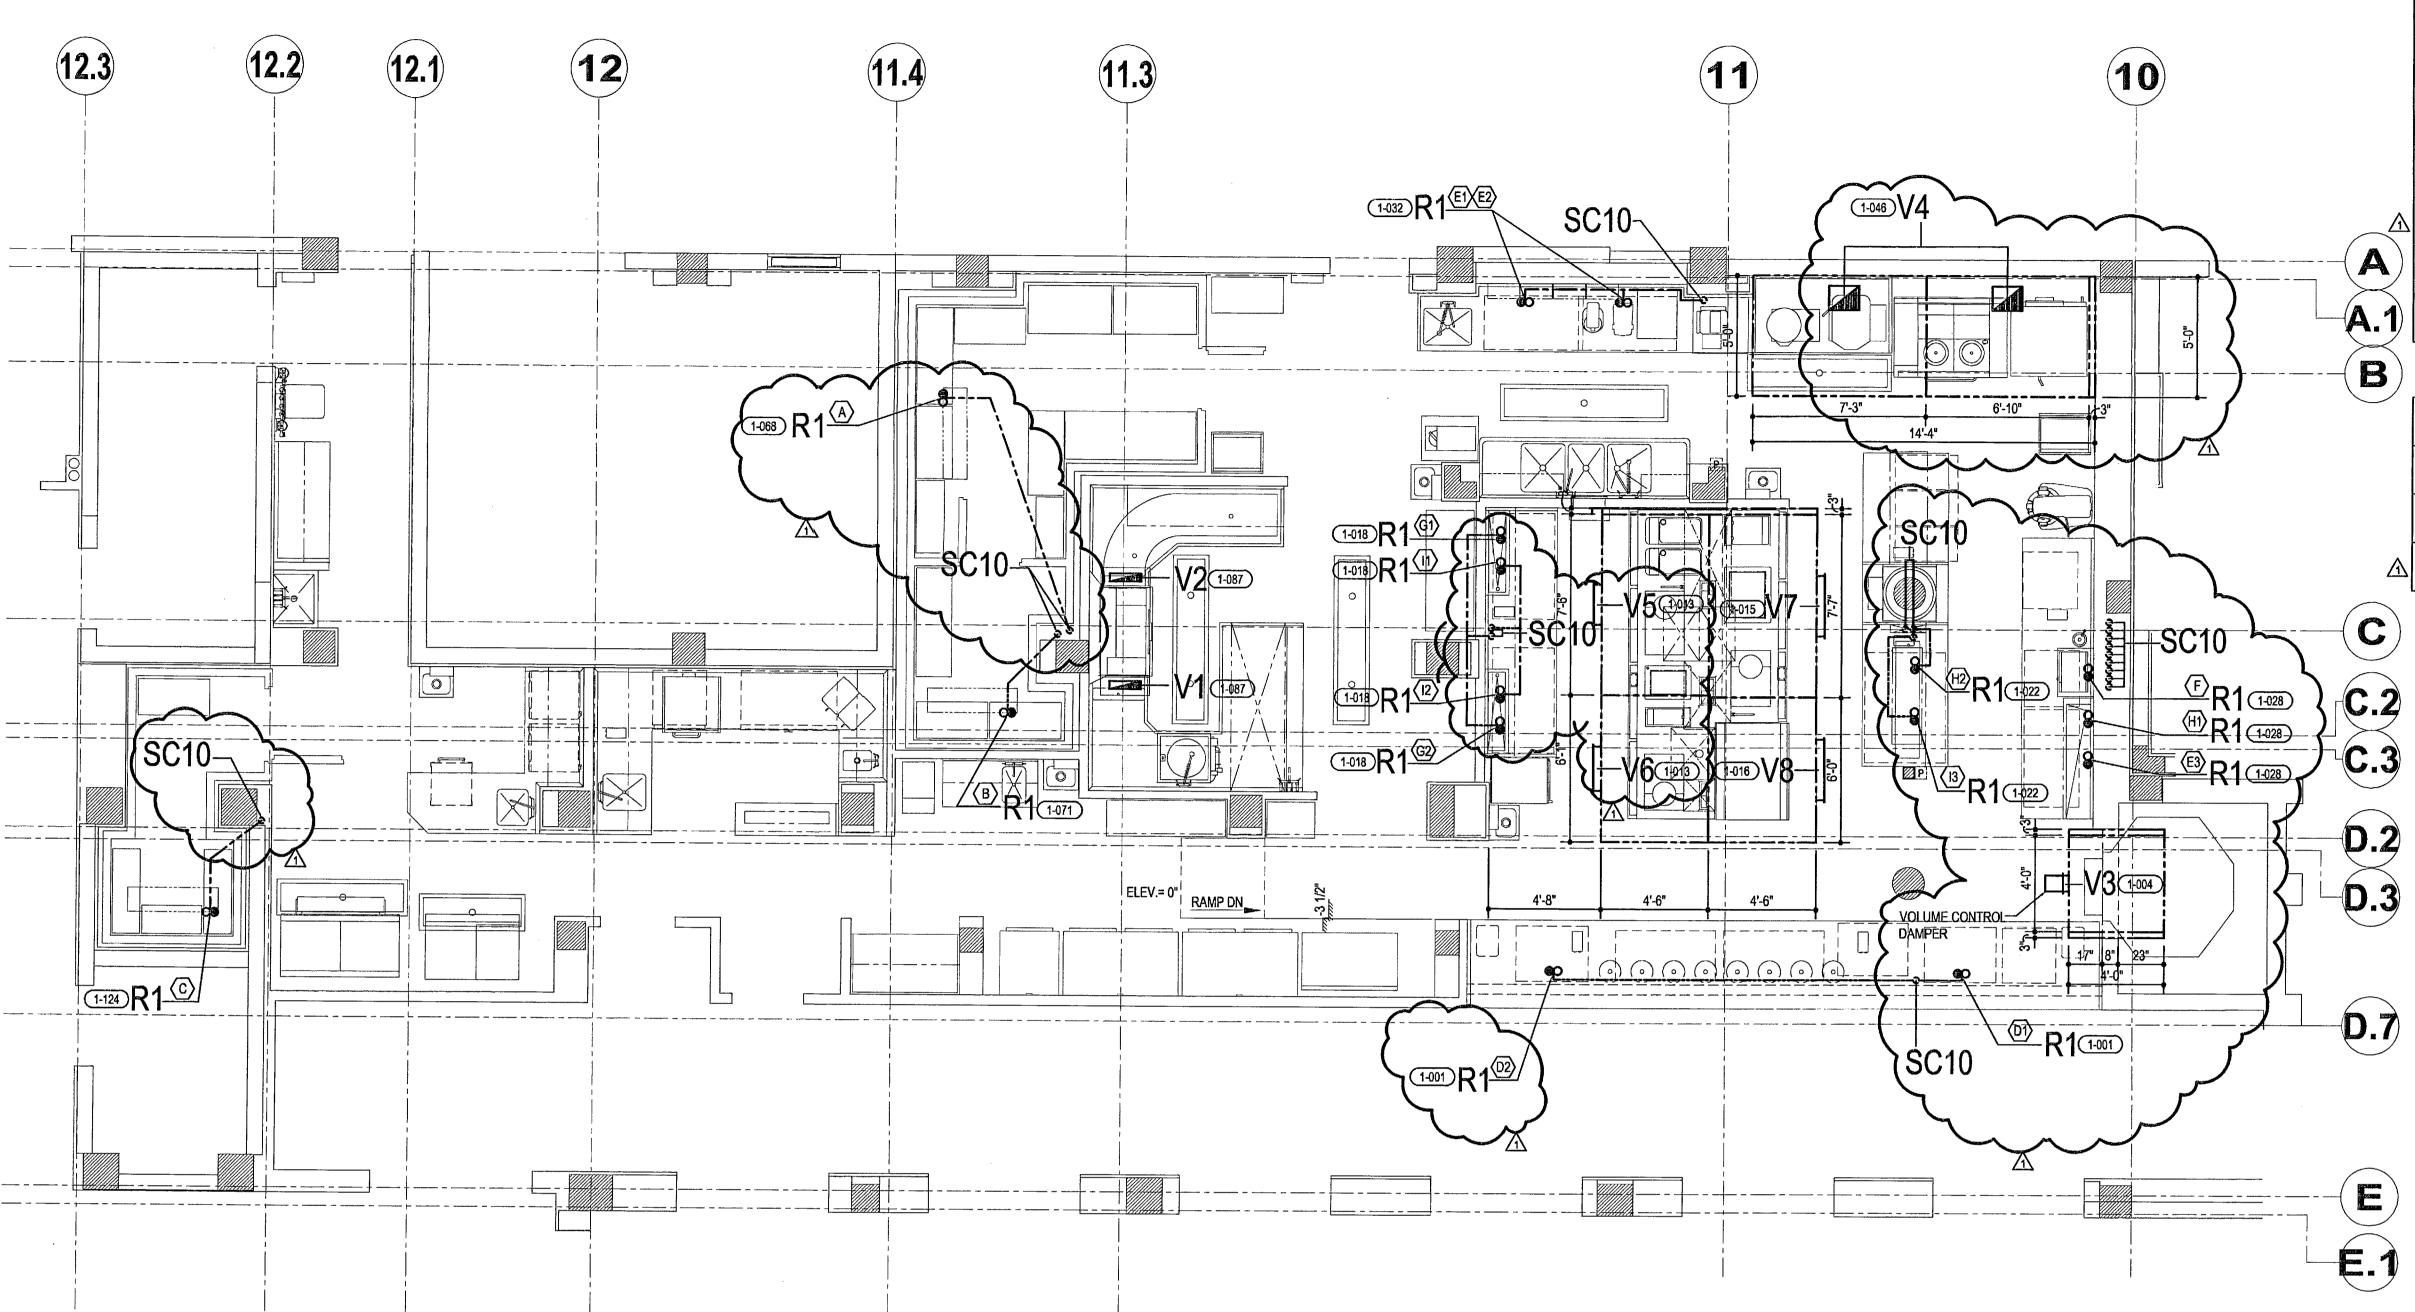

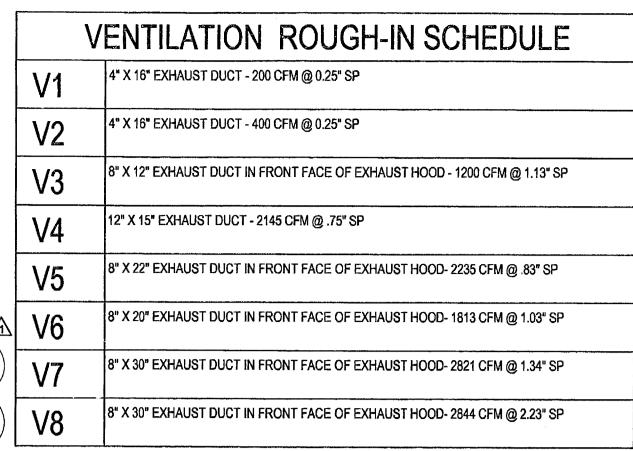

F		ROUGH-IN SCHEDULE
21	LIQUID & SUCTION REFRIGERATION RACK	ON LINES BETWEEN THE EQUIPMENT & REMOTE

SC10 3" DIA SLEEVE THROUGH FLOOR SLAB F/REFRIGERATION LINES

△ SC11 NOT USED

REFRIGERATION LEGEND

LIQUID & SUCTION LINES

OVERHEAD REFRIGERATION LINES

BELOW FLOOR REFRIGERATION LINES

INSIDE EQUIPMENT REFRIGERATION LINES

ABOVE FINISHED FLOOR

DROP FROM ABOVE

BELOW FINISHED FLOOR

DFA

BELOW FINISHED FLOOR

BFF

VENTILATION LEGEND

EXHAUST DUCT

SUPPLY DUCT

STATIC PRESSURE, WATER GAUGE

CUBIC FEET/MINUTE

ABOVE FINISHED FLOOR

COMMANDE SPWG

CFM

AFF



BARING INDUSTRIES

A Division of Electrolux Professional, Inc.

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MI BEACH, FLORIDA

REVISION: BY: CK BY: DATE:

ST JM 08-26-2009

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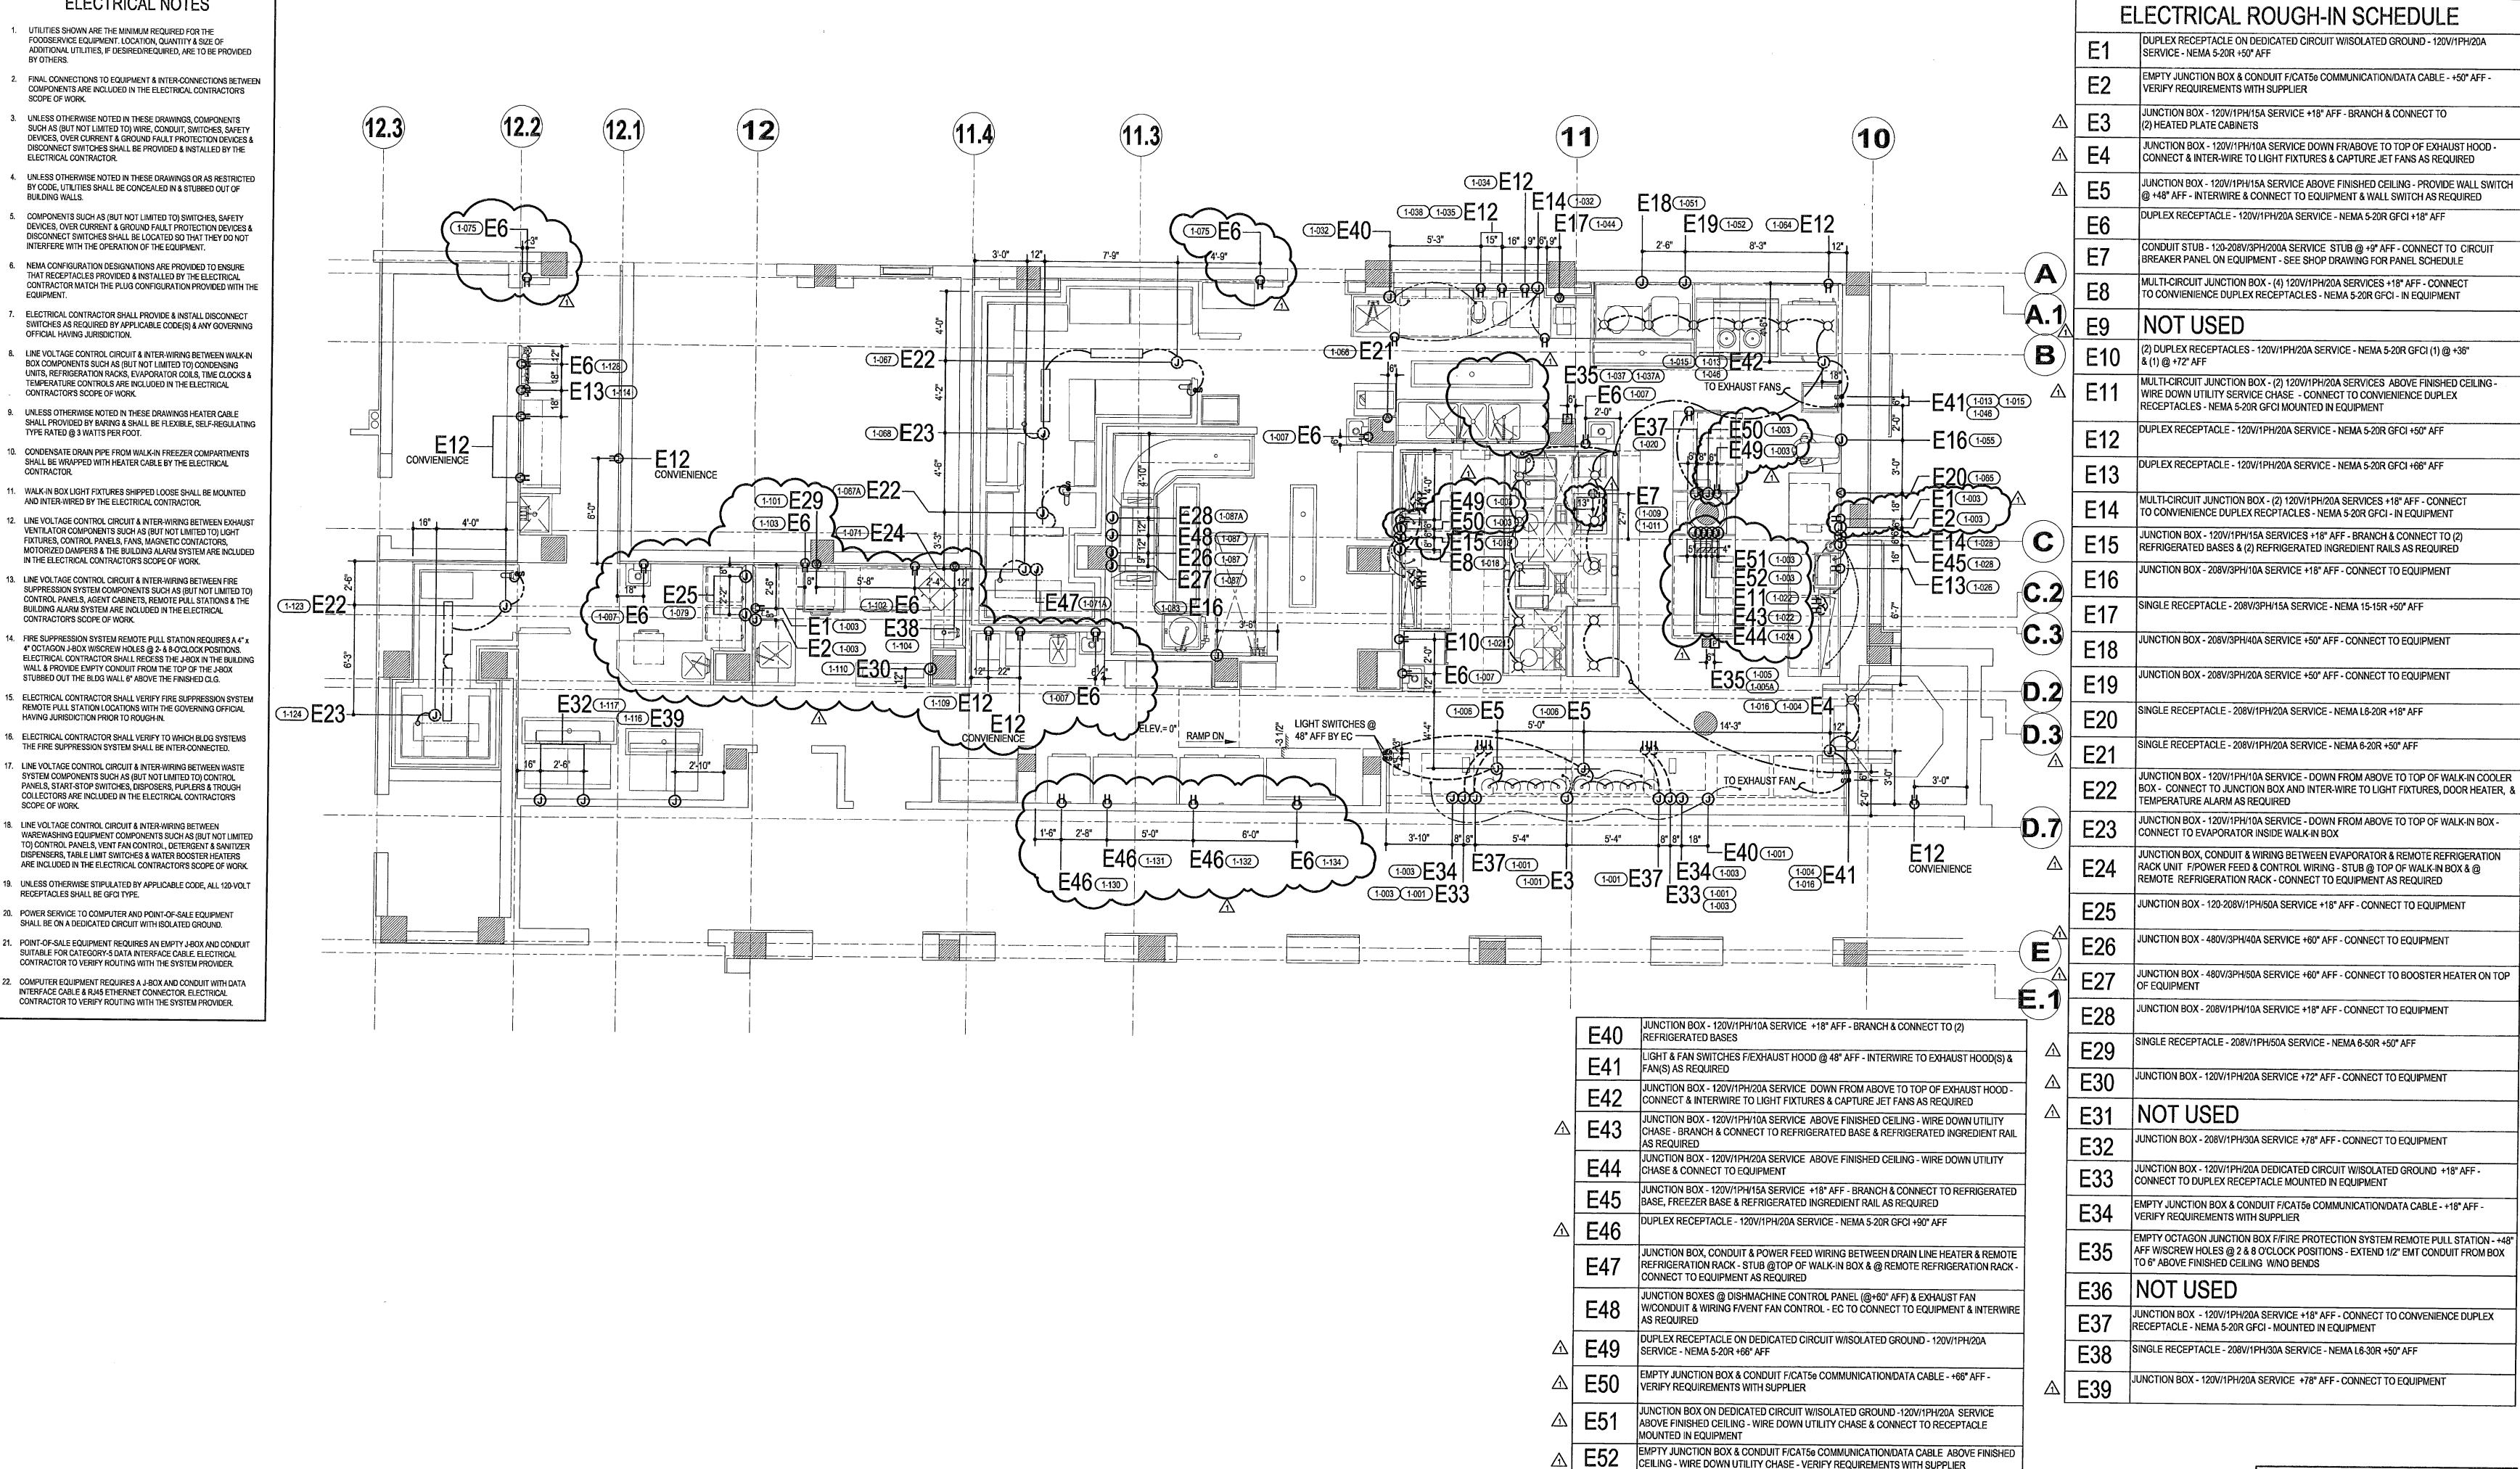
ROJ. MGR: FRANK MURPHY

PROJ. MGR: FRANK MURPHY
COORDINATOR: PATRICIA TEPPER
TELEPHONE: 954-327-6720
DRAWN BY: ST
CHECKED BY: JM
DATE: - 06-26-2009

K1-7

SCALE: 1/4" =1'-0"

PROJECT NUMBER 07115



ELECTRICAL LEGEND SINGLE RECEPTACLE, NEMA 5-20R DUPLEX RECEPTACLE, NEMA 5-20R DR QUADRAPLEX RECEPTACLE, NEMA 5-20R SPECIAL RECEPTACLE, 208 OR 480 FLOOR RECEPTACLE FR REVISION: BY: CK BY: DATE: JUNCTION BOX DROP CORD OR CONDUIT CONDUIT STUB WALL SWITCH RECEPTACLE ON EQUIPMENT FIRE PROTECTION SYSTEM REMOTE PULL STATION INCANDESCENT LIGHT FIXTURE FLUORESCENT LIGHT FIXTURE LOAD CENTER IN EQUIPMENT 2000 BUILDING LOAD CENTER PANEL POINT OF CONNECTION ON EQUIPMENT

BARING INDUSTRIES

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Northeastern Regional Office

Mideastern Regional Office

Midwestern Regional Office

Western Regional Office

11411 Southern Highlands Parkway

 $\overline{\mathbf{m}}$

ST JM 08-26-2009

PROJ. MGR: FRANK MURPHY

TELEPHONE: 954-327-6720

K1-8

DRAWN BY: ST CHECKED BY: JM DATE: - 06-26-2009 SCALE: 1/4" =1'-0"

COORDINATOR: PATRICIA TEPPER

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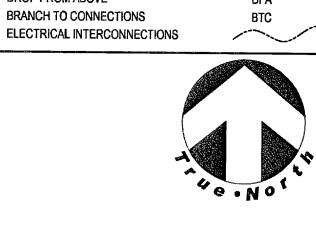
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FAX: (954) 327-6781

Baring Industries



ABOVE FINISHED FLOOR

DROP FROM ABOVE

GENERAL NOTES

- REFER TO THE PROJECT ARCHITECTURAL, ELECTRICAL, INTERIOR DESIGN, MECHANICAL & PLUMBING DRAWINGS FOR ACTUAL CONSTRUCTION CONDITIONS & DETAILS.
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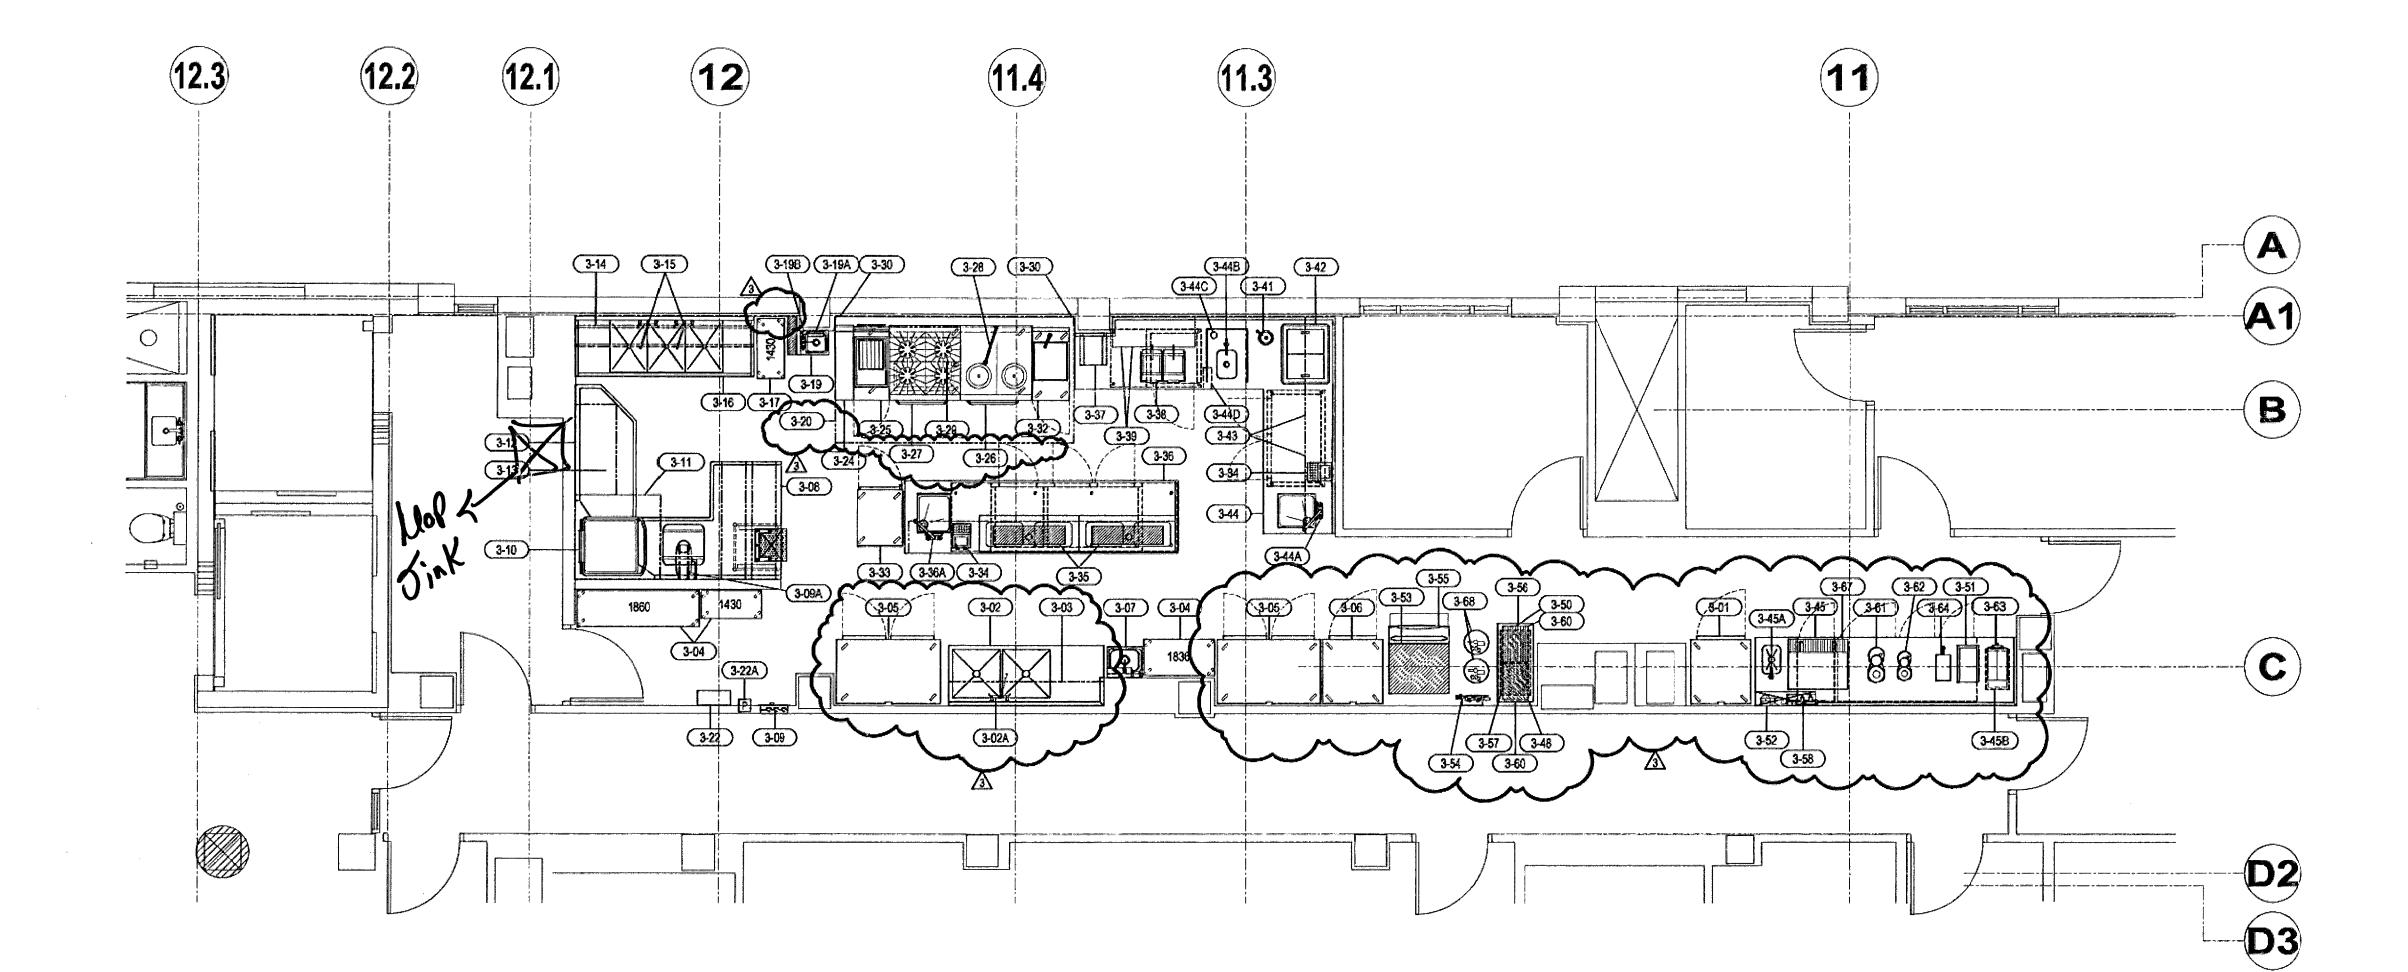
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FOREIGN MATTER.

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PROJ. MGR: FRANK MURPHY COORDINATOR: PATRICIA TEPPER TELEPHONE: 954-327-6720 DRAWN BY: ST CHECKED BY: JM DATE: 02-27-2009

SCALE: 1/4" =1'-0"

K3-2



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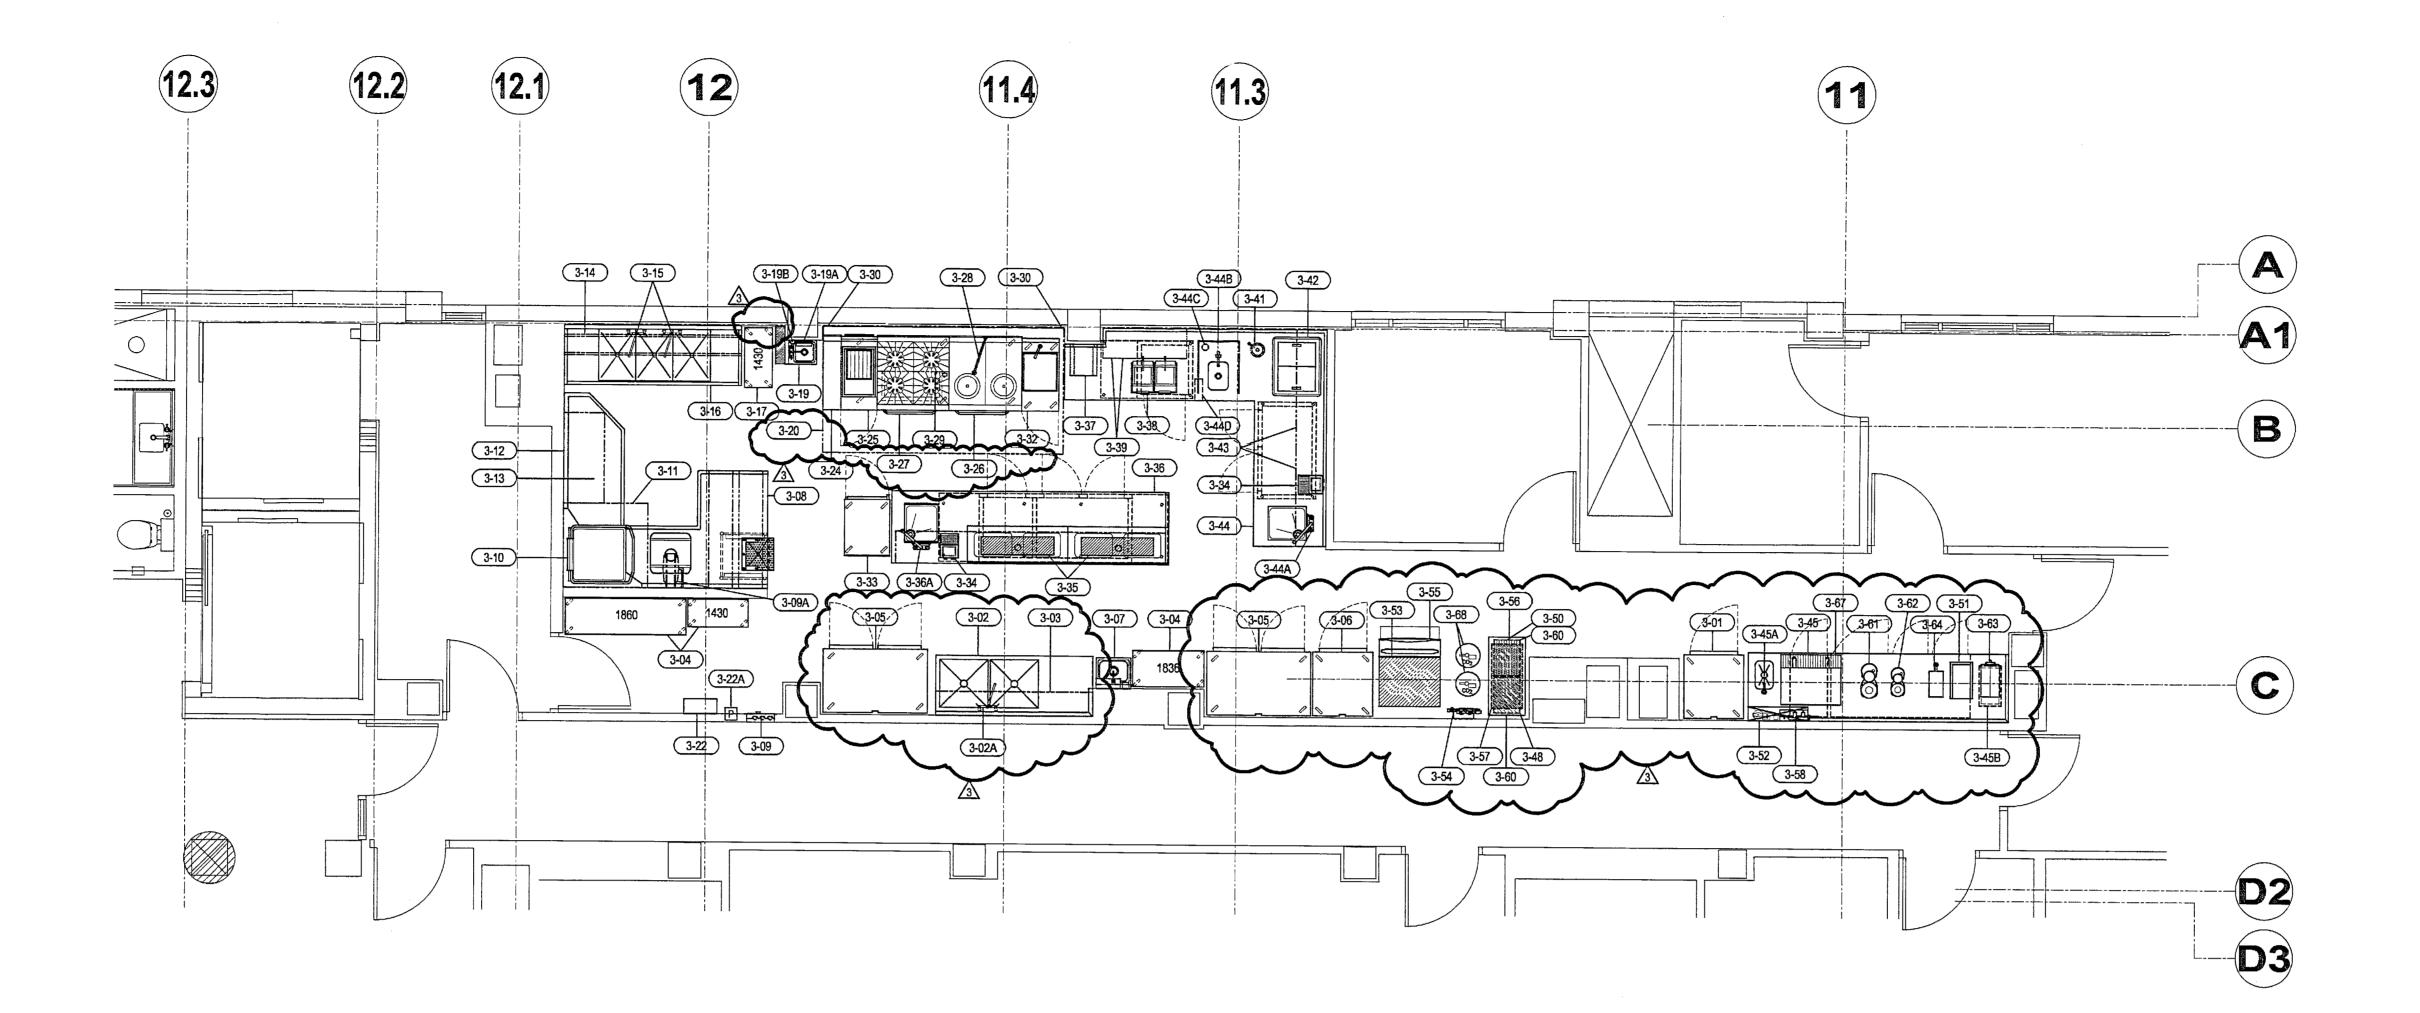
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BY ACID BASED CLEANING/ETCHING AGENTS ARE NOT COVERED

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- E. WALL FINISHES INSTALLED ON EXPOSED WALL SURFACES. F. ELECTRICAL WIRING PULLED TO ROUGH-IN LOCATIONS SHOWN IN
- THESE DRAWINGS. G. PLUMBING PIPING INSTALLED TO ROUGH-IN LOCATIONS SHOWN IN
- THESE DRAWINGS. H. GAS, STEAM & WATER PIPING PRESSURE TESTED & FLUSHED FREE OF FOREIGN MATTER.





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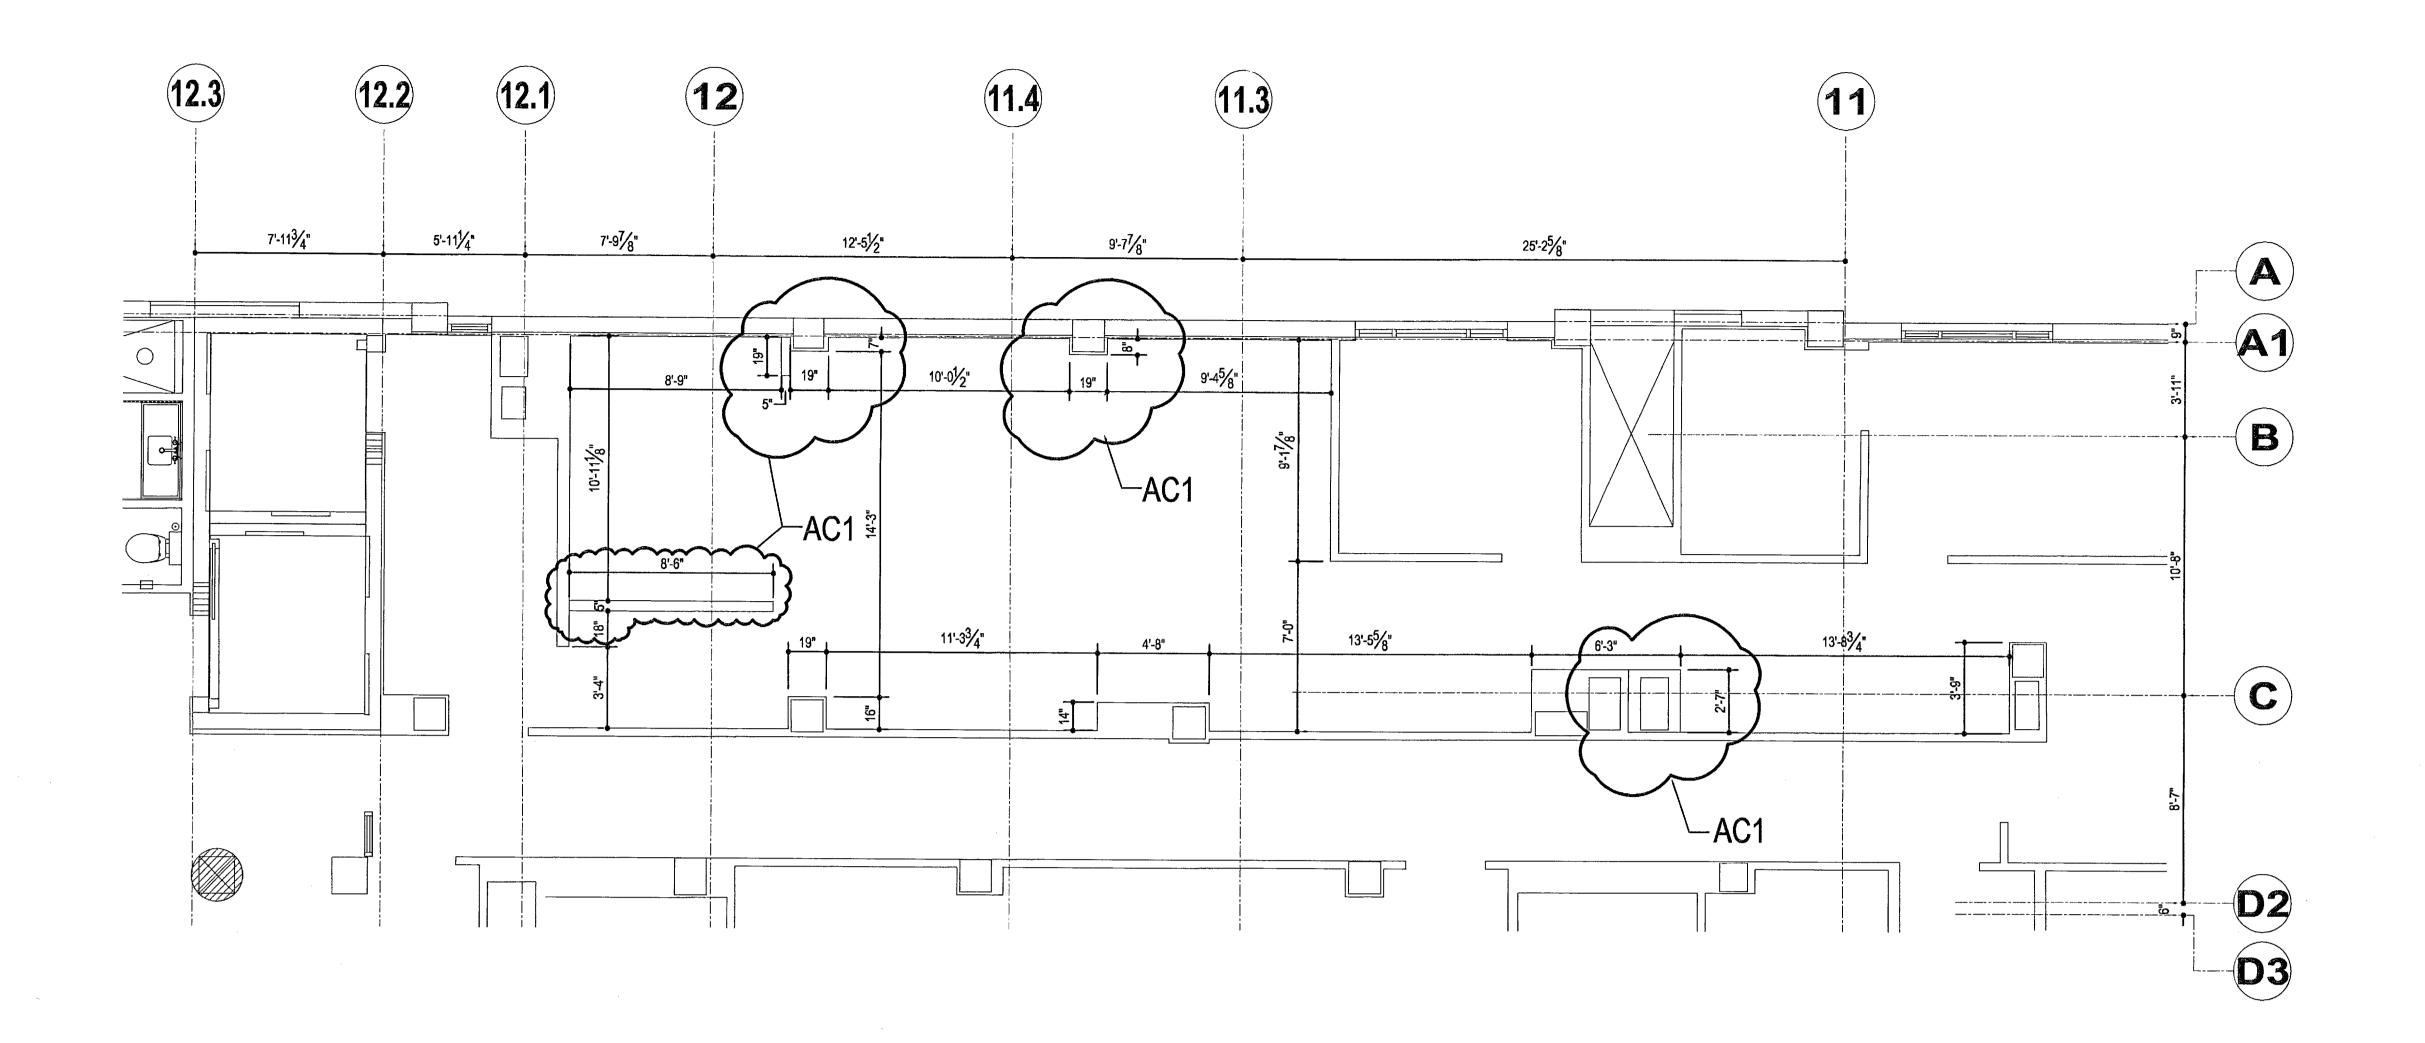
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PROJ. MGR: FRANK MURPHY COORDINATOR: PATRICIA TEPPER TELEPHONE: 954-327-6720 DRAWN BY: ST

SCALE: 1/4" =1'-0"

CHECKED BY: JM DATE: 02-27-2009





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ARCHITECTURAL NOTES AC1

BUILDING WALLS IN THIS AREA VARY FROM THE ARCHITECTURAL DRAWINGS TO ACCOMMODATE THE FOODSERVICE EQUIPMENT



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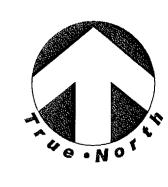
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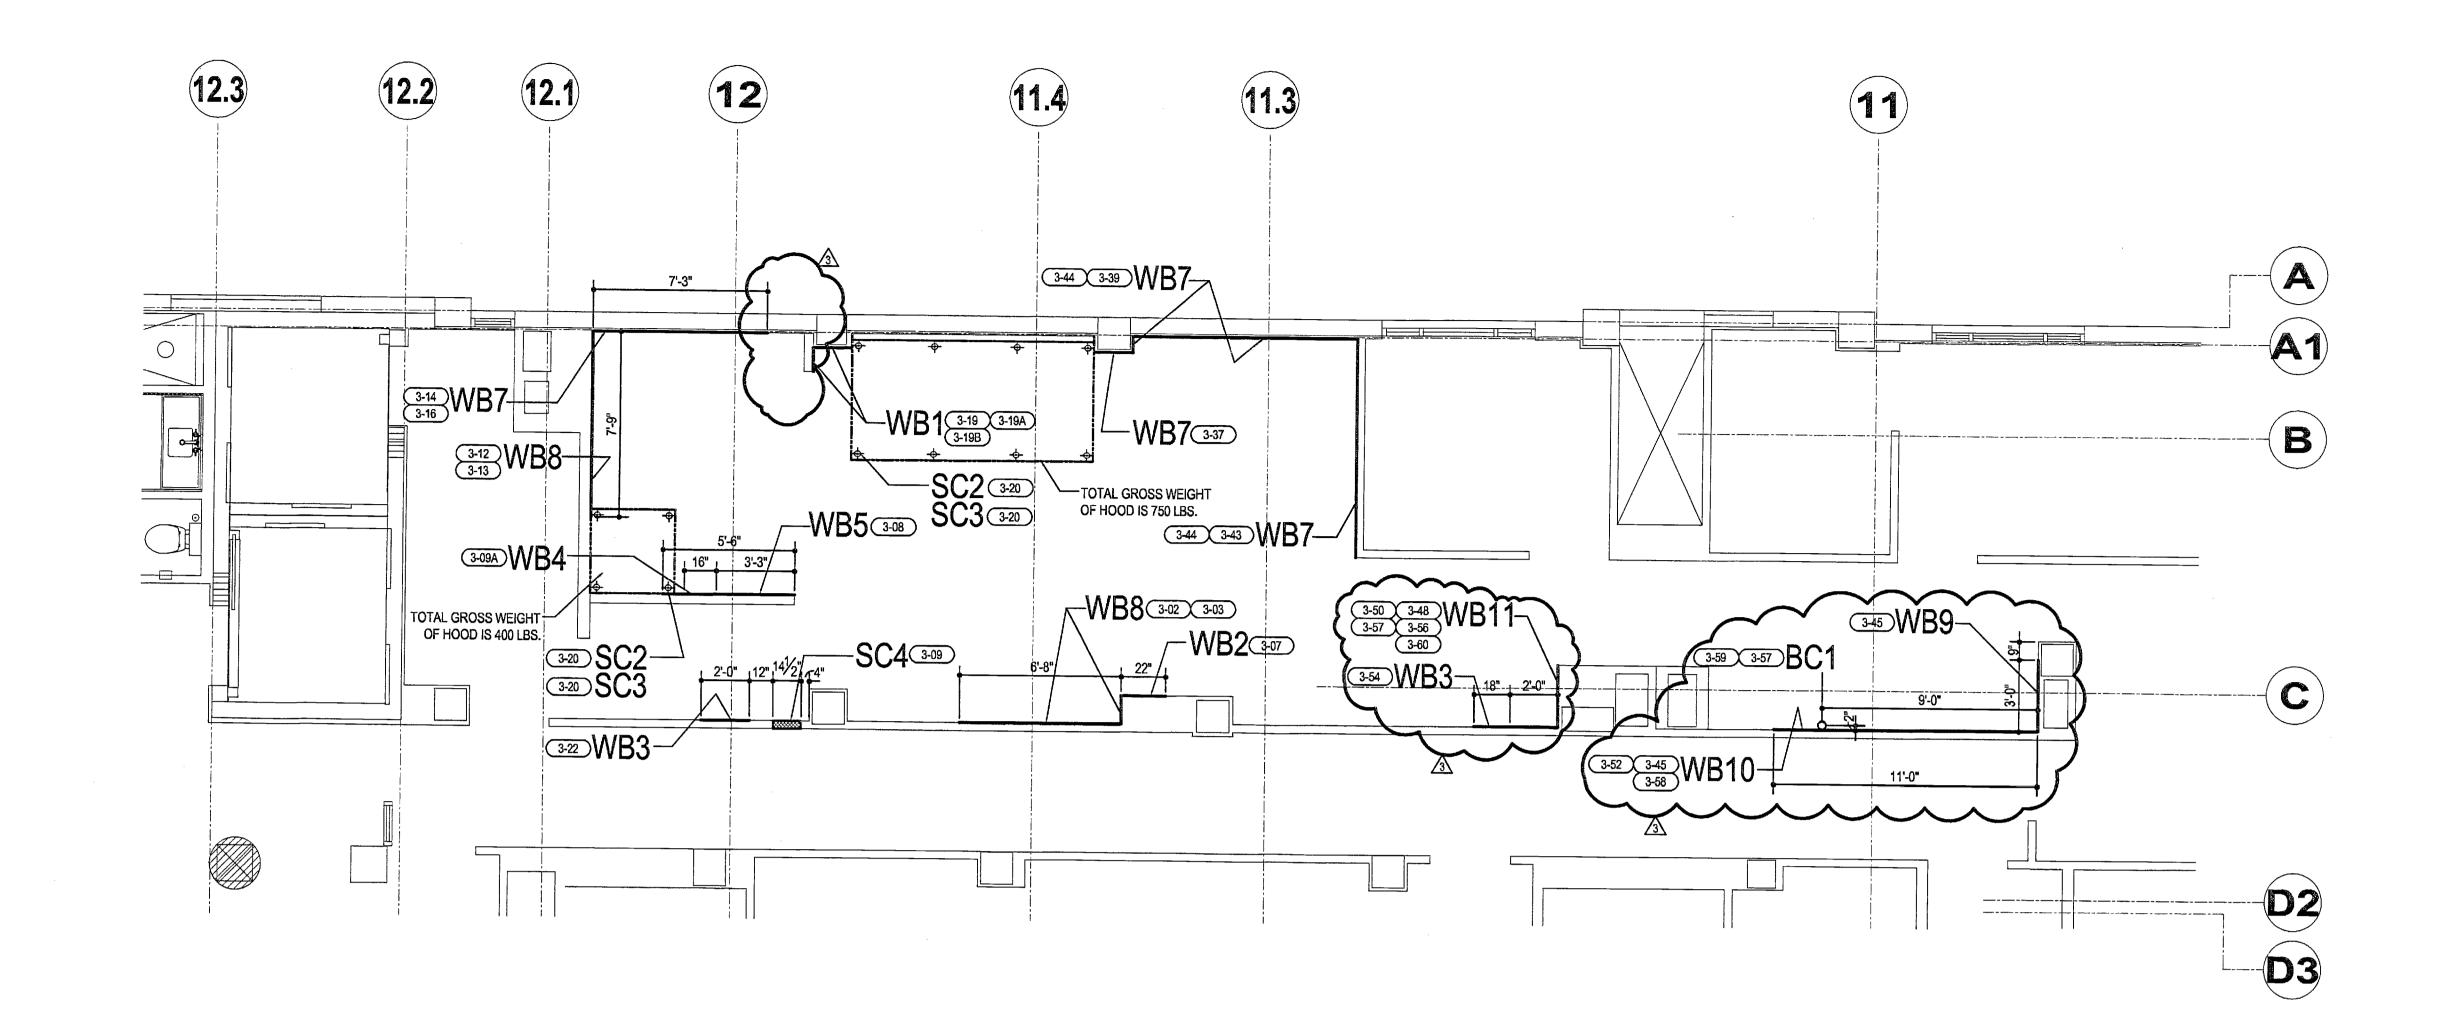
PROJ. MGR: FRANK MURPHY COORDINATOR: PATRICIA TEPPER TELEPHONE: 954-327-6720 DRAWN BY: ST CHECKED BY: JM

DATE: 02-27-2009 SCALE: 1/4" =1'-0"



SPECIAL CONDITIONS NOTES

- CONCRETE & MASONRY BASES & CURBS SHALL BE PROVIDED BY THE GENERAL CONTRACTOR & SHALL BE TROWEL SMOOTH & LEVEL +/- 1/8".
- 2. WALL BACKING SUITABLE FOR SUPPORTING WALL-MOUNTED EQUIPMENT PROVIDED & INSTALLED BY THE GENERAL CONTRACTOR.
- 3. SLEEVES PENETRATING ANY WALL, FLOOR OR ROOF SHALL BE PROVIDED & INSTALLED BY THE GENERAL CONTRACTOR IN ACCORDANCE WITH APPLICABLE CODE(S) & GOVERNING OFFICIAL HAVING JURISDICTION
- 4. BEVERAGE CONDUIT RUNS SHOWN ARE SCHEMATIC. PROVIDER TO VERIFY ROUTING, MATERIAL, DIAMETER & PULL BOX REQUIREMENTS WITH BEVERAGE SYSTEM CONTRACTOR(S) PRIOR TO INSTALLING
- 5. DEPRESSIONS & PITS FOR WALK-IN BOXES SHALL BE TROWEL SMOOTH & LEVEL +/- 1/8".
- 6. FINISHED FLOOR SURFACES UNDER ROLL-IN EQUIPMENT SHALL BE LEVEL +/- 1/8".
- WALL SURFACES AROUND RECESSED CONTROL PANELS SHALL BE LEFT OPEN & UNFINISHED UNTIL THE CONTROL PANELS HAVE BEEN INSTALLED.
- 8. UNLESS OTHERWISE NOTED IN THESE DRAWINGS, CURBS/RACKS/DUNNAGE FOR ROOF-MOUNTED EQUIPMENT SHALL BE PROVIDED & INSTALLED BY THE GENERAL CONTRACTOR IN ACCORDANCE WITH APPLICABLE CODE(S) & ANY GOVERNING OFFICIAL HAVING JURISDICTION.
- UNLESS OTHERWISE NOTED IN THESE DRAWINGS BUILDING
 STRUCTURAL SUPPORT SUITABLE FOR SUPPORTING CEILING
 SUSPENDED EQUIPMENT SHALL BE PROVIDED & INSTALLED BY THE
 GENERAL CONTRACTOR IN ACCORDANCE WITH APPLICABLE CODE(S)
 & ANY GOVERNING OFFICIAL HAVING JURISDICTION.





BEVERAGE CONDUIT ROUGH-IN SCHEDULE

ALUMINUM BEVERAGE CONDUIT ABOVE CEILING - STUB DOWN 6" BELOW FINISHED CEILING -FLOOR SLAB AND WALL PENETRATIONS SHALL BE SEALED WITH A ULLISTED FIRESTOP ASSEMBLY.

	SPECIAL CONDITIONS NOTES
SC1	NOT USED
SC2	APPROXIMATE HANGER ROD LOCATION & QUANTITY ABOVE EQUIPMENT. ARCHITECT/ENGINEER TO DESIGN & GC TO PROVIDE STRUCTURAL SUPPORT ABOVE ADEQUATE TO SUPPORT EQUIPMENT. ARCHITECT/ENGINEER/GC TO VERIFY QTY. & LOCATION OF HANGER RODS & WT TO BE SUPPORTED.
SC3	ALL CONTRACTORS TO VERIFY HANGER ROD LOCATIONS & MECHANICAL/ELECTRICAL CONNECTION POINTS BEFORE COMMENCING ANY WORK ABOVE CEILING SUSPENDED EQUIPMENT.
SC4	14 1/2" (W) X 20" (H) X 4" (D) RECESS IN BUILDING WALL W/SILL @ 48" AFF F/EQUIPMENT - DO NOT CLOSE OR FINISH BUILDING WALL UNTIL EQUIPMENT INSTALLATION IS COMPLETE

		WALL BACKING NOTES						
	WB1 48"(H) WALL BACKING W/BOTTOM @ 24" AFF							
	WB2	36"(H) WALL BACKING W/BOTTOM @ 24" AFF						
	WB3	24"(H) WALL BACKING W/TOP @ FINISHED CEILING						
	WB4	24"(H) WALL BACKING W/BOTTOM @ 70" AFF						
	WB5	9"(H) WALL BACKING W/BOTTOM @ 36" AFF & 36" (H) WALL BACKING W/BOTTOM @ 48"AFF						
<u> </u>	WB6	NOT USED						
	WB7	9"(H) WALL BACKING W/BOTTOM @ 36" AFF & 36"(H) WALL BACKING W/BOTTOM @ 54" AFF						
	WB8	9"(H) WALL BACKING W/BOTTOM @ 36" AFF & 24"(H) WALL BACKING W/BOTTOM @ 54" AFF						
3	WB9	18"(H) WALL BACKING W/BOTTOM @ 30" AFF						
<u> </u>	WB10	56"(H) WALL BACKING W/TOP @ FINISHED CEILING						
<u> </u>	WB11	WALL BACKING W/BOTTOM @ 6" AFF & TOP @ 6" ABOVE FINISHED CEILING						

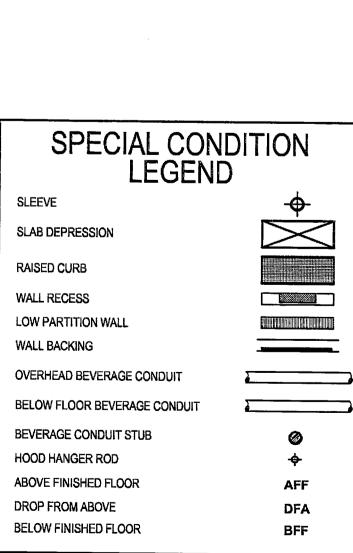

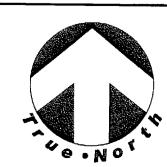



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SOHOHOLOSE
MIAMI BEACH, FLORIDA
SEVENTH FLOOR

ROJECT LOCATION

CIAL CONDITIONS PLAN

PROJ. MGR: FRANK MURPHY
COORDINATOR: PATRICIA TEPPER
TELEPHONE: 954-327-6720
DRAWN BY: ST

DRAWN BY: ST

CHECKED BY: JM

DATE: 02-27-2009

SCALE: 1/4" =1'-0"

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PLUMBING NOTES

- UTILITIES SHOWN ARE THE MINIMUM REQUIRED FOR THE FOODSERVICE EQUIPMENT. LOCATION, QUANTITY & SIZE OF ADDITIONAL UTILITIES, IF DESIRED/REQUIRED, ARE TO BE PROVIDED
- . FINAL CONNECTIONS TO EQUIPMENT, INTER-CONNECTIONS BETWEEN COMPONENTS & INSTALLING DRAINS/FAUCETS ARE INCLUDED IN THE

PLUMBING CONTRACTOR'S SCOPE OF WORK

BUILDING WALLS.

- UNLESS OTHERWISE NOTED IN THESE DRAWINGS, COMPONENTS SUCH AS (BUT NOT LIMITED TO) PIPE, TRAPS, VALVES, WATER HAMMER ARRESTORS, PRESSURE REDUCING VALVES, PRESSURE REGULATING VALVES & GAUGES SHALL BE PROVIDED & INSTALLED BY
- THE PLUMBING CONTRACTOR. UNLESS OTHERWISE NOTED IN THESE DRAWINGS OR AS RESTRICTED BY CODE, UTILITIES SHALL BE CONCEALED IN & STUBBED OUT OF
- COMPONENTS SUCH AS (BUT NOT LIMITED TO) TRAPS, VALVES, WATER HAMMER ARRESTORS, PRESSURE REDUCING VALVES, PRESSURE REGULATING VALVES & GAUGES SHALL BE LOCATED SO THAT THEY
- DO NOT INTERFERE WITH THE OPERATION OF THE EQUIPMENT. 6. UNLESS OTHERWISE NOTED IN THESE DRAWINGS, WATER PRESSURE AT CONNECTION POINTS ON THE EQUIPMENT SHALL NOT EXCEED:
- B. 50 PSI FOR ALL OTHER EQUIPMENT

A. 25 PSI FOR DISHMACHINES & WATER BOOSTER HEATERS

- & SHALL COMPLY WITH THE MANUFACTURE'S WATER FLOW REQUIREMENTS. UNLESS OTHERWISE NOTED IN THESE DRAWINGS, HOT WATER
- SUPPLY TO DISH & WAREWASHING EQUIPMENT & WATER BOOSTER HEATERS SHALL BE 120 DEG F (+/- 5 DEG F) AT THE CONNECTION POINT ON THE EQUIPMENT.
- 3. THE PLUMBING CONTRACTOR SHALL PROVIDE A WATER HAMMER ARRESTOR AT ALL WATER HEATERS AND DISHMACHINE/WATER BOOSTER HEATER LOCATIONS.
- UNLESS OTHERWISE NOTED IN THESE DRAWINGS, THE PLUMBING CONTRACTOR SHALL PROVIDE & INSTALL BACKFLOW PREVENTION DEVICES AS REQUIRED BY APPLICABLE CODE(S) AND GOVERNING

OFFICIALS HAVING JURISDICTION.

BUILDING WASTE DRAIN.

- 10. EXPOSED PORTIONS OF CHILLED/COOLING WATER & HOT WATER PIPING SHALL BE INSULATED BY THE PLUMBING CONTRACTOR.
- GAS, STEAM & WATER PIPING SHALL BE BE PRESSURE TESTED, FLUSHED FREE OF FOREIGN MATTER & LINE STRAINERS CLEANED BY THE PLUMBING CONTRACTOR PRIOR TO CONNECTION TO THE
- 12. GREASE TRAPS ARE TO BE LOCATED & INSTALLED SO THEY ARE ACCESSIBLE & COVER(S) REMOVED WITHOUT INTERFERING IN THE OPERATION OF THE EQUIPMENT OR WITH ANY ELECTRICAL,
- MECHANICAL OR PLUMBING UTILITY. 13. CONDENSATE DRAIN PIPING SHALL BE TRAPPED OUTSIDE OF THE REFRIGERATED COMPARTMENT & EXTENDED TO AN INDIRECT
- 14. CONDENSATE DRAIN PIPING FROM WALK-IN EVAPORATOR COILS SHALL BE PROVIDED, INSTALLED & INSULATED BY THE PLUMBING
- 15. UNLESS OTHERWISE NOTED IN THESE DRAWINGS, CONDENSATE DRAIN PIPING FROM REFRIGERATED EQUIPMENT NOT EQUIPPED WITH
- THE PLUMBING CONTRACTOR. 16. DRAIN PIPING FROM WASTE DISPOSAL EQUIPMENT SUCH AS


A CONDENSATE EVAPORATOR SHALL BE PROVIDED & INSTALLED BY

- DISPOSERS/PULPERS SHALL BE PROVIDED WITH CLEAN-OUT FITTINGS. 17. PLUMBING CONTRACTOR TO PROVIDE & INSTALL A MAIN FUEL GAS SHUT-OFF VALVE IN ACCORDANCE WITH APPLICABLE CODES & ANY
- GOVERNING OFFICIAL HAVING JURISDICTION. 18. UNLESS OTHERWISE NOTED IN THESE DRAWINGS, FUEL GAS SOLENOID SHUT-OFF VALVE(S) FOR FOODSERVICE EQUIPMENT

PROVIDED BY BARING ARE PROVIDED BY BARING & INSTALLED BY THE

- PLUMBING CONTRACTOR. 19. UNLESS PERMITTED BY APPLICABLE CODE(S) FUEL GAS PIPING TO
- PILOT BURNERS ON EQUIPMENT SHALL SHALL NOT BY-PASS A FUEL GAS SOLENOID SHUT-OFF VALVE. 20. BARING INDUSTRIES RECOMMENDS THAT FUEL GAS SERVICE BE
- PROVIDED VIA A LOOPED DISTRIBUTION SYSTEM. THE SIZE OF THE LOOP SHALL BE DETERMINED BY THE PROJECT ARCHITECT/ENGINEER. 21. DRAIN PIPING FROM ANY EQUIPMENT USING/GENERATING STEAM
- SHALL BE OF MATERIALS & UTILIZING INSTALLATION METHODS TO ACCOMMODATE TEMPERATURES ABOVE 212 DEG F.
- 22. BARING INDUSTRIES RECOMMENDS THAT STEAM SUPPLY & CONDENSATE RETURN BE PROVIDED VIA LOOPED SYSTEMS. THE SIZE OF THE LOOPS SHALL BE DETERMINED BY THE PROJECT ARCHITECT/ENGINEER.
- 23. BARING INDUSTRIES RECOMMENDS THAT CHILLED/COOLING WATER SUPPLY & RETURNS BE PROVIDED VIA LOOPED SYSTEMS. THE SIZE OF THE LOOPS SHALL BE DETERMINED BY THE PROJECT

ARCHITECT/ENGINEER.

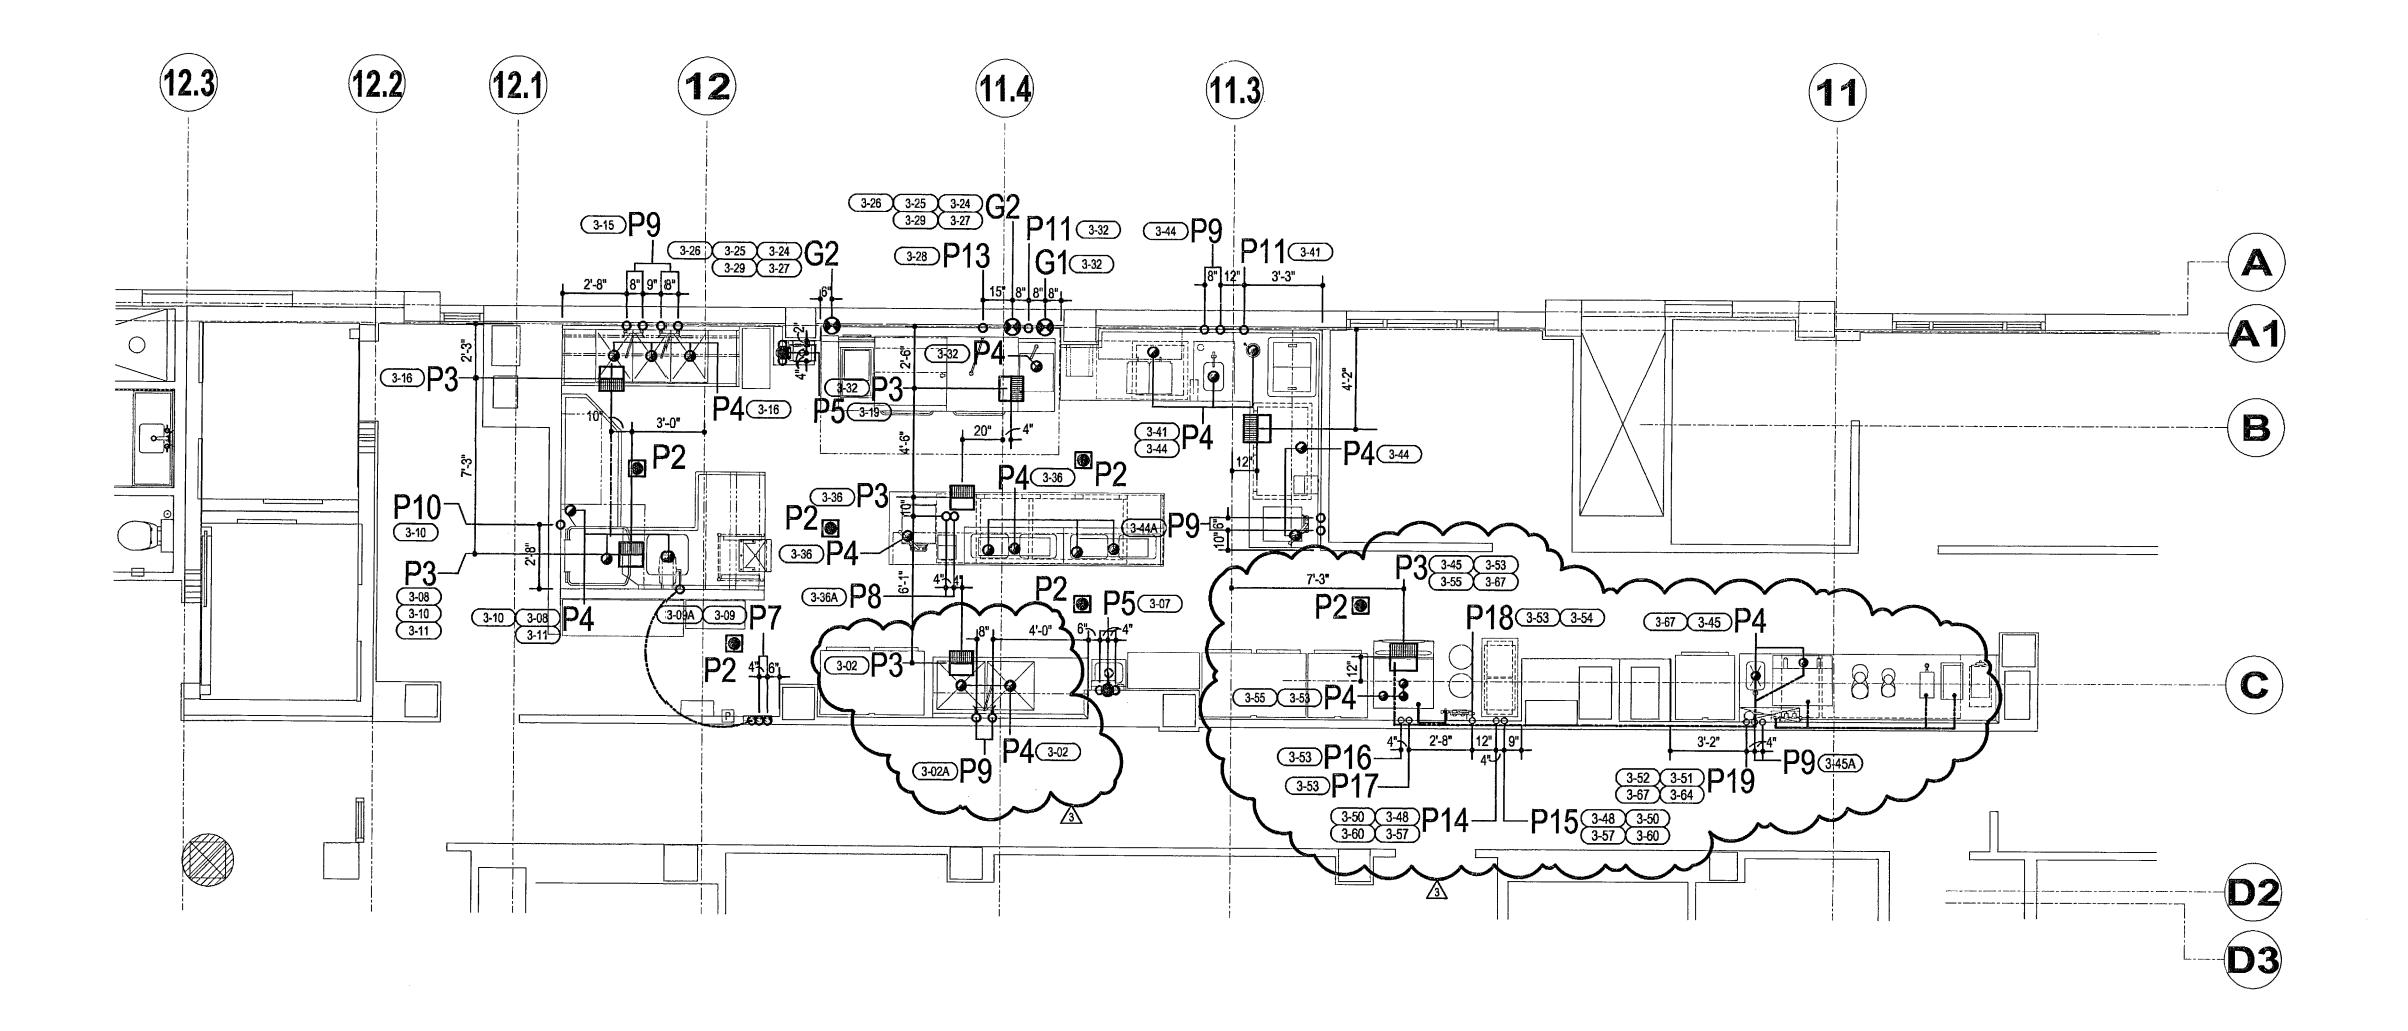

 GAS ROUGH-IN SCHEDULE
 1/2" NATURAL GAS - STUB @ +24" AFF & OUT OF BUILDING WALL - CONNECT TO EQUIPMENT THROUGH PRESSURE REGULATOR & FLEXIBLE GAS LINE W/QUICK DISCONNECT & PROVIDE SHUT-OFF
1-1/4"NATURAL GAS FR/GAS SUPPLY LOOP - STUB @ +24" AFF & OUT OF BUILDING WALL - CONNECT TO EQUIPMENT THROUGH PRESSURE REGULATOR & FLEXIBLE GAS LINE W/QUICK DISCONNECT - PROVIDE SHUT-OFF @ EACH END OF LOOP

P2	FLOOR DRAIN W/REMOVABLE GRATE
P3	FLOOR SINK W/REMOVABLE GRATE
P4	DRAIN LOCATION ON EQUIPMENT - EXTEND TO BUILDING WASTE DRAIN
P5	1/2" HOT & COLD WATER STUB @ +12" AFF & OUT OF WALL AND 1-1/2" DIRECT WASTE DRAIN STUBED-UP +18" & OUT OF WALL - CONNECT TO HAND SINK & PROVIDE SHUT-OFF VALVES ON WATER LINES
P6	3" DIRECT WASTE DRAIN F/FLOOR TROUGH - STUB UP +6" AFF - TRIM TO CORRECT ELEVATION & CONNECT TO FLOOR TROUGH
P7	1/2" HOT & COLD WATER - STUB @ +80" AFF TO TOP OF CONTROL CABINET, CONNECT TO MIXING VALVE IN HOSE REEL CONTROL CABINET & EXTEND TO HOSE REEL INSIDE BUILDING WALL
P8	1/2" HOT & COLD WATER - STUB @ +6" AFF - CONNECT TO EQUIPMENT & PROVIDE SHUT-OFF VALVES
P9	1/2" HOT & COLD WATER - STUB @ +12" AFF & OUT OF WALL - CONNECT TO EQUIPMENT & PROVIDE SHUT-OFF VALVES
P10	3/4" MINIMUM 110° F HOT WATER - STUB @ +12" AFF & OUT OF WALL - CONNECT TO EQUIPMENT & PROVIDE SHUT-OFF VALVE
P11	1/2" COLD WATER - STUB @ +12" AFF & OUT OF WALL - CONNECT TO EQUIPMENT & PROVIDE SHUT-OFF VALVE
P12	NOT USED
P13	1/2" COLD WATER - STUB @ +40" AFF & OUT OF WALL - CONNECT TO EQUIPMENT & PROVIDE SHUT-OFF VALVE
P14	1 1/4" COOLING WATER SUPPLY FR/BUILDING COOLING SYSTEM LOOP -STUB @ + 24" AFF & OUT OF WALL -MANIFOLD & CONNECT TO INLETS ON MULTIPLE EQUIPMENT -PROVIDE SHUT-OFF AT EACH INLET -INSULATE ALL EXPOSED PIPING.
P15	1 1/4" COOLING WATER RETURN TO BUILDING COOLING SYSTEM LOOP MANIFOLD & -STUB @ + 24" AFF & CONNECT TO OUTLETS ON MULTIPLE EQUIPMENT -PROVIDE SHUT-OFF AT EACH OUTLET -INSULATE ALL EXPOSED PIPING.
P16	1/2" COOLING WATER SUPPLY FR/BUILDING COOLING SYSTEM LOOP - STUB @ +54" AFF & OUT OF WALL - CONNECT TO EQUIPMENT & PROVIDE SHUT-OFF VALVE
P17	1/2" COOLING WATER RETURN TO BUILDING COOLING SYSTEM LOOP - STUB @ +54" AFF & OUT OF WALL - CONNECT TO EQUIPMENT & PROVIDE SHUT-OFF VALVE
P18	3/4" COLD WATER - STUB @ +84" AFF & OUT OF WALL - CONNECT TO WATER FILTER & EXTEND FR/FILTER THROUGH BUILDING WALL TO ICE MACHINE - PROVIDE SHUT-OFF VALVE
△ P19	3/4" COLD WATER - STUB @ +84" AFF & OUT OF WALL - CONNECT TO WATER FILTER & EXTEND FR/FILTER TO BEVERAGE EQUIPMENT - PROVIDE SHUT-OFF VALVE

PLUMBING ROUGH-IN SCHEDULE



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REVISION: BY: CK BY: DATE: ST JM 03-23-2009 JRL JM 04-23-200-) ST MGP 07-08-2009

COORDINATOR: PATRICIA TEPPER TELEPHONE: 954-327-6720 DRAWN BY: ST CHECKED BY: JM DATE: 02-27-2009 SCALE: 1/4" =1'-0"

PROJ. MGR: FRANK MURPHY

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PLUMBING LEGEND

HW o

CWR o

DW 🌑

HD/AGD •

FD 📵

FTFD

DFA

COLD WATER HOT WATER

ON EQUIPMENT

FLOOR DRAIN

FLOOR SINK STEAM SUPPLY CONDENSATE RETURN

COMPRESSED AIR ABOVE FINISH FLOOR

DROP FROM ABOVE

BELOW FINISH FLOOR

INTER-CONNECTING WATER PIPING

COOLING WATER SUPPLY **COOLING WATER RETURN**

HUB DRAIN/AIR GAP DRAIN

FUNNEL-TYPE FLOOR DRAIN

BUILDING DIRECT WASTE DRAIN

INDIRECT WASTE DRAIN LOCATION

REFRIGERATION & VENTILATION NOTES


- SLEEVES PENETRATING ANY WALL, FLOOR OR ROOF SHALL BE PROVIDED & INSTALLED BY THE GENERAL CONTRACTOR IN ACCORDANCE WITH APPLICABLE CODE(S) & ANY GOVERNING OFFICIAL HAVING JURISDICTION.
- REFRIGERATION LINE RUNS SHOWN ARE SCHEMATIC. ACTUAL
 ROUTING TO BE DETERMINED BY JOB SITE CONDITIONS,
 REFRIGERATION SYSTEM INSTALLER & THE GENERAL CONTRACTOR.
 UNLESS OTHERWISE NOTED IN THESE DRAWINGS,
 CURBS/RACKS/DUNNAGE FOR ROOF-MOUNTED EQUIPMENT SHALL BE
 PROVIDED & INSTALLED BY THE GENERAL CONTRACTOR IN

ACCORDANCE WITH APPLICABLE CODE(S) & ANY GOVERNING OFFICIAL

4. UNLESS OTHERWISE NOTED IN THESE DRAWINGS, EXHAUST VENTILATORS SHALL BE HUNG WITH THE BOTTOM OF THE VENTILATOR @ 80° AFF.

HAVING JURISDICTION.

- 5. HVAC CONTRACTOR SHALL MAKE CONNECTIONS BETWEEN EXHAUST VENTILATORS & DUCT WORK FULLY WELDED & LIQUID TIGHT.
- 6. HVAC CONTRACTOR SHALL PROVIDE & INSTALL DUCTWORK, FANS & CURBS REQUIRED FOR A COMPLETE & FUNCTIONING SYSTEM.
- SYSTEM START-UP & AIR BALANCE IS INCLUDED IN THE HVAC CONTRACTOR'S SCOPE OF WORK.

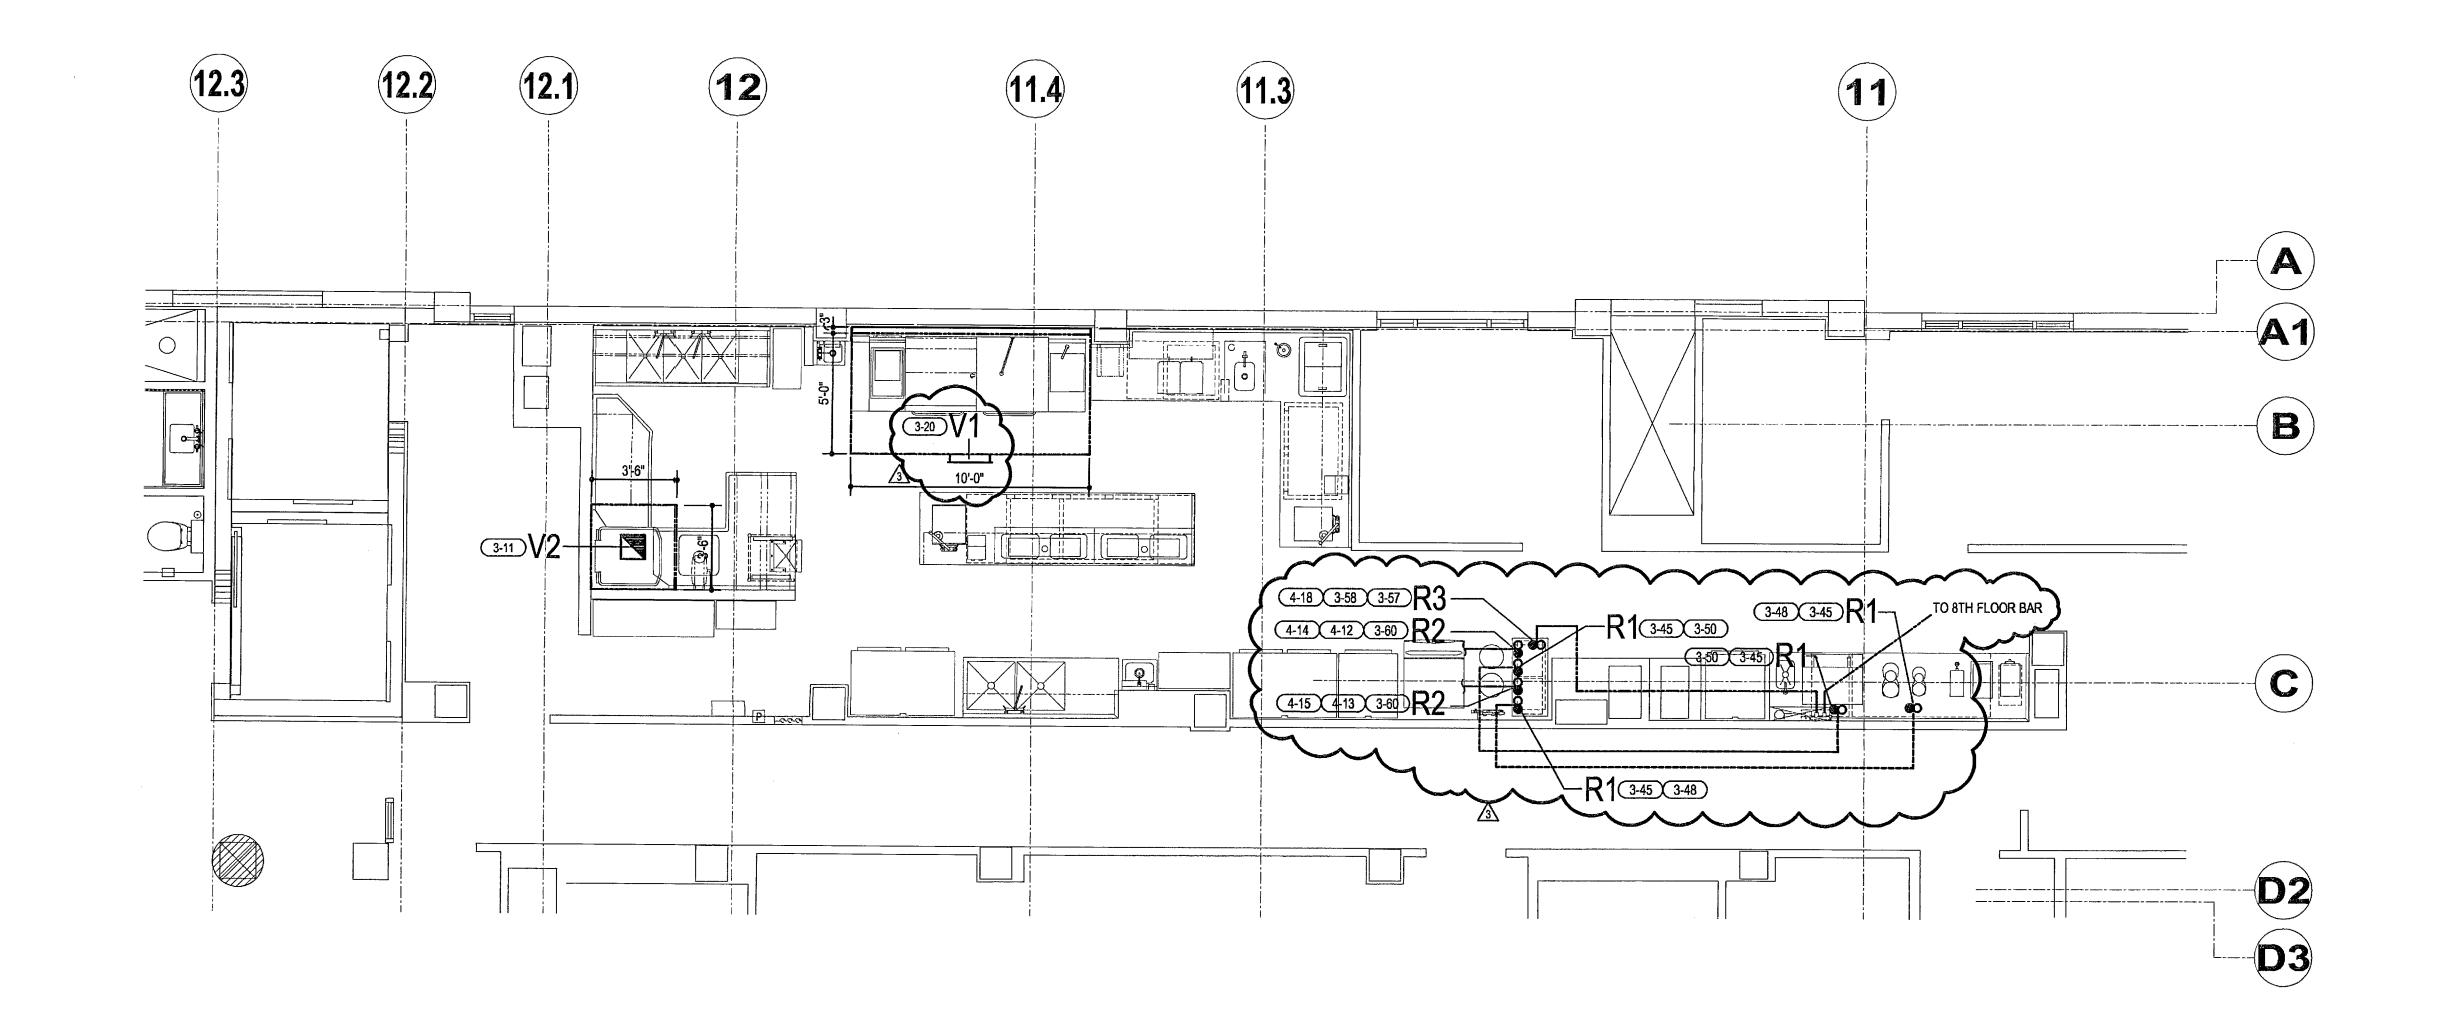

		VENTILATION ROUGH-IN SCHEDULE
<u> </u>	V1	10" X 20" EXHAUST DUCT IN FRONT FACE OF EXHAUST HOOD- 2927 CFM @ .80" SP
	V2	10" X 10" VAPOR HOOD EXHAUST - 500 CFM

1	REFRIGERATION ROUGH-IN SCHEDULE							
	R1 LIQUID & SUCTION REFRIGERATION LINES BETWEEN THE EQUIPMENT & REMOTE CONDENSING UNIT							
<u> </u>	R2	LIQUID & SUCTION REFRIGERATION LINES BETWEEN 8TH FLOOR REFRIGERATED EQUIPMENT & REMOTE CONDENSING UNIT						
<u> </u>	R3	REFRIGERATED GLYCOL CIRCULATION LINES TO REMOTE BEER PUMP PANEL STATION & BEER TOWERS ON 8TH FLOOR VIA PRODUCT CONDUIT PYTHON						



ORIDA

DUGH-IN SCHEDULE FACE OF EXHAUST HOOD- 2927 CFM @ .80" SP 00 CFM

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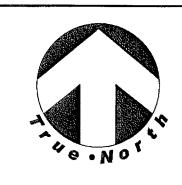
REFR	IGER/	ATION	LEG	END

LIQUID & SUCTION LINES
OVERHEAD REFRIGERATION LINES
BELOW FLOOR REFRIGERATION LINES
ABOVE FINISHED FLOOR
DROP FROM ABOVE

BELOW FINISHED FLOOR

VENTILATION LEGEND

EXHAUST DUCT
SUPPLY DUCT
STATIC PRESSURE, WATER GAUGE
CUBIC FEET/MINUTE
ABOVE FINISHED FLOOR



DFA

CFM

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TELEPHONE: 954-327-6720
DRAWN BY: ST
CHECKED BY: JM
DATE: 02-27-2009
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SHEET
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PROJECT NUMBER
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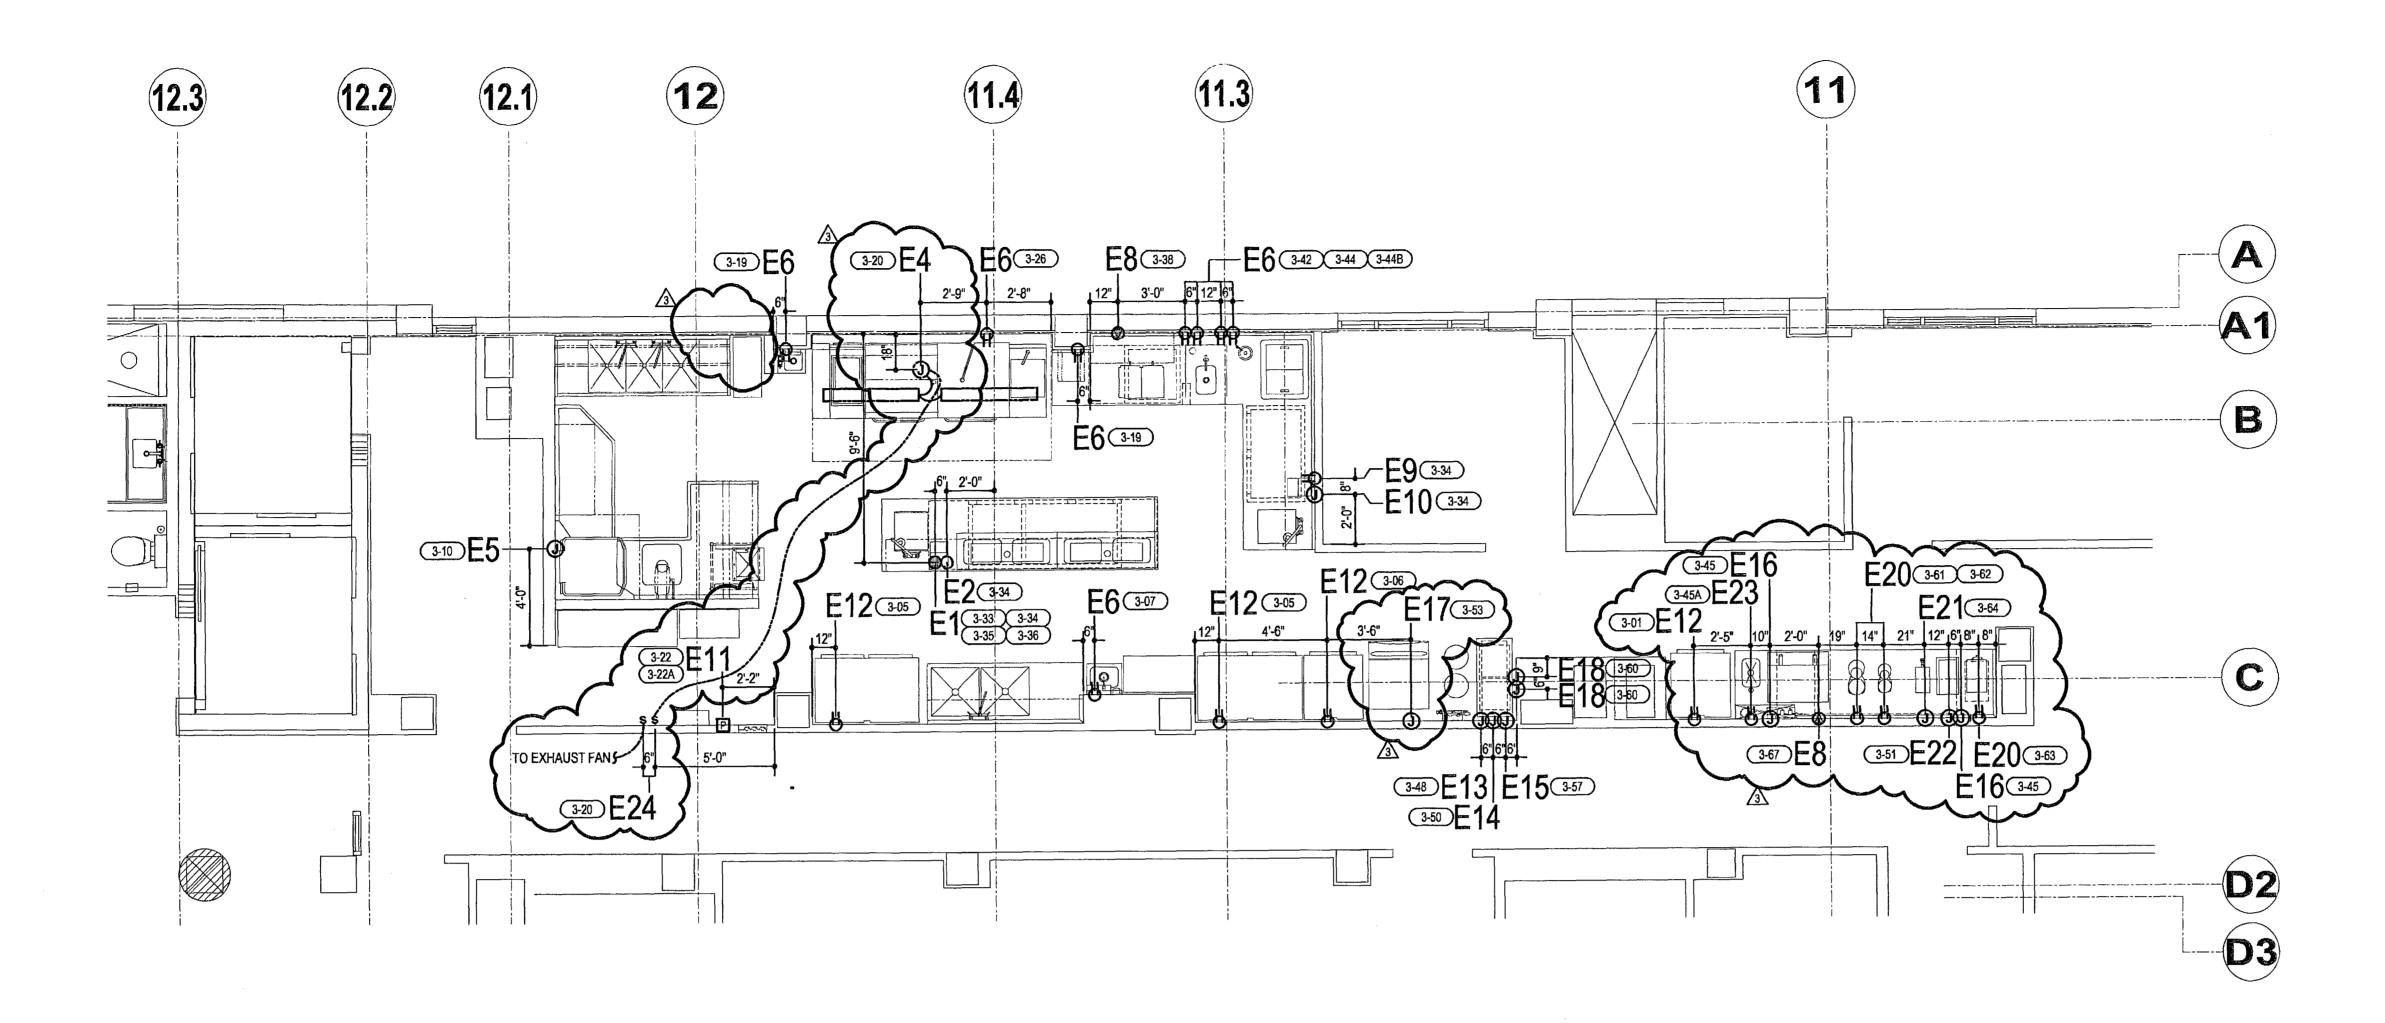
ELECTRICAL NOTES


- UTILITIES SHOWN ARE THE MINIMUM REQUIRED FOR THE FOODSERVICE EQUIPMENT. LOCATION, QUANTITY & SIZE OF ADDITIONAL UTILITIES, IF DESIRED/REQUIRED, ARE TO BE PROVIDED
- FINAL CONNECTIONS TO EQUIPMENT & INTER-CONNECTIONS BETWEEN COMPONENTS ARE INCLUDED IN THE ELECTRICAL CONTRACTOR'S SCOPE OF WORK.
- UNLESS OTHERWISE NOTED IN THESE DRAWINGS, COMPONENTS SUCH AS (BUT NOT LIMITED TO) WIRE, CONDUIT, SWITCHES, SAFETY DEVICES, OVER CURRENT & GROUND FAULT PROTECTION DEVICES & DISCONNECT SWITCHES SHALL BE PROVIDED & INSTALLED BY THE ELECTRICAL CONTRACTOR.
- UNLESS OTHERWISE NOTED IN THESE DRAWINGS OR AS RESTRICTED BY CODE, UTILITIES SHALL BE CONCEALED IN & STUBBED OUT OF BUILDING WALLS.
- COMPONENTS SUCH AS (BUT NOT LIMITED TO) SWITCHES, SAFETY DEVICES, OVER CURRENT & GROUND FAULT PROTECTION DEVICES & DISCONNECT SWITCHES SHALL BE LOCATED SO THAT THEY DO NOT INTERFERE WITH THE OPERATION OF THE EQUIPMENT.
- NEMA CONFIGURATION DESIGNATIONS ARE PROVIDED TO ENSURE THAT RECEPTACLES PROVIDED & INSTALLED BY THE ELECTRICAL CONTRACTOR MATCH THE PLUG CONFIGURATION PROVIDED WITH THE
- ELECTRICAL CONTRACTOR SHALL PROVIDE & INSTALL DISCONNECT SWITCHES AS REQUIRED BY APPLICABLE CODE(S) & ANY GOVERNING OFFICIAL HAVING JURISDICTION.
- LINE VOLTAGE CONTROL CIRCUIT & INTER-WIRING BETWEEN WALK-IN BOX COMPONENTS SUCH AS (BUT NOT LIMITED TO) CONDENSING UNITS, REFRIGERATION RACKS, EVAPORATOR COILS, TIME CLOCKS & TEMPERATURE CONTROLS ARE INCLUDED IN THE ELECTRICAL CONTRACTOR'S SCOPE OF WORK.
- UNLESS OTHERWISE NOTED IN THESE DRAWINGS HEATER CABLE SHALL PROVIDED BY BARING & SHALL BE FLEXIBLE, SELF-REGULATING TYPE RATED @ 3 WATTS PER FOOT.
- CONDENSATE DRAIN PIPE FROM WALK-IN FREEZER COMPARTMENTS SHALL BE WRAPPED WITH HEATER CABLE BY THE ELECTRICAL
- WALK-IN BOX LIGHT FIXTURES SHIPPED LOOSE SHALL BE MOUNTED
- AND INTER-WIRED BY THE ELECTRICAL CONTRACTOR. LINE VOLTAGE CONTROL CIRCUIT & INTER-WIRING BETWEEN EXHAUST VENTILATOR COMPONENTS SUCH AS (BUT NOT LIMITED TO) LIGHT FIXTURES, CONTROL PANELS, FANS, MAGNETIC CONTRATOGRS, MOTORIZED DAMPERS & THE BUILDING ALARM SYSTEM ARE INCLUDED IN THE ELECTRICAL CONTRACTOR'S SCOPE OF WORK.
- LINE VOLTAGE CONTROL CIRCUIT & INTER-WIRING BETWEEN FIRE SUPPRESSION SYSTEM COMPONENTS SUCH AS (BUT NOT LIMITED TO) CONTROL PANELS, AGENT CABINETS, REMOTE PULL STATIONS & THE BUILDING ALARM SYSTEM ARE INCLUDED IN THE ELECTRICAL CONTRACTOR'S SCOPE OF WORK
- FIRE SUPPRESSION SYSTEM REMOTE PULL STATION REQUIRES A 4" x 4" OCTAGON J-BOX W/SCREW HOLES @ 2- & 8-O'CLOCK POSITIONS. ELECTRICAL CONTRACTOR SHALL RECESS THE J-BOX IN THE BUILDING WALL & PROVIDE EMPTY CONDUIT FROM THE TOP OF THE J-BOX STUBBED OUT THE BLDG WALL 6" ABOVE THE FINISHED CLG.
- 5. ELECTRICAL CONTRACTOR SHALL VERIFY FIRE SUPPRESSION SYSTEM REMOTE PULL STATION LOCATIONS WITH THE GOVERNING OFFICIAL HAVING JURISDICTION PRIOR TO ROUGH-IN.
- 16. ELECTRICAL CONTRACTOR SHALL VERIFY TO WHICH BLDG SYSTEMS THE FIRE SUPPRESSION SYSTEM SHALL BE INTER-CONNECTED.
- LINE VOLTAGE CONTROL CIRCUIT & INTER-WIRING BETWEEN WASTE SYSTEM COMPONENTS SUCH AS (BUT NOT LIMITED TO) CONTROL PANELS, START-STOP SWITCHES, DISPOSERS, PUPLERS & TROUGH COLLECTORS ARE INCLUDED IN THE ELECTRICAL CONTRACTOR'S SCOPE OF WORK.
- 8. LINE VOLTAGE CONTROL CIRCUIT & INTER-WIRING BETWEEN WAREWASHING EQUIPMENT COMPONENTS SUCH AS (BUT NOT LIMITED TO) CONTROL PANELS, VENT FAN CONTROL, DETERGENT & SANITIZER DISPENSERS, TABLE LIMIT SWITCHES & WATER BOOSTER HEATERS

ARE INCLUDED IN THE ELECTRICAL CONTRACTOR'S SCOPE OF WORK.

- 19. UNLESS OTHERWISE STIPULATED BY APPLICABLE CODE, ALL 120-VOLT RECEPTACLES SHALL BE GFCI TYPE.
- 20. POWER SERVICE TO COMPUTER AND POINT-OF-SALE EQUIPMENT SHALL BE ON A DEDICATED CIRCUIT WITH ISOLATED GROUND.
- 1. POINT-OF-SALE EQUIPMENT REQUIRES AN EMPTY J-BOX AND CONDUIT SUITABLE FOR CATEGORY-5 DATA INTERFACE CABLE. ELECTRICAL CONTRACTOR TO VERIFY ROUTING WITH THE SYSTEM PROVIDER.
- 2. COMPUTER EQUIPMENT REQUIRES A J-BOX AND CONDUIT WITH DATA INTERFACE CABLE & RJ45 ETHERNET CONNECTOR, ELECTRICAL CONTRACTOR TO VERIFY ROUTING WITH THE SYSTEM PROVIDER.

_ _ -



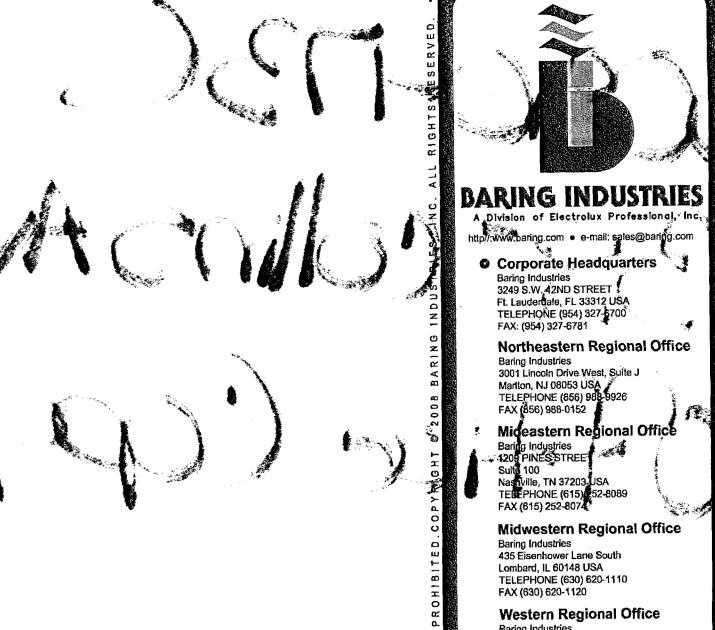

		LECTRICAL ROUGH-IN SCHEDULE
	E1	CONDUIT STUB - 120-208V/3PH/60A SERVICE STUB @ +6" AFF - CONNECT TO CIRCUIT BREAKER PANEL ON EQUIPMENT - SEE SHOP DRAWING FOR PANEL SCHEDULE
	E2	EMPTY JUNCTION BOX & CONDUIT F/CAT5e COMMUNICATION/DATA CABLE - +6" AFF - VERIFY REQUIREMENTS WITH SUPPLIER
3	E3	NOT USED
3	E4	JUNCTION BOX - 120V/1PH/10A SERVICE DOWN FR/ABOVE TO TOP OF EXHAUST HOOD - CONNECT & INTER-WIRE TO LIGHT FIXTURES & CAPTURE JET FAN(S) AS REQUIRED
	E5	JUNCTION BOX - 480V/3PH/35A SERVICE +18" AFF - CONNECT TO EQUIPMENT & INTERWIRE VENT FAN CONTROL TO EXHAUST FAN.
	E6	DUPLEX RECEPTACLE - 120V/1PH/20A SERVICE - NEMA 5-20R GFCI +18" AFF
	E7	NOT USED
	E8	SINGLE RECEPTACLE - 208V/1PH/30A SERVICE - NEMA L6-30R +50" AFF
	E9	DUPLEX RECEPTACLE ON DEDICATED CIRCUIT W/ISOLATED GROUND - 120V/1PH/20A SERVICE - NEMA 5-20R +50" AFF
	E10	EMPTY JUNCTION BOX & CONDUIT F/CAT5e COMMUNICATION/DATA CABLE - +50" AFF - VERIFY REQUIREMENTS WITH SUPPLIER
	E11	EMPTY OCTAGON JUNCTION BOX F/FIRE PROTECTION SYSTEM REMOTE PULL STATION - +48" AFF W/SCREW HOLES @ 2 & 8 O'CLOCK POSITIONS - EXTEND 1/2" EMT CONDUIT FROM BOX TO 6" ABOVE FINISHED CEILING W/NO BENDS
	E12	DUPLEX RECEPTACLE - 120V/1PH/20A SERVICE - NEMA 5-20R GFCI +90" AFF
	E13	JUNCTION BOX - 120V/1PH/15A SERVICE +24" AFF - CONNECT TO EQUIPMENT
	E14	JUNCTION BOX - 120V/1PH/10A SERVICE +24" AFF - CONNECT TO EQUIPMENT
	E15	JUNCTION BOX - 208V/1PH/15A SERVICE +60" AFF - CONNECT TO EQUIPMENT
ļ	E16	JUNCTION BOX - 120V/1PH/10A SERVICE +24" AFF - CONNECT TO EQUIPMENT
3	E17	JUNCTION BOX - 208V/1PH/20A SERVICE +66" AFF - CONNECT TO EQUIPMENT
	E18	JUNCTION BOX - 120V/1PH/15A SERVICE +78" AFF - CONNECT TO EQUIPMENT
	E19	NOT USED
	E20	DUPLEX RECEPTACLE - 120V/1PH/20A SERVICE - NEMA 5-20R GFCI +50" AFF
	E21	JUNCTION BOX - 120V/1PH/20A SERVICE +50" AFF - CONNECT TO EQUIPMENT
<u> </u>	E22	JUNCTION BOX - 120-208V/1PH/20A SERVICE +50" AFF - CONNECT TO EQUIPMENT
3	E23	DUPLEX RECEPTACLE - 120V/1PH/15A SERVICE - NEMA 5-15R GFCI +18" AFF
<u> </u>	E24	LIGHT & FAN SWITCHES F/EXHAUST HOOD @ 48" AFF - INTERWIRE TO EXHAUST HOOD & FAN AS REQUIRED

ELECTRICAL LE	GENI	_ }
	OLIVE	
SINGLE RECEPTACLE, NEMA 5-20R	SR	(
DUPLEX RECEPTACLE, NEMA 5-20R	DR	(
QUADRAPLEX RECEPTACLE, NEMA 5-20R	QR	2
SPECIAL RECEPTACLE, 208 OR 480	SPR	
FLOOR RECEPTACLE JUNCTION BOX	FR JB	(
DROP CORD OR CONDUIT	DC	
CONDUIT STUB	C	
WALL SWITCH	S	-
RECEPTACLE ON EQUIPMENT		
FIRE PROTECTION SYSTEM REMOTE PULL ST	ration .	į
INCANDESCENT LIGHT FIXTURE	p40	
FLUORESCENT LIGHT FIXTURE		
LOAD CENTER IN EQUIPMENT		
BUILDING LOAD CENTER PANEL POINT OF CONNECTION ON EQUIPMENT	- '	<u>.</u>
ABOVE FINISHED FLOOR	AFF	
DROP FROM ABOVE	DFA	
-, , , , -=	BTC	
BRANCH TO CONNECTIONS		



Ft. Lauderdale, FL 33312 USA TELEPHONE (954) 327-6700 FAX: (954) 327-6781 Northeastern Regional Office 3001 Lincoln Drive West, Suite J Martton, NJ 08053 USA TELEPHONE (856) 988-FAX (856) 988-0152 Midwestern Regional Office Baring Industries
435 Eisenhower Lane South
Lombard, IL 60148 USA
TELEPHONE (630, 620-1110 FAX (630) 620-1120 Western Regional Office Baring Industries 11411 Southern Highlands Parkway Las Vegas, NV 89141 USA TELEPHONE (702) 385-4416 FAX (702) 385-4417 ORIDA

ST MGP 07-08-2009

PROJ. MGR: FRANK MURPHY COORDINATOR: PATRICIA TEPPER TELEPHONE: 954-327-6720 DRAWN BY: ST CHECKED BY: JM

DATE: 02-27-2009 SCALE: 1/4" =1'-0" K3-7

60504736 UBSSCOllins Ave Office Copy

> Migra Do Amos Ceco 12/9/09

BUILDING:

ZONING:

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Derm Number: 2009-1204-1159-1078
Contact Name: CEETA POLIAH
Contact Phone: (786)897-5342
Folio: 02-3226-001-2140
Project Name: SOHO BEACH HOUSE
Date Received: 12/04/2009

Reviewer Name:



CITY OF MIAMI BEACH BUILDING DEPARTMENT 1700 CONVENTION CENTER DRIVE 2ND FLOOR - CITY HALL MIAMI BEACH, FL 33139

NOTICE TO THE CITY OF MIAMI BEACH BUILDING DEPARTMENT OF EMPLOYMENT AS SPECIAL INSPECTOR UNDER THE FLORIDA BUILDING CODE

I, (w	ve) have b	een retained	by: Claro Devel	opment_	to p	erform	special n	шажкы	services	under
the I	Florida Bui	lding Code a	at the <u>4385 Coll</u>	ins Avenue	pr	oject c	on the be	low liste	d structu	ires as
			am a professional							
Proc	ess Number	B1100	002	Master Per	mit (IF AI	PPLICA	BLE):	:	••••	
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ŏ	•		or for Soil Compaction	•) (3 CT	()		••••	••••
ŏ			or for Precast Attach or for Reinforced Ma			sy P.E. t	or R.A)		•	••••
⊗	·		on for Steel Bolted &			מר אי נמ	2 (15) 0 6	ar D.A	, •	
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л _ 1.		j individual's) Fernandez,	employed by this fir	m or me are au	uthorized r 2.		ntatives to er Koerl		inspection	ns*
3.	• .	ico Garcia			4.					
I, (we) I, (we) of Miar Special comple Log for	will notify the understand the seach Build linspector his thought on of the worn and sealed	City of Miami Bonat a Special Insign Department and by the Owner with under each by statement that, a Code and are in the Code	IVZ sections 1927, ngineer or Register cach Building Department pection Log for each build Inspector. All mandaton LOG for acc in addition to the utilding permit, I will substate the best of my knowled in subsequent accordance.	of any changes redding must be display inspections, as remandatory inspections in the Building dge, belief and pro	egarding autiliayed in a co equired of the ections perions properties and the contractions of the contract	horized ponvenient the Florida formed to the time	ersonnel per location on to Building Cox 14 Use Building to 15 Of final insp	rspection forming institution institution institution institution institution in the section the section the section the section the section the section in	pection server reference by lon performer to the completed in completed in the complete	rices. y the City ed by the ner, upon
. i		Archi	tect/Engineer Signature:							
	,		Architect/Engineer Name Printed:	Mustaf	a Canka	it, PE) 			
(1)	Com		Address:	1900_S	W 57 AV	IE? #	1. Miam	iEL	33155	
Sign	ned and Scale	de April	Phone Number:		266-977	ì	,	,		
#1	8632		Owner/Agent Signature:		LP	1.	h - L	1_	+	
	ense Number	-	er/Agent Name Printed:	vee/	a 1 C	or a	//	gen		
Date:	10/15/10		Building Department Accepted By:		Ger	er	12/	6/11		

CANKAT-ESSMAN, INC.

1900 SW 57 Avenue, #1 Miami, FL 33155 Tel: (305) 266-9777 Fax: (305) 266-0584 mus@cankatessman.com www.cankatessman.com

October 20, 2010

City of Miami Beach
Building Department
1700 Convention Center Drive
2nd Floor City Hall
Miami Beach, FL

Attention: Mr. R. L. Valdes, PE

Structural Plan Reviewer

Re: 4385 Collins Ave., Miami Beach, FL

Soho Beach House / Court Yard Pergola

Structural B 1100002 Our Job No. 10017

Dear Sir:

The following are our responses to your Structural Review Comments, dated 10/7/10.

ITEM #1:

Comment: PROVIDE FOUNDATION FOR TRELLIS COLUMNS. NOTE THAT DESIGN CRITERIA REFERS TO SOIL BEARING PRESSURE BUT THE MASTER PERMIT USED PILE FOUNDATION. IF TRELLIS IS SUPPORTED BY A CONCRETE STRUCTURE BY OTHERS (SLAB ON GRADE, STRUCTURAL SLAB OR CONTINUOUS OR INDIVIDUAL FOOTINGS), PROVIDE EVIDENCE OF SUCH.

RESPONSE: Trellis columns are supported on existing 8" reinforced concrete slab over pile foundation. Calculation page foundation information is corrected. See attached partial foundation plan of the area where the trellis columns are installed. See calculation page 11 maximum downward reaction (gravity + wind) is 2.05 kips. Punching shear at column base is less than 10 psi and distributed load is within the capacity of structural slab.

ITEM #2:

Comment: SPECIAL INSPECTIONS ARE REQUIRED FOR STRUCTURAL STEEL BOLTED AND WELDED CONNECTIONS. PROVIDE THREE FULLY EXECUTED COPIES OF SPECIAL INSPECTOR FORM.

RESPONSE: Special Inspector forms are provided. Please see attached.

ITEM #3:

Comment: SECTION 1/S-2. PROVIDE SIZE AND CONNECTIONS FOR HANGERS SUPPORTING TRELLIS FROM "EXISTING BEAMS BY OTHERS".

RESPONSE: Please see Section 6/S-2 for tubular hanger section size and weld size connecting them at top and bottom.

ITEM #4:

Comment: CALCULATIONS INDICATE A MOMENT CONNECTION BETWEEN BEAM AND POST AS AN ALL-AROUND 3/16" FILLET WELD. PROVIDE DETAIL FOR CONNECTION 2. RESPONSE: Stability of the hanging pergola below the long bar structure has been originally provided in transverse direction (N-S) by connecting the new HSS 6x4x3/16 beams to concrete columns of the bar structure at each end in longitudinal direction (E-W) hangers were welded only. We revised Section 2/S-2 by adding cross bracing members to provide stability without relying on moment connection.

Yours truly,

Mustafa Cankat.

Atts.

CANKAT-ESSHAN, INC.

COSSELTING ENGISEERS

1900 SW 57 Ave., Suite 1 MIAMI, FL 33155 T:305.266.9777 F:305.286.0584

STRUCTURAL CALCULATIONS

GENERAL INFORMATION

Project:

SOHO BEACH HOUSE Courtyard Pergola

Project Address:

4385 Collins Ave

Date

Miami Beach FL 33140 9/21/2010

Our Job No.

10017

Client:

SOHO BEACH HOUSE

INDEX

CONTENTS
DESIGN CRITERIA
WIND ANALYSIS
STEEL FRAMING BEAMS & POSTS
WOOD RAFTERS
CONNECTIONS
APPENDIX

TOTAL (21) PAGES

Mustafa Cankat, PE Florida License #: 18632 C.A #: 404419

M. Can/x
10/27/2010

NAMI, FL 33155 :305.266.9777 F:305.266.0584	CLIENT:	DESIGN CRITER			JOB NO: 10017 TITLE:	Page: Calc'd: Checked	FO
	ARCHITECT:	ALLAN T. SHUL	MAN ARCHITEC	TS, P.A.	REVISED	Date:	10/27/10
STRUCTURAL CALCULATIONS							
Applicable Codes:							
* Florida Building Code 2007							
* ACI 318-99 Reinforced Concrete							
* ACI 530-98 Reinforced Masonry							
* ASTM C-90 Hollow unit masonry							
*ASTM C-476 Grout							
* AISC							
* ASCE 7-05							
Wind Criteria (as per ASCE 7-05)							
Basic Wind sp	eed	146 (3 s	second gust) High V	elocity Wind Zone			
Height <60 Ft.		edistriction and about 4 to 1 g.	3,· 0	•			
Exposure	С						
Importance fac	tor l=	****					
Kd=		*					
kdt=		0.85				•••••	•
Design Loads:	·:·	******	Dead Load	<u>s.i. dl</u>	Live Load	•	
Roof	,		10 psf		30 psf	:	•
Floor	9.7					• ••	•
Теттасе, Ваісс	ny /Stair	:a	25 psf	4	100 pst	•	•
Pitch of roof		/12		degrees		•	• ••
Eave height(z)		Ft Ft				•	•
Building width (L)	********	ફrι Ft				•• •	
Mean roof height(H)		FL				• •••	• • • •
						•	
						• •	• •
Pergola columns are supported on	existino 8" ca	oncrete structural sia	ab over Pile Founda	tions.		:	•
Assumed minimum concrete prope				• •			
						.	_
Concrete: Foundation	Superstructu	re Re	inforcing Steel				•

Structural Wood

fc'= E=

All structural lumber shall be No.2 common grade Southern Pine or better grade


Structural Steel

Tubular sections: ASTM A-500 Gr B

3321 ksi

All Others: ASTM A-36

MIAMI, FL 33155 T:305.266.9777 F:305.266.0584	PROJECT: SOHO BEACH HOUSE Courtyard Pergola	JOB NO:	Page: 5 Calc'd: F9
	CLIENT:		Checked FO
	ARCHITECT:		Date: 9/2/10

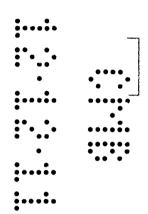

WIND ANALYSIS

ASCE 7-05,	MONOS	ELOPE FREE ROOFS,	C&C	Θ<=7.5°	SOHO E	Beach
h(feet)	9.25	mean roof height		Θ°	0.00	OK< 7.5
Exposure	2	1 for B, 2 for C,1 for D		a(feet)	3.00	
K _{zt}	1.00	6.5.7 [°]		Exposure	С]
K _d	0.85	Table 6-4		α	9.5	Table 6-2
V	146	mph		z_{g}	900	Table 6-2
1	1.00	Table6-1		Kh(CASE 1)	0.85	Table 6-3
G	0.85	6.5.8		q_h	39.37	$.00256K_zK_{zt}K_dV^2I$
p(in/ft)	0.00	roof pitch		q _h G	33.47	psf
L(feet)	18.83	least horizontal dim.		h/L	0.49	OK
Flow	1	Enter1 for clear flow		-		


roof	sqft.	A _f	,		C _N			•
angle			Zone	3	Zone	2	Zone	1 •
	9	<=a²	2.4	-3.3	1.8	-1.7	1.2	-1.1
0°	36	>a ² <=4a ²	1.8	-1.7	1.8	-1.7	1.2	-1.1
	36	>4a²	1.2	-1.1	1.2	-1.1	1.2	-1.1

ſ	roof	sqft	A _f			C _N				ŀ	
L	angle			Zone 3		Zone	2	Zone	1		:
ſ		9	<=a ²	2.4	-3.3	1.8	-1.7	1.2	-1.1	•	•
l	Θ°	36	>a ² <=4a ²	1.8	-1:7	1.8	-, -1.7	1.2	-1.1		•
L		36	>a²<=4a² >4a²	1.2	-1.1	1.2	-1.1	1.2	-1.1		


roof	sqft	A _f	C _N					
angle			Zone	3	Zone	2	Zone	1
	9	<=a ²	3.2	-4.2	2.4	-2.1	1.6	-1.4
7.5°	36	>a ² <=4a ²	2.4	-2.1	2.4	-2.1	1.6	-1.4
	36	>4a ²	1.6	-1.4	1.6	-1.4	1.6	-1.4

ſ	roof	sqft	A _f	q _h GC	C _{N(} psf)		·	Clear F	low		
	angle		<u> </u>	Zon	e 3	Zone	2	Zone	1		
ſ	_	9.	<=a ²	80.32	-110.44	60.24	-56.90	40.16	-36.81		1
ı	Θ°	36	>a ² <=4a ²	60.24	-56.90	60.24	-56.90	40.16	-46.86		- 4x
		36	>4a²	40.16	-36.81	(40.16)	-36.81	40.16	-36.81	\Leftarrow	FRAM


MIAMI, FL 33155	PROJECT: SOHO BEACH HOUSE Courtyard Pergola	JOB NO:	Page: 5
T:305.266.9777 F:305.266.05	84		Calc'd: FO
	CLIENT:		Checked FO
	ARCHITECT: ALLAN T. SHULMAN ARCHITECTS, P.A.		Date: 9/2/10

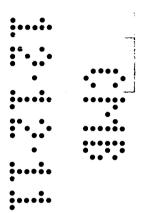

FRAMING STEEL BEAM/POST

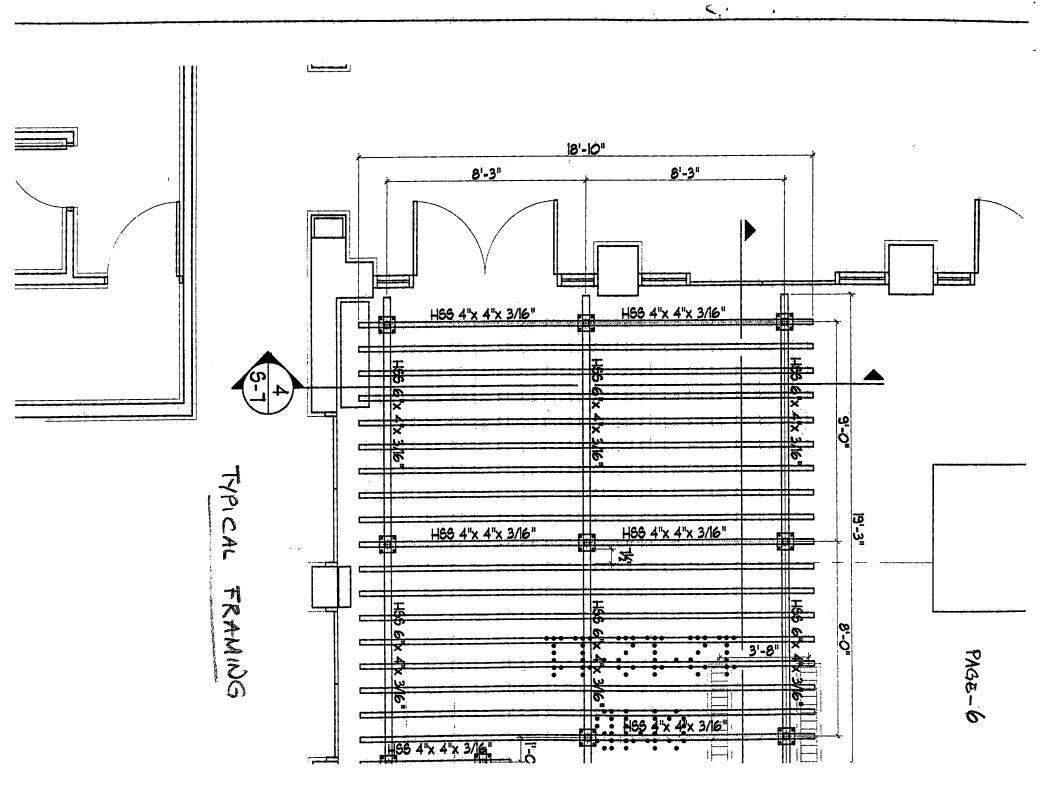


CANKAT ESSMAN		_		STEEL BEAM				<u> </u>	Page		of	
1900 SW 57th Ave. N mIAMI, fl 33155 (305)266-9777	lo:1			SOHO BEACH 9' LONG TUBUI				Pro	Design: Checked:	MC F.C		/04 ate: 09/02/10 ate:
Beam Data Ma Sp	aterial pan length				B = /	t M	HE	55	GX		nmed by: Fu	at Ornarli,P.E.
	L form Load liform Loa liform Loa	d d	Start	s from left <u>End</u> 9:0 Ft 9.0 Ft	Total	Appl	. Point	Мо	ment		•	
Point Load P1 P2 P3 P4 P5 P6 P7	<u>P(K)</u>	<u>x(Ft) from left</u>	Dist to mid span	Dist to point of inflection	↓ ↓	<u> </u>	<u> </u>	\	<u> </u>	<u> </u>		••••
P8 P9				<u>[</u>		0.1	44 KIf				<u> </u>	
P10 RESULT M= S _{req'd} = M _m	1.46 Ft-l _{nex} /F _b =	< x 12.00 = 17.5	17.5 in-K / 30.36 =	R= 0.6 = 0.58 in3	48 k			1.46 F 1.46 F 1.44 F	t-K	@ 4.50 Ft		R= 0.648 k

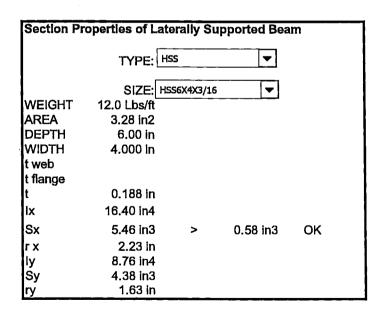

Deflection Check:	As per FE	IC '02 L/	360	▼
$\Delta = 5/48 * M * L^2/E * I =$		0.04 in	<	0.30 in OK
Vibration Check: $f=3.5\sqrt{1/\Delta}$	= 3.5 √ 22.	37 = 1	6.56	OK >5


3 k


CANKAT ESSMAN PROJECT: SOHO BEACH HOUSE	Page:
1900 SW 57th Ave. No: 1 CLIENT:	
Mami, 33155 SUBJECT:	JOB NO: Designed: FO
(305)266-9777 Frame 1	TITLE: Checked: MC

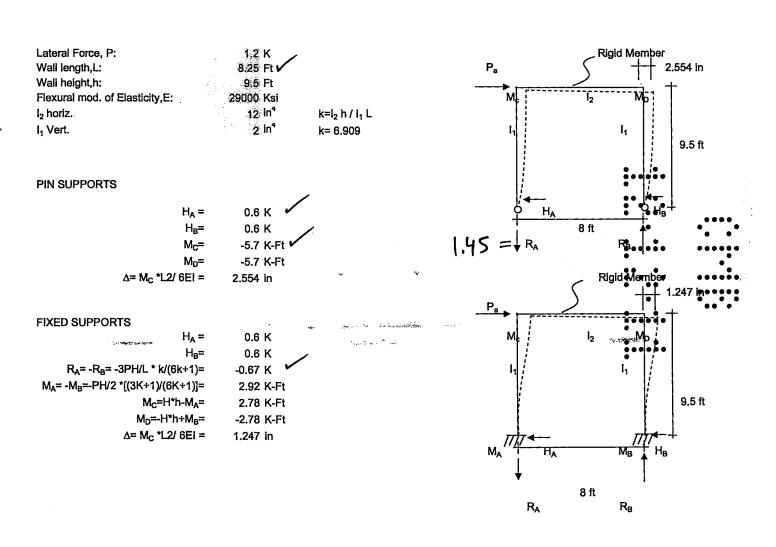

FIXED SUPPORTS AND PINNED AT TOP

H _A =	0.6 K
H _B ≕	0.6 K
$R_A = -R_B = PH/L =$	0.0 K
M _A ≕H*h≕	5.70 K-Ft
M _B =H*h=	5.70 K-Ft
Δ= P*L ³ / EI =	15.326 in

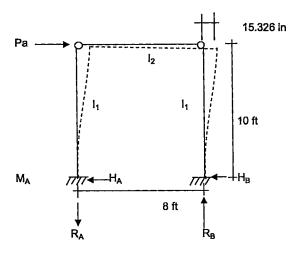

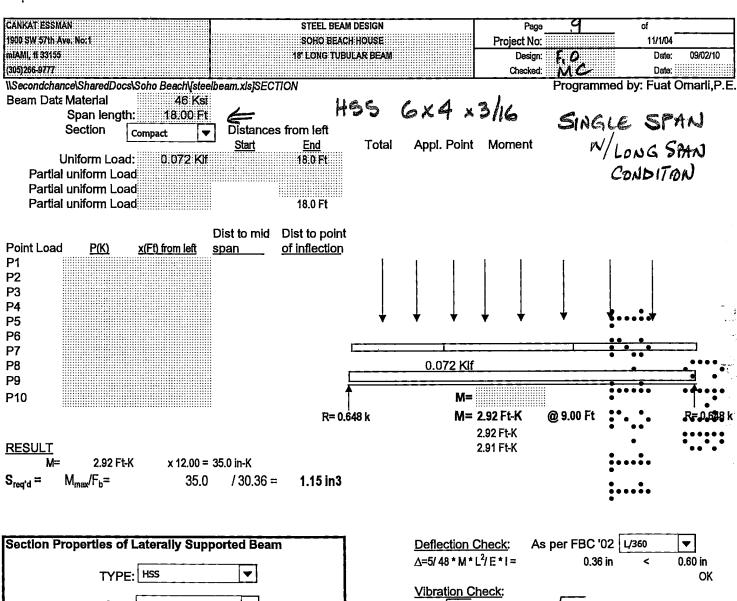

Section Pr	operties of L	aterally Su	ported B	eam
	TYPE:	HSS	~	
1	SIZE:	HSS6X4X3/16	~	
WEIGHT	12.0 Lbs/ft		· · · · · · · · ·	•
AREA	3.28 in2			
DEPTH	6.00 in			
WIDTH	4.000 in			
t web				
t flange				
t	0.188 in			
lx	16.40 in4			
Sx	5.46 in3	>	1.15 in3	OK
гx	2.23 in			
ly	8.76 in4			
Sy	4.38 in3			
ry	1.63 in			

 $f=3.5\sqrt{1/\Delta}$ **= 3.5** √ 2.80 = 5.85 OK >5


CANKAT ESSMAN PROJECT: SOHO BEACH HOUSE	Page: 10
1900 SW 57th Ave. No. 1 CLIENT:	1 -
Miami, 33155 SUBJECT:	JOB NO: Designed: FO
(305)266-9777 Frame 2	TITLE: Checked: MC

Lateral Force, P:	1.2 K	
Wall length,L:	18 Ft 🗸	
Wall height,h:	9.5 Ft	
Flexural mod. of Elasticity,E:	29000 Ksi	
l ₂ horiz.	12 in⁴	k=l ₂ h / l ₁ L
I ₁ Vert.	<u>2</u> in⁴	k= 3.167

PIN SUPPORTS


 $H_A = 0.6 \text{ K}$ $H_B = 0.6 \text{ K}$ $M_C = -5.7 \text{ K-Ft}$ $M_D = -5.7 \text{ K-Ft}$ $\Delta = M_C * L2/6EI = 2.554 \text{ in}$


FIXED SUPPORTS

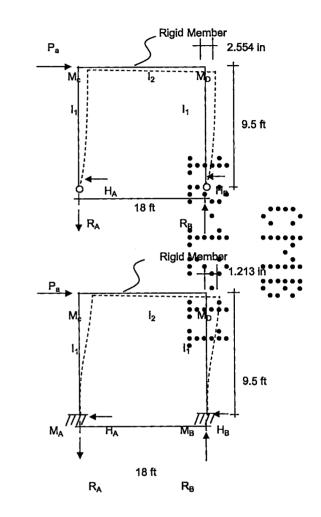

FIXED SUPPORTS AND PINNED AT TOP

 $H_A = 0.6 \text{ K}$ $H_B = 0.6 \text{ K}$ $R_A = -R_B = PH/L = 0.0 \text{ K}$ $M_A = H^*h = 5.70 \text{ K-Ft}$ $M_B = H^*h = 5.70 \text{ K-Ft}$ $\Delta = P^*L^3/\text{ El} = 15.326 \text{ in}$

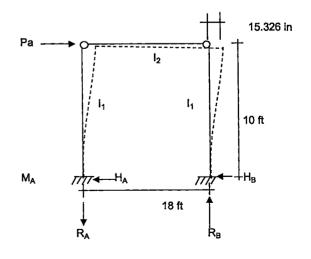

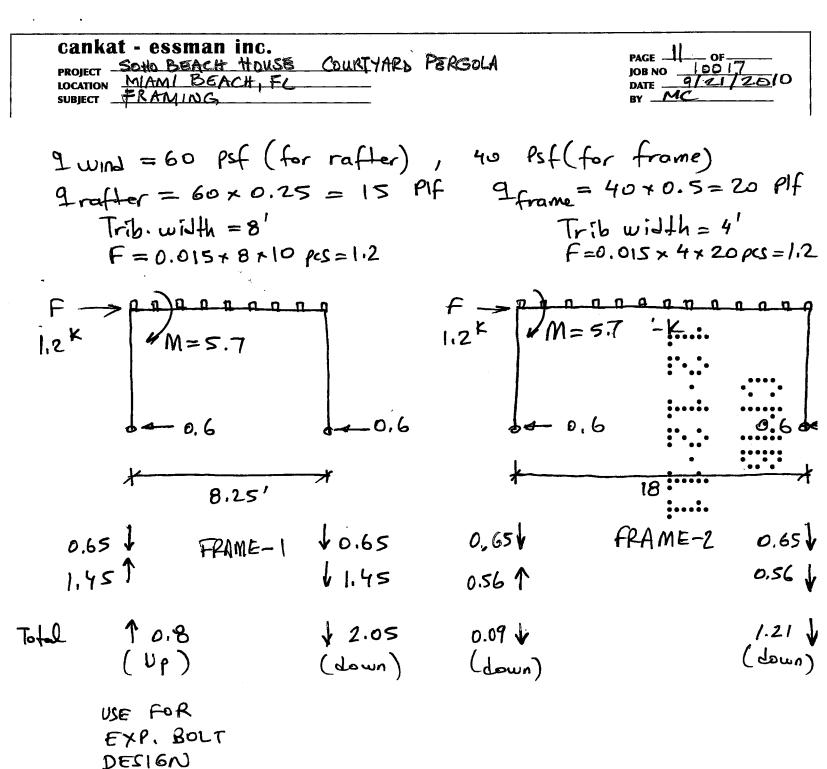

PROJECT SOHD BEACH ITOUSE COURTYARD BERGOLA LOCATION MINING BEACH, FL SUBJECT WOOD RAFTERS 4" x 4" PT, WOOD RAFTERS @ 12" o/c BOUTHERN PINE #2 OR BETTER SOUTHERN PINE #2 Lmax = 11-3" # flo = 1,500 psi stor for 4"wise


Ft = 825 psi

Fv = 175 psi

Fc = 565 psi

E = 1.6 x 10° psi A=12.25 Eq in Sx-x=7.146 in³ I=12.51 in⁴ WW = 60 PS (CONSERVATIVE) CEA. RAFTER WW = GO x 3.5/12 = 17.5 plf. Mw = 17.5 x 11.25/8 Mw = 277 ft-16: flox = 277 x12 = 465 psi < 1,100 psi :...0. K $V = 17.5 \times 11.25/2$ $V = 66 \text{ 1bs.} \uparrow$ 5-4-66 = 7 ps: « 175 ps: L = 247" MAX. CANTILEVER END MCANT = 17.5 x 2.58/2 MCANOT - 58 ft-16 (277 ft-16 DO NOT GOVERN NOTE: NO ADJUSTMENT FACTORS ARE USED SINCE STRESSES ARE NERT LOW ... OK ,


MIAMI, FL 33155 T:305.266.9777 F:305.266.0584	PROJECT: SOHO BEACH HOUSE Courtyard Pergola	JOB NO:	Page: 13 Calc'd: FO
	CLIENT:		Checked FO
	ARCHITECT: ALLAN T. SHULMAN ARCHITECTS, P.A.		Date: 9/2/10

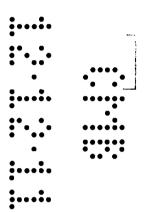


CONNECTIONS

cankat - essman inc. PROJECT SOHO BEACH HOUSE COLLETYARD PERSOLA LOCATION MIAMI BEACH, FLORIDA CONNECTIONS OF POST W/BEAM. MOMENT @ Top CONNECTION 4×6×3/16

455 444x 3/16

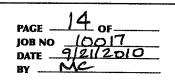


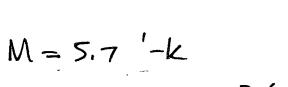

$$S = 4.209 in^3(*)$$


$$f = \frac{5.7 \times 12}{4.207} = 16.25$$

$$F_{W_{ALLOW}} = 0.3 \times 70 \text{ ksi} = 21 \text{ ksi}$$

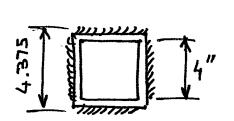

W/EXPANSION BOLTS BASE CONNECTION

FROM PAGE MAXIMUM REACTIONS @ BASE

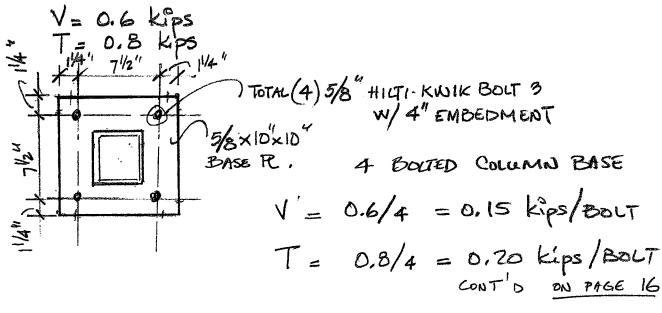

See NEXT PAGE (FAGE -15) FOR WELD SECTION MODULUS,

CANKAT ESSMAN	Project:	SOHO BEACH HOUSE	Engineer:	FO	Page:
1900 SW 57th Ave.			Date:	2-Sep	15
Miami, FL 33155	Subject:	4X4 POST WELD	Checker:	MC	Project #
Tel: (305) 266-9777			Date:	2-Sep	1


PROPERTIES OF SECTION DESCRIBED BY NODES COORDINATES

Units: in

No	des Coor	dinates
	X	Y
1		
2		4,375
3	4.375	
4	4.375	
5		
6	- 0.188	0.188
7	4.188	0.188
8		4,188
9	0.188	4.188
10	0.188	0.188
11		
12		
13		
14		
15		
16		
17		
18		
19		
20		
21		
22		
23		
24		
25		
26		
27		
28		
29		
30		
31		
32		
33		
34	<u> Parakilan</u>	

Abo	Section ut Centroidal Axis	Properties Parallel to Or	loinal Axis
φ =	45.00000 deg	X-dim =	4.3750 in
A=	3.14063 in^2	Y-dim =	4.3750 in
Xcg =	2.18495 in	Sx(top) =	4.1994 in^3
Ycg =	2.18495 in	Sx(bot) =	4.2092 in^3)
lxo =	9.19694 in^4	Sy(left) =	4.2092 in^3
iyo =	9.19694 in^4	Sy(right)=	4.1994 in^3
lxyo =	-0.00002 in^4		

5	ection Properties	About Princip	al Axis
φ =	45.00000 deg	Sxp(top) =	2.9729 in^3
lxp =	9.19696 in^4	Sxp(bot) =	2.9729 in^3
iyp =	9.19691 in^4	Syp(left) =	2.9764 in^3
ixyp =	.0.00000 in^4	Syp(right)=	2.9694 in^3
J=	18.39387 in^4	<u></u>	

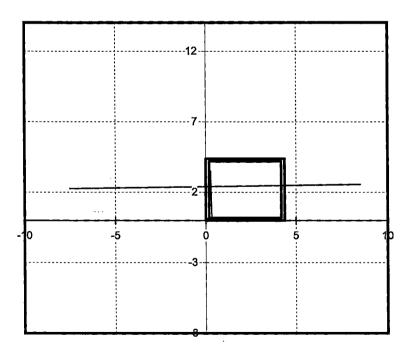

cankat - essman inc. PROJECT SOMO BEACH HOUSE COURTYARD PERGOLA IOB NO LOCATION MIAMI BEACHIFL. CONNECTIONS MIN. EDGE DIST (FOR TENSION =) 1.75x4=7"


FOR SHEAR =) 3x4=12"

BOLT SPACING (T&V) => 3x4=12" ALL COLUMNS WITH THE EXCEPTION OF COLUMNS NEXT TO TREACH HAVE MORE THAN 12" EDGE DISTANCE. CHECK COLUMN BASE NEXT TO TRENCH. EDGE DISTANCE = 5" (WORST CONDITION) & Grominal = 4" (EMBEDMENT) ADJUSTMENT FACTORS TENSION/SHEAR (Spacing) 7/2 => == 2:35 (Edge Distance) = 5"= fen=0.9. ENSION (Edge Distance) = 5 =) fri 0.6 .. SHEAR TENSION CAP/PER BOLT (CONCRETE &=3000 758) $T = 2.87 \times 0.96 \times 0.9$ T = 2.47 > 0.2 kg = 0kSHEAR CAP / PER BOLT V= 4,89 x0,80 x 0,96 x 0.61 20% REDUCTION ok. V = 2,29 Kips > 0.15 kips COMBINED TENSION & SHEAR (0.2/2.47) + (0.15/2.29) = 0.14 % 1.0 ok.WOOD RAFTER TO STEEL TUBE COUNECTION PULL OUT @ END CONNECTION (FROM PAGE 12) 66 165/(0.25x4297)

* SEE APPENDIX ITW BUILDEX 1/4-20 × 3 SELF DRILLING SCREWS ALL OTHER CONNECTION, REACTIONS ARE LOW & BY ENSPECTION. OK.

PAGE - 17

MIAMI, FL 33155 PROJECT: **SOHO BEACH HOUSE Courtyard Pergola** JOB NO: Page: T:305.266.9777 F:305.266.0584 Calc'd: FO CLIENT: Checked FO ARCHITECT: **ALLAN T. SHULMAN ARCHITECTS, P.A.** Date: 9/2/10

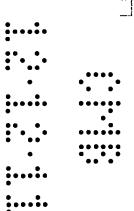

APPENDIX



BUILDING CODE COMPLIANCE OFFICE (BCCO) PRODUCT CONTROL DIVISION

MIAMI-DADE COUNTY, FLORIDA METRO-DADE FLAGLER BUILDING 140 WEST FLAGLER STREET, SUITE 1603 MIAMI, FLORIDA 33130-1563 (305) 375-2901 FAX (305) 375-2908

NOTICE OF ACCEPTANCE (NOA)

Hilti, Inc. 5400 S. 122nd East Avenue Tulsa OK 74146

SCOPE:

This NOA is being issued under the applicable rules and regulations governing the use of construction materials. The documentation submitted has been reviewed by Miami-Dade County Product Control Division and accepted by the Board of Rules and Appeals (BORA) to be used in Miami Dade County and other areas where allowed by the Authority Having Jurisdiction (AHJ).

This NOA shall not be valid after the Technical additionated the less of the Missing Pade County Product Control Division (In Miami Dade County) and the Missing Reason the Missing Pade County) are single to have this product or material tested for additional field of the Missing Reason that the field of the field of the county of the co

This product is approved as described herein, and has been designed to comply with the Florida Building Gode including the High Velocity Hurricane Zone.

DESCRIPTION: Kwik Bolt 3 Concrete Expansion Anchor.

APPROVAL DOCUMENT: Drawing No. 543-003-C, Sheets 1 of 1, titled "Hilti Kwik Bolt 3 Mechanical Expansion Anchor for Concrete and Masonry Elements" dated 11/12/98 with last revision on 10/31/06, prepared by T. E. Lunn PE Engineering, signed and sealed by T. E. Lunn PE, bearing the Miami-Dade County Product Control Approval stamp with the Notice of Acceptance (NOA) number and approval date by the Miami-Dade County Product Control Division.

MISSILE IMPACT RATING: None

LABELING: Each unit or box shall bear a permanent label with the manufacturer's name or logo, city, state and following statement: "Miami-Dade County Product Control Approved or MDCPCA", unless otherwise noted herein.

RENEWAL of this NOA shall be considered after a renewal application has been filed and there has been no change in the applicable building code negatively affecting the performance of this product.

TERMINATION of this NOA will occur after the expiration date or if there has been a revision or change in the materials, use, and/or manufacture of the product or process. Misuse of this NOA as an endorsement of any product, for sales, advertising or any other purposes shall automatically terminate this NOA. Failure to comply with any section of this NOA shall be cause for termination and removal of NOA.

ADVERTISEMENT: The NOA number preceded by the words Miami-Dade County, Florida, and followed by the expiration date may be displayed in advertising literature. If any portion of the NOA is displayed, then it shall be done in its entirety.

INSPECTION: A copy of this entire NOA shall be provided to the user by the manufacturer or its distributors and shall be available for inspection at the job site at the request of the Building Official.

This NOA consist of this page 1, evidence page as well as approval document mentioned above.

The submitted documentation was reviewed by Candido F. Font. P.E.

12/28/06

NOA No 06-0810.13 Expiration Date: December 28, 2011 Approval Date: December 28, 2006

Page |

NOTICE OF ACCEPTANCE: EVIDENCE PAGE

A DRAWINGS:

1. Drawings prepared by T.E. Lunn PE Engineering, titled "Hilti Kwik Bolt 3 Mechanical Expansion Anchor for Concrete and Masonry Elements"; Drawing No. 543-003-C, dated 11/12/98 with last revision on 10/31/06, sheet 1 of 1, signed and sealed by T.E. Lunn PE.

-	7555
В	TEST:

	Laboratory No.	Test Report.	Date.	Signature
1.	CEL 51792C	ASTM E488	05/22/06	L.W. Mattis PE.
2.	STTS 99-0513.01	ASTM G85 Annex 5	08/25/05	M. Mosbat PE.

C CALCULATIONS:

N/A	Δ.
11//	`

D QUALITY ASSURANCE.

- 1. Building Code Compliance Office.
- E MATERIAL CERTIFICATIONS: N/A

F STATEMENTS:

- 1. No interest letter issued by T.E. Lunn on 07/20/06, signed and sealed by T.E. Lunn, PE.
- 2. Code compliance letter issued by T.E. Lunn on 07/20/06 signed and sealed by T. E. Lunn, PE.


Candido F. Font, P.E.

Senior Product Control Examiner NOA No 06-0810.13

Expiration Date: December 28, 2011 Approval Date: December 28, 2006



HILTI Kwik Bolt 3 is a stud type expansion anchor with a single piece wedge which expands in concrete and CMU when torque is applied, they are supplied. with a nut and washer.

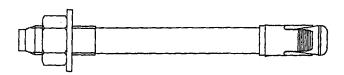

Anchor	Fracture
Diameter (in.)	Load (lb)
1/4	2,900
3/8	7,200
1/2	12,400
5/8	19,600
3/4	28,700

MATERIAL CHARACTERISTICS:

1" carbon steel studs, conform to AISI 11L41. Nuts are carbon steel conforming to ASTM A563 Grade A and meet dimensional requirements of ANSI B18.2.2. Washers are made from carbon steel conforming to ASTM F844 and meet dimensional requirements of ANSI 18.22.1 Type A plain.

All 3/8", 1/2", 5/8", and 3/4" wedges are made from carbon steel.


All 1/4" and 1" wedges are made from stainless steel.

GENERAL NOTES:

- 1) Design values in pounds are equal to ultimate load divided by 4.
- 2) Edge distance shall be 1.75 times the minimum embedment for tension and 3 times the minimum embedment for shear. Anchor center to center distance shall be 3 times the minimum embedment.
- 3) Anchor installation shall be made in accordance with Hilti's published installation instructions in the Product Technical Guide. Limit one anchor per cell.
- 4) Anchor installation in grouted concrete masonry units require a minimum 12" distance and 8" spacing. Limit one anchor per cell. Avoid installation within 1-3/8" of any vertical mortar
- joint. See Figure 1. 5) Values shown are for shear plane through the anchor
- body. 6) When the shear plane is acting through the anchor
- threads, reduce the shear by 10%. 7) When the shear plane is acting through the anchor threads, reduce the shear by 6%
- 8) When the shear plane is acting through the anchor threads, reduce the shear by 20%.

DESIGN VALUES:

Dia.	Min. Embed.	3000		CMU Grouted		
(in.)	(in.)	Tension	Shear	Tension	Shear	
1/4	<u>.</u> 2	623	458	_	-	
3/8	2-1/2	1355	1460 ⁶	780	1155	
1/2	3-1/2	2185	2343 7	905	1723	
5/8	4	2870	4885 8	. 1295	1723	
3/4	4-3/4	3635	6173	-		
1	6	4808	9200	-		

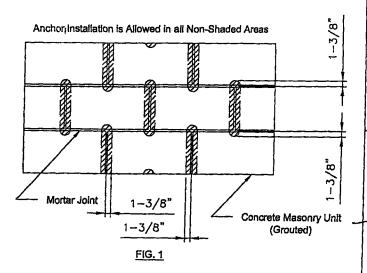

₩ ENGINEERING

LUNN 23 THURSTON DR. PALM BEACH GARDENS, FL. 33418 OFC: (561 625-6455 FAX: (561)625-4883

FLORIDA REG. # 26119

HILTI, INC. 5400 S 122nd E Ave Tulsa, OK 74146


HILTI KWIK BOLT 3 MECHANICAL **EXPANSION ANCHOR** FOR CONCRETE AND MANSONRY **ELEMENTS**

REVISION DATE: 31-10-06 DATE: 11-12-98 DRAWING: 543-003-C SCALE: 1" = 1"SHEET NO. 1 OF 1

FOR OFFICE USE

SELF-DRILLING FASTENERS

Selector Guide

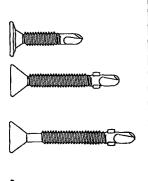

Part Number	Description	Head Style	Drill Point	Drill & Tap Capacity	Wood Attachment Range	Applications
1077000	10-24 x 3/4"	Wafer	#3	.036175	1/4"-3/8"	Plywood, mansard, fascia
1079000	10-24 x 1"	Wafer	#3	.036175	1/4"-1/2"	roofing, flooring to steel
1082000	10-24 x 1-7/16"	PFH ww	#3	.060175	1/4"-3/4"	framing.
1087000	10-16 x 1-13/16"	PFH	#3	.036175	1/4"-3/4"	
1092000	12-24 x 2-1/4"	PFH w/w*	#4	.125250	3/4"-1-3/8"	• Plywood, 2 X 4's header.
1094000	12-24 x 2-3/4"	PFH w/w*	#4	.125250	3/4"-1-5/8"	to steel framing.
1096000	1/4-20 x 3"	PFH www *ww with wing	#4 js	.125250	3/4"-2"	• 2 X 4's to steel framing.

Performance Data

		PUL	LOUT	VALU	JES (a	verag	e lbs	. ultin	nate)		
Fastener Steel Gauge											
Dia.	Pt.	26	24	22	20	18	16	14	12	3/16	1/4
#10	3				299	499	708	967	1474		
#12	4.5			20	3 177		683	923	1508	3865	4101
1/4	4	2 32	H. W.		14.74		788	1116	1803	4297	

FASTENER VALUES							
Fastener (dia-tpi)			Torque (min. in. ibs.)				
10-16 T/3	1936	1400	61				
10-24 T/3	2702	1500	65				
12-24 T/4	3165	2200	150				
1/4-20	(3860)	(2700)	168				

SHEET STEEL GAUGES									
Gauge No.	12	14	16•	18	20	22	24	2	
Decimal Equivalent	.105"	.075"	.060"	.048"	.036"	.036"	.024"	.0	

SHEAR VALUES (average lbs. ultimate)								
Fast	ener	Steel Gauge (lapped)						
Dia.	Pt.	20	18	16	.14	12:	118	1/4
#10	3	728	1266	1540	1522			
#12	4.5					2641	2887	2897
1/4	4				•••	2650	2820	

The values listed are ultimate averages achieved under laboratory conditions and app Buildex manufactured fasteners only. Appropriate safety factors should be applied to 1 values for design purposes.

Installation Guidelines



A standard screwgun with a depth sensitive nosepiece should be used to install Teks. For optimal fastener performance, the screwgun should be a minimum of 4 amps and have a RPM range of 0-2000.



Adjust the screwgun nosepiece to properly seat the fastener.



Worn or damaged bit tip should be replaced.



The fastener is fully seated when the head is flush with the work surface.

Overdriving may result in torsional failure of the faster or stripout of the substrate.



The fastener must penetrate beyond the metal structu minimum of 3 pitches of thread.



All #10 diameter "Winged" parts must be driven into a minimum of 16 GA steel thickness; all 1/4 and #12 diameter "Winged" parts must be driven into a minimu of 1/8" steel in order to break the wings consistently.

TW Buildex

Teks®, Climaseal™ and Building Ideas that Work™ a trademarks of ITW Buildex and Illinois Tool Works In




BUILDING IDEAS THAT WORK™


1349 West Bryn Mawr Avenue Itasca, Illinois 60143


630/595-3500 FAX: 630/595-3549

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REVISIONS BY

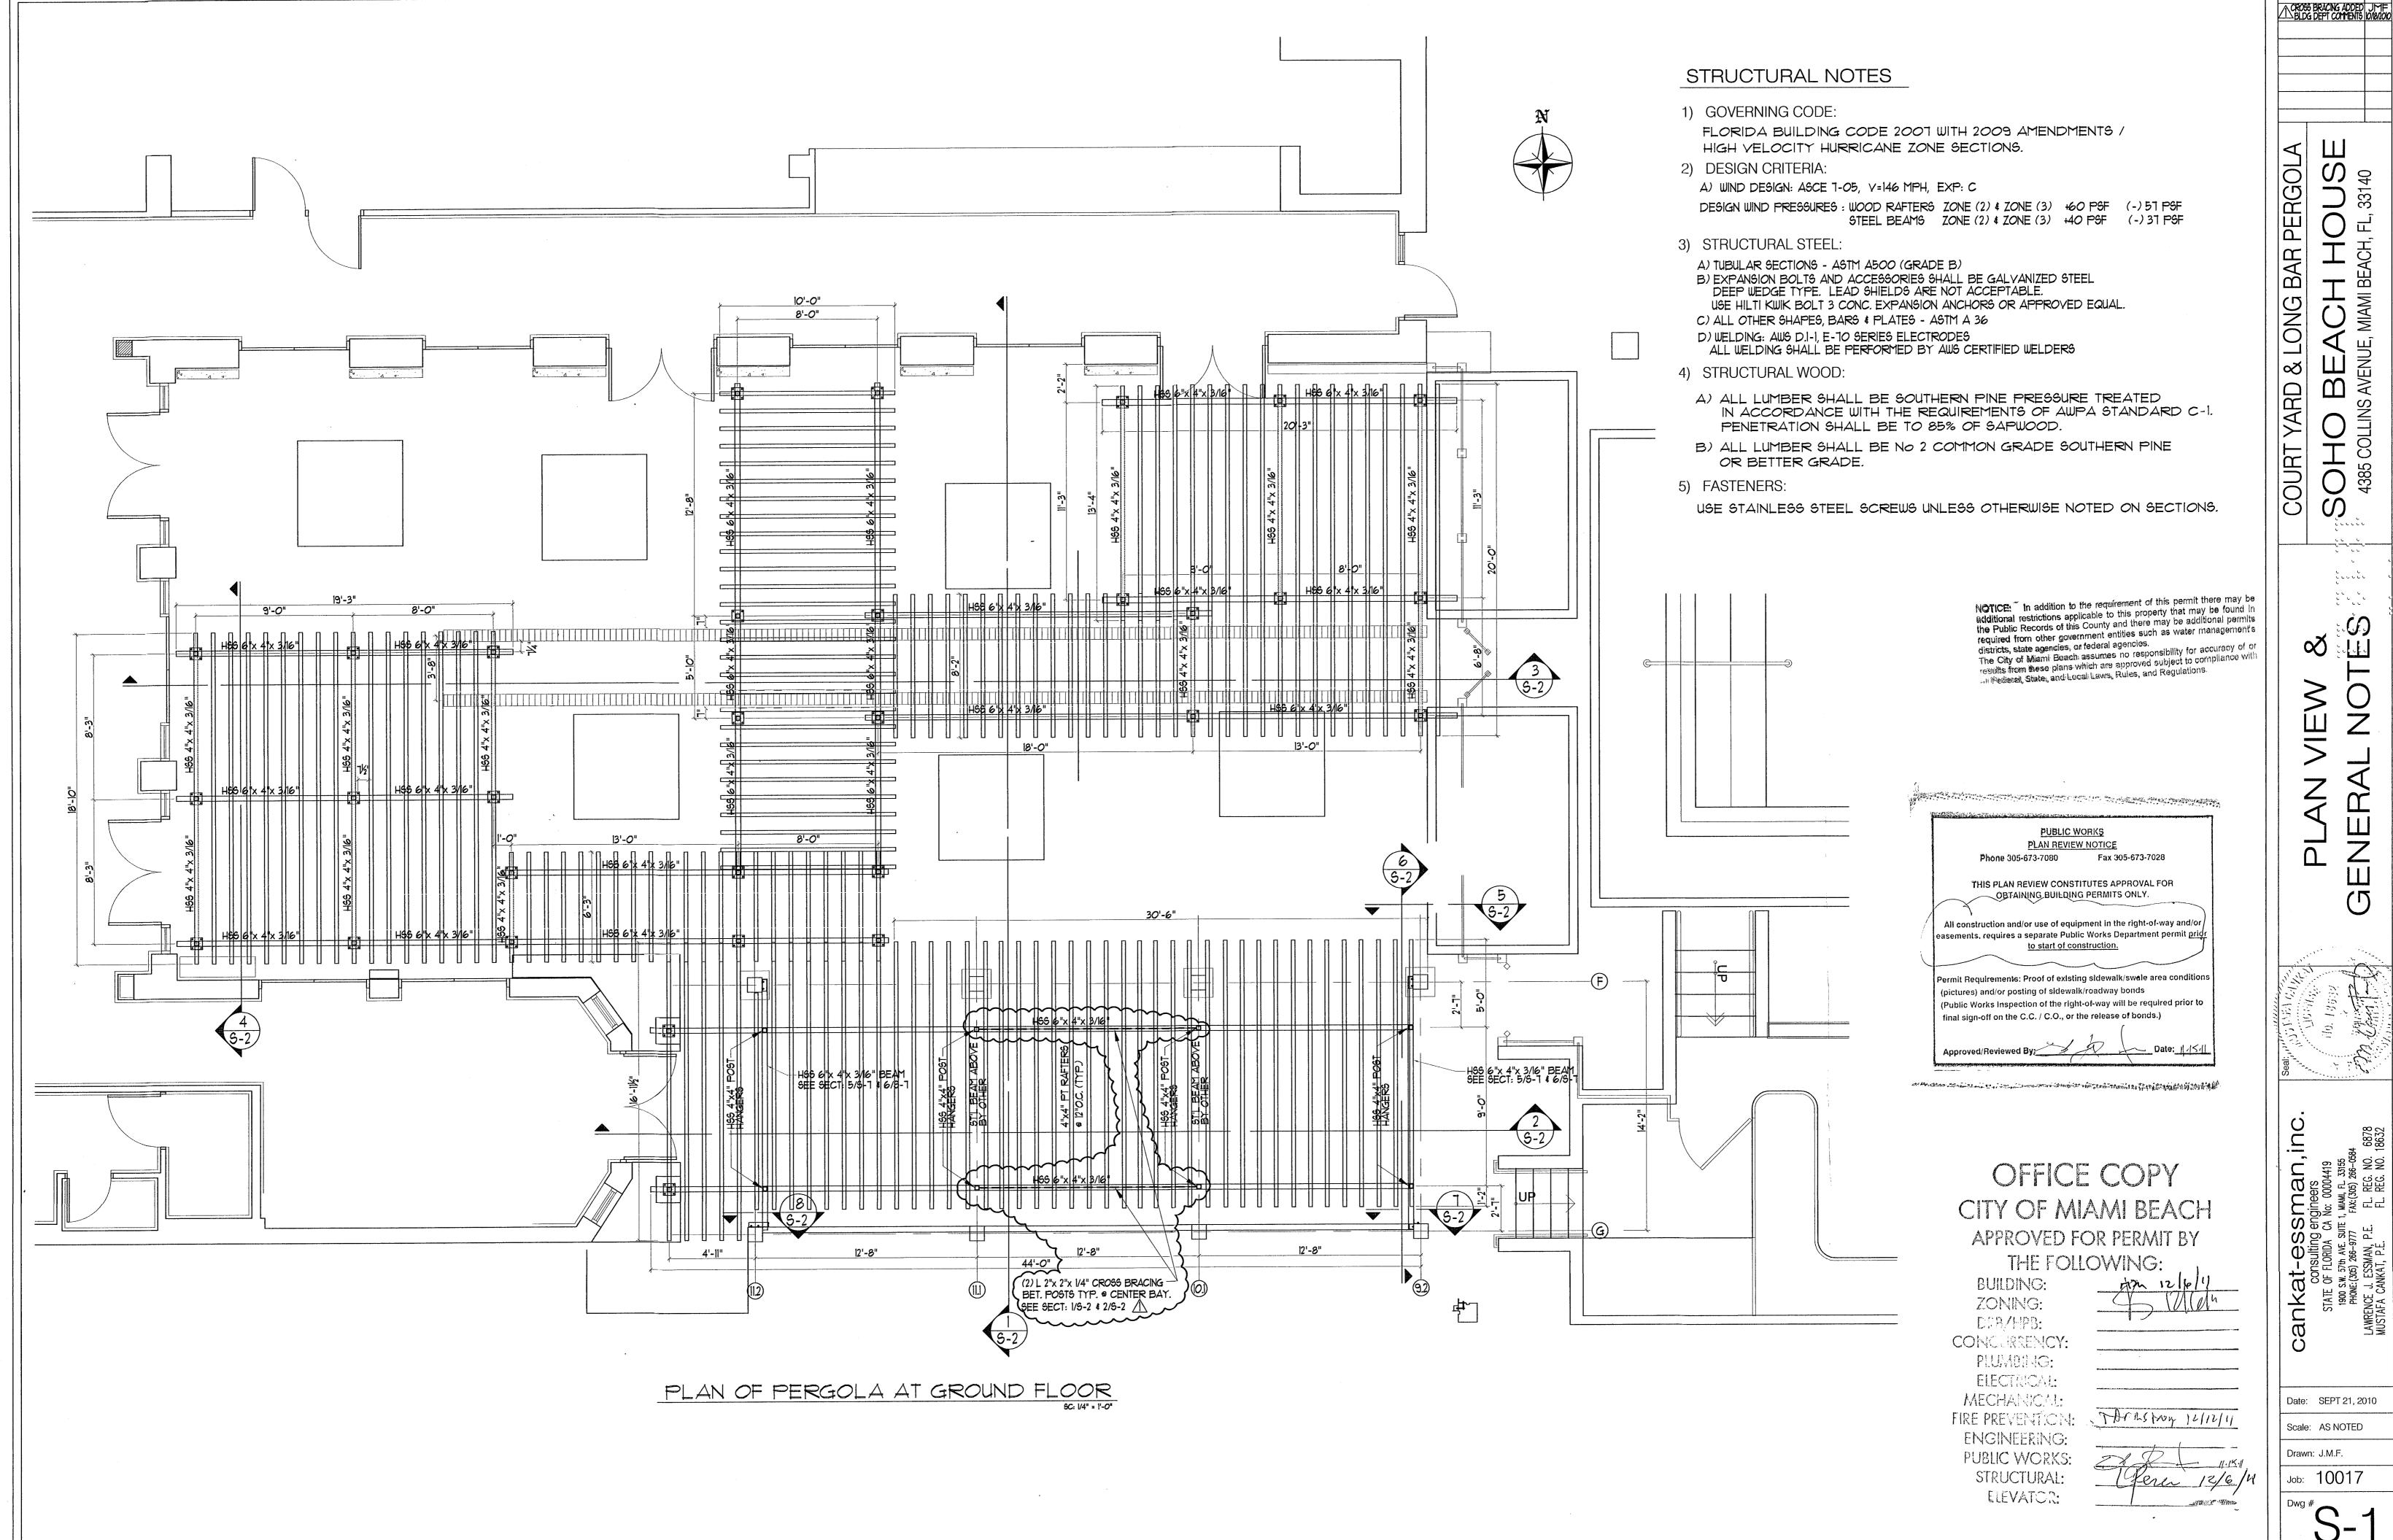

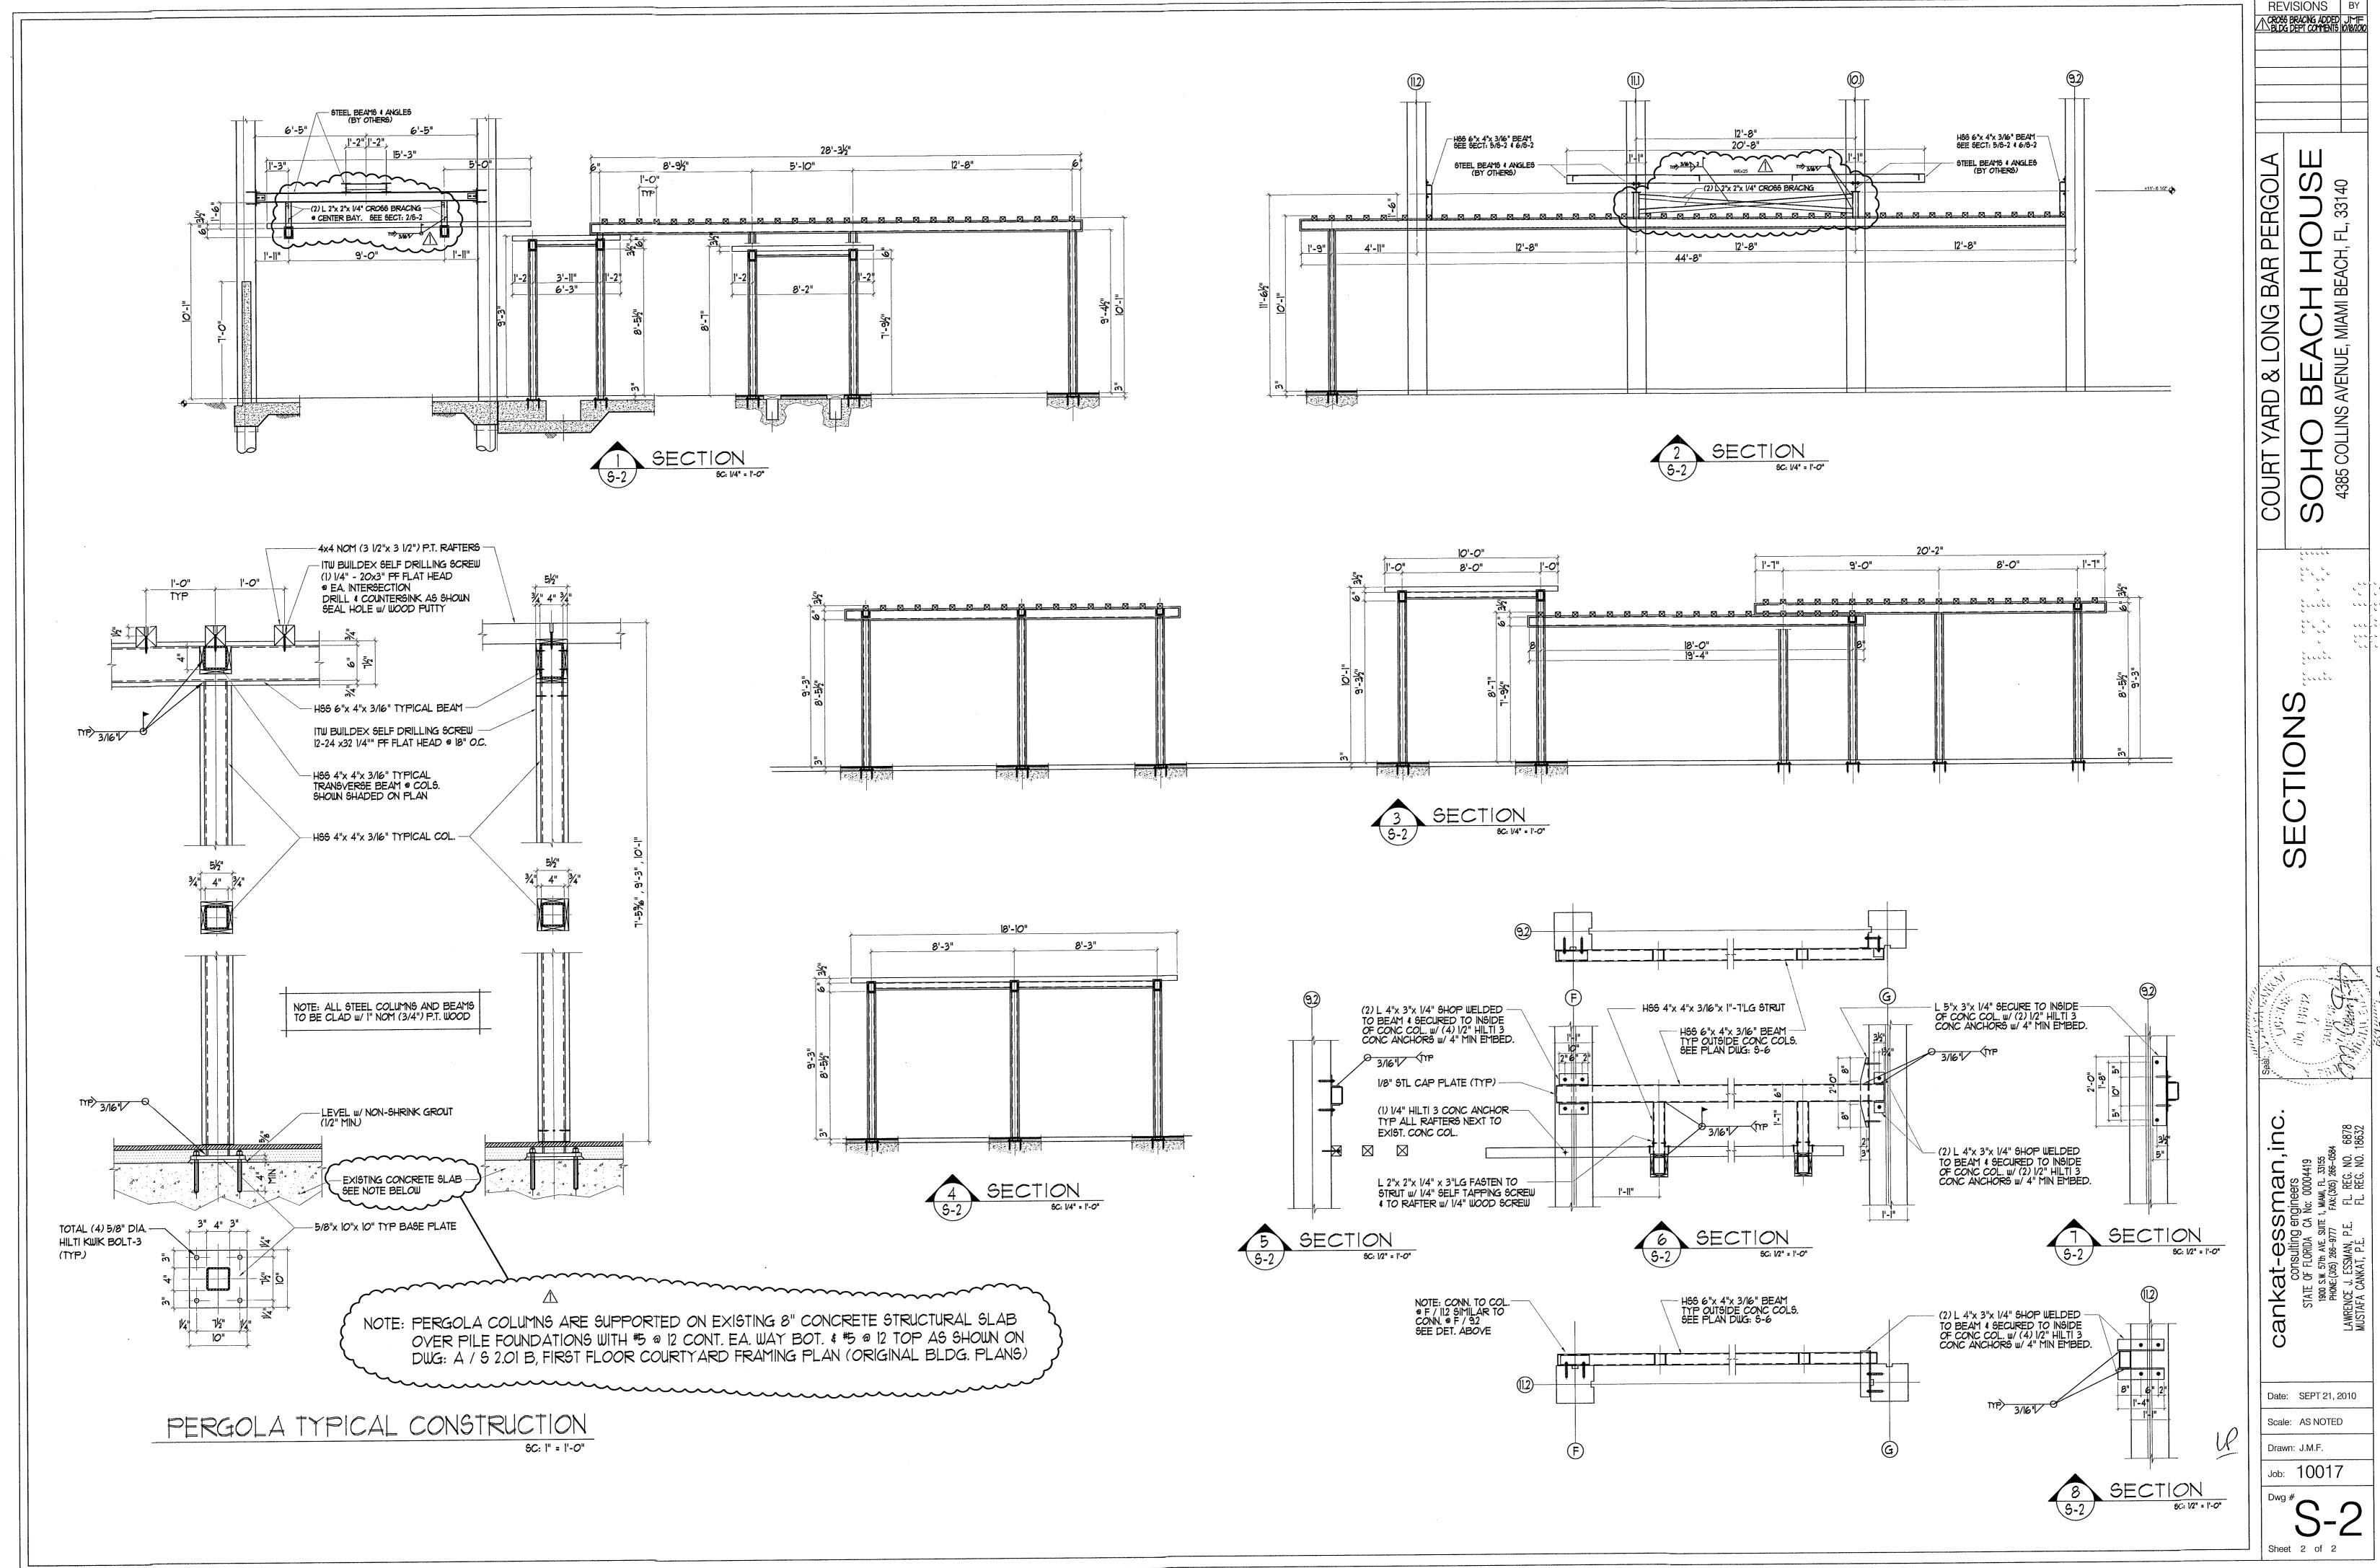

PROPOSED SITE PLAN

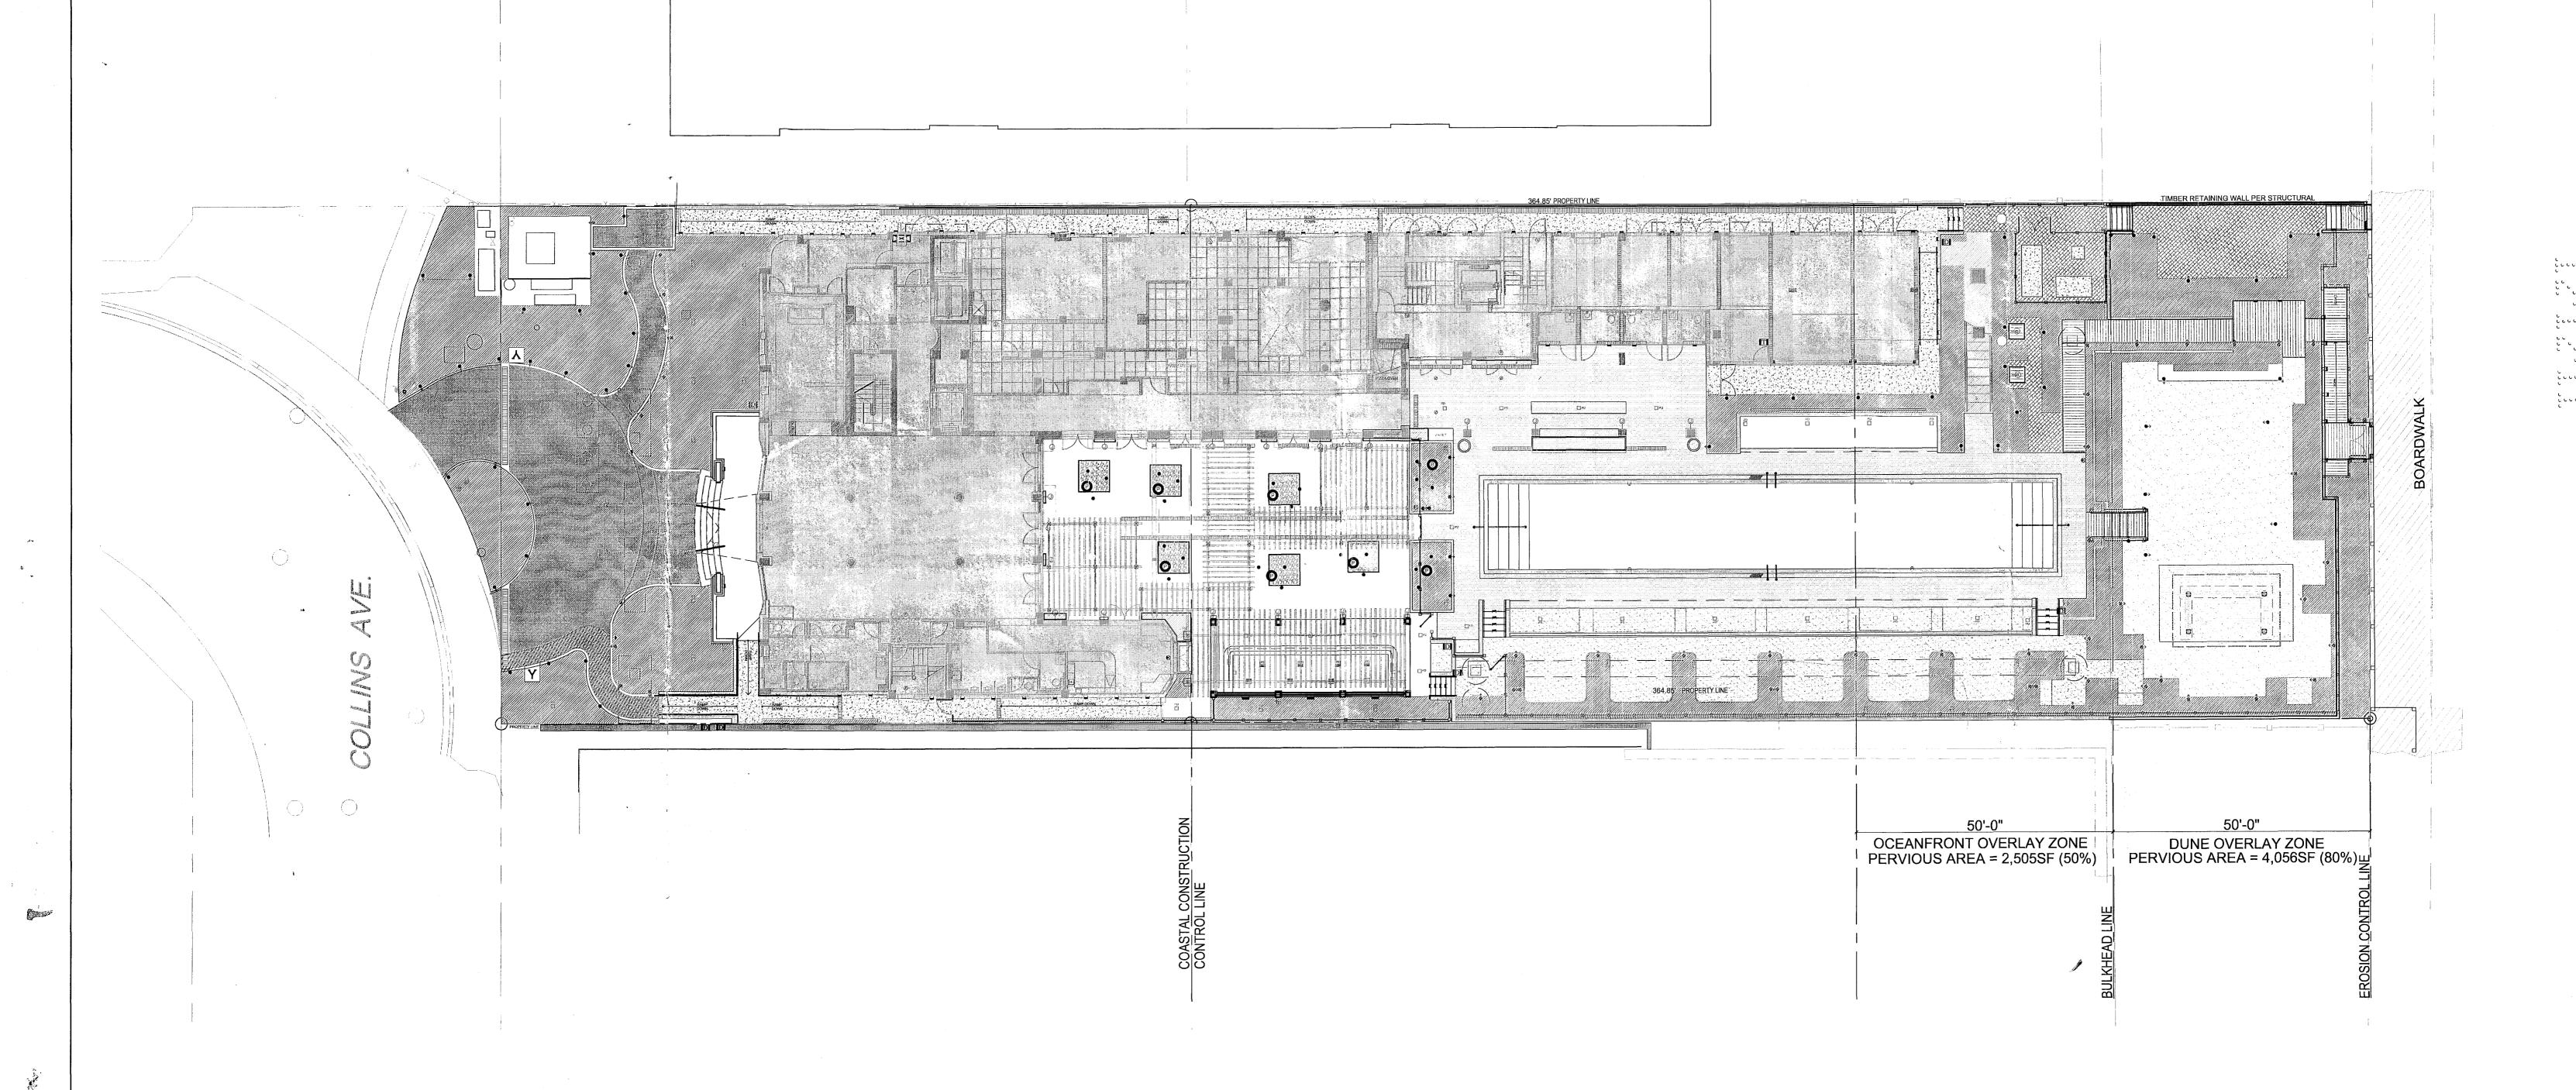NOT TO SCALE

ALLANT. SHULMAN ARCHITECT, P.A


The second of th

100 NE 38TH STREET, SPACE #2 MIAMI, FL 33137 TEL: 305.438.0609 FAX: 305.438.0170

LANDSCAPE
ARCHITECT

RAYMOND JUNGLES INCORPORATED
Landscape Architect ASLA
242 SW 5th Street, Miami, FL 33130
PH (305)858.6777 FAX (305)856.0742
www.raymondjungles.com



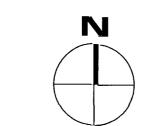

SOHO BEACH HOUSE
4385 COLLINS AVENUE, MIAMI BEACH, FL, 33140
JOB NO. 06023

L-1.00 RENOVATION AND ADDITION

