MAXIMUM MEDICINE CABINET MACH. MACHINE MECH. MECHANICAL MEMB MEMBRANE MET. METAL MANUFACTURER MANHOLE MINIMUM MIRROR **MISCELLANEOUS** MATCH LINE MASONRY OPENING MOUNTED MULLION

NORTH

NUMBER

QUARRY TILE

NOT IN CONTRACT

TRD.

T.B.

T.C.

TEL.

TEMP

T. & G.

THK.

TOIL.

T.P.

T.P.D.

T.V.

T.W.

T.O.B.

T.O.C.

T.O.S.

VERT.

V.T.

VEST.

V.B.

WSCT.

TREAD

TOWEL BAR

TOP OF CURB

TELEPHONE

TELEVISION

TOP OF WALL

TYPICAL TOP OF BEAM

TOP OF SLAB

UNFINISHED

TOP OF CONCRETE

TONGUE AND GROOVE

TOILET PAPER DISPENSER

UNLESS OTHERWISE NOTED

UNDERWRITERS LAB

VERIFY IN FIELD

VAPOR BARRIER

WATER CLOSET

VERTICAL

VINYL TILE

VESTIBULE

WEST

WITH

WEIGHT

WOOD WITHOUT WATERPROOF

WAINSCOT

TOP OF PAVEMENT

TEMPERED

THICK

TOILET

ELEVATION NOMINAL N.T.S. NOT TO SCALE ELECTRICAL **ELEVATOR EMERGENCY** EMER. **OVERALL ENCLOSURE ENCL** OBSCURE E.P. ELECTRICAL PANEL BOARD ON CENTER EQ. **OUTSIDE DIMENSION** EQPT. **EQUIPMENT** OFFICE E.S EMERGENCY OVERFLOW OPNG. OPENING SCUPPER OPPOSITE HAND **ELECTRIC WATER COOLER** EXST. **EXISTING** EXP0. **EXPOSED** EXP. **EXPANSION** EXT. **EXTERIOR**

DBL.

D.F.

DET.

DIA.

DIM.

DISP.

DN.

D.O.

DWR.

D.S.P.

DWG.

F.B.

F.D.

F.E.

F.S.

FTG.

FUT.

F.V. F.V.C.

FURR.

FURRING

FUTURE

FIELD VERIFY

FIRE VALVE CABINET

DEPT.

DOUBLE

DETAIL

DOWN

DOOR

EAST

EACH

DRAWER

DRAWING

DIAMETER

DIMENSION

DISPENSER

DOOR OPENING

DOWN SPOUT

DRY STANDPIPE

EXPANSION JOINT


DEPARTMENT

DRINKING FOUNTAIN

FIRE ALARM PRE-CAST FLAT BAR PROPERTY LINE PRESSURE TREATED FLOOR DRAIN FDN. FOUNDATION PLATE PLASTIC LAMINATE FIRE EXTINGUISHER F.E.C. FIRE EXTINGUISHER CAB. PLAS. PLASTER F.H.C. FIRE HOSE CABINET PLYWD. PLYWOOD FIN. FINISH POLISHED **FLOOR** PAIR **FLASH** FLASHING POINT FLUOR. **FLUORESCENT** PAPER TOWEL F.O.C. FACE OF CONCRETE DISPENSER F.O.F. FACE OF FINISH PARTITION F.O.S. FACE OF STUDS PAPER TOWEL FPRF. **FIREPROOF** RECEPTACLE **FULL SIZE** FOOT OR FEET


MATERIAL LEGEND

insulation blanket

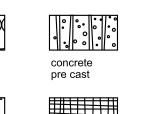

small scale

blocking

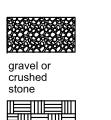



steel


brick

large scale

large scale

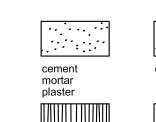

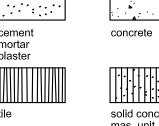


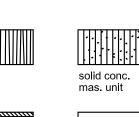


OWNER:

PROJECT ARCHITECT:

FIRE PROTECTION:

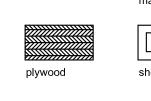

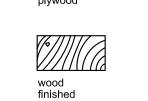

PROJECT TEAM

433 LINCOLN RD LLC 1244 6TH STREET SANTA MONICA, CA 90401

Phone: (310) 319. 1600 BEILINSON GOMEZ ARCHITECTS PA

JOSE L. GOMEZ AR0015416 8101 BISCAYNE BLVD., SUITE 309-310 MIAMI, FL 33138-4664 TEL. (305) 559.1250 FAX. (305) 551.1740

DRAWING INDEX

ARCHITECTURAL

PROJECT & ZONING INFORMATION

SURVEY

SITE IMAGES

SP-101 SITE PLAN EXIST. FLOOR PLAN & FRONT ELEVATION, SIGNAGE DETAILS

> ARCHITECTURE AAC001062 JOSE L. GOMEZ AR0015416 8101 BISCAYNE BLVD. MIAMI FL 33138-4664 TEL. (305) 559.1250 FAX (305) 551.1740 beilinsonarchitectspa.com


CHITECTSpa

BEILLINSON

SYMBOL LEGEND

REVISION

NUMBER

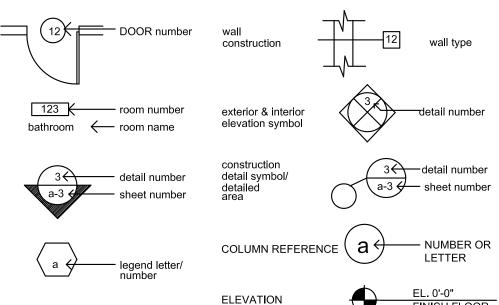

DRAWING REVISION

APPLICABLE CODES

FLORIDA FIRE PREVENTION CODE - 2012 5TH EDITION

GOVERNING ZONING CODE: MIAMI BEACHI, FLORIDA CODE OF ORDINANCE RESIDENTIAL CODE: FLORIDA RESIDENTIAL CODE 2014 **EXISTING BUILDING:** FLORIDA BUILDING CODE: EXISTING BUILDING CODE 2014 STRUCTURAL: FLORIDA BUILDING CODE 2014 PLUMBING: FLORIDA BUILDING CODE 2014 - PLUMBING MECHANICAL: FLORIDA BUILDING CODE 2014 - MECHANICAL ELECTRICAL: FLORIDA BUILDING CODE - 2014 EDITION FLORIDA BUILDING CODE 2014 ACCESSIBILITY:

PROJECT INFORMATION

SCOPE OF WORK


NEW SIGN & ASSOCIATED ARCHITECTURAL CHANGES TO EXISTING HISTORIC FACADE

LEGAL DESCRIPTION

LOT 2 & 3, BLOCK 3 "LINCOLN ROAD SUBDIVISION", ACCORDING TO THE PLAT THEREOF, AS RECORDED IN PLAT BOOK 34, AT PAGE 66, OF THE PUBLIC RECORDS OF MIAMI-DADE COUNTY

ZONING SUMMARY

PROJECT ADDRESS:	433-441 LINCOLN ROAD MIAMI BEACH, FL 33139
FOLIO NUMBER (S):	02-3234-005-0110
ZONING DISTRICT:	CD-3 COMMERCIAL, HIGH INTENSITY
YEAR BUILT:	1940
OCCUPANCY:	MERCANTILE EXISTING RETAIL OUTLET

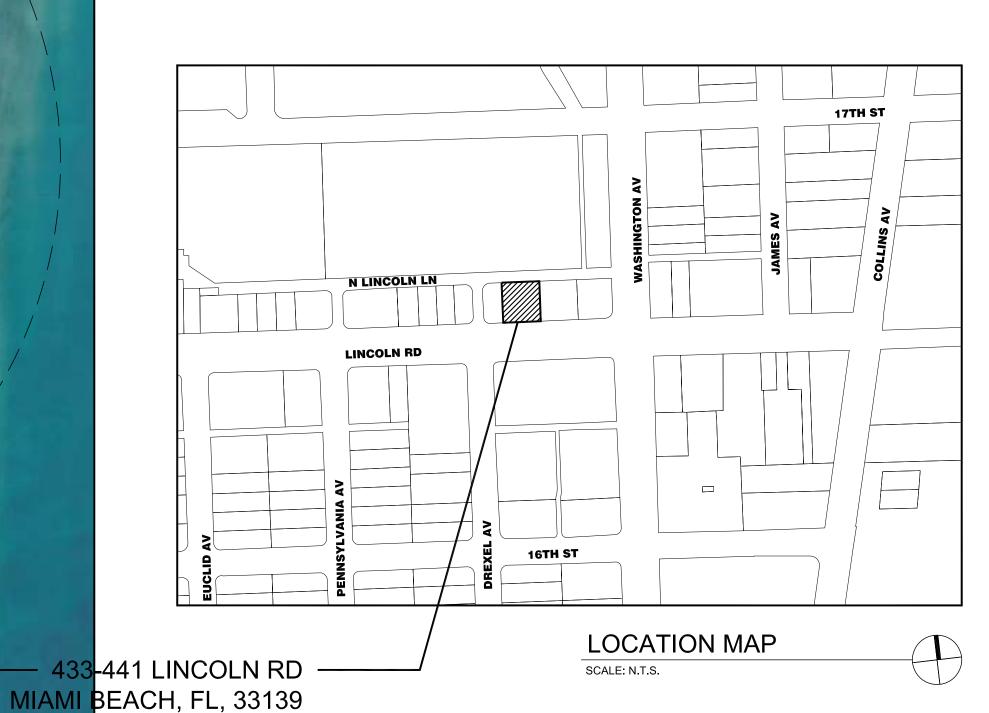

HPB FINAL SUBMITTAL: 04-24-17

RD LINCOLN

433-441 LI

 \triangle date REVISION DWG. TITLE GENERAL NOTES SCALE PROJECT NO.

AS SHOWI

DATE

large scale

blocking

DOOR SYMBOL


room name /


bldg. / partial


symbol


& detail section


finish schedule

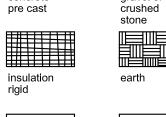


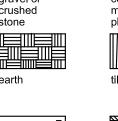

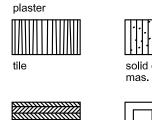

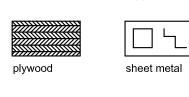


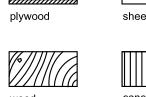

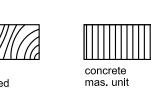



433-441 LINCOLN RD.

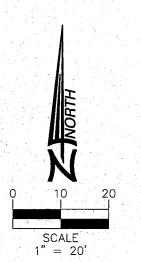

LEGEND:

F.F.E.

= SHADE TREE

= PALM TREE

P.G. = PAGE
P.O.B. = POINT OF BEGINNING
P. = PROPERTY LINE
N.T.S. = NOT TO SCALE

= ELEVATION

= MONUMENT LINE

= CENTRAL ANGLE

_ = TRAFFIC SIGN CATCH BASIN (INLET)

FIRE HYDRANT

WV = WATER VALVE FMV = SEWER VALVE

MAST ARM
WOOD UTILITY POLE
ANCHOR POLE

LP = CONCRETE LIGHT POLE

= ELECTRIC BOX

= CABLE TV BOX

= CONCRETE POWER POLE

= DRAINAGE CATCH BASIN

= WATER OUTLET

= BLOCK

C = CLEANOUT

TELEPHONE MANHOLE

DRAINAGE MANHOLE

SANITARY SEWER MANHOLE

TEMPORARY BENCH MARK

PARKING METER

FLAG POLE

= FLAS POLE

FINISH
FLOOR ELEVATION
= SET IRON REBAR
= POINT OF COMMENCEMENT
= FOUND NAIL
= POINT OF TANCENCY
= ENCROACHMENT
= FOUND IRON PIPE
= FOUND IRON REBAR
= LOWEST FLOOR ELEVATION
= LIGHT POLE
= MEASURED VALUE
= RECORD VALUE

X=TRUNK DIAMETER Y=TREE HIGH Z=CANOPY DIAMETER

----- = RIGHT OF WAY LINE

= PROPERTY LINE = EASEMENT LINE

- X X X = CHAIN LINK FENCE - M - 04 - 04 - 04 = OVERHEAD UTILITY I

CBS WALL

= CONCRETE

= PAVEMENT

_____ = IRON FENCE

= BRICK

= CONCRETI

= TILE

= DRIVEWAY

= DRAINAGE MAINTENANCE EASEMENT

= CANAL MAINTENANCE EASEMENT

= UTILITY EASEMENT

= ARC DISTANCE

= BUILDING

= CATCH BASIN

= CONCRETE BLOCK STRUCTURE

= CHORD DISTANCE

= CALCULATED VALUE

= CLEAR

= CENTER LINE

= POINT OF REVERSE CURVE = POINT OF CURVATURE = FOUND NAIL/DISK = POINT OF COMPOUND CURVE

BASELINE

N.G.Y.D. = NATIONAL GEODETIC VERTICAL DATUM

INV. EL. = INVERT ELEVATION

= PERMANENT CONTROL POIN

CORRUGATED METAL PIPE
POINT OF INTERSECTION

BLOCK CORNER

RADIUS

RADIAL


RESIDENCE
RIGHT OF WAY

SECTION

SET IRON PIPE
TOP OF PIPE
SUPPMLK K

P.B. = PLAT BOOK
P.C.P. = PERMANENT CONTROL POINT

= CENTER LINE = CONCRETE

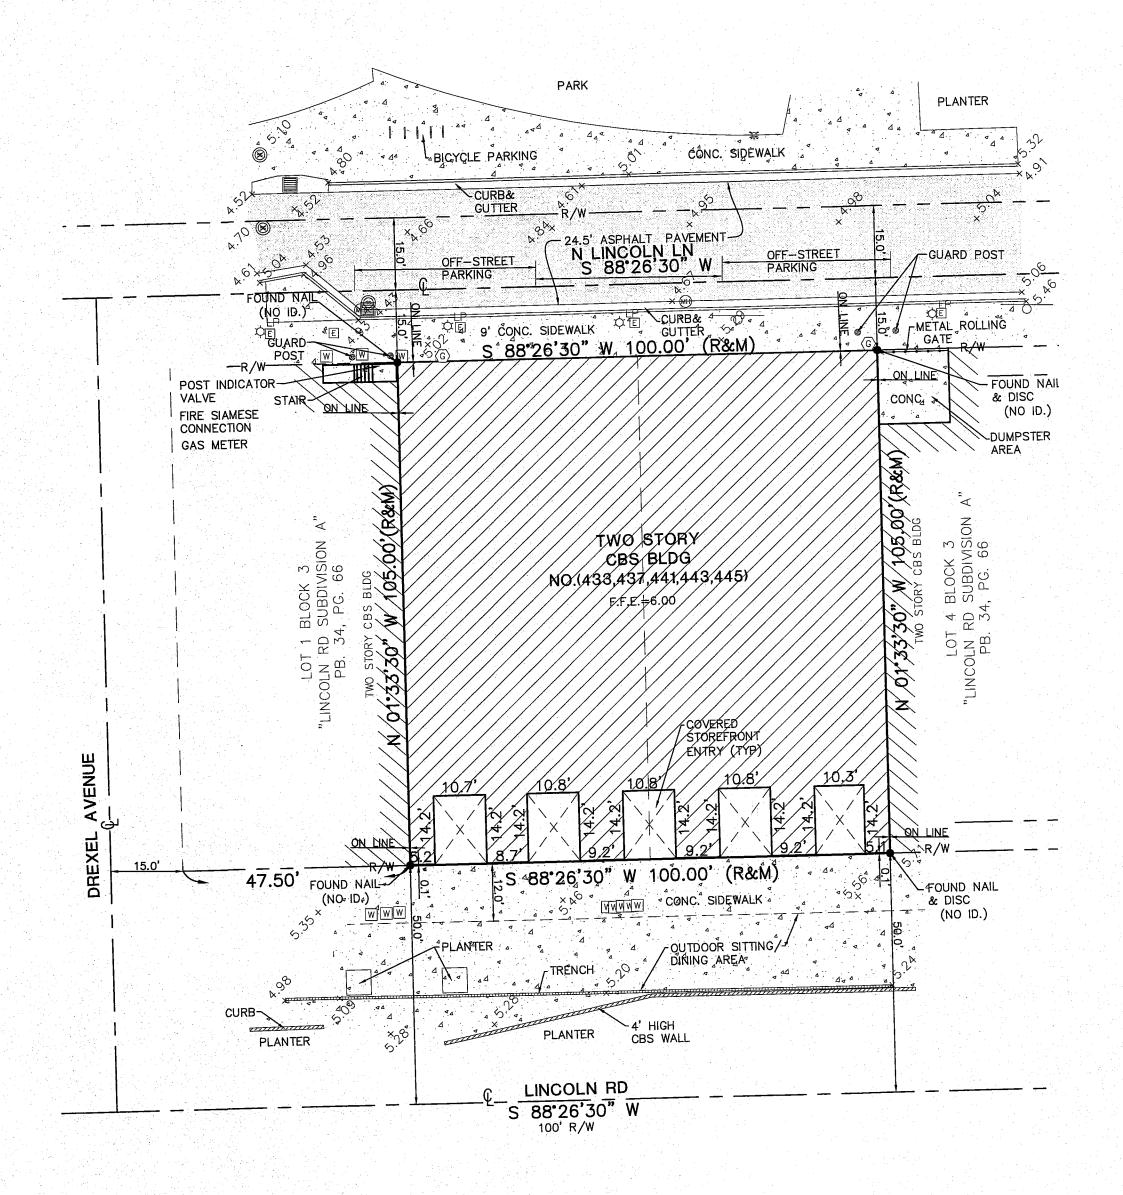

SURVEYOR'S NOTES:

SECTION 1) DATE OF FIELD SURVEY:

1. The date of completion of the field work for the original Survey was on December 27, 2016.

SECTION 2) LEGAL DESCRIPTION:

Lot 2 & 3, Block 3 "LINCOLN ROAD SUBDIVISION", according to the plat thereof, as recorded in Plat Book 34, at Page 66, of the Public Records of Miami-Dade County Florida.

SECTION 3) ACCURACY:

The accuracy obtained by field measurement methods and office calculations of closed geometric figures meets and exceeds the Standards of Practice requirement for this Type of Survey as defined in Rule 5J-17.051, Florida Administrative Code.

Elevations of well identified features as depicted on the Survey Map were measured to an estimated vertical position accuracy of 1/100 of a foot on hard surfaces and 1/10 of a foot on ground surfaces.

Well identified features as depicted on the Survey Map were measured to an estimated horizontal position accuracy of 1/10 of

This Map of Survey is intended to be displayed at a scale of (1"=20') or smaller.

SECTION 4) SOURCES OF DATA:

North arrow direction is based on an assumed Meridian.

Bearings as shown hereon are based upon the Northerly Boundary Line with an assumed bearing of S88°26'30"W, said line to be considered a well established and monumented line.

This property appears to be located in Flood Zone "AE", Elevation 8.0 as per Federal Emergency Management Agency (FEMA) Community Number 120651 (City of Miami-Beach), Map Panel No. 12086C317, Suffix L, Map Revised Date: September 11, 2009.

Legal Description was furnished by client.

Elevations as shown hereon are based on the National Geodetic Vertical Datum of 1929, as per Miami—Dade County's Benchmark Number Y-310-R, Elevation 5.62 feet.

SECTION 34 - TOWNSHIP 53 SOUTH - RANGE 42 EAST



SECTION 5) LIMITATIONS:

Since no other information were furnished other than what is cited in the Sources of Data, the Client is hereby advised that there may be legal restrictions on the Subject Property that are not shown on the Survey Map that may be found in the Public Records of Miami-Dade County.

NOT TO SCALE

The Surveyor makes no representation as to ownership or possession of the Subject Property by any entity or individual who may appear of public records of this County.

No excavation or determination was made as to how the Subject Property is served by utilities.

No improvements were located, other than those shown. No underground foundations, improvements and/or utilities were located or shown hereon.

SECTION 6) CLIENT INFORMATION:

This Boundary Survey was prepared at the request of and certified

Beillinson Gomez Arcitects

SECTION 7) SURVEYOR'S CERTIFICATE:

I hereby certify: That this "Boundary Survey" and the Survey Map resulting therefrom was performed under my direction and is true and correct to the best of my knowledge and belief and further, that said "Boundary Survey" meets the intent of the applicable provisions of the "Standards of Practice for Land Surveying in the State of Florida", pursuant to Rule 5J-17.051 through 5J-17.052 of the Florida Administrative Code and its implementing law. Chapter 472.027 of the Florida Statutes.


HADONNE CORP., a Florida Corporation Florida Certificate of Authorization Number LB7097

Raul Izquierdo, PSM
For the Firm
Registered Surveyor and Majores 156099
State of Florida

NOTICE: Not valid without integrity and original raised seal of a Florida Licensed Surveyor and Masper. Additions or deletions to Survey Maps by other than the signing party are prohibited without the written consent of the signing party.


LAND SURVEYOR AND MAPPERS 3D LASER SCANNING UTILITY COORDINATION 1985 NW 88th Court, Suite 201 · Doral, Fl 33172 · P: +1(305)266-1188 · F: +1(305)207-6845 · W: www.hadonne.com MAP OF BOUNDARY SURVEY BEILLINSON GOMEZ ARCHITECTS 433-445 LINCOLN RD, MIAMI BEACH, FL., 33139

Field Book: FILE 16150 DRAWN BY: BG TECH BY: RI 1/1 QA/QC BY: AH

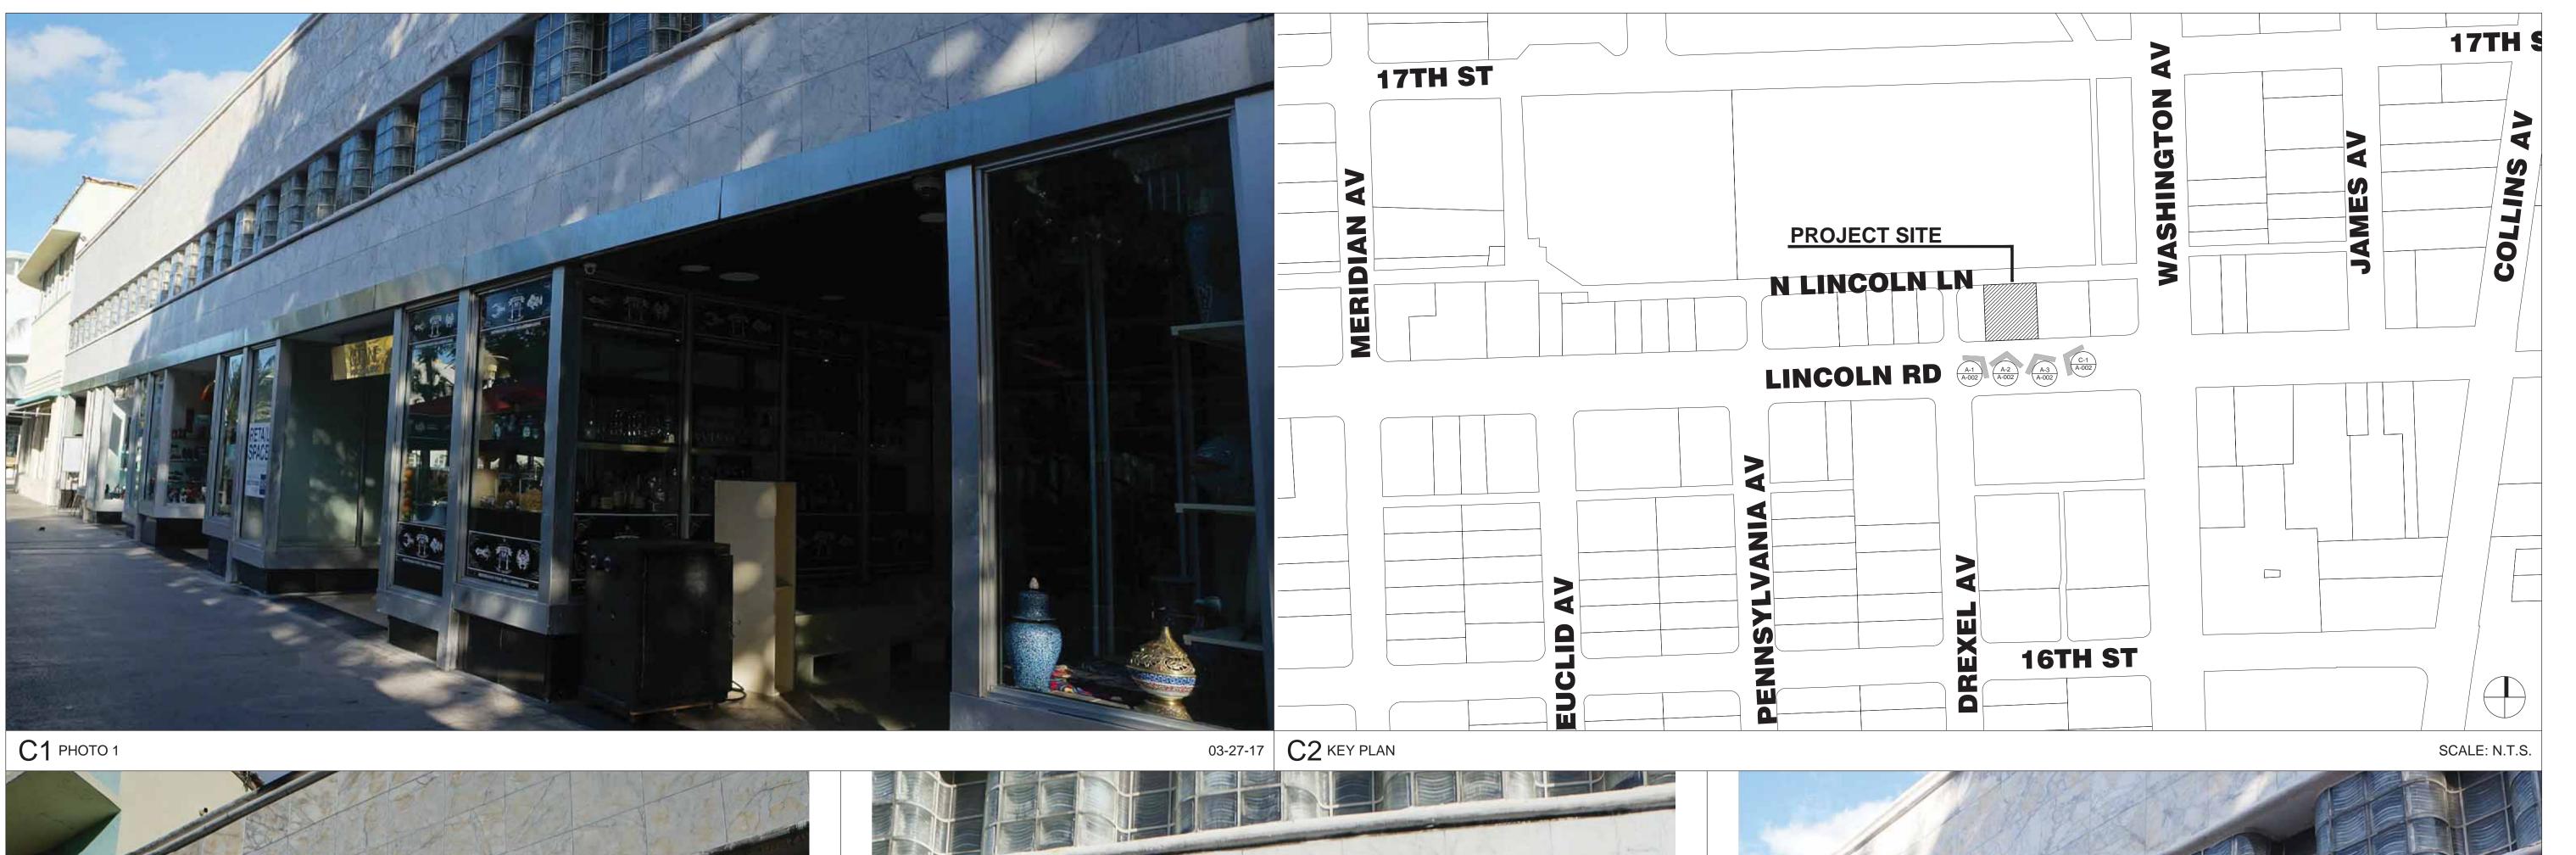



Д1 РНОТО 2

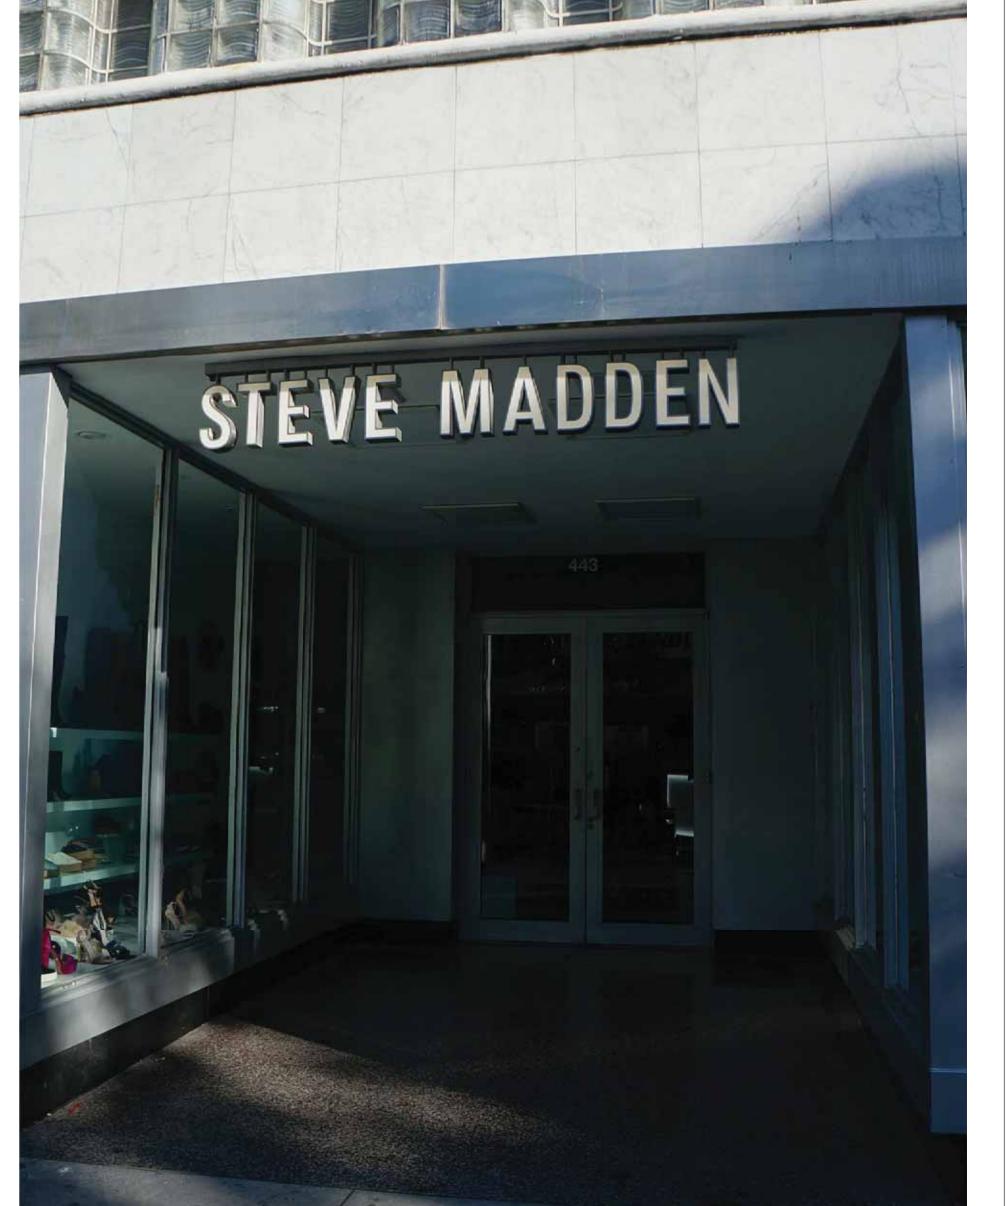



DWG. TITLE

BEILINSON GOMEZ


ARCHITECTURE AAC001062 JOSE L. GOMEZ AR0015416 8101 BISCAYNE BLVD. SUITE 309 MIAMI FL 33138-4664 TEL. (305) 559.1250 FAX (305) 551.1740

AS SHOWN PROJECT NO.

03-27-17 A2 PHOTO 3 03-27-17 A3 PHOTO 4

A-002

SHEET NUMBER 03-27-17

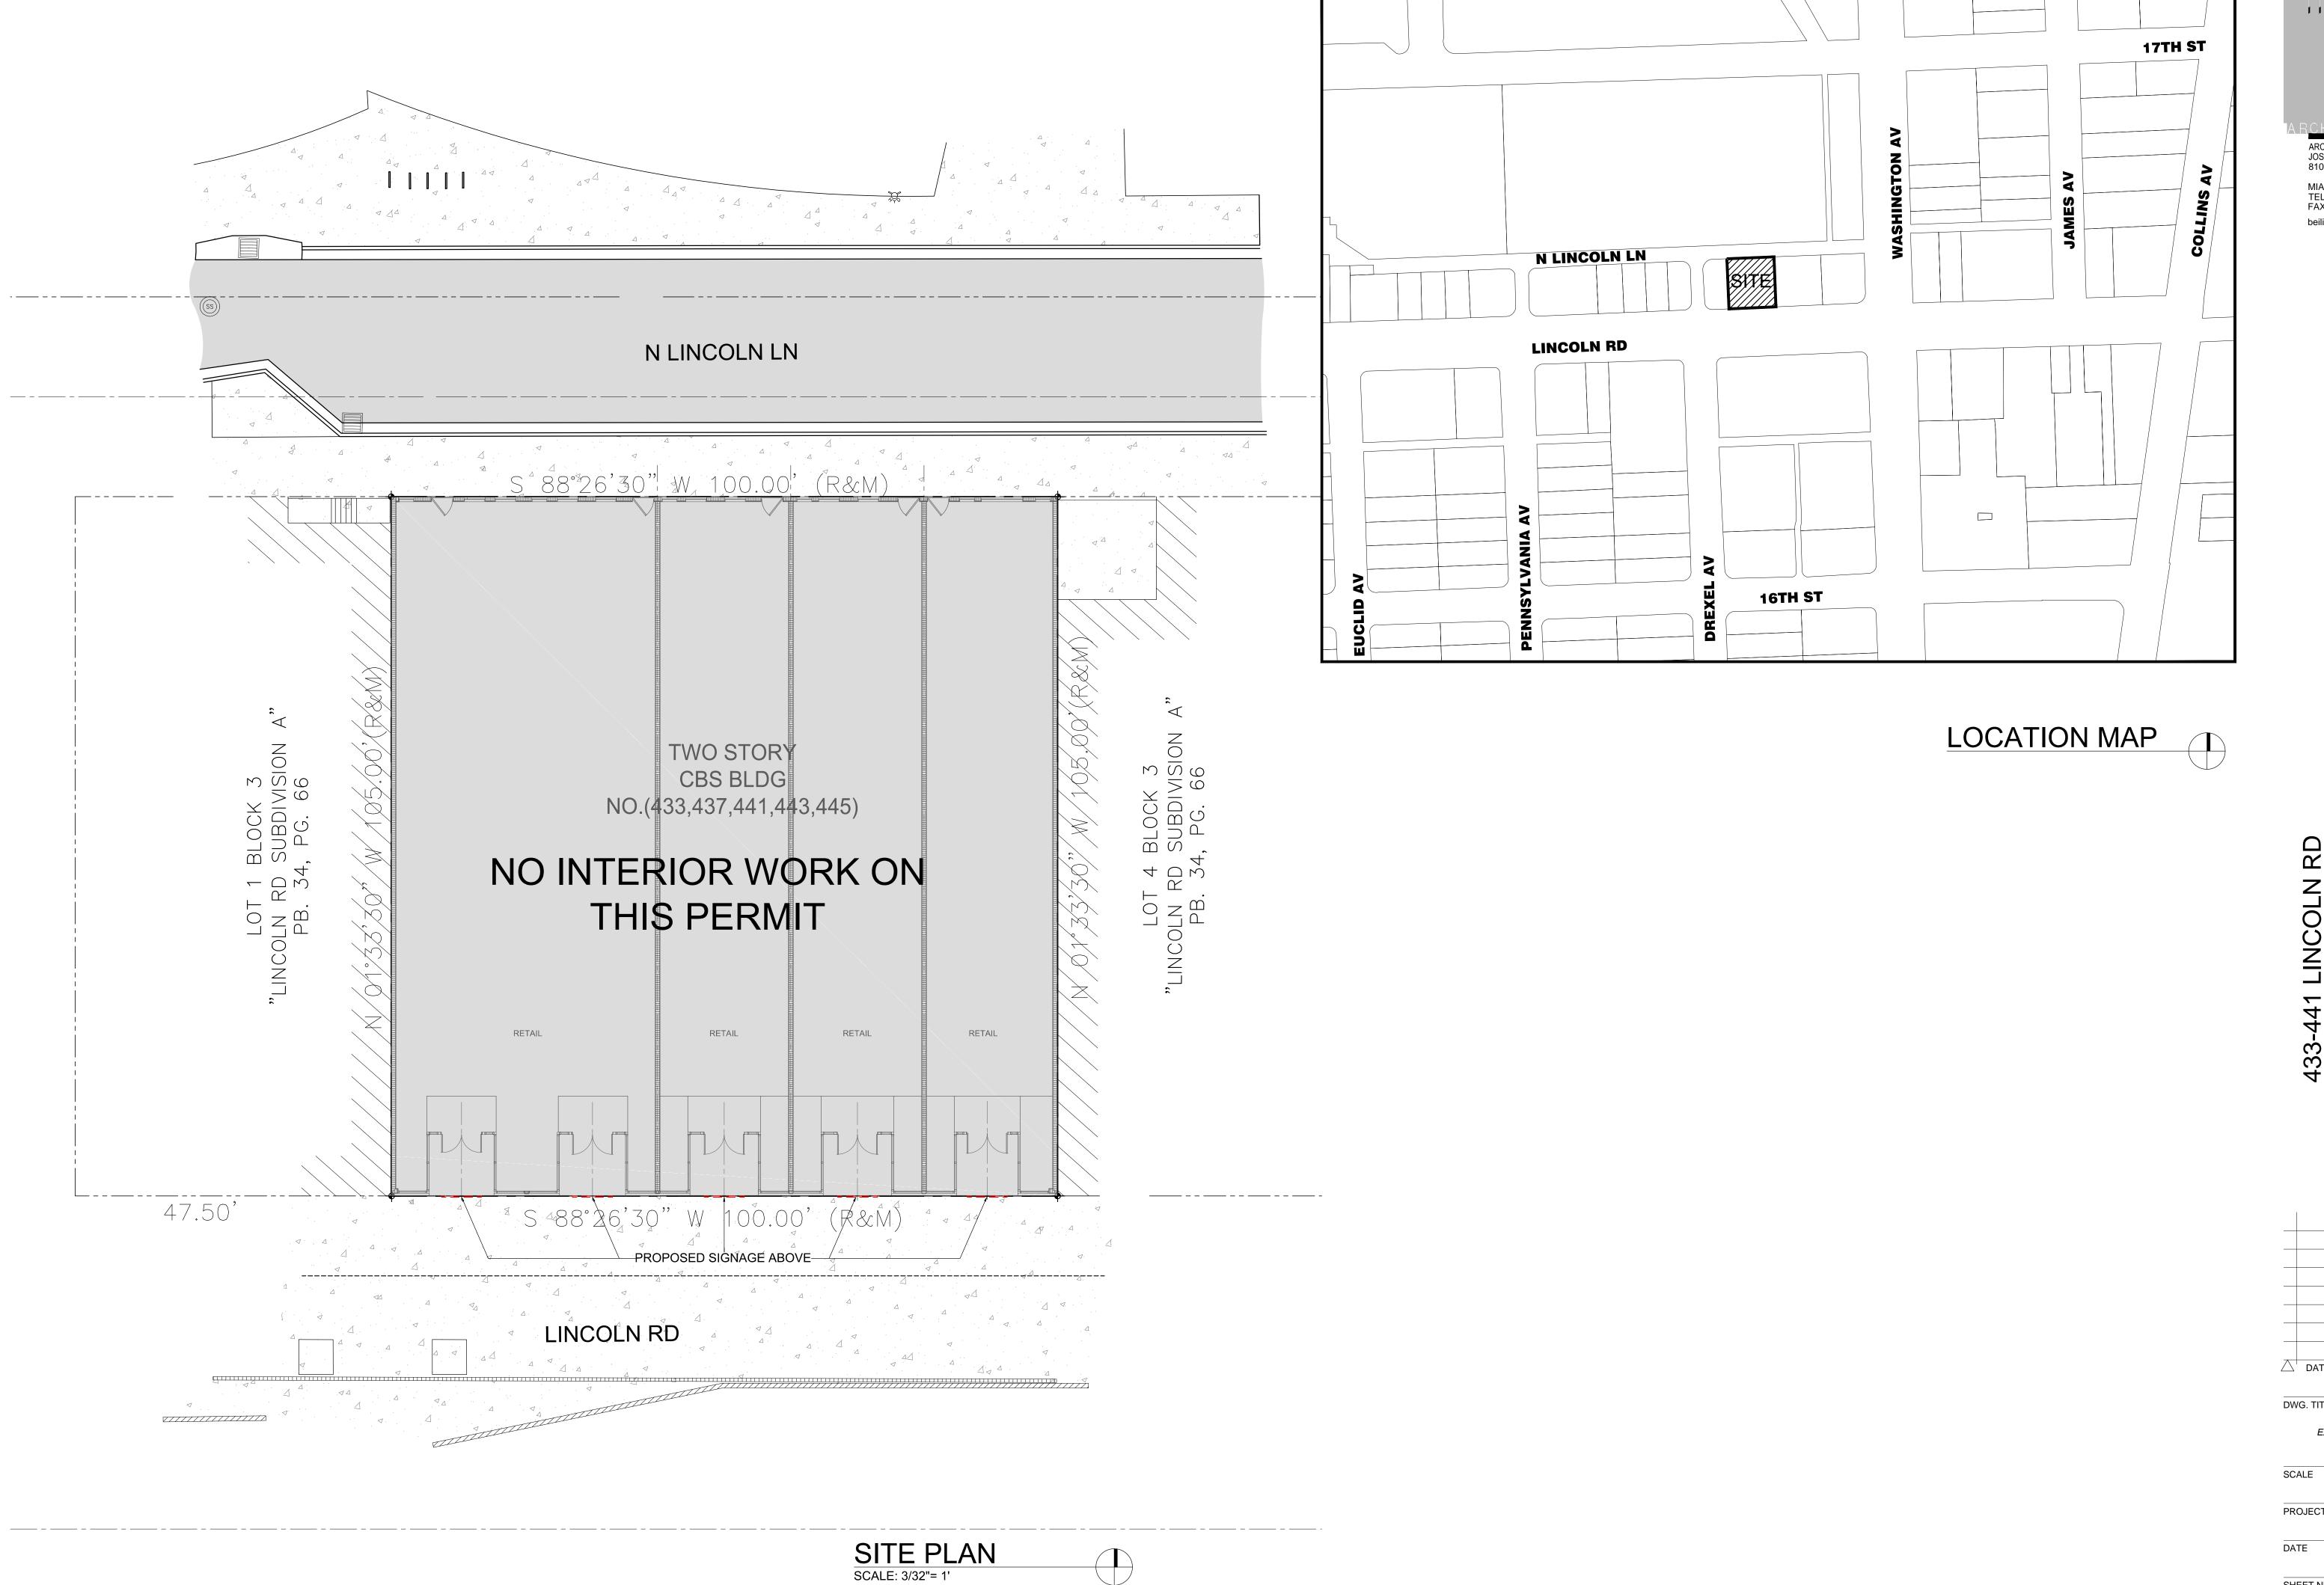

BEILINSON GOMEZ ARCHITECTURE AAC001062 JOSE L. GOMEZ AR0015416 8101 BISCAYNE BLVD. SUITE 309 MIAMI FL 33138-4664 TEL. (305) 559.1250 FAX (305) 551.1740

DATE DWG. TITLE

PROJECT NO.

SHEET NUMBER SP-101

NOTES AND REQUIREMENTS

- 1. SIGNS SHALL BE 6'-0" TO 8'-0" IN LENGTH, WALL MOUNTED. A MAXIMUM OF TWO ROWS OF LETTERING IS ALLOWED, AND THE TOTAL SIZE MAY NOT EXCEED 15FT² AND CANNOT EXCEED THE WIDTH OF THE INTERIOR TENANT SPACE (DEMISING WALLS). EACH SIGN TO BE CENTERED OVER TENANTS ENTRY DOORWAY.
- 2. SIGNS SHALL HAVE A WALL OFFSET OF 1"TO 2 $\frac{1}{2}$ " FOR REAR LIGHT GLOW.
- 3. SIGNS SHALL BE MADE WITH MAXIMUM 12" LETTERS.

2 SECTION

SCALE: 3" = 1'-0"


- SIGNS SHALL BE CLEAR ANODIZED BRUSHED ALUMINUM, STAINLESS STEEL, OR BLACK CHANNEL BACKLIT CHANNEL LETTERS MANUFACTURED WITH LED BACKLIGHTING.
- ALL LIGHTING TRANSFORMERS OR OTHER EQUIPMENT REQUIRED BY THE SIGN SHALL BE MOUNTED INTERNAL TO THE TENANT SPACE. NO LIGHTING TRANSFORMERS OR OTHER NON-LETTER MOUNTING TO THE EXTERIOR FACADE.
- 6. ALL ACCENTS OR DETAILS TO THE TYPICAL SIGNAGE TO BE REVIEWED AND APPROVED BY BUILDING MANAGER PRIOR TO SUBMITTAL TO THE CITY OF MIAMI BEACH. CITY PERMIT STAFF SHALL REVIEW FOR CONSISTENCY WITH THESE SIGN RULES AND PERMIT REQUIREMENTS AS PART OF PERMIT SUBMITTAL.
- ALL MOUNTING HARDWARE TO BE BRUSHED STAINLESS STEEL OR OTHER NON-CORROSIVE MATERIAL IN A COASTAL ENVIRONMENT. HARDWARE SHOULD MATCH THE FINISH OF THE SIGN MATERIAL.
- 8. COLOR AND TEMPERATURE OF LED LIGHTING TO BE APPROVED BY LANDLORD AND CITY PERMIT STAFF. PROVIDE WHITE UNLESS OTHER IS APPROVED BY LANDLORD PRIOR TO CITY PERMIT SUBMITTAL.


FRONT ELEVATION

PRIMARY ELECTRICAL

SERVICE TO SIGN AREA


SCALE: 1/4" = 1'-0"

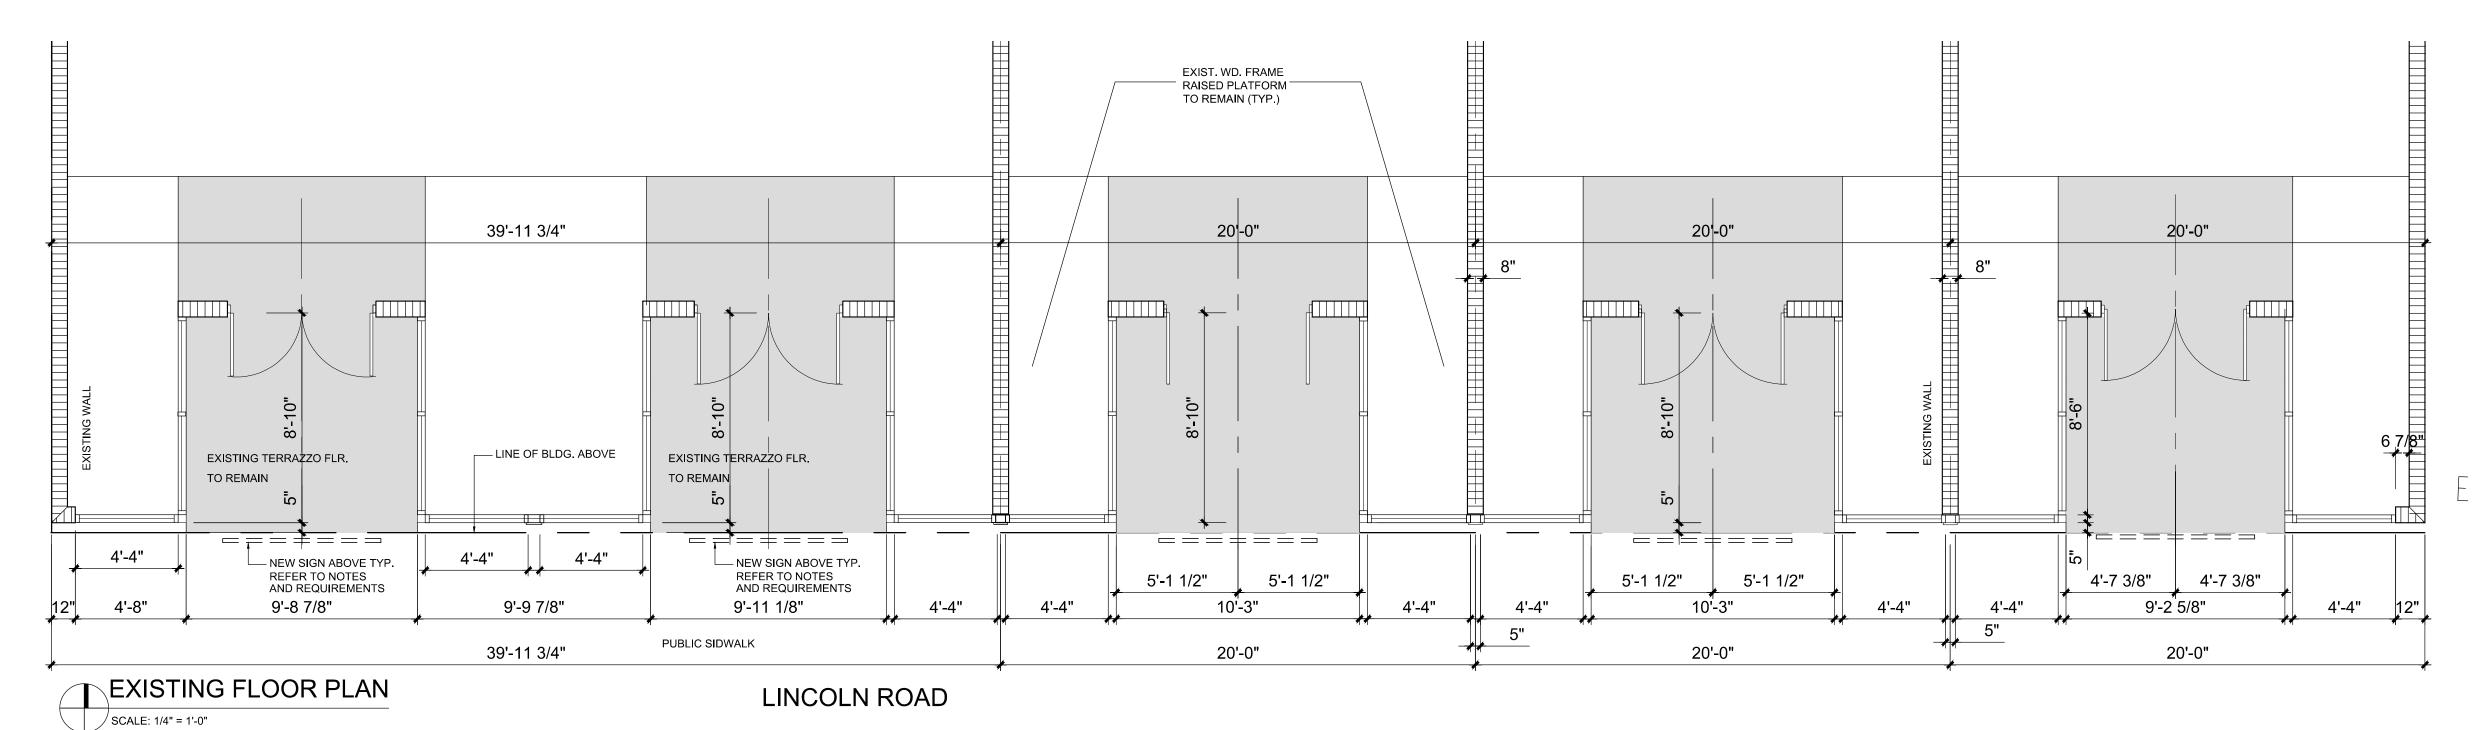

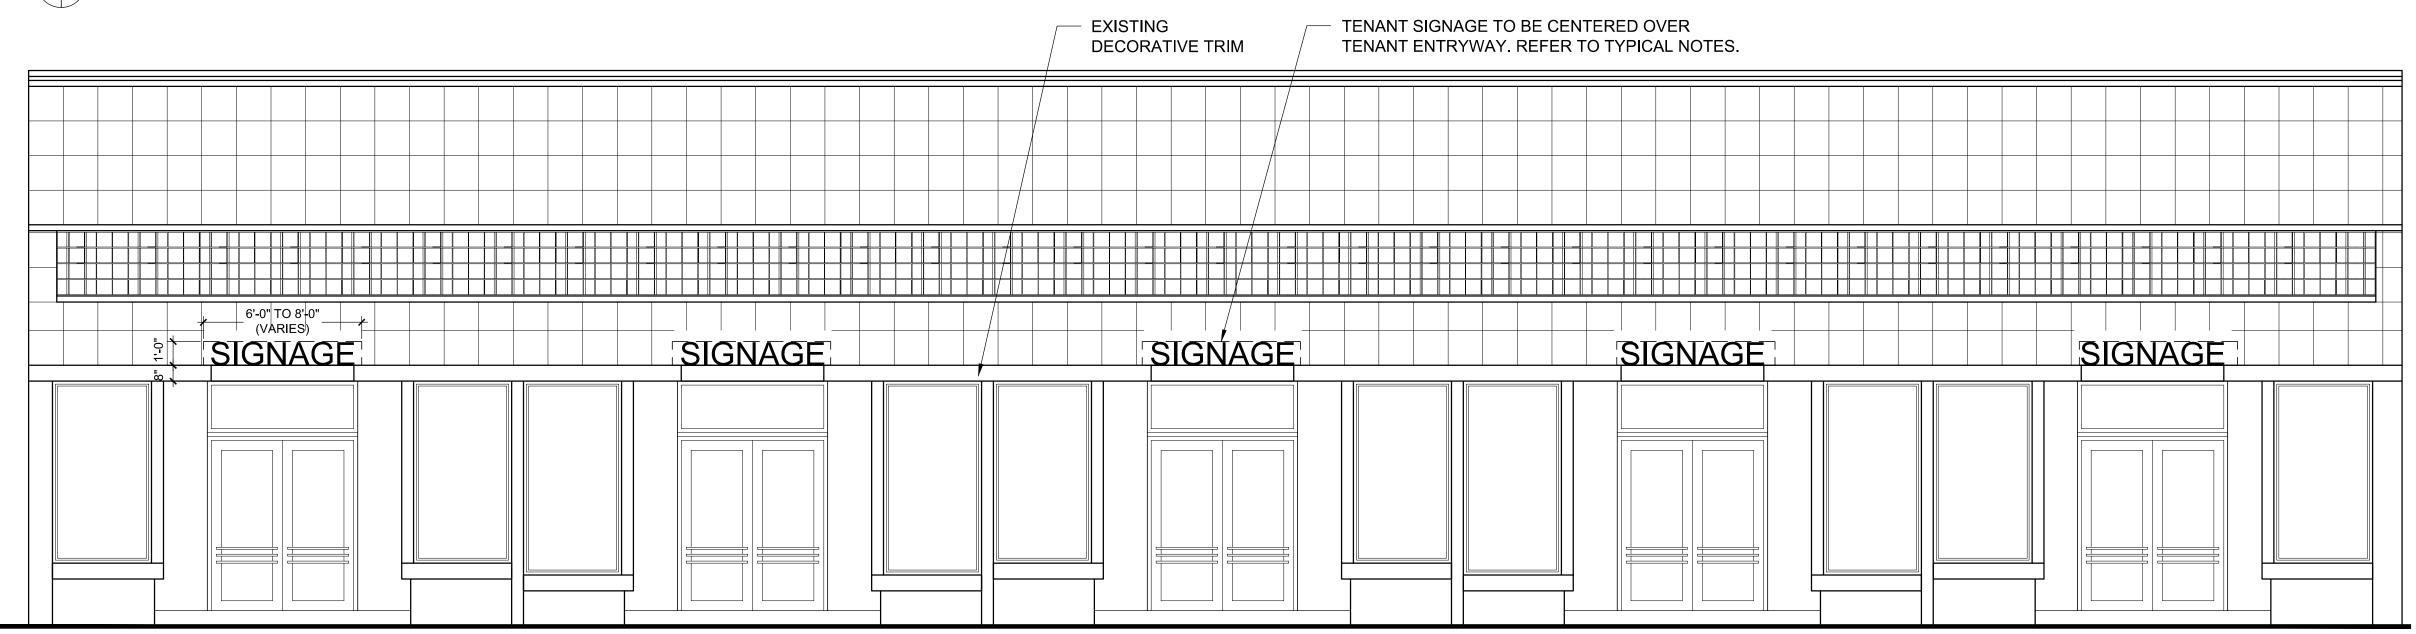

SIGNAGE SHALL BE NO GREATER THAN 15FT² MAXIMUM AND MUST CONFORM

TO CITY MANDATED FT2 SIZES.

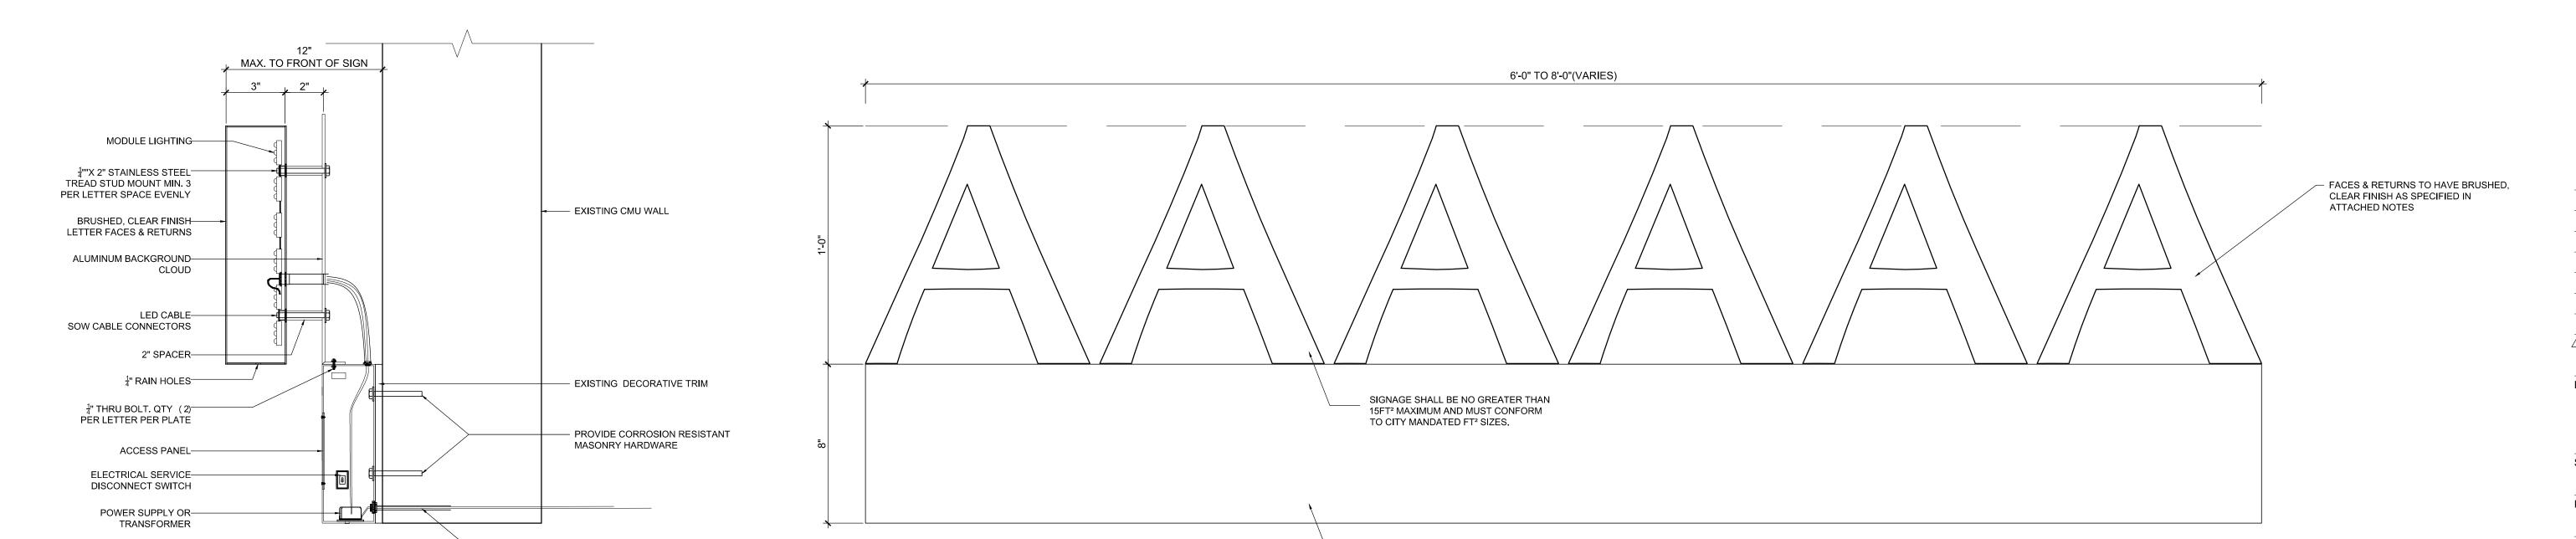

SIGNAGE ELEVATION

SCALE: 3" = 1'-0"

433-441 LINCOLN RD

ARCHITECTURE AAC001062 JOSE L. GOMEZ AR0015416

8101 BISCAYNE BLVD.

MIAMI FL 33138-4664 TEL. (305) 559.1250 FAX (305) 551.1740

beilinsonarchitectspa.com

SUITE 309

1 04-05-17 HPB CMMT

DATE REVISION

DWG. TITLE

SIGNAGE PLAN

SCALE

AS SHOWN

PROJECT NO.

2016-23

DATE

SHEET NUMBER