IL VILLAGGIO CONDOMINIUM

CANOPY #3 STRUCTURE

LOCATED AT: 1455 OCEAN DRIVE MIAMI BEACH FL 33139

FOR:
IL VILLAGGIO CONDO ASSOCIATION



SAG GROUP INC.
7003 N WATERWAY DR, SUITE 219
MIAMI. FLORIDA 33155
PH. 305-322-8991
AA26001605

INDEX OF DRAWINGS

ARCHITECTURAL

SHEET NO. DESCRIPTION COVER SHEET/INDEX

EXISTING SITE PLAN W/PROPOSED CANOPY- STREET LEVEL, RAMPS AND RESIDENTIAL LEVEL/DROP-OFF LOCATION PLAN, SITE PLA-KEY PLAN, SCOPE OF WORK, CODE SEARCH AND NOTES

A-101 PARTIAL SITE PLAN-EXISTING AND PROPOSED CONDITION

A-102 CANOPY FLOOR AND ROOF PLAN AND SECTION

2. THE CONTRACT DOCUMENTS ARE INSTRUMENTS OF SERVICE AND SHALL REMAIN THE PROPERTY OF THE ARCHITECT WHETHER THE PROJECT FOR WHICH THEY ARE PREPARED IS EXECUTED OR NOT. THE CONTRACT DOCUMENTS ARE NOT TO BE USED BY THE OWNER FOR OTHER PROJECTS OR EXTENSIONS TO THE PROJECT NOR ARE THEY TO BE MODIFIED IN ANY MANNER WHATSOEVER EXCEPT BY AGREEMENT IN WRITING AND WITH APPROPRIATE COMPENSATION TO THE ARCHITECT.

3. THE WORK WILL CONFORM WITH THE REQUIREMENTS OF ALL AGENCIES HAVING JURISDICTION.

4. "FURNISH" MEANS SUPPLY ONLY FOR OTHERS TO PUT IN PLACE.

5. "PROVIDE" MEANS FURNISH AND INSTALL, COMPLETE IN PLACE.

6. "SIMILAR" MEANS COMPATIBLE CHARACTERISTICS FOR CONDITIONS NOTED. CONTRACTOR TO VERIFY DIMENSIONS AND ORIENTATION.

7. "TYPICAL" MEANS IDENTICAL FOR CONDITIONS NOTED.

8. DO NOT SCALE DRAWINGS; DIMENSIONS GOVERN. VERIFY DIMENSIONS WITH FIELD CONDITIONS. IF DISCREPANCIES ARE DISCOVERED BETWEEN FIELD CONDITIONS AND DRAWINGS OR BETWEEN DRAWINGS, CONTACT ARCHITECT FOR RESOLUTION BEFORE PROCEEDING.

9. HORIZONTAL DIMENSIONS INDICATED ARE TO/FROM FACE OF STRUCTURE, EXCEPT AS NOTED.

10. VERTICAL DIMENSIONS ARE FROM TOP OF FINISH FLOOR. (A.F.F.) 11. DIMENSIONS ARE NOT ADJUSTABLE WITHOUT APPROVAL OF ARCHITECT

UNLESS NOTED (+/-). 13. ALL WORK SHALL BE ERECTED AND INSTALLED PLUMB, LEVEL, SQUARE AND TRUE, AND IN PROPER ALIGNMENT.

13. CUT AND FIT COMPONENTS FOR ALTERATIONS OF EXISTING WORK AND INSTALLATION OF NEW WORK. PATCH DISTURBED AREAS TO MATCH ADJACENT MATERIALS AND FINISHES.

14. PATCH AND REPAIR ALL FIREPROOFING DAMAGED OR REMOVED DURING PERFORMANCE OF THE WORK. FIREPROOF ALL NEW PENETRATIONS REQUIRED BY

15. COORDINATE AND PROVIDE BLOCKING/BACKING IN PARTITIONS BEHIND ALL WALL MOUNTED ITEMS. ALL CONCEALED WOOD TO BE FIRE TREATED.

16. MAKE ALL NECESSARY PROVISIONS FOR ITEMS TO BE FURNISHED OR INSTALLED BY TENANT. PROVIDE PROTECTION FOR THESE PROVISIONS UNTIL COMPLETION OF THE PROJECT. GENERAL CONTRACTOR TO COORDINATE N.I.C. ITEMS WITH APPROPRIATE TRADES.

17. GENERAL CONTRACTOR SHALL BE RESPONSIBLE FOR CHECKING CONTRACT DOCUMENTS, FIELD CONDITIONS, AND DIMENSIONS FOR ACCURACY AND CONFIRMING THAT WORK IS BUILDABLE AS SHOWN BEFORE PROCEEDING WITH CONSTRUCTION. CLARIFICATIONS REGARDING ANY CONFLICTS SHALL BE ACHIEVED PRIOR TO RELATED WORK BEING STARTED.

18. GENERAL CONTRACTOR SHALL VERIFY THAT NO CONFLICTS EXIST IN LOCATIONS OF ANY AND ALL MECHANICAL, TELEPHONE, ELECTRICAL, PLUMBING, AND EQUIPMENT (TO INCLUDE ALL PIPING, DUCTWORK, AND CONDUIT) AND THAT ALL REQUIRED CLEARANCES FOR INSTALLATION AND MAINTENANCE OF ABOVE EQUIPMENT ARE PROVIDED. ELEMENTS TO BE EXPOSED OR CONCEALED SHALL BE DETERMINED AND REVIEWED WITH ARCHITECT IN THE FIELD PRIOR TO CONSTRUCTION PROCEEDING.

19. GENERAL CONTRACTOR AND SUB-CONTRACTORS SHALL COORDINATE THE LAYOUT AND EXACT LOCATION OF PARTITIONS, DOORS, ELECTRICAL/TELEPHONE OUTLETS AND LIGHT SWITCHES WITH ARCHITECT IN THE FIELD BEFORE PROCEEDING WITH CONSTRUCTION.

20. GENERAL CONTRACTOR IS RESPONSIBLE FOR AND SHALL PROVIDE PROTECTION FOR ANY EXISTING FINISHES INCLUDING ELEVATORS, LOBBIES AND CORRIDORS OF THE BASE BUILDING. ANY DAMAGE TO EXISTING AREAS CAUSED BY THE GENERAL CONTRACTOR OR HIS SUBCONTRACTORS SHALL BE REPAIRED BY THE GENERAL CONTRACTOR. THE REPAIRS ARE NOT PART OF THIS PROJECT OR CONTRACT AND WILL BE RESPONSIBILITY OF THE GENERAL CONTRACTOR.

21. CONTRACTOR SHALL PROVIDE MANUFACTURER'S SPECIFICATIONS INSTALLATION INSTRUCTIONS, SHOP DRAWINGS AND SAMPLES FOR REVIEW AND APPROVAL OF ALL MATERIALS AND METHODS TO BE USED PRIOR TO ORDERING OR PROCEEDING WITH THE WORK.

22. CONTRACTOR TO FOLLOW MANUFACTURER'S RECOMMENDED SPECIFICATIONS AND INSTALLATION PROCEDURES. IF THESE ARE CONTRARY TO THE CONTRACT DOCUMENTS, CONTRACTOR SHALL NOTIFY ARCHITECT, IN WRITING, IMMEDIATELY, TO RESOLVE DISCREPANCIES PRIOR TO PROCEEDING.

23. THE CONTRACT DOCUMENTS CONSIST OF THE FOLLOWING:

A. OWNER-CONTRACTOR AGREEMENT.

B. GENERAL CONDITIONS. C. DRAWINGS AS DATED IN AGREEMENT.

24. EXERCISE EXTREME CARE AND PRECAUTION DURING CONSTRUCTION OF THE WORK TO MINIMIZE DISTURBANCES TO ADJACENT STRUCTURES AND THEIR OCCUPANTS, PROPERTY, PUBLIC THOROUGHFARES, ETC. CONTRACTOR SHALL TAKE PRECAUTIONS AND BE RESPONSIBLE FOR THE SAFETY OF ALL BUILDING OCCUPANTS FROM CONSTRUCTION PROCEDURES.

25. WITHIN FIVE (5) DAYS FROM CONTRACT DATE, PREPARE AND SUBMIT AN ESTIMATED PROGRESS SCHEDULE FOR THE WORK, WITH SUB SCHEDULES OF RELATED ACTIVITIES SUCH AS DATA/TELEPHONE CABLING AND FURNITURE

26. ALL WORK SHALL COMPLY WITH APPLICABLE CODES, AMENDMENTS, RULES, REGULATIONS, ORDINANCES, LAWS, ORDERS, APPROVALS, ETC., THAT ARE REQUIRED BY PUBLIC AUTHORITIES. IN THE EVENT OF CONFLICT, THE MOST STRINGENT REQUIREMENTS SHALL GOVERN. REQUIREMENTS INCLUDE, BUT ARE NOT NECESSARILY LIMITED TO, THE CURRENT APPLICABLE EDITIONS OF PUBLICATIONS OF THE FOLLOWING:

A. FLORIDA BUILDING CODE, 2017 B. NATIONAL FIRE PROTECTION ASSOCIATION C. AMERICAN NATIONAL STANDARDS INSTITUTE

27. ABBREVIATIONS USED IN REFERRING TO STANDARDS THAT APPLY TO THE WORK INCLUDE, BUT ARE NOT LIMITED TO THE FOLLOWING:

A. AMERICAN SOCIETY OF TESTING MATERIALS (ASTM)

B. AMERICAN INSTITUTE OF STEEL CONSTRUCTION (AISC) C. AMERICAN WELDING SOCIETY (AWS)

D. AMERICAN CONCRETE INSTITUTE E. AMERICAN NATIONAL STANDARDS INSTITUTE (ANSI)

F. ARCHITECTURAL ALUMINUM MANUFACTURER'S ASSOCIATION (AAMA) G. ALUMINUM ASSOCIATION, INC. (AA) H. CONCRETE REINFORCING STEEL INSTITUTE (CRSI)

NOTES:

I. PRIOR TO START OF CONSTRUCTION. THE CONTRACTOR AND ALL THE SUBCONTRACTORS SHALL VERIFY ALL GRADES, LINES, LEVELS, DIMENSIONS AND COORDINATE EXISTING CONDITIONSAT THE JOB SITE WITH THE PLANS AND SPECIFICATIONS. THEY SHALL REPORT ANY ONCONSISTENCIES OR ERRORS IN THE ABOVE TO THE ARCHITECT/ENGINEER BEFORE COMMENCING WORK FROM ESTABLISHED REFERENCE POINTS AND BE RESPONSIBLE FOR ALL LINES, ELEVATIONS AND MEASUREMENTS IN CONNECTION WITH

. IF ANY ERRORS OR OMISSIONS APPEAR IN THE DRAWINGS, GENERAL NOTES OR OTHER DOCUMENTS, PRIOR TO PROCEEDING WITH ANY WORK WHICH APPEARS IN QUESTION. IN THE EVENT OF THE CONTRACTOR'S FAILING TO GIVE SUCH AN ADVANCED NOTICE, HE SHALL BE RESPONSIBLE FOR THE RESULTS OF ANY SUCH ERRORS OR OMISSIONS AND THE COST OF RECTIFYING THE SAME.

ALL DIMENSIONS SHALL BE CONSIDER "NOMINAL" UNLESS OTHERWISE NOTED. DIMENSIONS ON LARGE SCALE DRAWINGS OR DTLS. WILL PREVAIL OVER SMALLER SCALED DRAWINGS DO NOT SCALE DRAWINGS. USE FIGURED DIMENSIONS ONLY, CONTRACTOR SHALL VERIFY ALL

DIMENSIONS & CONDITIONS AND IN THE EVENT OF CONFLICT, NOTIFY THE ARCHITECT BEFORE

ALL PARTITIONS WITH WALL HUNG ITEMS ARE MIN. 20 GA. METAL STUDS @16" O.C MAX. PROVIDE 2"X1" FIRE RETARDANT WOOD BACKING OR METAL SHEETING WHERE CABINETRY WILL BE INSTALLED

FLAME SPREAD AND SMOKE DENSITY: WALL AND CEILING FINISHES SHALL HAVE A FLAME-SPREAD CLASSIFICATION OF NOT GREATER THAN 200 WALL AND CEILING FINISHES SHALL HAVE A SMOKE-DEVELOPED INDEX OF NOT GREATER THAN 450. AS PER FBC2017. INSULATION MATERIALS, INCLUDING FACINGS, SUCH AS VAPOR RETARDANT OR VAPOR PERMEABLE MEMBRANES INSTALLED WITHIN FLOOR-CEILING ASSEMBLIES, ROOF-CEILING ASSEMBLIES AND WALL ASSEMBLIES SHALL HAVE A FLAME SPREAD INDEX NOT TO EXCEED 25 WITH AN ACCOMPANYING SMOKE-DEVELOPED INDEX NOT TO EXCEED 450 AS PER FBC2017.

PROVIDE FIRE CAULKING AT ALL PIPE PENETRATIONS OF FLOOR/CEILING ASSEMBLY AND BETWEEN DEMISING WALLS WITH HALLWAYS.

REFER TO MECHANICAL, ELECTRICAL AND PLUMBING DRAWINGS FOR SPECIFIC INFORMATION . ALL FLOORING TO BE SLIP RESISTANT

I. NATIONAL ASSOCIATION OF ARCHITECTURAL METAL MANUFACTURER'S

J. NATIONAL FIRE PROTECTION ASSOCIATION (NFPA) K. NATIONAL WOODWORK MANUFACTURER'S ASSOCIATION (NWMA)

L. AMERICAN WOODWORK INSTITUTE (AWI)

CLARIFICATION HAS BEEN MADE.

28. IN THE EVENT OF CONFLICT BETWEEN DATA SHOWN ON DRAWINGS AND DATA SHOWN ON THE SPECIFICATIONS, THE SPECIFICATIONS SHALL GOVERN. DIMENSIONS NOTED ON DRAWINGS SHALL TAKE PRECEDENCE OVER DRAWINGS OF SMALLER SCALE. SHOULD THE CONTRACTOR AT ANY TIME DISCOVER AN ERROR IN A DRAWING OR SPECIFICATION, OR A DISCREPANCY OR VARIATION BETWEEN DIMENSIONS OR DRAWINGS AND MEASUREMENTS AT SITE, OR LACK OF DIMENSIONS OR OTHER INFORMATION, HE SHALL NOT PROCEED WITH THE WORK AFFECTED UNTIL

29. ONLY NEW ITEMS OF RECENT MANUFACTURER, OF STANDARD QUALITY, FREE FROM DEFECTS, WILL BE PERMITTED ON THE WORK AND REPLACED WITH ITEMS OF THE QUALITY SPECIFIED. FAILURE TO REMOVE REJECTED MATERIALS AND EQUIPMENT SHALL NOT RELIEVE THE CONTRACTOR FROM THE RESPONSIBILITY FOR QUALITY AND CHARACTER OF ITEMS USED NOR FROM ANY OTHER OBLIGATION IMPOSED ON HIM/ HER BY THE CONTRACT.

30. THE FINISHED WORK SHALL BE FIRM, WELL ANCHORED, IN TRUE ALIGNMENT, PLUMB, LEVEL, WITH SMOOTH, CLEAN, UNIFORM APPEARANCE WITHOUT WAVES, DISTORTIONS, HOLES, MARKS, CRACKS, STAINS, OR DISCOLORATION. JOINTS SHALL BE CLOSE FITTING, NEAT AND WELL SCRIBED. THE FINISH WORK SHALL HAVE NO EXPOSED UNSIGHTLY ANCHORS OR FASTENERS AND SHALL NOT PRESENT HAZARDOUS, UNSAFE CORNERS. ALL WORK SHALL HAVE THE PROVISION FOR EXPANSION, CONTRACTION, AND SHRINKAGE AS NECESSARY TO PREVENT CRACKS, BUCKLING AND WARPING DUE TO TEMPERATURE AND HUMIDITY CONDITIONS.

31. ATTACHMENTS, CONNECTIONS, OR FASTENINGS OF ANY NATURE ARE TO BE PROPERLY AND PERMANENTLY SECURED IN CONFORMANCE WITH BEST PRACTICE AND THE CONTRACTOR IS RESPONSIBLE FOR IMPROVING THEM ACCORDINGLY AND TO THESE CONDITIONS. THE DRAWINGS SHOW ONLY SPECIAL CONDITIONS TO ASSIST CONTRACTOR; THEY DO NOT ILLUSTRATE EVERY SUCH DETAIL.

32. THE CONTRACTOR IS RESPONSIBLE FOR VERIFYING THE DIMENSIONS AND ELEVATIONS AT THE SITE. THE CONTRACTOR AND SUB-CONTRACTOR SHALL COORDINATE THE LAYOUT AND EXACT LOCATION OF ALL PARTITIONING, DOORS, ELECTRICAL/TELEPHONE OUTLETS, LIGHT SWITCHES AND THERMOSTATS WITH THE ARCHITECT IN THE FIELD BEFORE PROCEEDING WITH CONSTRUCTION.

33. NO WORK DEFECTIVE IN CONSTRUCTION OR QUALITY OR DEFICIENT IN ANY REQUIREMENTS OF DRAWINGS AND SPECIFICATIONS WILL BE ACCEPTABLE IN CONSEQUENCE OF OWNER'S OR ARCHITECT'S FAILURE TO DISCOVER OR TO POINT OUT DEFECTS OR DEFICIENCIES DURING CONSTRUCTION; NOR WILL PRESENCE OF INSPECTORS ON WORK RELIEVE CONTRACTOR FROM RESPONSIBILITY FOR SECURING QUALITY AND PROGRESS OF WORK AS REQUIRED BY CONTRACT. DEFECTIVE WORK REVEALED WITHIN REQUIRED TIME GUARANTEES SHALL BE REPLACED BY WORK CONFORMING WITH INTENT OF CONTRACT. NO PAYMENT WHETHER PARTIAL OR FINAL, SHALL BE CONSTRUED AS AN ACCEPTANCE OF DEFECTIVE WORK OR IMPROPER MATERIALS.

34. MATERIALS AND WORKMANSHIP SPECIFIED BY REFERENCE TO NUMBER. SYMBOL, TO TITLE OF A SPECIFICATION SUCH AS COMMERCIAL STANDARDS, FEDERAL SPECIFICATION, TRADE ASSOCIATION STANDARD, OR OTHER SIMILAR STANDARD, SHALL COMPLY WITH REQUIREMENTS IN LATEST EDITION OR REVISION THEREOF AND WITH ANY AMENDMENT OR SUPPLEMENT THERETO IN EFFECT ON DATE OF ORIGIN OF THIS PROJECT'S CONTRACT DOCUMENTS. SUCH STANDARD, EXCEPT AS MODIFIED HEREIN, SHALL HAVE FULL FORCE EFFECTS AS THOUGH PRINTED IN CONTRACT DOCUMENTS.

35. CONTRACTOR SHALL WAIVE "COMMON PRACTICE" AND "COMMON USAGE AS CONSTRUCTION CRITERIA WHEREVER DETAILS AND CONTRACT DOCUMENTS OR GOVERNING CODES, ORDINANCES, ETC., REQUIRE GREATER QUANTITY OR BETTER QUALITY THAN COMMON PRACTICE OR COMMON USAGE WOULD

36. CONTRACTOR SHALL ORDER AND SCHEDULE DELIVERY OF MATERIALS IN AMPLE TIME TO AVOID DELAYS IN CONSTRUCTION. IF AN ITEM IS FOUND TO BE UNAVAILABLE. CONTRACTOR SHALL NOTIFY ARCHITECT IMMEDIATELY TO ALLOW ARCHITECT A REASONABLE AMOUNT OF TIME TO SELECT A SUITABLE SUBSTITUTE.

37. IF AT ANY TIME BEFORE COMMENCEMENT OF WORK, OR DURING PROGRESS THEREOF, CONTRACTOR'S METHODS, EQUIPMENT OR APPLIANCES ARE INEFFICIENT OR INAPPROPRIATE FOR SECURING QUALITY OF WORK, OR RATE OF PROGRESS INTENDED BY CONTRACT DOCUMENTS, OWNER MAY ORDER CONTRACTOR TO IMPROVE THEIR QUALITY OR INCREASE EFFICIENCY. THIS WILL NOT RELIEVE CONTRACTOR OF HIS SURETIES FROM THEIR OBLIGATIONS TO SECURE QUALITY OF WORK AND RATE OF PROGRESS SPECIFIED IN CONTRACT.

38. WITH REFERENCES TO CEILINGS, CONTRACTOR SHALL COORDINATE WITH ALL TRADES INVOLVED TO INSURE THAT CONFLICTS DO NOT OCCUR BETWEEN LIGHT FIXTURES, DUCTWORK, DIFFUSERS, SPRINKLERS, ETC., AND THAT CEILING HEIGHTS INDICATED ON DRAWINGS ARE ACHIEVED. CLARIFY CONFLICTS WITH

39. ALL TELEPHONE AND COMMUNICATIONS WORK SHALL BE COORDINATED BY THE CONTRACTOR WITH TENANT'S REPRESENTATIVES. TENANT WILL PROCURE CABLING SUB-CONTRACTOR.

40. FIRE PROTECTION SYSTEM, CONTRACTOR SHALL NOTIFY AND COORDINATE

WITH THE BUILDING MANAGEMENT OFFICE PRIOR TO DISCONNECT ANY FIRE SPRINKLER AND FIRE ALARM SYSTEM DEVICE. 41. REFERENCES TO MAKES, BRANDS, MODELS, ETC., IS TO ESTABLISH TYPE AND QUALITY DESIRED; SUBSTITUTION OF ACCEPTABLE EQUALS WILL NOT BE

PERMITTED UNLESS SPECIFICALLY NOTED OTHERWISE WHEN MADE ACCORDINGLY TO PROCEDURES FOR SUBTITUTIONS. 42. THE CONTRACTOR SHALL NOTIFY THE OWNER IN WRITING OF ANY

DEFICIENCIES IN BASE BUILDING WORK PRIOR TO THE COMMENCEMENT OF HIS

WORK. ANY UNREPORTED DEFICIENCIES WILL BECOME THE RESPONSIBILITY OF THE CONTRACTOR TO CORRECT. 43. CORING, DRILLING, OR OTHER SUCH WORK IN OR ADJACENT TO OCCUPIED AREAS SHALL BE PERFORMED AT OTHER THAN NORMAL WORKING AREAS FOR THE

44. UTILITY OUTAGES SHALL BE SCHEDULED OUTSIDE NORMAL WORKING HOURS FOR THE AFFECTED OCCUPANCY UNLESS OTHERWISE INDICATED.

45. THE CONTRACTOR SHALL TAKE ALL REASONABLE CONTROL AND PRECAUTION TO CONTROL/ ELIMINATE DUST, NOISE, ODOR NUISANCE AND THE LIKE TO THE PREMISES AND OCCUPANCY.

46. CONTRACTOR SHALL "STRIKE OUT" LOCATION OF ALL WALLS, DOORS, MULLIONS, SOFFITS, AND OTHER MAJOR ELEMENTS AS DIRECTED BY ARCHITECT AT THE BEGINNING OF THE PROJECT BEFORE PROCEEDING WITH CONSTRUCTION.

47. CONTRACTOR SHALL APPLY FOR PAY FOR AND OBTAIN ALL REQUIRED PERMITS FOR DEMOLITION, CONSTRUCTION AND OCCUPANCY.

CODE SEARCH AND TABULATION:

- FLORIDA FIRE PREVENTION CODE 8th EDITION

AFFECTED OCCUPANCY UNLESS OTHERWISE INDICATED.

OCCUPANCY GROUPS: RESIDENTIAL-HIGH RISE (R-2)(Existing) (U) UTILITY & MISCELLANEOUS-"Canopy" TYPE OF CONSTRUCTION: II-B (FIRE SPRINKLER- F. ALARM)

- FLORIDA BUILDING CODE 2023-8th EDITION FLORIDA BUILDING CODE 2023-8th EDITION-EXISTING BUILDING - FLORIDA BUILDING CODE 2023-8th EDITION-FLORIDA ACCESSIBILITY CODE NFPA 101 LIFE SAFETY CODE 2024 EDITION

CLASSIFICATION OF WORK:


ALTERATION- LEVEL 2 FBC-EXIST. BLDG- SECTION 504

504.1 SCOPE: LEVEL 2 ALTERATIONS INCLUDE THE RECONFIGURATION OF SPACE, THE ADDITION OR ELIMINATION OF ANY DOOR OR WINDOW, THE RECONFIGURATION OR EXTENSION OF ANY SYSTEM, OR THE INSTALLATION OF ANY ADDITION EQUIPMEN 504.2 APPLICATION: LEVEL 2 ALTERATIONS SHALL COMPLY WITH THE PROVISIONS OF CHAPTER 7 FOR LEVEL 1 ALTERATIONS AS WELL AS THE PROVISIONS OF CHAPTER 8.

TYPE OF REHABILITATION

MODIFICATION: (43.2.2.1.3)

THE RECONFIGURATION OF ANY SPACE; THE ADDITION, RELOCATION OR LIMINATION OF ANY DOOR OR WINDOW, THE ADDITION OR ELIMINATION OF LOAD-BEARING ELEMENTS; THE RECONFIGURATION OR EXTENSION OF ANY SYSTEM; OR THE INSTALLATION OF ANY ADDITIONAL EQUIPMENT

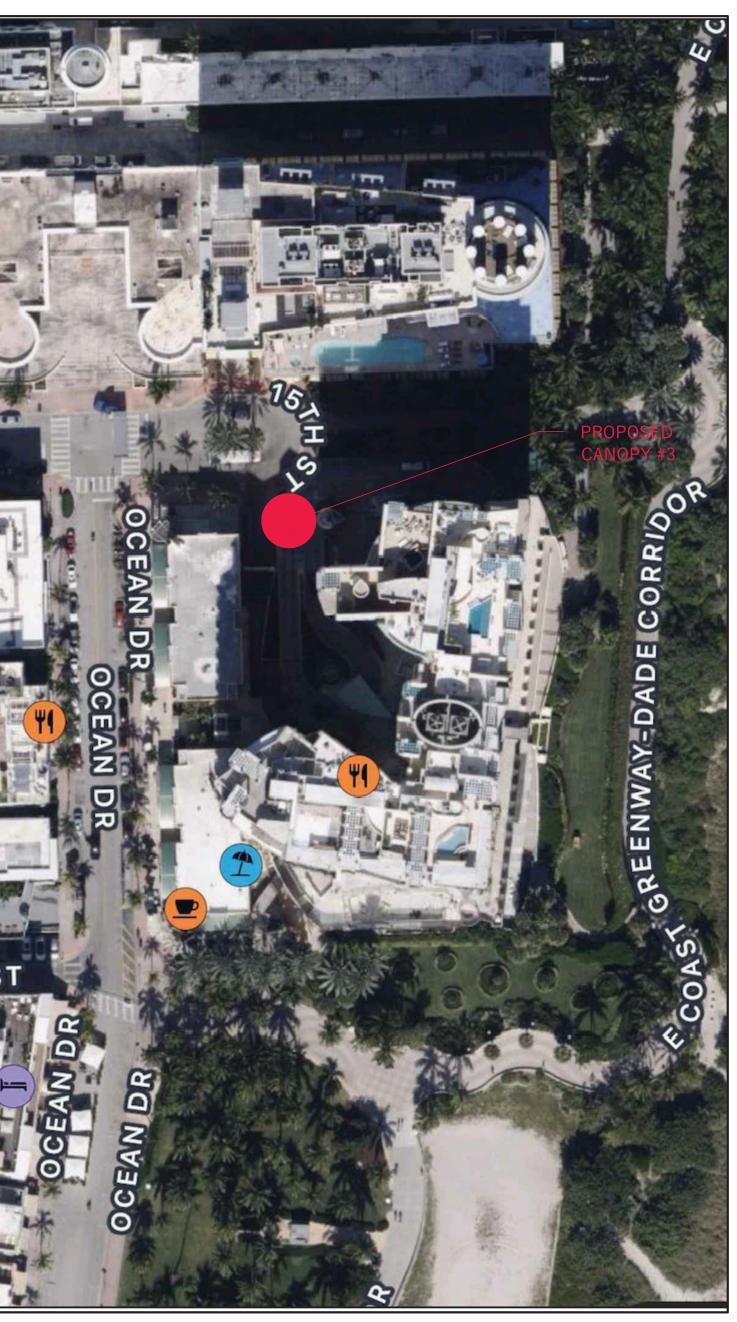



SCOPE OF WORK:

ACCESS BOX AND THE ARM GATES MOTOR.

AREA CALCULATIONS:

CANOPY #3 AREA:

EXISTING RESIDENTIAL HIGH RISE EXTERIOR COMMON AREAS:

*TO ADD A CANOPY (#3) OVER THE ACCESS TO THE VEHICULAR RAMP.

*EOUIPMENT WILL BE RELOCATED WITHIN THE SAME CONCRETE ISLAND.

THE LOCATION OF THE COLUMNS WILL BE ABOVE THE EXISTING ISLAND CURB HOLDING THE


173.00 SF

TOTAL RENOVATION AREA 173.00 S



N.T.S

VILLAGGIO CONDOMINIUM: 1455 COLLINS AVENUE, MIAMI BEACH FL

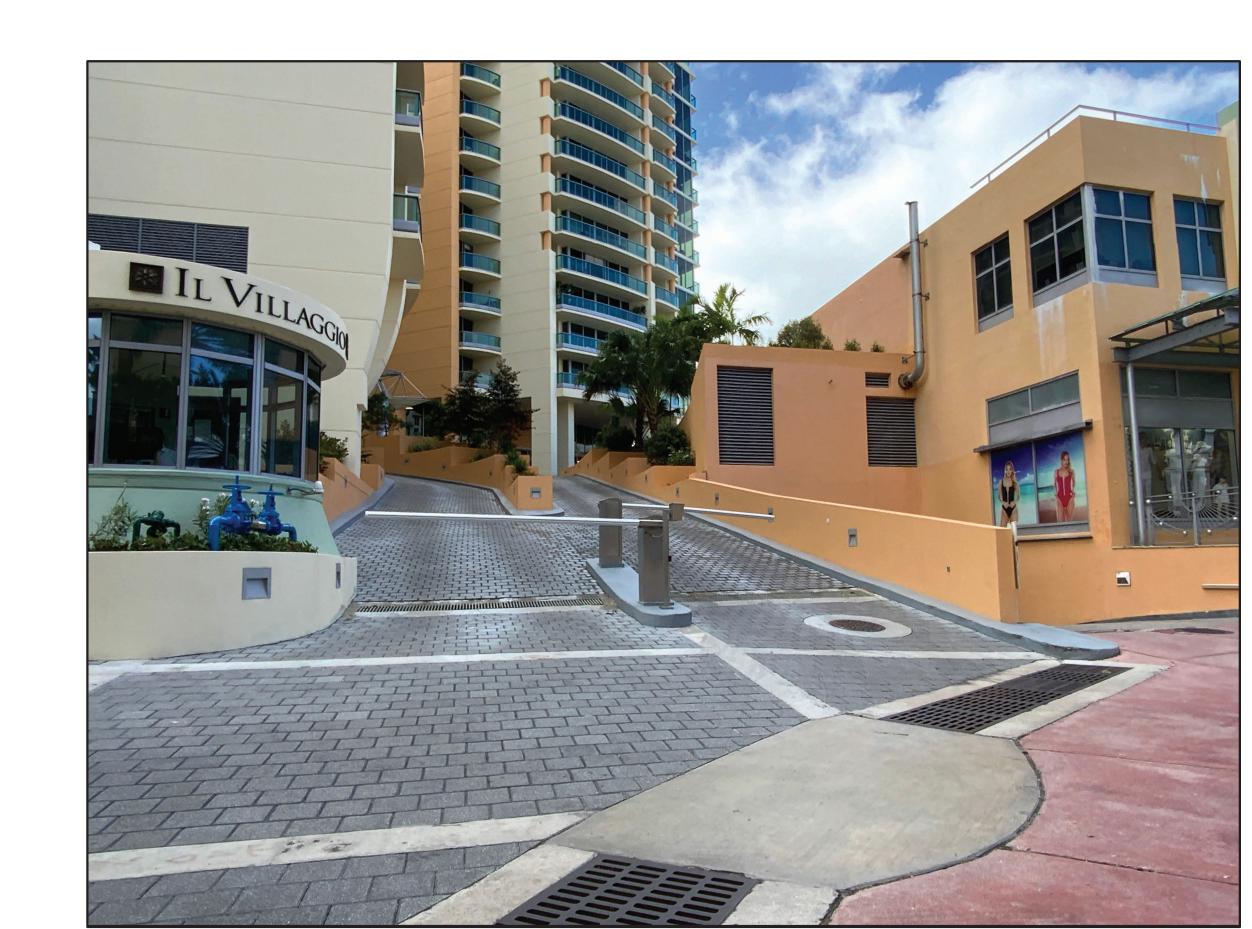

MAGE OF THE VEHICULAR RAMP-EXISTING CONDITION

REVISIONS


Signed and Sealed by: GABRIEL SALAZAR AR # 0009297


'ob No ²⁴⁻⁰¹⁷ ^oroject Manager <u>AMB</u> Drawn by . AS INDICATED Scale MARCH 2024


SHEET No.

N.T.S

Ctur (1)

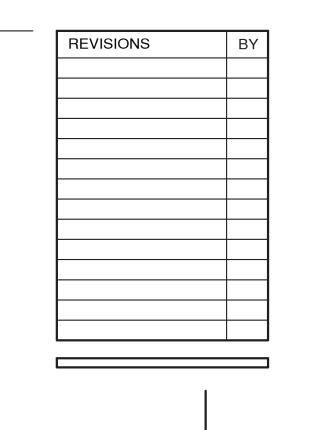

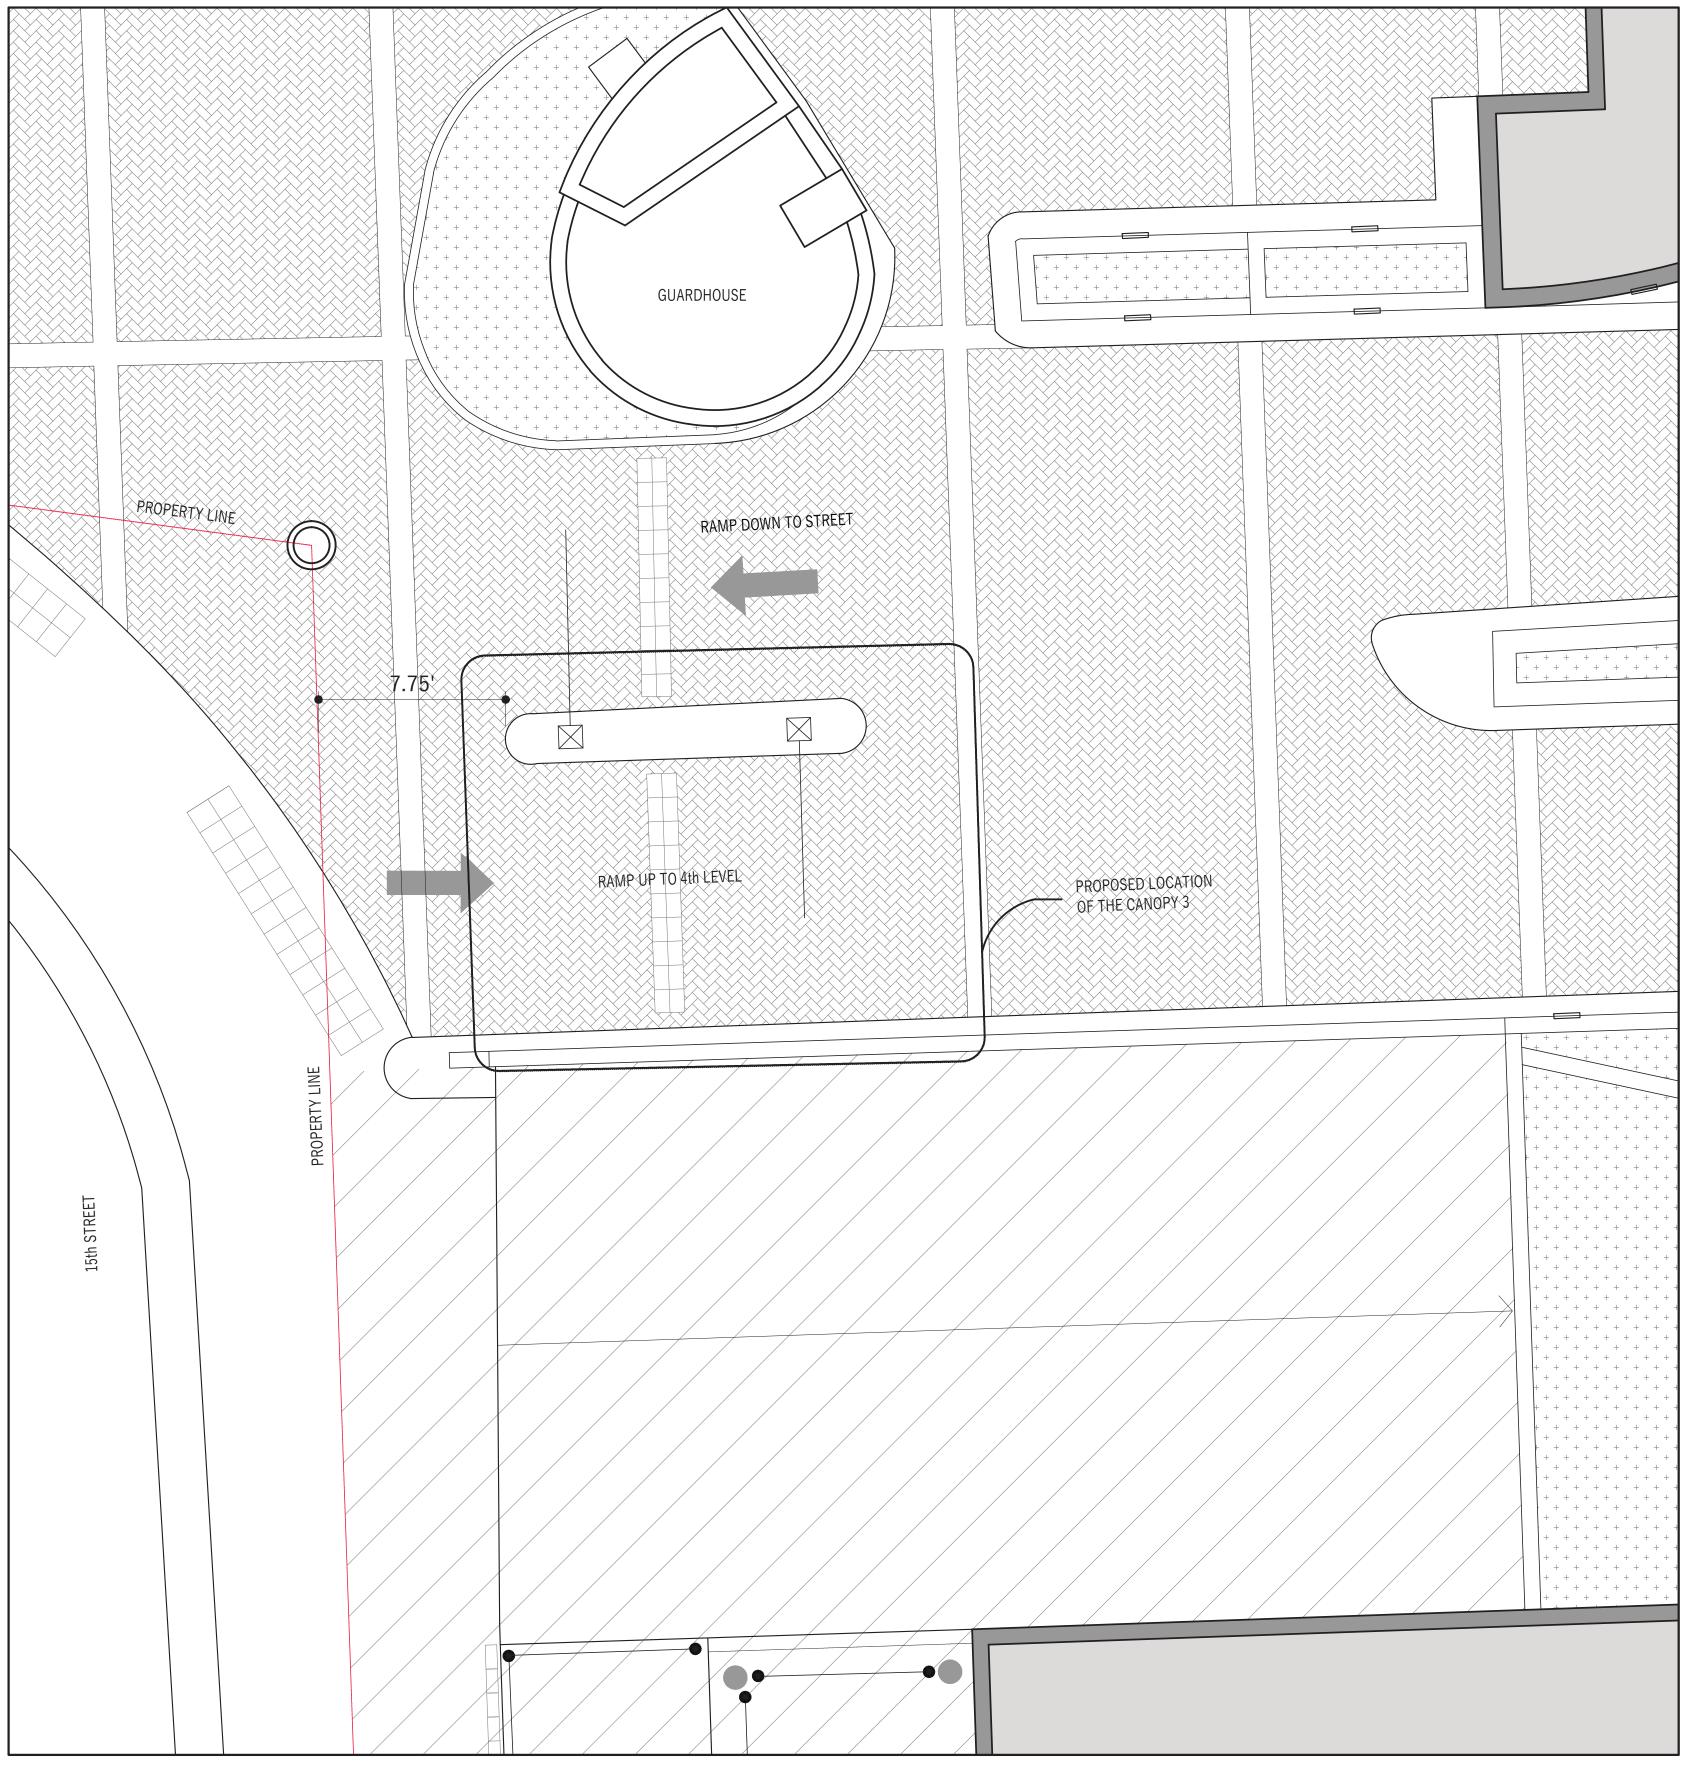

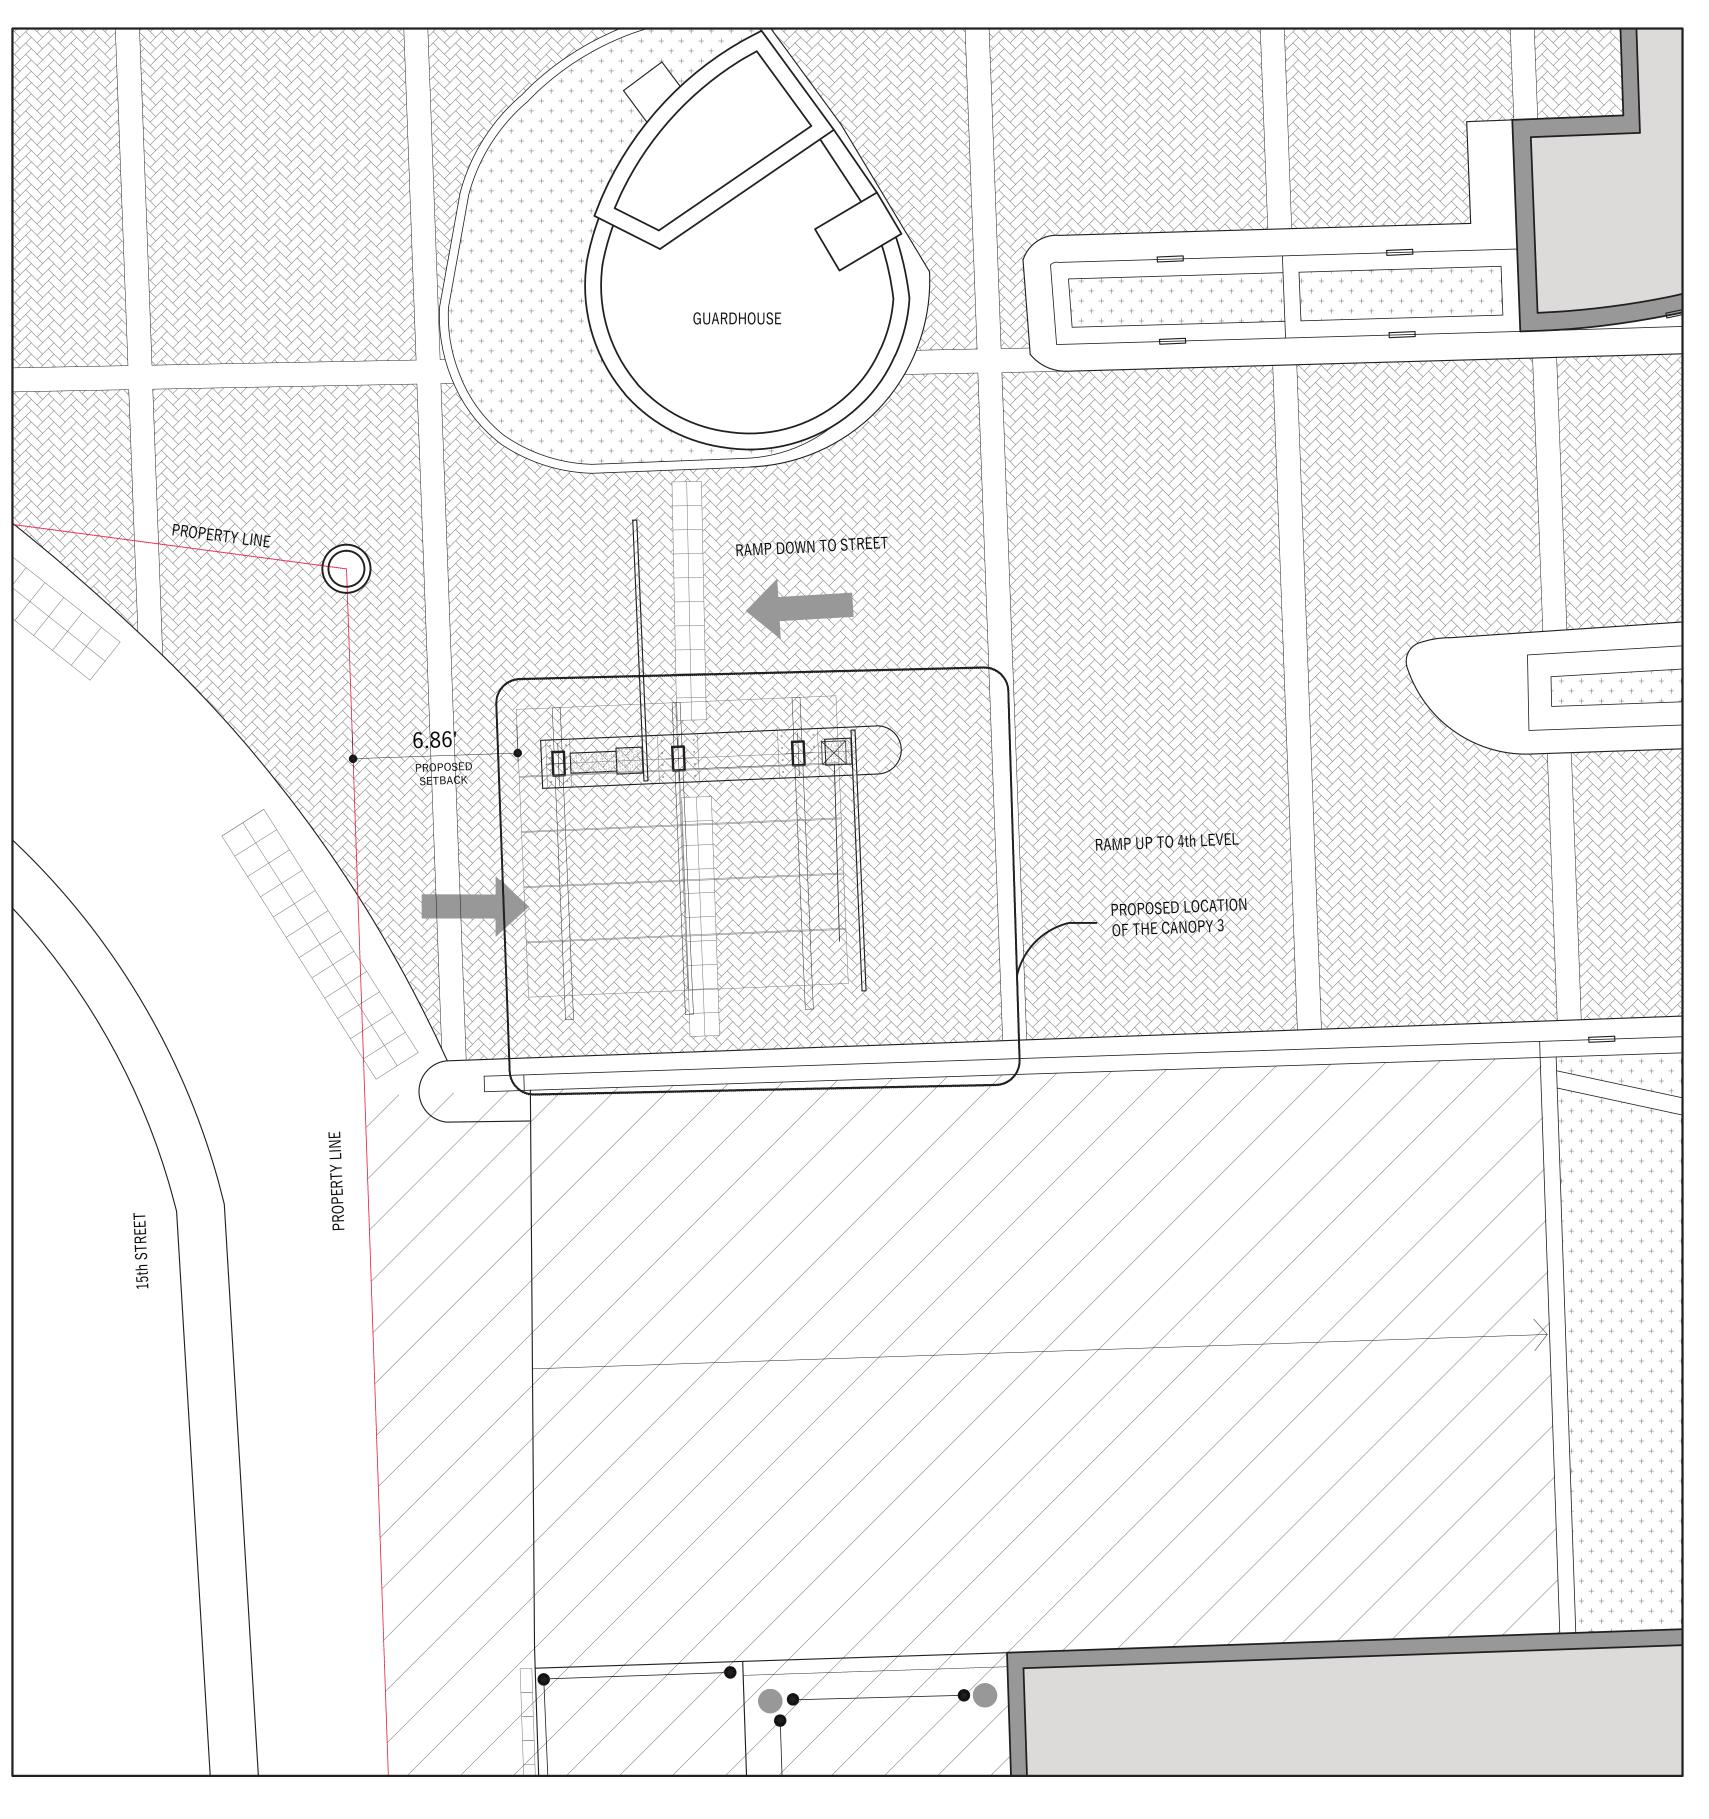





2

1/4"=1'

PARTIAL SITE PLAN - PROPOSED CONDITION

Job No 24-017
Project Manager AMB
Drawn by AS INDICATED
Date MARCH 2024


1/4"=1'


Signed and Sealed by: GABRIEL SALAZAR AR # 0009297


chitectural


SHEET No.


A-101

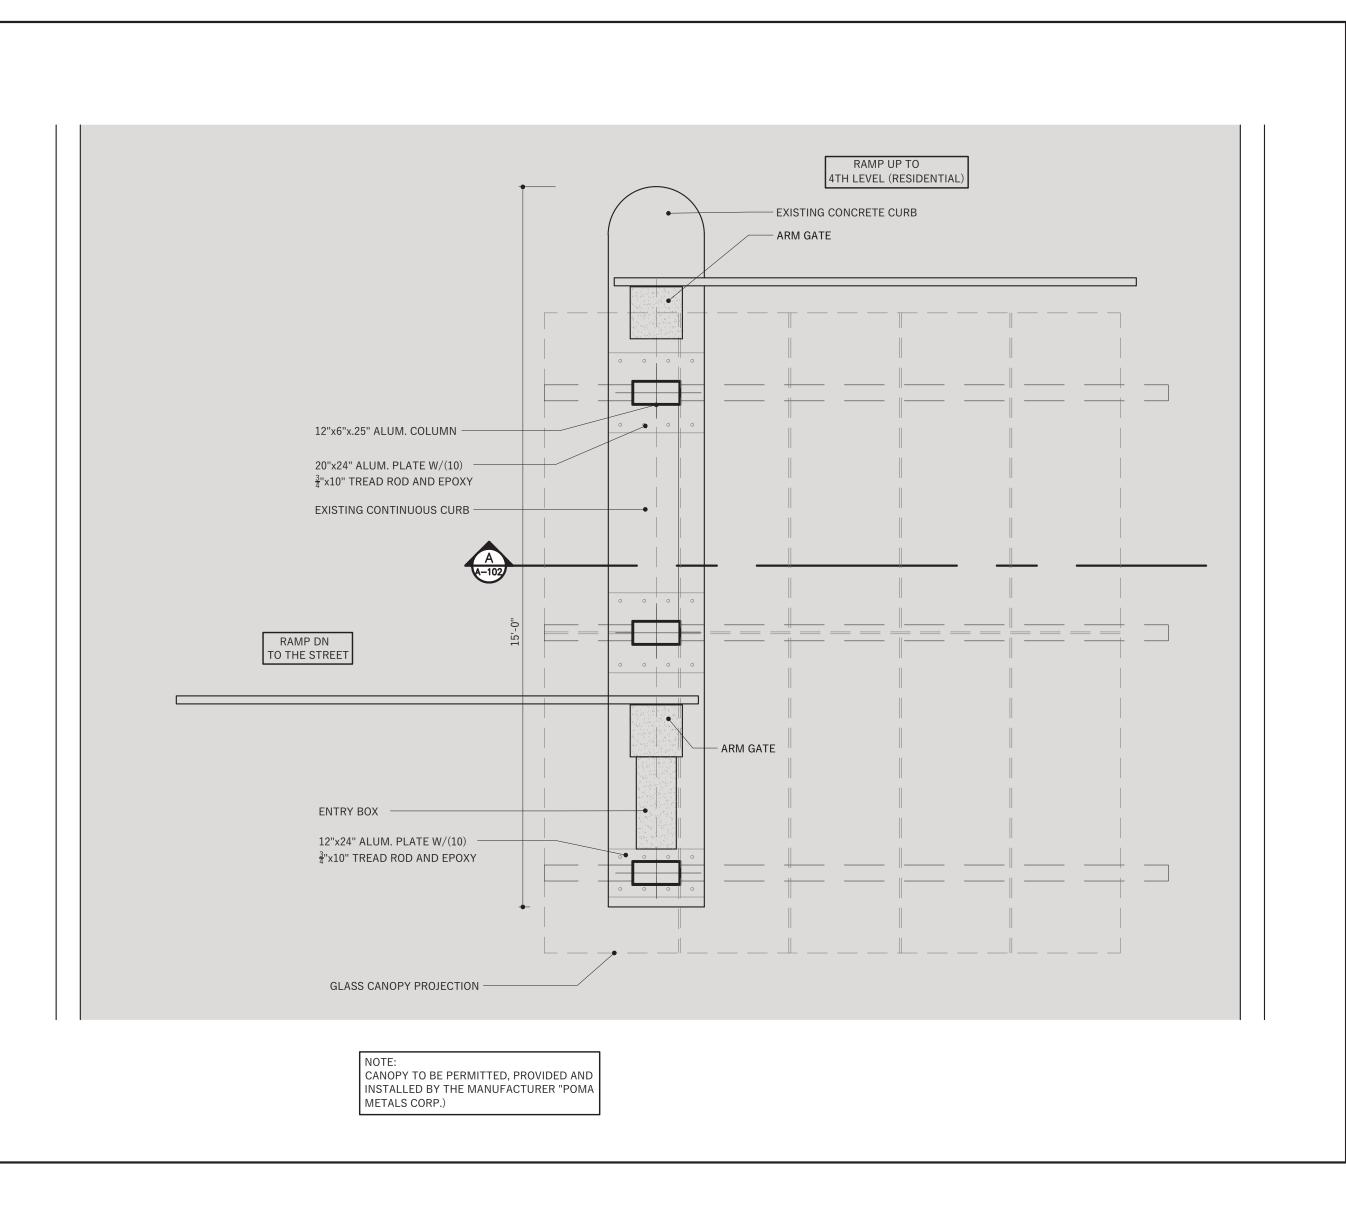


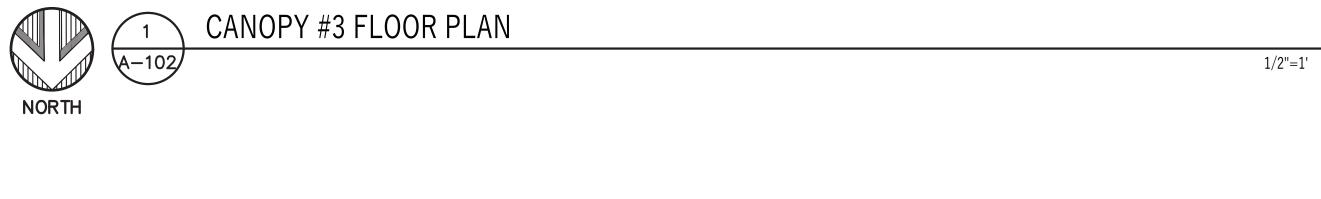

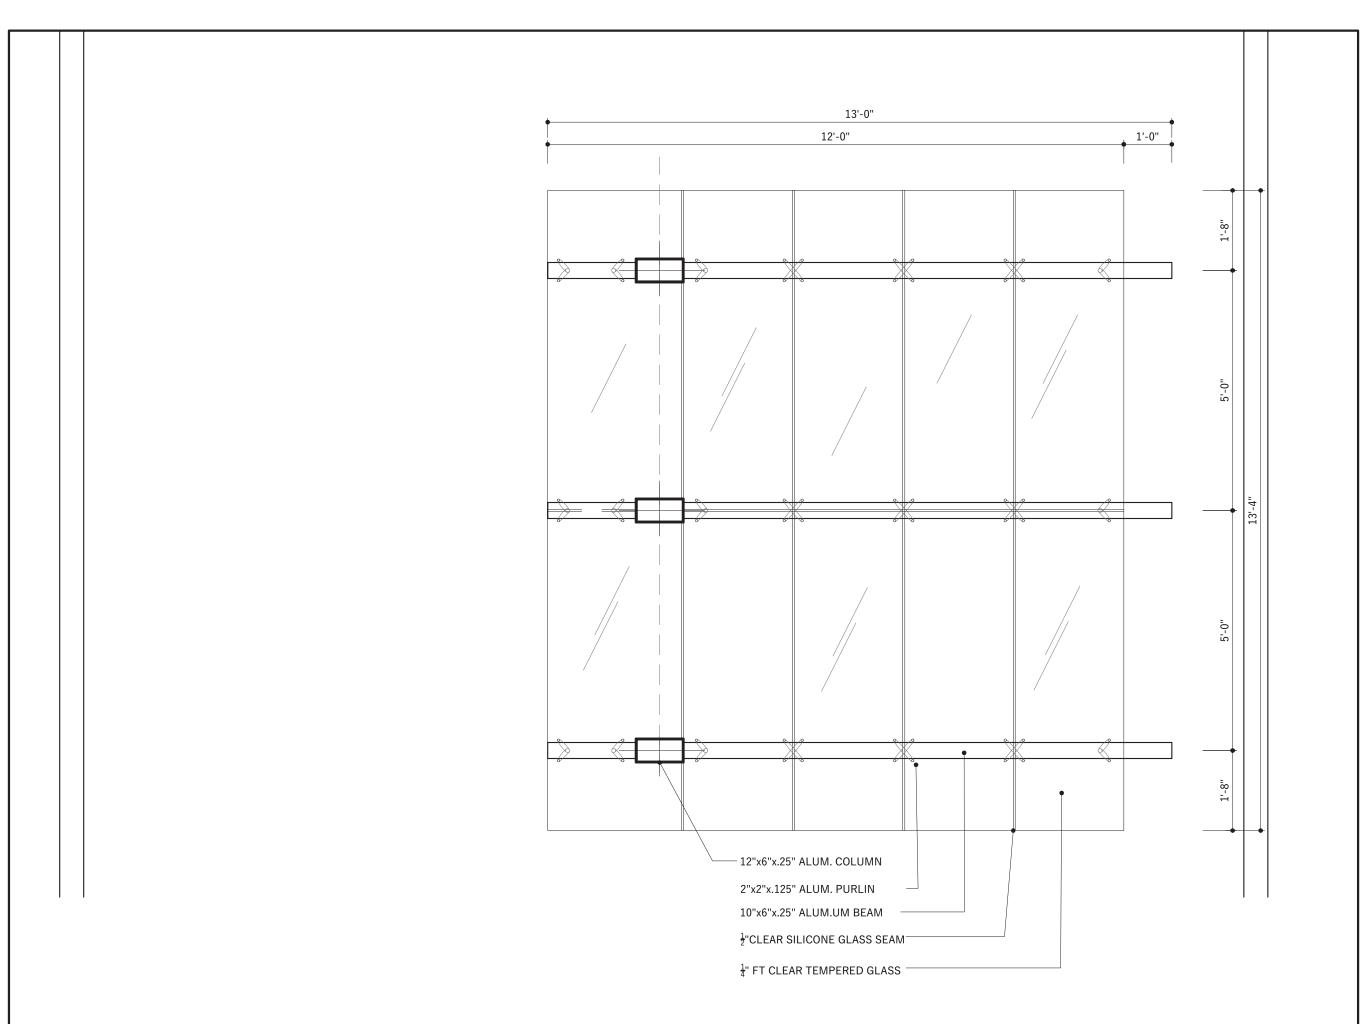

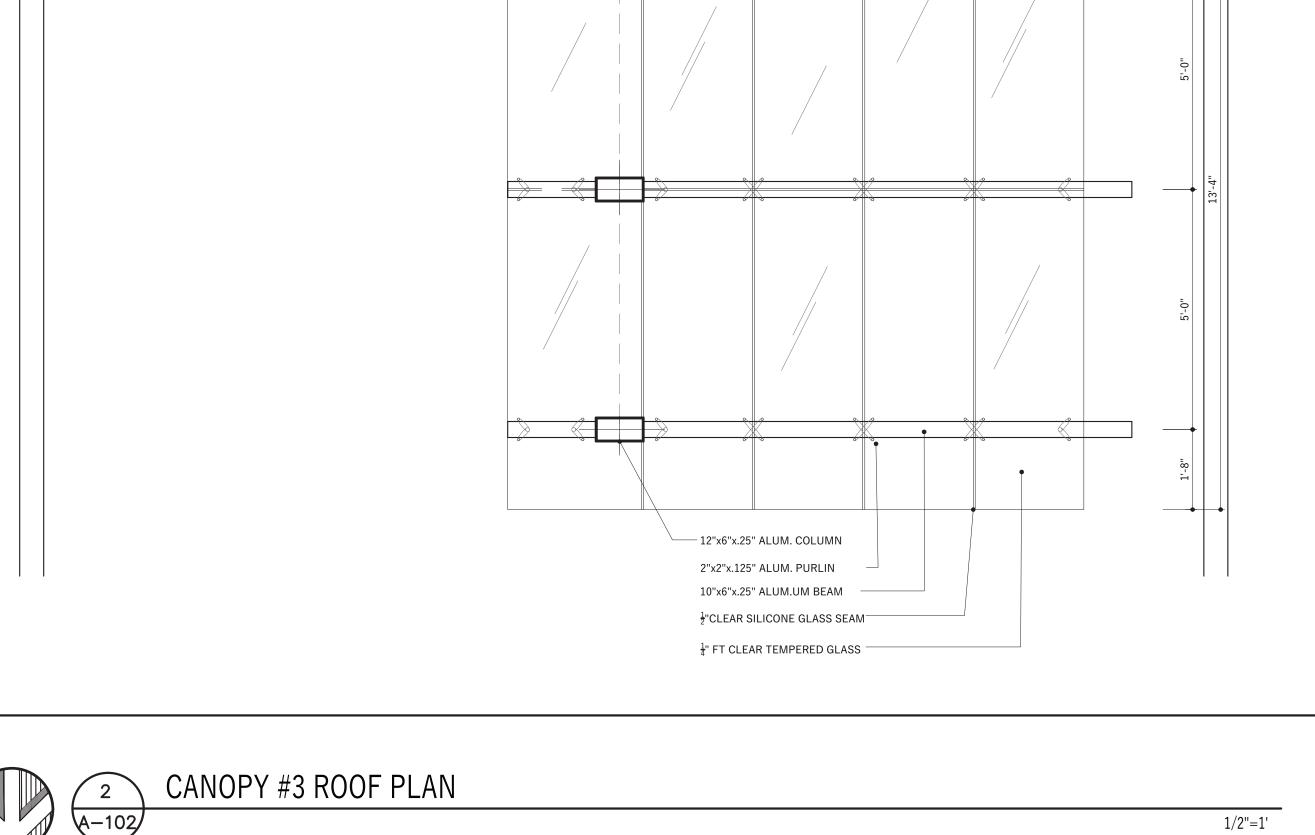

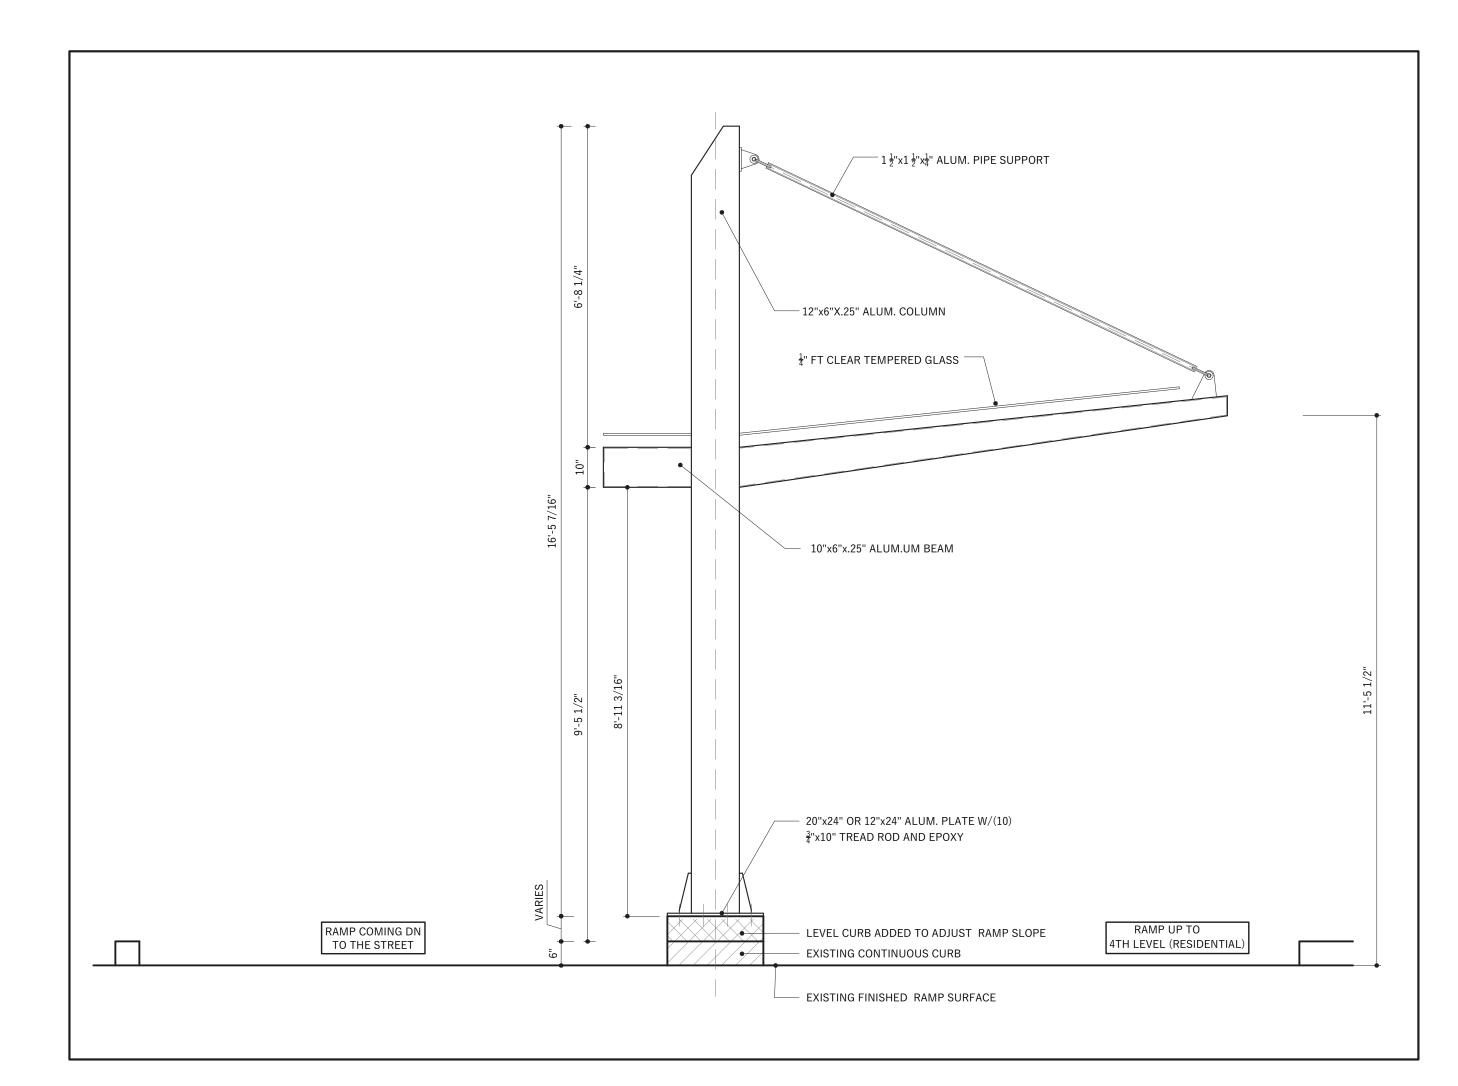

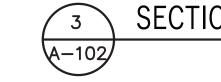

SECTION A

Signed and Sealed by: GABRIEL SALAZAR AR # 0009297

Project Manager AMB
Drawn by AS INDICATED

Date ____MARCH 2024


SHEET No.


REVISIONS

A-102

1/2"=1'



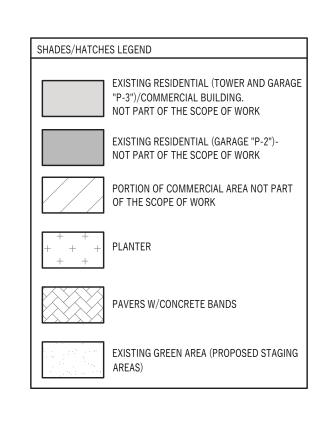

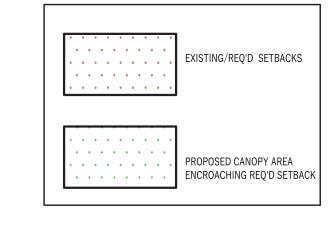

SITE INFORMA	ATION	
STREET ADDRESS: 1455 Ocean Drive Miami Beach	n. Florida 33139	
LEGAL DESCRIPTION All of the following described la	N:	
9, at Page 73 of the public recolline of Ocean Drive, a distance of North 88° 00'49"E along the Sot SUBDIVISION OF ALTON BEACH Plat Book 2, at Page 77 of the pralong the Easterly line of 15th Sthence run North 88° 00'49" Eafeet to the intersection of the Er Miami-Dade County, Florida; the feet to the intersection of the pr	erly corner of Lot 4, HARRISON AND HAYES S rds of Miami-Dade County, Florida, and run No of 295.70 feet to the Southerly line of 15th Streutherly line of 15th Street, a distance of 117.90 H, recorded in Plat Book 2, at Page 77 of the public records of Miami-Dade County, Florida; t treet, formerly Avenue "D", a distance of 35.49 st along the projection Easterly of the centerlinosion Control Line, recorded in Plat Book 105, ence run South 03° 26'32" West along the Ero rojecti on Easterly of the Southerly line of said un South 88° 00'49" West along the Southerly Point of Beginning (P.O.B.).	orth 01° 59'11" West along the Easter, formerly Avenue "D"; thence rul feet to the Easterly end of 15th Sublic records of Miami-Dade Counhence run North 07° 34'49" East leet to the centerline of said Strene of 15th Street, a distance of 210 at Page 62 of the public records of sion Control Line, a distance of 33 Lot 4 of aforesaid HARRISON AND
FOLIO NUMBER: 02-3234-115-0001		
FLOOD ZONE:	"AE", BASE FLOOD ELEVATION 8'	
CURRENT ZONING D	DISTRICT: MIXED USE ENTERTAINMEN	T DISTRICT (MXE)
BUILDING DISPOSITION:		
	REQUIRED	EXISTING/PROP
LOT OCCUPATION		
NET LOT AREA		101,169.71 SF
LOT WIDTH		East 332.19'/West 295.69'
SETBACKS- OCEANFRONT		
FRONT PEDESTAL TOWER	N/A N/A	EXISTING
SIDE - STREET PEDESTAL TOWER SIDE - INTERIOR	15% of the lot width + 5 feet (44.35'+ 5 feet=49.35')	(Non-Conforming) 41.89'-Prop. canopy-northernmos 6.86' Prop. canopy-northern clos side to the canopy
SIDE - INTERIOR PEDESTAL TOWER	15% of the lot width (44.35')	EXISTING
<u>REAR</u> PEDESTAL TOWER	25% of the lot depth or 75 ft min. from the bulkhead line which ever is greater (334.5'x25%= 83.65')	EXISTING



1/16"=1'-0"

REVISIONS

Signed and Sealed by: GABRIEL SALAZAR AR # 0009297

Project Manager AMB
Drawn by AS INDICATED

SHEET No.

SP-1