LINCOLN RD 350 Lincoln Rd Miami Beach, FL 33139

## **EXTERIOR SCOPE DESCRIPTION:**

- 1. Install illuminated green fins as architectural feature behind TD Signage on street facing north and west wall.
- 2. Replace TD Signage on ground level with TD Bank current design standards, including ceiling-hung illuminated TD cube at main entrance canopy.
- 3. Install Illuminated TD hyper shield on interior side of storefront window facing lincoln road.

05/15/2023




## PROPOSED EXTERIOR BRANDING & IMPROVEMENTS

ARCHITECTURE + DESIGN

350 Lincoln Road, Miami Beach, FL 33139

## MIAMI BEACH, FL



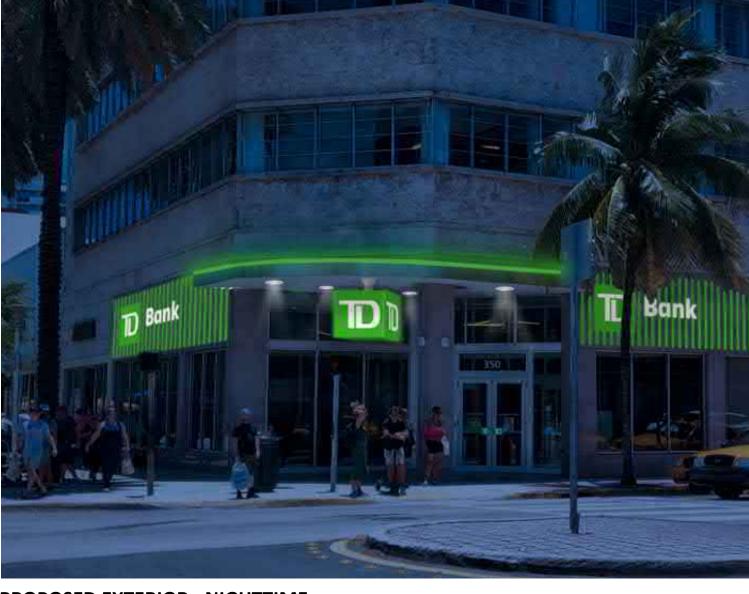

#### **PROPOSED EXTERIOR - DAYTIME**

\*Rendering provided by IRG

#### **PROPOSED EXTERIOR SCOPE OF WORK:**

- DEMO EXISTING TD SHIELD ABOVE ENTRANCE CANOPY AND REPAIR/ PATCH UP ROOF AS REQUIRED. INSTALL NEW INTERNALLY ILLUMINATED TD CUBE PROVIDED BY ATLAS, APPROX. DIM. PER SIDE: 33.52"X30" (WXH).
- PROVIDE NEW NOA MIAMI-DADE APPROVED IMPACT RESISTANT STOREFRONT SYSTEM AT MAIN ENTRANCE TO MATCH EXISTING INCLEAR ANODIZED FINISH AND INSTALL NEW TD DOOR PULLS ON BOTH SIDES OF DOORS.

#### **PROPOSED EXTERIOR - NIGHTTIME**

\*Rendering provided by IRG

- POWER WASH EXTERIOR BUILDING FACADE.
- DEMO EXISTING TD LOCKUPS AND REPAIR/PATCH UP WALL AS REQUIRED. INSTALL NEW TD LOCKUP OVER ILLUMINATED METAL FINS AT LINCOLN ROAD AND WASHINGTON AVE ELEVATIONS WITH NEW AS SHOWN.
- PROVIDE NEW TD 361 GREEN ARCHITECTURAL ILLUMINATED FINS AS SHOWN PROVIDED BY IRG.
- INSTALL GREEN LINEAR LIGHTING ABOVE CANOPY: BASIS OF DESIGN NOVE FLEX TAPE.

## TD BANK EXISTING EXTERIOR

350 Lincoln Road, Miami Beach, FL 33139

MIAMI BEACH, FL







**TD BANK OVERALL BUILDING VIEW** 

**TD BANK ENTRANCE VIEW** 

## TD BANK EXISTING EXTERIOR

350 Lincoln Road, Miami Beach, FL 33139

ENTERPRISE REAL ESTATE
ARCHITECTURE + DESIGN



MIAMI BEACH, FL





LINCOLN RD ELEVATION

**WASHINGTON AVE ELEVATION** 

# ENTERPRISE REAL ESTATE ARCHITECTURE + DESIGN

## MIAMI BEACH, FL



**WASHINGTON AVENUE SOUTH VIEW** 

# ENTERPRISE REAL ESTATE ARCHITECTURE + DESIGN

## MIAMI BEACH, FL







LINCOLN RD

## **SURROUNDING BUILDINGS**

350 Lincoln Road, Miami Beach, FL 33139

## **ENTERPRISE REAL ESTATE** ARCHITECTURE + DESIGN

## MIAMI BEACH, FL



LINCOLN RD INTERSECTION



**WASHINGTON AVE NORTH VIEW** 



## TD BANK - LINCOLN RD. 350 LINCOLN RD. MIAMI BEACH, FL 33139



**PERMIT SET** 03/30/2023

#### PROJECT DIRECTORY

Owner TD Bank Architect BERGMANN 8375 Dix Ellis Trail. Suite 105 12000 Atrium Way MT. Laurel, NJ 08054 Contact: Nicole Thompson-Floyd T: (813) 335-5043

General Contractor TBD

Street City/State/Zip Contact: T: ()

Electrical Engineer
BERGMANN
8375 Dix Ellis Trail, Suite 105 Jacksonville, FL 32256 Contact: Brett Garner T: (904) 760-4510

PROPOSED

BUSINESS GROUP B

: N/A : PER EXISTING

3,847.52 SF / 150 SF = 26.65 OCC

208.98 SF / 15 SF = 13.93 OCC

: 15 SF / 5 SF = 3 OCC : 93.12 SF / 7 SF = 13.30 OCC

PROVIDED PER EXISTING

2 (HIGH/LOW)

: EXISTING

: EXISTING : EXISTING : EXISTING : EXISTING

: CLASS "A"

: 4,672 SF GROSS AREA

: TENANT SPACE: +/- 18'-0" / 4,678 SF : 6 STORIES (TD IS ON FIRST FLOOR)

: 100.32+178.07+71.59+416.65 = 766.63 SF / 300 = 2.55 OCC

OCCUPANT LOAD AT MAXIMUM 49 PER LETTER FROM TD BANK

: 36" MIN, TOTAL EGRESS WIDTH 72" : 1 EXIT PROVIDED : 36" MIN, SWINGING DOOR LEAF

TELLER SPACE IN PLATFORM AREA

1.30 MINI, SWINGING DOOR LEAT 1.98 ACTUAL MAX 1.100% ENTRY/EXIT, CHANGE IN LEVELS, CLEAR AREA DOORWAY APPROACH, FIXTURE CLEARANCES, 48" REACH, 48" CONTROL HEIGHTS,

26.65+13.93+2.55+3+13.30 = 59 OCCUPANTS

Mechanical/Plumbing Engineer BERGMANN

Six Tower Bridge 181 Washington Street, Suite 430 Conshohookken, PA 19428 Contact: Evan Graves



An affiliate of Colliers Engineering & Design

TD BANK

LINCOLN RD

350 LINCOLN RD, MIAMI BEACH, FL 33139

06/23/2023 REVISION 1

PERMIT SET 03/30/2023

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S WRASMAN A MCINTYRE M DIEGAN Project Number 22007047A

**COVER SHEET** 

T-001

Construction Manager RJP Consulting Group 211 Welsh Pool Rd, Suite 200 Exton, PA 19341 Contact: Chris Groves T: (707) 815-6734 **CODE SUMMARY** APPLICABLE CODES
BUILDING CODE PLUMBING CODE MECHANICAL CODE ELECTRICAL CODE FIRE PROTECTION CODE FUEL GAS CODE ENERGY CODE ACCESSIBILITY CODE FIRE ALARM REQUIRED AND PROVIDED PER EXISTING PER 2020 FBC 907.2.2 DESCRIPTION **GENERAL** USE GROUP CONSTRUCTION TYPE BUILDING HEIGHT AND AREA NUMBER OF STORIES AREA MODIFICATIONS MIXED USE
AUTOMATIC SPRINKLER SYSTEMS
PORTABLE FIRE EXTINGUISHERS OCCUPANT LOAD GROSS FLOOR AREA OCCUPANCY - BUSINESS AREA - EMPLOYEE LOUNGE - COIN ROOM/ VAULT/ JANITOR CLOSET/ MECH/ ELEC TOTAL OCCUPANT LOAD FIXTURE - WATER CLOSET - LAVATORY - DRINKING FOUNTAIN - SERVICE SINK **EGRESS** OTHER EGRESS WIDTH NUMBER OF EXITS DOORWAY WIDTH ACCESSIBLE ROUTE

PLUMBING FACILITIES PER FBPC SECTION 403 REQUIRED

1 PER 25 FOR FIRST 50 AND 1 PER 50 FOR REMAINDER EXCEEDING 50
1 PER 40 FOR FIRST 80

: 7TH EDITION (2020) FLORIDA BUILDING CODE - BUILDING : 7TH EDITION (2020) FLORIDA BUILDING CODE - EXISTING BUILDING : 7TH EDITION (2020) FLORIDA BUILDING CODE - PLUMBING

THE DITION (2020) FLORIDA BUILDING CODE - FUEL GAS
THE EDITION (2020) FLORIDA BUILDING CODE - FUEL GAS
THE EDITION (2020) FLORIDA BUILDING CODE - ENERGY CONSERVATION
THE EDITION (2020) FLORIDA BUILDING CODE - ACCESSIBILITY

REQUIRED / ALLOWED

BUSINESS GROUP B

55'-0" / 14000 SE : 55-0 / 14 : 1 STORY : N/A : N/A

EXISTING NEPA 13

: 150 SF GROSS/ OCCUPANT

: 300 SF GROSS / OCCUPANT : 5 SF NET / OCCUPANT : 7 SF NET / OCCUPANT

15 SF NET / OCCUPANT

7TH EDITION (2020) FLORIDA BUILDING CODE - FLORIBING THE EDITION (2020) FLORIDA BUILDING CODE - MECHANICAL NFPA 70, 2017 NATIONAL ELECTRIC CODE 7TH EDITION (2020) FLORIDA FIRE PREVENTION CODE

CODE REFERENCE

SECTION 304.1 : TABLE 601 : TABLE 503 : TABLE 503

: TABLE 1004.5

N/A N/A

: W/ SPRINKLER 0.2"X39=7.8" : 1 REQUIRED : FBC TABLE 1019.1 & 1019.2 : FBC TABLE 1019.1 & 1019.2

32" CLEAR MIN, 48" MAX FOR SWINGING DOOR

FBC 1008.1.1

: FBC 11-4.3

: TABLE 601 : TYPE 1A = 3 HOURS : TYPE 1A = 1 HOURS (X>/=30') : TYPE 1A = 3 HOURS : TYPE 1A = 0 HOURS (X>/=30') : TYPE 1A = 0 HOURS TABLE 602 TABLE 601

EXIT ACCESS CORRIDORS ROOMS AND ENCLOSED SPACES TABLE 803.5

HVAC AND PLUMBING NOTES - NO CHANGES TO EXISTING MECHANICAL & PLUMBING SYSTEMS.

BUILDING STRUCTURE FRAME

INT NON-BEARING WALL

EXT BEARING WALL

THIS PROJECT IS A MINOR RENOVATION OF 4 672 SE INTERIOR FIT-OUT TO EXISTING BRANCH BANK WITH PRIMARY BUSINESS OCCUPANCY CLASSIFICATION OF WORK THIS PROJECT IS A MINOR RENOVATION OF 1672 OF INTERIOR FIT-OUT TO EASTING BRANCH CLASSIFICATION OF WORK ALTERATION LEVEL 1 PER FBC EXISTING BUILDING SECTION 602 IN A HISTORIC PRESERVATION BUILDING IN MIAMI SOUTH BEACH DISTRICT. BUILDING IS 4-STORY CONCRETE FRAME BUILDING STRUCTURE WITH MIXED OCCUPANCY AS PREVIOUSLY PERMITED. THE LIFE SAFETY SYSTEMS INCLUDE: FIRE SPRINKLER SYSTEM, FIRE EXTINGUISHERS AND ANNUNCIATION SYSTEMS. ENERGY SYSTEMS INCLUDE: LIGHTING CONTROLS, OCCUPANCY SENSORS.

NOTE: SIGNAGE TO BE SUBMITTED UNDER SEPARATE PERMIT

**EXISTING 22.4 SF TD** SHELD AT TOP OF **BUILDING TO REMAIN** 

INSTALL ILLUMINATED FINS, REFER TO A-201 & A-703

REPLACE EXISTING TD LOCKUP & PROVIDE TD GREEN ARCHITECTURAL FINS (NORTH WALL)

REPLACE EXISTING TD SHIELD WITH FLOATING **CUBE SUSPENDED BELOW CANOPY** (NORTHWEST WALL) INSTALL ILLUMINATED FINS, REFER TO A-201 & A-703

REPLACE EXISTING TD LOCKUP & PROVIDE TD **GREEN ARCHITECTURAL** FINS (WEST WALL)

EXISTING 22.4 SF TD SHELD AT TOP OF **BUILDING TO MATCH EXISTING** 

TD BANK 4,672 SF

**EXISTING SITE PLAN AND PROPOSED IMPROVEMENTS** 



FOR REFERENCE ONLY

NOTE: EXTERIOR SIGNAGE TO BE SUBMITTED BY SIGNAGE VENDOR UNDER SEPARATE PERMIT.



8375 Dix Ellis Trail Building 600, Suite 105 Jacksonville, FL 32256

TD BANK

LINCOLN RD

350 LINCOLN RD, MIAMI BEACH, FL 33139

PERMIT SET 03/30/2023

MICHELINE HIREZI DIEGAN, AIA LICENSE NUMBER: #AR93351 EXPIRATION DATE: 02/28/2025


1		
ı	Project Manager	Discipline Lead
Т	M DIEGAN	S WRASMAN
ı	Designer	Reviewer
Т	A MCINTYRE	M DIEGAN
ı	Date Issued	Project Number
Т	03/30/23	22007047A

CONCEPT SITE PLAN

NORTH

G-004

1 CONCEPT SITE PLAN
SCALE: 3" = 1'-0"

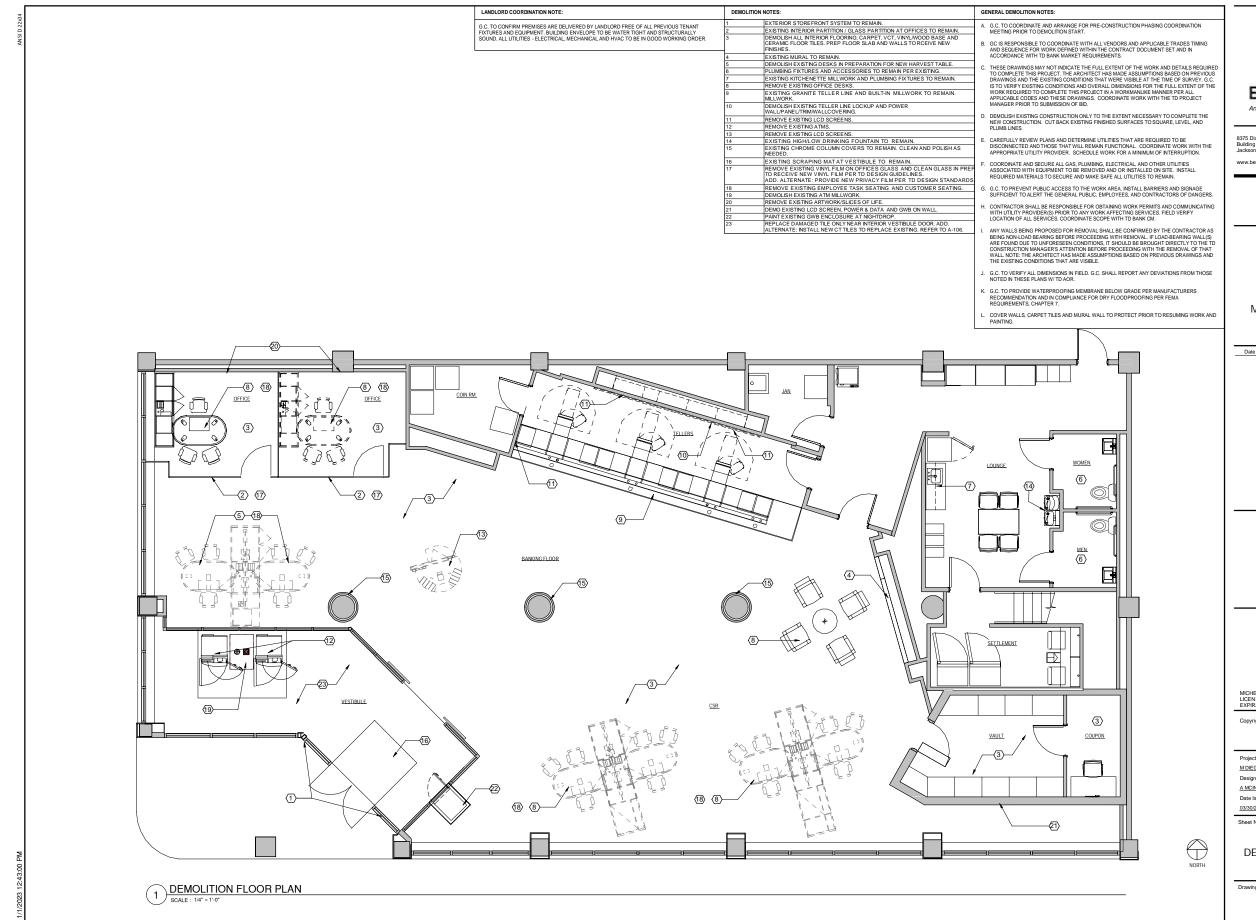



#### BERGMANN

An affiliate of Colliers Engineering & Design

TD BANK

LINCOLN RD

350 LINCOLN RD, MIAMI BEACH, FL 33139

Date Revised Description

> PERMIT SET 03/30/2023


MICHELINE HIREZI DIEGAN, AIA LICENSE NUMBER: #AR93351 EXPIRATION DATE: 02/28/2025

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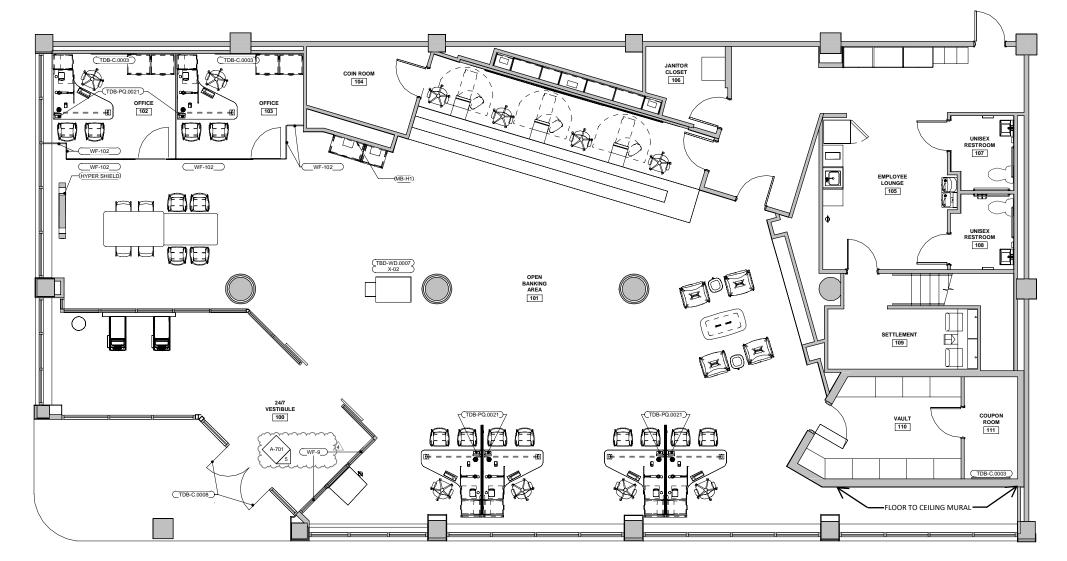
Project Manager	Discipline Lead
M DIEGAN	S WRASMAN
Designer	Reviewer
A MCINTYRE	M DIEGAN
Date Issued	Project Number
03/30/23	22007047A

DEMOLITION FLOOR PLAN

AD-101



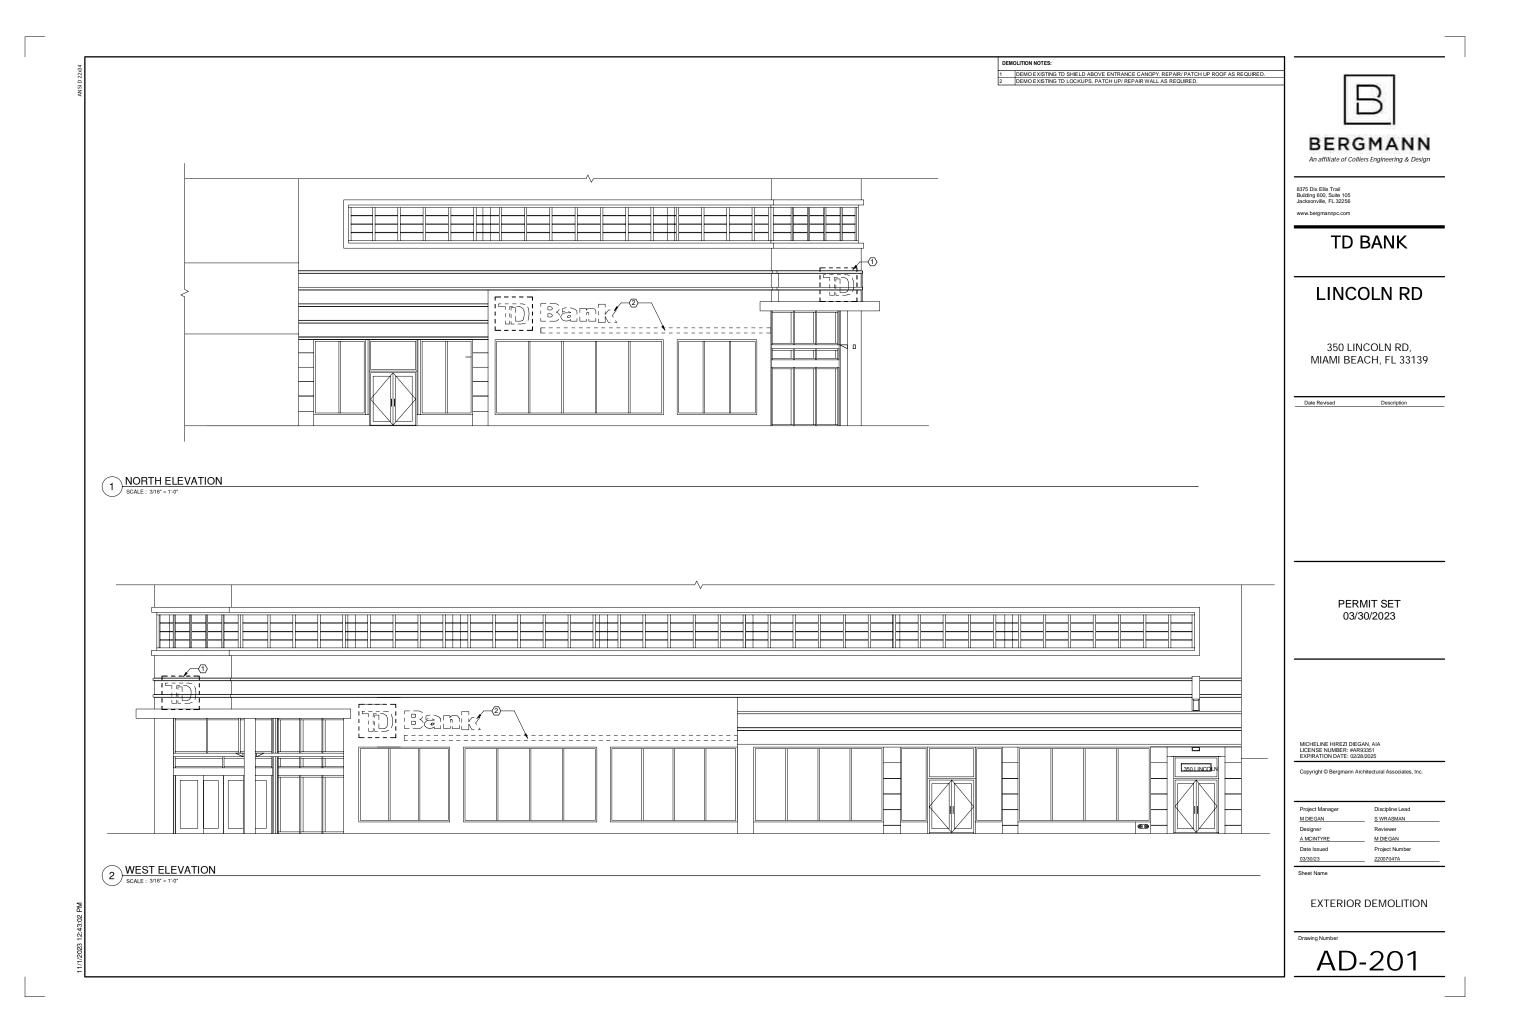



MERCHANDISING & SIGNAGE PLAN

SCALE: 1/4" = 1'-0"



8375 Dix Ellis Trail Building 600, Suite 105 Jacksonville, FL 32256

#### TD BANK

#### LINCOLN RD

#### 350 LINCOLN RD, MIAMI BEACH, FL 33139

Date Revised	Description		
06/23/2023	REVISION 1		
08/25/2023	REVISION 1		
09/14/2023	REVISION 2		
11/02/2023	REVISION 4		

PERMIT SET 03/30/2023


MICHELINE HIREZI DIEGAN, AIA LICENSE NUMBER: #AR93351 EXPIRATION DATE: 02/28/2025

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Project Manager M DIEGAN	Discipline Lead S WRASMAN
Designer	Reviewer
A MCINTYRE	M DIEGAN
Date Issued	Project Number
03/30/23	22007047A

MERCHANDISING AND SIGNAGE PLAN

A-108



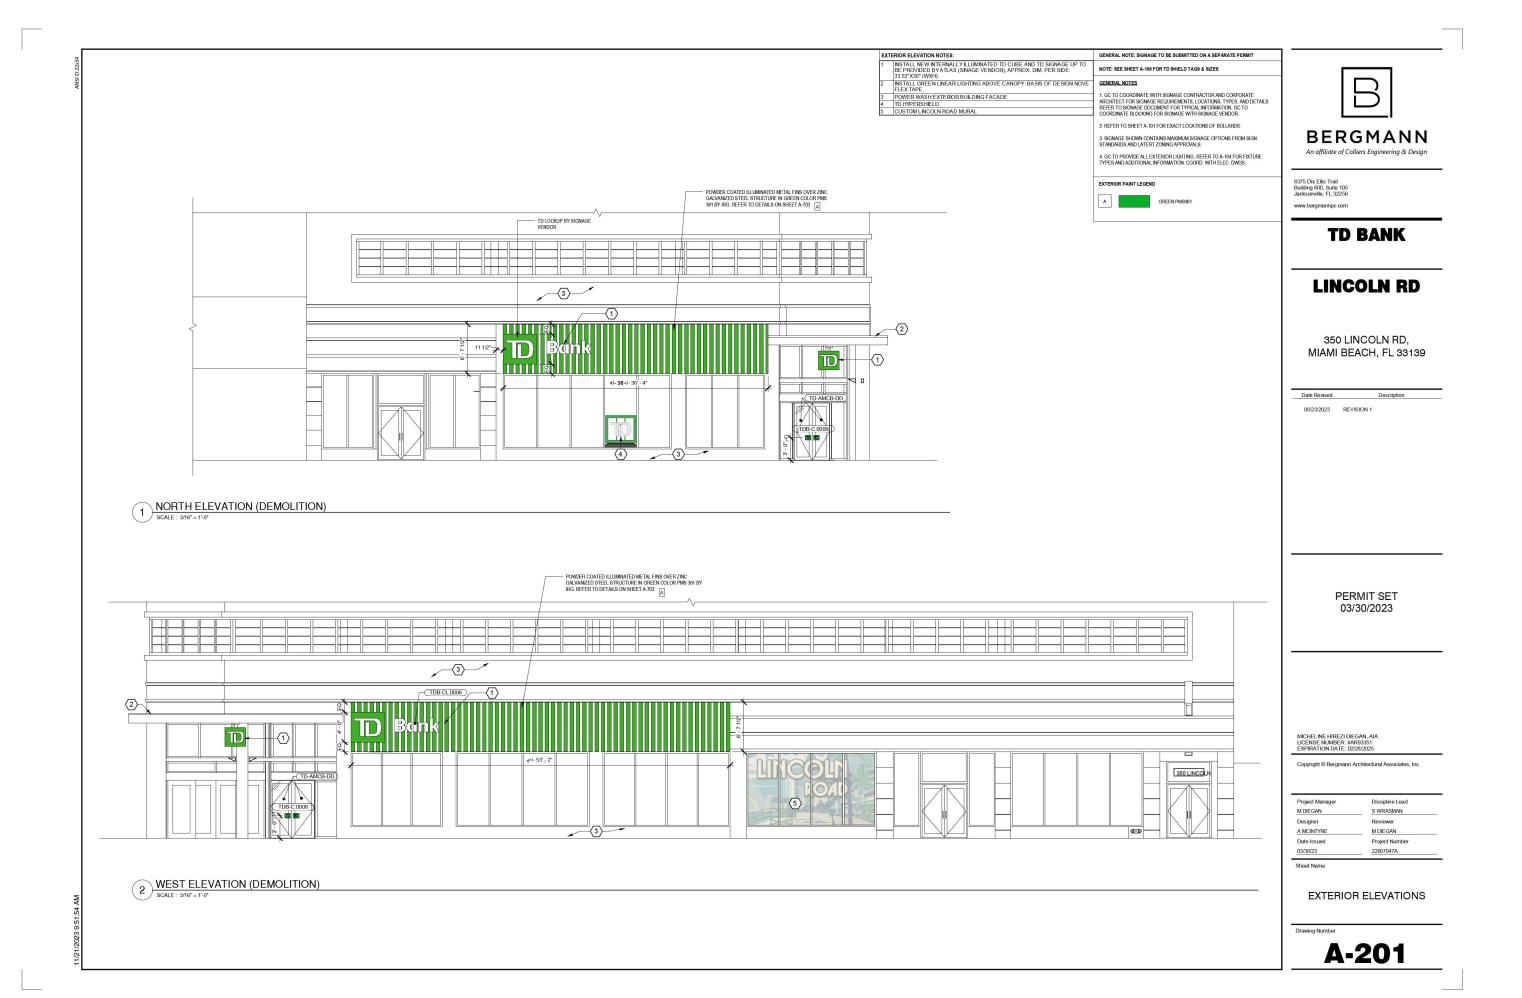

# 350 Lincoln Rd Miami Beach, FL

SO 148100

Created: 02.16.2023

Revised: 03.31.2023

05.17.2023

10.20.2023

10.27.2023



## Code

#### Wall Signs:

Maximum area calculation: 0.75 square feet for every foot of linear frontage, with a minimum of 15 square feet permissible, regardless of linear frontage. Maximum area Max.: 100 square feet

Sign	Proposed Sign	Qty	SQ FT
S01	IL Cabinet w/ Channel Letters	1	56.32
S02	IL Cabinet w/ Channel Letters	1	56.32
S03	Existing Wall Cabinet	1	22.4
S04	Existing Wall Cabinet	1	22.4
S05	IL Cube Sign	1	11.2
S06	Door Vinyl	1	-

#### Notes



SP





Revisions:	

#### **Face Lit Channel Letters**

#### Action:

- Remove Existing Letterset. Patch, repair, and paint area.
- Manufacture and install (1) face lit channel letterset.

#### Description:

- TD Shield construction to be aluminum returns with white acrylic faces secured with trimcap. Vinyl to be applied to logo faces with TD Copy to be exposed face material.
- Letterset and logo cabinet to be illuminated with white LEDs.
- Logo to be mounted with non corrosive fasteners.
- Letters to be mounted with nylon spacers.
- Letterset to be mounted on face of architectural features. Provided by others.

#### Material & Color:

- Logo Vinyl: 3M 3630-5741 Light Green Translucent Vinyl (First Surface)
- Entire Logo face and letters to be laminated with 3M 3660M
- Logo Returns: MP65220 R165605 TD Light Green (Satin Finish)
- Logo Trim Cap: MP65220 R165605 TD Light Green (Satin Finish)
- Logo and Letter Faces: 7328 White Acrylic
- Logo and Letters Illumination: White LED
- Letter Trim Cap: 1" White
- Letter Returns: Precoat White



Night Composite



**Existing Conditions** 



Proposed


#### Code:

Maximum area calculation: 0.75 square feet for every foot of linear frontage, with a minimum of 15 square feet permissible, regardless of linear frontage. Maximum area

Max.: 100 square feet

Existing Sign: 61.76 Sq Ft

Fins to have timed animated illumination creating motion

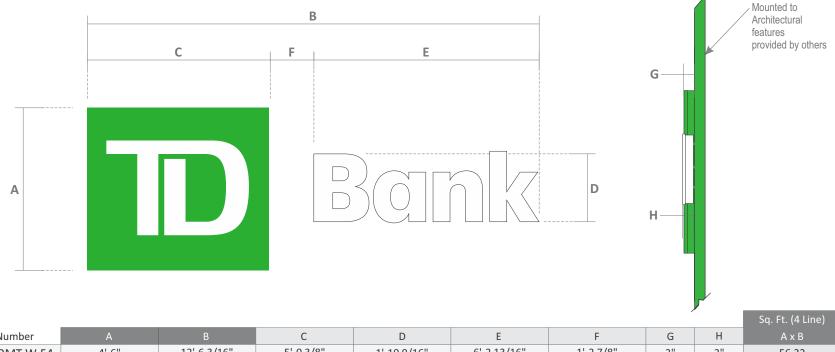

										3q. r t. ( <del>4</del> Line)
Sign Type	Part Number	А	В	С	D	E	F	G	Н	A x B
TDB-CL.0032	TDB-CL-RMT-W-54	4'-6"	12'-6 3/16"	5'-0 3/8"	1'-10 9/16"	6'-2 13/16"	1'-2 7/8"	3"	3"	56.32



Revisions:	
Revised Letterset 03.31.2023 TLD	

PM: SJP Address: 350 Lincoln Rd Drawn By: TLD

#### **Face Lit Channel Letters**

#### Action:

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- Logo and Letter Faces: 7328 White Acrylic
- Logo and Letters Illumination: White LED
- Letter Trim Cap: 1" White
- Letter Returns: Precoat White



Night Composite



**Existing Conditions** 




Proposed

#### Code:

Maximum area calculation: 0.75 square feet for every foot of linear frontage, with a minimum of 15 square feet permissible, regardless of linear frontage. Maximum area Max.: 100 square feet

Existing Sign: 61.76 Sq Ft

Fins to have timed animated illumination creating motion

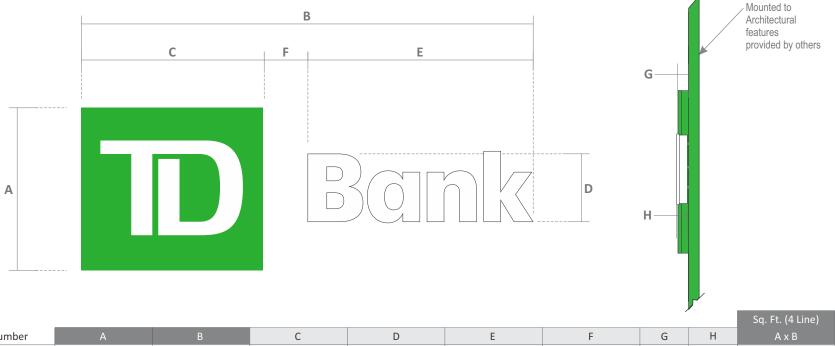

										34. 1 t. (4 Lille)	4
Sign Type	Part Number	А	В	С	D	Е	F	G	Н	A x B	
TDB-CL.0032	TDB-CL-RMT-W-54	4'-6"	12'-6 3/16"	5'-0 3/8"	1'-10 9/16"	6'-2 13/16"	1'-2 7/8"	3"	3"	56.32	



Revisions:	
levised Letterset 03.31.2023 TLD	






















Revisions:	

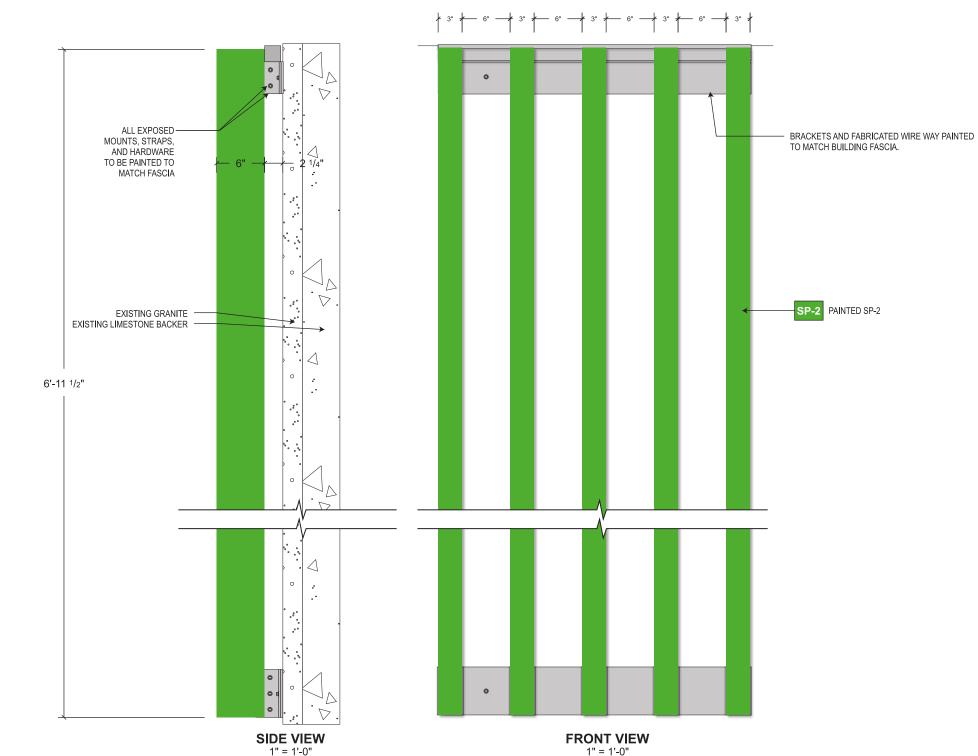

### TDB-FINS 210.49 sq.ft

210.49 sq.ft 841-11 1/2 lf.

#### Signage Description

HALO ILLUMINATED TD GREEN FINS.

COLOR SCHEDULE	
Matthews TD Light Green Paint #MP65220 Ver 1.3 (Satin Finish)	SP-2
Matthews Paint Gray Epoxy Primer # 274528SP	SP-8

#### **Electrical Specifications**

 Power SUPPLIES:
 60W Power Supply

 AMPS:
 Total AMPS

 Circuits:
 20 Amp Circuit

 Volts:
 120 Volts
 277 Volts

- ALL ELECTRICAL COMPONENTS ARE TO BE U.L. LISTED AND APPROVED AS PER NEC.5 2011
- \*ALL TRANSFORMERS GROUND FAULT PROTECTED & COMPLY WITH NEC-600-23
- ALL SECONDARY WIRING INSIDE SIGN IS TO BE HIGH TENSION GTO AS PER NEC-600-31
   ALL PRIMARY WIRING TO BE #12 THWN AS PER
- NEC-60-5
   GROUNDING AND BONDING AS PER NEC 250
- INSTALLATION WILL COMPLY WITH ALL OF THE REQUIREMENTS OF NEC 600 & FBC.505.2.4 SIGNS WILL BE CONTROLLED BY A PHOTOCELL


OR ASTRONOMICAL TIME CLOCK.

10-25-23 RKN Added attachment details | 10-26-23 RKN Added existing wall detail.



# DRAWING APPROVAL APPROVED REVISE AND RESUBMIT APPROVED AS NOTED NAME: DATE:

#### **Typical Sign Connection Details**

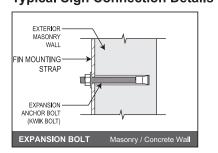

## EXPANSION BOLT Bolt Diameter: 3/8"

52

1 3/4"

See Page 4 for placement and qty per elevation break down

#### **Connection Specifications:**

Qty:

Min. Embed:


Attach Fins to Wall with Connectors. See Engineered sealed drawings for Complete Specifications. Do Not Overtighten Connectors. Use Oversized Washer Backers for Thru Wall Connectors.

130 PINNACLE POINT CT., SUITE 101
COLUMBIA, SC 29223
PHONE: 803-790-2121
FAX: 803-790-2125
www.imageresourcegroup.com


THIS IS AN UNPUBLISHED DESIGN OFFERED BY IRG, INC.. IT IS SUBMITTED FOOD TO SUBMITTED SUBMITTED FOOD TO SUBMITTED FOOD T

FOR R YOU	CLIENT:	TD Bank		
	LOCATION:	350 Lincoln R	oad, Miami Beach	, FL
	DRAFTED BY	RKN	PROJECT MANAGER:	WHANCE


DRAWING NUMBER:	TDB-FINS
SHEET: 1	OF: 7
DATE: 03-29-23	PAGE:

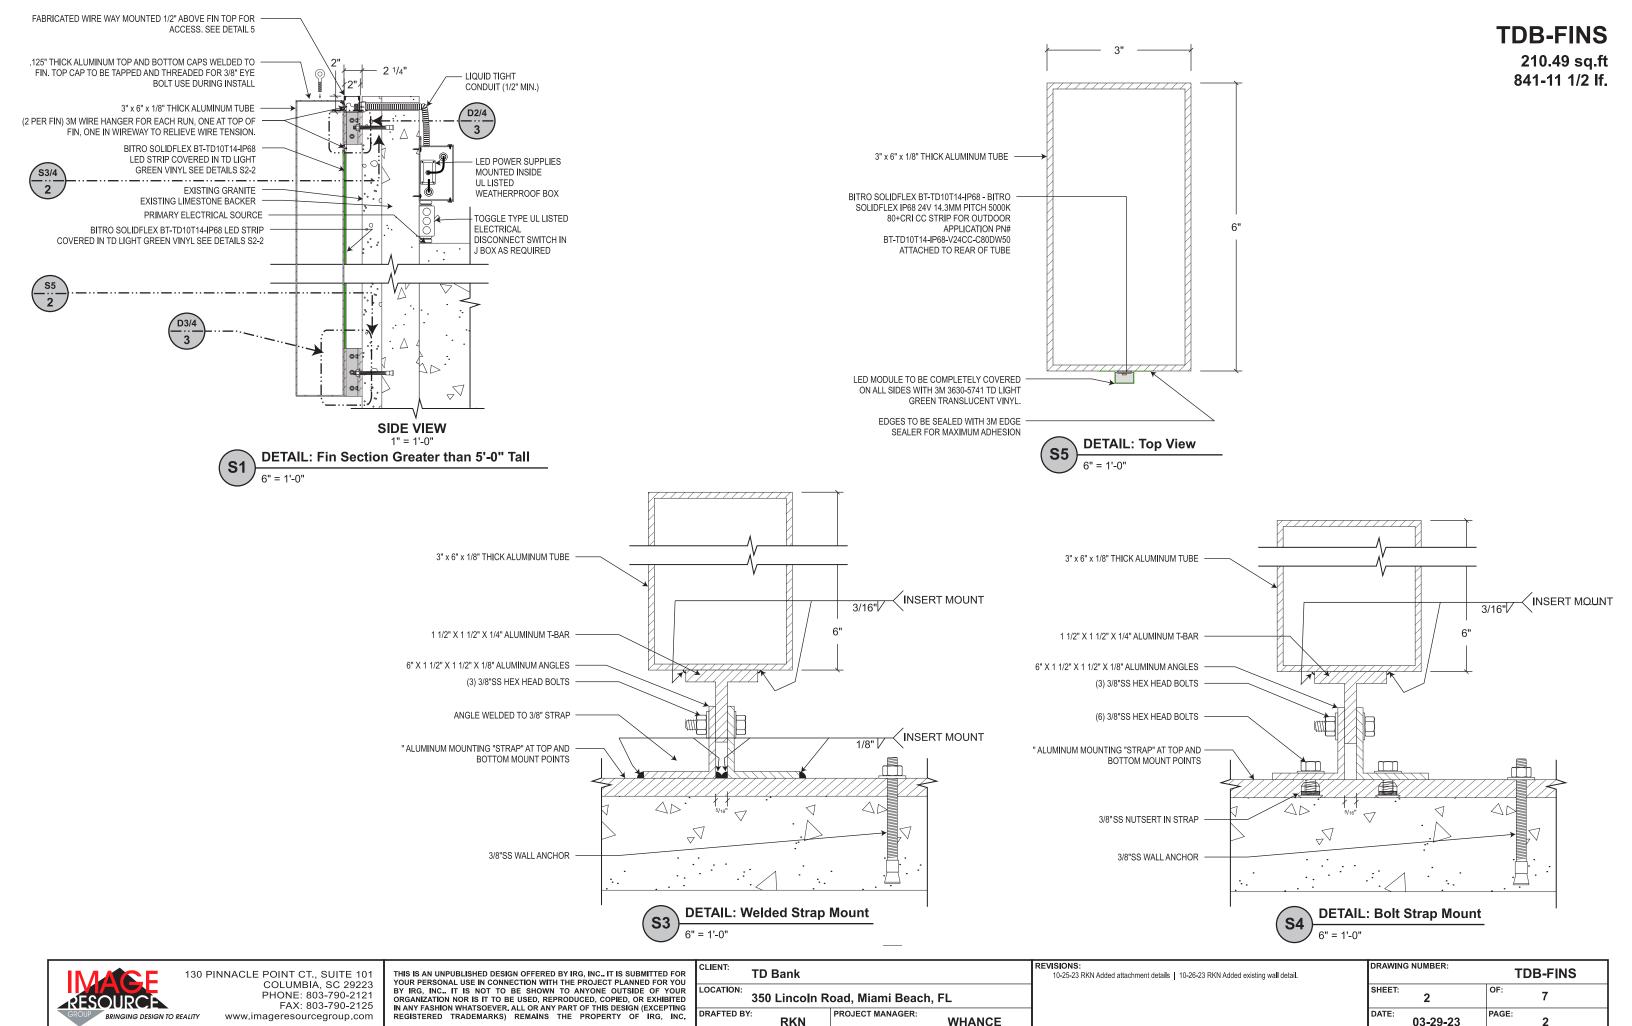





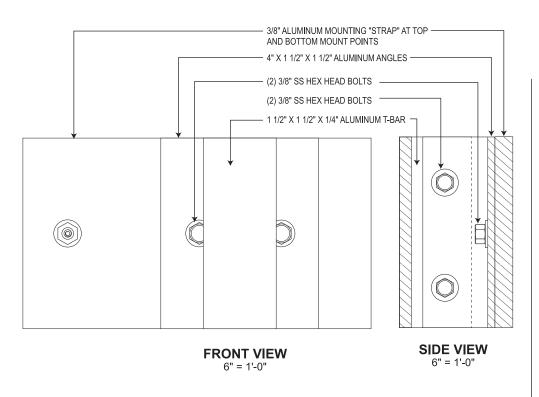



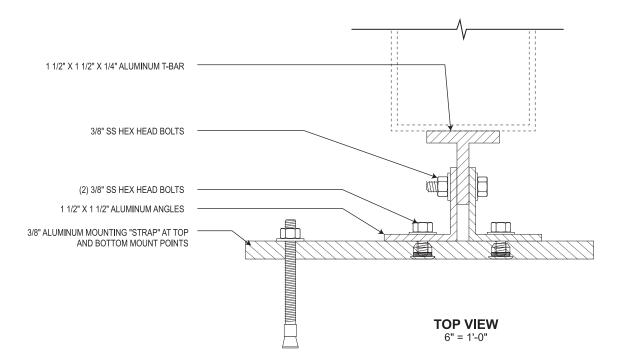

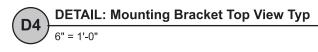

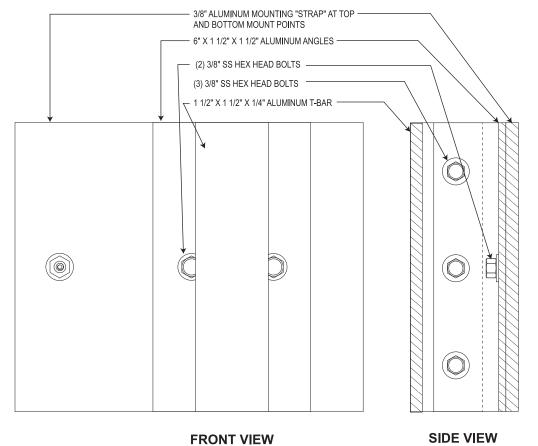

DETAIL: 6" Mounting Bracket Side and Front View

6" = 1'-0"

6" = 1'-0"

10-25-23 RKN Added attachment details | 10-26-23 RKN Added existing wall detail.


D3 6" = 1'


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COLUMBIA, SC 29223
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FAX: 803-790-2125
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FOR YOU	CLIENT:	TD Bank			<b>REVISIONS:</b> 10-25-23 RI
OUR ITED TING	LOCATION:	350 Lincoln R	oad, Miami Beach, FL		
	DRAFTED B	r: RKN	PROJECT MANAGER: WH	ANCE	

DRAWING NUMBER:	TDB-FINS
SHEET:	OF: 7
DATE: 03-29-23	PAGE:





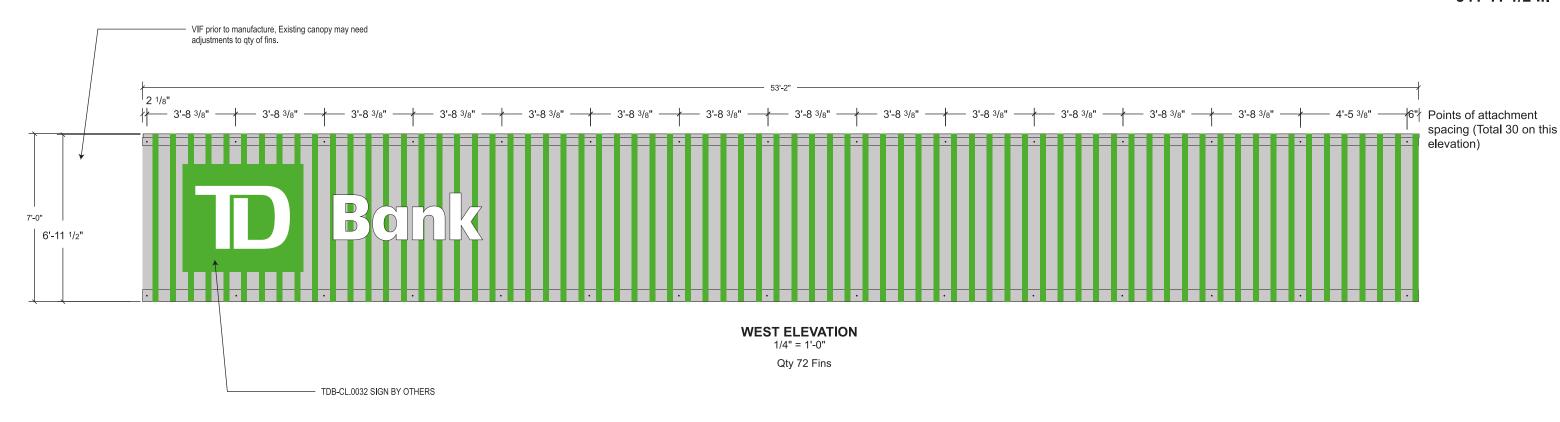

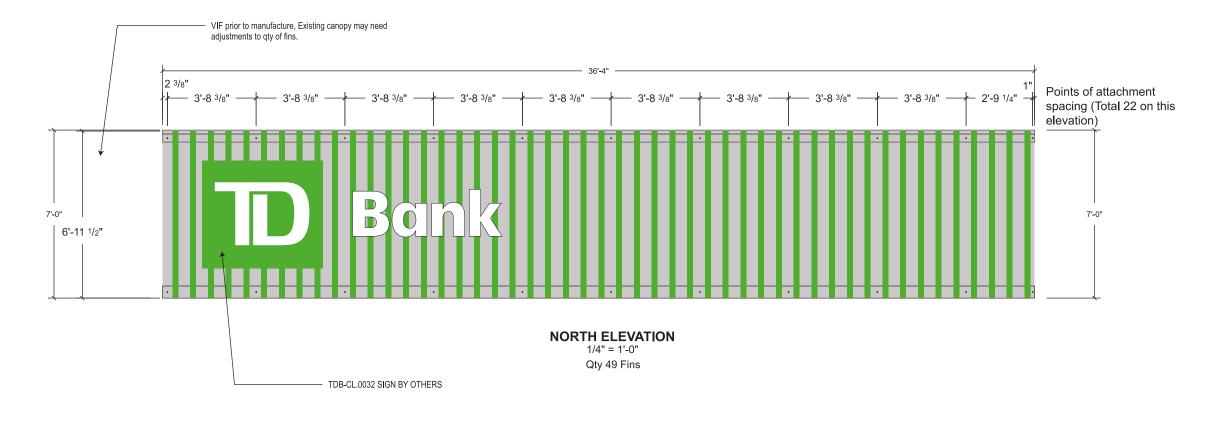130 PINNACLE POINT CT., SUITE 101 COLUMBIA, SC 29223 PHONE: 803-790-2121 FAX: 803-790-2125 eautry www.imageresourcegroup.com THIS IS AN UNPUBLISHED DESIGN OFFERED BY IRG, INC.. IT IS SUBMITTED FO YOUR PERSONAL USE IN CONNECTION WITH THE PROJECT PLANNED FOR YO BY IRG, INC.. IT IS NOT TO BE SHOWN TO ANYONE OUTSIDE OF YOU ORGANIZATION NOR IS IT TO BE USED, REPRODUCED, COPIED, OR EXHIBITE IN ANY FASHION WHATSOEVER. ALL OR ANY PART OF THIS DESIGN (EXCEPTIN REGISTERED TRADEMARKS) REMAINS THE PROPERTY OF IRG, INC


FOR YOU	CLIENT:	TD Bank		<b>REVISIONS:</b> 10-25-23 RK
DUR TED ING	LOCATION:	350 Lincoln R	oad, Miami Beach, FL	
INC.	DRAFTED BY	r: RKN	PROJECT MANAGER: WHANCE	

DRAWING	NUMBER:	TDB-FINS		
SHEET:	4	OF:	7	
DATE:	03-29-23	PAGE:	4	

10-25-23 RKN Added attachment details | 10-26-23 RKN Added existing wall detail.

#### LIGHTING SCHEME

LIGHTING SCHEME: Fins will light at the same time on both elevations in 8 steps. North elevation, a qty of 6 fins (7 on the final grouping) will light, while a qty of 9 fins per section on the West Elevation will light. These will be programmed so the farthest groups from the entrance will light on both elevations at the same time, and drive the illumination towards the entrance.

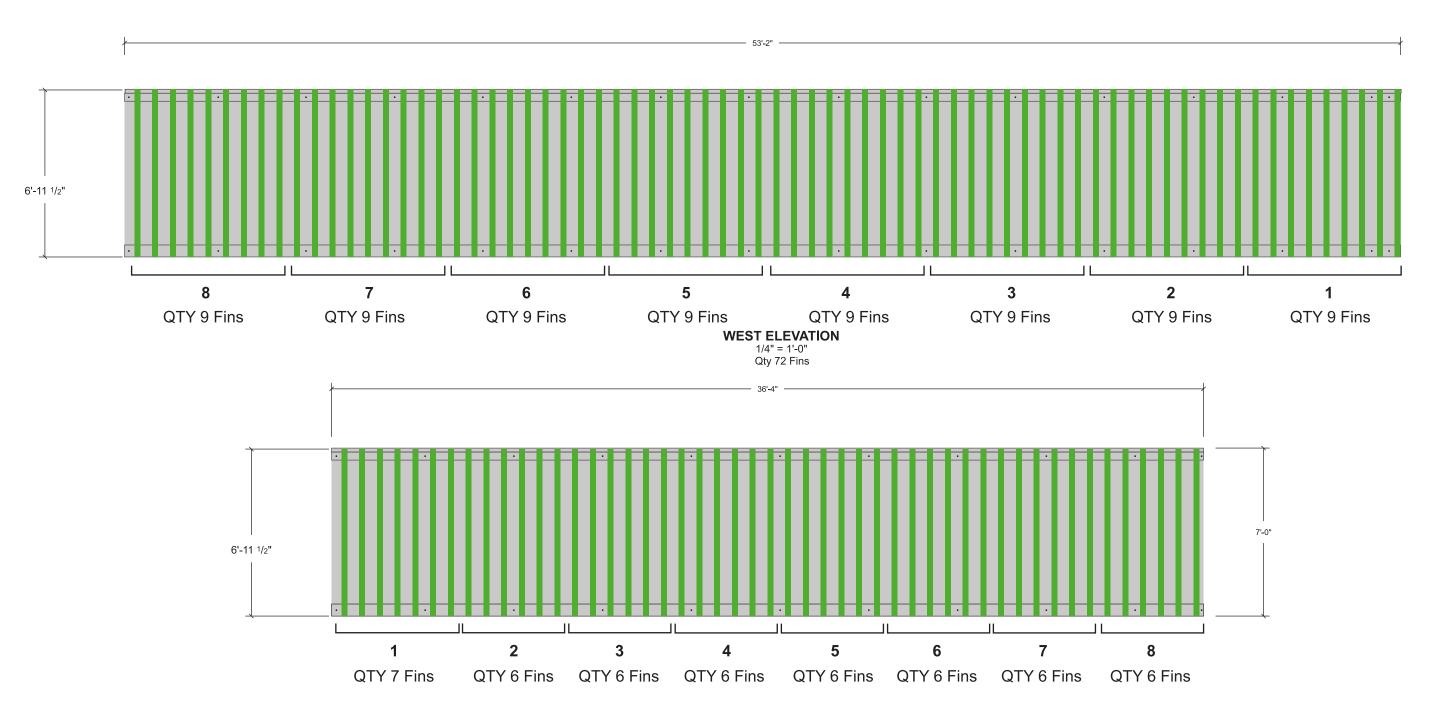

## NORTH ELEVATION 1/4" = 1'-0"

1/4" = 1'-0" Qty 49 Fins

130 PINNAGE 130 PI


130 PINNACLE POINT CT., SUITE 101 COLUMBIA, SC 29223 PHONE: 803-790-2121 FAX: 803-790-2125 www.imageresourcegroup.com THIS IS AN UNPUBLISHED DESIGN OFFERED BY IRG, INC... IT IS SUBMITTED FOR YOUR PERSONAL USE IN CONNECTION WITH THE PROJECT PLANNED FOR YOU BY IRG, INC... IT IS NOT TO BE SHOWN TO ANYONE OUTSIDE OF YOUR ORGANIZATION NOR IS IT TO BE USED, REPRODUCED, COPIED, OR EXHIBITED IN ANY FASHION WHATSOEVER, ALL OR ANY PART OF THIS DESIGN (EXCEPTING REGISTERED TRADEMARKS) REMAINS THE PROPERTY OF IRG, INC.


OR OU	CLIENT:	TD Bank			REVISIONS: 10-25-23 RKN Added attachment details   10-26-23 RKN Added existing wall detail.
	LOCATION:	350 Lincoln R	oad, Miami Beach	, FL	
NC.	DRAFTED BY	Y: RKN	PROJECT MANAGER:	WHANCE	

DRAWING NUMBER:		TD	B-FINS
SHEET:	5	OF:	7
DATE:	03-29-23	PAGE:	5

## **TDB-FINS DMX Animated Light Wiring Scheme**



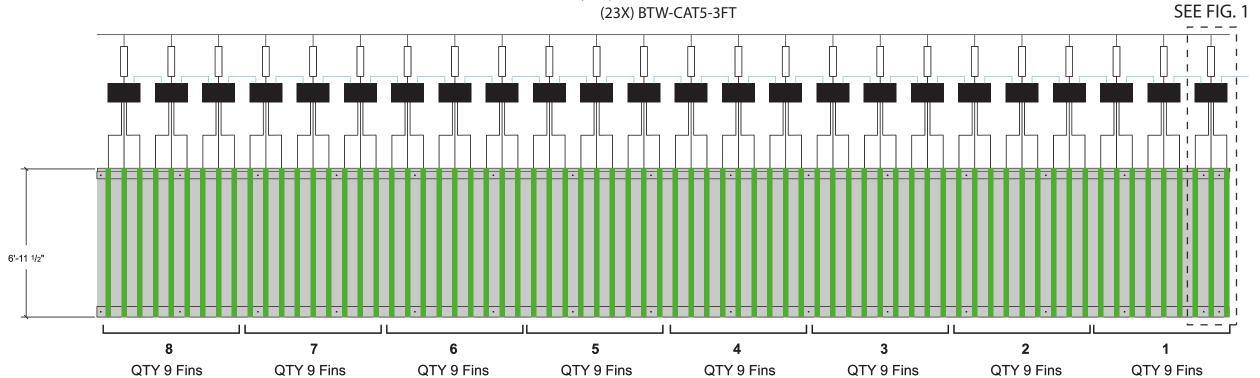

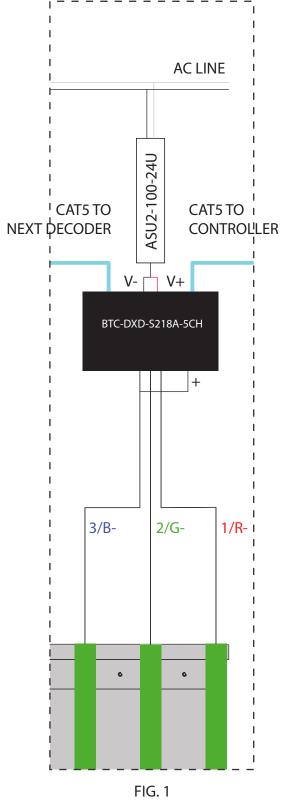

(15X) BTW-CAT-3FT 6'-11 1/2" 1 2 3 5 6 7 8

(16X) ASU2-100-24U (16X) BTC-DXD-S218A-5CH

QTY 6 Fins QTY 6 Fins

TYP. WIRING DETAIL (3 FINS)

BRINGING DESIGN TO REALITY

130 PINNACLE POINT CT., SUITE 101 COLUMBIA, SC 29223 PHONE: 803-790-2121 FAX: 803-790-2125 www.imageresourcegroup.com

QTY 7 Fins

THIS IS AN UNPUBLISHED DESIGN OFFERED BY IRG, INC.. IT IS SUBMITTED FOOD TO SUBMITTED SUBMITTED FOOD TO SUBMITTED FOOD T

FOR	CLIENT:	TD Bank			REVISIONS: 10-25-23 RKN Added attachment details   10-26-23 RKN Added existing wall detail.
OUR BITED PTING	LOCATION:	350 Lincoln R	oad, Miami Beach,	FL	
INC.	DRAFTED B	Y: RKN	PROJECT MANAGER:	WHANCE	

			_
DRAWING NUMBER:		TDB-FINS	
SHEET:	6	OF: 7	
DATE:	03-29-23	PAGE: 6	

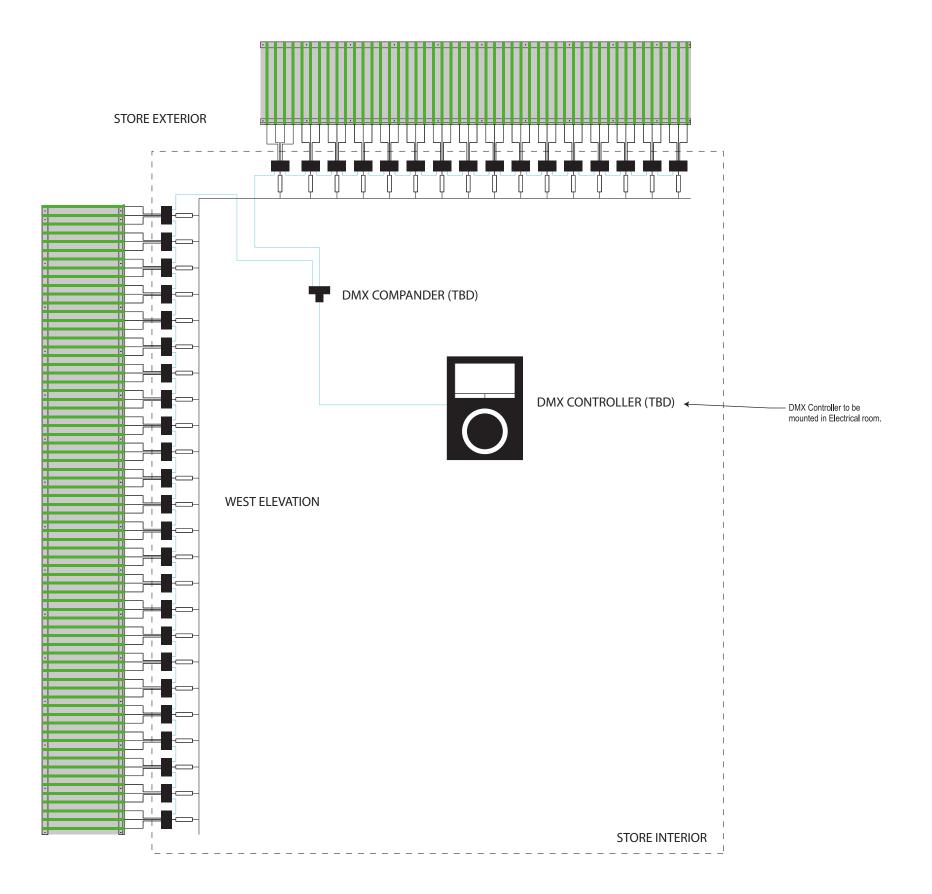


IMAGE	130 PI
RESOURCE GROUP BRINGING DESIGN TO	REALITY

O PINNACLE POINT CT., SUITE 101 COLUMBIA, SC 29223 PHONE: 803-790-2121 FAX: 803-790-2125 www.imageresourcegroup.com THIS IS AN UNPUBLISHED DESIGN OFFERED BY IRG, INC.. IT IS SUBMITTED FOR YOUR PERSONAL USE IN CONNECTION WITH THE PROJECT PLANNED FOR YOU BY IRG, INC.. IT IS NOT TO BE SHOWN TO ANYONE OUTSIDE OF YOUR ORGANIZATION NOR IS IT TO BE USED, REPRODUCED, COPIED, OR EXHIBITED IN ANY FASHION WHATSOEVER, ALL OR ANY PART OF THIS DESIGN (EXCEPTING REGISTERED TRADEMARKS) REMAINS THE PROPERTY OF IRG, INC.

)R	CLIENT:	TD Bank			REVISIONS: 10-25-23 RKN Added attachment details   10-26-23 RKN Added existing wall detail.	
IR D	LOCATION:	350 Lincoln R	oad, Miami Beach,	FL		
C.	DRAFTED B	Y: RKN	PROJECT MANAGER:	WHANCE		

DRAWING NUMBER:		TDB-FINS		
SHEET:	7	OF:	7	
DATE:	03-29-23	PAGE:	7	

## Existing Wall Sign | LEAVE AS IS

Action:

• Leave existing illuminated wall sign as is.

Code:

Maximum area calculation: 0.75 square feet for every foot of linear frontage, with a minimum of 15 square feet permissible, regardless of linear frontage. Maximum area Max.: 100 square feet

Existing Sign: 22.4 Sq Ft



S03

**WEST ELEVATION** 



Revisions:			

## Existing Wall Sign | LEAVE AS IS


Action:

• Leave existing illuminated wall sign as is.

Code:

Maximum area calculation: 0.75 square feet for every foot of linear frontage, with a minimum of 15 square feet permissible, regardless of linear frontage. Maximum area Max.: 100 square feet

Existing Sign: 22.4 Sq Ft

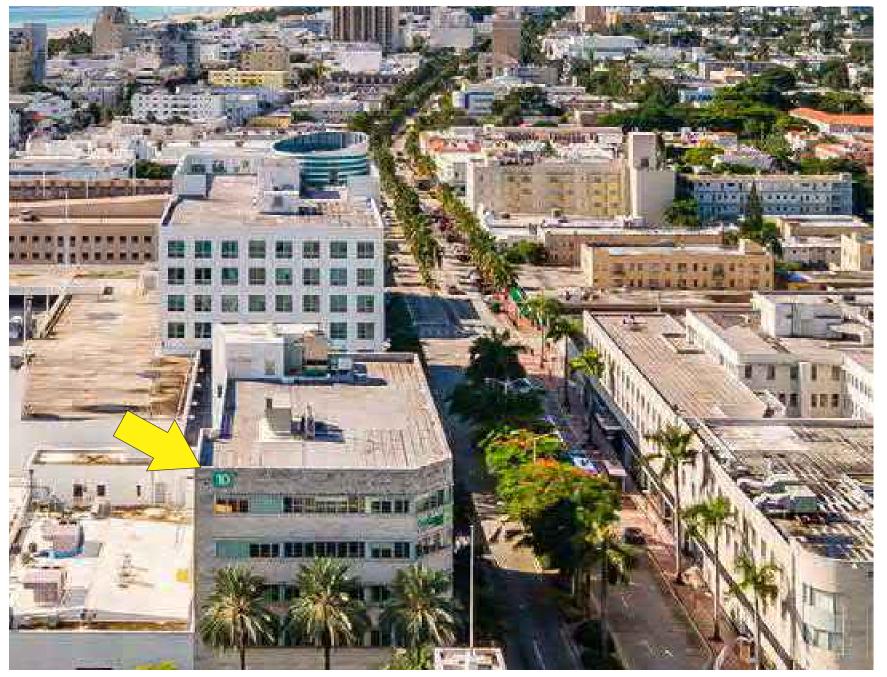

**S04** 

**NORTH ELEVATION** 



Revisions:				

#### Illuminated Cube Sign (4) illuminated sides

#### Action:

- Manufacture and install (4 sided cube sign)
   3 sides to be one piece clear break formed polycarbonate.
   One side to be single face with retainer.
- Suspended with center round tube painted MP brushed aluminum.

Engineering drawings required.

#### Material & Color:

Logo Vinyl: 3M 3630-5741 Light Green Translucent Vinyl (First Surface)

Entire face to be laminated with 3M 3660M

Cabinet : Paint : MP65220 R165605 TD Light Green (Satin Finish)

Face: 7328 White Acrylic

Support Pole: Painted MP Brushed Aluminum



**Existing Conditions** 




Proposed

#### Code:

Maximum area calculation: 0.75 square feet for every foot of linear frontage, with a minimum of 15 square feet permissible, regardless of linear frontage. Maximum area

Max.: 100 square feet

Proposed Sign: 11.2 Sq Ft

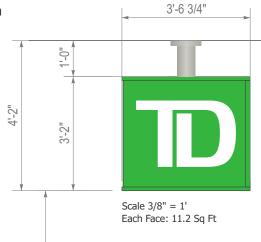










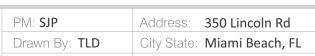


**S05** 


Date: 02.16.2023 Drawing Number:

148100


11' 2" from grade

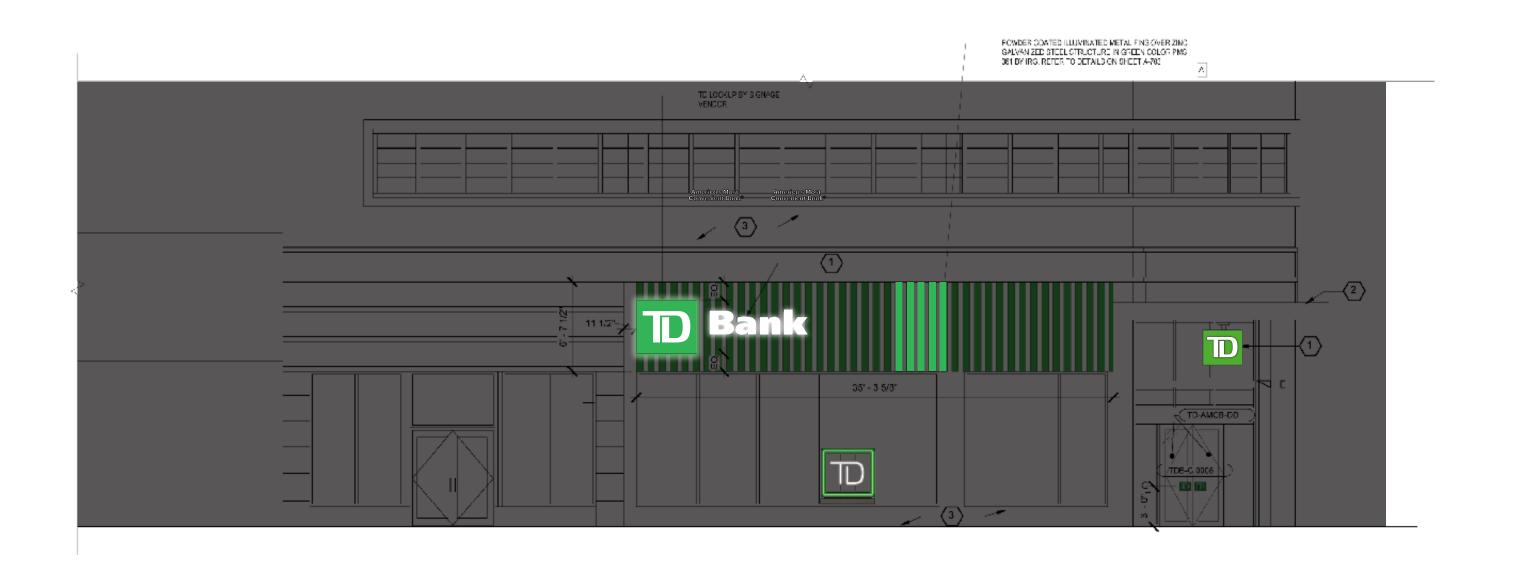



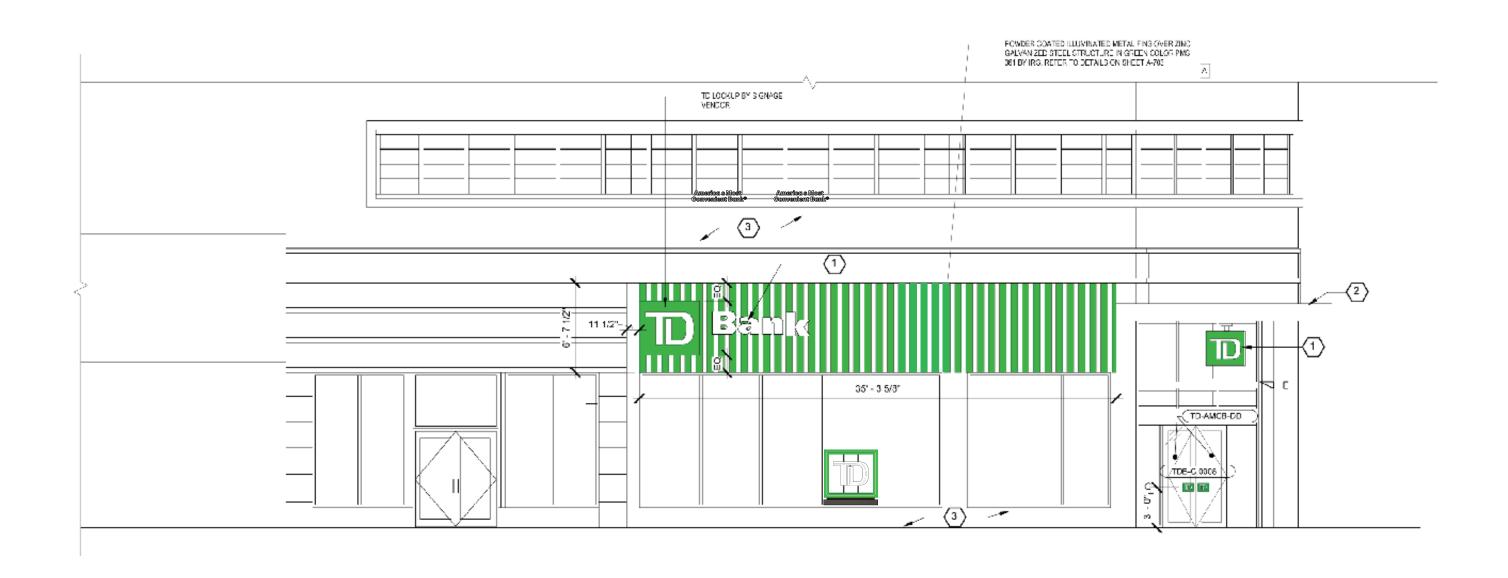



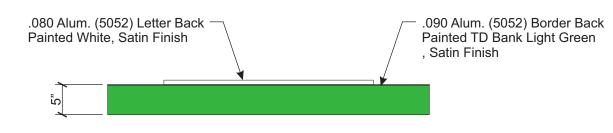

PLAN VIEW SCALE: 3/4" = 1'-0"

# PRELIMINARY PRINT

Note: This sign is intended to be installed in accordance with the requirements of Article 600 of the NFPA 2017 National Electrical Code and/or other applicable local codes. This includes proper grounding and bonding of the sign.

#### STANDARD MONUMENT NOTES:

- Sufficient Primary Circuit In Vicinity Of Sign By Others.
- 2. Final Primary Hook-up By Sign Installer, Where Allowed By Local Codes.
- 3. Sign Shall Be U.L. Listed.
- 4. Soil Assumed To Be 300 psf/ft Lateral Bearing Pressure (psf/ft below natural grade).
- 5. Concrete 2,500 PSI @ 28 Days.
- 6. Reinforcing Steel Shall Be ASTM A615 GR-40.
- 7. Structural Steel Shall Be ASTM A36.
- 8. All Welds Shall Conform To A.W.S Standards.

Electrical Load
(1.16) Amps @ 120 Volts
Electrical Req'mts
(1) 20 Amp/120 Volt Circuits



707 West Spring Garden Street Palmyra, New Jersey 08065

Phone: 856.829.1460 Fax: 856.829.8549 www.philadelphiasign.com

**CUSTOMER:** 

TD BANK

JOB NUMBER:

TD\_3811

SIGN TYPE:
HYPER SHIELD

\_\_\_\_\_

LOCATION: 350 LINCOLN ROAD MIAMI BEACH, FL 33139

DATE:

10/19/23

DRAWN BY:

RRR

REVISION: Number:

SHEET:

By:


ENG DEPT

1 OF 2

DWG NUMBER:


B-106862


**ENGINEER SEAL:** 

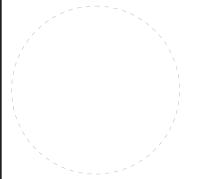


ULTIMATE WIND SPEED 180 MPH EXPOSURE C

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.080 Aluminum Letter Back Escutcheon Plate -Attached to 1/2" x 3/4" x .125 x 1" Alum. Angle Clips w/ #10 Flat Head

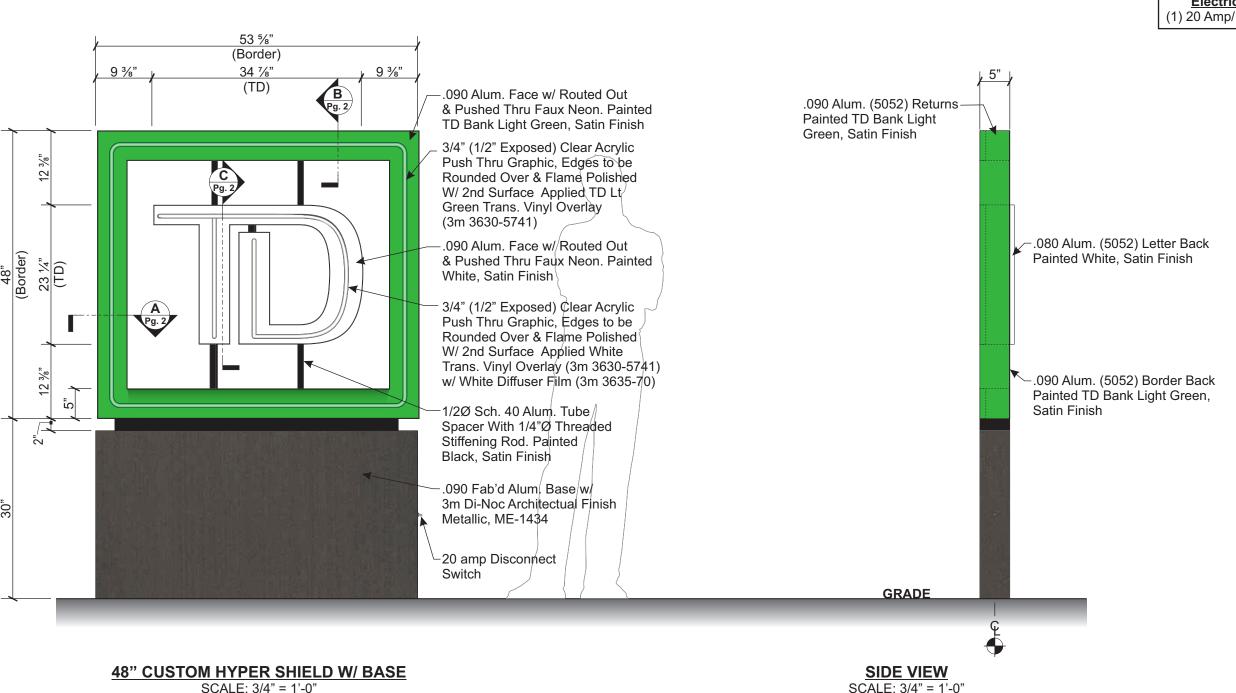

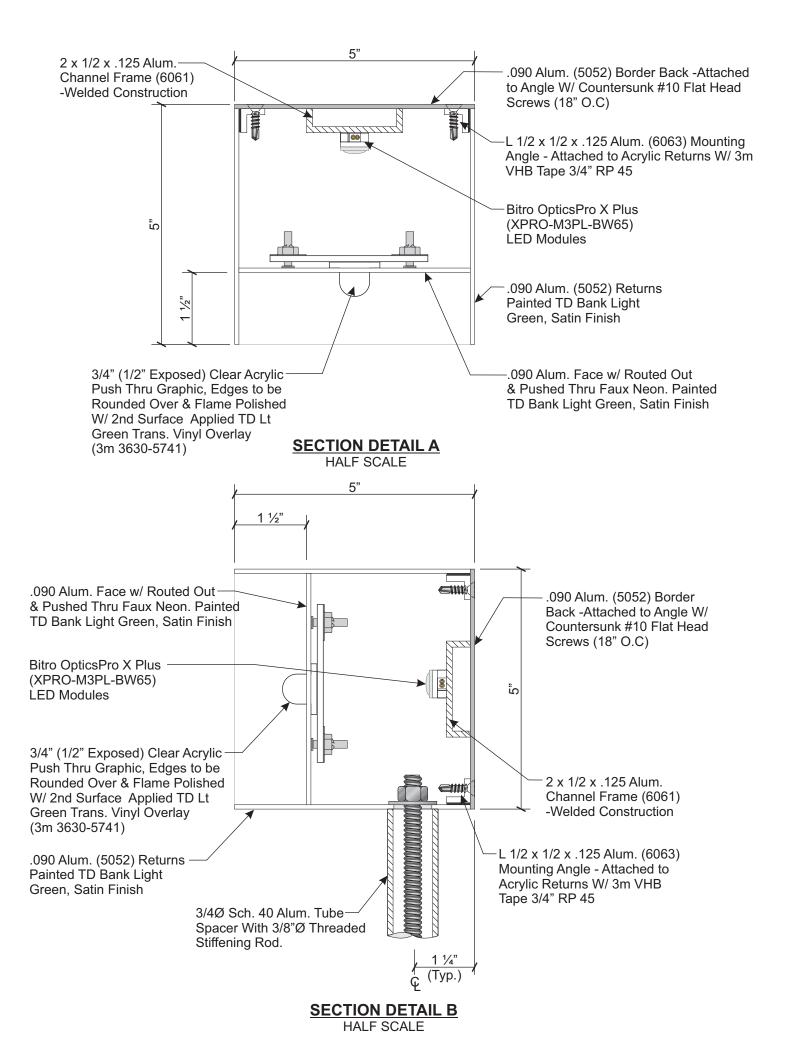707 West Spring Garden Street Palmyra, New Jersey 08065

Phone: 856.829.1460 Fax: 856.829.8549 www.philadelphiasign.com

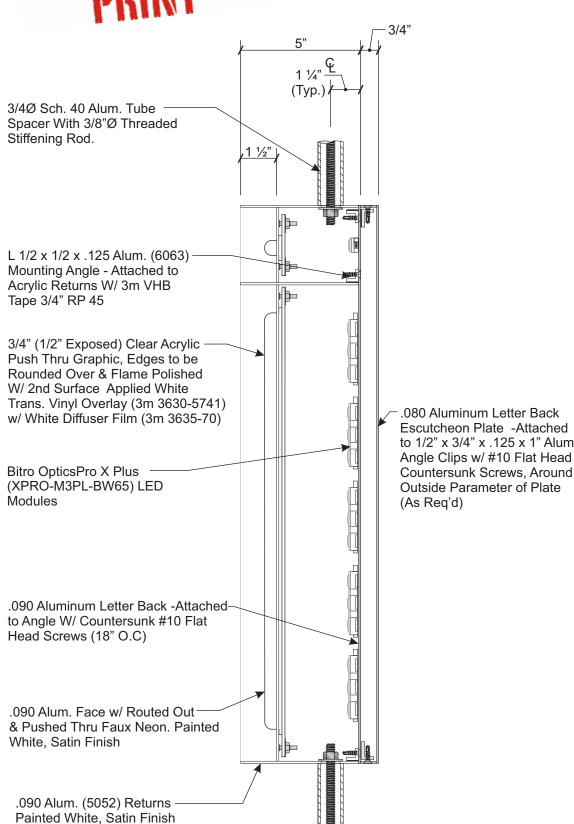**CUSTOMER:** 

**TD BANK** 

JOB NUMBER:

TD 3811

**SIGN TYPE:** 

**HYPER SHIELD** 

LOCATION:

350 LINCOLN ROAD **MIAMI BEACH, FL 33139** 

DATE:

10/19/23

DRAWN BY:

**RRR** 

**REVISION:** 

By:

ENG DEPT


SHEET:

2 OF 2

DWG NUMBER:

B-106862

**ENGINEER SEAL:** 

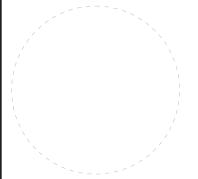

**ULTIMATE WIND SPEED 180 MPH EXPOSURE C** 

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**SECTION DETAIL C** SCALE: 3" = 1'-0"