

MIAMI BEACH

PUBLIC WORKS DEPARTMENT
INDIAN CREEK DRIVE (SR-A1A) & 41ST STREET (SR-112)
INTERACTIVE DIGITAL KIOSK DEPLOYMENT PROJECT
OCTOBER 2023
IKE SMART CITY
MIB-020

CITY OF MIAMI BEACH

MAYOR: DAN GELBER


COMMISSIONERS: MICKY STEINBERG
 MARK SAMUELIAN
 MICHAEL GONGORA
 STEVEN MEINER
 RICKEY ARRIOLA
 DAVID RICHARDSON

CITY MANAGER: ALINA T. HUDAK

CITY ATTORNEY: RAFAEL A. PAZ

PUBLIC WORKS DIRECTOR: JOE GOMEZ, P.E., F.FES

CITY ENGINEER: NELSON PEREZ-JACOME, PE

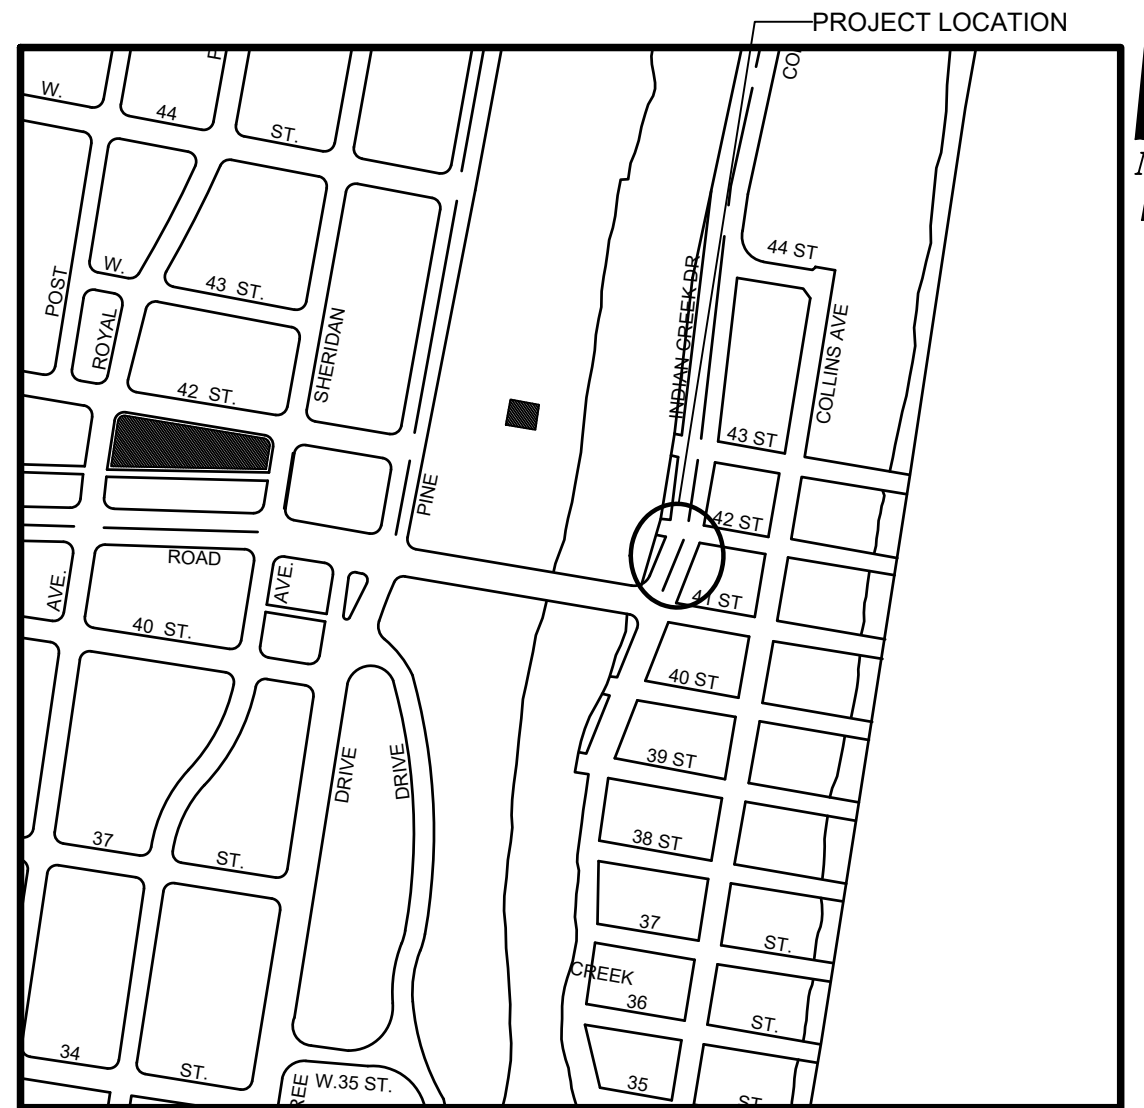

LOCATION MAP



INDEX OF PLANS

NUMBER	DISCIPLINE	SHEET NO.	DESCRIPTION	NOTES
1	GENERAL	G0-03	INDEX OF SHEETS	
2	GENERAL	G0-04	ADA NOTES, SCOPE OF WORK & KIOSK SPECIFICATIONS	
3	CIVIL	C1-01	CIVIL SITE PLAN	
4	CIVIL	C1-02	KIOSK MIB-020 ENGINEERING PLAN	
5	ELECTRICAL	E1-01	KIOSK MIB-020 ELECTRICAL PLAN	
6	SURVEY		KIOSK MIB-020 SITE SURVEY	

SCOPE OF WORK: THE PROJECT CONSISTS OF THE INSTALLATION OF ONE (1) DIGITAL INTERACTIVE KIOSK AND APPLICABLE INFRASTRUCTURE; STRUCTURAL FOUNDATION AND ELECTRICAL SERVICE AT THE LOCATION INDICATED ON THESE DESIGN PLANS.


FINAL SUBMITTAL 10/09/2023

Always call 811 two full business days before you dig to have underground utilities located and marked.



INDEX OF PLANS

NUMBER	DISCIPLINE	SHEET NO.	DESCRIPTION	NOTES
1	GENERAL	G0-03	INDEX OF SHEETS	
2	GENERAL	G0-04	ADA NOTES, SCOPE OF WORK & KIOSK SPECIFICATIONS	
3	CIVIL	C1-01	CIVIL SITE PLAN	
4	CIVIL	C1-02	KIOSK MIB-020 ENGINEERING PLAN	
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6	SURVEY		KIOSK MIB-020 SITE SURVEY	

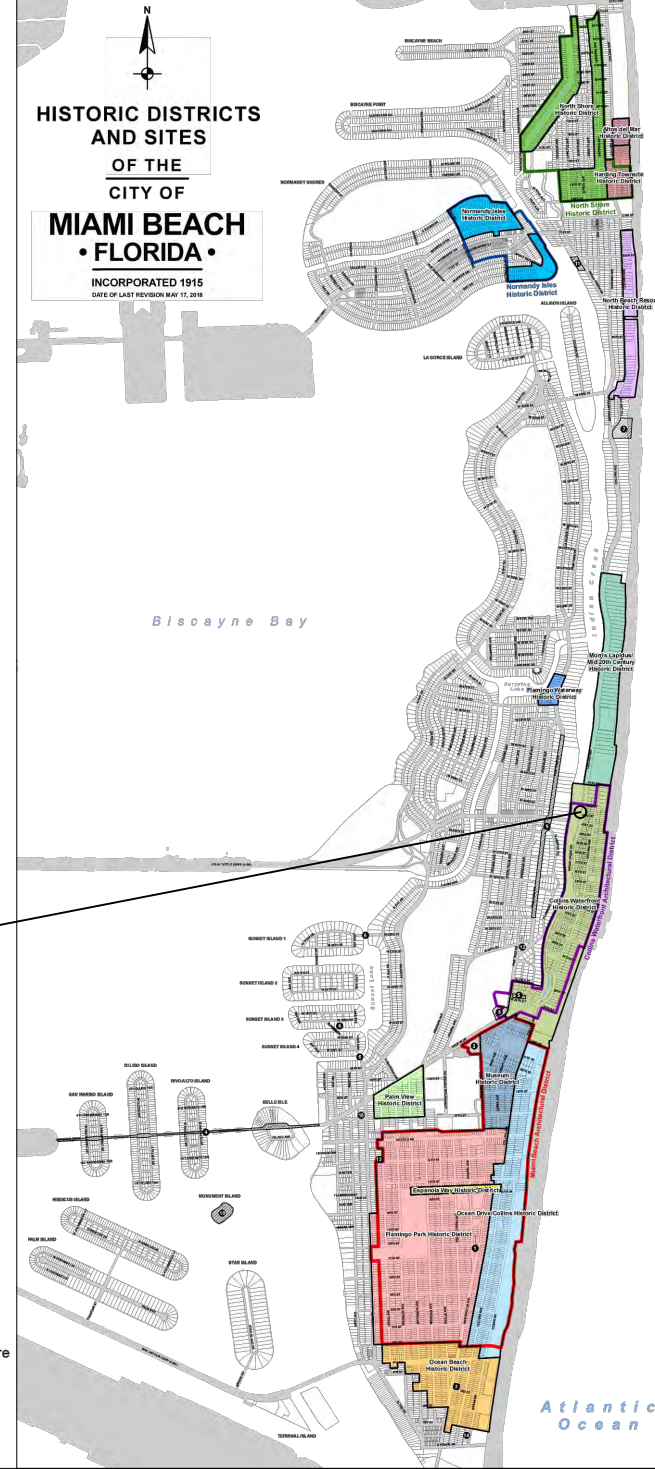

PROJECT LOCATION
COLLINS WATERFRONT HISTORIC DISTRICT

LEGEND AND ABBREVIATIONS

- = PALM TREE
- = TREE
- = ORNAMENTAL TREE
- O.R.B. = OFFICIAL RECORDS BOOK
- PG. = PAGE
- ELEV. = ELEVATION
- TYP. = TYPICAL
- CATV = CABLE TELEVISION
- OHE = OVERHEAD ELECTRIC LINE
- X 0.00 = SPOT ELEVATION
- CONC. = CONCRETE
- C.B.S. = CONCRETE BLOCK STUCCO
- C.L.F. = CHAIN LINK FENCE
- W.F. = WOOD FENCE
- M.F. = METAL FENCE
- RCP = REINFORCED CONCRETE PIPE
- FF = FINISH FLOOR
- (R) = RECORD
- (C) = CALCULATED
- (M) = MEASURE
- LB = LICENSE BUSINESS
- L = LENGTH
- Δ = CENTRAL ANGLE
- R = RADIUS
- T = TANGENT
- PT = POINT OF TANGENCY
- PC = POINT OF CURVATURE
- STA. = STATION
- PI = POINT OF INTERSECTION
- ID = IDENTIFICATION
- MLP = METAL LIGHT POLE
- CLP = CONCRETE LIGHT POLE
- R/W = RIGHT-OF-WAY
- P.B. = PLAT BOOK
- = SECTION LINE
- = CENTERLINE
- = BASELINE
- = MONUMENT LINE
- = TRAFFIC SIGNAL BOX
- = TRAFFIC SIGNAL CABINET
- = BOLLARD
- = PEDESTRIAN SIGNAL
- = TRAFFIC SIGNAL MAST ARM
- = SIGN
- = CABLE TELEVISION BOX
- = LIGHT POLE
- = ELECTRIC BOX
- = UTILITY POLE
- = ELECTRIC TRANSFORMER
- = GUY ANCHOR
- = ELECTRIC MANHOLE
- = ELECTRIC METER
- = GAS VALVE
- = GAS UTILITY BOX
- = GAS MANHOLE
- = GAS TANK
- = GAS METER
- = COMMUNICATION BOX
- = COMMUNICATION MANHOLE
- = GARBAGE RECEPTACLE
- = HANDICAP PARKING SPACE
- = WATER METER
- = IRRIGATION VALVE
- = WATER VALVE
- = FIRE HYDRANT
- = WATER BOX
- = WATER CONNECTION
- = WATER MANHOLE
- = WATER TANK
- = WATER WELL
- = WATER MARKING FLAG
- = WATER MARKING SIGN
- = STORM MANHOLE
- = STORM METER
- = CATCH BASIN
- = TELEPHONE MANHOLE
- = TELEPHONE BOX
- = NEWSPAPER DISPENSER
- = MAILBOX
- = SANITARY MANHOLE
- = SANITARY BOX
- = SANITARY TANK
- = SANITARY LIFT STATION
- = GREASE TRAP MANHOLE
- = CLEANOUT
- = PARKING METER
- = FIBER OPTIC BOX
- = FIBER OPTIC MARKER SIGN
- = MONITORING WELL
- = FUEL TANK
- = UNKNOWN UTILITY BOX
- = UNKNOWN UTILITY METER
- = UNKNOWN UTILITY MANHOLE
- = UNKNOWN UTILITY VALVE
- = UNKNOWN UTILITY MARKER FLAG
- = SANITARY VALVE
- = RAILROAD SIGN
- = FLAGPOLE
- = PROPERTY LINE
- = ELECTRICAL OUTLET

NOTES:

LOCAL HISTORIC DISTRICTS

	Espanola Way Historic District		Palm View Historic District
	Altos del Mar Historic District		Collins Waterfront Historic District
	Flamingo Park Historic District		North Beach Resort Historic District
	Ocean Drive/Collins Avenue Historic District		Flamingo Waterway Historic District
	Museum Historic District		Morris Lapidus/Mid 20th Century Historic District
	Ocean Beach Historic District		North Shore Historic District
	Harding Townsite Historic District		Normandy Isles Historic District

NATIONAL REGISTER HISTORIC DISTRICTS

	Miami Beach Architectural District
	Normandy Isles Historic District
	North Shore Historic District
	Collins Waterfront Architectural District

LOCAL HISTORIC SITES

1	Old City Hall Historic Site	8	Dade Blvd Fire Station Historic Site
2	21st St Recreation Center Historic Site	9	PineTree Dr Historic Roadway
3	Congregation Beth Jacob Historic Site	10	Flagler Memorial and Monument Island Historic Site
4	Venetian Causeway Historic Site	11	69th St Fire Station Historic Site
5	Miami Beach Woman's Club Historic Site	12	28th St Obelisk and Pumping Station Historic Structure
6	Sunset Island Bridges Historic Structures	13	1600 Lenox Ave Historic Site
7	The Bath Club Historic Site	14	36 Ocean Dr Historic Site
		15	1700 Alton Rd Historic Site

PROJECT DIRECTORY:

PROJECT NAME:
INTERACTIVE DIGITAL INFORMATION
KIOSKS DEPLOYMENT PROJECT

JURISDICTION:
CITY OF MIAMI
DEPARTMENT OF RESILIENCE AND
PUBLIC WORKS
MIAMI RIVERSIDE CENTER
444 S.W. 2nd AVENUE, 8th FLOOR
MIAMI, FLORIDA 33130
TEL: 305-416-1200

OWNER:
IKE SMART CITY
250 N HARTOFORD AVE
COLUMBUS, OH 43222
(614) 589-0087

ENGINEER OF RECORD:
MAINSTREET ENGINEERING
7035 SW 47 STREET, SUITE A
MIAMI, FL 33155
(305) 456-3505
PROJ. MGR: VANESSA MELA, P.E.
VMELA@MAINSTREETENG.COM

KIOSK MANUFACTURER:
DISPLAY DEVICE INC.
21075 WESTGATE RD.
GOLDEN, CO 80403
CONTACT: ERIC PERKINS
PHONE: (303) 929-4071

UTILITIES:

ELECTRICAL POWER: FLORIDA
POWER & LIGHT COMPANY (FPL)

WATER & SEWER: MIAMI-DADE
WATER & SEWAGE DEPARTMENT

TELEPHONE: AT&T
CABLE: COMCAST, XFINITY,
ATT-UVERSE
GAS: FLORIDA GAS


SIDEWALK & STREET SYMBOLS

	ASPHALT		BRICK
	PAVER		CONCRETE
	UNIMPROVED		TILE
	GRAVEL		STAMPED CONCRETE

KEY PLAN (NOT TO SCALE):



P.E. SEAL:

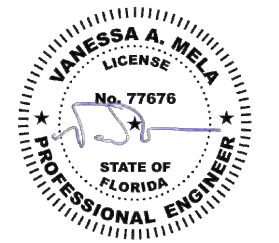

NO.	DATE	REVISION	APP'D. BY
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ADA NOTES

- ALL CONSTRUCTION ACTIVITIES SHALL BE COMPLETED IN FULL COMPLIANCE WITH THE AMERICANS WITH DISABILITIES ACT (ADA). CLEAR SPACES IN FRONT OF KIOSK SHALL HAVE THE FOLLOWING CHARACTERISTICS:
- SURFACES SHALL BE FIRM, STABLE, AND SLIP RESISTANT AND OTHERWISE COMPLY WITH PROWAG SECTION R302.7 AND SHALL HAVE A RUNNING SLOPE CONSISTENT WITH GRADE OF THE ADJACENT PEDESTRIAN ACCESS ROUTE AND CROSS SLOPE OF 1.50% +/-0.50%)
- SIZE: CLEAR SPACES SHALL BE 48" MINIMUM BY 48" MINIMUM.
- POSITION: UNLESS OTHERWISE SPECIFIED, CLEAR SPACES SHALL BE POSITIONED FOR EITHER FORWARD OR PARALLEL APPROACH TO THE KIOSK.
- APPROACH: ONE FULL UNOBSTRUCTED SIDE OF A CLEAR SPACE SHALL ADJOIN A PEDESTRIAN ACCESS ROUTE OR ADJOIN ANOTHER CLEAR SPACE.
- MANEUVERING SPACE: WHERE A CLEAR SPACE IS CONFINED ON ALL OR PART OF THREE SIDES, ADDITIONAL MANEUVERING SPACE SHALL BE PROVIDED AS FOLLOWS:
 - FORWARD APPROACH: THE CLEAR SPACE AND ADDITIONAL MANEUVERING SPACE SHALL BE 36" WIDE MINIMUM WHERE THE DEPTH OF THE CONFINING ELEMENT EXCEEDS 24".
 - PARALLEL APPROACH: THE CLEAR SPACE AND ADDITIONAL MANEUVERING SPACE SHALL BE 60" WIDE MINIMUM WHERE THE DEPTH OF THE CONFINING ELEMENT EXCEEDS 15".
- THE MINIMUM WHEELCHAIR PASSAGE WIDTH OR CLEAR SPACE WIDTH FOR A SINGLE WHEELCHAIR PASSAGE SHALL BE 48" PER PROWAG SECTION R302.3.
- INITIAL OPERATION FOR THE KIOSK WILL HAVE 4G LTE CONNECTION SECTION R404. TO THE INTERNET.
- THE KIOSKS HAVE BEEN DESIGN TO COMPLY WITH ALL ADA GUIDELINES INCLUDING VIEWING, OPERATION, AND ACCESSIBILITY.
- THE MOBILE IKE EXPERIENCE WILL FOLLOW WEB CONTENT ACCESSIBILITY GUIDELINES (WCAG) TO WORK IN TANDEM WITH THE NATIVE ACCESSIBILITY FEATURES ON THE USER'S MOBILE DEVICE, INCLUDING TALKBACK AND VOICEOVER TOOLS.

SCOPE OF WORK

THE PROJECT CONSIST OF THE INSTALLATION OF ONE (1) DIGITAL INTERACTIVE KIOSKS AT THE LOCATION(S) INDICATED ON THIS PLANS SET. INSTALLER SHALL PROVIDE AND INCLUDE ALL WORKMANSHIP AND MATERIALS NECESSARY TO COMPLETE THE INSTALLATION INCLUDING BUT NOT LIMITED TO:


- INSTALLATION OF THE KIOSKS TO THE FOUNDATION AS INDICATED ON PLANS TO NEW RECTANGULAR CONCRETE FOUNDATION.
- ELECTRICAL SERVICE POINTS ARE EXISTING. CONNECT THE EXISTING ELECTRIC SERVICE TO THE NEW KIOSK AS INDICATED ON PLANS.
- TESTING OF THE ELECTRICAL SERVICE INFRASTRUCTURE SHALL BE PERFORMED IN CONJUNCTION WITH A REPRESENTATIVE OF THE ENGINEER OF RECORD.
- THE CONTRACTOR SHALL INSTALL THE KIOSK IN SUCH A WAY THAT THE KIOSK IS WITHIN THE PUBLIC R.O.W. AND IN COMPLIANCE WITH ALL APPLICABLE A.D.A. REQUIREMENTS
- THE LOCATION OF KIOSKS HAS BEEN COORDINATE TO ENSURE THERE IS NO OBSTRUCTION OF THE SIGHT OF VEHICULAR SIGNS.
- STAND-ALONE PEDESTRIAN KIOSKS SHOULD NOT BE INSTALLED WITHIN PEDESTRIAN CIRCULATION PATHS IN A MANNER THAT PERSONS AT THE KIOSK LOCK THE EFFECTIVE WIDTH OF THE PEDESTRIAN TRAVEL WAY.

MONUMENT SIGN SPECIFICATIONS AND FUNCTIONS


THE UNIT CONSISTS OF A UL/NRTL LISTED WEATHER AND VANDAL RESISTANT FREE STANDING ENCLOSURE DESIGNED TO COMPLY WITH THE FLORIDA BUILDING CODE AND OTHER APPLICABLE CODES INCLUDING THE NATIONAL ELECTRICAL CODE. THE UNIT HAS BEEN DESIGNED TO WITHSTAND WINDS OF 165 MPH. THE UNIT'S MAIN COMPONENTS ARE:

- TWO (2) INTERACTIVE 65" VIDEO TOUCH SCREENS.
- TWO (2) CAMERAS
- ONE (1) CPU
- ONE (1) WI-FI TRANSMITTER

MANUFACTURER: DYNASCAN MODEL NUMBER: CIO651DR5
 NATIVE RESOLUTION: 1920 X 1080
 ELECTRICAL POWER REQUIREMENT:
 1. ONE-2-POLE, 20 AMP, 240 VOLTS CIRCUIT.
 2. TOTAL LOAD: 1400/2200 WATTS (OPERATIONAL/PEAK)
 3. VOLTAGE: 100-240 VOLTS AC, 50-60 HZ
 WEIGHT: 832 LBS
 CERTIFICATION CE / FCC / RoHS

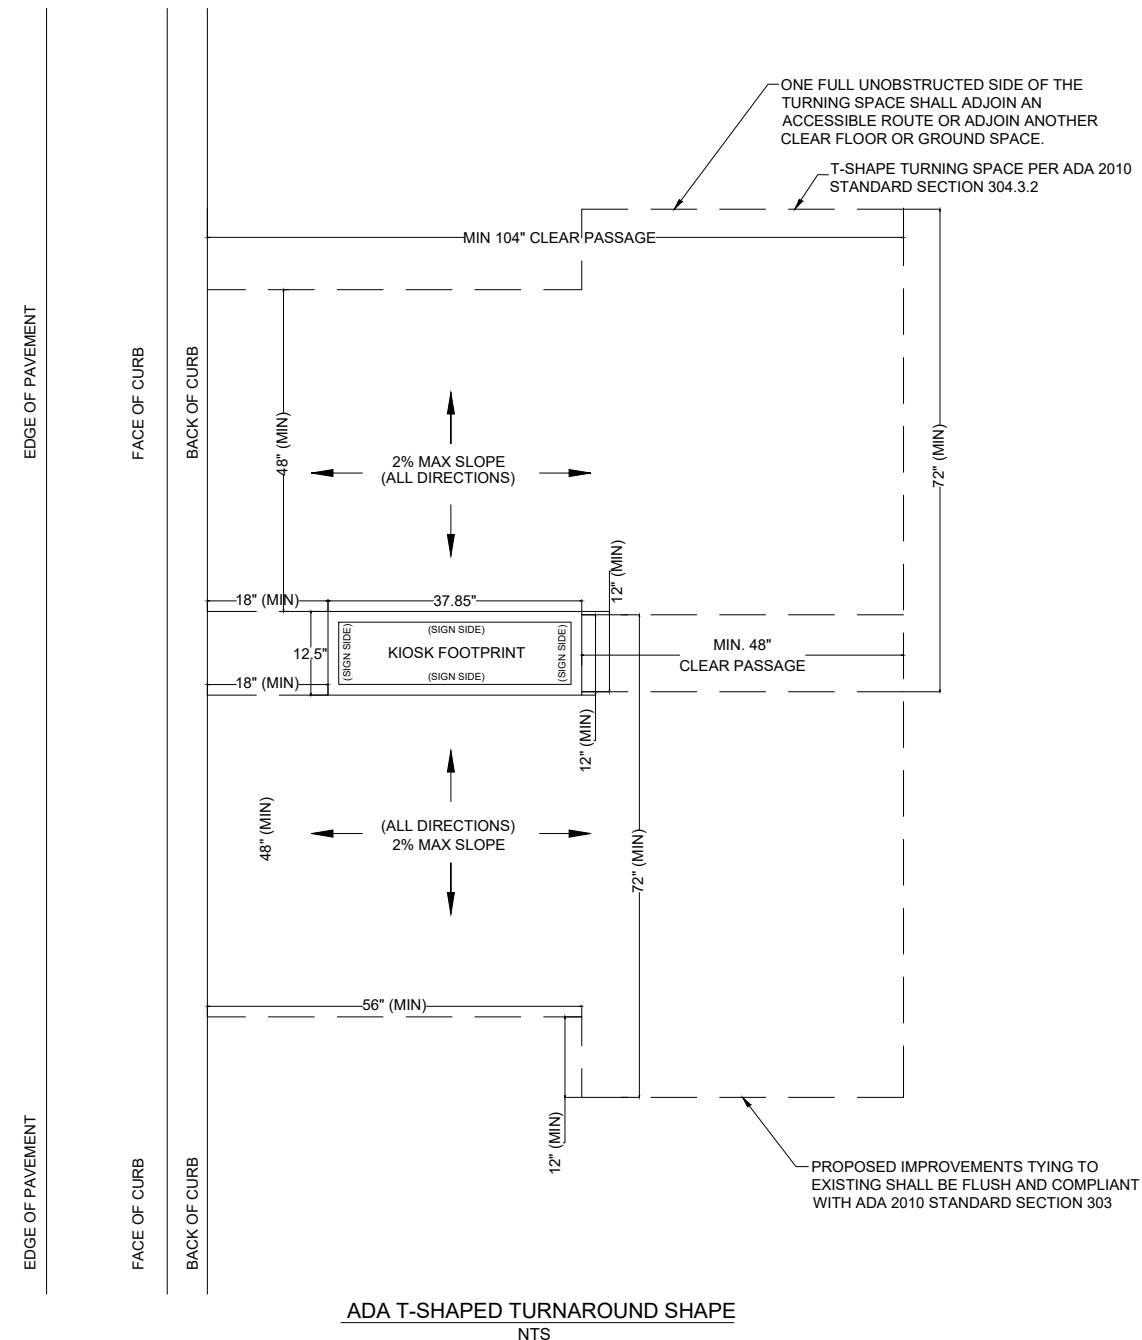

NOTES:

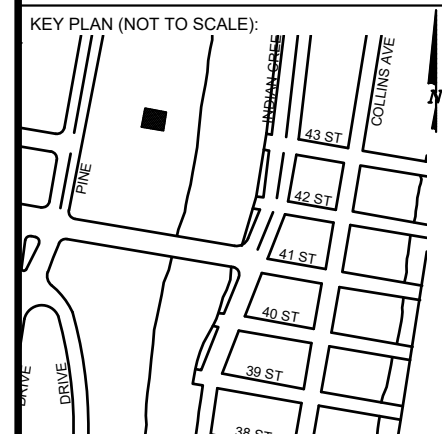

P.E. SEAL:

MIAMI BEACH
 PUBLIC WORKS DEPARTMENT
 1700 CONVENTION CENTER DRIVE, MIAMI BEACH, FL 33139

CITY MANAGER: ALINA T. HUDAK
 DIRECTOR: JOE GOMEZ, P.E.
 CITY ENGINEER: CRISTINA ORTEGA CASTINEIRAS, P.E.

5			
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Main Street ENGINEERING
 7035 SW 47th Street, Ste A, Miami, FL 33155
 Tel: (305) 466-3055 Fax: (305) 476-8994
 FL PE Certificate No: 00008751

ENGINEER OF RECORD:
 VANESSA A. MELA,
 P.E. NO. 77676


ENGINEER OF RECORD: VM
 DESIGN ENGINEER: VM
 DRAWN BY: KM
 CHECKER: WP
 SCALE:

NEIGHBORHOOD:
MIB-020: INDIAN CREEK DRIVE & 41ST STREET
 TITLE:
ADA NOTES, SCOPE OF WORK & KIOSK SPECIFICATIONS


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 Survey Reference:
 Field Book: N/A Page: N/A Work Order: N/A
 Date: 10/09/2023 Sheet: 2 of 6 Drawing: G0-04



NOTES:

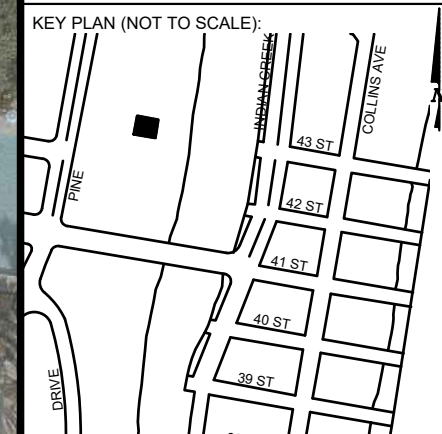

P.E. SEAL:

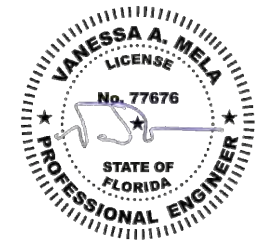

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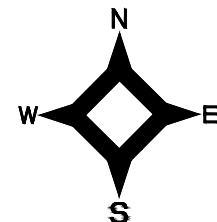


Call 811 or visit sunshine811.com two full business days before digging to have buried facilities located and marked.

Check positive response codes before you dig!



NOTES:



EX. STORM SEWER

EX. SANITARY SEWER

EX. GAS

EX. SIGN

EX. SIGN

EX. CATCH BASIN

2' C&G

BOC

FOC

EOP

R/W

CONCRETE FOUNDATION. SEE SHEET S-01 FOR FOUNDATION DETAILS


KIOSK MIB-020.
SEE DETAIL ON SHEET G0-05.

5'-0" FROM BOC

10'-1" FROM BOC TO R/W

Canal and Out Lot


Indian Creek Out Lot

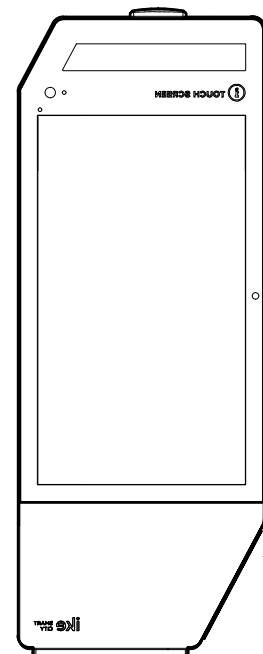


IKE 3.0 KIOSK
SEE SPEC. SHEET
FOR DETAILS

5'-0" FROM BOC

BACK OF CURB (BOC)
FRONT OF CURB (FOC)

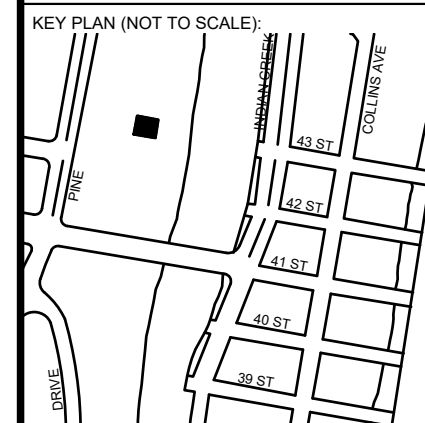


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EXISTING 277/470V FPL PADMOUNTED TRANSFORMER TO SERVICE POINT

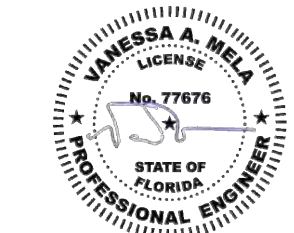5'-11" CLEAR DISTANCE

NEW FPL METER

NEW PULLBOX JB-1

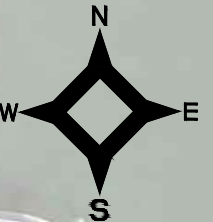43RD STREET

INDIAN CREEK DRIVE

Indian Creek Canal

RW
BOC
FOC
EOP



NEW KIOSK MIB-020

10'-1" FROM BOC TO RW

NEW PULLBOX JB-2

5'-0" FROM BOC

42ND STREET


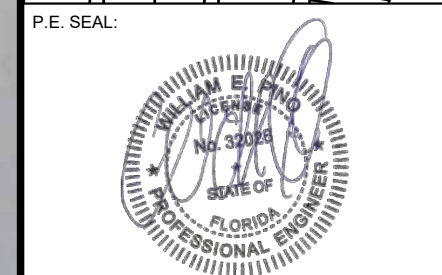
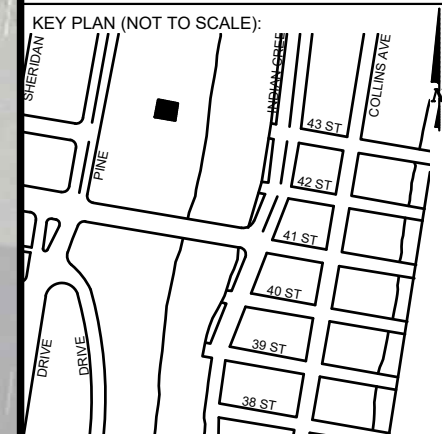


ELECTRICAL PLAN
SCALE 1"=20'

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NO.	DATE	REVISION	APP'D. BY



SPECIFIC PURPOSE SURVEY

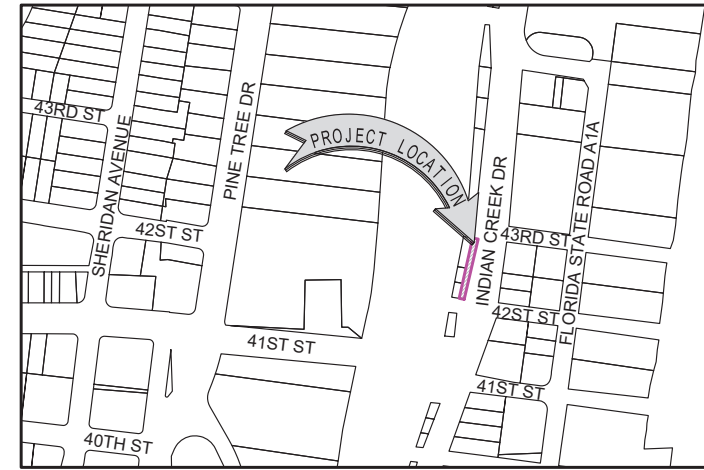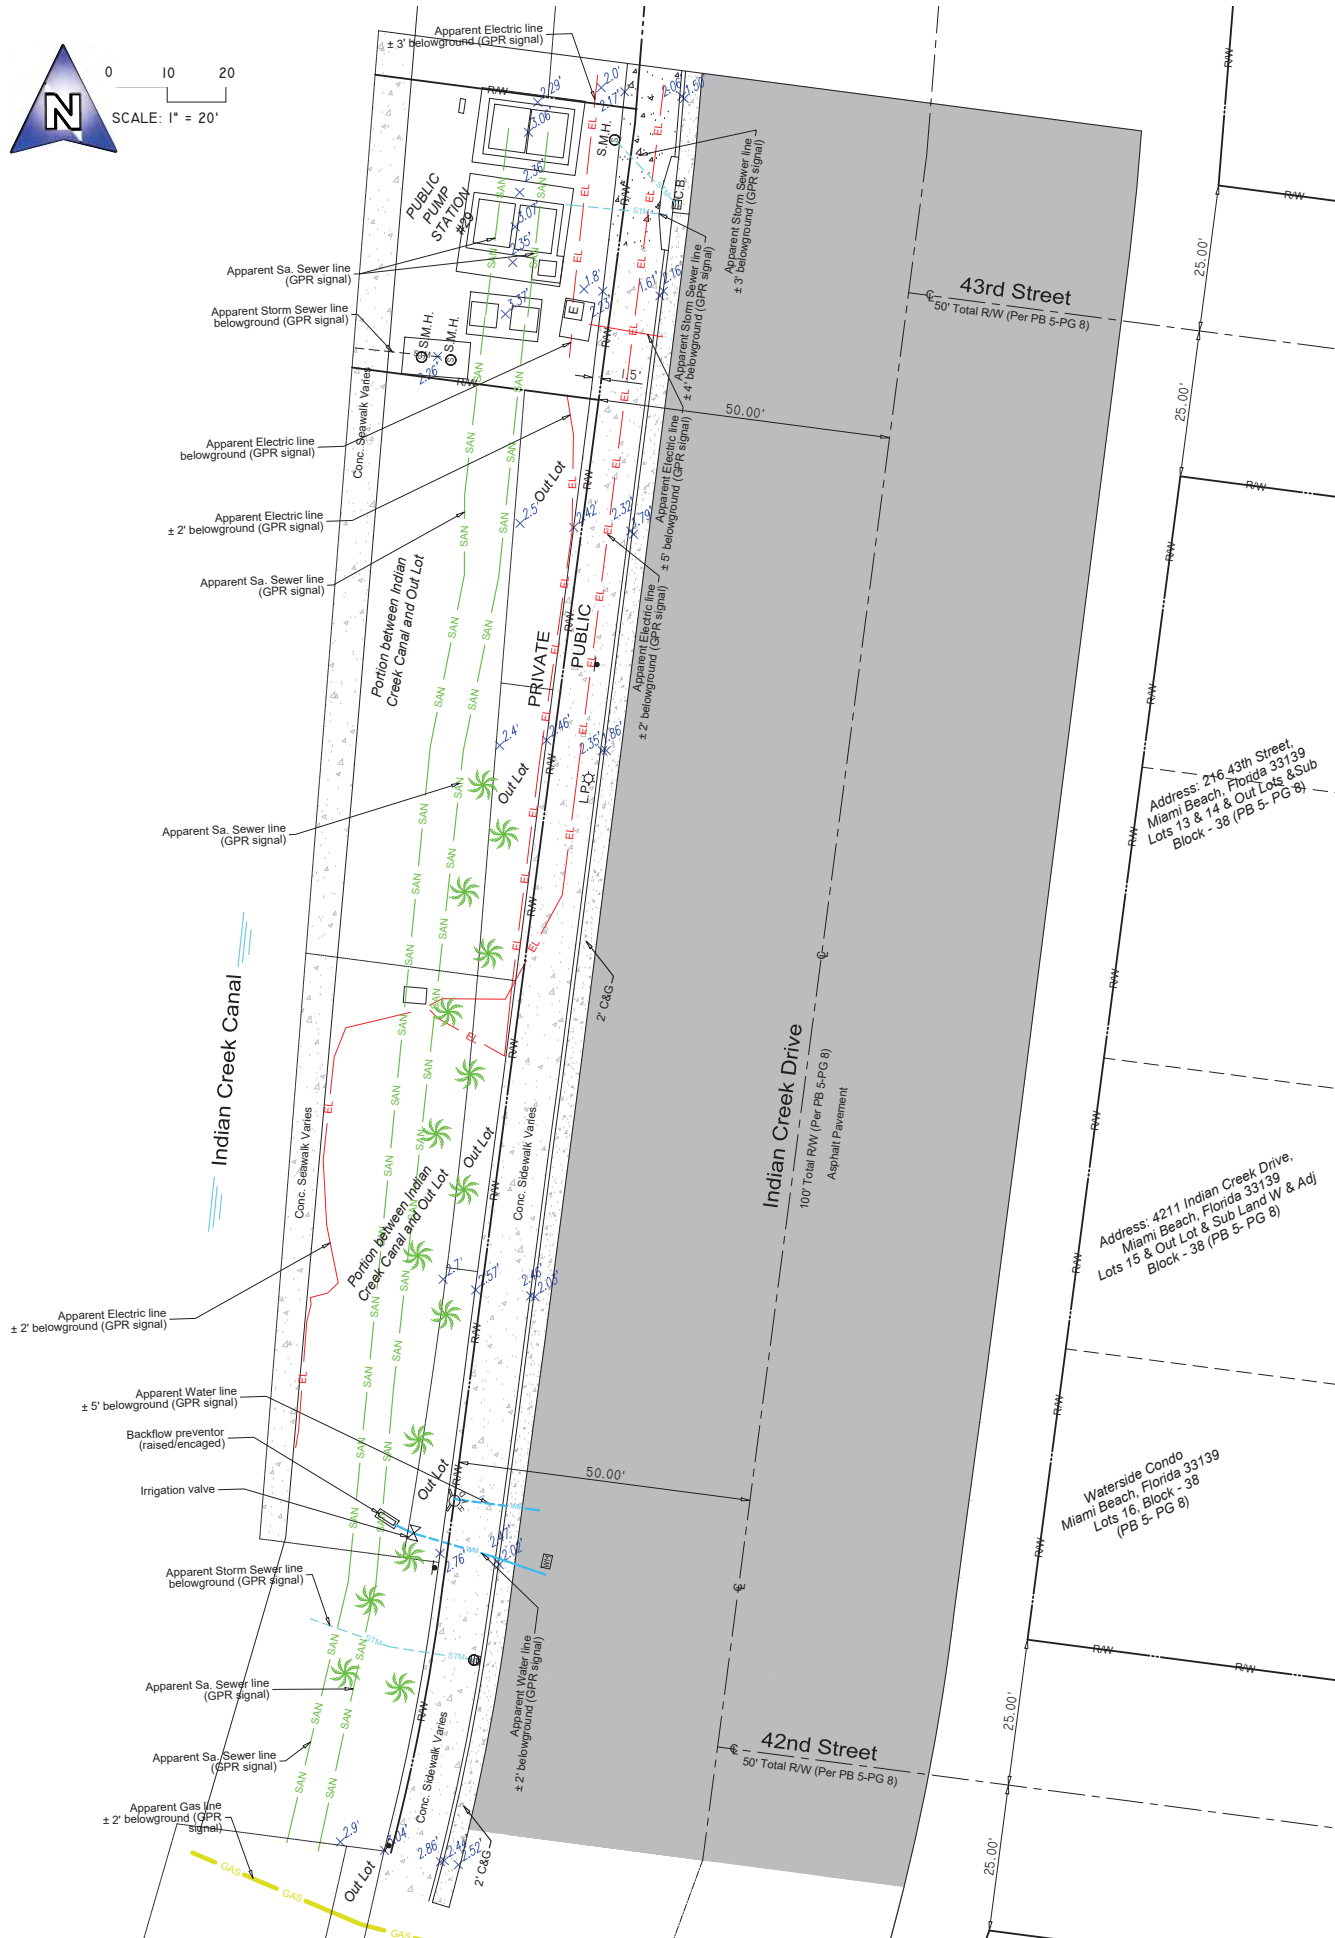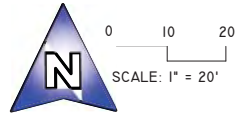

LOCATION MAP

Not to Scale



LEGEND & ABBREVIATIONS

	= CONCRETE (CONC.)
	= CONCRETE BLOCK WALL
	= WOOD DECK
	= COVERED AREA
	= ASPHALT
	= TILE
	= PAVERS
	= STONE
	= CHAIN LINK FENCE (CLF)
	= WOOD FENCE (WF)
	= IRON METAL BARS FENCE (IF)
	= OVERHEAD WIRES
	= WATER VALVE (WV)
	= POWER POLE (PP)
	= GUY ANCHOR
	= WATER METER (WM)
	= CONC. LIGHT POLE (LP)
	= WELL
	= STREET SIGN
	= SANITARY MANHOLE
	= DRAINAGE MANHOLE
	= MANHOLE
	= FIRE HYDRANT
	= CABLE BOX (CATV)
	= FFL TRANSFORMER
	= CATCH BASIN OR INLET
	= EXISTING ELEVATION
	= ELECTRIC BOX
	= PROPERTY CORNER
	= PERMANENT CONTROL POINT (PCP)
	PT = POINT OF TANGENCY
	PC = POINT OF CURVATURE
	PCC = POINT OF COMPOUND CURVE
	PRC = POINT OF REVERSE CURVE
	BM = BENCH MARK
	BR = BEARING REFERENCE
	TBM = TEMPORARY BENCH MARK
	PL = PROPERTY LINE
	CL = CENTER LINE
	ML = MONUMENT LINE
	BL = BASE LINE
	MEAS = FIELD MEASURED
	P = PER PLAT
	PSM = PROFESSIONAL SURVEYOR AND MAPPER
	A/C = AIR CONDITIONER PAD
	ENCR = ENCROACHMENT
	FF ELEV = FINISHED FLOOR ELEVATION
	(XX-XX) = DENOTES PLAT BOOK XX - PAGE XX
	ORB = OFFICIAL RECORD BOOK
	CBS = CONCRETE BLOCK STRUCTURE
	R/W = RIGHT OF WAY
	ELEV = ELEVATION
	SEC = SECTION
	T = TOWNSHIP
	R = RANGE
	CALC = CALCULATED
	(R) = RECORD


SURVEYOR'S REPORT AND GENERAL NOTES

- (Not valid without the attached Survey Map)
- This is not a Boundary Survey.
 - These lands are subject to additional restrictions of record that were not furnished to the undersigning registered surveyor. A title search has not been performed by the surveyor.
 - North arrow direction is based on an assumed Meridian. Bearings are based on an assumed meridian on a well-established line, said line is being noted as BR on the Survey Map.
 - Only above ground improvements are shown herein. Foundations, underground features and utilities have not been located by this surveyor. Refer to SUE effort notes below.
 - Survey markers found in the field have no identification unless otherwise shown. Any survey marker set by our company is labeled LB 7262 or PSM 6169.
 - This Survey Map is intended to be displayed at the scale shown hereon. Data is expressed in U.S. Survey Foot.
 - This Survey Map is being prepared for the use of the party/parties that it is certified to and does not extend to any unnamed individual, entity or assignee.
 - FLOODPLAIN INFORMATION:** As scaled from Federal Insurance Rate Map (FIRM) of Community No. 120651 (City of Miami Beach), Panel 0328, Suffix L, revised on Sept 11th, 2009, this real property falls in Zone "AE" with Base Flood Elevation 7 feet (NGVD 1929)
 - HORIZONTAL ACCURACY:** Accuracy obtained thru measurements and calculations meets and exceeds the minimum horizontal feature accuracy for a Suburban area being equal to 1 foot in 7, 500 feet.
 - VERTICAL CONTROL AND ACCURACY:** The elevations as shown are referred to the National American Vertical Datum of 1988 (NAVD 1988). The closure in feet, as computed, meets the standard of plus or minus 0.05 feet times the squared root of the loop distance in miles. Elevation are based on a level loop from and to the following official Bench Marks:
Bench Mark # 1: City Miami Beach Bench Mark CMB 42 01 06, Elevation = 2.06 feet (NAVD'88)
Bench Mark # 2: City Miami Beach FDOT 87-03-PN01C, Elevation = 3.81 feet (NAVD'88)


11. SUE NOTES:
Subsurface Utility investigation was performed by South Florida Utility Location Services using GPR (Ground Penetrating Radar) and RD (Radiodetection Technology) for designation and location of underground facilities. The horizontal accuracy of this method is +/- 1.5 feet approximately, and is subject to equipment limitations. This Survey depicts the location of the marks indicating the approximate location of the buried pipes and conduits. There might be additional underground facilities not discovered at the time of this survey. Underground utility references as shown on this survey drawing is solely based on information marked on the field by South Florida Utility Location Services for this project. Contact information below:

South Florida Utility Location Services
15323 SW 31st Terrace, Miami, Florida 33185
(786) 547 9086 Office, Email: rogerh@sf-uls.com, Contact Person: Roger Hasbani

Surveyor is not responsible for any errors or omissions that could arise from the information provided. Call 811 or visit www.sunshine811.com before digging.

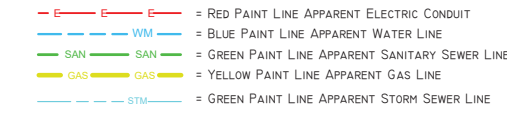

I HEREBY CERTIFY TO:
Main Street Engineering, that this Survey conforms to the Standards of Practice as set forth by the Florida Board of Professional Surveyors and Mappers in applicable provisions of Chapter 5J-17, Florida Administrative Code pursuant to Section 472.027 Florida Statutes. This Survey is accurate and correct to the best of my knowledge and belief.

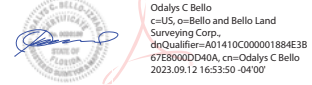

Odalys C. Bello
Professional Surveyor and Mapper LS6169 · State of Florida
Field Work Date: 09/12/2023

Additional and deletions to this Survey Map are prohibited. This Survey Map and Report are not valid without the signature and original raised seal or without the authenticated electronic signature and seal of the undersigning Florida licensed Surveyor and Mapper.

MIB-020
Project No. 23258 D.B.: I.C Page 1 of 1

BELLO & BELLO LAND SURVEYING
12230 SW 131 AVENUE • SUITE 201 • MIAMI FL 33186
Phone: 305.251.9606 • Fax: 305.251.6057 • LB#7262
e-mail: info@belloland.com • www.bellolandsurveying.com




1. Indian Creek Drive & W 41st Street



INDEX OF PLANS

NUMBER	DISCIPLINE	SHEET NO.	DESCRIPTION	NOTES
1	GENERAL	G0-03	INDEX OF SHEETS	
2	GENERAL	G0-04	ADA NOTES, SCOPE OF WORK & KIOSK SPECIFICATIONS	
3	CIVIL	C1-01	CIVIL SITE PLAN	
4	CIVIL	C1-02	KIOSK MIB-025 ENGINEERING PLAN	
5	ELECTRICAL	E0-01	ELECTRICAL SITE PLAN	
6	ELECTRICAL	E1-01	KIOSK MIB-025 ELECTRICAL PLAN	
7	SURVEY		KIOSK MIB-025 SITE SURVEY	

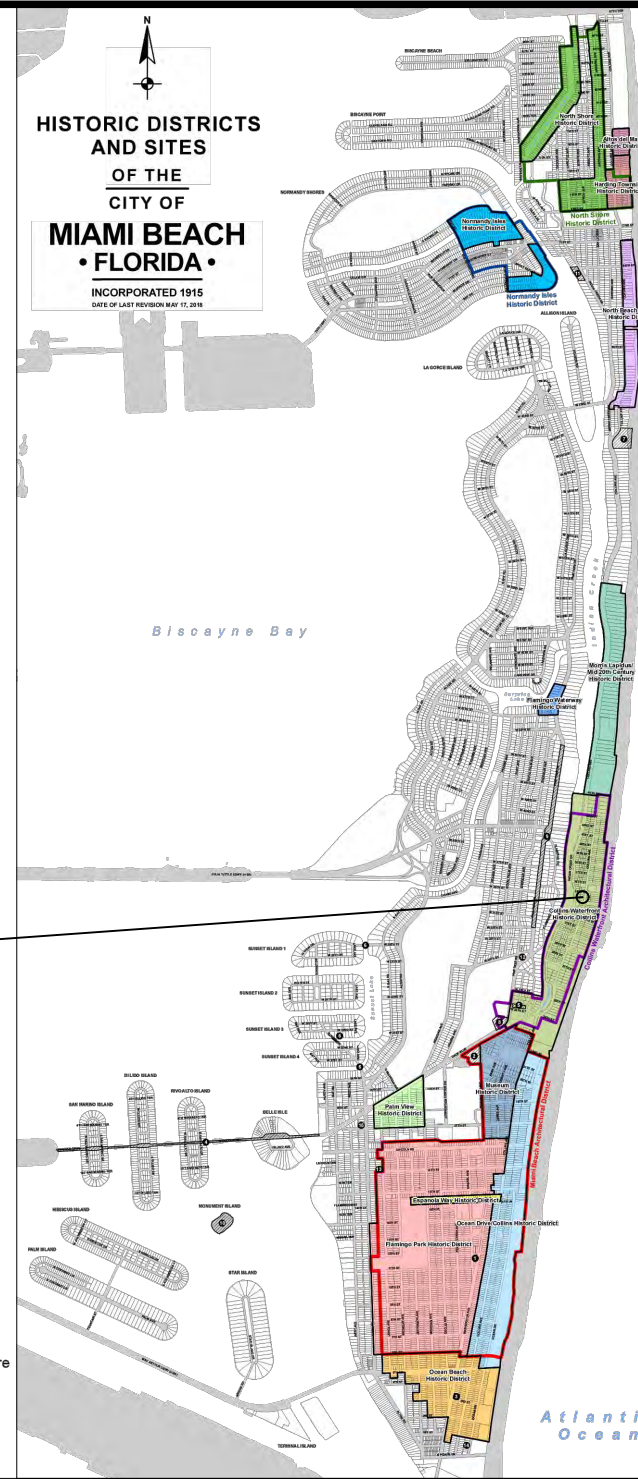

PROJECT LOCATION
COLLINS WATERFRONT HISTORIC DISTRICT

LEGEND AND ABBREVIATIONS	
	= PALM TREE
	= TREE
	= ORNAMENTAL TREE
O.R.B.	= OFFICIAL RECORDS BOOK
PG.	= PAGE
ELEV.	= ELEVATION
TYP.	= TYPICAL
CATV	= CABLE TELEVISION
OHE	= OVERHEAD ELECTRIC LINE
X 0.00	= SPOT ELEVATION
CONC.	= CONCRETE
C.B.S.	= CONCRETE BLOCK STUCCO
C.L.F.	= CHAIN LINK FENCE
W.F.	= WOOD FENCE
M.F.	= METAL FENCE
RCP	= REINFORCED CONCRETE PIPE
FF	= FINISH FLOOR
(R)	= RECORD
(C)	= CALCULATED
(M)	= MEASURE
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Δ	= CENTRAL ANGLE
R	= RADIUS
T	= TANGENT
PT	= POINT OF TANGENCY
PC	= POINT OF CURVATURE
STA.	= STATION
PI	= POINT OF INTERSECTION
ID	= IDENTIFICATION
MLP	= METAL LIGHT POLE
CLP	= CONCRETE LIGHT POLE
R/W	= RIGHT-OF-WAY
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—	= FLAGPOLE
—	= PROPERTY LINE
—	= ELECTRICAL OUTLET

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	Ocean Drive/Collins Avenue Historic District
	Museum Historic District
	Ocean Beach Historic District
	Harding Townsite Historic District
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	North Shore Historic District
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12	28th St Obelisk and Pumping Station Historic Structure
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14	36 Ocean Dr Historic Site
15	1700 Alton Rd Historic Site

PROJECT DIRECTORY:

PROJECT NAME:
INTERACTIVE DIGITAL INFORMATION
KIOSKS DEPLOYMENT PROJECT

JURISDICTION:
CITY OF MIAMI
DEPARTMENT OF RESILIENCE AND
PUBLIC WORKS
MIAMI RIVERSIDE CENTER
444 S.W. 2nd AVENUE, 8th FLOOR
MIAMI, FLORIDA 33130
TEL: 305-416-1200

OWNER:
IKE SMART CITY
250 N HARTOFORD AVE
COLUMBUS, OH 43222
(614) 589-0087

ENGINEER OF RECORD:
MAINSTREET ENGINEERING
7035 SW 47 STREET, SUITE A
MIAMI, FL 33155
(305) 456-3505
PROJ. MGR: VANESSA MELA, P.E.
VMELA@MAINSTREETENG.COM

KIOSK MANUFACTURER:
DISPLAY DEVICE INC.
21075 WESTGATE RD.
GOLDEN, CO 80403
CONTACT: ERIC PERKINS
PHONE: (303) 929-4071

UTILITIES:

ELECTRICAL POWER: FLORIDA
POWER & LIGHT COMPANY (FPL)

WATER & SEWER: MIAMI-DADE
WATER & SEWAGE DEPARTMENT

TELEPHONE: AT&T

CABLE: COMCAST, XFINITY,
ATT-UVERSE

GAS: FLORIDA GAS


SIDEWALK & STREET SYMBOLS

	ASPHALT		BRICK
	PAVER		CONCRETE
	UNIMPROVED		TILE
	GRAVEL		STAMPED CONCRETE

KEY PLAN (NOT TO SCALE):



P.E. SEAL:

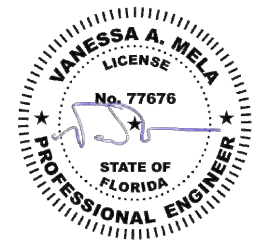

NO.	DATE	REVISION	APP'D. BY
5			
4			
3			
2			
1			

ADA NOTES

- ALL CONSTRUCTION ACTIVITIES SHALL BE COMPLETED IN FULL COMPLIANCE WITH THE AMERICANS WITH DISABILITIES ACT (ADA). CLEAR SPACES IN FRONT OF KIOSK SHALL HAVE THE FOLLOWING CHARACTERISTICS:
- SURFACES SHALL BE FIRM, STABLE, AND SLIP RESISTANT AND OTHERWISE COMPLY WITH PROWAG SECTION R302.7 AND SHALL HAVE A RUNNING SLOPE CONSISTENT WITH GRADE OF THE ADJACENT PEDESTRIAN ACCESS ROUTE AND CROSS SLOPE OF 1.50% +/-0.50%)
- SIZE: CLEAR SPACES SHALL BE 48" MINIMUM BY 48" MINIMUM.
- POSITION: UNLESS OTHERWISE SPECIFIED, CLEAR SPACES SHALL BE POSITIONED FOR EITHER FORWARD OR PARALLEL APPROACH TO THE KIOSK.
- APPROACH: ONE FULL UNOBSTRUCTED SIDE OF A CLEAR SPACE SHALL ADJOIN A PEDESTRIAN ACCESS ROUTE OR ADJOIN ANOTHER CLEAR SPACE.
- MANEUVERING SPACE: WHERE A CLEAR SPACE IS CONFINED ON ALL OR PART OF THREE SIDES, ADDITIONAL MANEUVERING SPACE SHALL BE PROVIDED AS FOLLOWS:
 - FORWARD APPROACH: THE CLEAR SPACE AND ADDITIONAL MANEUVERING SPACE SHALL BE 36" WIDE MINIMUM WHERE THE DEPTH OF THE CONFINING ELEMENT EXCEEDS 24".
 - PARALLEL APPROACH: THE CLEAR SPACE AND ADDITIONAL MANEUVERING SPACE SHALL BE 60" WIDE MINIMUM WHERE THE DEPTH OF THE CONFINING ELEMENT EXCEEDS 15".
- THE MINIMUM WHEELCHAIR PASSAGE WIDTH OR CLEAR SPACE WIDTH FOR A SINGLE WHEELCHAIR PASSAGE SHALL BE 48" PER PROWAG SECTION R302.3.
- INITIAL OPERATION FOR THE KIOSK WILL HAVE 4G LTE CONNECTION SECTION R404. TO THE INTERNET.
- THE KIOSKS HAVE BEEN DESIGN TO COMPLY WITH ALL ADA GUIDELINES INCLUDING VIEWING, OPERATION, AND ACCESSIBILITY.
- THE MOBILE IKE EXPERIENCE WILL FOLLOW WEB CONTENT ACCESSIBILITY GUIDELINES (WCAG) TO WORK IN TANDEM WITH THE NATIVE ACCESSIBILITY FEATURES ON THE USER'S MOBILE DEVICE, INCLUDING TALKBACK AND VOICEOVER TOOLS.

SCOPE OF WORK

THE PROJECT CONSIST OF THE INSTALLATION OF ONE (1) DIGITAL INTERACTIVE KIOSKS AT THE LOCATION(S) INDICATED ON THIS PLANS SET. INSTALLER SHALL PROVIDE AND INCLUDE ALL WORKMANSHIP AND MATERIALS NECESSARY TO COMPLETE THE INSTALLATION INCLUDING BUT NOT LIMITED TO:


- INSTALLATION OF THE KIOSKS TO THE FOUNDATION AS INDICATED ON PLANS TO NEW RECTANGULAR CONCRETE FOUNDATION.
- ELECTRICAL SERVICE POINTS ARE EXISTING. CONNECT THE EXISTING ELECTRIC SERVICE TO THE NEW KIOSK AS INDICATED ON PLANS.
- TESTING OF THE ELECTRICAL SERVICE INFRASTRUCTURE SHALL BE PERFORMED IN CONJUNCTION WITH A REPRESENTATIVE OF THE ENGINEER OF RECORD.
- THE CONTRACTOR SHALL INSTALL THE KIOSK IN SUCH A WAY THAT THE KIOSK IS WITHIN THE PUBLIC R.O.W. AND IN COMPLIANCE WITH ALL APPLICABLE A.D.A. REQUIREMENTS
- THE LOCATION OF KIOSKS HAS BEEN COORDINATE TO ENSURE THERE IS NO OBSTRUCTION OF THE SIGHT OF VEHICULAR SIGNS.
- STAND-ALONE PEDESTRIAN KIOSKS SHOULD NOT BE INSTALLED WITHIN PEDESTRIAN CIRCULATION PATHS IN A MANNER THAT PERSONS AT THE KIOSK LOCK THE EFFECTIVE WIDTH OF THE PEDESTRIAN TRAVEL WAY.

MONUMENT SIGN SPECIFICATIONS AND FUNCTIONS


THE UNIT CONSISTS OF A UL/NRTL LISTED WEATHER AND VANDAL RESISTANT FREE STANDING ENCLOSURE DESIGNED TO COMPLY WITH THE FLORIDA BUILDING CODE AND OTHER APPLICABLE CODES INCLUDING THE NATIONAL ELECTRICAL CODE. THE UNIT HAS BEEN DESIGNED TO WITHSTAND WINDS OF 165 MPH. THE UNIT'S MAIN COMPONENTS ARE:

- TWO (2) INTERACTIVE 65" VIDEO TOUCH SCREENS.
- TWO (2) CAMERAS
- ONE (1) CPU
- ONE (1) WI-FI TRANSMITTER

MANUFACTURER: DYNASCAN MODEL NUMBER: CIO651DR5
 NATIVE RESOLUTION: 1920 X 1080
 ELECTRICAL POWER REQUIREMENT:
 1. ONE-2-POLE, 20 AMP, 240 VOLTS CIRCUIT.
 2. TOTAL LOAD: 1400/2200 WATTS (OPERATIONAL/PEAK)
 3. VOLTAGE: 100-240 VOLTS AC, 50-60 HZ
 WEIGHT: 832 LBS
 CERTIFICATION CE / FCC / RoHS

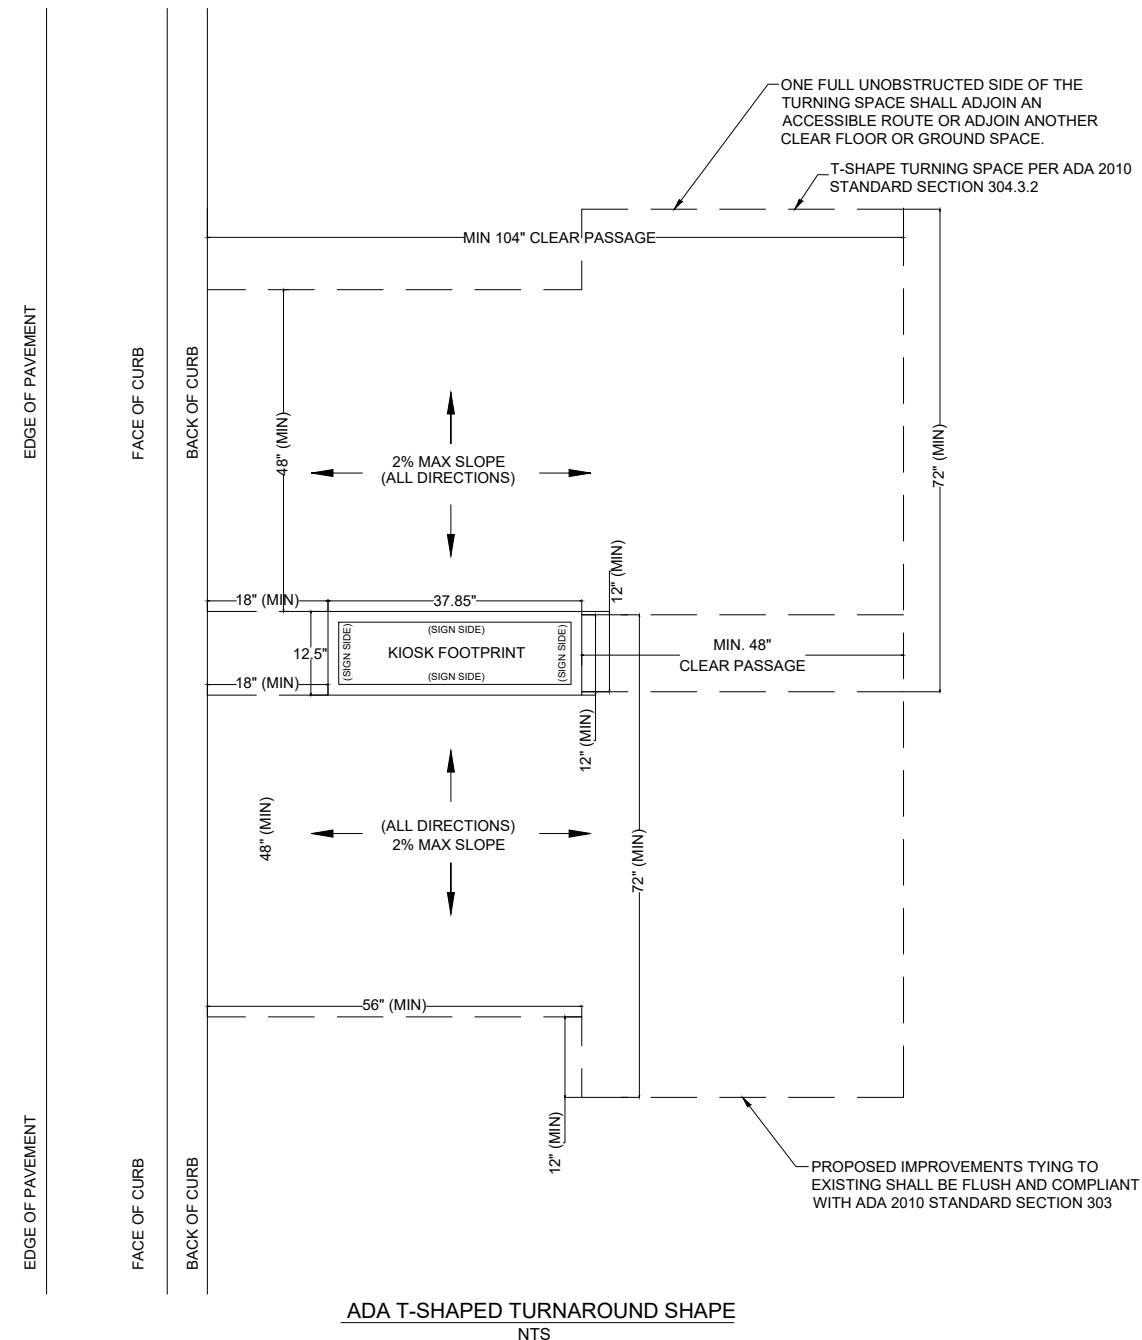

NOTES:

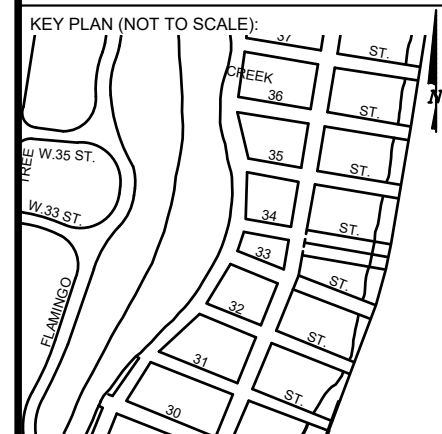

P.E. SEAL:

MIAMI BEACH
 PUBLIC WORKS DEPARTMENT
 1700 CONVENTION CENTER DRIVE, MIAMI BEACH, FL 33139

CITY MANAGER: ALINA T. HUDAK
 DIRECTOR: JOE GOMEZ, P.E.
 CITY ENGINEER: CRISTINA ORTEGA CASTINEIRAS, P.E.

5			
4			
3			
2			
1			
NO.	DATE	REVISION	APP'D. BY

Main Street ENGINEERING
 7055 SW 47th Street, Ste A, Miami, FL 33155
 Tel: (305) 466-3055 Fax: (305) 476-8994
 FL PE Certificate No: 00008751

ENGINEER OF RECORD:
 VANESSA A. MELA,
 P.E. NO. 77676


ENGINEER OF RECORD: VM
 DESIGN ENGINEER: VM
 DRAWN BY: KM
 CHECKER: WP
 SCALE:

NEIGHBORHOOD:
MIB-025: COLLINS AVENUE & 34TH STREET
 TITLE:
ADA NOTES, SCOPE OF WORK & KIOSK SPECIFICATIONS

File Name: MIB-025-GENERAL AND FOUNDATION.dwg
 Survey Reference:
 Field Book: N/A Page: N/A Work Order: N/A
 Date: 10/09/2023 Sheet: 2 of 7 Drawing: G0-04



NOTES:

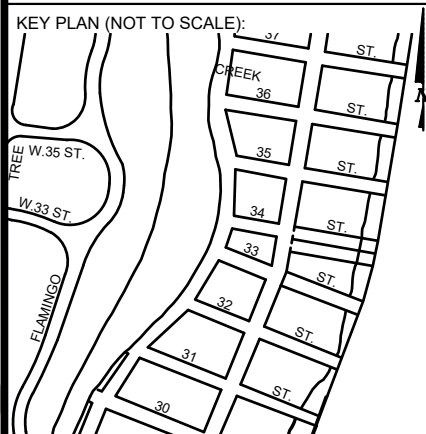

P.E. SEAL:

NO.	DATE	REVISION	APP'D. BY
5			
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3			
2			
1			





ENGINEER OF RECORD:
VANESSA A. MELA,
P.E. NO. 77676

ENGINEER OF RECORD: VM
DESIGN ENGINEER: VM
DRAWN BY: KM
CHECKER: WP
SCALE:



NEIGHBORHOOD:
MIB-025: COLLINS AVENUE & 34TH STREET
TITLE:
CIVIL SITE PLAN

ELECTRICAL SITE PLAN

SCALE: 1"=40'

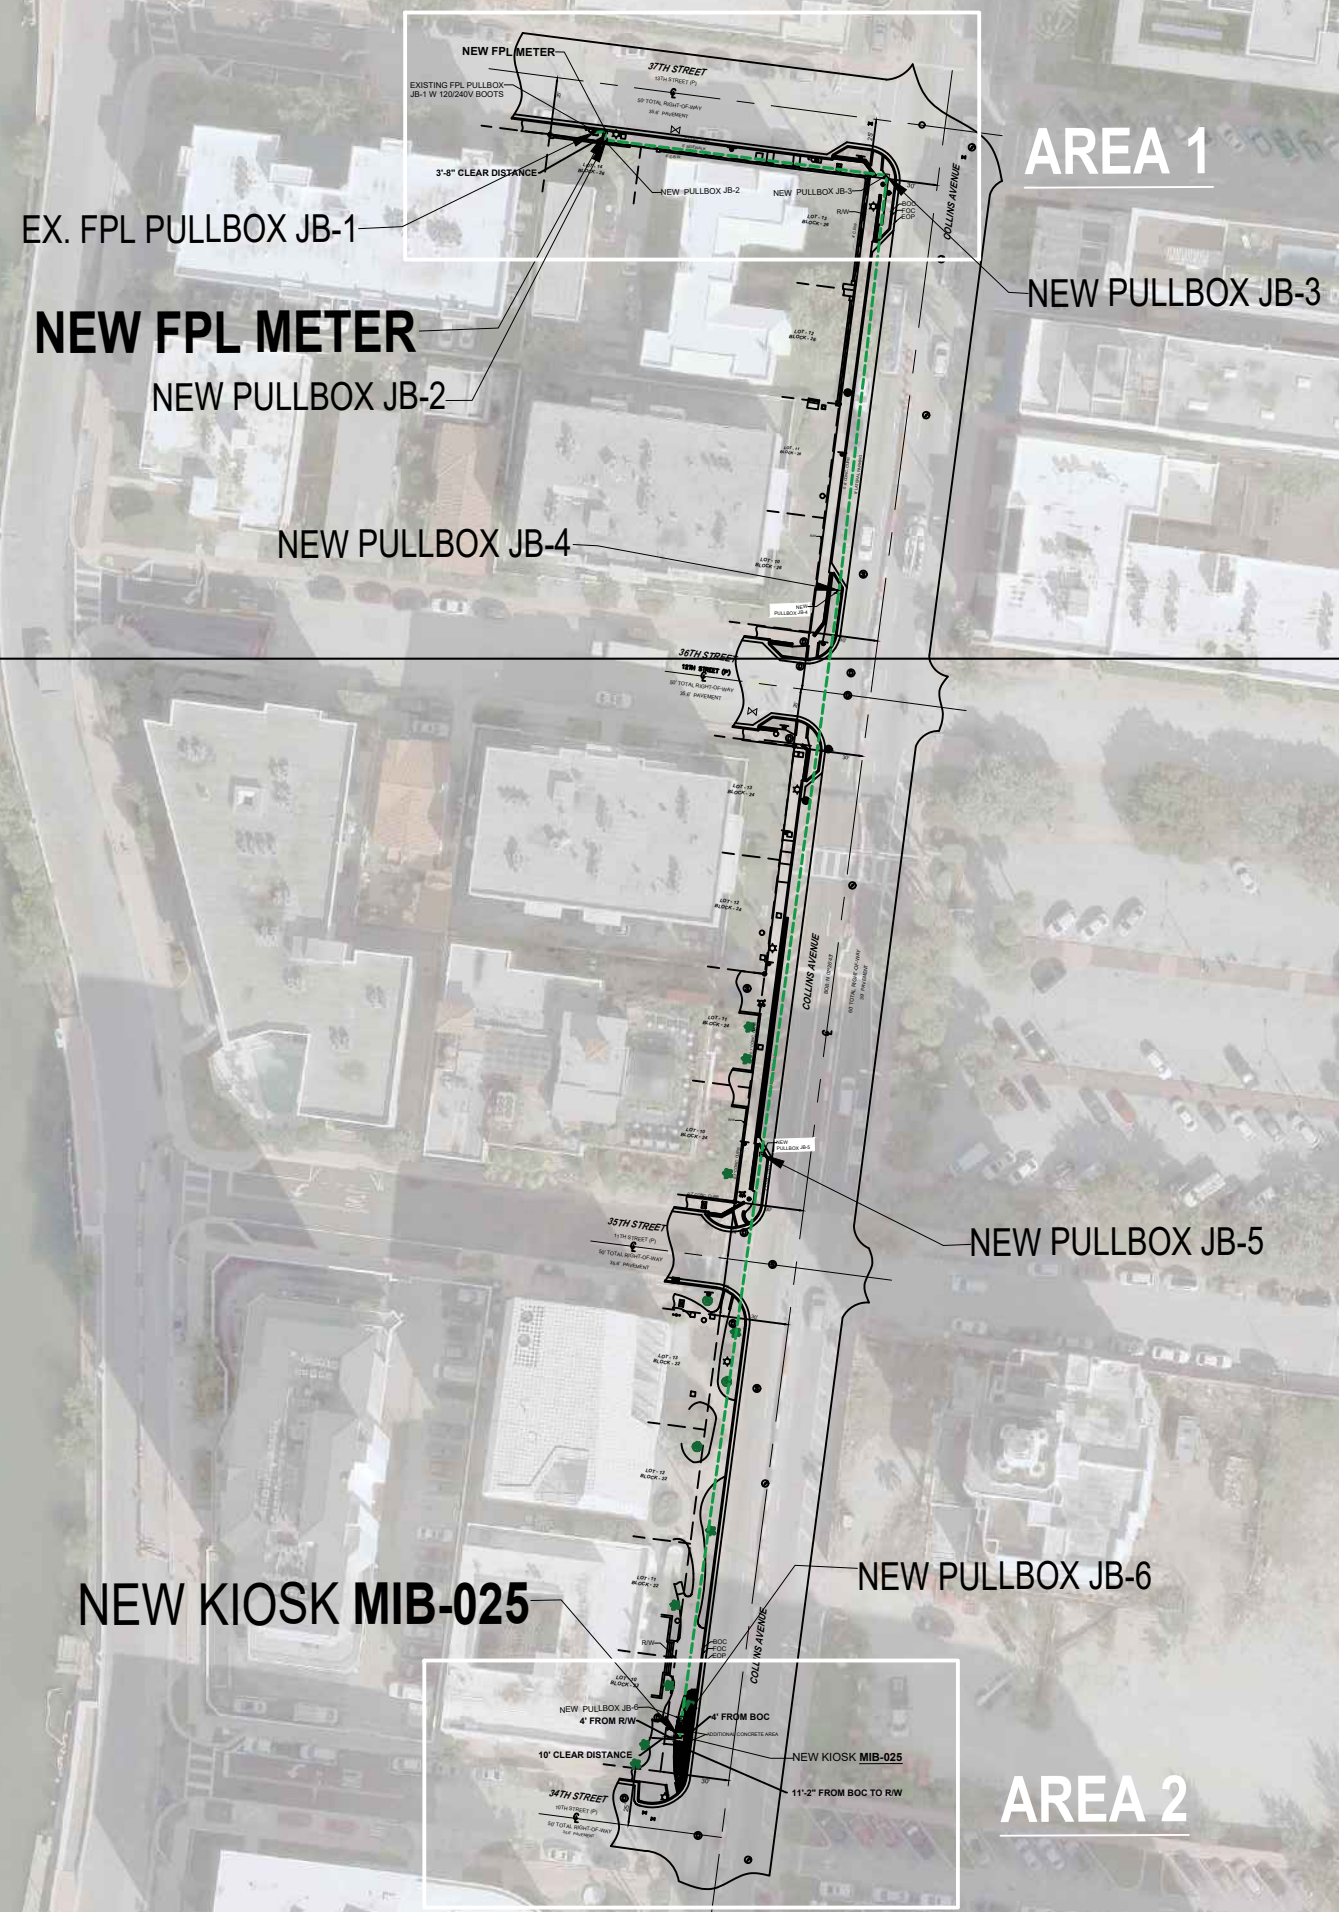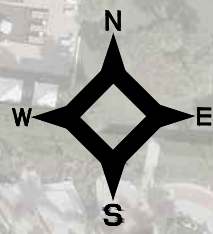

NOTES:

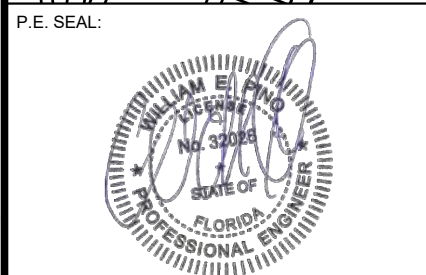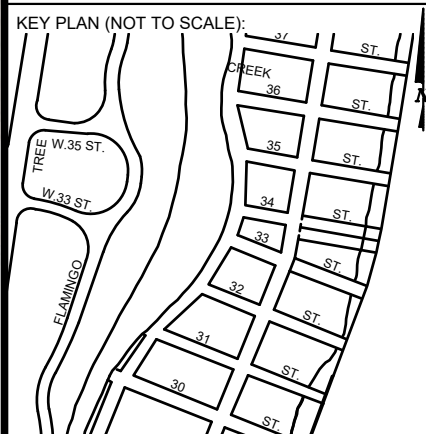

MIAMI BEACH
PUBLIC WORKS DEPARTMENT
1700 CONVENTION CENTER DRIVE, MIAMI BEACH, FL 33139

CITY MANAGER: ALINA T. HUDAK
DIRECTOR: JOE GOMEZ, P.E.
CITY ENGINEER: CRISTINA ORTEGA CASTINEIRAS, P.E.

NO.	DATE	REVISION	APP'D. BY
5			
4			
3			
2			
1			



ENGINEER OF RECORD:
WILLIAM E. PINO,
P.E. NO. 32028

ENGINEER OF RECORD: WP
DESIGN ENGINEER: WP
DRAWN BY: KM
CHECKER: WP
SCALE: 1"=40'

NEIGHBORHOOD:
MIB-025: COLLINS AVENUE & 34TH STREET
TITLE:
ELECTRICAL SITE PLAN

File Name: MIB-025-ELECTRICAL & TTC PLANS.dwg
Survey Reference:
Field Book: N/A Page: N/A Work Order: N/A
Date: 10/09/2023 Sheet: 5 of 7 Drawing: **E0-01**

ELECTRICAL PLAN

AREA 1
SCALE 1"=10'

NEW FPL METER

EXISTING FPL PULLBOX
JB-1 W 120/240V BOOTS

3'-8" CLEAR DISTANCE

LOT - 14
BLOCK - 26

37TH STREET

13TH STREET (P)

50' TOTAL RIGHT-OF-WAY
35.6' PAVEMENT

2" CONC. C&G

5' SIDEWALK

4' C.B.W.

NEW PULLBOX JB-2

NEW PULLBOX JB-3


LOT - 13
BLOCK - 26

R/W

4' C.B.W.

BOC
FOC
EOP

COLLINS AVENUE

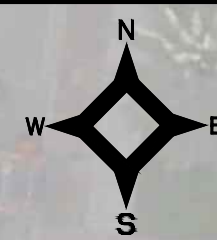

NOTES:

ELECTRICAL PLAN

AREA 2
SCALE 1"=10'

10' CLEAR DISTANCE

34TH STREET

10TH STREET (P)

50' TOTAL RIGHT-OF-WAY
35.6' PAVEMENT

LOT - 10
BLOCK - 22

NEW PULLBOX JB-6
4' FROM R/W

4' FROM BOC

ADDITIONAL CONCRETE AREA

NEW KIOSK MIB-025


11'-2" FROM BOC TO R/W

COLLINS AVENUE


Sunshine811

Call 811 or visit sunshine811.com two full business days before digging to have buried facilities located and marked.
Check positive response codes before you dig!

KEY PLAN (NOT TO SCALE):

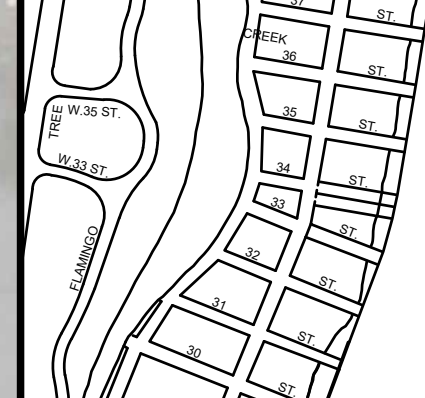

P.E. SEAL:

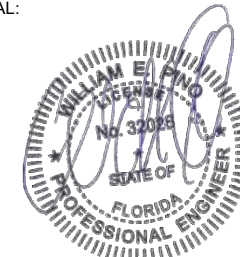

NO.	DATE	REVISION	APP'D. BY
5			
4			
3			
2			
1			

2. Collins Ave & 34th Street



MIAMI BEACH

PUBLIC WORKS DEPARTMENT
COLLINS AVENUE (SR-A1A) & 23RD STREET
INTERACTIVE DIGITAL KIOSK DEPLOYMENT PROJECT
OCTOBER 2023
IKE SMART CITY
MIB-022

CITY OF MIAMI BEACH

MAYOR: DAN GELBER


COMMISSIONERS: MICKY STEINBERG
 MARK SAMUELIAN
 MICHAEL GONGORA
 STEVEN MEINER
 RICKEY ARRIOLA
 DAVID RICHARDSON

CITY MANAGER: ALINA T. HUDAK

CITY ATTORNEY: RAFAEL A. PAZ

PUBLIC WORKS DIRECTOR: JOE GOMEZ, P.E., F.FES

CITY ENGINEER: NELSON PEREZ-JACOME, PE

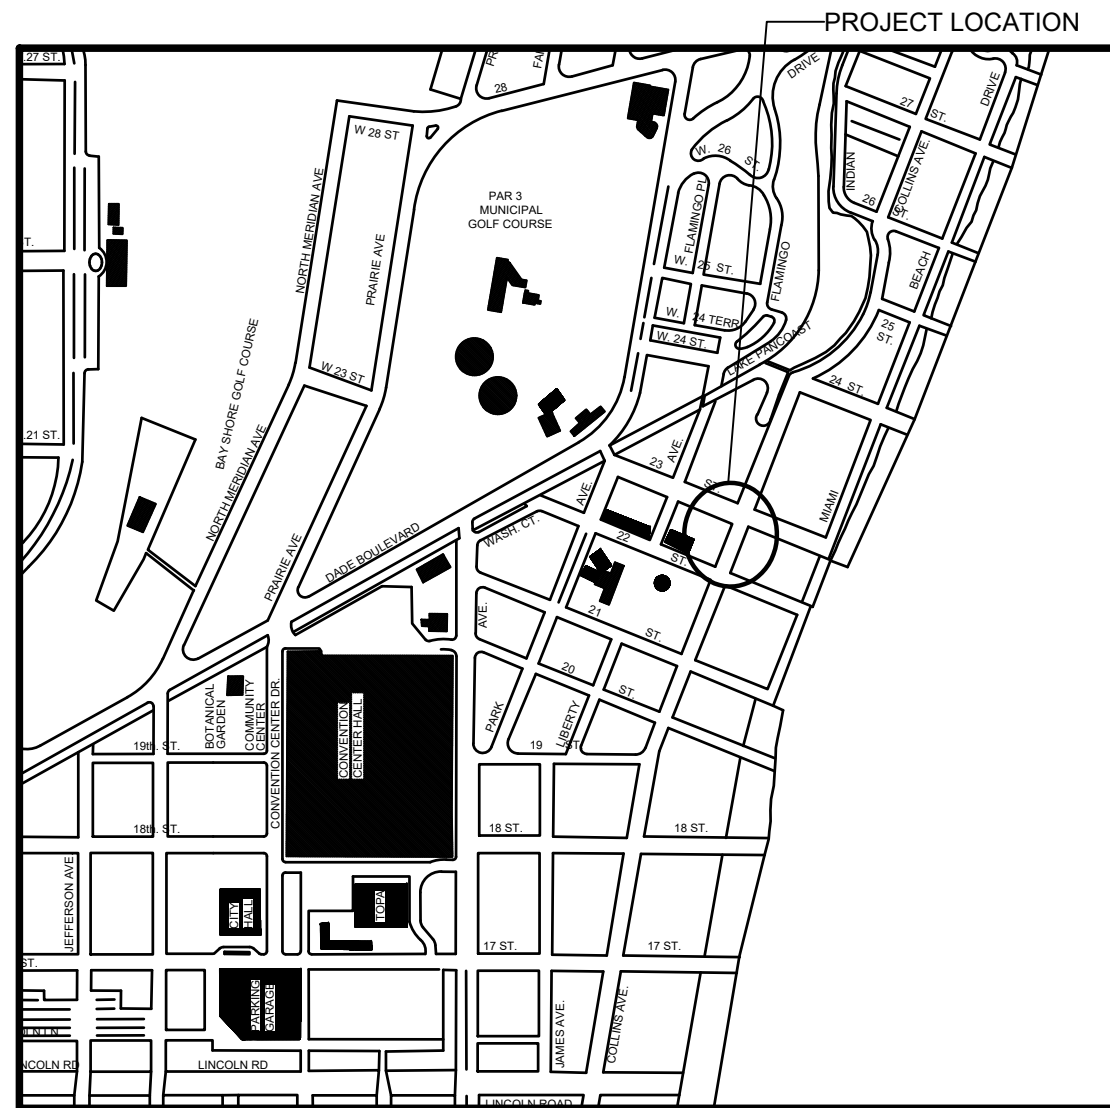

LOCATION MAP



INDEX OF PLANS

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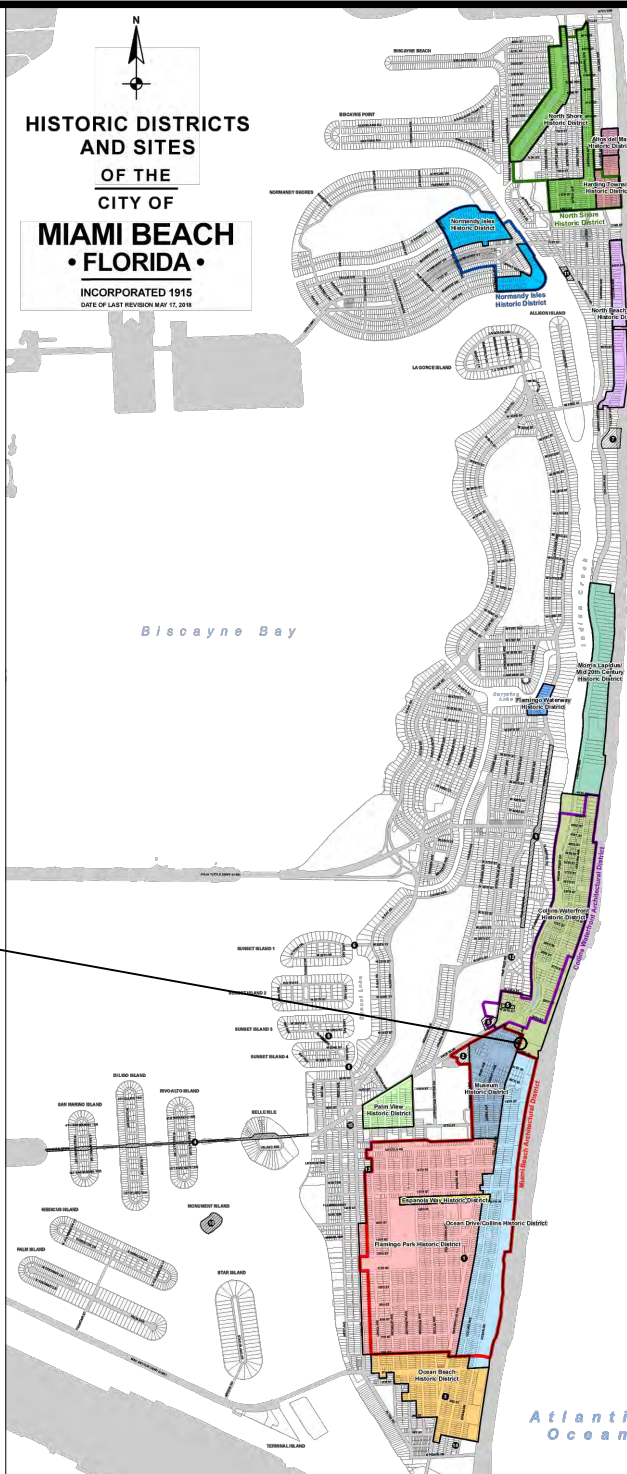
FINAL SUBMITTAL 10/09/2023

Always call 811 two full business days before you dig to have underground utilities located and marked.



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PROJECT LOCATION
COLLINS WATERFRONT HISTORIC DISTRICT

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PROJECT NAME:
INTERACTIVE DIGITAL INFORMATION
KIOSKS DEPLOYMENT PROJECT

JURISDICTION:
CITY OF MIAMI
DEPARTMENT OF RESILIENCE AND
PUBLIC WORKS
MIAMI RIVERSIDE CENTER
444 S.W. 2nd AVENUE, 8th FLOOR
MIAMI, FLORIDA 33130
TEL: 305-416-1200

OWNER:
IKE SMART CITY
250 N HARTOFORD AVE
COLUMBUS, OH 43222
(614) 589-0087

ENGINEER OF RECORD:
MAINSTREET ENGINEERING
7035 SW 47 STREET, SUITE A
MIAMI, FL 33155
(305) 456-3505
PROJ. MGR: VANESSA MELA, P.E.
VMELA@MAINSTREETENG.COM

KIOSK MANUFACTURER:
DISPLAY DEVICE INC.
21075 WESTGATE RD.
GOLDEN, CO 80403
CONTACT: ERIC PERKINS
PHONE: (303) 929-4071

UTILITIES:

ELECTRICAL POWER: FLORIDA
POWER & LIGHT COMPANY (FPL)

WATER & SEWER: MIAMI-DADE
WATER & SEWAGE DEPARTMENT


TELEPHONE: AT&T

CABLE: COMCAST, XFINITY,
ATT-UVERSE

GAS: FLORIDA GAS

SIDEWALK & STREET SYMBOLS

	ASPHALT		BRICK
	PAVER		CONCRETE
	UNIMPROVED		TILE
	GRAVEL		STAMPED CONCRETE

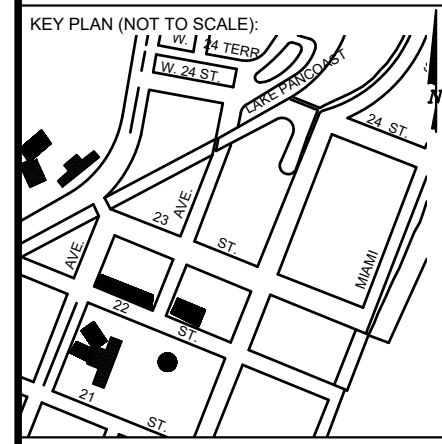

P.E. SEAL:

ADA NOTES

- ALL CONSTRUCTION ACTIVITIES SHALL BE COMPLETED IN FULL COMPLIANCE WITH THE AMERICANS WITH DISABILITIES ACT (ADA). CLEAR SPACES IN FRONT OF KIOSK SHALL HAVE THE FOLLOWING CHARACTERISTICS:
- SURFACES SHALL BE FIRM, STABLE, AND SLIP RESISTANT AND OTHERWISE COMPLY WITH PROWAG SECTION R302.7 AND SHALL HAVE A RUNNING SLOPE CONSISTENT WITH GRADE OF THE ADJACENT PEDESTRIAN ACCESS ROUTE AND CROSS SLOPE OF 1.50% +/-0.50%)
- SIZE: CLEAR SPACES SHALL BE 48" MINIMUM BY 48" MINIMUM.
- POSITION: UNLESS OTHERWISE SPECIFIED, CLEAR SPACES SHALL BE POSITIONED FOR EITHER FORWARD OR PARALLEL APPROACH TO THE KIOSK.
- APPROACH: ONE FULL UNOBSTRUCTED SIDE OF A CLEAR SPACE SHALL ADJOIN A PEDESTRIAN ACCESS ROUTE OR ADJOIN ANOTHER CLEAR SPACE.
- MANEUVERING SPACE: WHERE A CLEAR SPACE IS CONFINED ON ALL OR PART OF THREE SIDES, ADDITIONAL MANEUVERING SPACE SHALL BE PROVIDED AS FOLLOWS:
 - FORWARD APPROACH: THE CLEAR SPACE AND ADDITIONAL MANEUVERING SPACE SHALL BE 36" WIDE MINIMUM WHERE THE DEPTH OF THE CONFINING ELEMENT EXCEEDS 24".
 - PARALLEL APPROACH: THE CLEAR SPACE AND ADDITIONAL MANEUVERING SPACE SHALL BE 60" WIDE MINIMUM WHERE THE DEPTH OF THE CONFINING ELEMENT EXCEEDS 15".
- THE MINIMUM WHEELCHAIR PASSAGE WIDTH OR CLEAR SPACE WIDTH FOR A SINGLE WHEELCHAIR PASSAGE SHALL BE 48" PER PROWAG SECTION R302.3.
- INITIAL OPERATION FOR THE KIOSK WILL HAVE 4G LTE CONNECTION SECTION R404. TO THE INTERNET.
- THE KIOSKS HAVE BEEN DESIGN TO COMPLY WITH ALL ADA GUIDELINES INCLUDING VIEWING, OPERATION, AND ACCESSIBILITY.
- THE MOBILE IKE EXPERIENCE WILL FOLLOW WEB CONTENT ACCESSIBILITY GUIDELINES (WCAG) TO WORK IN TANDEM WITH THE NATIVE ACCESSIBILITY FEATURES ON THE USER'S MOBILE DEVICE, INCLUDING TALKBACK AND VOICEOVER TOOLS.

SCOPE OF WORK

THE PROJECT CONSIST OF THE INSTALLATION OF ONE (1) DIGITAL INTERACTIVE KIOSKS AT THE LOCATION(S) INDICATED ON THIS PLANS SET. INSTALLER SHALL PROVIDE AND INCLUDE ALL WORKMANSHIP AND MATERIALS NECESSARY TO COMPLETE THE INSTALLATION INCLUDING BUT NOT LIMITED TO:


- INSTALLATION OF THE KIOSKS TO THE FOUNDATION AS INDICATED ON PLANS TO NEW RECTANGULAR CONCRETE FOUNDATION.
- ELECTRICAL SERVICE POINTS ARE EXISTING. CONNECT THE EXISTING ELECTRIC SERVICE TO THE NEW KIOSK AS INDICATED ON PLANS.
- TESTING OF THE ELECTRICAL SERVICE INFRASTRUCTURE SHALL BE PERFORMED IN CONJUNCTION WITH A REPRESENTATIVE OF THE ENGINEER OF RECORD.
- THE CONTRACTOR SHALL INSTALL THE KIOSK IN SUCH A WAY THAT THE KIOSK IS WITHIN THE PUBLIC R.O.W. AND IN COMPLIANCE WITH ALL APPLICABLE A.D.A. REQUIREMENTS
- THE LOCATION OF KIOSKS HAS BEEN COORDINATE TO ENSURE THERE IS NO OBSTRUCTION OF THE SIGHT OF VEHICULAR SIGNS.
- STAND-ALONE PEDESTRIAN KIOSKS SHOULD NOT BE INSTALLED WITHIN PEDESTRIAN CIRCULATION PATHS IN A MANNER THAT PERSONS AT THE KIOSK LOCK THE EFFECTIVE WIDTH OF THE PEDESTRIAN TRAVEL WAY.

MONUMENT SIGN SPECIFICATIONS AND FUNCTIONS


THE UNIT CONSISTS OF A UL/NRTL LISTED WEATHER AND VANDAL RESISTANT FREE STANDING ENCLOSURE DESIGNED TO COMPLY WITH THE FLORIDA BUILDING CODE AND OTHER APPLICABLE CODES INCLUDING THE NATIONAL ELECTRICAL CODE. THE UNIT HAS BEEN DESIGNED TO WITHSTAND WINDS OF 165 MPH. THE UNIT'S MAIN COMPONENTS ARE:

- TWO (2) INTERACTIVE 65" VIDEO TOUCH SCREENS.
- TWO (2) CAMERAS
- ONE (1) CPU
- ONE (1) WI-FI TRANSMITTER

MANUFACTURER: DYNASCAN MODEL NUMBER: CIO651DR5
 NATIVE RESOLUTION: 1920 X 1080
 ELECTRICAL POWER REQUIREMENT:
 1. ONE-2-POLE, 20 AMP, 240 VOLTS CIRCUIT.
 2. TOTAL LOAD: 1400/2200 WATTS (OPERATIONAL/PEAK)
 3. VOLTAGE: 100-240 VOLTS AC, 50-60 HZ
 WEIGHT: 832 LBS
 CERTIFICATION CE / FCC / RoHS

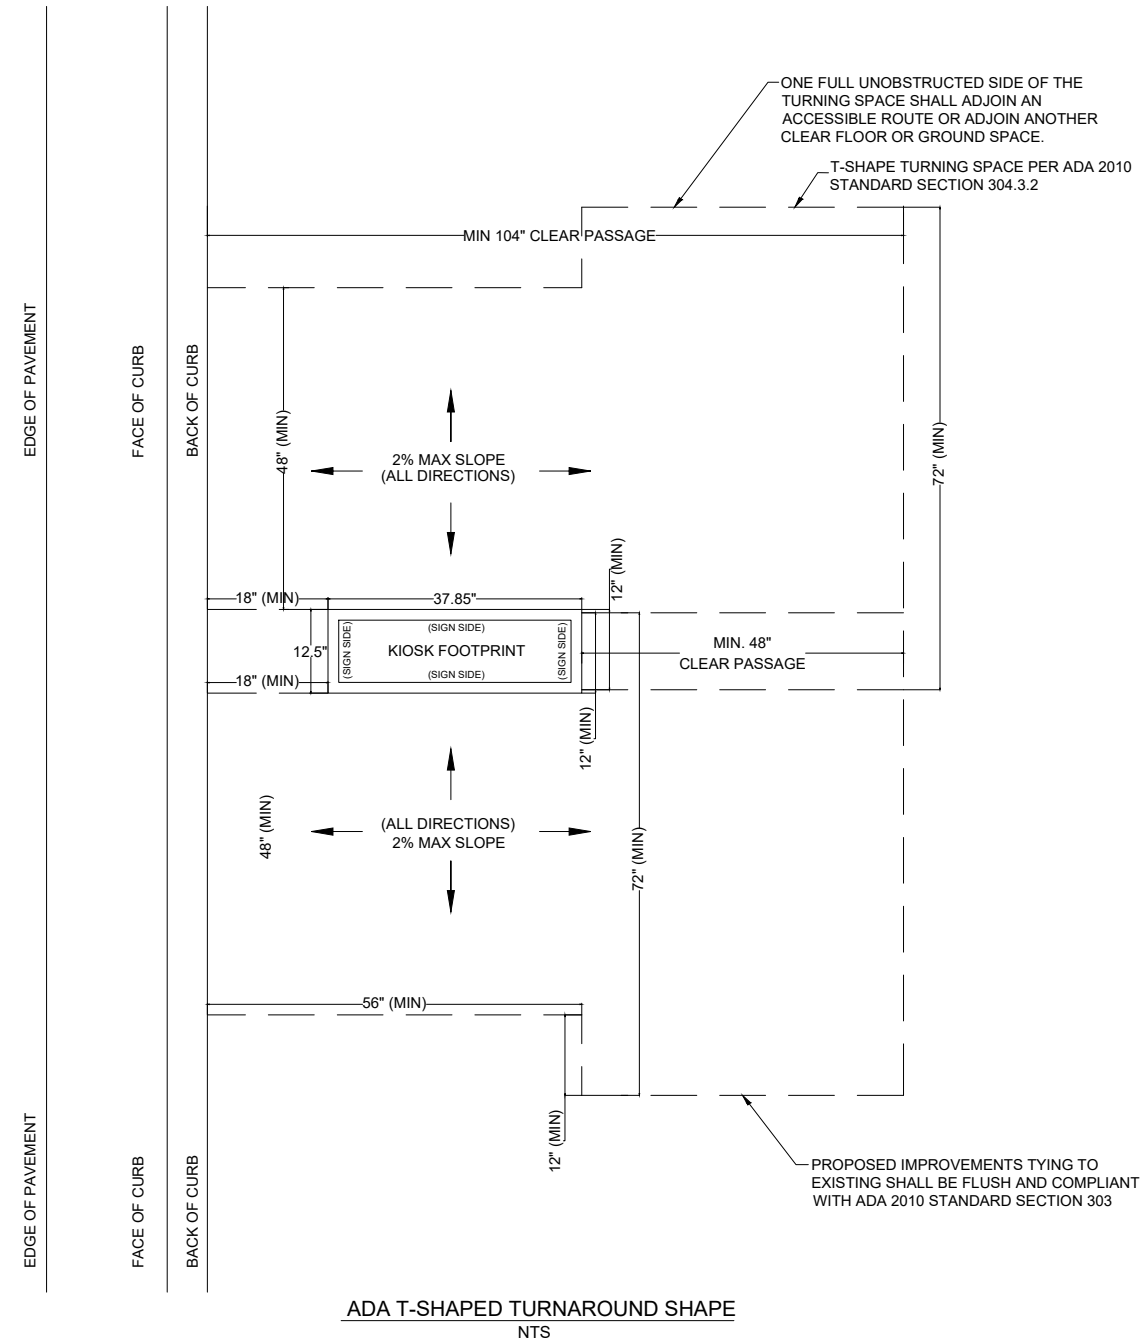

NOTES:

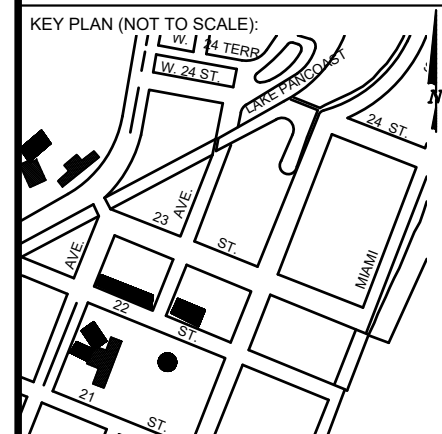

P.E. SEAL:

MIAMI BEACH
 PUBLIC WORKS DEPARTMENT
 1700 CONVENTION CENTER DRIVE, MIAMI BEACH, FL 33139

CITY MANAGER: ALINA T. HUDAK
 DIRECTOR: JOE GOMEZ, P.E.
 CITY ENGINEER: CRISTINA ORTEGA CASTINEIRAS, P.E.

NO.	DATE	REVISION	APP'D. BY
5			
4			
3			
2			
1			



Main Street ENGINEERING
 7035 SW 47th Street, Ste A, Miami, FL 33155
 Tel: (305) 466-3055, Fax: (305) 476-8894
 FL PE Certificate No: 00008751

ENGINEER OF RECORD:
 VANESSA A. MELA,
 P.E. NO. 77676

ENGINEER OF RECORD: VM
 DESIGN ENGINEER: VM
 DRAWN BY: KM
 CHECKER: WP
 SCALE:


NEIGHBORHOOD:
MIB-022: COLLINS AVENUE & 23RD STREET
 TITLE:
ADA NOTES, SCOPE OF WORK & KIOSK SPECIFICATIONS

File Name: MIB-022-GENERAL AND FOUNDATION.dwg
 Survey Reference:
 Field Book: N/A Page: N/A Work Order: N/A
 Date: 10/09/2023 Sheet: 2 of 6 Drawing: G0-04

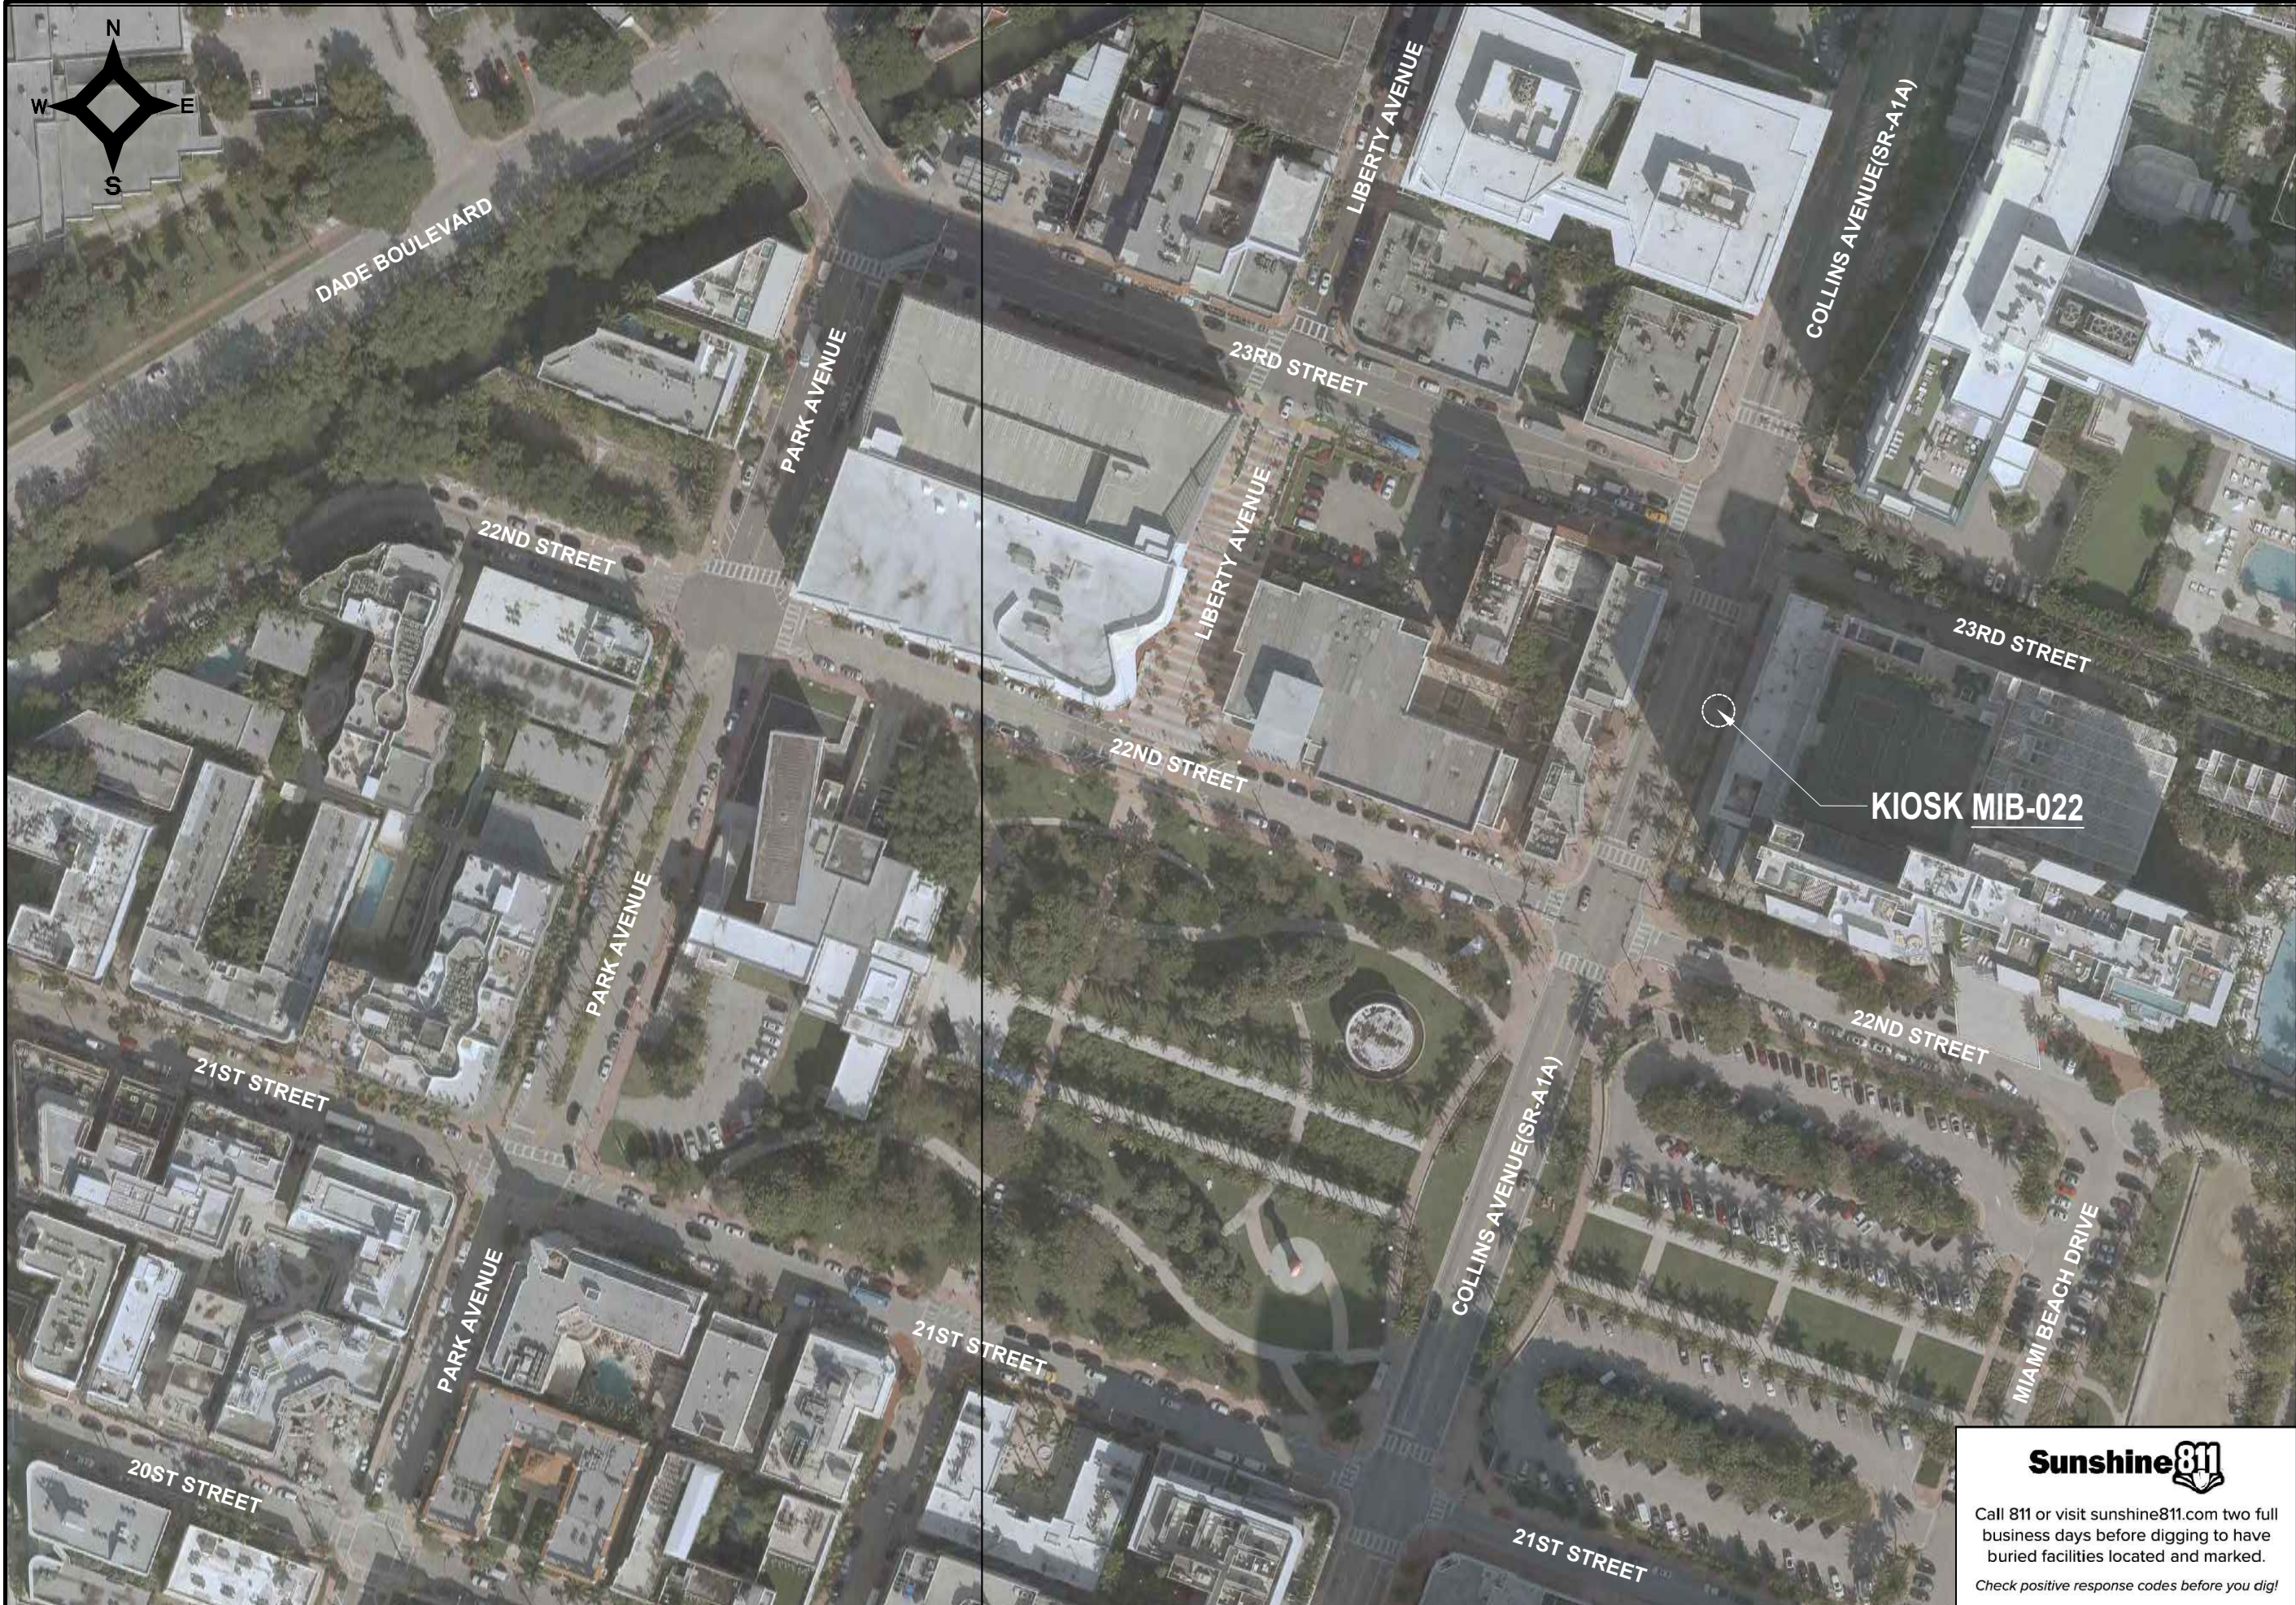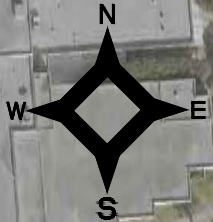


KIOSK MIB-022

NOTES:

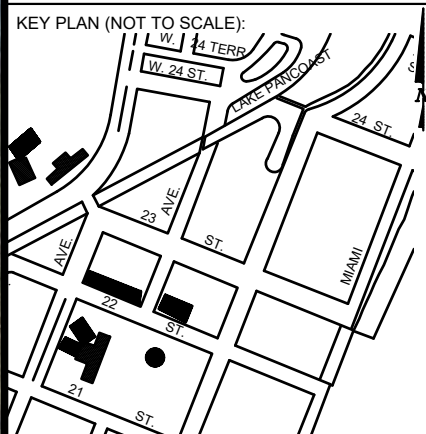

KEY PLAN (NOT TO SCALE):

P.E. SEAL:

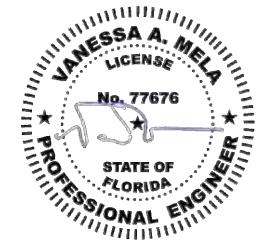

Sunshine811
 Call 811 or visit sunshine811.com two full business days before digging to have buried facilities located and marked.
 Check positive response codes before you dig!

MIAMI BEACH
 PUBLIC WORKS DEPARTMENT
 1700 CONVENTION CENTER DRIVE, MIAMI BEACH, FL 33139

CITY MANAGER: ALINA T. HUDAK
 DIRECTOR: JOE GOMEZ, P.E.
 CITY ENGINEER: CRISTINA ORTEGA CASTINEIRAS, P.E.

NO.	DATE	REVISION	APP'D. BY
5			
4			
3			
2			
1			

Main Street ENGINEERING
 7035 SW 47th Street, Ste A, Miami, FL 33155
 Tel: (305) 498-3025 Fax: (305) 478-8884
 FL PE Certificate No: 00008751

ENGINEER OF RECORD: VANESSA A. MELA, P.E. NO. 77676
 ENGINEER OF RECORD: VM
 DESIGN ENGINEER: VM
 DRAWN BY: KM
 CHECKER: WP
 SCALE:

NEIGHBORHOOD: MIB-022: COLLINS AVENUE & 23RD STREET
 TITLE: CIVIL SITE PLAN

File Name: MIB-022-CIVIL PLANS.dwg
 Survey Reference:
 Field Book: N/A Page: N/A Work Order: N/A
 Date: 10/09/2023 Sheet: 3 of 6 Drawing: C1-01

Survey Pros, Inc.

4348 SW 74TH AVENUE, MIAMI, FL. 33155
 Tel: 305.767.6802
 www.survey-pros.com

MAP OF SPECIFIC PURPOSE TOPOGRAPHIC & TREE SURVEY

OF A PORTION OF
 "COLLINS AVENUE"
 CITY OF MIAMI BEACH, FL.
 PLAT OF "THE OCEAN FRONT PROPERTY OF THE MIAMI
 BEACH IMPROVEMENT COMPANY"
 PLAT BOOK 5, PAGE 7, MDCR

LEGEND

ABBREVIATIONS:

- A = ARC DISTANCE
- AC = AIR CONDITIONER PAD
- BCR = BROWARD COUNTY RECORDS
- BLDG = BUILDING
- BM = BENCH MARK
- BOB = BASIS OF BEARINGS
- CBS = CONCRETE BLOCK & STUCCO
- (C) = CALCULATED
- C&G = CURB & GUTTER
- CLF = CHAIN LINK FENCE
- COL = COLUMN
- D.E. = DRAINAGE EASEMENT
- D.M.E. = DRAINAGE & MAINTENANCE EASEMENT
- D/W = DRIVEWAY
- EB = ELECTRIC BOX
- ENC. = ENCROACHMENT
- EP = EDGE OF PAVEMENT
- EW = EDGE OF WATER
- FDH = FOUND DRILL HOLE
- FFE = FINISHED FLOOR ELEVATION
- FIP = FOUND IRON PIPE (NO ID)
- FIR = FOUND IRON ROD (NO ID)
- FN = FOUND NAIL (NO ID)
- FPL = FLORIDA POWER & LIGHT TRANSFORMER PAD
- L.E. = LANDSCAPE EASEMENT
- L.M.E. = LAKE MAINTENANCE EASEMENT
- (M) = MEASURED
- MDCR = MIAMI-DADE COUNTY RECORDS
- MH = MAN HOLE
- ML = MONUMENT LINE
- (P) = PLAT
- PB = PLAT BOOK
- PC = POINT OF CURVATURE
- PCP = PERMANENT CONTROL POINT
- PE = POOL EQUIPMENT PAD
- PG = PAGE
- PI = POINT OF INTERSECTION
- PL = PLANTER
- POB = POINT OF BEGINNING
- POC = POINT OF COMMENCEMENT
- PRC = POINT OF REVERSE CURVATURE
- PRM = PERMANENT REFERENCE MONUMENT
- PT = POINT OF TANGENCY
- R = RADIUS DISTANCE
- (R) = RECORD
- R/W = RIGHT-OF-WAY
- RES = RESIDENCE
- SIP = SIP LB#8023
- SND = SET NAIL & DISK LB#8023
- STL = SURVEY TIE LINE
- SWK = SIDEWALK (TYP) = TYPICAL
- UB = UTILITY BOX
- U.E. = UTILITY EASEMENT
- W/F = WOOD FENCE


TREE TABLE			
No.	COMMON NAME	DBH (Ø)	HEIGHT CANOPY
1	PALM	10"	18' 12'
2	PALM	10"	18' 12'
3	PALM	10"	25' 10'
4	PALM	10"	25' 10'
5	PALM	10"	25' 10'
6	PALM	10"	25' 10'
7	PALM	10"	25' 10'
8	PALM	10"	25' 10'

IN CASE OF A DISPUTE AN ARBORIST REPORT WILL GOVERN.



SYMBOLS:

- = TELEPHONE RISER
- = CABLE TV RISER
- = WATER METER
- X 0.00 = ELEVATION
- (00') = ORIGINAL LOT DISTANCE
- Δ = CENTRAL ANGLE
- = CENTER LINE
- = WATER VALVE
- = CURB INLET
- = FIRE HYDRANT
- = LIGHT POLE
- = CATCH BASIN
- = UTILITY POLE
- = DRAINAGE MANHOLE
- = SEWER MANHOLE
- = SIGN
- = METAL FENCE
- = WOOD FENCE
- = CHAIN LINK FENCE
- = EASEMENT
- = BOUNDARY LINE
- = OVERHEAD UTILITY LINE
- = ORIGINAL LOT LINE

- = COMMUNICATION LINE
- = ELECTRIC LINE
- = UNKNOWN
- = STORM LINE
- = WATER LINE
- = SANITARY LINE

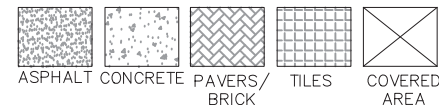


GRAPHIC SCALE

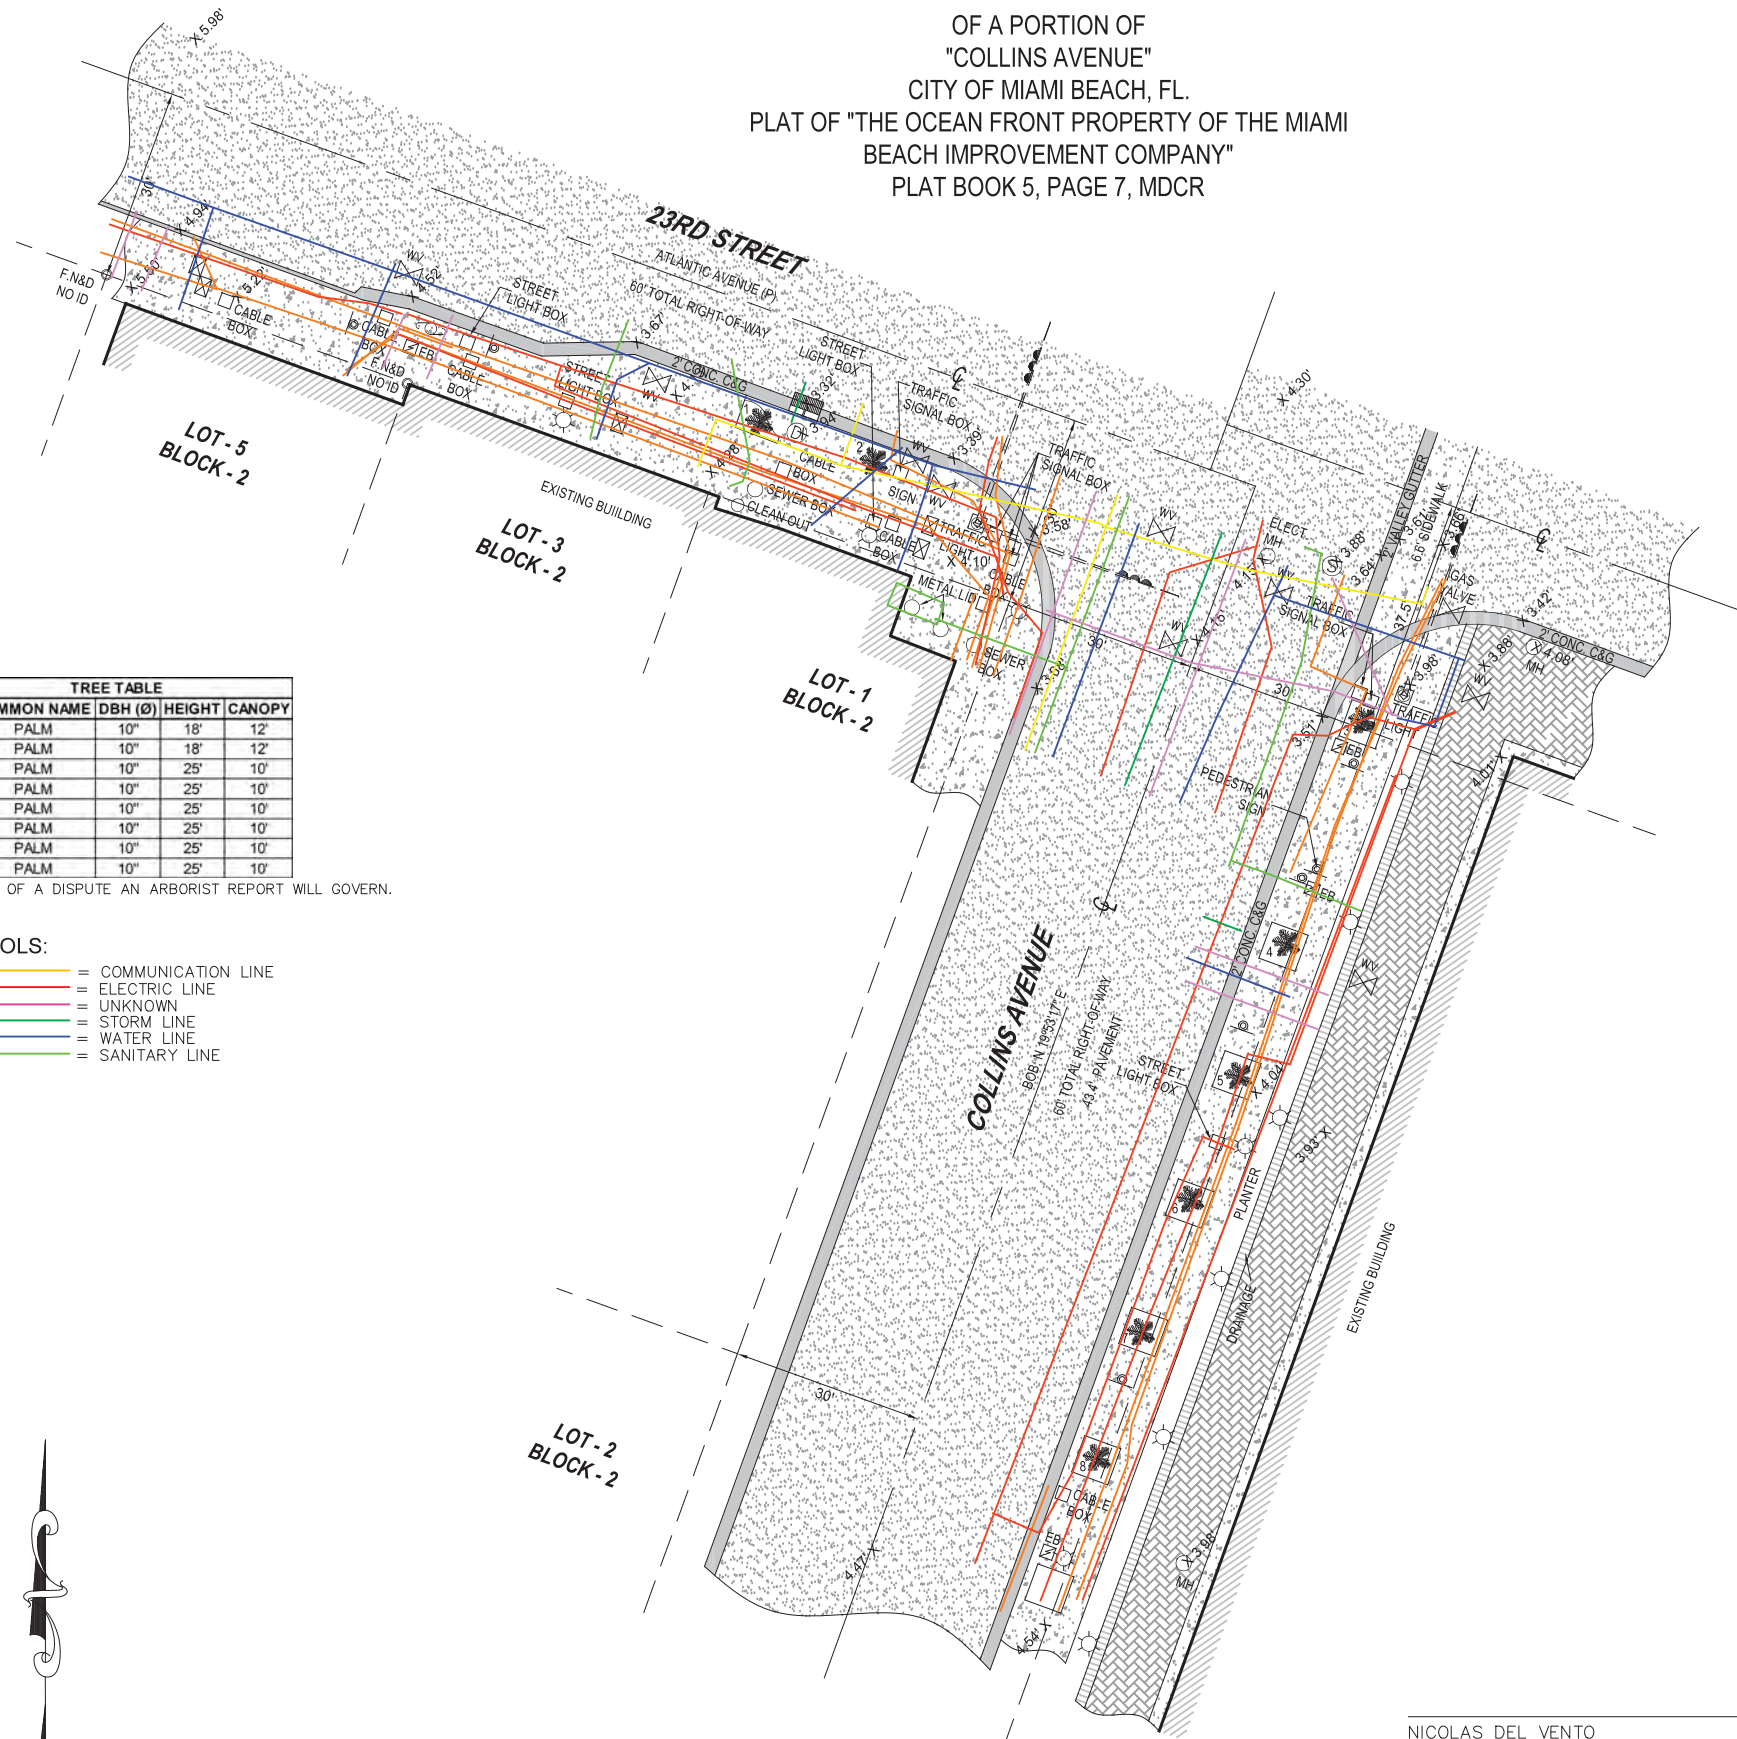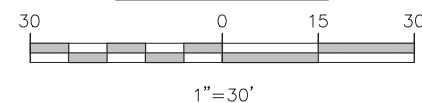

LOCATION SKETCH:

NOT TO SCALE

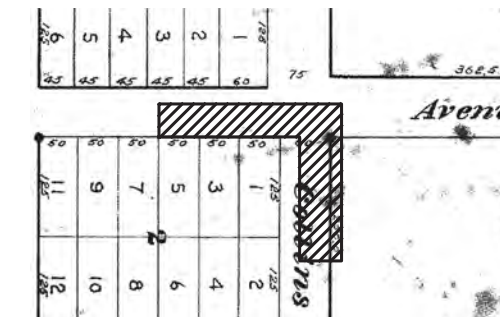

FLOOD ZONE INFORMATION:

THE GRAPHICALLY DEPICTED BUILDING(S) SHOWN ON THIS MAP OF SURVEY IS WITHIN ZONE AE. BASE FLOOD ELEVATION 8. COMMUNITY NAME & NUMBER CITY OF MIAMI BEACH 120651. MAP & PANEL NUMBER 12086C0317 SUFFIX L.

SURVEYOR'S NOTES:

1. ELEVATIONS WHEN SHOWN REFER TO 1929 NATIONAL GEODETIC VERTICAL DATUM (NGVD 1929).
2. NO ATTEMPT WAS MADE TO LOCATE FOOTINGS/FOUNDATIONS, OR UNDERGROUND UTILITIES UNLESS OTHERWISE NOTED.
3. THE LANDS SHOWN HEREON HAVE NOT BEEN ABSTRACTED IN REGARDS TO MATTERS OF INTEREST BY OTHER PARTIES, SUCH AS EASEMENTS, RIGHTS OF WAYS, RESERVATIONS, ETC. ONLY PLATTED EASEMENTS ARE SHOWN.
4. THIS SURVEY WAS PREPARED FOR AND CERTIFIED TO THE PARTY(IES) INDICATED HEREON AND IS NOT TRANSFERABLE OR ASSIGNABLE WITHOUT WRITTEN CONSENT OF THIS FIRM.
5. ALL BOUNDARY LIMIT INDICATORS SET ARE STAMPED LB#8023.
6. THE BOUNDARY LIMITS ESTABLISHED ON THIS SURVEY ARE BASED ON THE LEGAL DESCRIPTION PROVIDED BY THE CLIENT OR ITS REPRESENTATIVE.
7. FENCE OWNERSHIP IS NOT DETERMINED. DIMENSIONS ARE TO THE INTERIOR PORTION OF THE FENCE.
8. ADDITIONS OR DELETIONS TO THIS SURVEY MAP AND/OR REPORT BY SOMEONE OTHER THAN THE SIGNING PARTY(IES) IS PROHIBITED WITHOUT WRITTEN CONSENT OF THE SIGNING PARTY(IES).
9. THIS SURVEY IS NOT VALID WITHOUT THE ORIGINAL SIGNATURE AND RAISED SEAL OF A FLORIDA LICENSED SURVEYOR AND MAPPER. OTHERWISE THIS MAP IS FOR INFORMATIONAL PURPOSES ONLY.
10. BEARINGS WHEN SHOWN ARE TO AN ASSUMED MERIDIAN AND BASED ON PLAT. THE CENTERLINE OF COLLINS AVENUE BEARS N 19°53'17" E.

SURVEYOR'S CERTIFICATION:

I HEREBY CERTIFY THAT THIS SURVEY IS TRUE AND CORRECT TO THE BEST OF MY KNOWLEDGE AND BELIEF AS RECENTLY SURVEYED AND DRAWN UNDER MY DIRECTION AND MEETS THE MINIMUM TECHNICAL STANDARDS SET FORTH BY THE FLORIDA STATE BOARD OF SURVEYORS AND MAPPERS IN CHAPTER 5J-17 FLORIDA ADMINISTRATIVE CODE PURSUANT TO SECTION 472.027 FLORIDA STATUTE.

CERTIFIED TO:

MAIN STREET ENGINEERING

<p>SEAL</p>	<p>DATE OF ORIGINAL FIELD WORK: 09/06/2023</p> <p>JOB NUMBER: 23089915</p> <p>DRAWN BY: ADRIEL</p> <p>CAD FILE: MAIN STREET ENGINEER</p> <p>SHEET 1 OF 1</p> <p>REVISION(S):</p>
-------------	--

NICOLAS DEL VENTO
 PROFESSIONAL SURVEYOR & MAPPER
 STATE OF FLORIDA LIC. # 6945

MIAMI BEACH

PUBLIC WORKS DEPARTMENT
COLLINS AVENUE (SR-A1A) & 20TH STREET
INTERACTIVE DIGITAL KIOSK DEPLOYMENT PROJECT
OCTOBER 2023
IKE SMART CITY
MIB-021

CITY OF MIAMI BEACH

MAYOR: DAN GELBER


COMMISSIONERS: MICKY STEINBERG
 MARK SAMUELIAN
 MICHAEL GONGORA
 STEVEN MEINER
 RICKEY ARRIOLA
 DAVID RICHARDSON

CITY MANAGER: ALINA T. HUDAK

CITY ATTORNEY: RAFAEL A. PAZ

PUBLIC WORKS DIRECTOR: JOE GOMEZ, P.E., F.FES

CITY ENGINEER: NELSON PEREZ-JACOME, PE

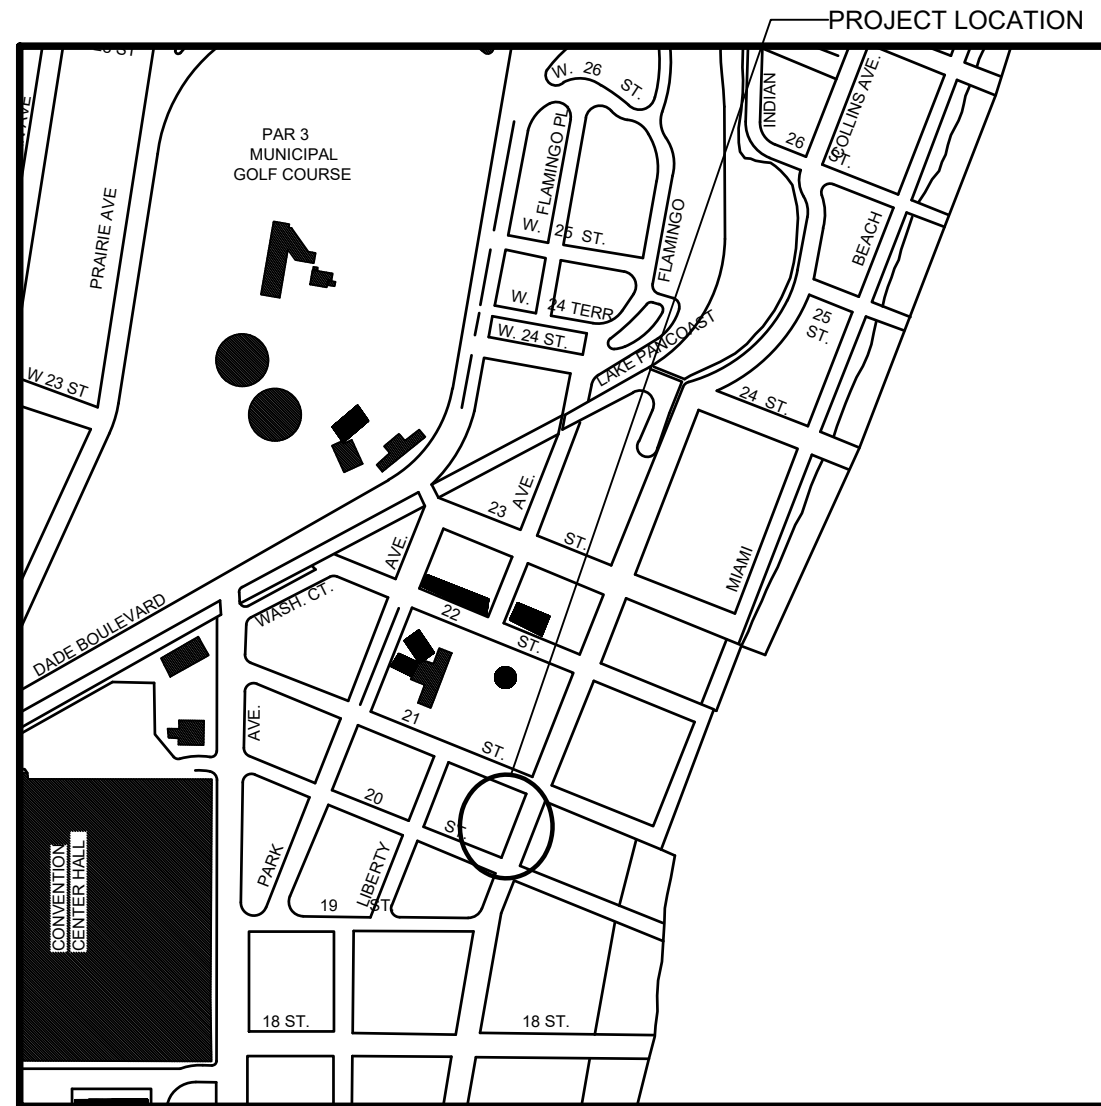

LOCATION MAP



INDEX OF PLANS

NUMBER	DISCIPLINE	SHEET NO.	DESCRIPTION	NOTES
1	GENERAL	G0-03	INDEX OF SHEETS	
2	GENERAL	G0-04	ADA NOTES, SCOPE OF WORK & KIOSK SPECIFICATIONS	
3	CIVIL	C1-01	CIVIL SITE PLAN	
4	CIVIL	C1-02	KIOSK MIB-021 ENGINEERING PLAN	
5	ELECTRICAL	E1-01	KIOSK MIB-021 ELECTRICAL PLAN	
6	SURVEY		KIOSK MIB-021 SITE SURVEY	

SCOPE OF WORK: THE PROJECT CONSISTS OF THE INSTALLATION OF ONE (1) DIGITAL INTERACTIVE KIOSK AND APPLICABLE INFRASTRUCTURE; STRUCTURAL FOUNDATION AND ELECTRICAL SERVICE AT THE LOCATION INDICATED ON THESE DESIGN PLANS.


FINAL SUBMITTAL 10/09/2023

Always call 811 two full business days before you dig to have underground utilities located and marked.



INDEX OF PLANS

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1	GENERAL	G0-03	INDEX OF SHEETS	
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5	ELECTRICAL	E1-01	KIOSK MIB-021 ELECTRICAL PLAN	
6	SURVEY		KIOSK MIB-021 SITE SURVEY	

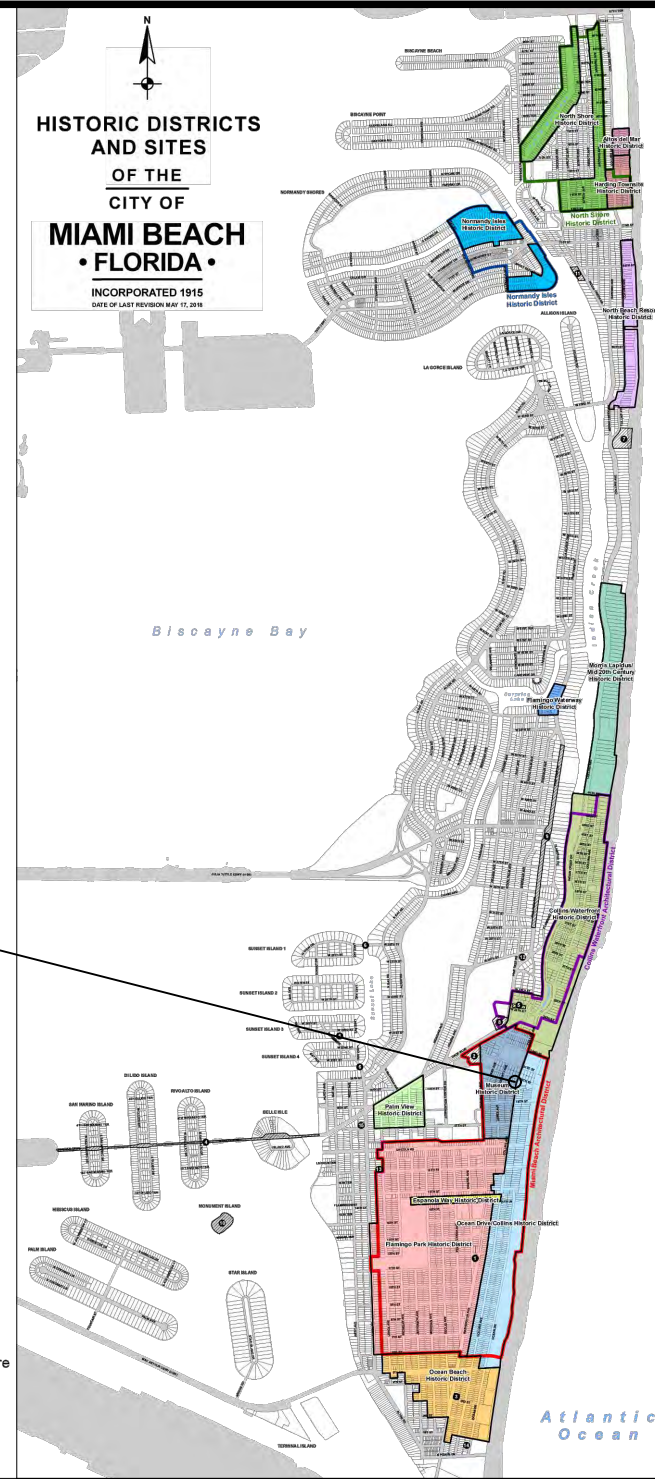

LEGEND AND ABBREVIATIONS	
	= PALM TREE
	= TREE
	= ORNAMENTAL TREE
O.R.B.	= OFFICIAL RECORDS BOOK
PG.	= PAGE
ELEV.	= ELEVATION
TYP.	= TYPICAL
CATV	= CABLE TELEVISION
OHE	= OVERHEAD ELECTRIC LINE
X 0.00	= SPOT ELEVATION
CONC.	= CONCRETE
C.B.S.	= CONCRETE BLOCK STUCCO
C.L.F.	= CHAIN LINK FENCE
W.F.	= WOOD FENCE
M.F.	= METAL FENCE
RCP	= REINFORCED CONCRETE PIPE
FF	= FINISH FLOOR
(R)	= RECORD
(C)	= CALCULATED
(M)	= MEASURE
LB	= LICENSE BUSINESS
L	= LENGTH
A	= CENTRAL ANGLE
R	= RADIUS
T	= TANGENT
PT	= POINT OF TANGENCY
PC	= POINT OF CURVATURE
STA.	= STATION
PI	= POINT OF INTERSECTION
ID	= IDENTIFICATION
MLP	= METAL LIGHT POLE
CLP	= CONCRETE LIGHT POLE
R/W	= RIGHT-OF-WAY
P.B.	= PLAT BOOK
	= SECTION LINE
	= CENTERLINE
	= BASELINE
	= MONUMENT LINE
	= TRAFFIC SIGNAL BOX
	= TRAFFIC SIGNAL CABINET
	= BOLLARD
	= PEDESTRIAN SIGNAL
	= TRAFFIC SIGNAL MAST ARM
	= SIGN
	= CABLE TELEVISION BOX
	= LIGHT POLE
	= ELECTRIC BOX
	= UTILITY POLE
	= ELECTRIC TRANSFORMER
	= GUY ANCHOR
	= ELECTRIC MANHOLE
	= ELECTRIC METER
	= GAS VALVE
	= GAS UTILITY BOX
	= GAS MANHOLE
	= GAS TANK
	= GAS METER
	= COMMUNICATION BOX
	= COMMUNICATION MANHOLE
	= GARBAGE RECEPTACLE
	= HANDICAP PARKING SPACE
	= WATER METER
	= IRRIGATION VALVE
	= WATER VALVE
	= FIRE HYDRANT
	= WATER BOX
	= WATER CONNECTION
	= WATER MANHOLE
	= WATER TANK
	= WATER WELL
	= WATER MARKING FLAG
	= WATER MARKING SIGN
	= STORM MANHOLE
	= STORM METER
	= CATCH BASIN
	= TELEPHONE MANHOLE
	= TELEPHONE BOX
	= NEWSPAPER DISPENSER
	= MAILBOX
	= SANITARY MANHOLE
	= SANITARY BOX
	= SANITARY TANK
	= SANITARY LIFT STATION
	= GREASE TRAP MANHOLE
	= CLEANOUT
	= PARKING METER
	= FIBER OPTIC BOX
	= FIBER OPTIC MARKER SIGN
	= MONITORING WELL
	= FUEL TANK
	= UNKNOWN UTILITY BOX
	= UNKNOWN UTILITY METER
	= UNKNOWN UTILITY MANHOLE
	= UNKNOWN UTILITY VALVE
	= UNKNOWN UTILITY MARKER FLAG
	= SANITARY VALVE
	= RAILROAD SIGN
	= FLAGPOLE
	= PROPERTY LINE
	= ELECTRICAL OUTLET

NOTES:

PROJECT LOCATION
MUSEUM HISTORIC DISTRICT

LOCAL HISTORIC DISTRICTS

	Espanola Way Historic District
	Altos del Mar Historic District
	Flamingo Park Historic District
	Ocean Drive/Collins Avenue Historic District
	Museum Historic District
	Ocean Beach Historic District
	Harding Townsite Historic District
	Palm View Historic District
	Collins Waterfront Historic District
	North Beach Resort Historic District
	Flamingo Waterway Historic District
	Morris Lapidus/Mid 20th Century Historic District
	North Shore Historic District
	Normandy Isles Historic District

NATIONAL REGISTER HISTORIC DISTRICTS

	Miami Beach Architectural District
	Normandy Isles Historic District
	North Shore Historic District
	Collins Waterfront Architectural District

LOCAL HISTORIC SITES

1	Old City Hall Historic Site
2	21st St Recreation Center Historic Site
3	Congregation Beth Jacob Historic Site
4	Venetian Causeway Historic Site
5	Miami Beach Woman's Club Historic Site
6	Sunset Island Bridges Historic Structures
7	The Bath Club Historic Site
8	Dade Blvd Fire Station Historic Site
9	PineTree Dr Historic Roadway
10	Flagler Memorial and Monument Island Historic Site
11	69th St Fire Station Historic Site
12	28th St Obelisk and Pumping Station Historic Structure
13	1600 Lenox Ave Historic Site
14	36 Ocean Dr Historic Site
15	1700 Alton Rd Historic Site

PROJECT DIRECTORY:

PROJECT NAME:
INTERACTIVE DIGITAL INFORMATION
KIOSKS DEPLOYMENT PROJECT

JURISDICTION:
CITY OF MIAMI
DEPARTMENT OF RESILIENCE AND
PUBLIC WORKS
MIAMI RIVERSIDE CENTER
444 S.W. 2nd AVENUE, 8th FLOOR
MIAMI, FLORIDA 33130
TEL: 305-416-1200

OWNER:
IKE SMART CITY
250 N HARTOFORD AVE
COLUMBUS, OH 43222
(614) 589-0087

ENGINEER OF RECORD:
MAINSTREET ENGINEERING
7035 SW 47 STREET, SUITE A
MIAMI, FL 33155
(305) 456-3505
PROJ. MGR: VANESSA MELA, P.E.
VMELA@MAINSTREETENG.COM

KIOSK MANUFACTURER:
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CONTACT: ERIC PERKINS
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WATER & SEWER: MIAMI-DADE
WATER & SEWAGE DEPARTMENT


TELEPHONE: AT&T

CABLE: COMCAST, XFINITY,
ATT-UVERSE

GAS: FLORIDA GAS

SIDEWALK & STREET SYMBOLS

	ASPHALT		BRICK
	PAVER		CONCRETE
	UNIMPROVED		TILE
	GRAVEL		STAMPED CONCRETE

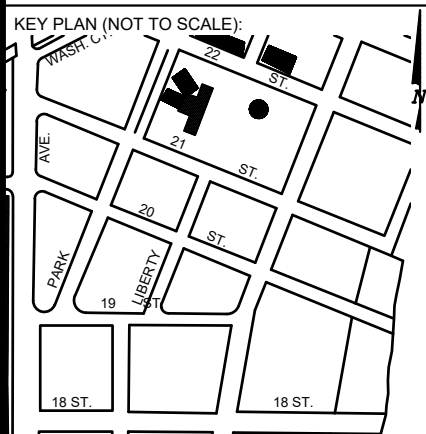

P.E. SEAL:

ADA NOTES

- ALL CONSTRUCTION ACTIVITIES SHALL BE COMPLETED IN FULL COMPLIANCE WITH THE AMERICANS WITH DISABILITIES ACT (ADA). CLEAR SPACES IN FRONT OF KIOSK SHALL HAVE THE FOLLOWING CHARACTERISTICS:
- SURFACES SHALL BE FIRM, STABLE, AND SLIP RESISTANT AND OTHERWISE COMPLY WITH PROWAG SECTION R302.7 AND SHALL HAVE A RUNNING SLOPE CONSISTENT WITH GRADE OF THE ADJACENT PEDESTRIAN ACCESS ROUTE AND CROSS SLOPE OF 1.50% +/-0.50%)
- SIZE: CLEAR SPACES SHALL BE 48" MINIMUM BY 48" MINIMUM.
- POSITION: UNLESS OTHERWISE SPECIFIED, CLEAR SPACES SHALL BE POSITIONED FOR EITHER FORWARD OR PARALLEL APPROACH TO THE KIOSK.
- APPROACH: ONE FULL UNOBSTRUCTED SIDE OF A CLEAR SPACE SHALL ADJOIN A PEDESTRIAN ACCESS ROUTE OR ADJOIN ANOTHER CLEAR SPACE.
- MANEUVERING SPACE: WHERE A CLEAR SPACE IS CONFINED ON ALL OR PART OF THREE SIDES, ADDITIONAL MANEUVERING SPACE SHALL BE PROVIDED AS FOLLOWS:
 - FORWARD APPROACH: THE CLEAR SPACE AND ADDITIONAL MANEUVERING SPACE SHALL BE 36" WIDE MINIMUM WHERE THE DEPTH OF THE CONFINING ELEMENT EXCEEDS 24".
 - PARALLEL APPROACH: THE CLEAR SPACE AND ADDITIONAL MANEUVERING SPACE SHALL BE 60" WIDE MINIMUM WHERE THE DEPTH OF THE CONFINING ELEMENT EXCEEDS 15".
- THE MINIMUM WHEELCHAIR PASSAGE WIDTH OR CLEAR SPACE WIDTH FOR A SINGLE WHEELCHAIR PASSAGE SHALL BE 48" PER PROWAG SECTION R302.3.
- INITIAL OPERATION FOR THE KIOSK WILL HAVE 4G LTE CONNECTION SECTION R404. TO THE INTERNET.
- THE KIOSKS HAVE BEEN DESIGN TO COMPLY WITH ALL ADA GUIDELINES INCLUDING VIEWING, OPERATION, AND ACCESSIBILITY.
- THE MOBILE IKE EXPERIENCE WILL FOLLOW WEB CONTENT ACCESSIBILITY GUIDELINES (WCAG) TO WORK IN TANDEM WITH THE NATIVE ACCESSIBILITY FEATURES ON THE USER'S MOBILE DEVICE, INCLUDING TALKBACK AND VOICEOVER TOOLS.

SCOPE OF WORK

THE PROJECT CONSIST OF THE INSTALLATION OF ONE (1) DIGITAL INTERACTIVE KIOSKS AT THE LOCATION(S) INDICATED ON THIS PLANS SET. INSTALLER SHALL PROVIDE AND INCLUDE ALL WORKMANSHIP AND MATERIALS NECESSARY TO COMPLETE THE INSTALLATION INCLUDING BUT NOT LIMITED TO:


- INSTALLATION OF THE KIOSKS TO THE FOUNDATION AS INDICATED ON PLANS TO NEW RECTANGULAR CONCRETE FOUNDATION.
- ELECTRICAL SERVICE POINTS ARE EXISTING. CONNECT THE EXISTING ELECTRIC SERVICE TO THE NEW KIOSK AS INDICATED ON PLANS.
- TESTING OF THE ELECTRICAL SERVICE INFRASTRUCTURE SHALL BE PERFORMED IN CONJUNCTION WITH A REPRESENTATIVE OF THE ENGINEER OF RECORD.
- THE CONTRACTOR SHALL INSTALL THE KIOSK IN SUCH A WAY THAT THE KIOSK IS WITHIN THE PUBLIC R.O.W. AND IN COMPLIANCE WITH ALL APPLICABLE A.D.A. REQUIREMENTS
- THE LOCATION OF KIOSKS HAS BEEN COORDINATE TO ENSURE THERE IS NO OBSTRUCTION OF THE SIGHT OF VEHICULAR SIGNS.
- STAND-ALONE PEDESTRIAN KIOSKS SHOULD NOT BE INSTALLED WITHIN PEDESTRIAN CIRCULATION PATHS IN A MANNER THAT PERSONS AT THE KIOSK LOCK THE EFFECTIVE WIDTH OF THE PEDESTRIAN TRAVEL WAY.

MONUMENT SIGN SPECIFICATIONS AND FUNCTIONS


THE UNIT CONSISTS OF A UL/NRTL LISTED WEATHER AND VANDAL RESISTANT FREE STANDING ENCLOSURE DESIGNED TO COMPLY WITH THE FLORIDA BUILDING CODE AND OTHER APPLICABLE CODES INCLUDING THE NATIONAL ELECTRICAL CODE. THE UNIT HAS BEEN DESIGNED TO WITHSTAND WINDS OF 165 MPH. THE UNIT'S MAIN COMPONENTS ARE:

- TWO (2) INTERACTIVE 65" VIDEO TOUCH SCREENS.
- TWO (2) CAMERAS
- ONE (1) CPU
- ONE (1) WI-FI TRANSMITTER

MANUFACTURER: DYNASCAN MODEL NUMBER: CIO651DR5
 NATIVE RESOLUTION: 1920 X 1080
 ELECTRICAL POWER REQUIREMENT:
 1. ONE-2-POLE, 20 AMP, 240 VOLTS CIRCUIT.
 2. TOTAL LOAD: 1400/2200 WATTS (OPERATIONAL/PEAK)
 3. VOLTAGE: 100-240 VOLTS AC, 50-60 HZ
 WEIGHT: 832 LBS
 CERTIFICATION CE / FCC / RoHS

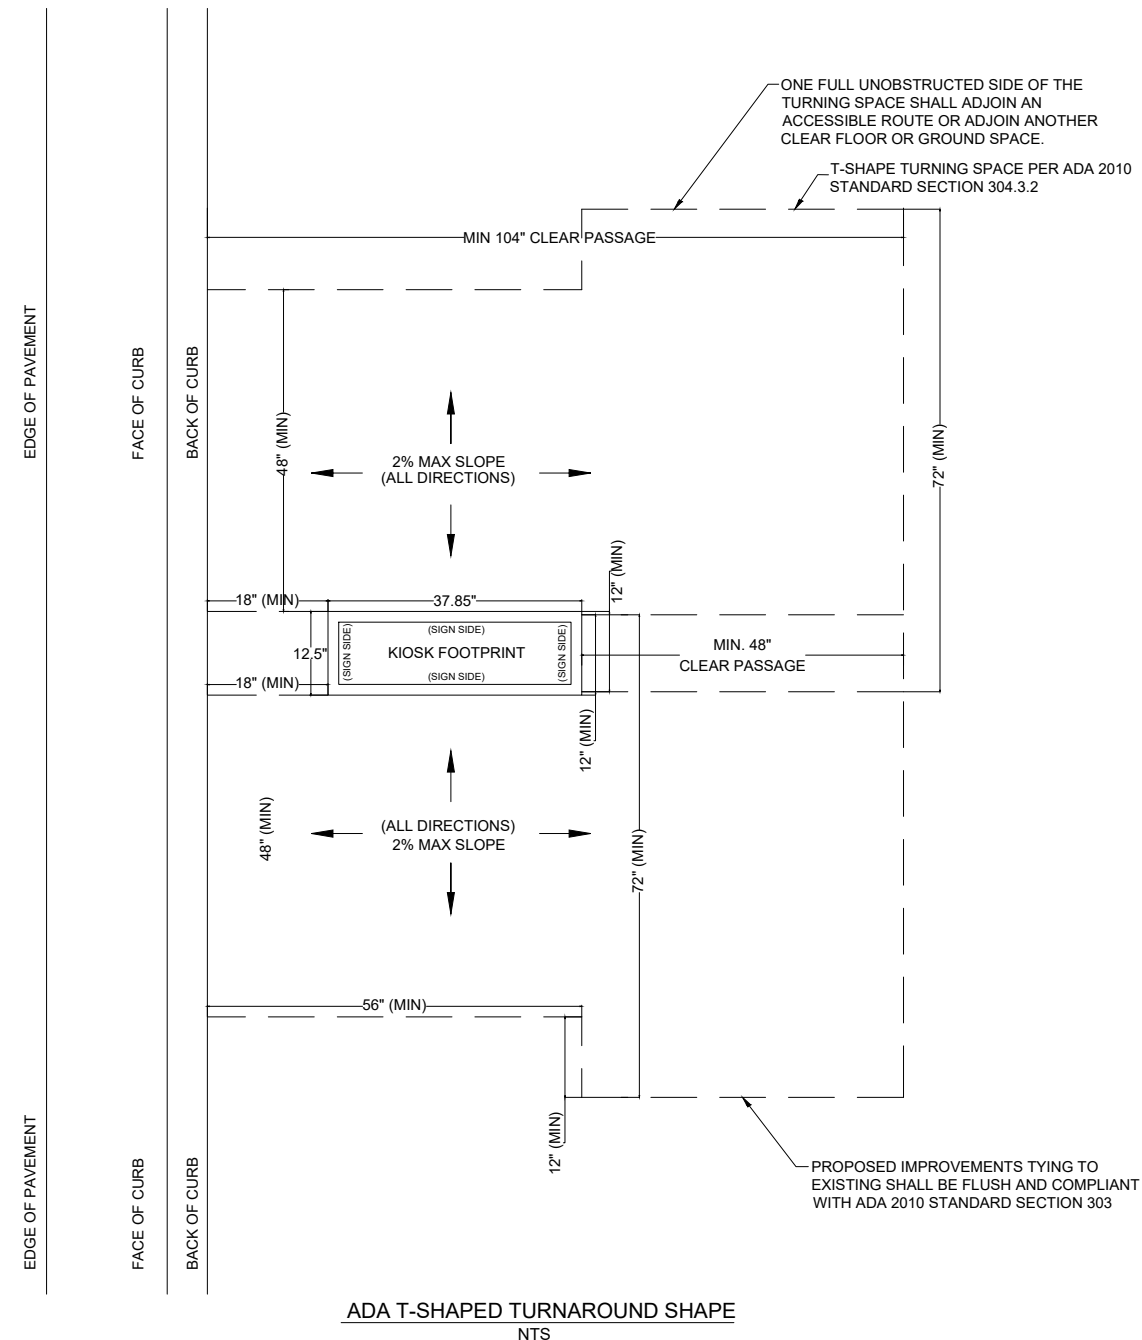

NOTES:

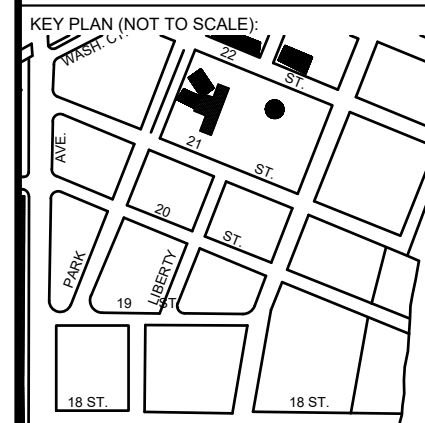

P.E. SEAL:

MIAMI BEACH
 PUBLIC WORKS DEPARTMENT
 1700 CONVENTION CENTER DRIVE, MIAMI BEACH, FL 33139

CITY MANAGER: ALINA T. HUDAK
 DIRECTOR: JOE GOMEZ, P.E.
 CITY ENGINEER: CRISTINA ORTEGA CASTINEIRAS, P.E.

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NO.	DATE	REVISION	APP'D. BY



Main Street ENGINEERING
 7035 SW 47th Street, Ste A, Miami, FL 33155
 Tel: (305) 466-3055, Fax: (305) 476-8994
 FL PE Certificate No: 00008751

ENGINEER OF RECORD:
 VANESSA A. MELA,
 P.E. NO. 77676


ENGINEER OF RECORD: VM
 DESIGN ENGINEER: VM
 DRAWN BY: KM
 CHECKER: WP
 SCALE:

NEIGHBORHOOD:
MIB-021: COLLINS AVENUE & 20TH STREET
 TITLE:
ADA NOTES, SCOPE OF WORK & KIOSK SPECIFICATIONS


File Name: MIB-021-GENERAL AND FOUNDATION.dwg
 Survey Reference:
 Field Book: N/A Page: N/A Work Order: N/A
 Date: 10/09/2023 Sheet: 2 of 6 Drawing: G0-04

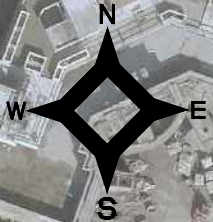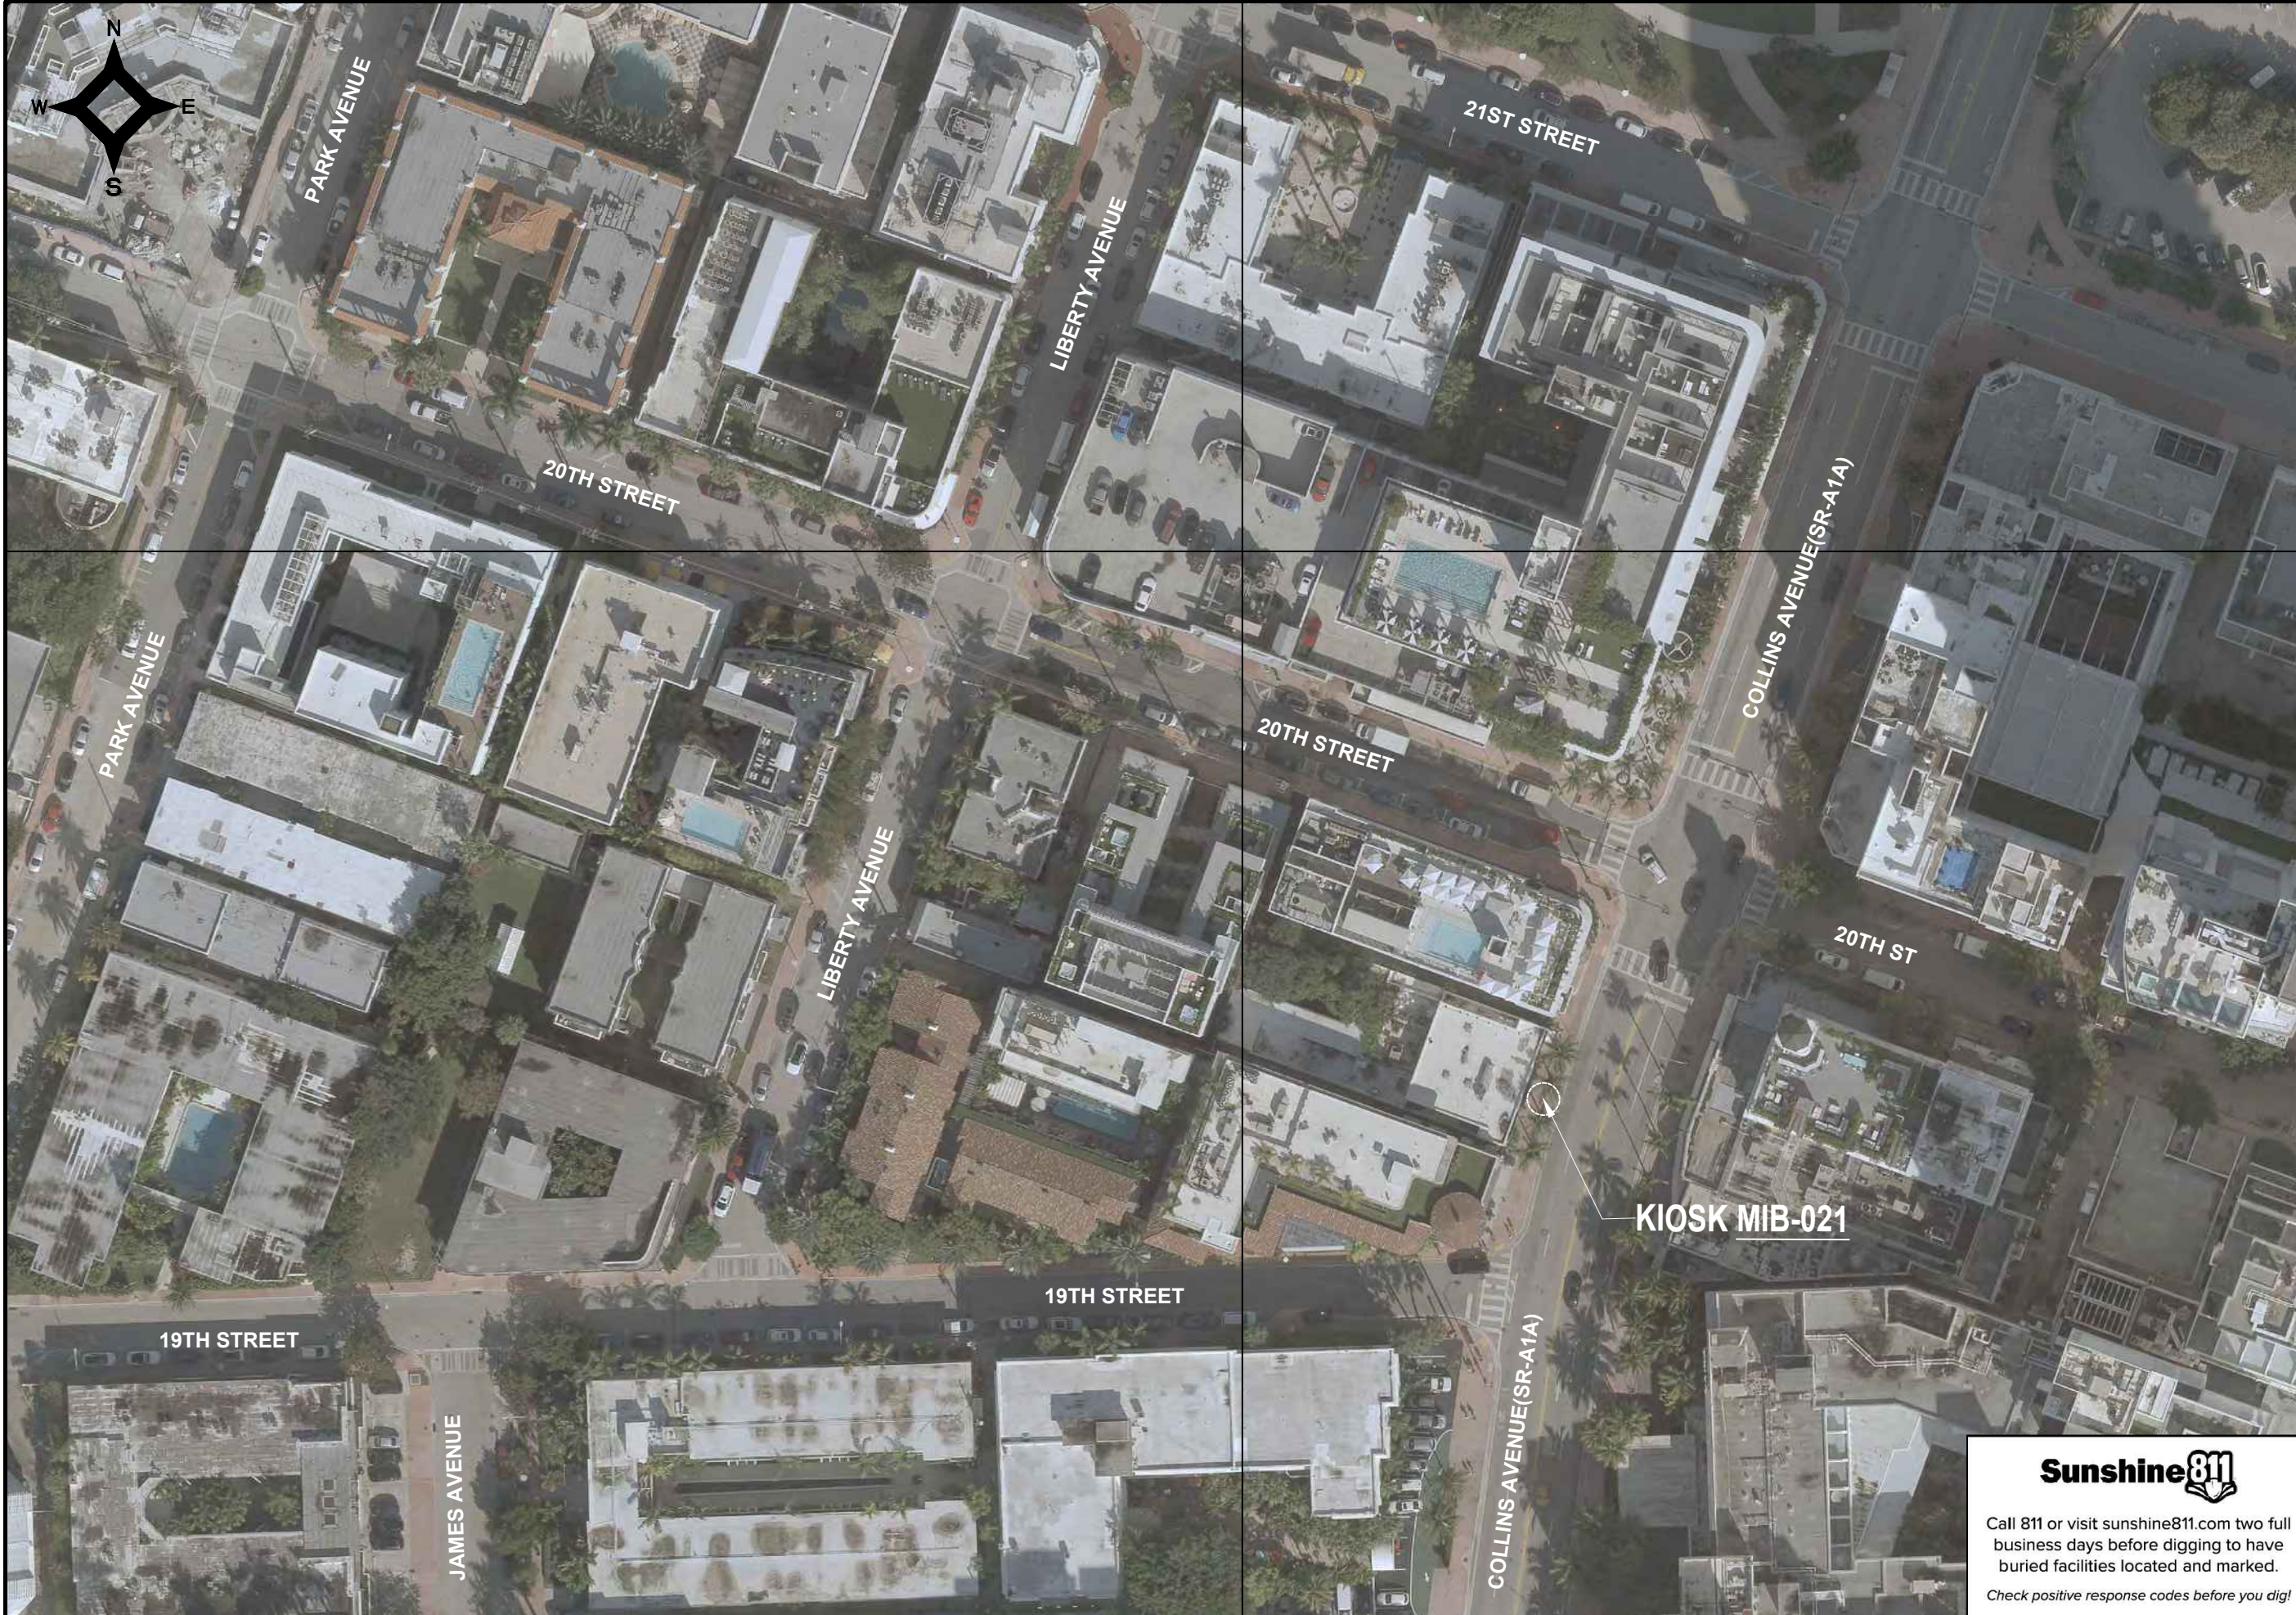

NOTES:

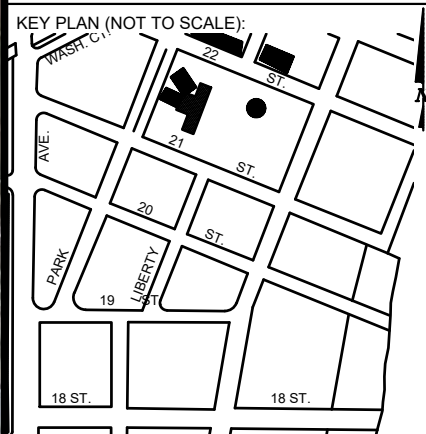

P.E. SEAL:

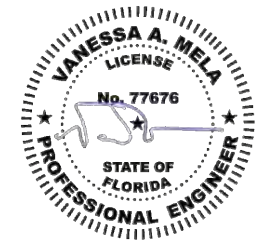

Sunshine811
 Call 811 or visit sunshine811.com two full business days before digging to have buried facilities located and marked.
 Check positive response codes before you dig!

MIAMI BEACH
 PUBLIC WORKS DEPARTMENT
 1700 CONVENTION CENTER DRIVE, MIAMI BEACH, FL 33139

CITY MANAGER: ALINA T. HUDAK
 DIRECTOR: JOE GOMEZ, P.E.
 CITY ENGINEER: CRISTINA ORTEGA CASTINEIRAS, P.E.

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NO.	DATE	REVISION	APP'D. BY

7035 SW 47th Street, Ste A, Miami, FL 33155
 Tel: (305) 456-3025 Fax: (305) 476-8884
 FL PE Certificate No: 00006751


ENGINEER OF RECORD: VANESSA A. MELA, P.E. No. 77676
 ENGINEER OF RECORD: VM
 DESIGN ENGINEER: VM
 DRAWN BY: KM
 CHECKER: WP
 SCALE:

NEIGHBORHOOD: MIB-021: COLLINS AVENUE & 20TH STREET
 TITLE: CIVIL SITE PLAN





File Name: MIB-021-CIVIL PLANS.dwg
 Survey Reference:
 Field Book: N/A Page: N/A Work Order: N/A
 Date: 10/09/2023 Sheet: 3 of 6 Drawing: C1-01

Call 811 or visit sunshine811.com two full business days before digging to have buried facilities located and marked. Check positive response codes before you dig!

NOTES:

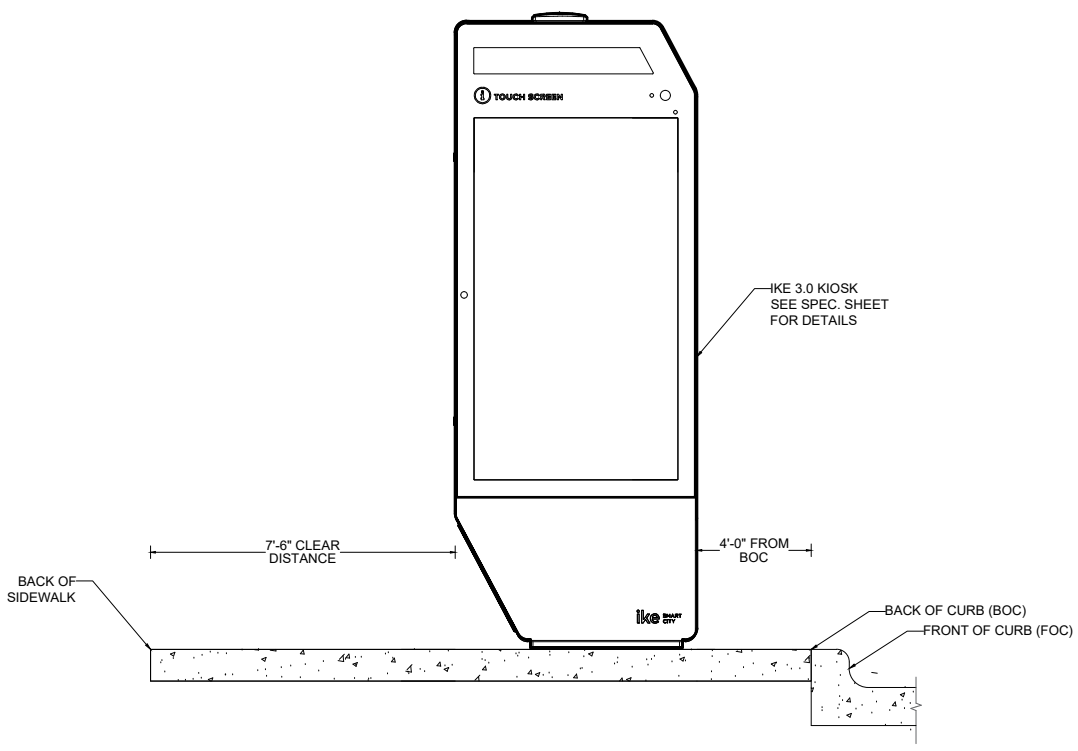

VISIBILITY TRIANGLE CLEARANCE ANALYSIS
SCALE: 1'-30"

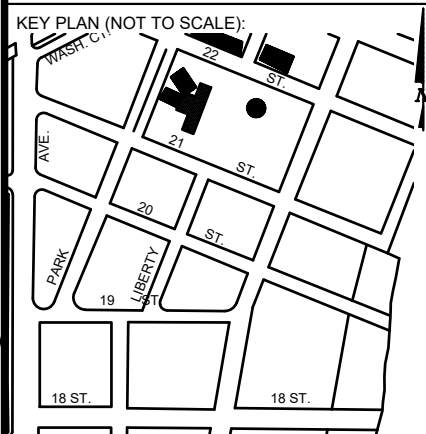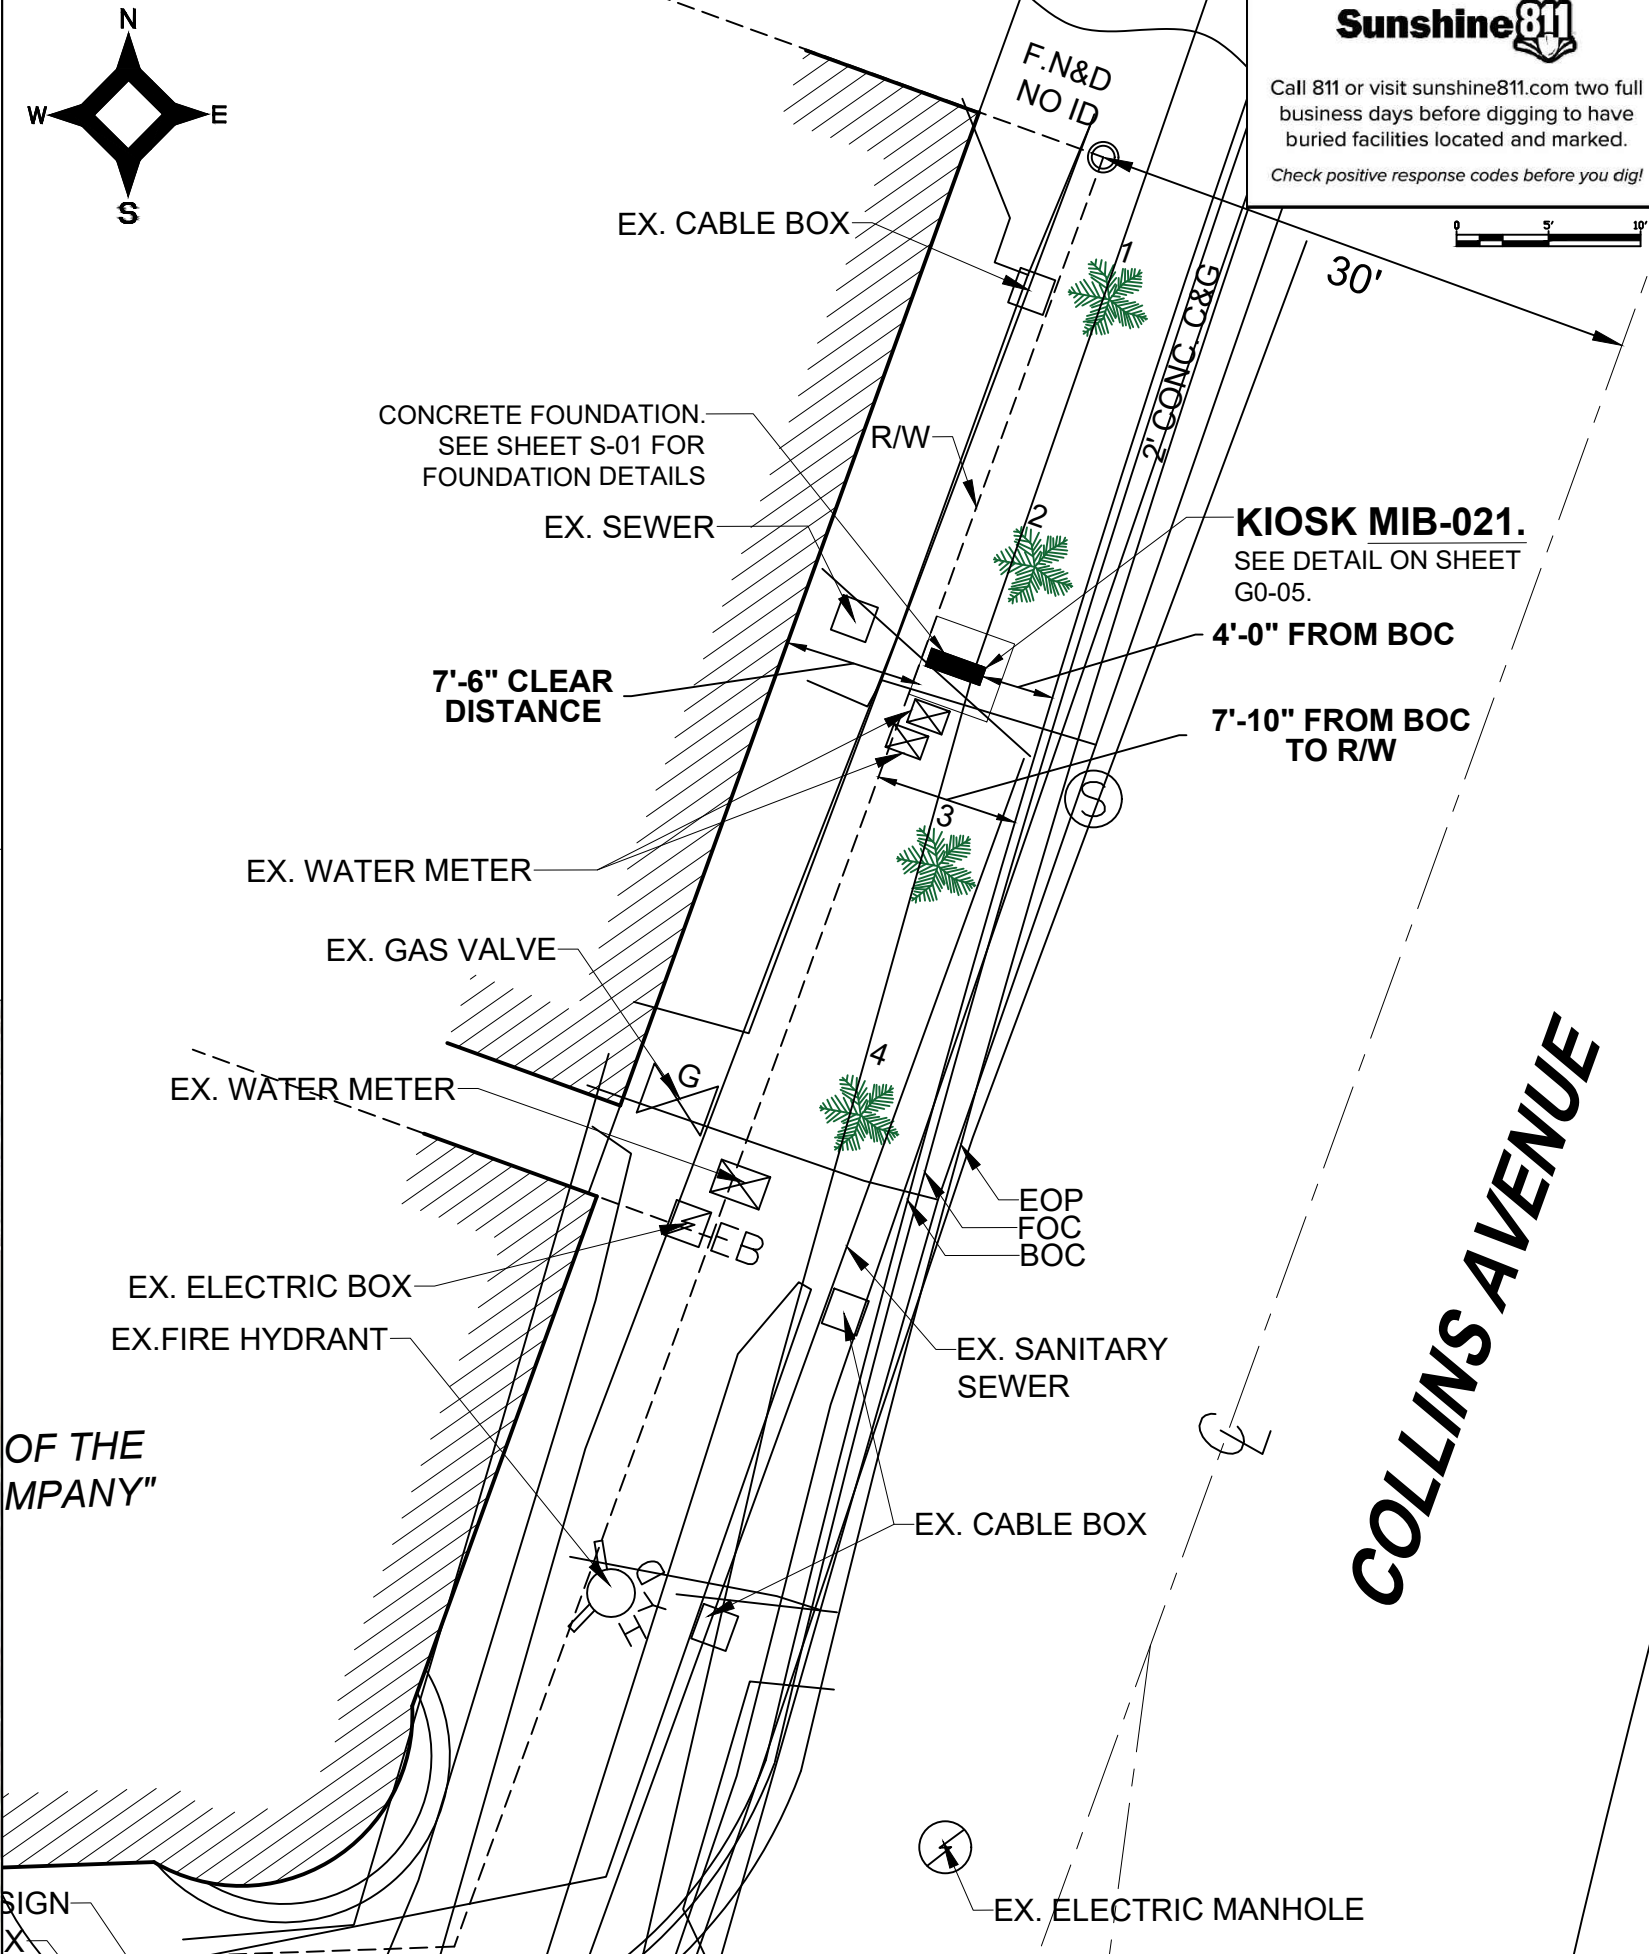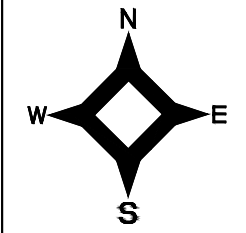
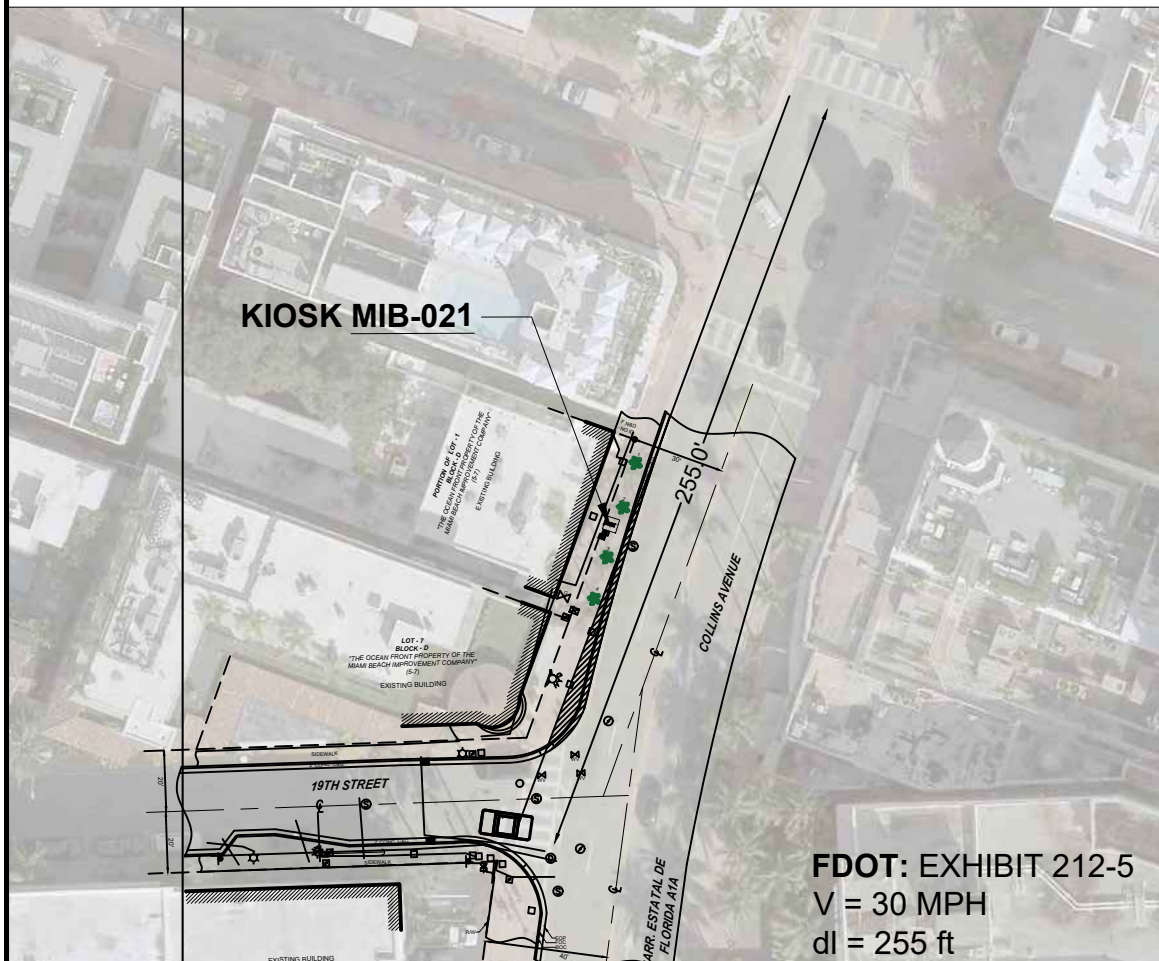


P.E. SEAL:

VANESSA A. MELA
LICENSE
No. 77676
STATE OF FLORIDA
PROFESSIONAL ENGINEER


NO.	DATE	REVISION	APP'D. BY
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NOTES:

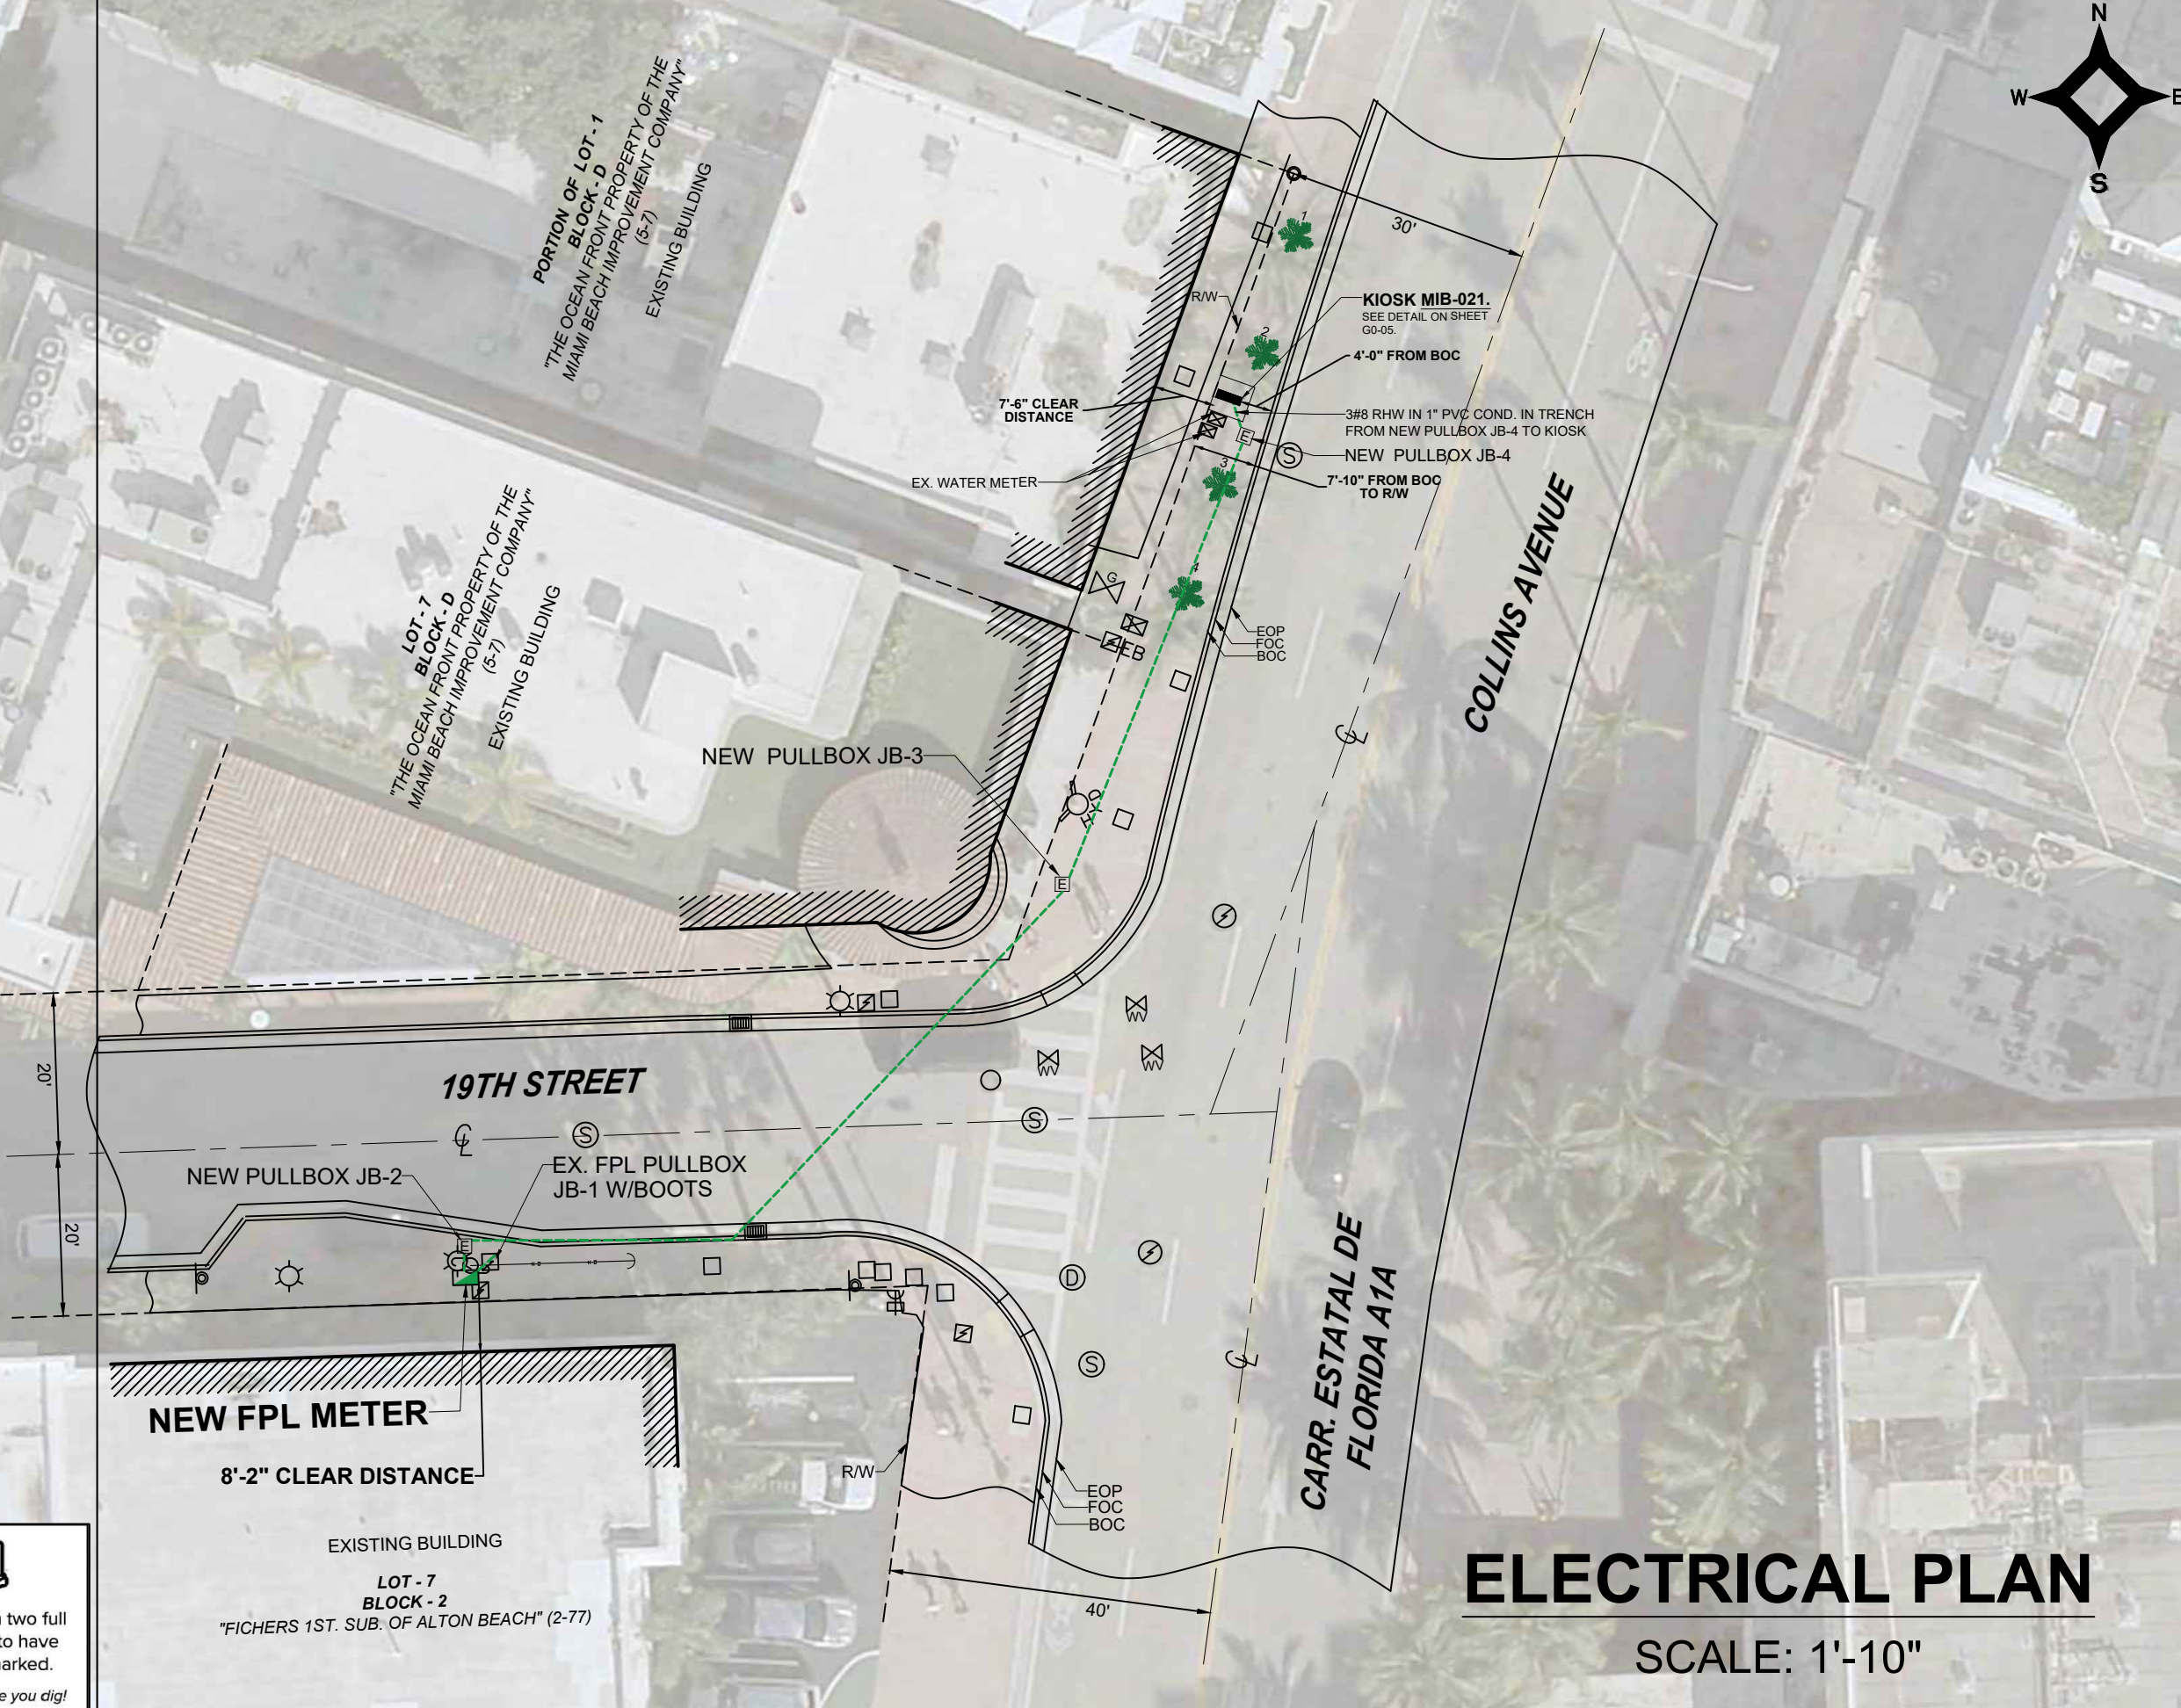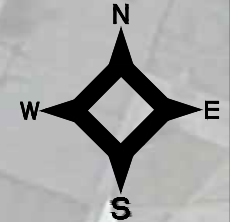


ELECTRICAL PLAN

SCALE: 1'-10"

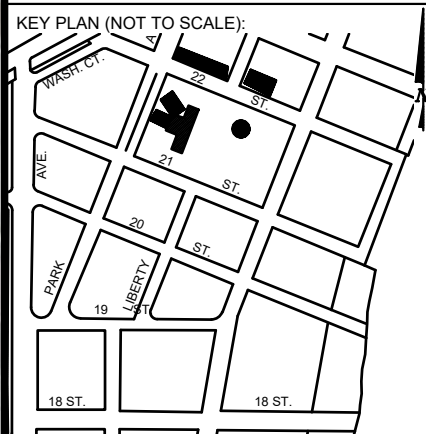

P.E. SEAL:

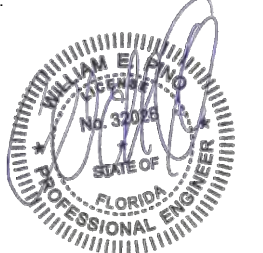

Sunshine811
 Call 811 or visit sunshine811.com two full business days before digging to have buried facilities located and marked.
 Check positive response codes before you dig!

EXISTING BUILDING
 LOT - 7
 BLOCK - 2
 "FICHERS 1ST. SUB. OF ALTON BEACH" (2-77)

MIAMI BEACH
 PUBLIC WORKS DEPARTMENT
 1700 CONVENTION CENTER DRIVE, MIAMI BEACH, FL 33139

CITY MANAGER: ALINA T. HUDAK
 DIRECTOR: JOE GOMEZ, P.E.
 CITY ENGINEER: CRISTINA ORTEGA CASTINEIRAS, P.E.

5			
4			
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NO.	DATE	REVISION	APP'D. BY

MainStreet ENGINEERING
 7035 SW 47th Street, Ste A, Miami, FL 33155
 Tel: (305) 406-3055 Fax: (305) 478-8884
 FL PE Certificate No: 00008751

ENGINEER OF RECORD: WILLIAM E. PINO, P.E. NO. 32028
 ENGINEER OF RECORD: WP
 DESIGN ENGINEER: WP
 DRAWN BY: KM
 CHECKER: WP
 SCALE: 1"=10'

NEIGHBORHOOD: MIB-021: COLLINS AVENUE & 20TH STREET
 TITLE: KIOSK MIB-021 ELECTRICAL PLAN

File Name: MIB-021-ELECTRICAL & TTC PLANS.dwg
 Survey Reference:
 Field Book: N/A Page: N/A Work Order: N/A
 Date: 10/09/2023 Sheet: 5 of 6 Drawing: E1-01

Survey Pros, Inc.

4348 SW 74TH AVENUE, MIAMI, FL. 33155

Tel: 305.767.6802

www.survey-pros.com

MAP OF SPECIFIC PURPOSE TOPOGRAPHIC & TREE SURVEY

OF A PORTION OF
"COLLINS AVENUE" AND "19TH STREET"
CITY OF MIAMI BEACH, FL.
PLAT OF "THE OCEAN FRONT PROPERTY OF THE MIAMI BEACH IMPROVEMENT COMPANY"
PLAT BOOK 5, PAGE 7, MDCR ; AND
PLAT OF "FICHERS 1ST. SUB. OF ALTON BEACH"
PLAT BOOK 2, PAGE 77, MDCR

LEGEND

ABBREVIATIONS:

- A = ARC DISTANCE
- AC = AIR CONDITIONER PAD
- BCR = BROWARD COUNTY RECORDS
- BLDG = BUILDING
- BM = BENCH MARK
- BOB = BASIS OF BEARINGS
- CBS = CONCRETE BLOCK & STUCCO
- (C) = CALCULATED
- C&G = CURB & GUTTER
- CLF = CHAIN LINK FENCE
- COL = COLUMN
- D.E. = DRAINAGE EASEMENT
- D.M.E. = DRAINAGE & MAINTENANCE EASEMENT
- D/W = DRIVEWAY
- EB = ELECTRIC BOX
- ENC. = ENCROACHMENT
- EP = EDGE OF PAVEMENT
- EW = EDGE OF WATER
- FDH = FOUND DRILL HOLE
- FPE = FINISHED FLOOR ELEVATION
- FIP = FOUND IRON PIPE (NO ID)
- FIR = FOUND IRON ROD (NO ID)
- FN = FOUND NAIL (NO ID)
- FPL = FLORIDA POWER & LIGHT TRANSFORMER PAD
- L.E. = LANDSCAPE EASEMENT
- L.M.E. = LAKE MAINTENANCE EASEMENT
- (M) = MEASURED
- MDCR = MIAMI-DADE COUNTY RECORDS
- MH = MAN HOLE
- ML = MONUMENT LINE
- (P) = PLAT
- PB = PLAT BOOK
- PC = POINT OF CURVATURE
- PCP = PERMANENT CONTROL POINT
- PE = POOL EQUIPMENT PAD
- PG = PAGE
- PI = POINT OF INTERSECTION
- PL = PLANTER
- POB = POINT OF BEGINNING
- POC = POINT OF COMMENCEMENT
- PRC = POINT OF REVERSE CURVATURE
- PRM = PERMANENT REFERENCE MONUMENT
- PT = POINT OF TANGENCY
- R = RADIUS DISTANCE
- (R) = RECORD
- R/W = RIGHT-OF-WAY
- RES = RESIDENCE
- SIP = SIP LB#8023
- SND = SET NAIL & DISK LB#8023
- STL = SURVEY TIE LINE
- SWK = SIDEWALK
- (TYP) = TYPICAL
- UB = UTILITY BOX
- U.E. = UTILITY EASEMENT
- W/F = WOOD FENCE

TREE TABLE:

NO	COMMON NAME	DBH(Ø)	HEIGHT	CANOPY
1	PALM	10"	27'	12'
2	PALM	10"	27'	12'
3	PALM	12"	27'	12'
4	PALM	12"	27'	12'

IN CASE OF A DISPUTE AN ARBORIST REPORT WILL GOVERN.


SYMBOLS:

- = COMMUNICATION LINE
- = ELECTRIC LINE
- = UNKNOWN
- = STORM LINE
- = WATER LINE
- = SANITARY LINE

SYMBOLS:


- = TELEPHONE RISER
- = CABLE TV RISER
- = WATER METER
- X 0.00 = ELEVATION
- (00°) = ORIGINAL LOT DISTANCE
- Δ = CENTRAL ANGLE
- ⊙ = CENTER LINE
- = WATER VALVE
- = CURB INLET
- = FIRE HYDRANT
- = LIGHT POLE
- = CATCH BASIN
- = UTILITY POLE
- = DRAINAGE MANHOLE
- = SEWER MANHOLE
- = SIGN
- = GAS VALVE
- = METAL FENCE
- = WOOD FENCE
- = CHAIN LINK FENCE
- = EASEMENT
- = BOUNDARY LINE
- = OVERHEAD UTILITY LINE
- = ORIGINAL LOT LINE
- ASPHALT
- CONCRETE
- PAVERS/BRICK
- TILES
- COVERED AREA

GRAPHIC SCALE

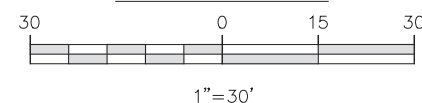


BENCHMARK INFORMATION:

NAME: D-166
 ELEVATION: 7.27'(NGVD29)
 LOCATION 1: VENETIAN CSWY --- 20' NORTH OF C/L
 LOCATION 2: BELLE ISLE EAST BRIDGE ---
 DESCRIPTION: PK NAIL AND BRASS WASHER IN CONCRETE SIDEWALK AT NE CORNER OF BRIDGE #874481

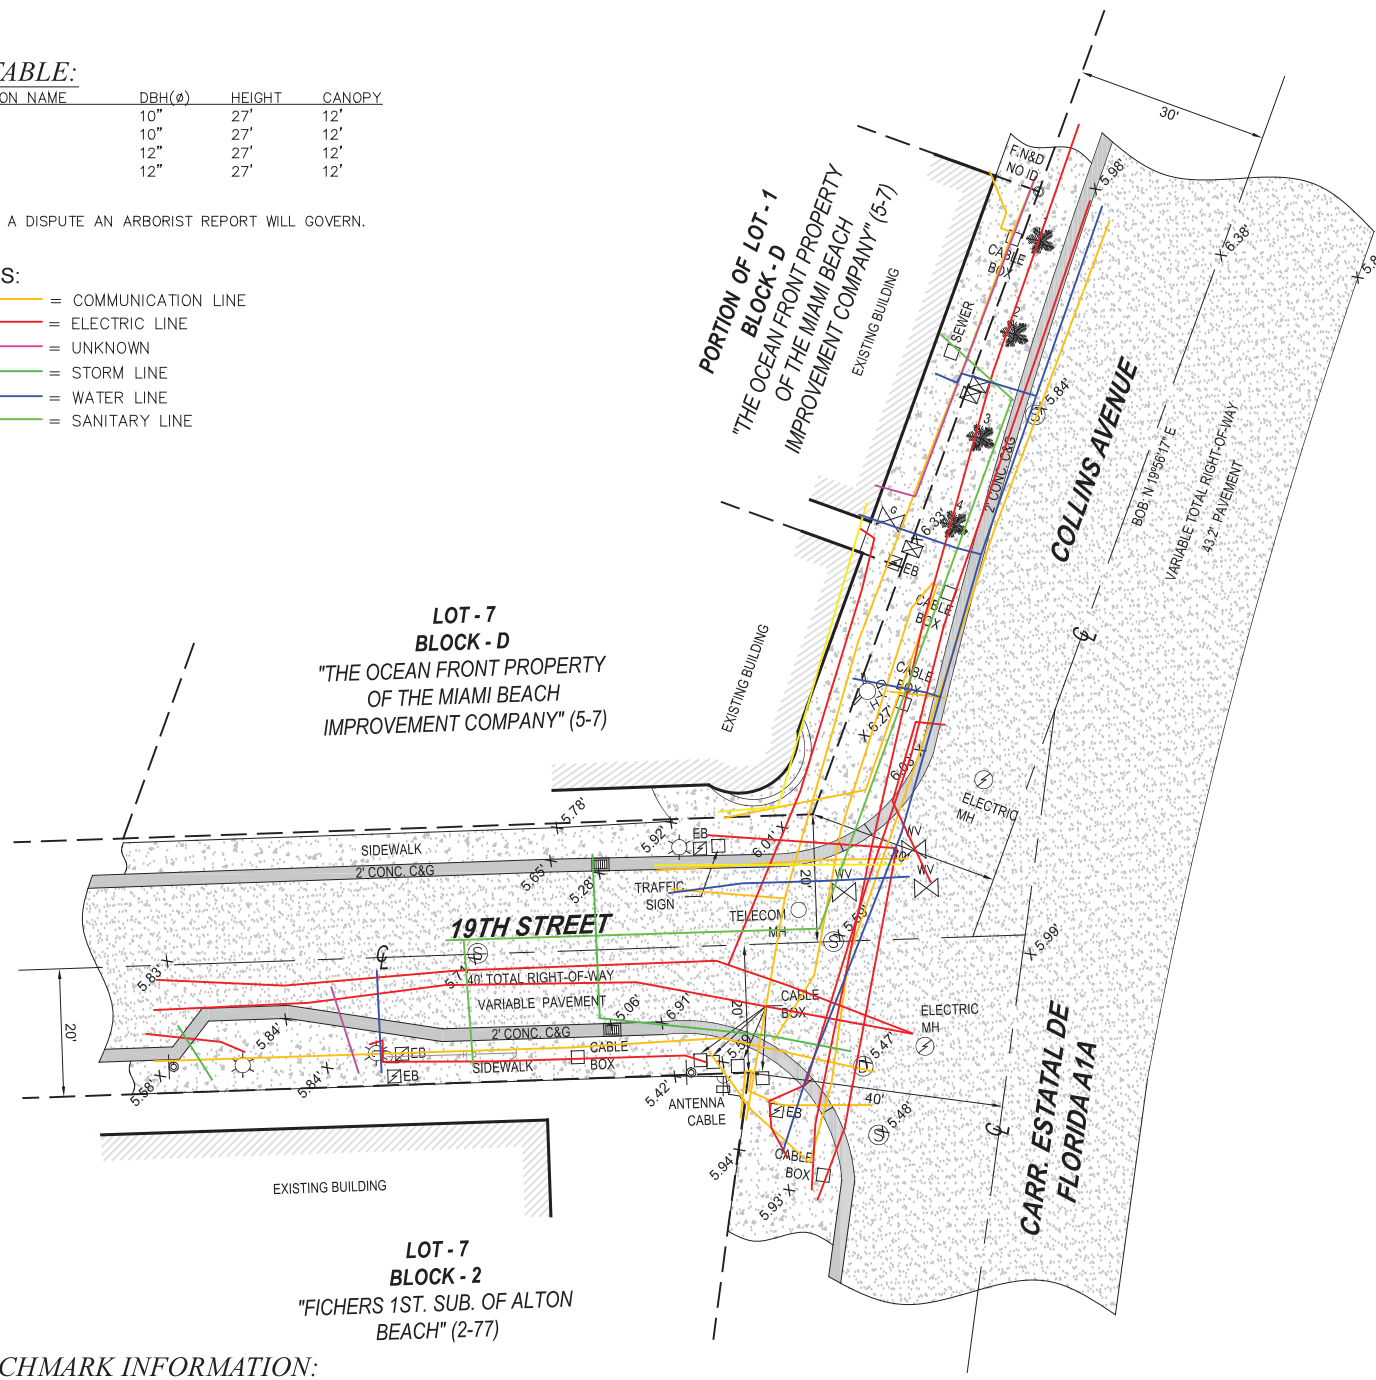

LOCATION SKETCH:

NOT TO SCALE

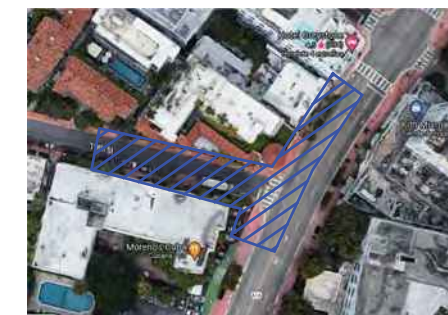

FLOOD ZONE INFORMATION:

THE GRAPHICALLY DEPICTED BUILDING(S) SHOWN ON THIS MAP OF SURVEY IS WITHIN ZONE AE, BASE FLOOD ELEVATION 8.
 COMMUNITY NAME & NUMBER CITY OF MIAMI BEACH 120651
 MAP & PANEL NUMBER 12086C0317 SUFFIX L

SURVEYOR'S NOTES:

1. ELEVATIONS WHEN SHOWN REFER TO 1929 NATIONAL GEODETIC VERTICAL DATUM (NGVD 1929).
2. NO ATTEMPT WAS MADE TO LOCATE FOOTINGS/FOUNDATIONS, OR UNDERGROUND UTILITIES UNLESS OTHERWISE NOTED.
3. THE LANDS SHOWN HEREON HAVE NOT BEEN ABSTRACTED IN REGARDS TO MATTERS OF INTEREST BY OTHER PARTIES, SUCH AS EASEMENTS, RIGHTS OF WAYS, RESERVATIONS, ETC. ONLY PLATTED EASEMENTS ARE SHOWN.
4. THIS SURVEY WAS PREPARED FOR AND CERTIFIED TO THE PARTY(IES) INDICATED HEREON AND IS NOT TRANSFERABLE OR ASSIGNABLE WITHOUT WRITTEN CONSENT OF THIS FIRM.
5. ALL BOUNDARY LIMIT INDICATORS SET ARE STAMPED LB#8023.
6. THE BOUNDARY LIMITS ESTABLISHED ON THIS SURVEY ARE BASED ON THE LEGAL DESCRIPTION PROVIDED BY THE CLIENT OR ITS REPRESENTATIVE.
7. FENCE OWNERSHIP IS NOT DETERMINED. DIMENSIONS ARE TO THE INTERIOR PORTION OF THE FENCE.
8. ADDITIONS OR DELETIONS TO THIS SURVEY MAP AND/OR REPORT BY SOMEONE OTHER THAN THE SIGNING PARTY(IES) IS PROHIBITED WITHOUT WRITTEN CONSENT OF THE SIGNING PARTY(IES).
9. THIS SURVEY IS NOT VALID WITHOUT THE ORIGINAL SIGNATURE AND RAISED SEAL OF A FLORIDA LICENSED SURVEYOR AND MAPPER. OTHERWISE THIS MAP IS FOR INFORMATIONAL PURPOSES ONLY.
10. BEARINGS WHEN SHOWN ARE TO AN ASSUMED MERIDIAN AND BASED ON PLAT. THE CENTERLINE OF COLLINS AVENUE BEARS N 19°56'17" E.

SURVEYOR'S CERTIFICATION:

I HEREBY CERTIFY THAT THIS SURVEY IS TRUE AND CORRECT TO THE BEST OF MY KNOWLEDGE AND BELIEF AS RECENTLY SURVEYED AND DRAWN UNDER MY DIRECTION AND MEETS THE MINIMUM TECHNICAL STANDARDS SET FORTH BY THE FLORIDA STATE BOARD OF SURVEYORS AND MAPPERS IN CHAPTER 5J-17 FLORIDA ADMINISTRATIVE CODE PURSUANT TO SECTION 472.027 FLORIDA STATUTE.

CERTIFIED TO:

MAIN STREET ENGINEERING

SEAL

DATE OF ORIGINAL FIELD WORK:
09/07/2023

JOB NUMBER: 23099919

DRAWN BY: ADRIEL

CAD FILE: MAIN STREET ENGINEERING

SHEET 1 OF 1

REVISION(S):

NICOLAS DEL VENTO
 PROFESSIONAL SURVEYOR & MAPPER
 STATE OF FLORIDA LIC. # 6945

4. Collins Ave & 20th Street



MIAMI BEACH

PUBLIC WORKS DEPARTMENT LINCOLN ROAD & WASHINGTON AVENUE INTERACTIVE DIGITAL KIOSK DEPLOYMENT PROJECT OCTOBER 2023 IKE SMART CITY MIB-004

CITY OF MIAMI BEACH

MAYOR: DAN GELBER


COMMISSIONERS: MICKY STEINBERG
MARK SAMUELIAN
MICHAEL GONGORA
STEVEN MEINER
RICKEY ARRIOLA
DAVID RICHARDSON

CITY MANAGER: ALINA T. HUDAK

CITY ATTORNEY: RAFAEL A. PAZ

PUBLIC WORKS DIRECTOR: JOE GOMEZ, P.E., F.FES

CITY ENGINEER: NELSON PEREZ-JACOME, PE

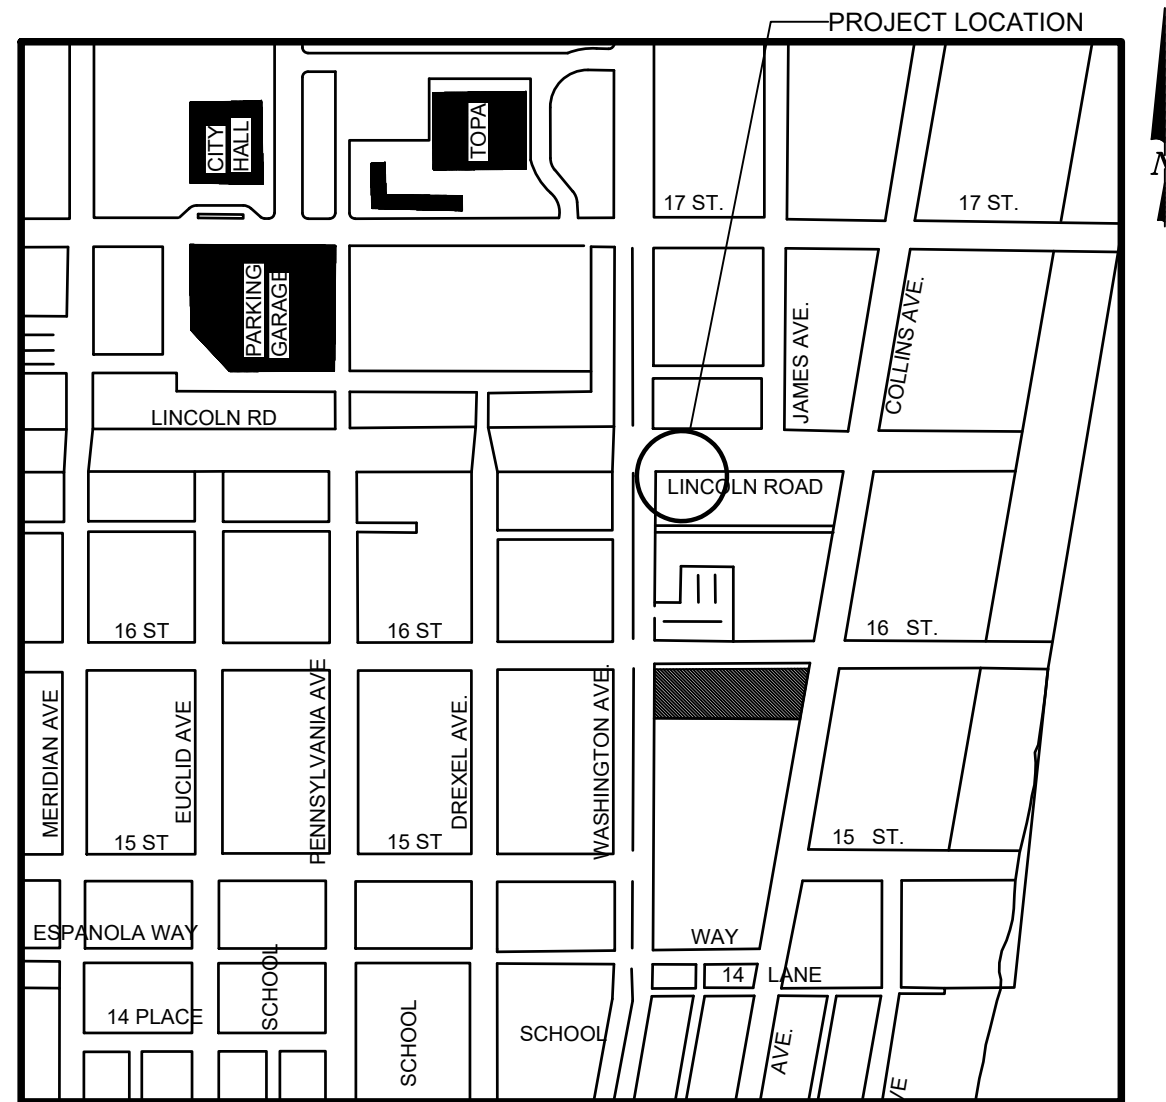

LOCATION MAP



INDEX OF PLANS

NUMBER	DISCIPLINE	SHEET NO.	DESCRIPTION	NOTES
1	GENERAL	G0-03	INDEX OF SHEETS	
2	GENERAL	G0-04	ADA NOTES, SCOPE OF WORK & KIOSK SPECIFICATIONS	
3	CIVIL	C1-01	CIVIL SITE PLAN	
4	CIVIL	C1-02	KIOSK MIB-004 ENGINEERING PLAN	
5	ELECTRICAL	E1-01	KIOSK MIB-004 ELECTRICAL PLAN	
6	SURVEY		KIOSK MIB-004 SITE SURVEY	

SCOPE OF WORK: THE PROJECT CONSISTS OF THE INSTALLATION OF ONE (1) DIGITAL INTERACTIVE KIOSK AND APPLICABLE INFRASTRUCTURE; STRUCTURAL FOUNDATION AND ELECTRICAL SERVICE AT THE LOCATION INDICATED ON THESE DESIGN PLANS.


FINAL SUBMITTAL 10/09/2023

Always call 811 two full business days before you dig to have underground utilities located and marked.



INDEX OF PLANS

NUMBER	DISCIPLINE	SHEET NO.	DESCRIPTION	NOTES
1	GENERAL	G0-03	INDEX OF SHEETS	
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4	CIVIL	C1-02	KIOSK MIB-004 ENGINEERING PLAN	
5	ELECTRICAL	E1-01	KIOSK MIB-004 ELECTRICAL PLAN	
6	SURVEY		KIOSK MIB-004 SITE SURVEY	

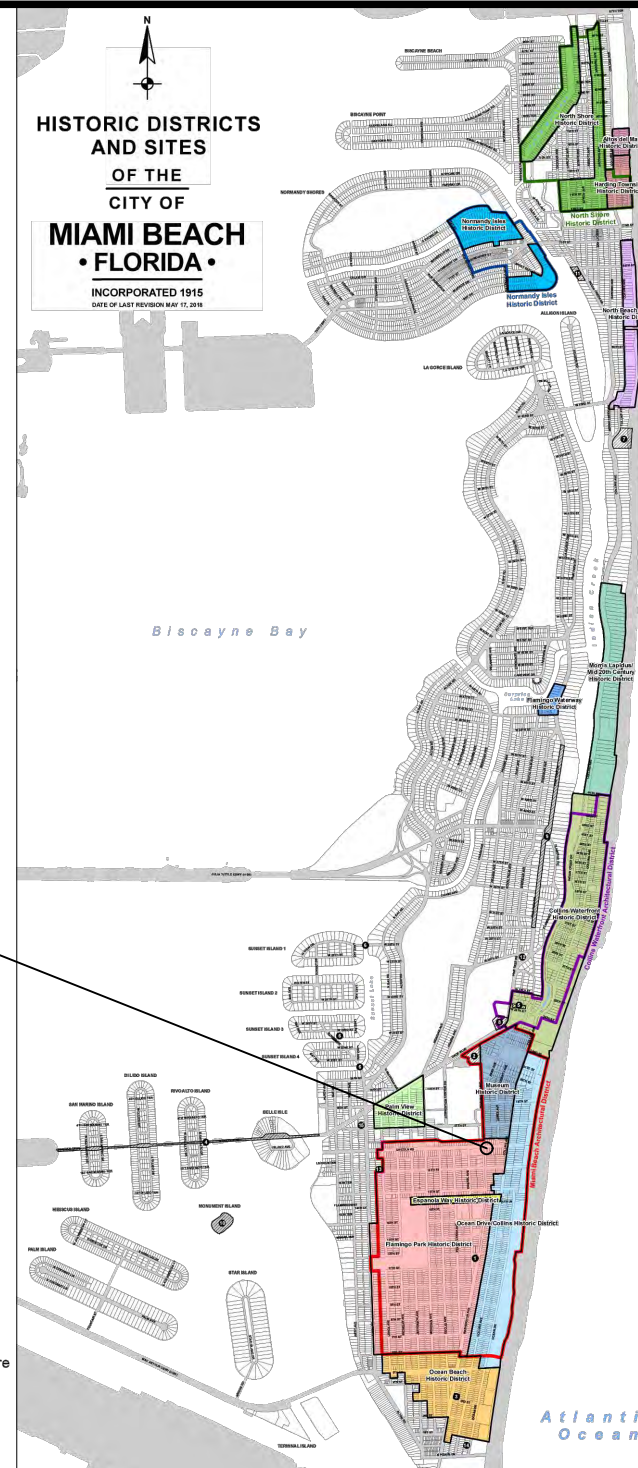

PROJECT LOCATION
FLAMINGO PARK HISTORIC DISTRICT

LEGEND AND ABBREVIATIONS	
	= PALM TREE
	= TREE
	= ORNAMENTAL TREE
O.R.B.	= OFFICIAL RECORDS BOOK
PG.	= PAGE
ELEV.	= ELEVATION
TYP.	= TYPICAL
CATV	= CABLE TELEVISION
OHE	= OVERHEAD ELECTRIC LINE
X 0.00	= SPOT ELEVATION
CONC.	= CONCRETE
C.B.S.	= CONCRETE BLOCK STUCCO
C.L.F.	= CHAIN LINK FENCE
W.F.	= WOOD FENCE
M.F.	= METAL FENCE
RCP	= REINFORCED CONCRETE PIPE
FF	= FINISH FLOOR
(R)	= RECORD
(C)	= CALCULATED
(M)	= MEASURE
LB	= LICENSE BUSINESS
L	= LENGTH
Δ	= CENTRAL ANGLE
R	= RADIUS
T	= TANGENT
PT	= POINT OF TANGENCY
PC	= POINT OF CURVATURE
STA.	= STATION
PI	= POINT OF INTERSECTION
ID	= IDENTIFICATION
MLP	= METAL LIGHT POLE
CLP	= CONCRETE LIGHT POLE
R/W	= RIGHT-OF-WAY
P.B.	= PLAT BOOK
	= SECTION LINE
	= CENTERLINE
	= BASELINE
	= MONUMENT LINE
	= TRAFFIC SIGNAL BOX
	= TRAFFIC SIGNAL CABINET
	= BOLLARD
	= PEDESTRIAN SIGNAL
	= TRAFFIC SIGNAL MAST ARM
	= SIGN
	= CABLE TELEVISION BOX
	= LIGHT POLE
	= ELECTRIC BOX
	= UTILITY POLE
	= ELECTRIC TRANSFORMER
	= GUY ANCHOR
	= ELECTRIC MANHOLE
	= ELECTRIC METER
	= GAS VALVE
	= GAS UTILITY BOX
	= GAS MANHOLE
	= GAS TANK
	= GAS METER
	= COMMUNICATION BOX
	= COMMUNICATION MANHOLE
	= GARBAGE RECEPTACLE
	= HANDICAP PARKING SPACE
	= WATER METER
	= IRRIGATION VALVE
	= WATER VALVE
	= FIRE HYDRANT
	= WATER BOX
	= WATER CONNECTION
	= WATER MANHOLE
	= WATER TANK
	= WATER WELL
	= WATER MARKING FLAG
	= WATER MARKING SIGN
	= STORM MANHOLE
	= STORM METER
	= CATCH BASIN
	= TELEPHONE MANHOLE
	= TELEPHONE BOX
	= NEWSPAPER DISPENSER
	= MAILBOX
	= SANITARY MANHOLE
	= SANITARY BOX
	= SANITARY TANK
	= SANITARY LIFT STATION
	= GREASE TRAP MANHOLE
	= CLEANOUT
	= PARKING METER
	= FIBER OPTIC BOX
	= FIBER OPTIC MARKER SIGN
	= MONITORING WELL
	= FUEL TANK
	= UNKNOWN UTILITY BOX
	= UNKNOWN UTILITY METER
	= UNKNOWN UTILITY MANHOLE
	= UNKNOWN UTILITY VALVE
	= UNKNOWN UTILITY MARKER FLAG
	= SANITARY VALVE
	= RAILROAD SIGN
	= FLAGPOLE
	= PROPERTY LINE
	= ELECTRICAL OUTLET

NOTES:

LOCAL HISTORIC DISTRICTS

	Espanola Way Historic District
	Altos del Mar Historic District
	Flamingo Park Historic District
	Ocean Drive/Collins Avenue Historic District
	Museum Historic District
	Ocean Beach Historic District
	Harding Townsite Historic District
	Palm View Historic District
	Collins Waterfront Historic District
	North Beach Resort Historic District
	Flamingo Waterway Historic District
	Morris Lapidus/Mid 20th Century Historic District
	North Shore Historic District
	Normandy Isles Historic District

NATIONAL REGISTER HISTORIC DISTRICTS

	Miami Beach Architectural District
	Normandy Isles Historic District
	North Shore Historic District
	Collins Waterfront Architectural District

LOCAL HISTORIC SITES

1	Old City Hall Historic Site
2	21st St Recreation Center Historic Site
3	Congregation Beth Jacob Historic Site
4	Venetian Causeway Historic Site
5	Miami Beach Woman's Club Historic Site
6	Sunset Island Bridges Historic Structures
7	The Bath Club Historic Site
8	Dade Blvd Fire Station Historic Site
9	PineTree Dr Historic Roadway
10	Flagler Memorial and Monument Island Historic Site
11	69th St Fire Station Historic Site
12	28th St Obelisk and Pumping Station Historic Structure
13	1600 Lenox Ave Historic Site
14	36 Ocean Dr Historic Site
15	1700 Alton Rd Historic Site

PROJECT DIRECTORY:

PROJECT NAME:
INTERACTIVE DIGITAL INFORMATION
KIOSKS DEPLOYMENT PROJECT

JURISDICTION:
CITY OF MIAMI
DEPARTMENT OF RESILIENCE AND
PUBLIC WORKS
MIAMI RIVERSIDE CENTER
444 S.W. 2nd AVENUE, 8th FLOOR
MIAMI, FLORIDA 33130
TEL: 305-416-1200

OWNER:
IKE SMART CITY
250 N HARTOFORD AVE
COLUMBUS, OH 43222
(614) 589-0087

ENGINEER OF RECORD:
MAINSTREET ENGINEERING
7035 SW 47 STREET, SUITE A
MIAMI, FL 33155
(305) 456-3505
PROJ. MGR: VANESSA MELA, P.E.
VMELA@MAINSTREETENG.COM

KIOSK MANUFACTURER:
DISPLAY DEVICE INC.
21075 WESTGATE RD.
GOLDEN, CO 80403
CONTACT: ERIC PERKINS
PHONE: (303) 929-4071

UTILITIES:

ELECTRICAL POWER: FLORIDA
POWER & LIGHT COMPANY (FPL)

WATER & SEWER: MIAMI-DADE
WATER & SEWAGE DEPARTMENT

TELEPHONE: AT&T


CABLE: COMCAST, XFINITY,
ATT-UVERSE

GAS: FLORIDA GAS


SIDEWALK & STREET SYMBOLS

	ASPHALT		BRICK
	PAVER		CONCRETE
	UNIMPROVED		TILE
	GRAVEL		STAMPED CONCRETE

KEY PLAN (NOT TO SCALE):

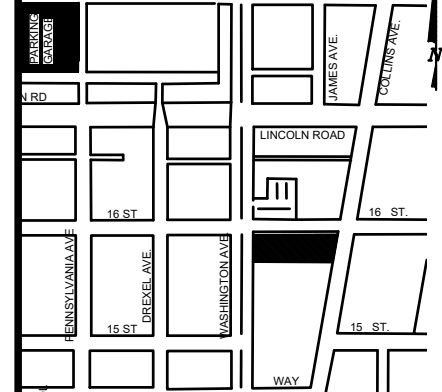

P.E. SEAL:

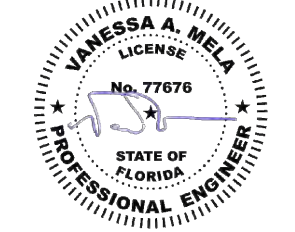

NO.	DATE	REVISION	APP'D. BY
5			
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2			
1			

ADA NOTES

- ALL CONSTRUCTION ACTIVITIES SHALL BE COMPLETED IN FULL COMPLIANCE WITH THE AMERICANS WITH DISABILITIES ACT (ADA). CLEAR SPACES IN FRONT OF KIOSK SHALL HAVE THE FOLLOWING CHARACTERISTICS:
- SURFACES SHALL BE FIRM, STABLE, AND SLIP RESISTANT AND OTHERWISE COMPLY WITH PROWAG SECTION R302.7 AND SHALL HAVE A RUNNING SLOPE CONSISTENT WITH GRADE OF THE ADJACENT PEDESTRIAN ACCESS ROUTE AND CROSS SLOPE OF 1.50% +/-0.50%)
- SIZE: CLEAR SPACES SHALL BE 48" MINIMUM BY 48" MINIMUM.
- POSITION: UNLESS OTHERWISE SPECIFIED, CLEAR SPACES SHALL BE POSITIONED FOR EITHER FORWARD OR PARALLEL APPROACH TO THE KIOSK.
- APPROACH: ONE FULL UNOBSTRUCTED SIDE OF A CLEAR SPACE SHALL ADJOIN A PEDESTRIAN ACCESS ROUTE OR ADJOIN ANOTHER CLEAR SPACE.
- MANEUVERING SPACE: WHERE A CLEAR SPACE IS CONFINED ON ALL OR PART OF THREE SIDES, ADDITIONAL MANEUVERING SPACE SHALL BE PROVIDED AS FOLLOWS:
 - FORWARD APPROACH: THE CLEAR SPACE AND ADDITIONAL MANEUVERING SPACE SHALL BE 36" WIDE MINIMUM WHERE THE DEPTH OF THE CONFINING ELEMENT EXCEEDS 24".
 - PARALLEL APPROACH: THE CLEAR SPACE AND ADDITIONAL MANEUVERING SPACE SHALL BE 60" WIDE MINIMUM WHERE THE DEPTH OF THE CONFINING ELEMENT EXCEEDS 15".
- THE MINIMUM WHEELCHAIR PASSAGE WIDTH OR CLEAR SPACE WIDTH FOR A SINGLE WHEELCHAIR PASSAGE SHALL BE 48" PER PROWAG SECTION R302.3.
- INITIAL OPERATION FOR THE KIOSK WILL HAVE 4G LTE CONNECTION SECTION R404. TO THE INTERNET.
- THE KIOSKS HAVE BEEN DESIGN TO COMPLY WITH ALL ADA GUIDELINES INCLUDING VIEWING, OPERATION, AND ACCESSIBILITY.
- THE MOBILE IKE EXPERIENCE WILL FOLLOW WEB CONTENT ACCESSIBILITY GUIDELINES (WCAG) TO WORK IN TANDEM WITH THE NATIVE ACCESSIBILITY FEATURES ON THE USER'S MOBILE DEVICE, INCLUDING TALKBACK AND VOICEOVER TOOLS.

SCOPE OF WORK

THE PROJECT CONSIST OF THE INSTALLATION OF ONE (1) DIGITAL INTERACTIVE KIOSKS AT THE LOCATION(S) INDICATED ON THIS PLANS SET. INSTALLER SHALL PROVIDE AND INCLUDE ALL WORKMANSHIP AND MATERIALS NECESSARY TO COMPLETE THE INSTALLATION INCLUDING BUT NOT LIMITED TO:


- INSTALLATION OF THE KIOSKS TO THE FOUNDATION AS INDICATED ON PLANS TO NEW RECTANGULAR CONCRETE FOUNDATION.
- ELECTRICAL SERVICE POINTS ARE EXISTING. CONNECT THE EXISTING ELECTRIC SERVICE TO THE NEW KIOSK AS INDICATED ON PLANS.
- TESTING OF THE ELECTRICAL SERVICE INFRASTRUCTURE SHALL BE PERFORMED IN CONJUNCTION WITH A REPRESENTATIVE OF THE ENGINEER OF RECORD.
- THE CONTRACTOR SHALL INSTALL THE KIOSK IN SUCH A WAY THAT THE KIOSK IS WITHIN THE PUBLIC R.O.W. AND IN COMPLIANCE WITH ALL APPLICABLE A.D.A. REQUIREMENTS
- THE LOCATION OF KIOSKS HAS BEEN COORDINATE TO ENSURE THERE IS NO OBSTRUCTION OF THE SIGHT OF VEHICULAR SIGNS.
- STAND-ALONE PEDESTRIAN KIOSKS SHOULD NOT BE INSTALLED WITHIN PEDESTRIAN CIRCULATION PATHS IN A MANNER THAT PERSONS AT THE KIOSK LOCK THE EFFECTIVE WIDTH OF THE PEDESTRIAN TRAVEL WAY.

MONUMENT SIGN SPECIFICATIONS AND FUNCTIONS


THE UNIT CONSISTS OF A UL/NRTL LISTED WEATHER AND VANDAL RESISTANT FREE STANDING ENCLOSURE DESIGNED TO COMPLY WITH THE FLORIDA BUILDING CODE AND OTHER APPLICABLE CODES INCLUDING THE NATIONAL ELECTRICAL CODE. THE UNIT HAS BEEN DESIGNED TO WITHSTAND WINDS OF 165 MPH. THE UNIT'S MAIN COMPONENTS ARE:

- TWO (2) INTERACTIVE 65" VIDEO TOUCH SCREENS.
- TWO (2) CAMERAS
- ONE (1) CPU
- ONE (1) WI-FI TRANSMITTER

MANUFACTURER: DYNASCAN MODEL NUMBER: CIO651DR5
 NATIVE RESOLUTION: 1920 X 1080
 ELECTRICAL POWER REQUIREMENT:
 1. ONE-2-POLE, 20 AMP, 240 VOLTS CIRCUIT.
 2. TOTAL LOAD: 1400/2200 WATTS (OPERATIONAL/PEAK)
 3. VOLTAGE: 100-240 VOLTS AC, 50-60 HZ
 WEIGHT: 832 LBS
 CERTIFICATION CE / FCC / RoHS

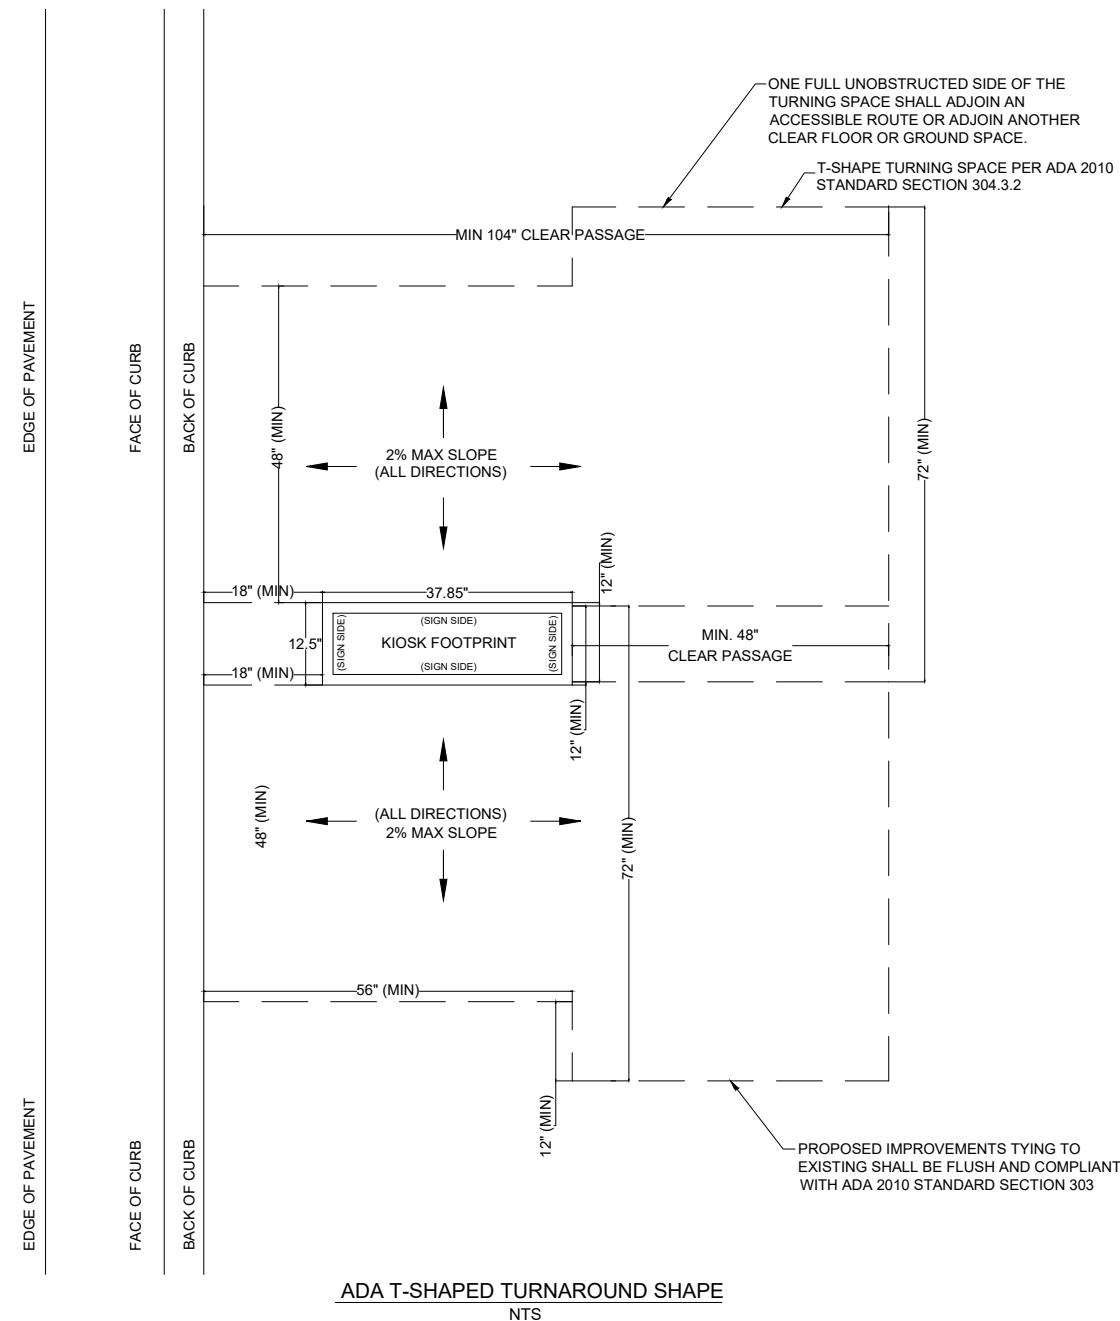

NOTES:

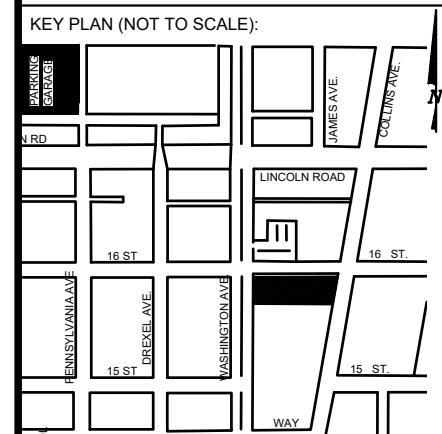

P.E. SEAL:

MIAMI BEACH
 PUBLIC WORKS DEPARTMENT
 1700 CONVENTION CENTER DRIVE, MIAMI BEACH, FL 33139

CITY MANAGER: ALINA T. HUDAK
 DIRECTOR: JOE GOMEZ, P.E.
 CITY ENGINEER: CRISTINA ORTEGA CASTINEIRAS, P.E.

NO.	DATE	REVISION	APP'D. BY
5			
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1			

Main Street ENGINEERING
 7055 SW 47th Street, Ste A, Miami, FL 33155
 Tel: (305) 466-3055 Fax: (305) 476-8884
 FL PE Certificate No.: 00008751


ENGINEER OF RECORD: VANESSA A. MELA, P.E. NO. 77676

ENGINEER OF RECORD: VM
 DESIGN ENGINEER: VM
 DRAWN BY: KM
 CHECKER: WP
 SCALE: _____


NEIGHBORHOOD: MIB-004: LINCOLN RD & WASHINGTON AVE


TITLE: ADA NOTES, SCOPE OF WORK & KIOSK SPECIFICATIONS

File Name: MIB-004-GENERAL AND FOUNDATION.dwg
 Survey Reference:
 Field Book: N/A Page: N/A Work Order: N/A
 Date: 10/09/2023 Sheet: 2 of 6 Drawing: G0-04

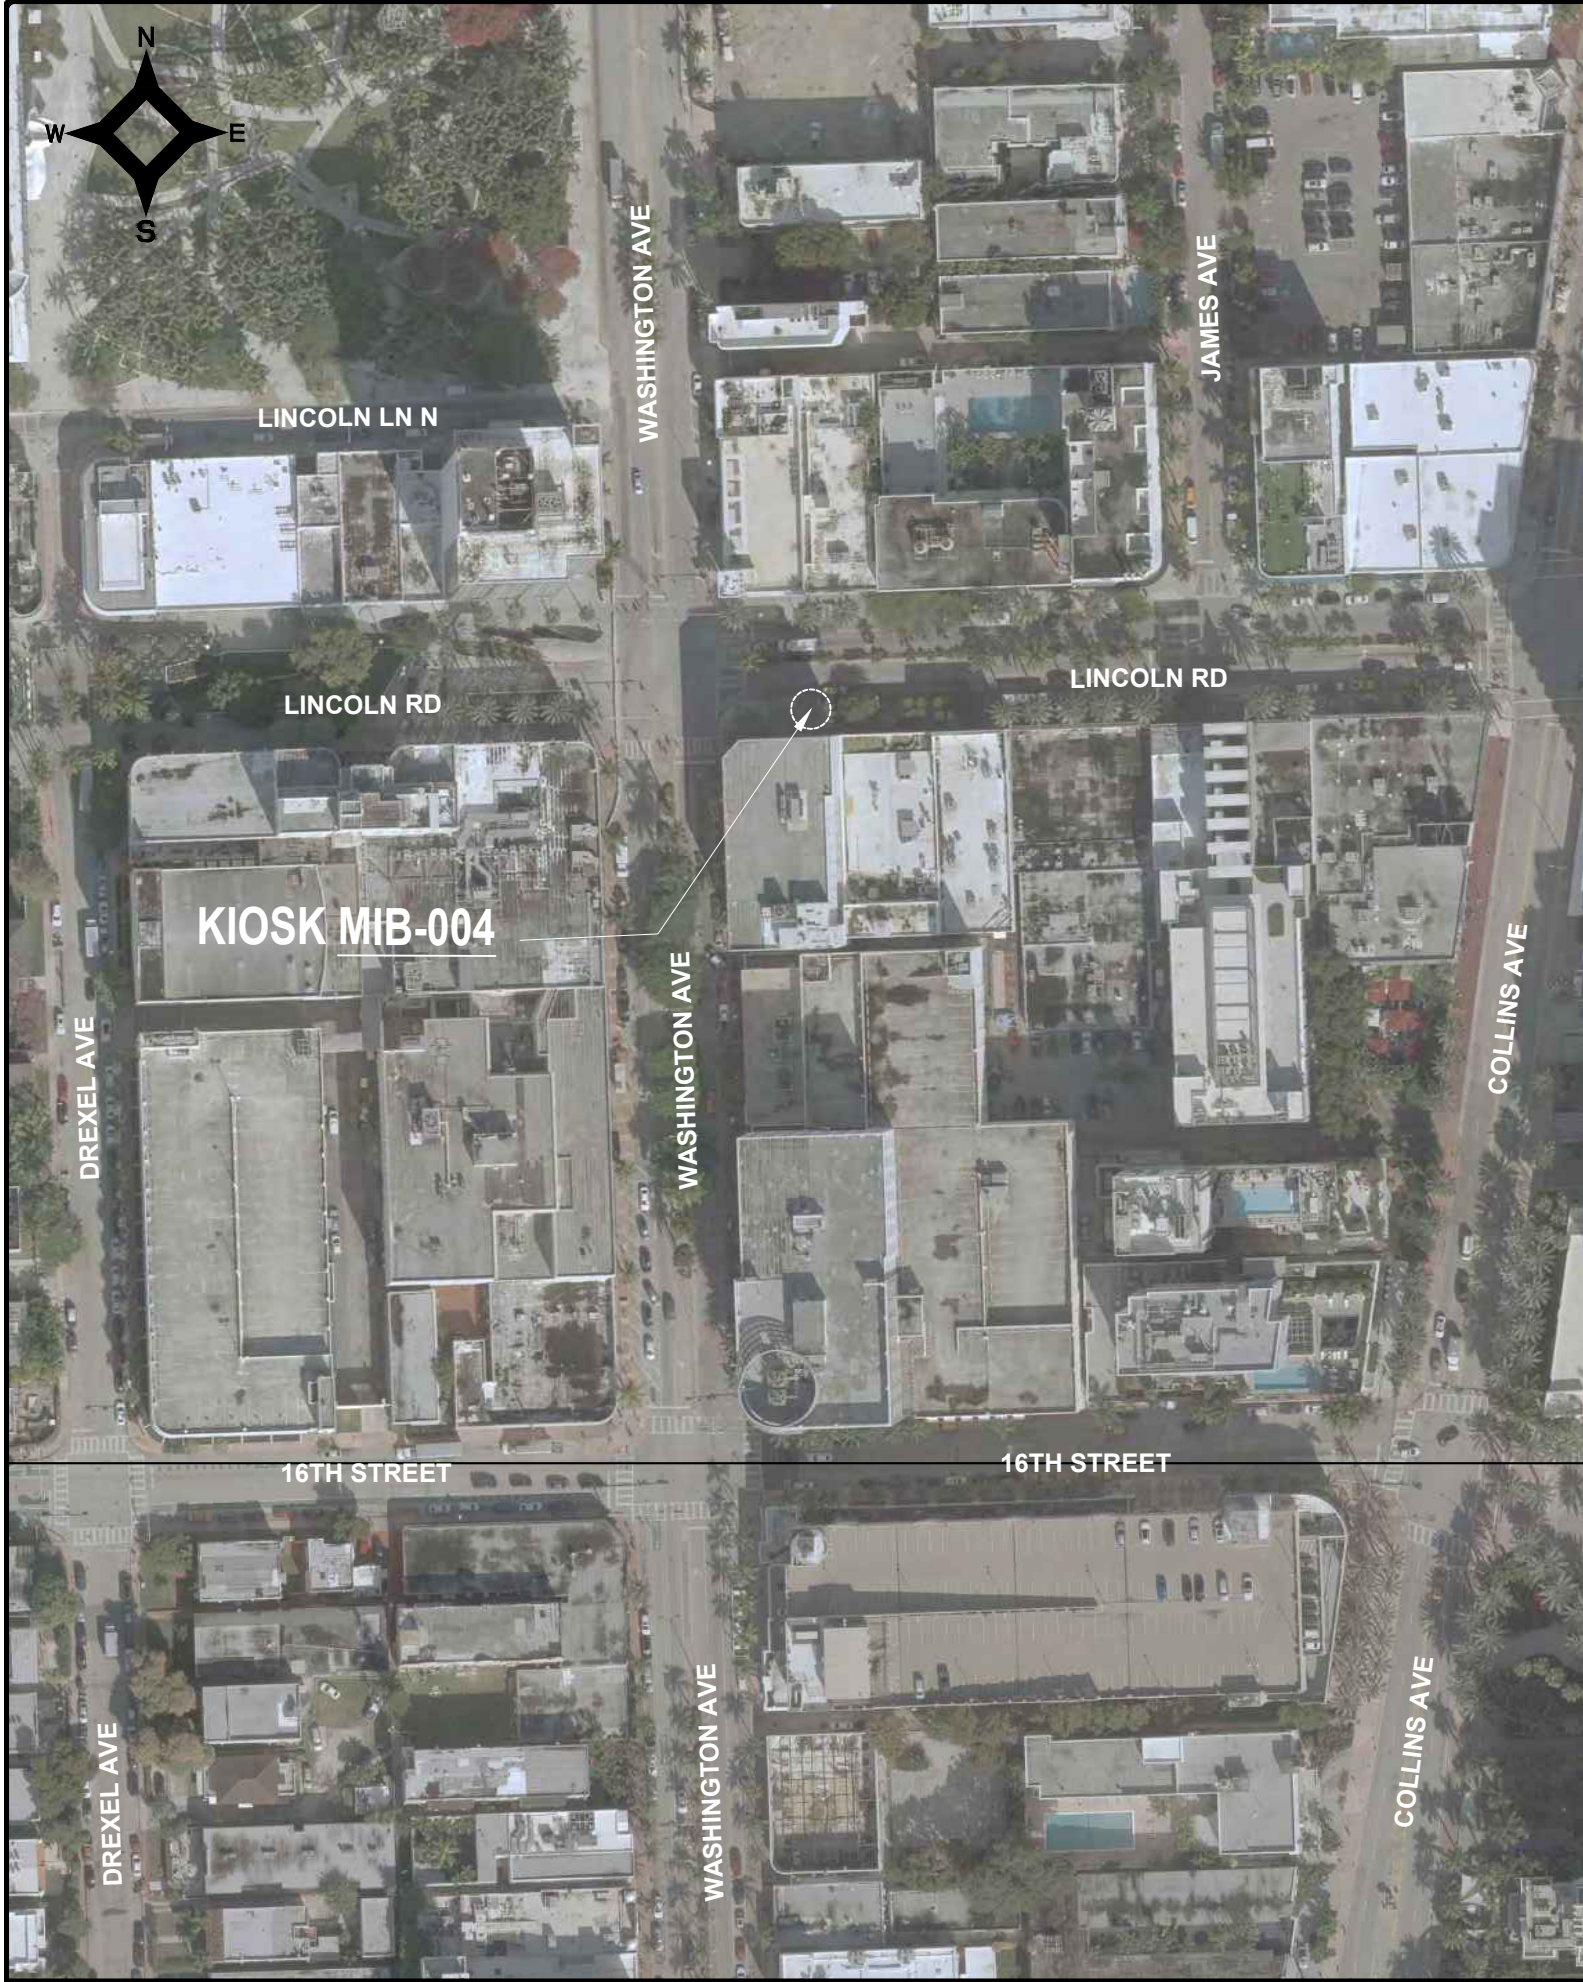


LEGEND

 AREA WHERE NO STRUCTURE OR PLANTING WHICH OBSTRUCTS TRAFFIC VISIBILITY BETWEEN THE HEIGHT OF TWO FEET AND TEN FEET ABOVE THE STREET CORNER GRADE IS ALLOWED. REFER TO CITY OF MIAMI BEACH CODE OF ORDINANCES SECTION 142-1135


 NO PLANTING OR STRUCTURE PERMITTED WITHIN THESE LIMITS WHICH OBSTRUCTS TRAFFIC VISIBILITY.

E.P. EDGE OF PAVEMENT

R/W RIGHT OF WAY

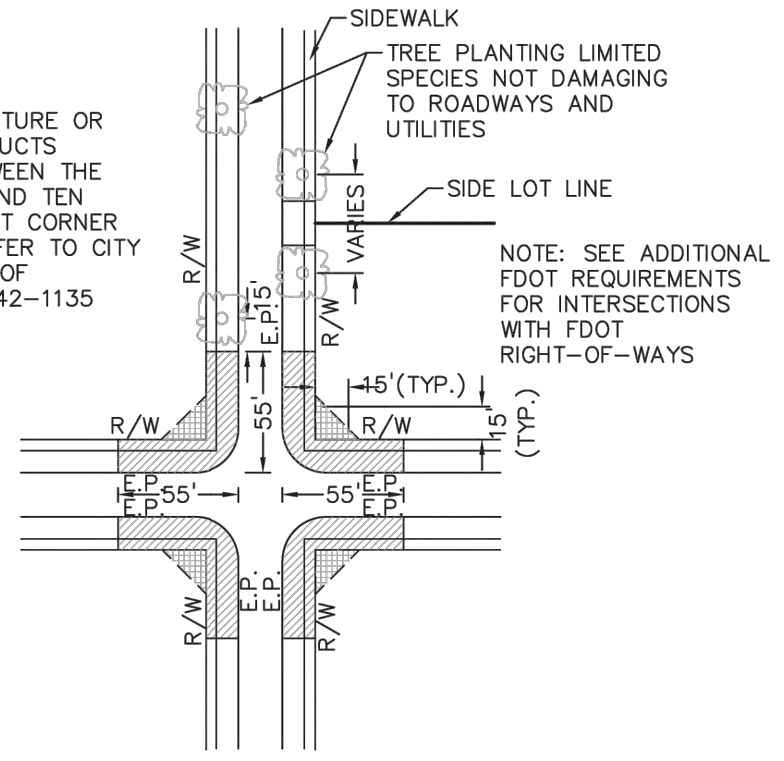


PLAN VIEW
N.T.S.

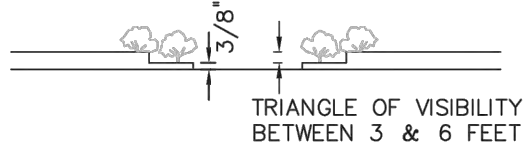

ELEVATION VIEW
N.T.S.

NOTES:

1. AT INTERSECTIONS WITH ALL-WAY STOP CONTROL, THE FIRST STOPPED VEHICLE ON ONE APPROACH SHOULD BE VISIBLE TO THE DRIVERS OF THE FIRST STOPPED VEHICLES ON EACH OF THE OTHER APPROACHES. THERE ARE NO OTHER SIGHT DISTANCE CRITERIA APPLICABLE TO INTERSECTIONS WITH ALL-WAY STOP CONTROL AND, INDEED, ALL-WAY CONTROL MAY BE THE BEST OPTION AT A LIMITED NUMBER OF INTERSECTIONS WHERE SIGHT DISTANCE FOR OTHER CONTROL TYPES CANNOT BE ATTAINED.
2. FOR TWO-WAY STOP INTERSECTIONS, SIGHT DISTANCE CRITERIA FOR STOP CONTROLLED INTERSECTIONS ARE LONGER THAN STOPPING SIGHT DISTANCE TO ENSURE THAT THE INTERSECTION OPERATES SMOOTHLY. MINOR-ROAD VEHICLE OPERATORS CAN WAIT UNTIL THEY CAN PROCEED SAFELY WITHOUT A MAJOR-ROAD VEHICLE TO STOP.


	APPROVED	REVISED	TITLE:	DETAIL
		07/2020 09/2020	SIGHT RESTRICTIONS AT INTERSECTIONS WITH NO DEDICATED RADII	10-26

SIGHT TRIANGLE CLEARANCE


Sunshine811

Call 811 or visit sunshine811.com two full business days before digging to have buried facilities located and marked.

Check positive response codes before you dig!

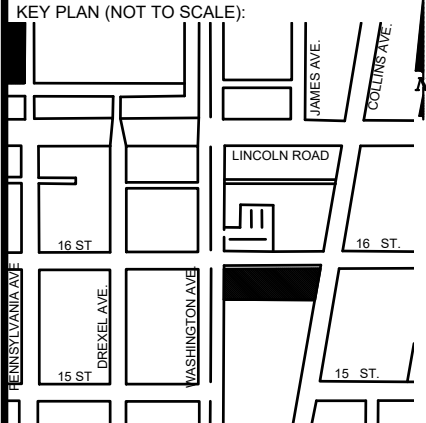



P.E. SEAL:

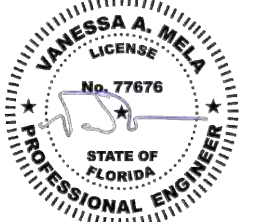

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NO.	DATE	REVISION	APP'D. BY





NOTES:

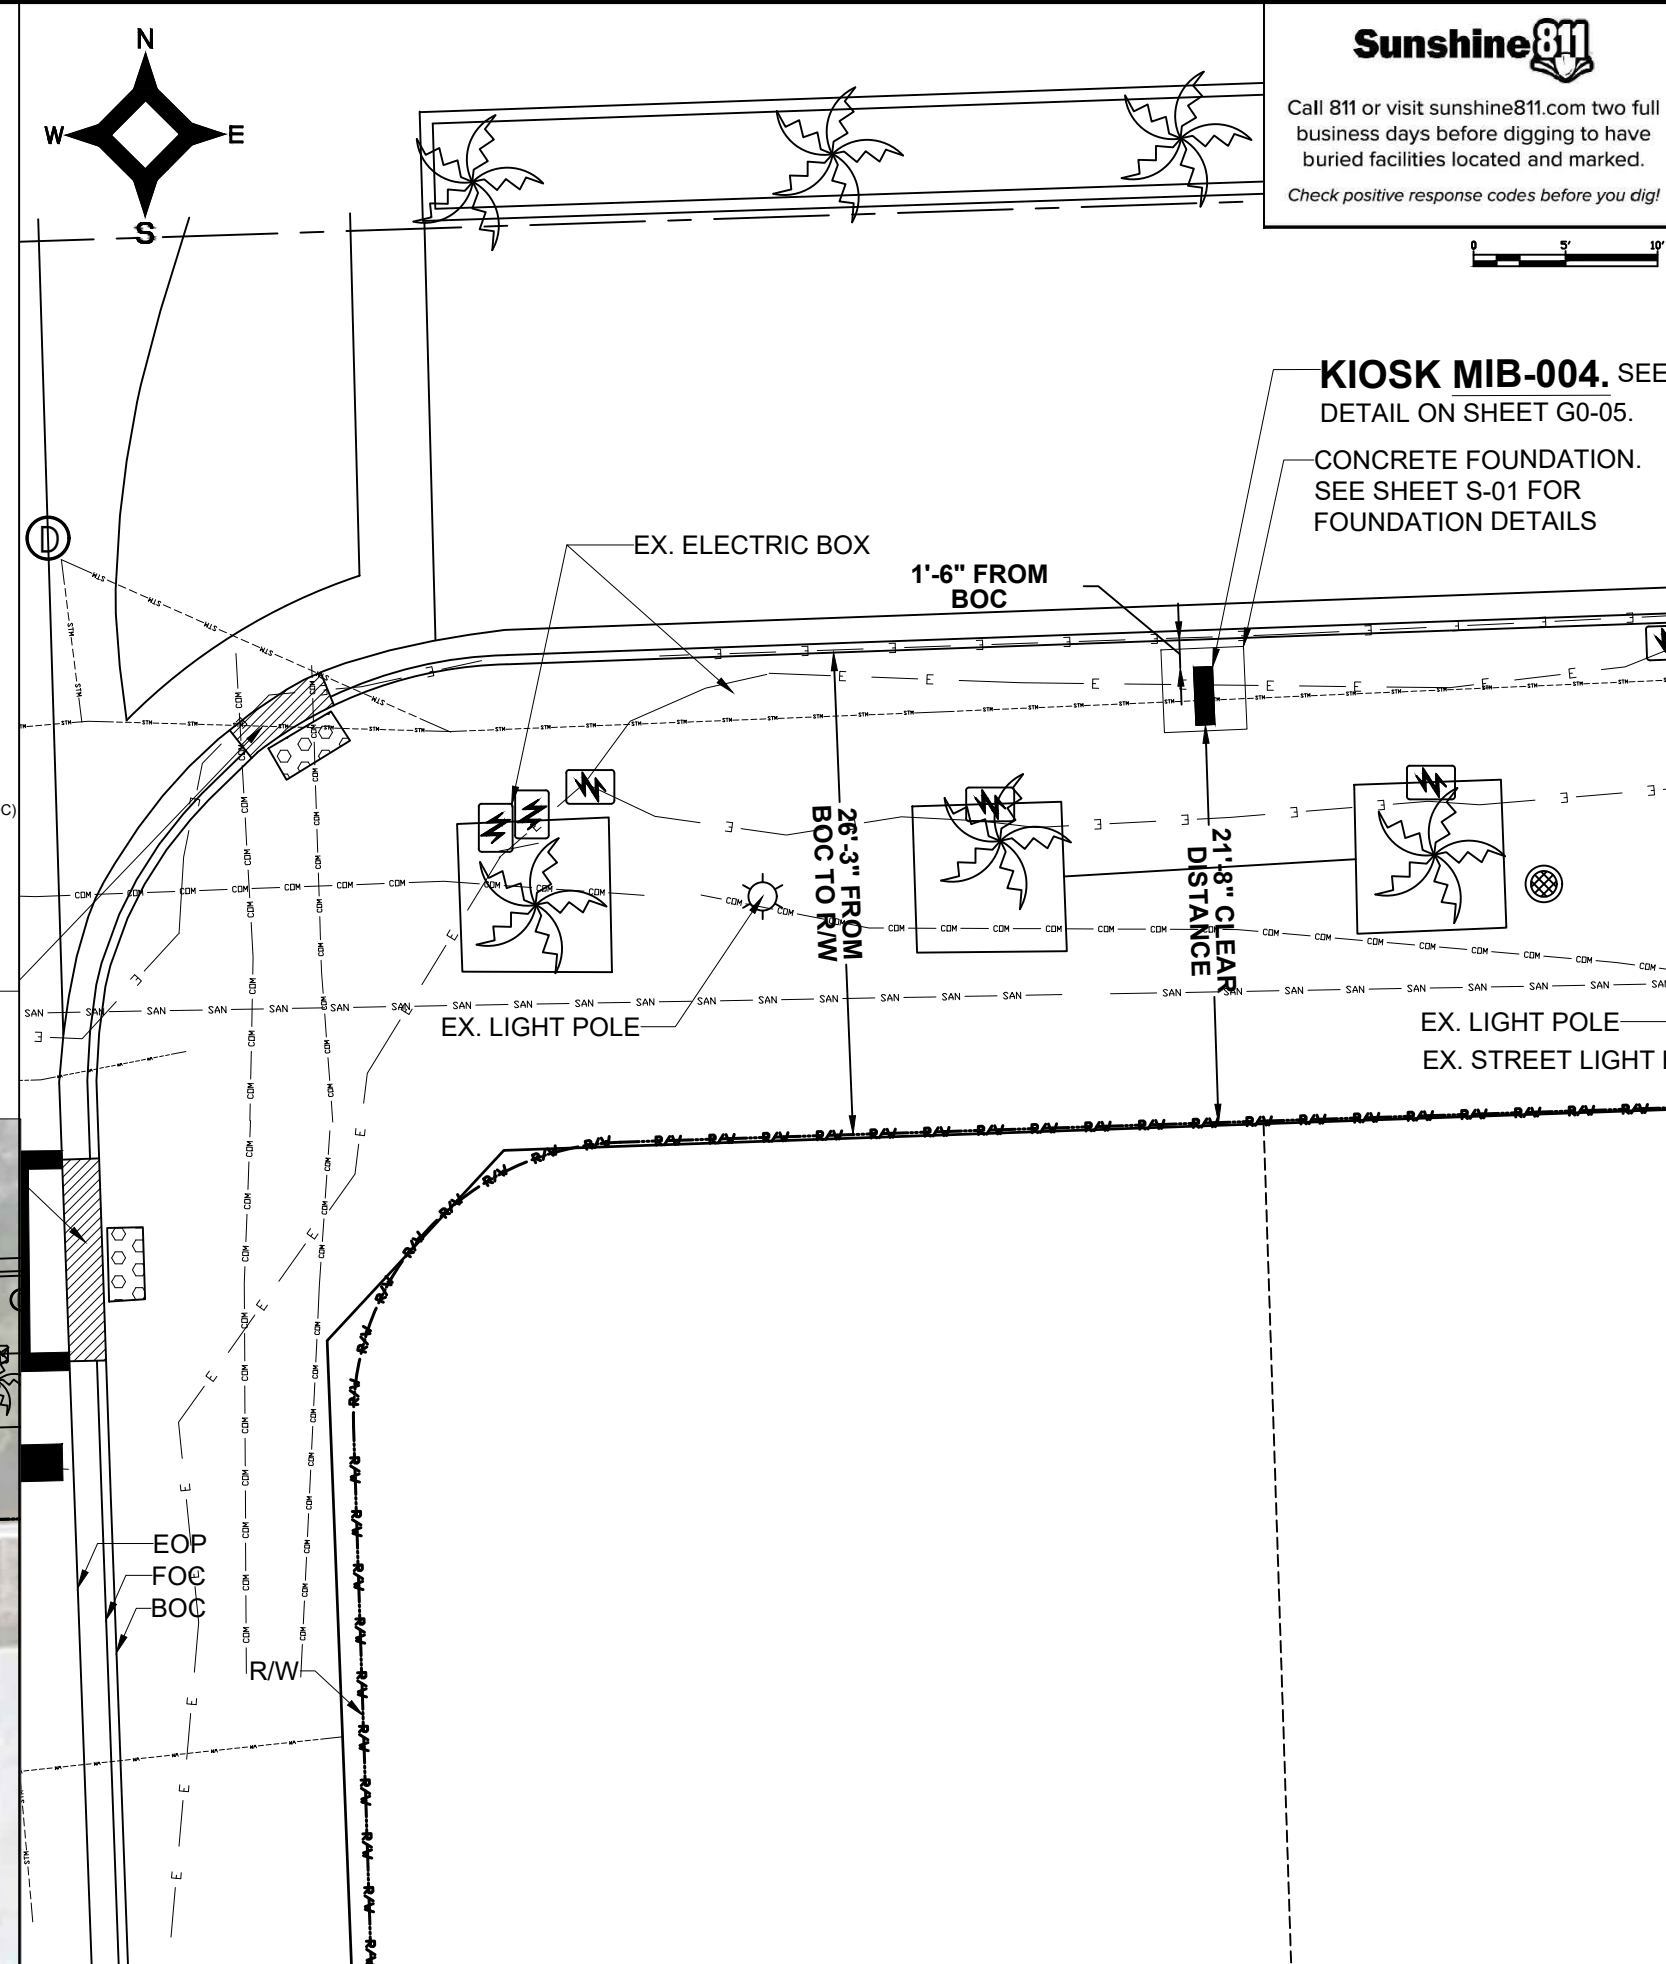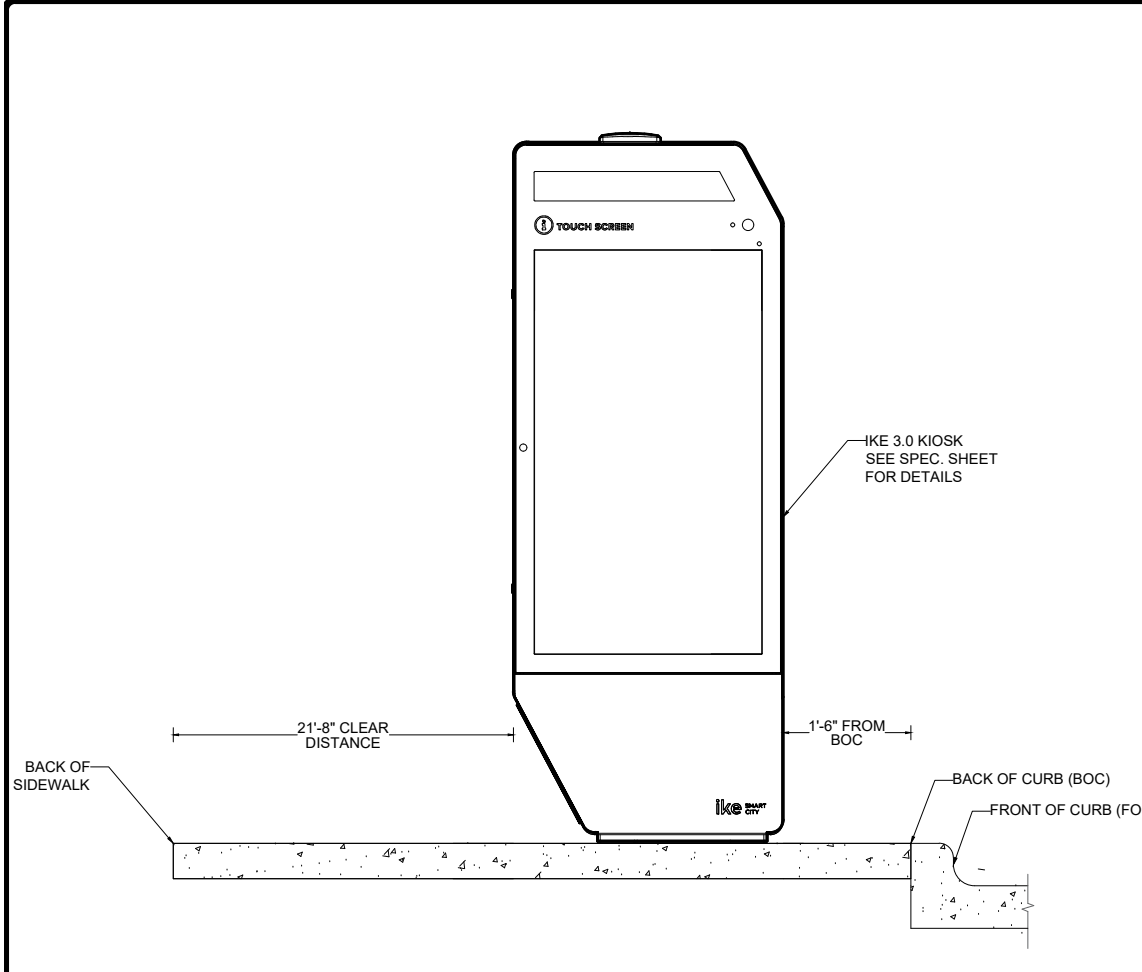


VISIBILITY TRIANGLE CLEARANCE ANALYSIS

SCALE: 1'-10"

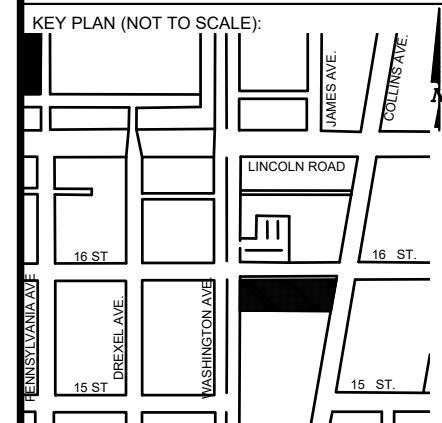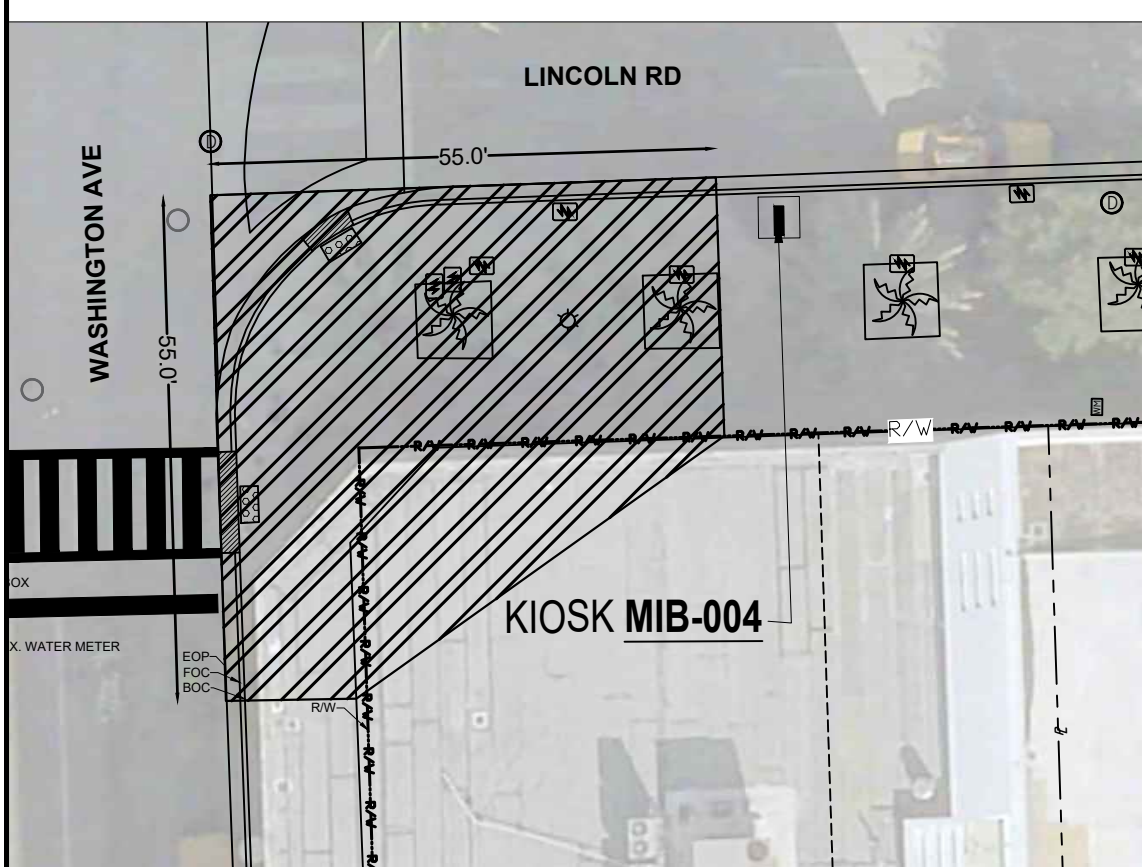


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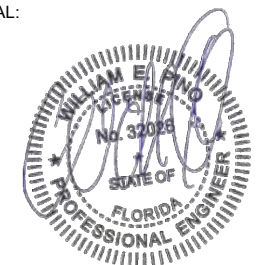
NO.	DATE	REVISION	APP'D. BY
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NOTES:

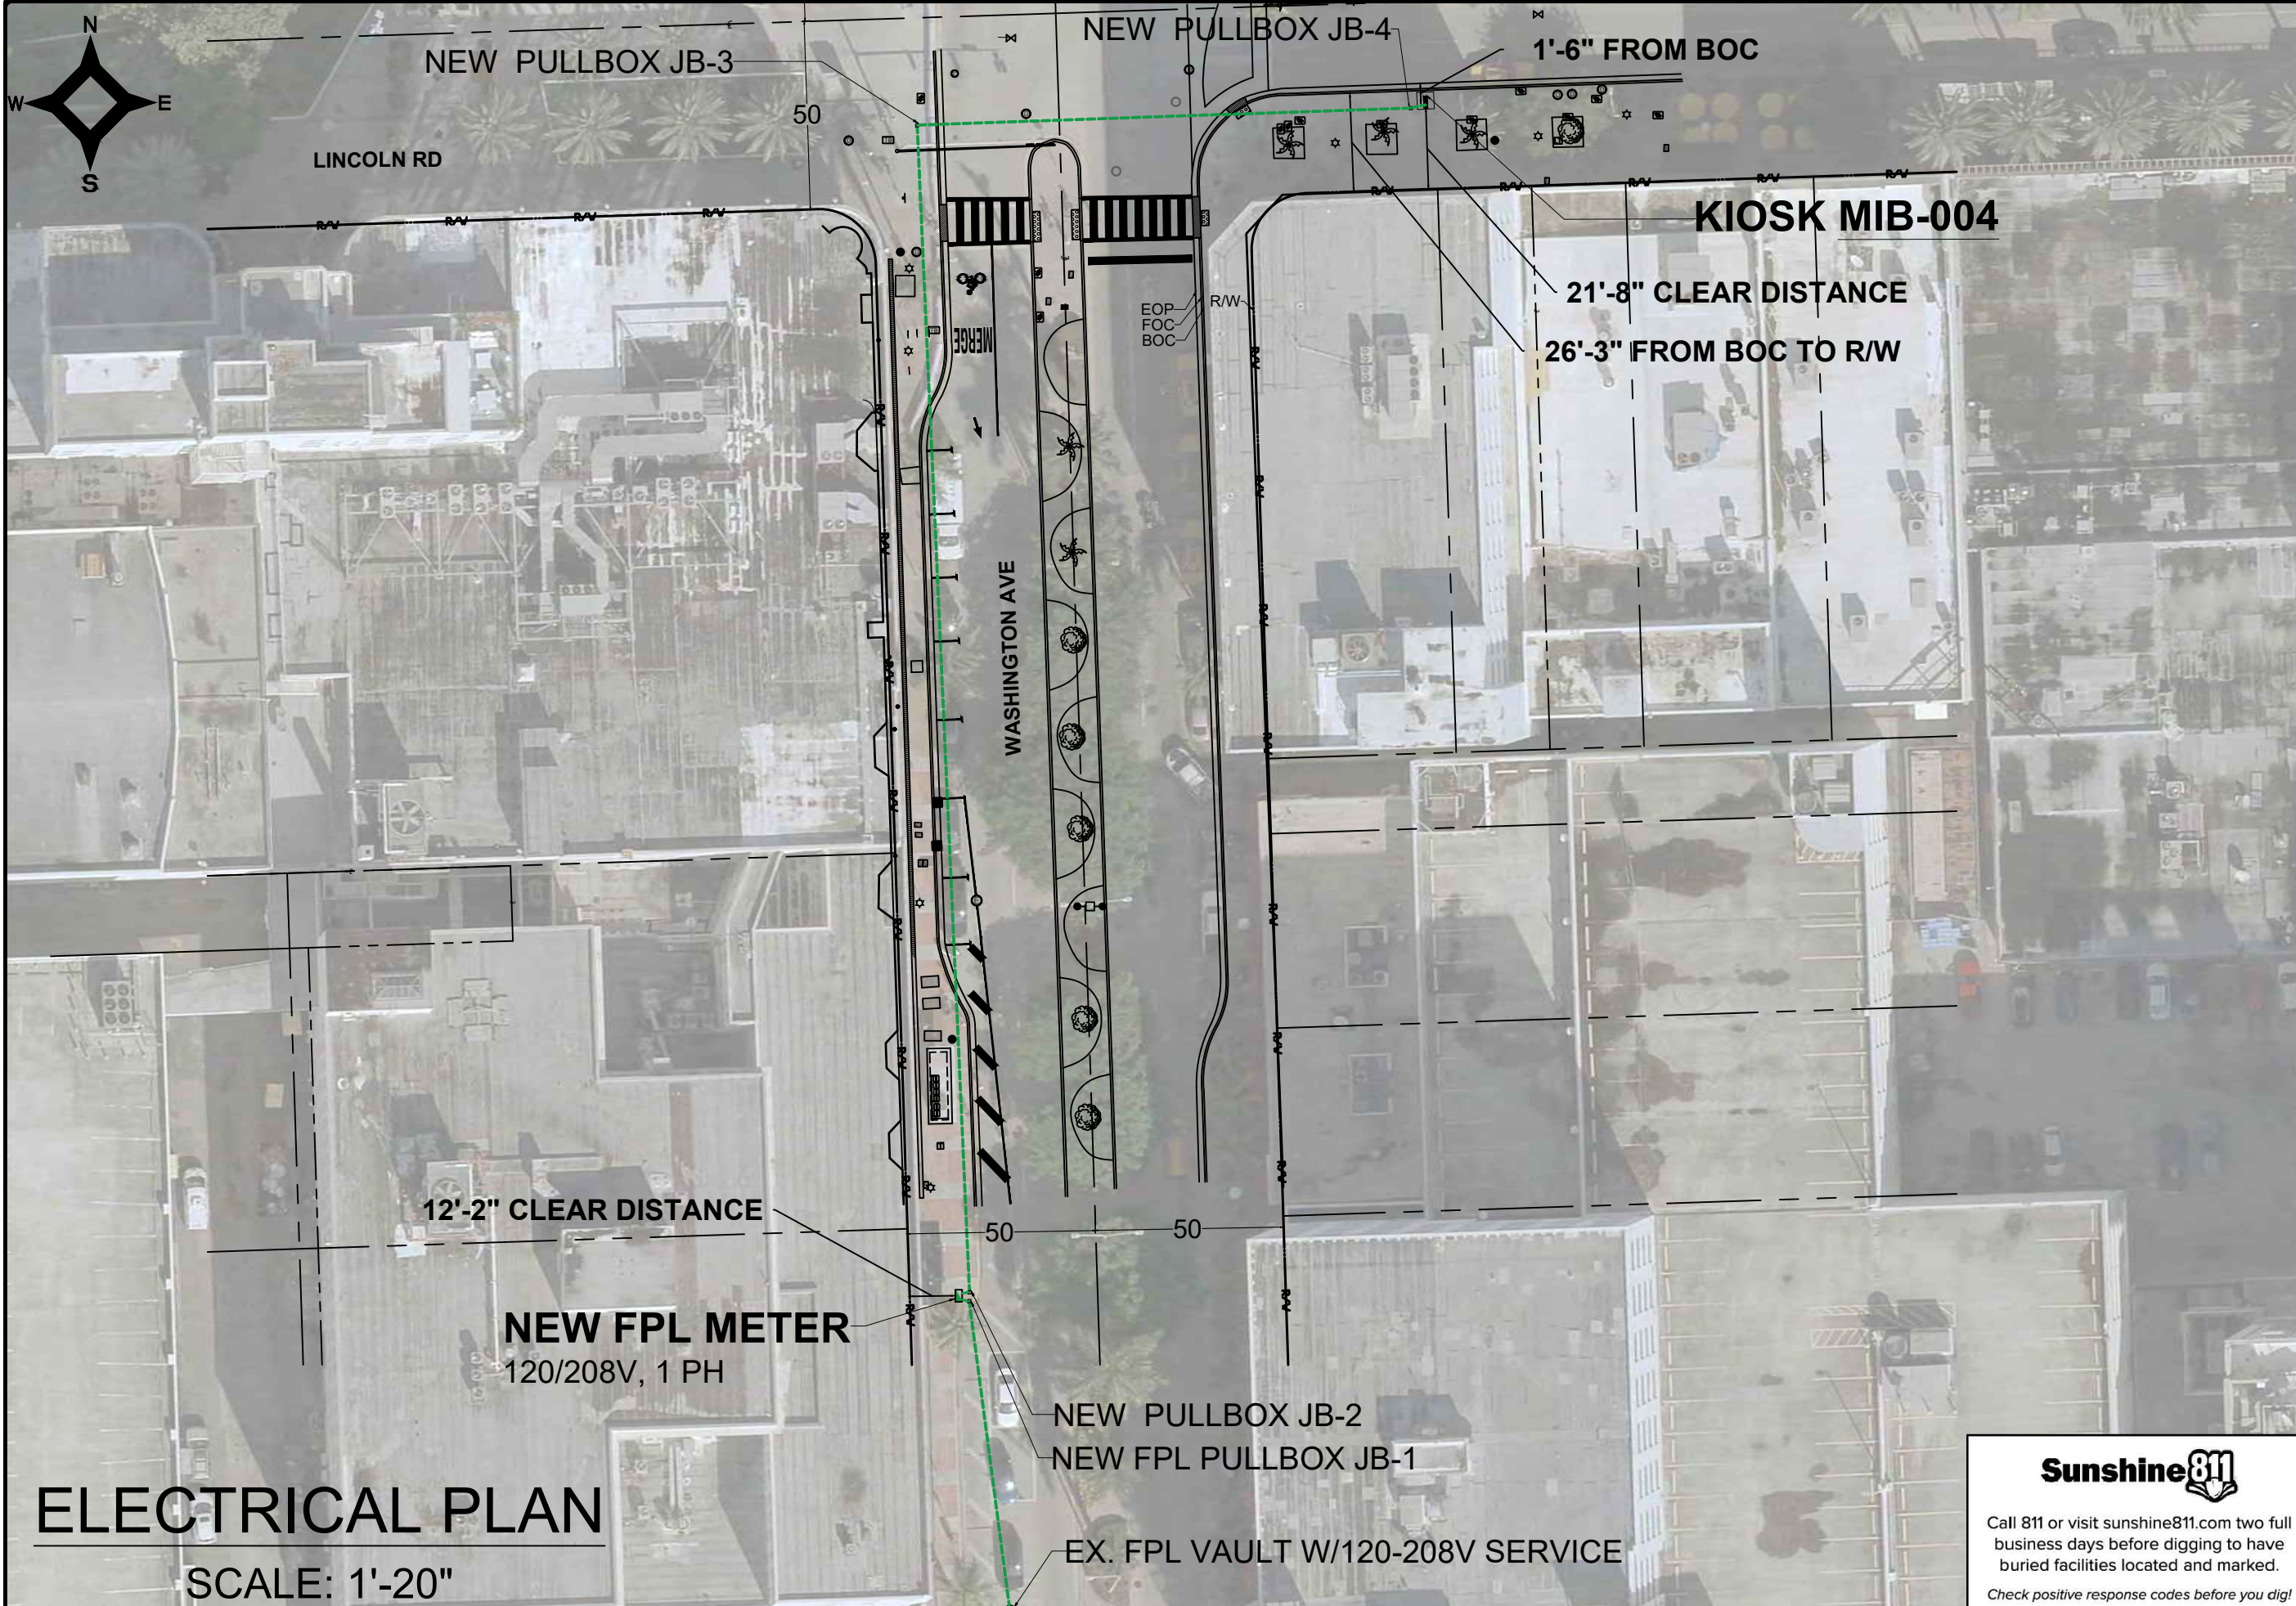

P.E. SEAL:

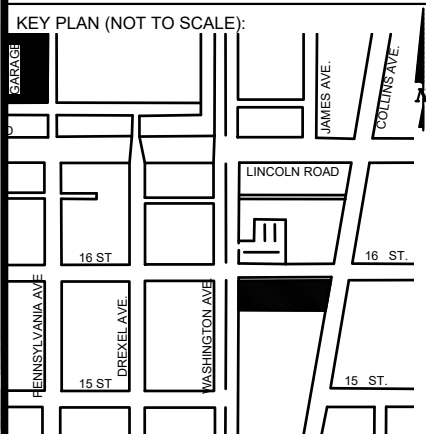

Sunshine811
 Call 811 or visit sunshine811.com two full business days before digging to have buried facilities located and marked.
 Check positive response codes before you dig!

ELECTRICAL PLAN
 SCALE: 1'-20"

MIAMI BEACH
 PUBLIC WORKS DEPARTMENT
 1700 CONVENTION CENTER DRIVE, MIAMI BEACH, FL 33139

CITY MANAGER: ALINA T. HUDAK
 DIRECTOR: JOE GOMEZ, P.E.
 CITY ENGINEER: CRISTINA ORTEGA CASTINEIRAS, P.E.

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1			
NO.	DATE	REVISION	APP'D. BY





ENGINEER OF RECORD: WILLIAM E. PINO, P.E. NO. 32026
 ENGINEER OF RECORD: WP
 DESIGN ENGINEER: WP
 DRAWN BY: KM
 CHECKER: WP
 SCALE: 1"=20'

NEIGHBORHOOD: MIB-004: LINCOLN RD & WASHINGTON AVE
 TITLE: KIOSK MIB-004 ELECTRICAL PLAN

File Name: MIB-004-ELECTRICAL & TTC PLANS.dwg
 Survey Reference:
 Field Book: N/A Page: N/A Work Order: N/A
 Date: 10/09/2023 Sheet: 5 of 6 Drawing: E1-01

SPECIFIC PURPOSE SURVEY

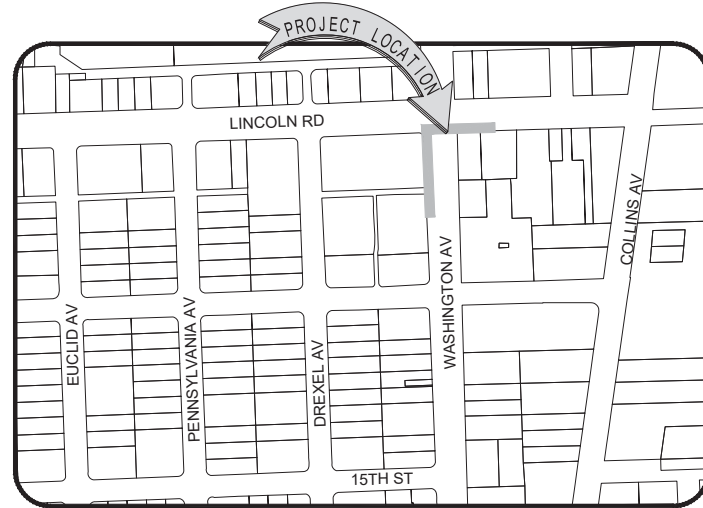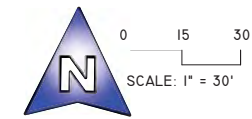

LOCATION MAP

Not to Scale

SURVEYOR'S REPORT AND GENERAL NOTES

(Not valid without the attached Survey Map)

- This is not a Boundary Survey.
- References to "Deed", "Record" or "Plat" refer to documents and instruments of record as part of the pertinent information used for this survey work. Measured distances, directions and angles along boundary lines are in consistency with corresponding values from records, unless otherwise shown.
- These lands are subject to additional restrictions of record that were not furnished to the undersigned registered surveyor. A title search has not been performed by the surveyor.
- North arrow direction is based on an assumed Meridian. Bearings are based on an assumed meridian on a well-established line, said line is being noted as BR on the Survey Map.
- Only above ground improvements are shown herein. Foundations, underground features and utilities have not been located.
- Survey markers found in the field have no identification unless otherwise shown. Any survey marker set by our company is labeled LB 7262 or PSM 6169.
- This Survey Map is intended to be displayed at the scale shown hereon. Data is expressed in U.S. Survey Foot.
- This Survey Map is being prepared for the use of the party/parties that it is certified to and does not extend to any unnamed individual, entity or assignee.
- FLOODPLAIN INFORMATION:** As scaled from Federal Insurance Rate Map (FIRM) of Community No. 120651 (City of Miami Beach), Panel 0319, Suffix L, revised on Sept 11th, 2009, this real property falls in Zone "AE" with Base Flood Elevation 8 feet (NGVD 1929)
- HORIZONTAL ACCURACY:** Accuracy obtained thru measurements and calculations meets and exceeds the minimum horizontal feature accuracy for a Suburban area being equal to 1 foot in 7,500 feet.
- VERTICAL CONTROL AND ACCURACY:** The elevations as shown are referred to the National American Vertical Datum of 1988 (NAVD 1988). The closure in feet, as computed, meets the standard of plus or minus 0.05 feet times the squared root of the loop distance in miles. Elevation are based on a level loop from and to the following official Bench Marks:
 Bench Mark # 1: City Miami Beach Bench Mark CMB W 16, Elevation = 4.00 feet (NAVD'88)
 Description: PK nail & washer @ Northeast quadrant of intersection Washington Avenue and 16th Street.
 Bench Mark # 2: City Miami Beach Bench Mark CMB 16 02R, Elevation = 2.03 feet (NAVD'88)
 Description: PK nail & washer @ Northwest quadrant of intersection Pennsylvania Avenue & 16th Street.


SUE NOTES:

- Data collected for this Survey had been determined using GNSS (RTK/GPS) conventional TS and differential leveling. Dimensions obtained are subject to equipment limitations.
- Subsurface Utility investigation was performed as part of this survey using GPR (Ground Penetrating Radar) and RD (Radiodetection Technology) for designation and location of underground facilities. This Survey depicts apparent location of underground piping found during this investigation. This method accuracy is plus or minus 1.5 feet approximately. There might be additional underground facilities not discovered at the time of this survey.


- E — E — E = RED PAINT LINE APPARENT ELECTRIC CONDUIT
- WM — WM — WM = BLUE PAINT LINE APPARENT WATER LINE
- SAN — SAN — SAN = GREEN PAINT LINE APPARENT SANITARY SEWER LINE
- GAS — GAS — GAS = YELLOW PAINT LINE APPARENT GAS LINE
- COM — COM — COM = ORANGE PAINT LINE APPARENT COMMUNICATION LINE
- STM — STM — STM = GREEN PAINT LINE APPARENT STORM SEWER LINE

I HEREBY CERTIFY TO:

Main Street Engineering, that this Survey conforms to the Standards of Practice as set forth by the Florida Board of Professional Surveyors and Mappers in applicable provisions of Chapter 5J-17, Florida Administrative Code pursuant to Section 472.027 Florida Statutes. This Survey is accurate and correct to the best of my knowledge and belief.

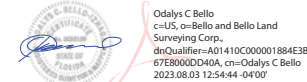

Odalys C. Bello-Iznaga
 Professional Surveyor and Mapper LS6169 • State of Florida
 Field Work Date: 07/27/2023

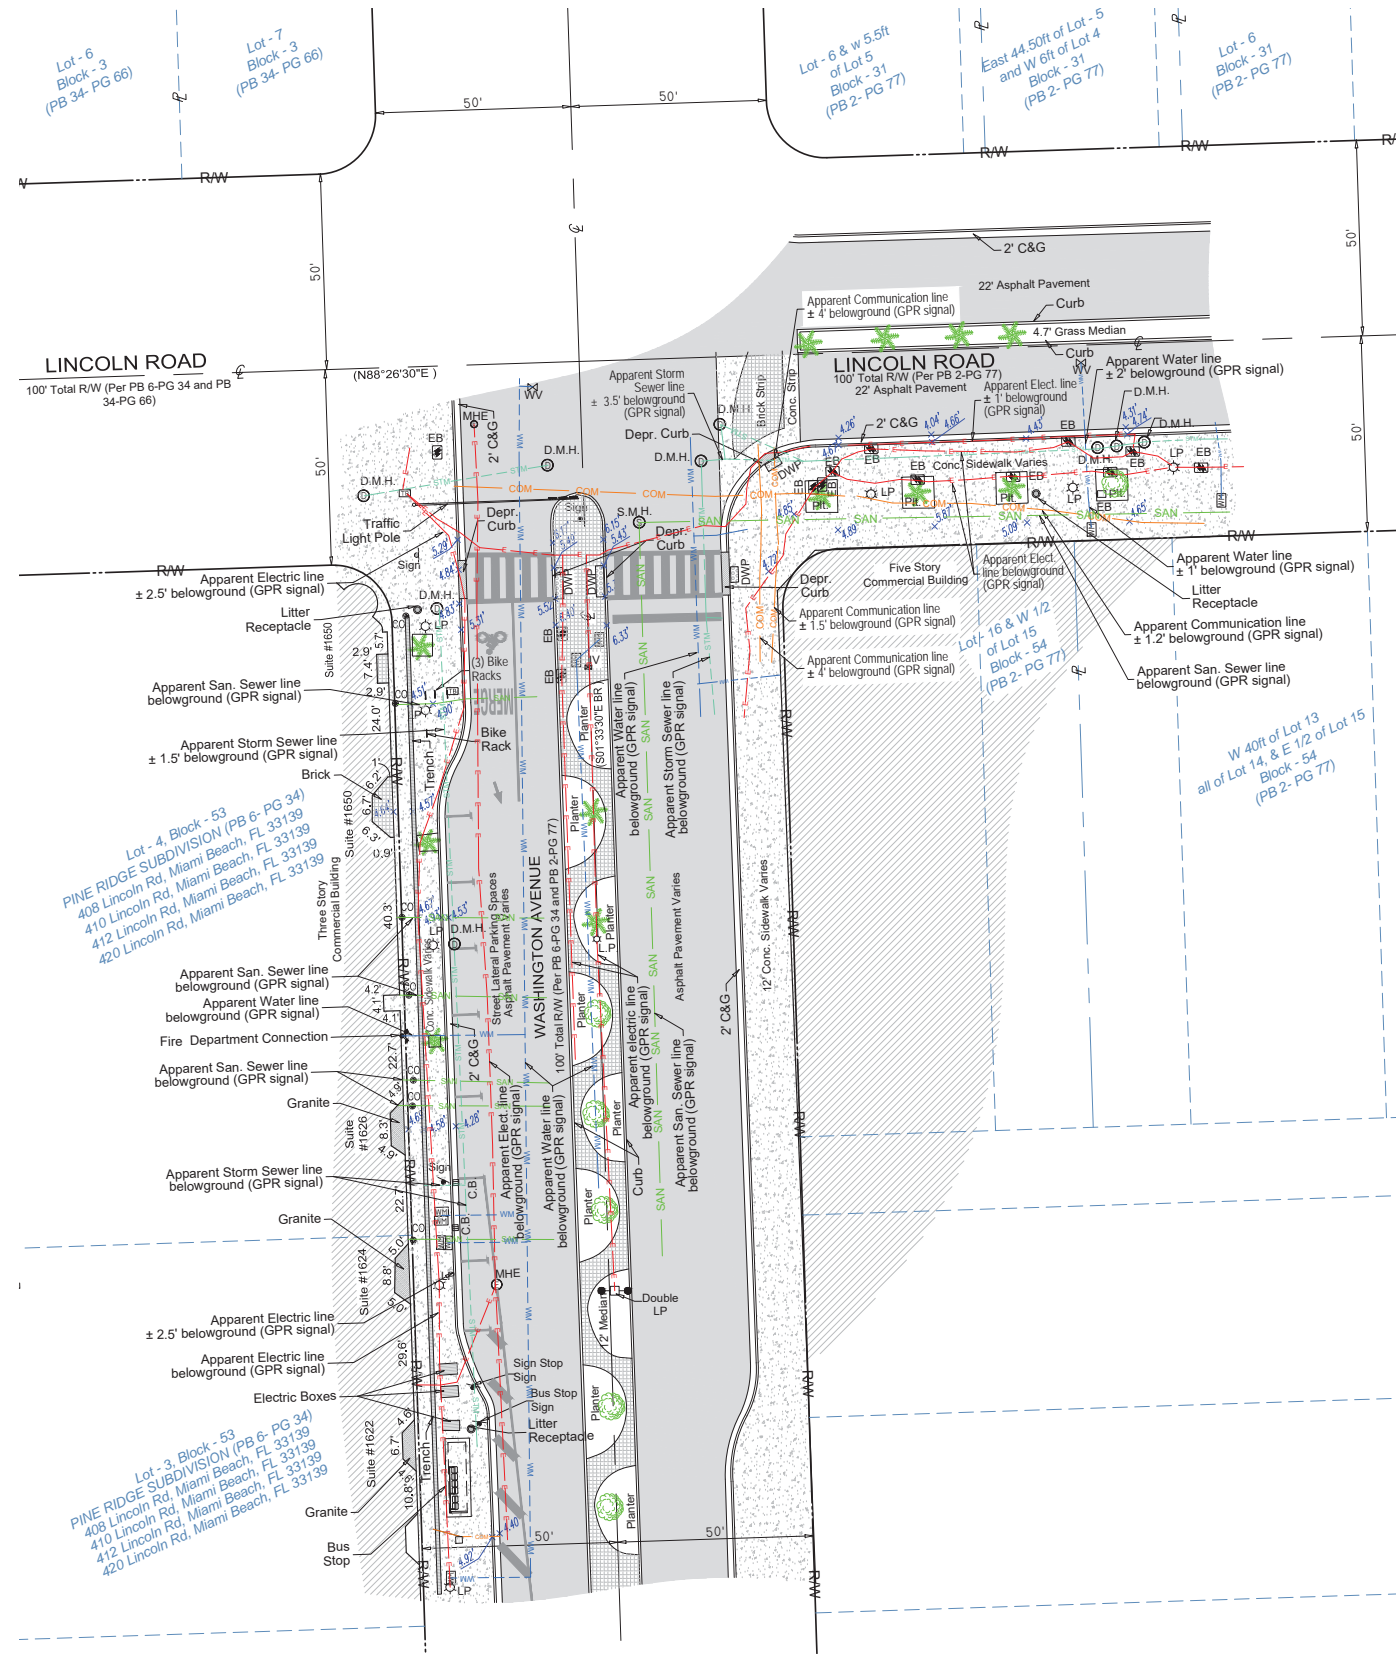

LEGEND & ABBREVIATIONS

- = CONCRETE (CONC.)
- = WOOD DECK
- = COVERED AREA
- = ASPHALT
- = TILE
- = PAVERS
- = STONE
- = CHAIN LINK FENCE (CLF)
- = WOOD FENCE (WF)
- = IRON METAL BARS FENCE (IF)
- = OVERHEAD WIRES
- = SEWER VALVE (S.V.)
- = POWER POLE (PP)
- = GUY ANCHOR
- = WATER METER (WM)
- = CONC. LIGHT POLE (LP)
- = ELECTRIC BOX (EB)
- = STREET SIGN
- = SANITARY MANHOLE
- = DRAINAGE MANHOLE
- = ELECTRIC MANHOLE
- = FIRE HYDRANT
- = CABLE BOX (CATV)
- = TRAFFIC BOX
- = CATCH BASIN OR INLET
- = EXISTING ELEVATION
- = BOX TELEPHONE
- = STREET LIGHT BOX
- = PALM (NO IDENTIFIED)
- = TREE (NO IDENTIFIED)
- PT = POINT OF TANGENCY
- PC = POINT OF CURVATURE
- PCC = POINT OF COMPOUND CURVE
- PRC = POINT OF REVERSE CURVE
- BM = BENCH MARK
- BR = BEARING REFERENCE
- DWP = DETECTABLE WARNING PAD
- DEPR. = DEPRESSED
- E = PROPERTY LINE
- C = CENTER LINE
- B = BASE LINE
- PSM = PROFESSIONAL SURVEYOR AND MAPPER
- C&G = CURB & GUTTER
- GA = GUY ANCHOR
- ENCR = ENCROACHMENT
- VG = VALLEY GUTTER
- (XX-XX) = DENOTES PLAT BOOK XX - PAGE XX
- ORB = OFFICIAL RECORD BOOK
- CBS = CONCRETE BLOCK STRUCTURE
- R/W = RIGHT OF WAY
- ELEV = ELEVATION
- SEC = SECTION
- T = TOWNSHIP
- R = RANGE
- (M) = FIELD MEASURED
- (C) = CALCULATED
- (R) = RECORD
- (P) = PER PLAT

BELLO & BELLO LAND SURVEYING
 12230 SW 131 AVENUE • SUITE 201 • MIAMI FL 33186
 Phone: 305.251.9606 • Fax: 305.251.6057 • LB#7262
 e-mail: info@belloland.com • www.bellolandsurveying.com

Additional deletions to this Survey Map are prohibited. This Survey Map and Report are not valid without the signature and original raised seal or without the authenticated electronic signature and seal of the undersigned Florida licensed Surveyor and Mapper.

Property Address:
 Washington Avenue & Lincoln Road, Miami Beach, Florida 33139
 Project No. 23182 D.B.: EO Page 1 of 1



7. Lincoln Rd & Washington Ave



MIAMI BEACH

PUBLIC WORKS DEPARTMENT
INTERACTIVE DIGITAL KIOSK DEPLOYMENT PROJECT
OCTOBER 2023
IKE SMART CITY
MIB-023: COLLINS AVENUE (SR-A1A) & LINCOLN ROAD
MIB-024: COLLINS AVENUE (SR-A1A) & 16TH STREET

CITY OF MIAMI BEACH

MAYOR: DAN GELBER


COMMISSIONERS: MICKY STEINBERG
 MARK SAMUELIAN
 MICHAEL GONGORA
 STEVEN MEINER
 RICKEY ARRIOLA
 DAVID RICHARDSON

CITY MANAGER: ALINA T. HUDAK

CITY ATTORNEY: RAFAEL A. PAZ

PUBLIC WORKS DIRECTOR: JOE GOMEZ, P.E., F.FES

CITY ENGINEER: NELSON PEREZ-JACOME, PE

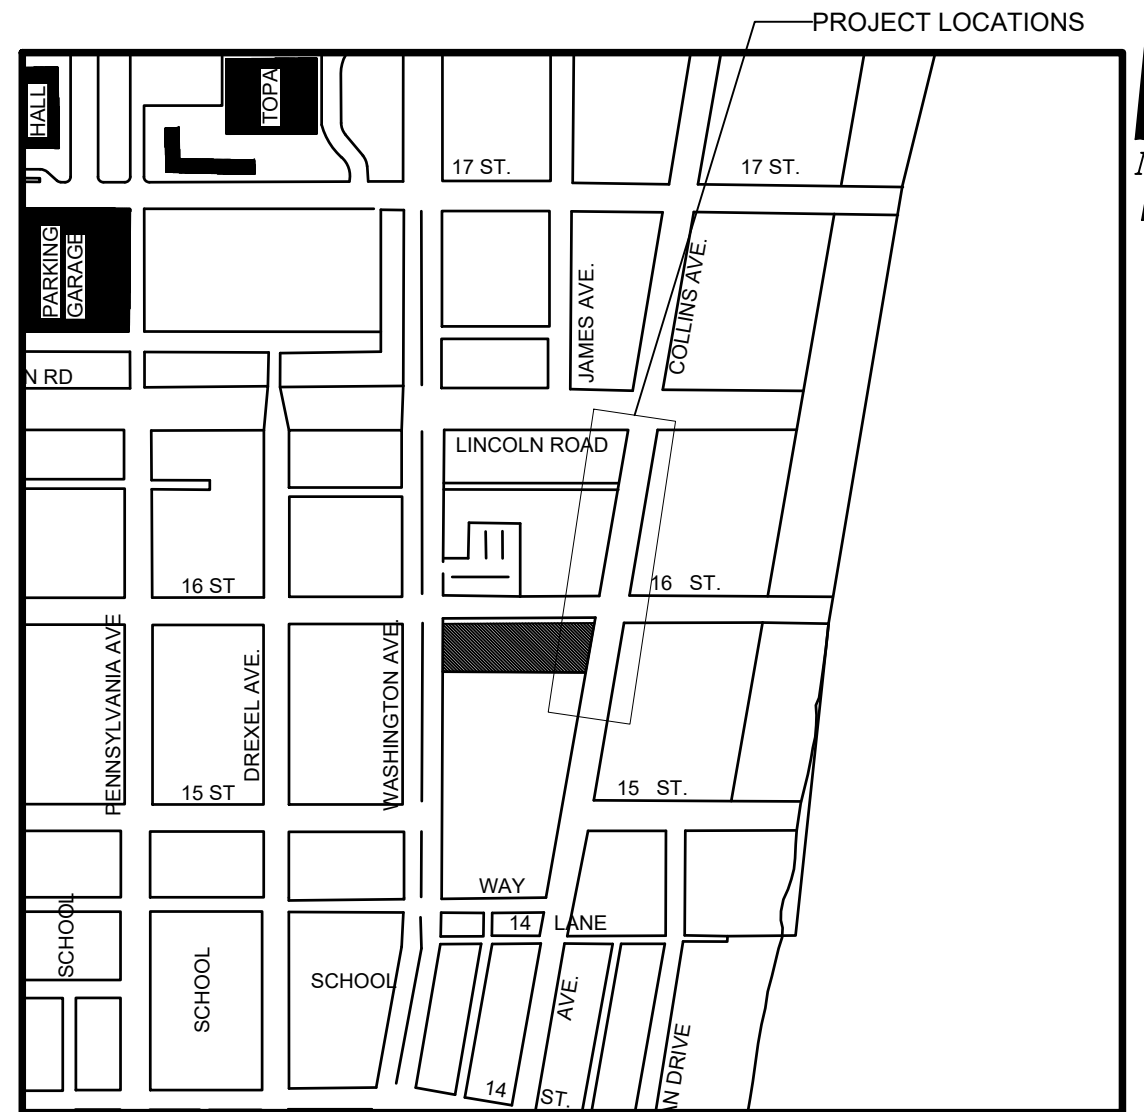

LOCATION MAP



INDEX OF PLANS

NUMBER	DISCIPLINE	SHEET NO.	DESCRIPTION	NOTES
1	GENERAL	G0-03	INDEX OF SHEETS	
2	GENERAL	G0-04	ADA NOTES, SCOPE OF WORK & KIOSK SPECIFICATIONS	
3	CIVIL	C1-01	CIVIL SITE PLAN	
4	CIVIL	C1-02	KIOSK MIB-023 ENGINEERING PLAN	
5	CIVIL	C1-03	KIOSK MIB-024 ENGINEERING PLAN	
6	ELECTRICAL	E0-01	ELECTRICAL SITE PLAN	
7	ELECTRICAL	E1-01	KIOSK MIB-023 ELECTRICAL PLAN	
8	ELECTRICAL	E1-02	KIOSK MIB-024 ELECTRICAL PLAN	
9	SURVEY		KIOSK MIB-023 & MIB-024 SITE SURVEY	


SCOPE OF WORK: THE PROJECT CONSISTS OF THE INSTALLATION OF TWO (2) DIGITAL INTERACTIVE KIOSK AND APPLICABLE INFRASTRUCTURE; STRUCTURAL FOUNDATION AND ELECTRICAL SERVICE AT THE LOCATION INDICATED ON THESE DESIGN PLANS.

FINAL SUBMITTAL 10/09/2023



INDEX OF PLANS

NUMBER	DISCIPLINE	SHEET NO.	DESCRIPTION	NOTES
1	GENERAL	G0-03	INDEX OF SHEETS	
2	GENERAL	G0-04	ADA NOTES, SCOPE OF WORK & KIOSK SPECIFICATIONS	
3	CIVIL	C1-01	CIVIL SITE PLAN	
4	CIVIL	C1-02	KIOSK MIB-023 ENGINEERING PLAN	
5	CIVIL	C1-03	KIOSK MIB-024 ENGINEERING PLAN	
6	ELECTRICAL	E0-01	ELECTRICAL SITE PLAN	
7	ELECTRICAL	E1-01	KIOSK MIB-023 ELECTRICAL PLAN	
8	ELECTRICAL	E1-02	KIOSK MIB-024 ELECTRICAL PLAN	
9	SURVEY		KIOSK MIB-023 & MIB-024 SITE SURVEY	

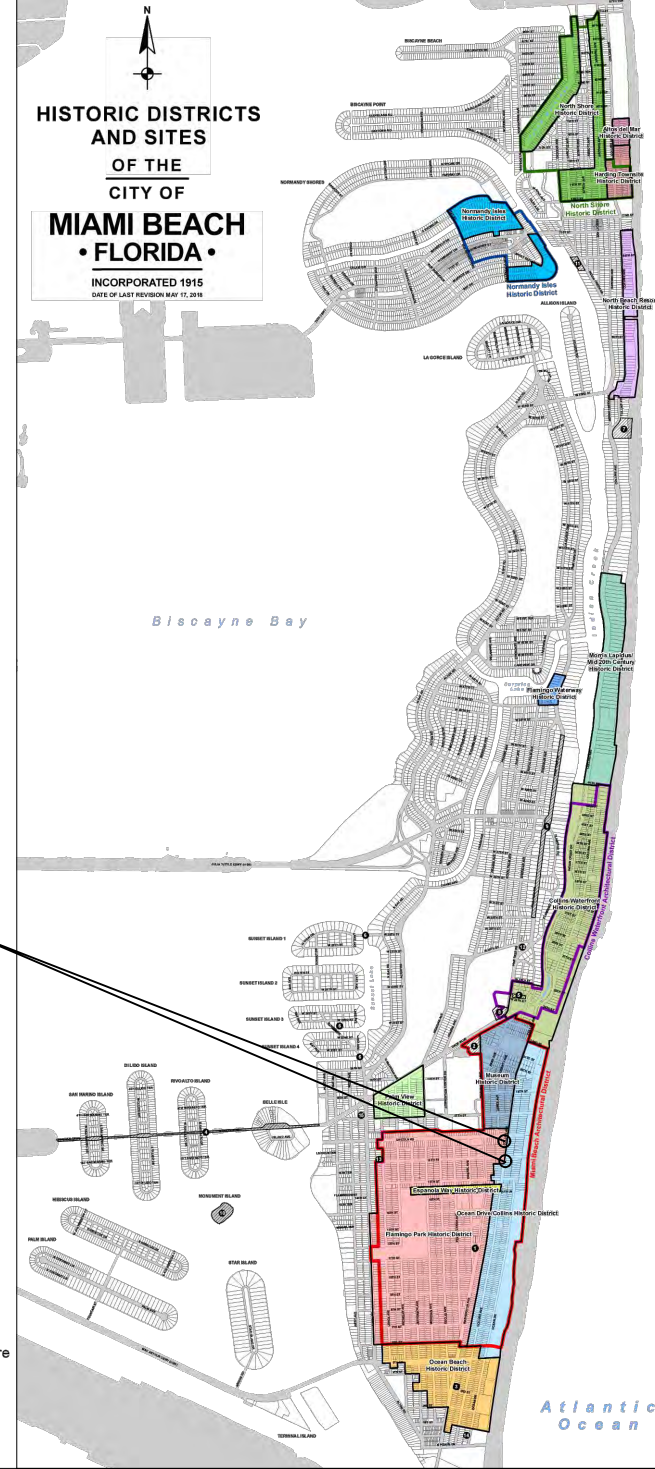

LEGEND AND ABBREVIATIONS

- = PALM TREE
- = TREE
- = ORNAMENTAL TREE
- O.R.B. = OFFICIAL RECORDS BOOK
- PG. = PAGE
- ELEV. = ELEVATION
- TYP. = TYPICAL
- CATV = CABLE TELEVISION
- OHE = OVERHEAD ELECTRIC LINE
- X 0.00 = SPOT ELEVATION
- CONC. = CONCRETE
- C.B.S. = CONCRETE BLOCK STUCCO
- C.L.F. = CHAIN LINK FENCE
- W.F. = WOOD FENCE
- M.F. = METAL FENCE
- RCP = REINFORCED CONCRETE PIPE
- FF = FINISH FLOOR
- (R) = RECORD
- (C) = CALCULATED
- (M) = MEASURE
- LB = LICENSE BUSINESS
- L = LENGTH
- Δ = CENTRAL ANGLE
- R = RADIUS
- T = TANGENT
- PT = POINT OF TANGENCY
- PC = POINT OF CURVATURE
- STA. = STATION
- PI = POINT OF INTERSECTION
- ID = IDENTIFICATION
- MLP = METAL LIGHT POLE
- CLP = CONCRETE LIGHT POLE
- R/W = RIGHT-OF-WAY
- P.B. = PLAT BOOK
- = SECTION LINE
- = CENTERLINE
- = BASELINE
- = MONUMENT LINE
- = TRAFFIC SIGNAL BOX
- = TRAFFIC SIGNAL CABINET
- = BOLLARD
- = PEDESTRIAN SIGNAL
- = TRAFFIC SIGNAL MAST ARM
- = SIGN
- = CABLE TELEVISION BOX
- = LIGHT POLE
- = ELECTRIC BOX
- = UTILITY POLE
- = ELECTRIC TRANSFORMER
- = GUY ANCHOR
- = ELECTRIC MANHOLE
- = ELECTRIC METER
- = GAS VALVE
- = GAS UTILITY BOX
- = GAS MANHOLE
- = GAS TANK
- = GAS METER
- = COMMUNICATION BOX
- = COMMUNICATION MANHOLE
- = GARBAGE RECEPTACLE
- = HANDICAP PARKING SPACE
- = WATER METER
- = IRRIGATION VALVE
- = WATER VALVE
- = FIRE HYDRANT
- = WATER BOX
- = WATER CONNECTION
- = WATER MANHOLE
- = WATER TANK
- = WATER WELL
- = WATER MARKING FLAG
- = WATER MARKING SIGN
- = STORM MANHOLE
- = STORM METER
- = CATCH BASIN
- = TELEPHONE MANHOLE
- = TELEPHONE BOX
- = NEWSPAPER DISPENSER
- = MAILBOX
- = SANITARY MANHOLE
- = SANITARY BOX
- = SANITARY TANK
- = SANITARY LIFT STATION
- = GREASE TRAP MANHOLE
- = CLEANOUT
- = PARKING METER
- = FIBER OPTIC BOX
- = FIBER OPTIC MARKER SIGN
- = MONITORING WELL
- = FUEL TANK
- = UNKNOWN UTILITY BOX
- = UNKNOWN UTILITY METER
- = UNKNOWN UTILITY MANHOLE
- = UNKNOWN UTILITY VALVE
- = UNKNOWN UTILITY MARKER FLAG
- = SANITARY VALVE
- = RAILROAD SIGN
- = FLAGPOLE
- = PROPERTY LINE
- = ELECTRICAL OUTLET

PROJECT LOCATIONS
MIB-023: FLAMINGO PARK HISTORIC DISTRICT
MIB-024: OCEAN DRIVE/COLLINS AVENUE HISTORIC DISTRICT

LOCAL HISTORIC DISTRICTS

	Espanola Way Historic District		Palm View Historic District
	Altos del Mar Historic District		Collins Waterfront Historic District
	Flamingo Park Historic District		North Beach Resort Historic District
	Ocean Drive/Collins Avenue Historic District		Flamingo Waterway Historic District
	Museum Historic District		Morris Lapidus/Mid 20th Century Historic District
	Ocean Beach Historic District		North Shore Historic District
	Harding Townsite Historic District		Normandy Isles Historic District

NATIONAL REGISTER HISTORIC DISTRICTS

	Miami Beach Architectural District
	Normandy Isles Historic District
	North Shore Historic District
	Collins Waterfront Architectural District

LOCAL HISTORIC SITES

	1 Old City Hall Historic Site		8 Dade Blvd Fire Station Historic Site
	2 21st St Recreation Center Historic Site		9 PineTree Dr Historic Roadway
	3 Congregation Beth Jacob Historic Site		10 Flagler Memorial and Monument Island Historic Site
	4 Venetian Causeway Historic Site		11 69th St Fire Station Historic Site
	5 Miami Beach Woman's Club Historic Site		12 28th St Obelisk and Pumping Station Historic Structure
	6 Sunset Island Bridges Historic Structures		13 1600 Lenox Ave Historic Site
	7 The Bath Club Historic Site		14 36 Ocean Dr Historic Site
			15 1700 Alton Rd Historic Site

PROJECT DIRECTORY:

PROJECT NAME:
INTERACTIVE DIGITAL INFORMATION
KIOSKS DEPLOYMENT PROJECT

JURISDICTION:
CITY OF MIAMI
DEPARTMENT OF RESILIENCE AND
PUBLIC WORKS
MIAMI RIVERSIDE CENTER
444 S.W. 2nd AVENUE, 8th FLOOR
MIAMI, FLORIDA 33130
TEL: 305-416-1200

OWNER:
IKE SMART CITY
250 N HARTOFORD AVE
COLUMBUS, OH 43222
(614) 589-0087

ENGINEER OF RECORD:
MAINSTREET ENGINEERING
7035 SW 47 STREET, SUITE A
MIAMI, FL 33155
(305) 456-3505
PROJ. MGR: VANESSA MELA, P.E.
VMELA@MAINSTREETENG.COM

KIOSK MANUFACTURER:
DISPLAY DEVICE INC.
21075 WESTGATE RD.
GOLDEN, CO 80403
CONTACT: ERIC PERKINS
PHONE: (303) 929-4071


UTILITIES:
ELECTRICAL POWER: FLORIDA
POWER & LIGHT COMPANY (FPL)
WATER & SEWER: MIAMI-DADE
WATER & SEWAGE DEPARTMENT

TELEPHONE: AT&T
CABLE: COMCAST, XFINITY,
ATT-UVERSE
GAS: FLORIDA GAS


SIDEWALK & STREET SYMBOLS

	ASPHALT		BRICK
	PAVER		CONCRETE
	UNIMPROVED		TILE
	GRAVEL		STAMPED CONCRETE

KEY PLAN (NOT TO SCALE):

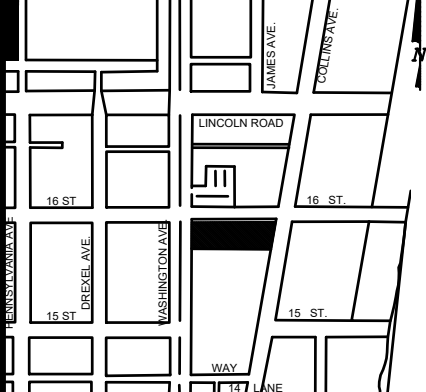

P.E. SEAL:

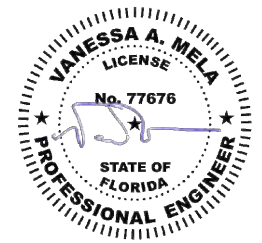

ADA NOTES

- ALL CONSTRUCTION ACTIVITIES SHALL BE COMPLETED IN FULL COMPLIANCE WITH THE AMERICANS WITH DISABILITIES ACT (ADA). CLEAR SPACES IN FRONT OF KIOSK SHALL HAVE THE FOLLOWING CHARACTERISTICS:
- SURFACES SHALL BE FIRM, STABLE, AND SLIP RESISTANT AND OTHERWISE COMPLY WITH PROWAG SECTION R302.7 AND SHALL HAVE A RUNNING SLOPE CONSISTENT WITH GRADE OF THE ADJACENT PEDESTRIAN ACCESS ROUTE AND CROSS SLOPE OF 1.50% +/-0.50%)
- SIZE: CLEAR SPACES SHALL BE 48" MINIMUM BY 48" MINIMUM.
- POSITION: UNLESS OTHERWISE SPECIFIED, CLEAR SPACES SHALL BE POSITIONED FOR EITHER FORWARD OR PARALLEL APPROACH TO THE KIOSK.
- APPROACH: ONE FULL UNOBSTRUCTED SIDE OF A CLEAR SPACE SHALL ADJOIN A PEDESTRIAN ACCESS ROUTE OR ADJOIN ANOTHER CLEAR SPACE.
- MANEUVERING SPACE: WHERE A CLEAR SPACE IS CONFINED ON ALL OR PART OF THREE SIDES, ADDITIONAL MANEUVERING SPACE SHALL BE PROVIDED AS FOLLOWS:
 - FORWARD APPROACH: THE CLEAR SPACE AND ADDITIONAL MANEUVERING SPACE SHALL BE 36" WIDE MINIMUM WHERE THE DEPTH OF THE CONFINING ELEMENT EXCEEDS 24".
 - PARALLEL APPROACH: THE CLEAR SPACE AND ADDITIONAL MANEUVERING SPACE SHALL BE 60" WIDE MINIMUM WHERE THE DEPTH OF THE CONFINING ELEMENT EXCEEDS 15".
- THE MINIMUM WHEELCHAIR PASSAGE WIDTH OR CLEAR SPACE WIDTH FOR A SINGLE WHEELCHAIR PASSAGE SHALL BE 48" PER PROWAG SECTION R302.3.
- INITIAL OPERATION FOR THE KIOSK WILL HAVE 4G LTE CONNECTION SECTION R404. TO THE INTERNET.
- THE KIOSKS HAVE BEEN DESIGN TO COMPLY WITH ALL ADA GUIDELINES INCLUDING VIEWING, OPERATION, AND ACCESSIBILITY.
- THE MOBILE IKE EXPERIENCE WILL FOLLOW WEB CONTENT ACCESSIBILITY GUIDELINES (WCAG) TO WORK IN TANDEM WITH THE NATIVE ACCESSIBILITY FEATURES ON THE USER'S MOBILE DEVICE, INCLUDING TALKBACK AND VOICEOVER TOOLS.

SCOPE OF WORK

THE PROJECT CONSIST OF THE INSTALLATION OF TWO (2) DIGITAL INTERACTIVE KIOSKS AT THE LOCATION(S) INDICATED ON THIS PLANS SET. INSTALLER SHALL PROVIDE AND INCLUDE ALL WORKMANSHIP AND MATERIALS NECESSARY TO COMPLETE THE INSTALLATION INCLUDING BUT NOT LIMITED TO:


- INSTALLATION OF THE KIOSKS TO THE FOUNDATION AS INDICATED ON PLANS TO NEW RECTANGULAR CONCRETE FOUNDATION.
- ELECTRICAL SERVICE POINTS ARE EXISTING. CONNECT THE EXISTING ELECTRIC SERVICE TO THE NEW KIOSK AS INDICATED ON PLANS.
- TESTING OF THE ELECTRICAL SERVICE INFRASTRUCTURE SHALL BE PERFORMED IN CONJUNCTION WITH A REPRESENTATIVE OF THE ENGINEER OF RECORD.
- THE CONTRACTOR SHALL INSTALL THE KIOSK IN SUCH A WAY THAT THE KIOSK IS WITHIN THE PUBLIC R.O.W. AND IN COMPLIANCE WITH ALL APPLICABLE A.D.A. REQUIREMENTS
- THE LOCATION OF KIOSKS HAS BEEN COORDINATE TO ENSURE THERE IS NO OBSTRUCTION OF THE SIGHT OF VEHICULAR SIGNS.
- STAND-ALONE PEDESTRIAN KIOSKS SHOULD NOT BE INSTALLED WITHIN PEDESTRIAN CIRCULATION PATHS IN A MANNER THAT PERSONS AT THE KIOSK LOCK THE EFFECTIVE WIDTH OF THE PEDESTRIAN TRAVEL WAY.

MONUMENT SIGN SPECIFICATIONS AND FUNCTIONS


THE UNIT CONSISTS OF A UL/NRTL LISTED WEATHER AND VANDAL RESISTANT FREE STANDING ENCLOSURE DESIGNED TO COMPLY WITH THE FLORIDA BUILDING CODE AND OTHER APPLICABLE CODES INCLUDING THE NATIONAL ELECTRICAL CODE. THE UNIT HAS BEEN DESIGNED TO WITHSTAND WINDS OF 165 MPH. THE UNIT'S MAIN COMPONENTS ARE:

- TWO (2) INTERACTIVE 65" VIDEO TOUCH SCREENS.
- TWO (2) CAMERAS
- ONE (1) CPU
- ONE (1) WI-FI TRANSMITTER

MANUFACTURER: DYNASCAN MODEL NUMBER: CIO651DR5
 NATIVE RESOLUTION: 1920 X 1080
 ELECTRICAL POWER REQUIREMENT:
 1. ONE-2-POLE, 20 AMP, 240 VOLTS CIRCUIT.
 2. TOTAL LOAD: 1400/2200 WATTS (OPERATIONAL/PEAK)
 3. VOLTAGE: 100-240 VOLTS AC, 50-60 HZ
 WEIGHT: 832 LBS
 CERTIFICATION CE / FCC / RoHS

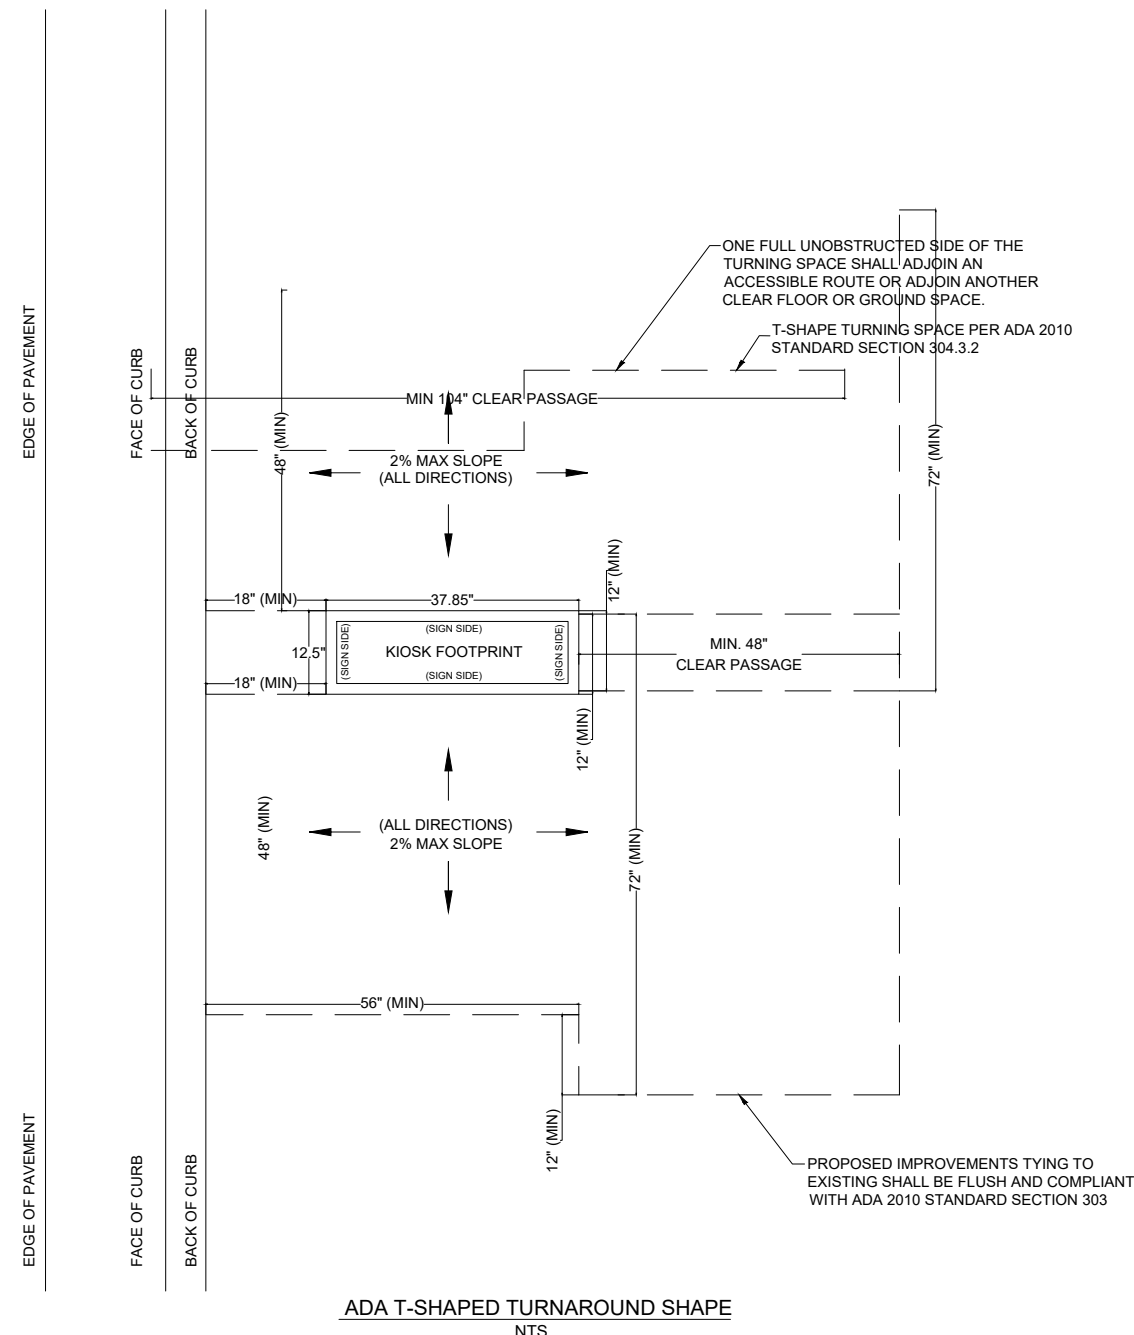

NOTES:

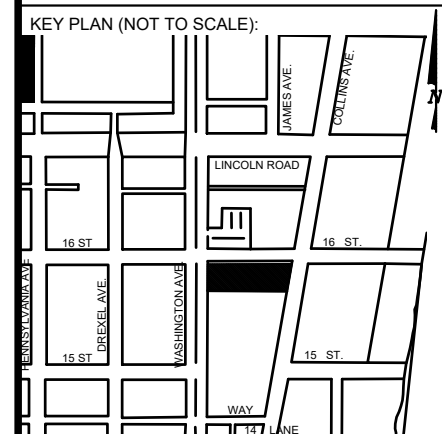

P.E. SEAL:

MIAMI BEACH
 PUBLIC WORKS DEPARTMENT
 1700 CONVENTION CENTER DRIVE, MIAMI BEACH, FL 33139

CITY MANAGER: ALINA T. HUDAK
 DIRECTOR: JOE GOMEZ, P.E.
 CITY ENGINEER: CRISTINA ORTEGA CASTINEIRAS, P.E.

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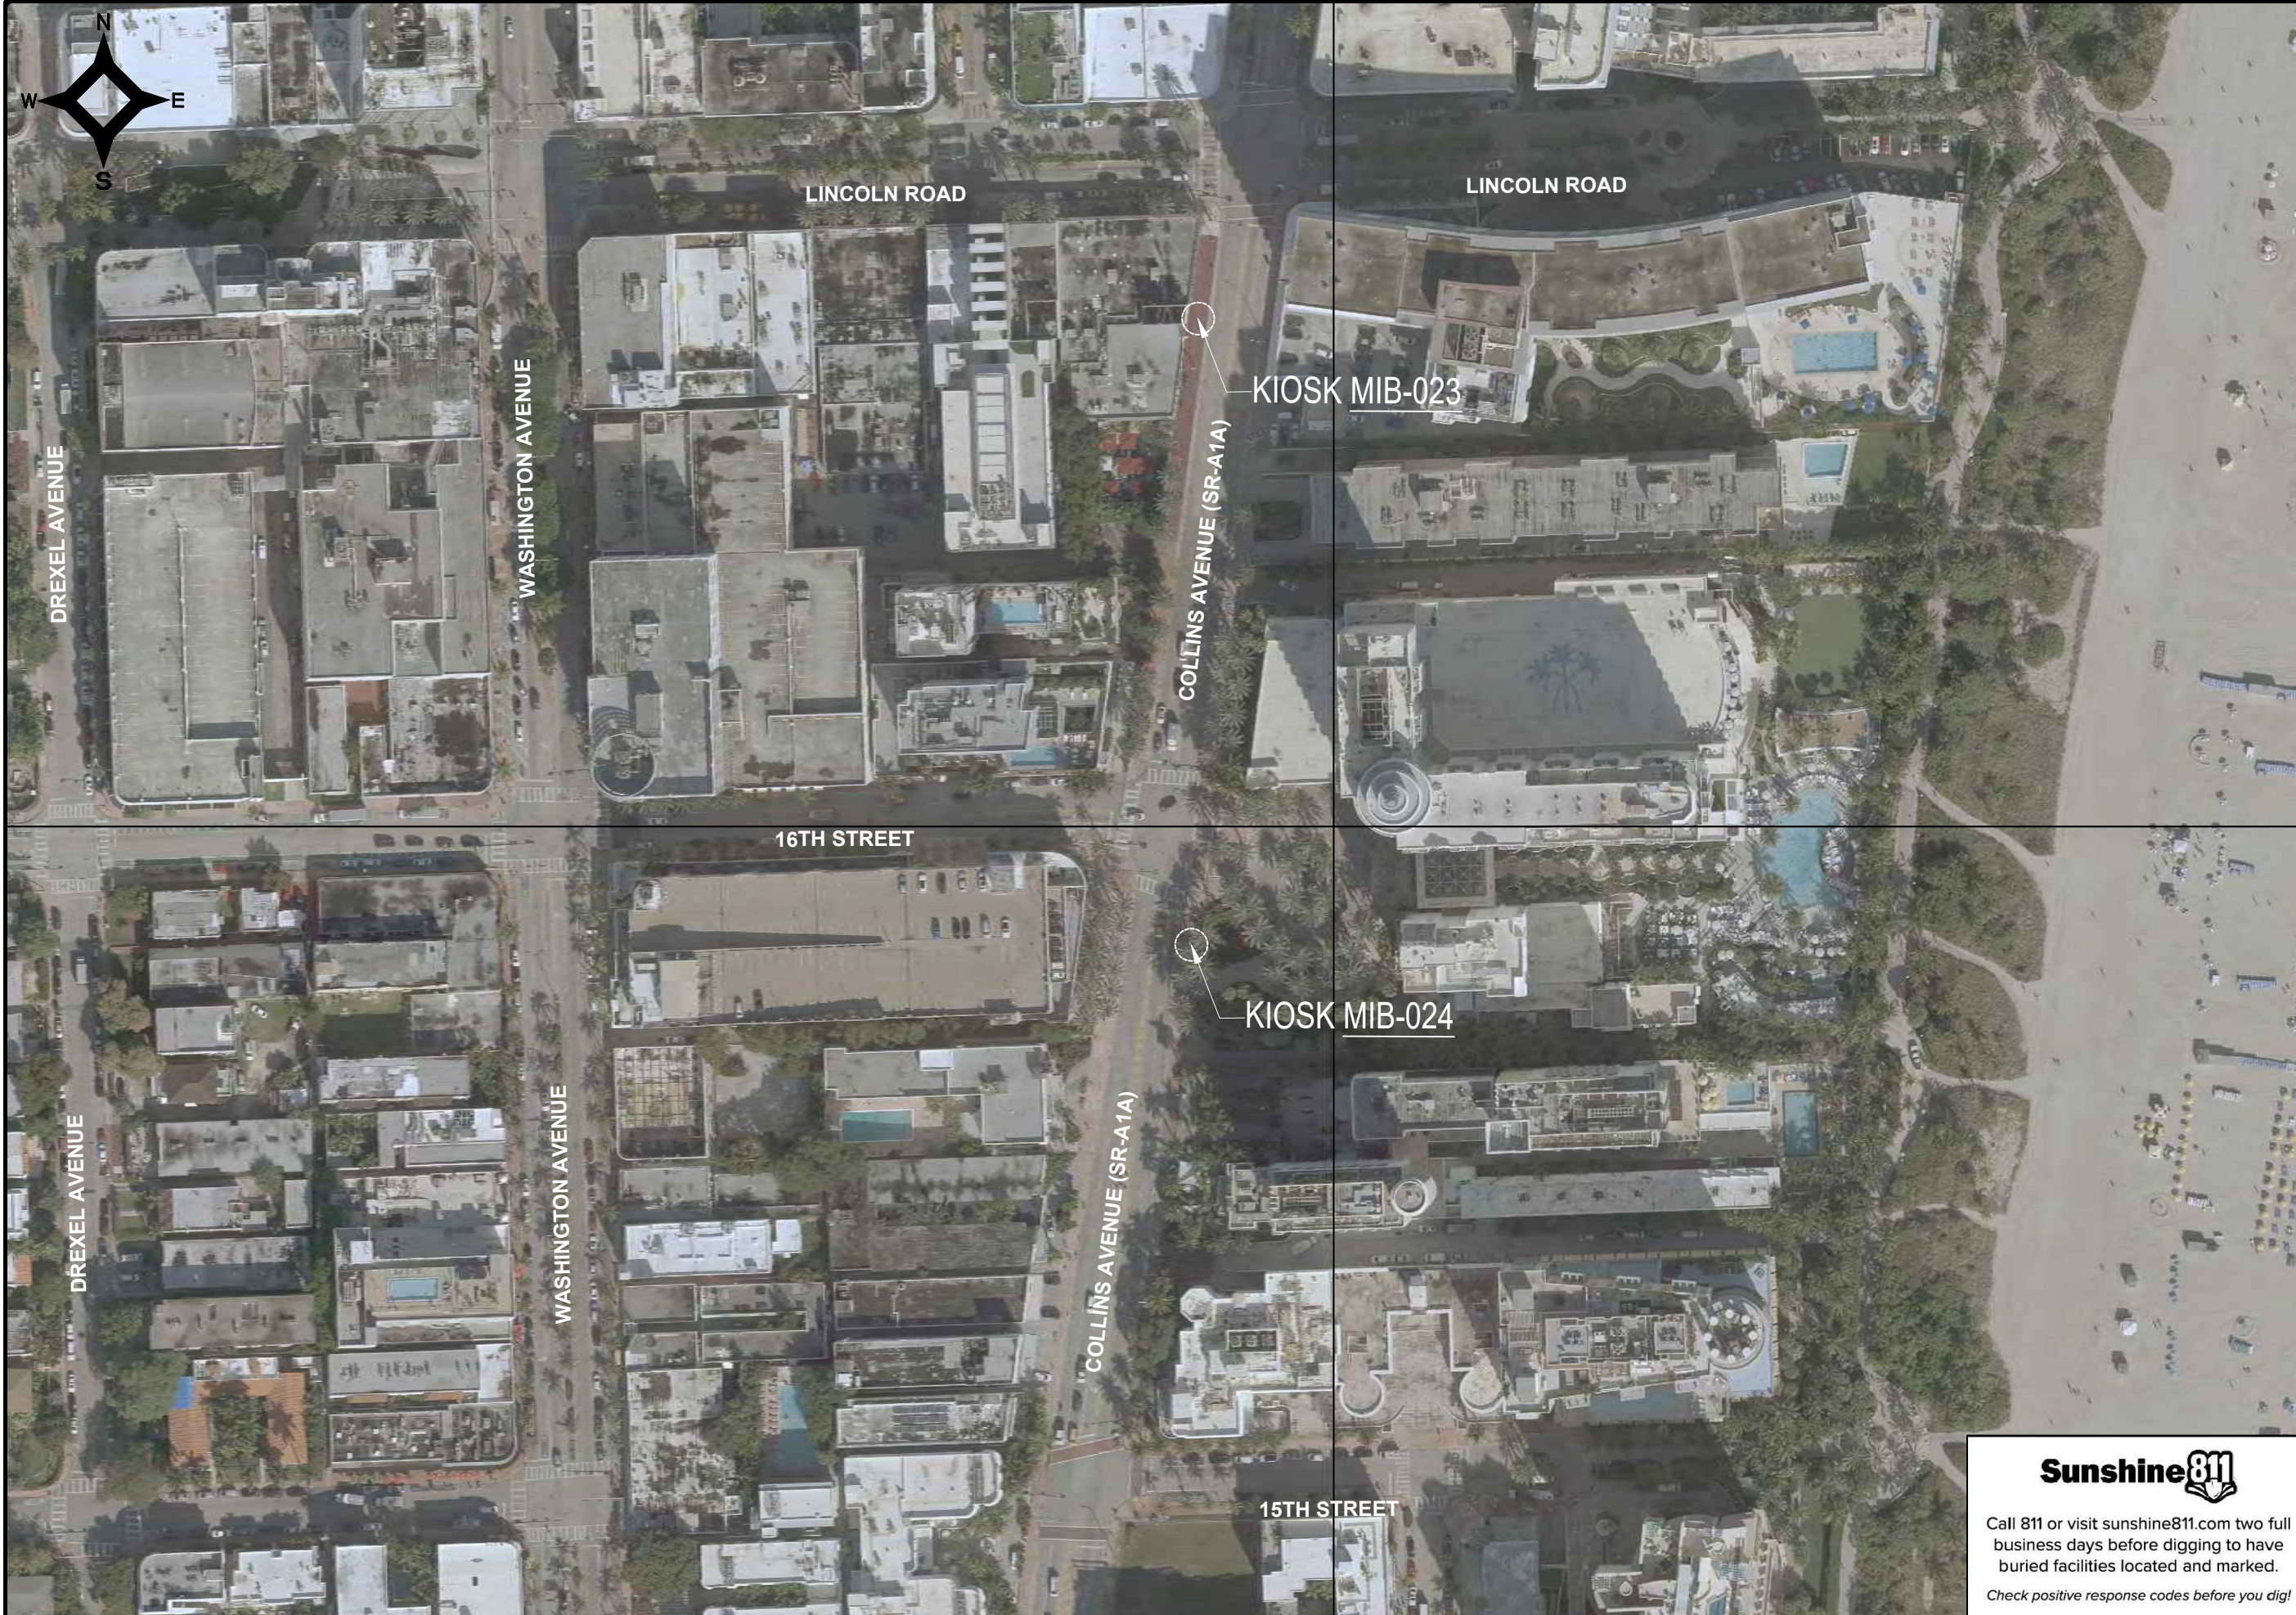
Main Street ENGINEERING
 7035 SW 47th Street, Ste A, Miami, FL 33155
 Tel: (305) 406-3055 Fax: (305) 476-9894
 FL PE Certificate No: 00008751

ENGINEER OF RECORD:
 VANESSA A. MELA,
 P.E. NO. 77676

ENGINEER OF RECORD: VM
 DESIGN ENGINEER: VM
 DRAWN BY: KM
 CHECKER: WP
 SCALE:


NEIGHBORHOOD: MIB-023: COLLINS AVENUE & LINCOLN ROAD
 MIB-024: COLLINS AVENUE & 16TH STREET
 TITLE: ADA NOTES, SCOPE OF WORK & KIOSK SPECIFICATIONS

File Name: MIB-023 & MIB-024 - GENERAL AND FOUNDATION.dwg
 Survey Reference:
 Field Book: N/A Page: N/A Work Order: N/A
 Date: 10/09/2023 Sheet: 2 of 9 Drawing: G0-04




NOTES:

KEY PLAN (NOT TO SCALE):

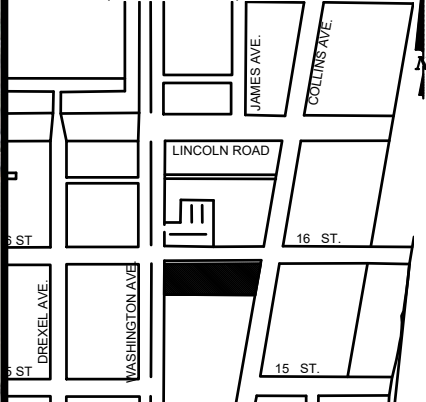

P.E. SEAL:

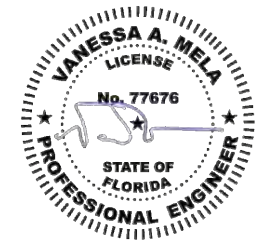

Sunshine811
 Call 811 or visit sunshine811.com two full business days before digging to have buried facilities located and marked.
 Check positive response codes before you dig!

MIAMI BEACH
 PUBLIC WORKS DEPARTMENT
 1700 CONVENTION CENTER DRIVE, MIAMI BEACH, FL 33139

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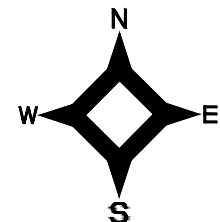
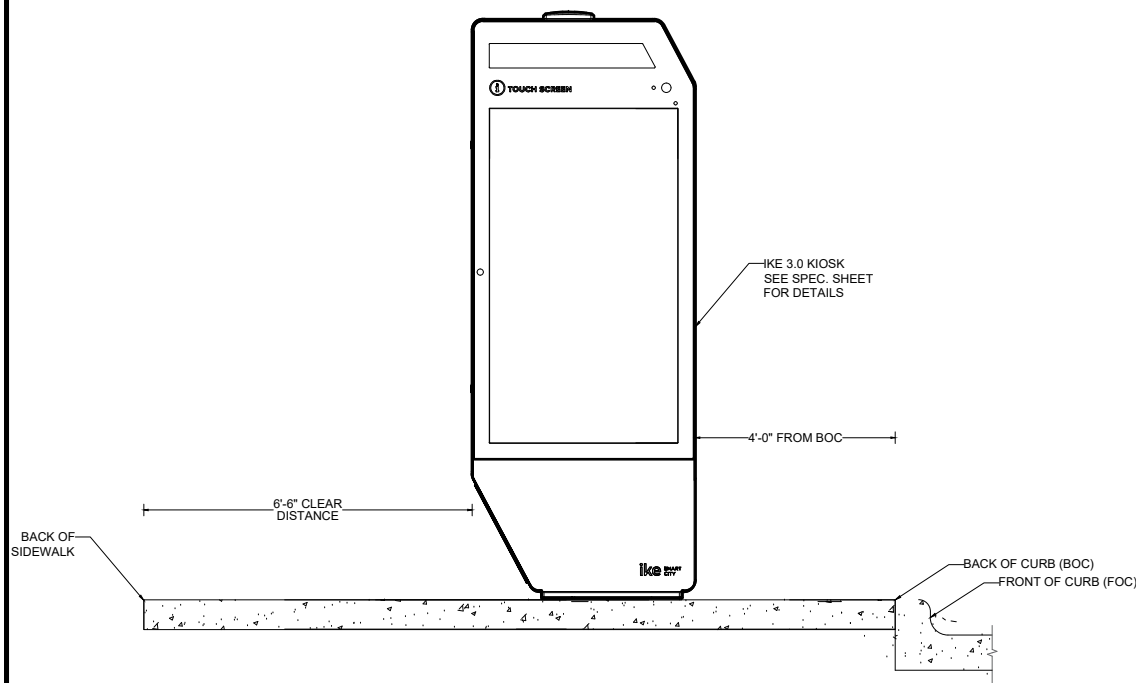
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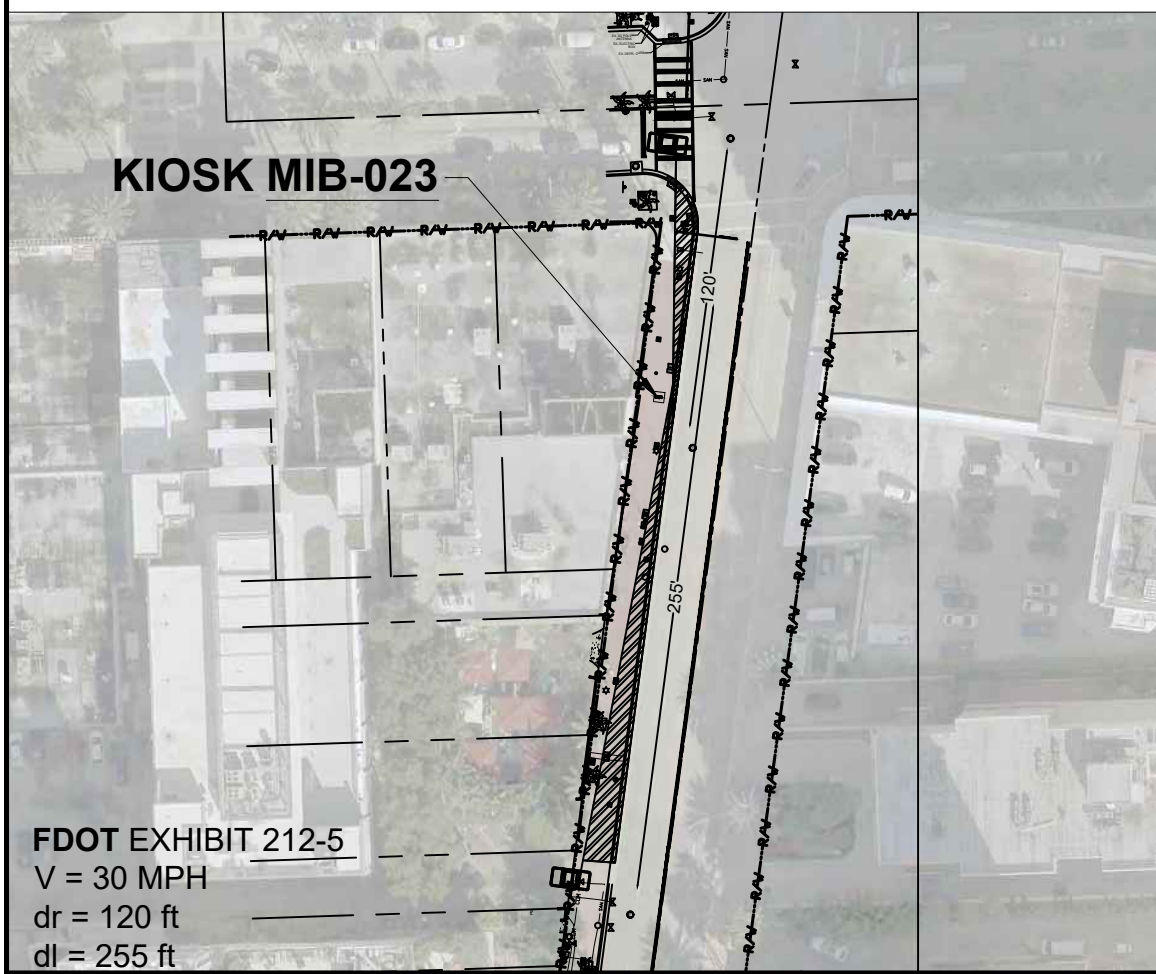
ENGINEER OF RECORD: VANESSA A. MELA, P.E. NO. 77676
 ENGINEER OF RECORD: VM
 DESIGN ENGINEER: VM
 DRAWN BY: KM
 CHECKER: WP
 SCALE:

NEIGHBORHOOD: MIB-023: COLLINS AVENUE & LINCOLN ROAD
 MIB-024: COLLINS AVENUE & 16TH STREET
 TITLE: CIVIL SITE PLAN


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 Survey Reference:
 Field Book: N/A Page: N/A Work Order: N/A
 Date: 10/09/2023 Sheet: 3 of 9 Drawing: C1-01




VISIBILITY TRIANGLE CLEARANCE ANALYSIS
SCALE: 1'-40"




6'-6" CLEAR DISTANCE
14'-6" FROM BOC TO R/W

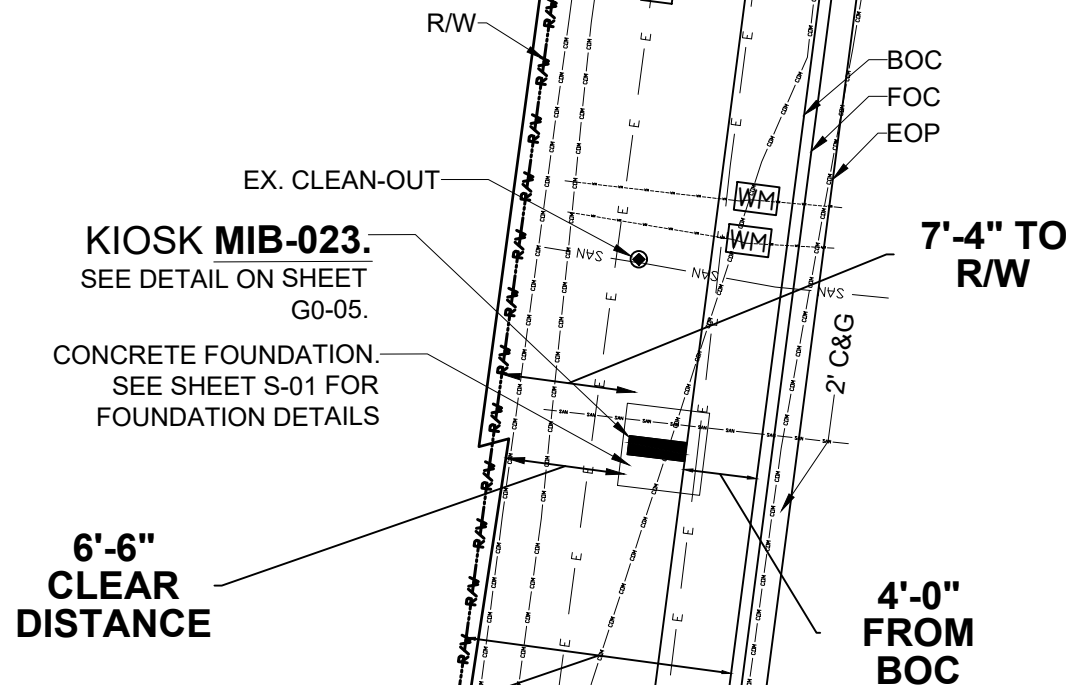

KEY PLAN (NOT TO SCALE):

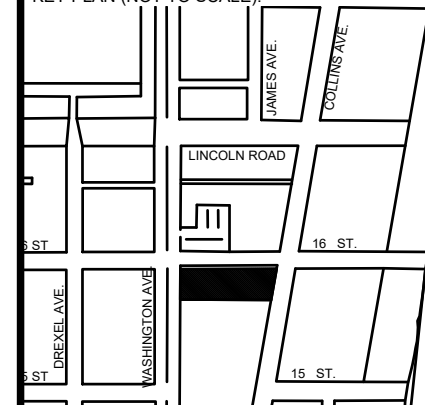


P.E. SEAL:

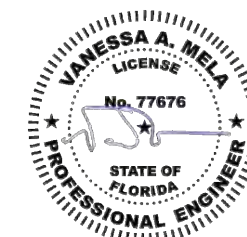


FDOT EXHIBIT 212-5
V = 30 MPH
dr = 120 ft
dl = 255 ft



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NOTES:

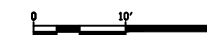


VISIBILITY TRIANGLE CLEARANCE ANALYSIS
SCALE: 1'-30"

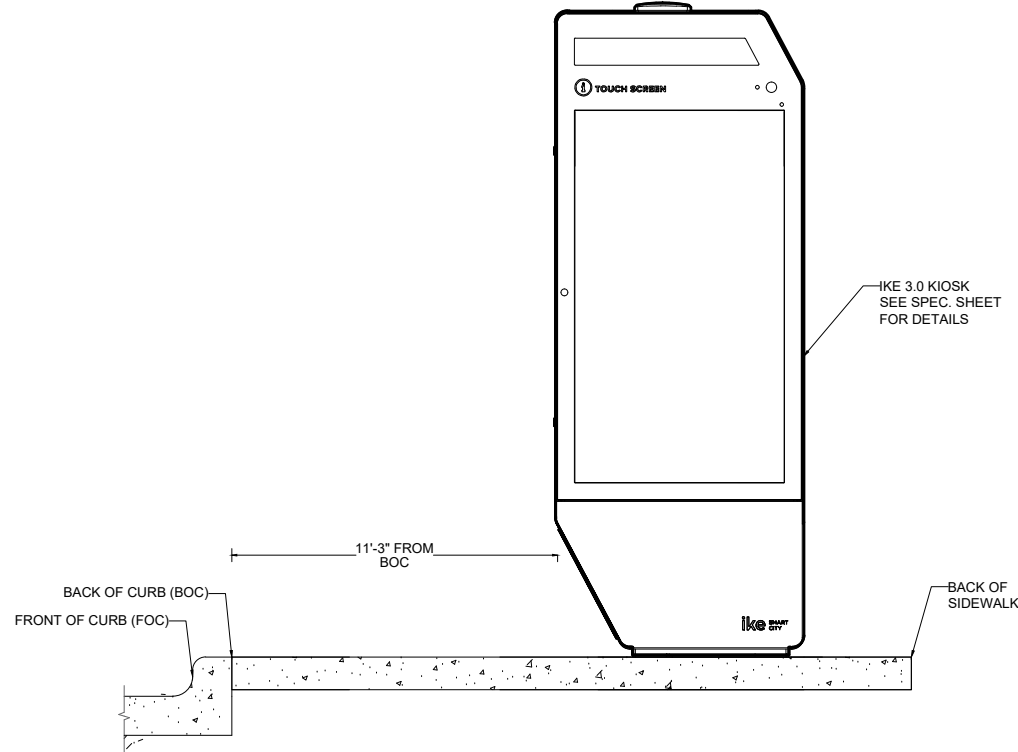

11'-3" FROM BOC

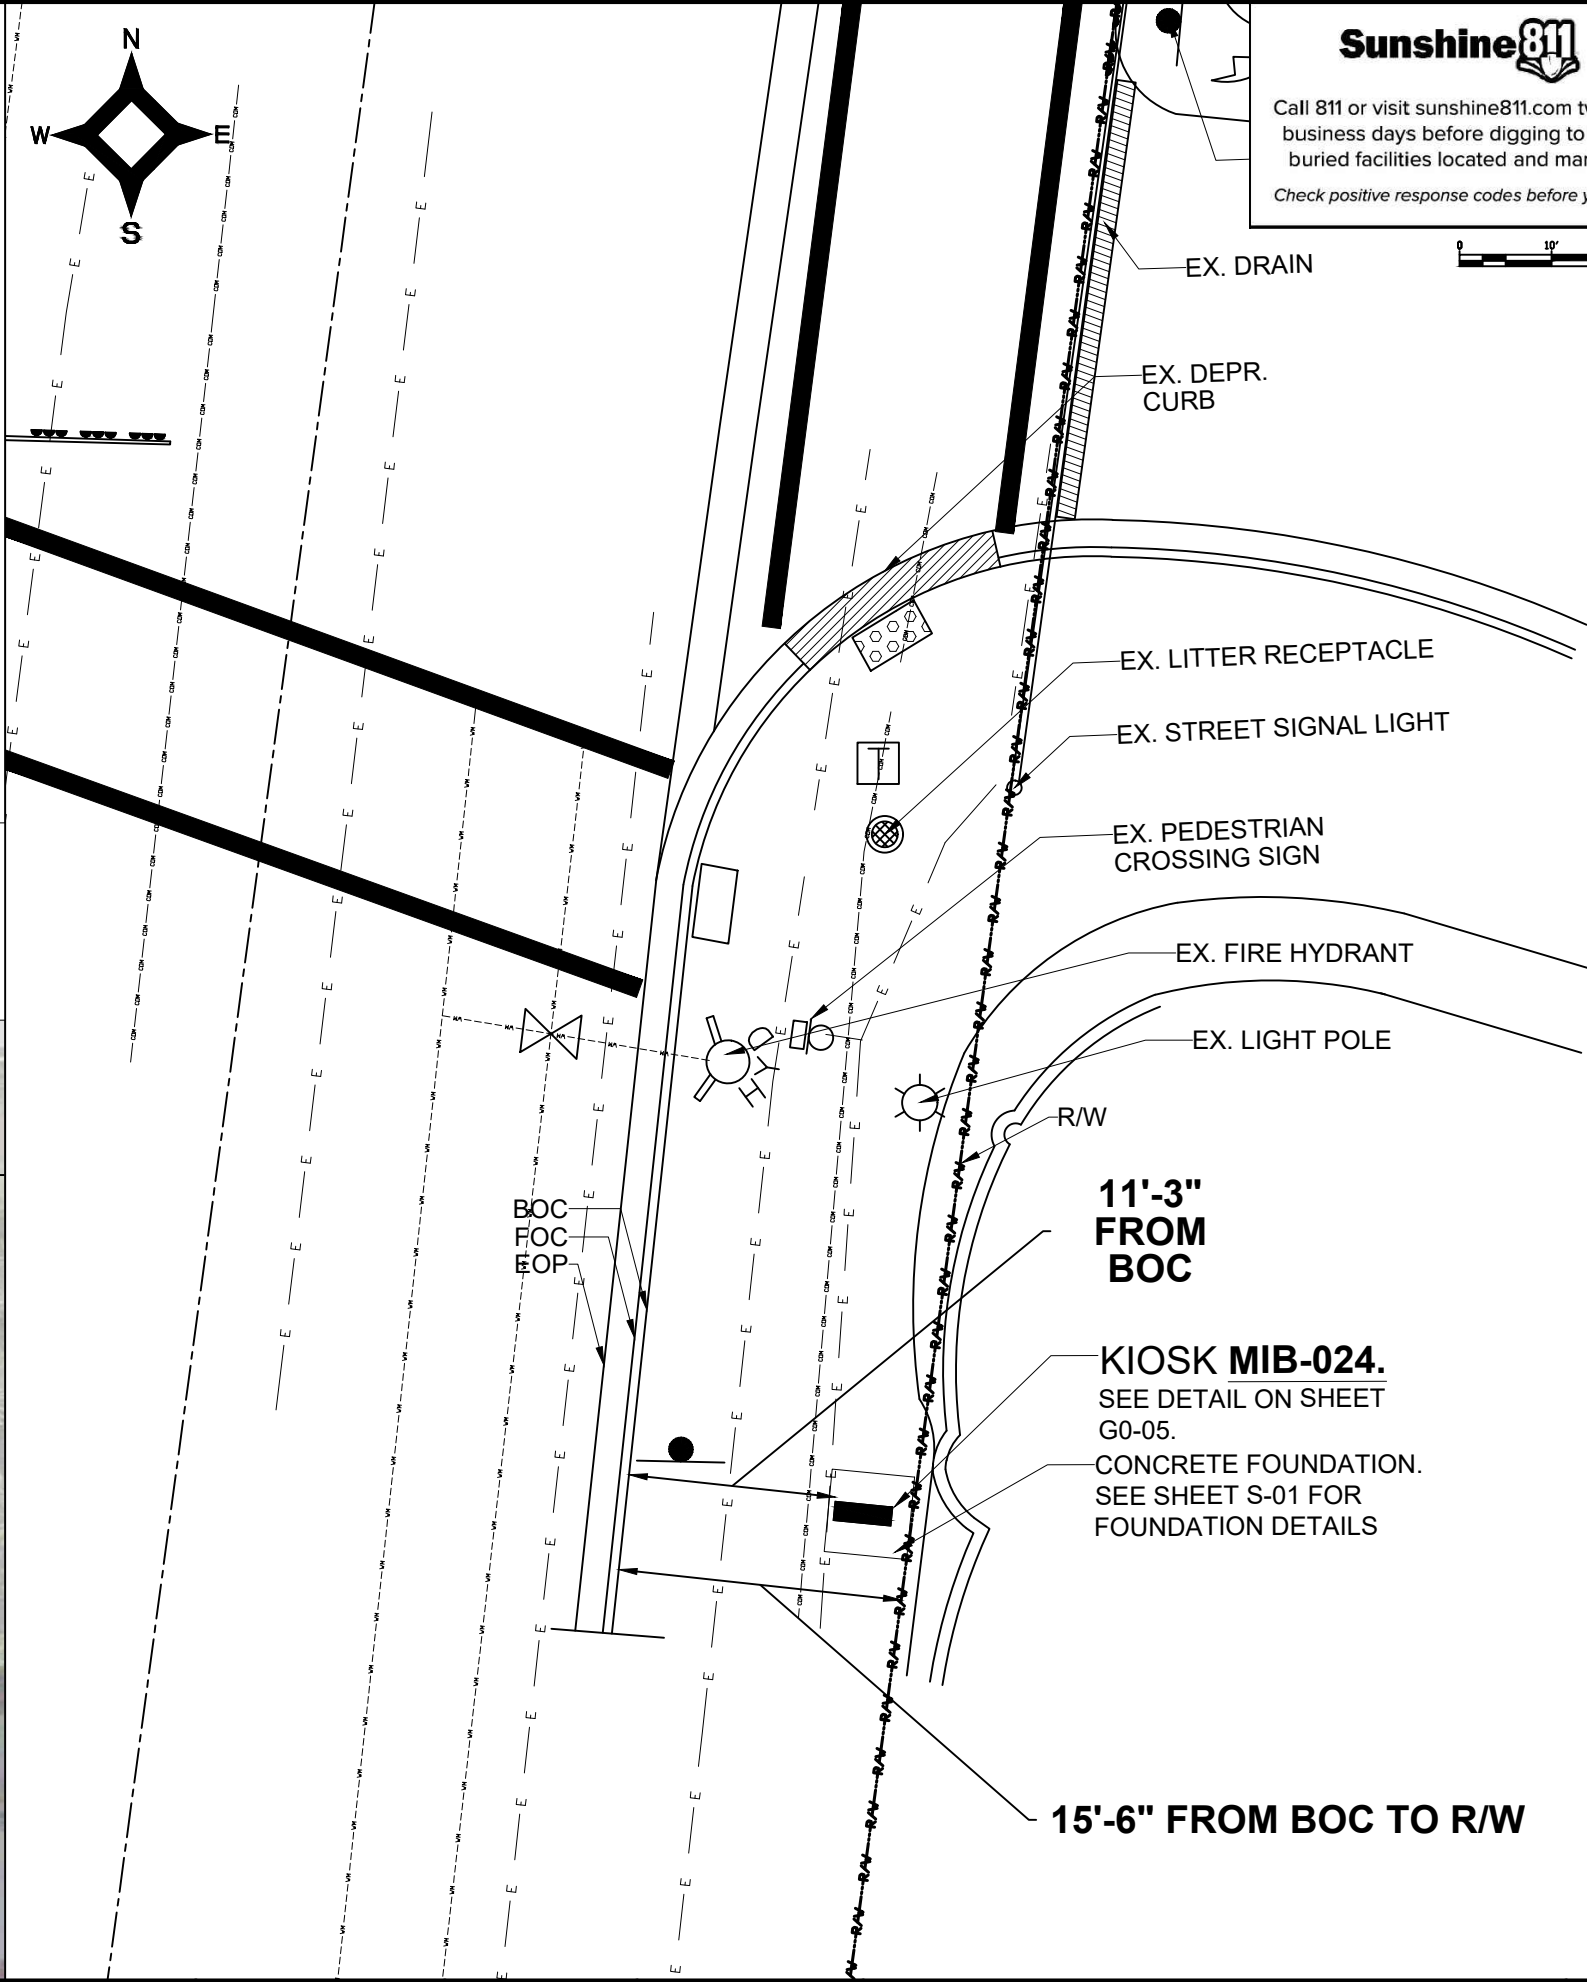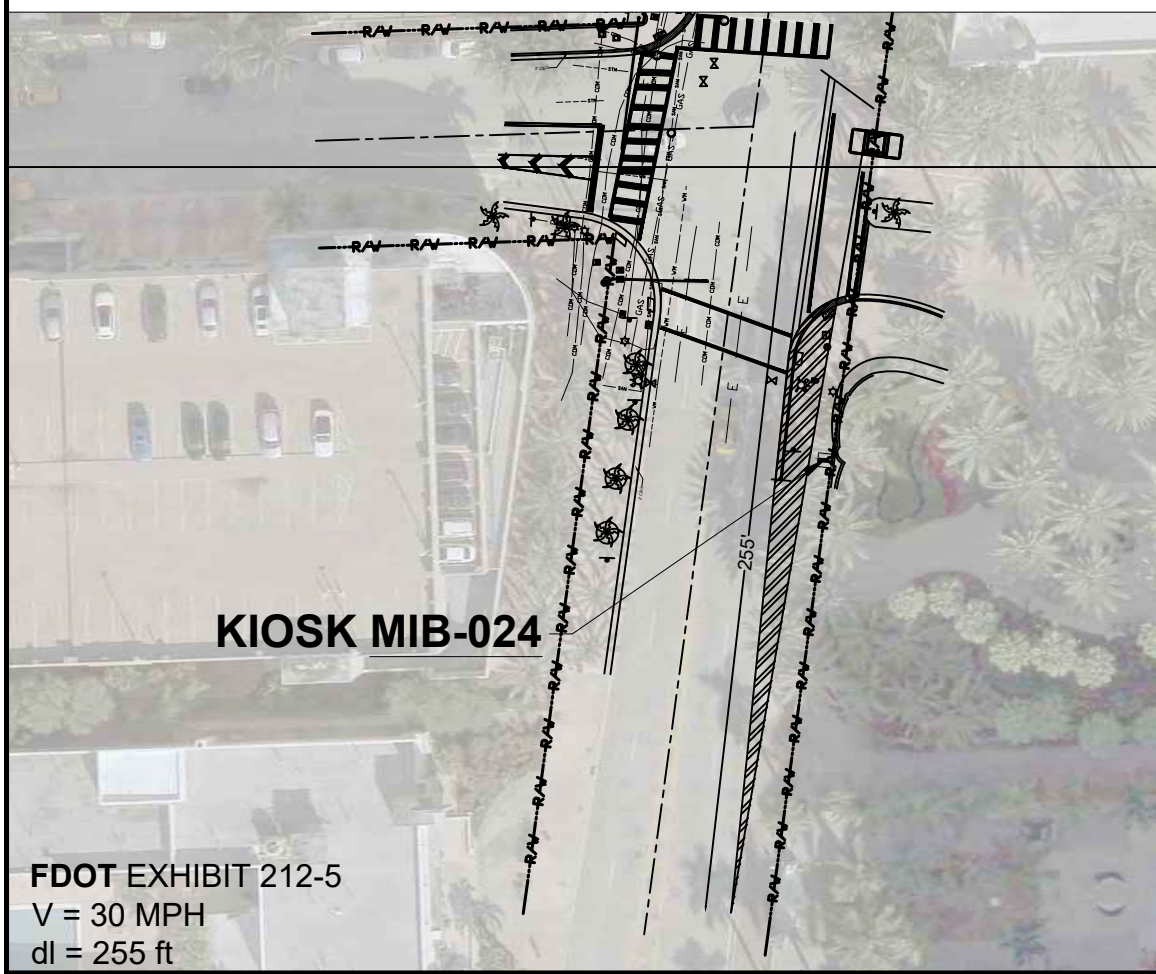KIOSK MIB-024.
SEE DETAIL ON SHEET G0-05.
CONCRETE FOUNDATION.
SEE SHEET S-01 FOR FOUNDATION DETAILS

15'-6" FROM BOC TO R/W

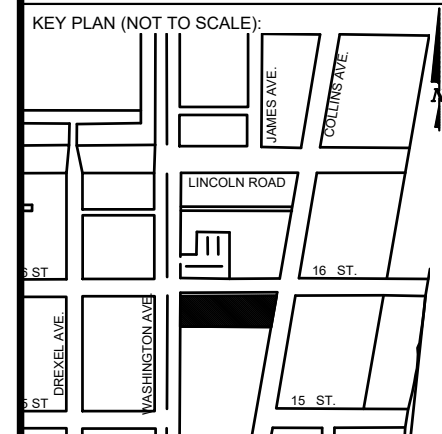

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EXISTING FPL PULLBOX
JB-1 W/ 120-240V BOOTS

AREA 1
SHEET E1-01

NEW FPL PULLBOX JB-2

NEW FPL METER
NEW KIOSK MIB-023

NEW PULLBOX JB-3

NEW PULLBOX JB-4

NEW PULLBOX JB-5



NEW PULLBOX JB-6

NEW PULLBOX JB-7
NEW KIOSK MIB-024

AREA 2
SHEET E1-02



ELECTRICAL SITE PLAN

SCALE: 1"=50'

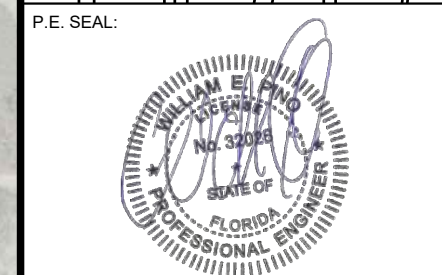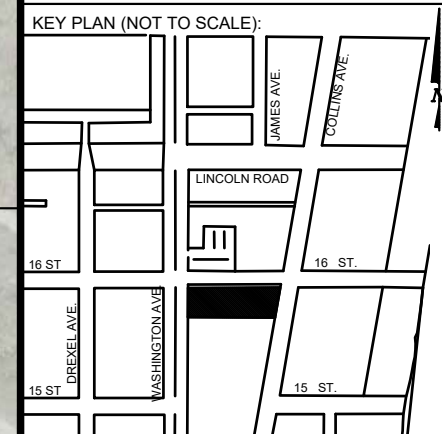


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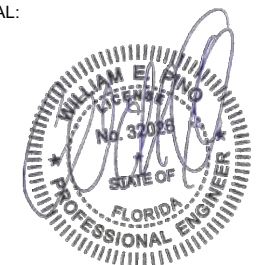


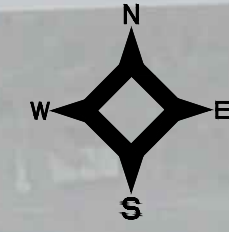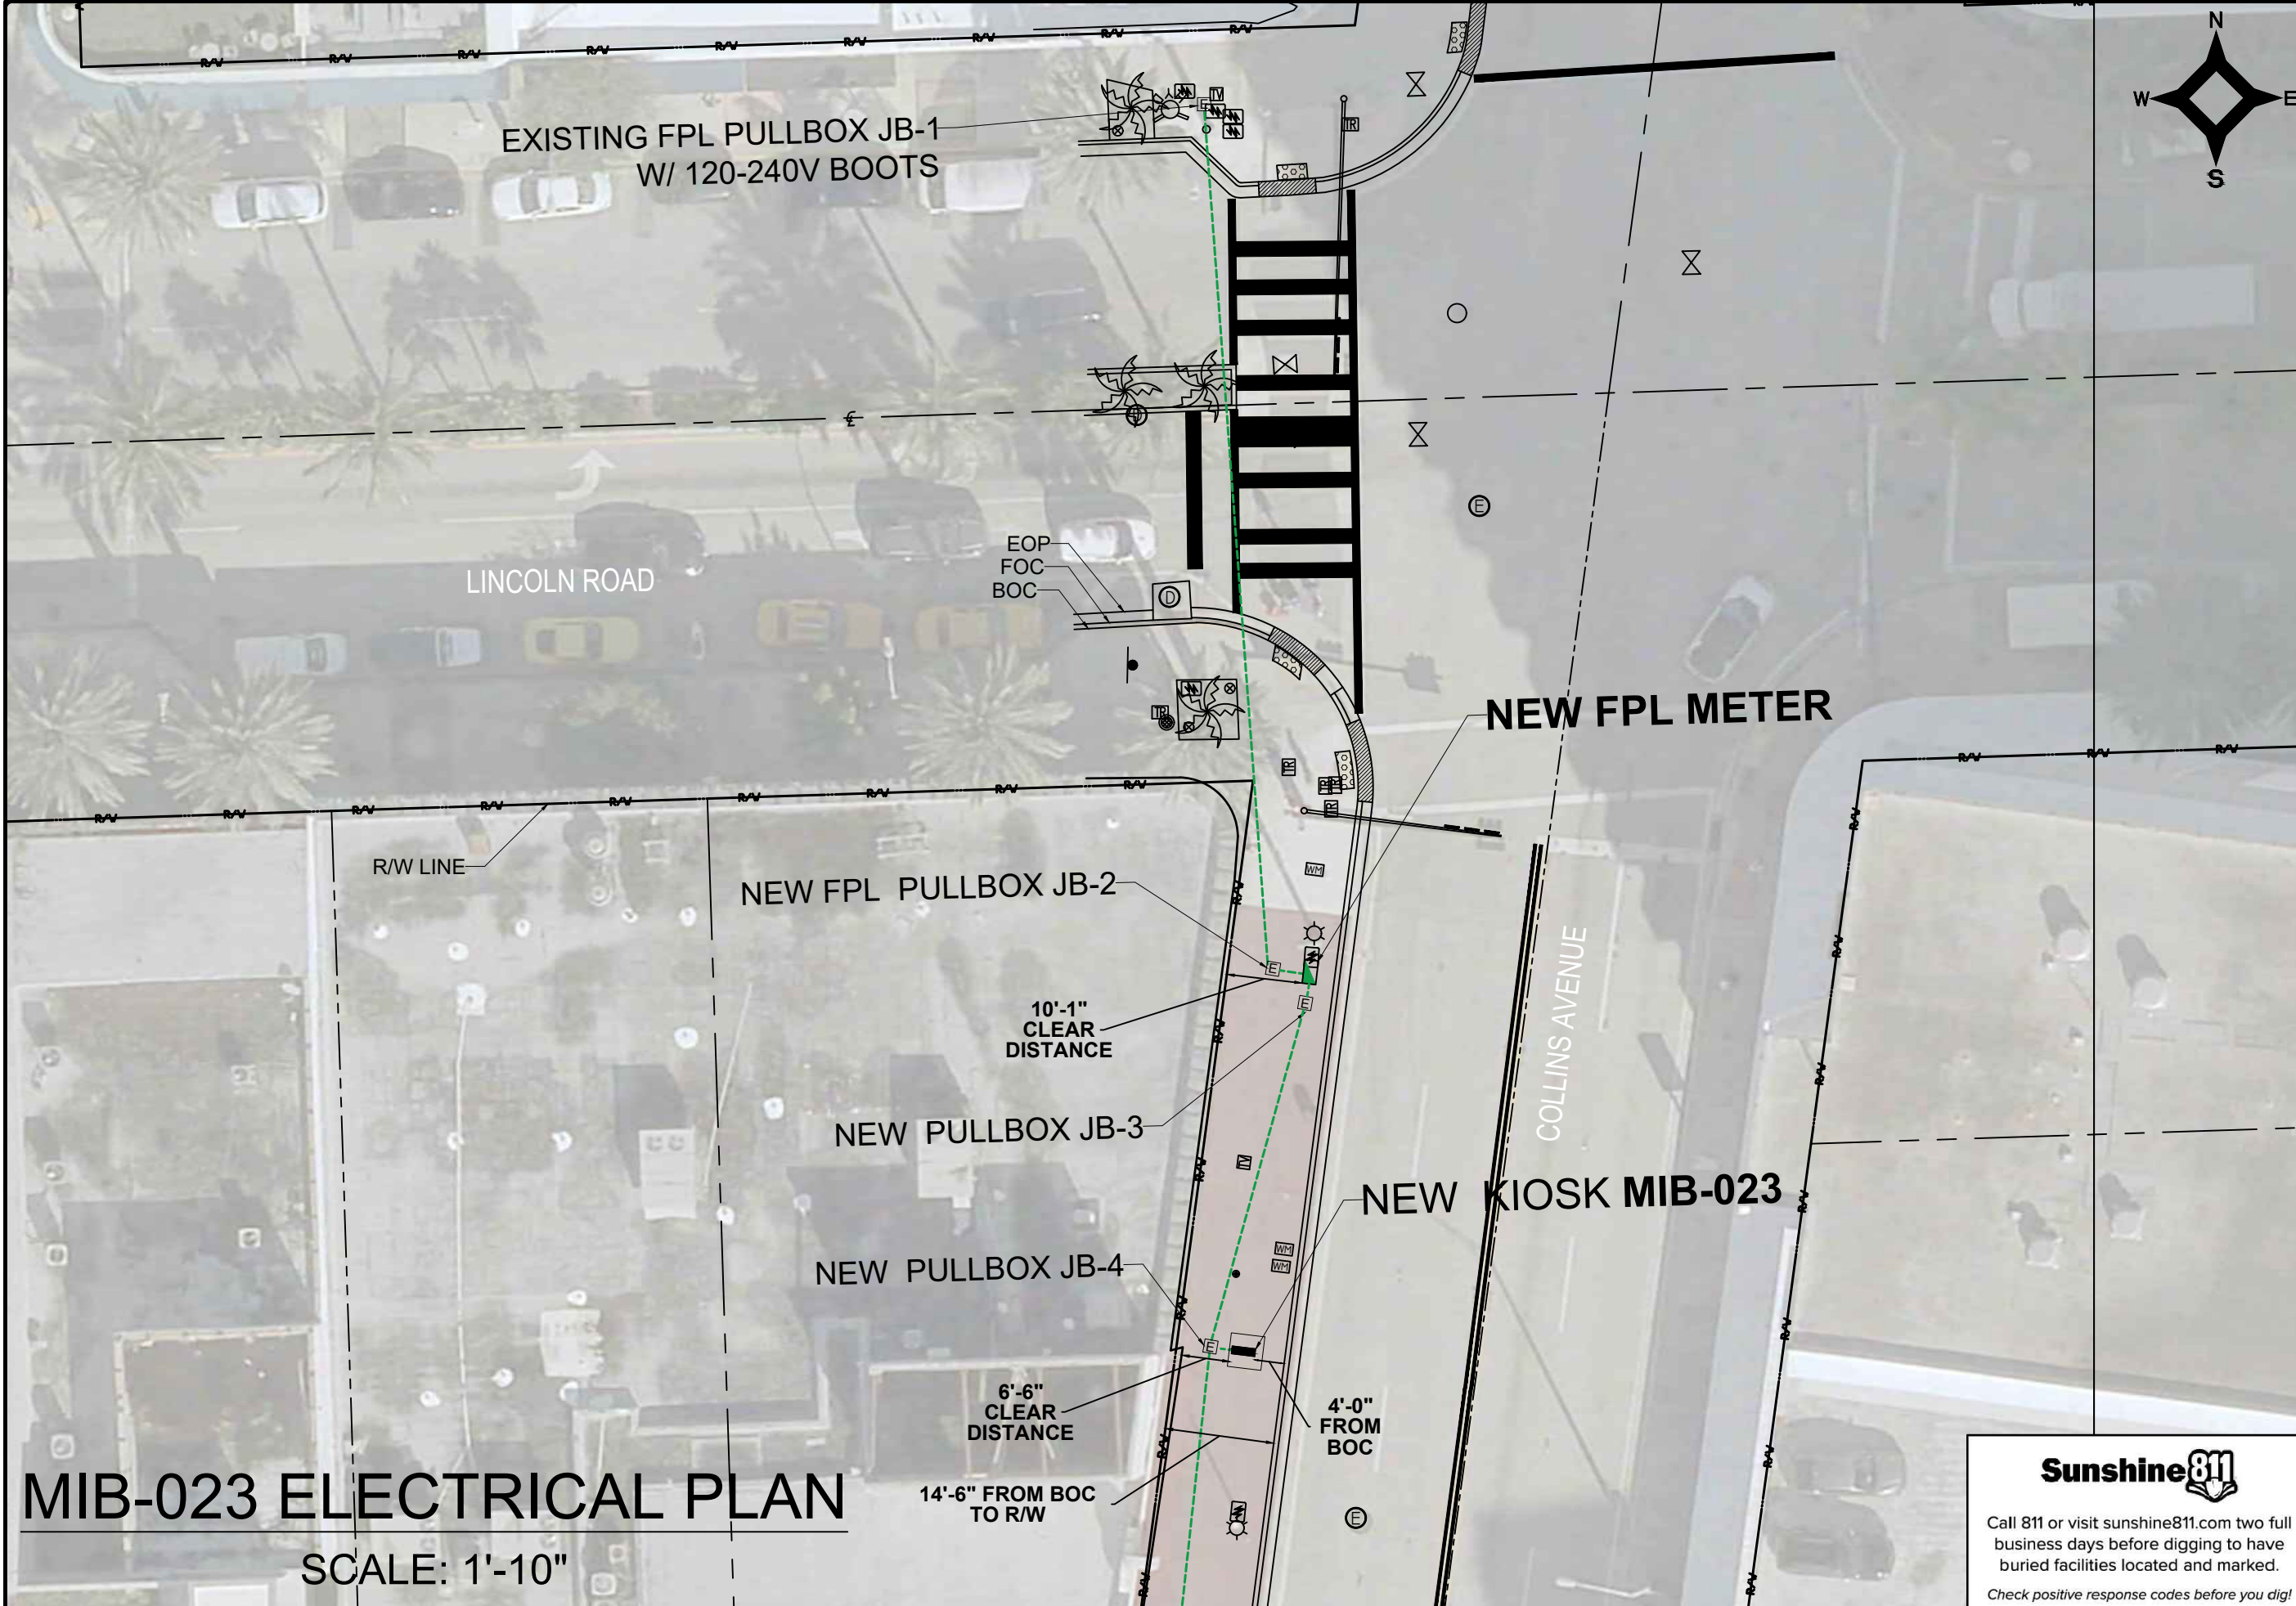

NOTES:

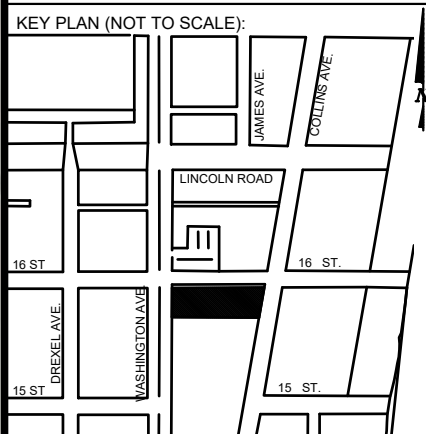

P.E. SEAL:




Sunshine811
 Call 811 or visit sunshine811.com two full business days before digging to have buried facilities located and marked.
 Check positive response codes before you dig!



MIB-023 ELECTRICAL PLAN
 SCALE: 1'-10"

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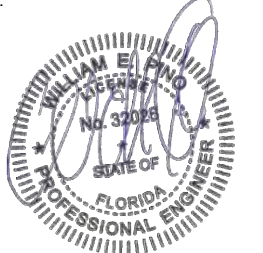


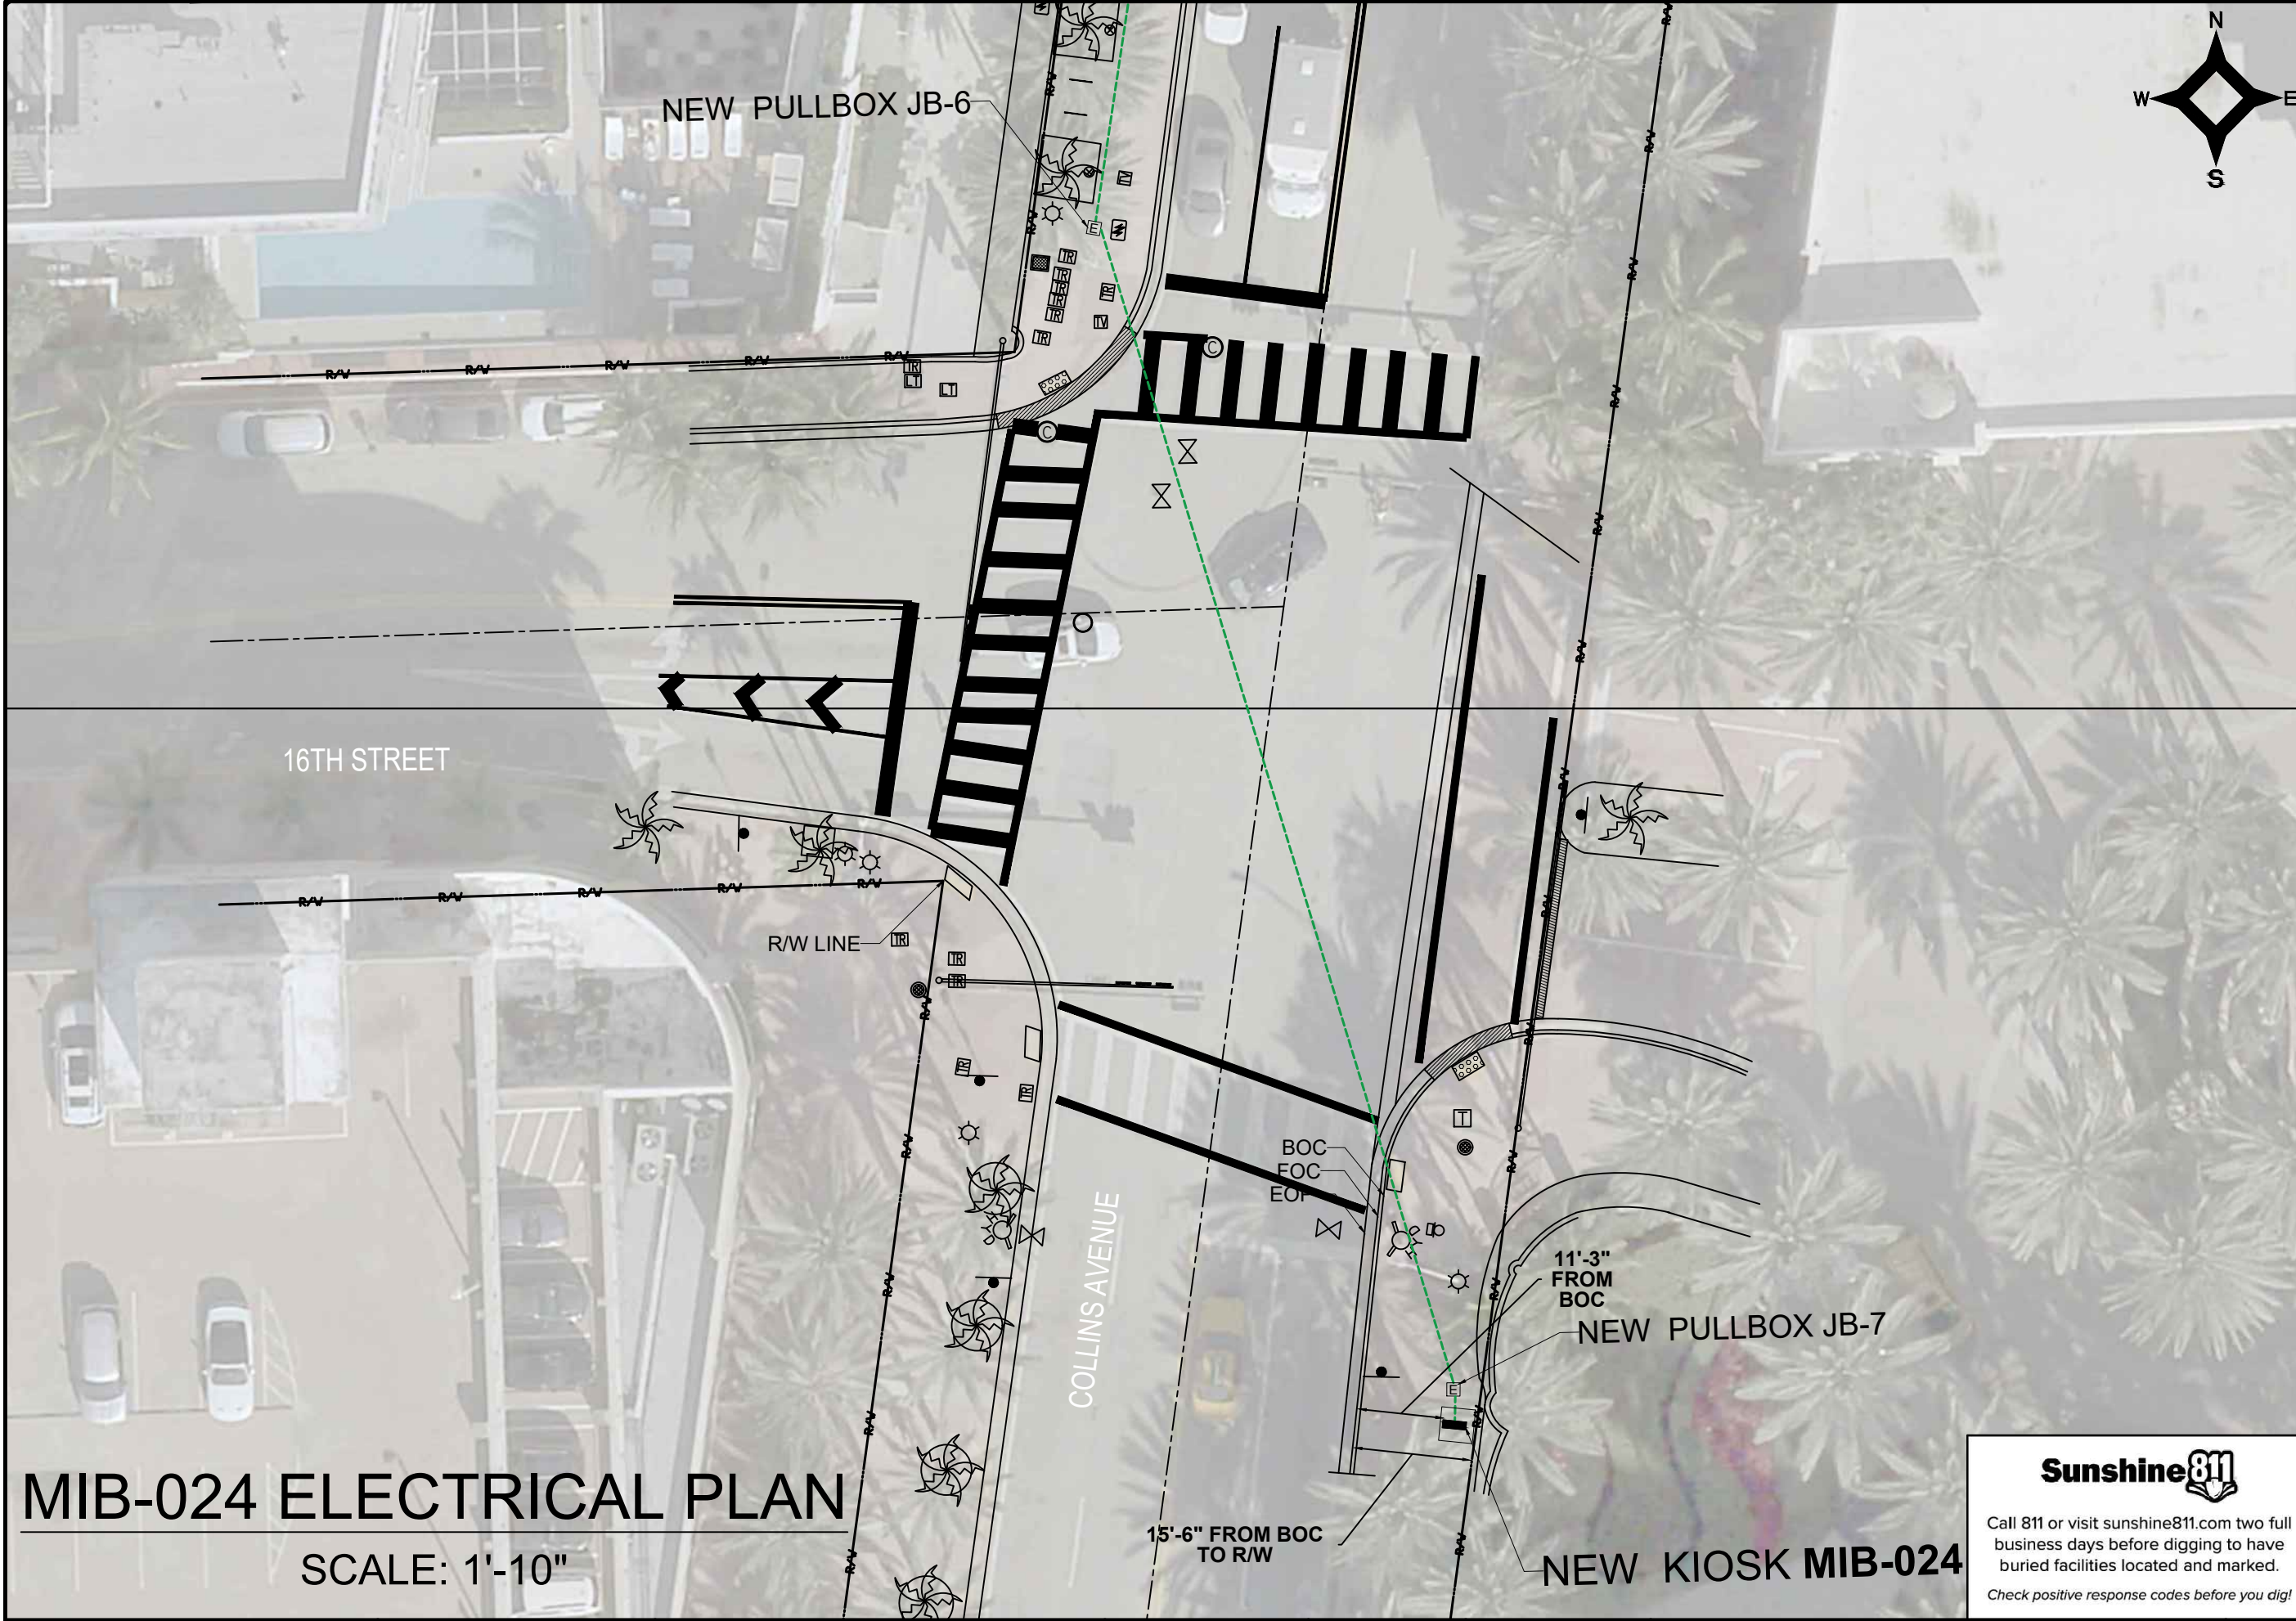

NOTES:

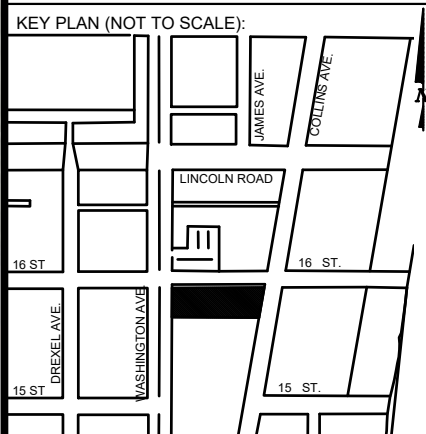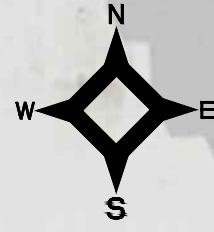

P.E. SEAL:



Sunshine811
 Call 811 or visit sunshine811.com two full business days before digging to have buried facilities located and marked.
 Check positive response codes before you dig!

MIB-024 ELECTRICAL PLAN
 SCALE: 1'-10"

MIAMI BEACH
 PUBLIC WORKS DEPARTMENT
 1700 CONVENTION CENTER DRIVE, MIAMI BEACH, FL 33139

CITY MANAGER: ALINA T. HUDAK
 DIRECTOR: JOE GOMEZ, P.E.
 CITY ENGINEER: CRISTINA ORTEGA CASTINEIRAS, P.E.

NO.	DATE	REVISION	APP'D. BY
5			
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ENGINEER OF RECORD:
 WILLIAM E. PINO,
 P.E. NO. 32028

ENGINEER OF RECORD: WP
 DESIGN ENGINEER: WP
 DRAWN BY: KM
 CHECKER: WP
 SCALE: 1"=10'

NEIGHBORHOOD: MIB-023: COLLINS AVENUE & LINCOLN ROAD
 MIB-024: COLLINS AVENUE & 16TH STREET
 TITLE: KIOSK MIB-024 ELECTRICAL PLAN

File Name: MIB-023 & MIB-024 - ELECTRICAL & TTC PLANS.dwg
 Survey Reference:
 Field Book: N/A Page: N/A Work Order: N/A
 Date: 10/09/2023 Sheet: 8 of 9 Drawing: E1-02

SPECIFIC PURPOSE SURVEY



LOCATION MAP

Not to Scale

SURVEYOR'S REPORT AND GENERAL NOTES

(Not valid without the attached Survey Map)

- This is not a Boundary Survey.
- These lands are subject to additional restrictions of record that were not furnished to the undersigning registered surveyor. A title search has not been performed by the surveyor.
- North arrow direction is based on an assumed Meridian. Bearings are based on an assumed meridian on a well-established line, said line is being noted as BR on the Survey Map.
- Only above ground improvements are shown herein. Foundations, underground features and utilities have not been located by this surveyor. Refer to SUE effort notes below.
- Survey markers found in the field have no identification unless otherwise shown. Any survey marker set by our company is labeled LB 7262 or PSM 6169.
- This Survey Map is intended to be displayed at the scale shown hereon. Data is expressed in U.S. Survey Foot.
- This Survey Map is being prepared for the use of the party/parties that it is certified to and does not extend to any unnamed individual, entity or assignee.
- FLOODPLAIN INFORMATION:** As scaled from Federal Insurance Rate Map (FIRM) of Community No. 120651 (City of Miami Beach), Panel 0317, Suffix L, revised on Sept 11th, 2009, this real property falls in Zone "AE" with Base Flood Elevation 8 feet (NGVD 1929)
- HORIZONTAL ACCURACY:** Accuracy obtained thru measurements and calculations meets and exceeds the minimum horizontal feature accuracy for a Suburban area being equal to 1 foot in 7,500 feet.
- VERTICAL CONTROL AND ACCURACY:** The elevations as shown are referred to the National American Vertical Datum of 1988 (NAVD 1988). The closure in feet, as computed, meets the standard of plus or minus 0.05 feet times the squared root of the loop distance in miles. Elevation are based on a level loop from and to the following official Bench Marks:
 Bench Mark # 1: City Miami Beach Bench Mark CMB W 16, Elevation = 4.00 feet (NAVD'88)
 Description: PK nail & washer @ Northeast quadrant of intersection Washington Avenue and 16th Street.
 Bench Mark # 2: City Miami Beach Bench Mark CMB 16 02R, Elevation = 2.03 feet (NAVD'88)
 Description: PK nail & washer @ Northwest quadrant of intersection Pennsylvania Avenue & 16th Street.



11. SUE NOTES:

Subsurface Utility Investigation was performed by South Florida Utility Location Services using GPR (Ground Penetrating Radar) and RD (Radiodetection Technology) for designation and location of underground facilities. The horizontal accuracy of this method is +/- 1.5 feet approximately, and is subject to equipment limitations. This Survey depicts the location of the marks indicating the approximate location of the buried pipes and conduits. There might be additional underground facilities not discovered at the time of this survey. Underground utility references as shown on this survey drawing is solely based on information marked on the field by South Florida Utility Location Services for this project. Contact information below:

South Florida Utility Location Services
 15323 SW 31st Terrace, Miami, Florida 33185
 (786) 547 9086 Office, Email: rogerh@sf-uls.com, Contact Person: Roger Hasbani

Surveyor is not responsible for any errors or omissions that could arise from the information provided. Call 811 or visit www.sunshine811.com before digging.

- E — E — = RED PAINT LINE APPARENT ELECTRIC CONDUIT
- W — W — = BLUE PAINT LINE APPARENT WATER LINE
- SAN — SAN — = GREEN PAINT LINE APPARENT SANITARY SEWER LINE
- GAS — GAS — = YELLOW PAINT LINE APPARENT GAS LINE
- COM — COM — = ORANGE PAINT LINE APPARENT COMMUNICATION LINE
- STM — STM — = GREEN PAINT LINE APPARENT STORM SEWER LINE

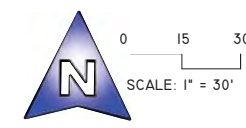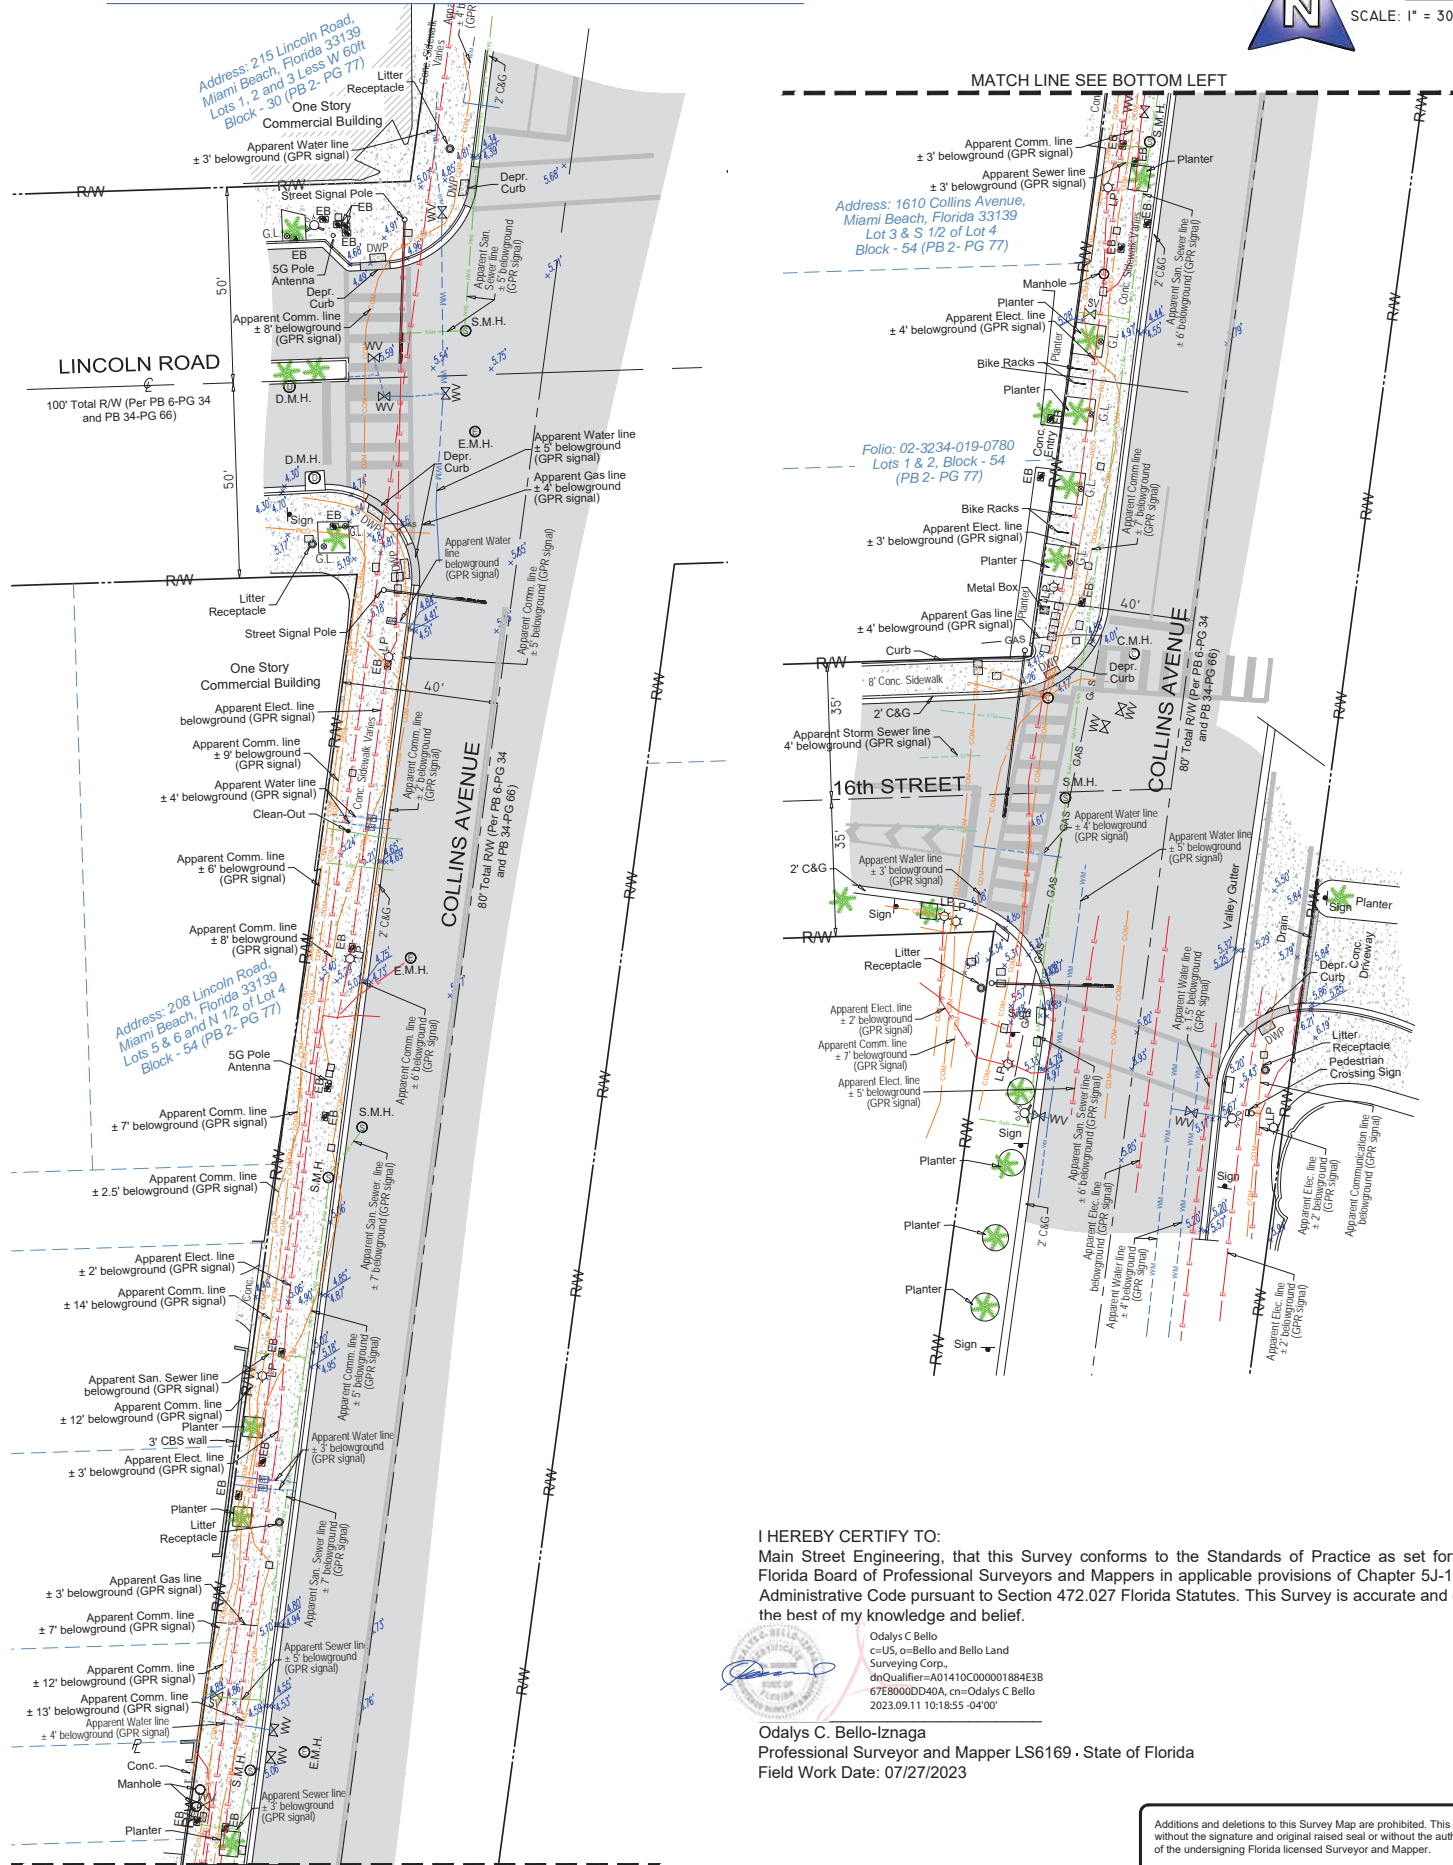

LEGEND & ABBREVIATIONS

- = CONCRETE (CONC.)
- = CONCRETE BLOCK WALL
- = WOOD DECK
- = COVERED AREA
- = ASPHALT
- = TILE
- = PAVERS
- = DETECTABLE WARNING PAD (DWP)
- = CHAIN LINK FENCE (CLF)
- = WOOD FENCE (WF)
- = IRON METAL BARS FENCE (IF)
- = OVERHEAD WIRES
- = SEWER VALVE (S.V.)
- = POWER POLE (PP)
- = GUY ANCHOR
- = WATER METER (WM)
- = CONC. LIGHT POLE (LP)
- = ELECTRIC BOX (EB)
- = GARDEN LIGHT (G.L.)
- = STREET SIGN
- = SANITARY MANHOLE
- = DRAINAGE MANHOLE
- = ELECTRIC MANHOLE (E.M.H.)
- = CABLE MANHOLE (C.M.H.)
- = FIRE HYDRANT
- = BOX TELEPHONE
- = CABLE BOX (CATV)
- = TRAFFIC BOX
- = STREET LIGHT BOX
- = CATCH BASIN OR INLET
- = EXISTING ELEVATION
- = PALM (NO IDENTIFIED)
- = TREE (NO IDENTIFIED)
- PT = POINT OF TANGENCY
- PC = POINT OF CURVATURE
- PCC = POINT OF COMPOUND CURVE
- PRC = POINT OF REVERSE CURVE
- BM = BENCH MARK
- BR = BEARING REFERENCE
- DWP = DETECTABLE WARNING PAD
- DEPR. = DEPRESSED
- E = PROPERTY LINE
- CL = CENTER LINE
- BL = BASE LINE
- PSM = PROFESSIONAL SURVEYOR AND MAPPER
- C&G = CURB & GUTTER
- GA = GUY ANCHOR
- ENCR = ENCROACHMENT
- VG = VALLEY GUTTER
- (XX-XX) = DENOTES PLAT BOOK XX - PAGE XX
- ORB = OFFICIAL RECORD BOOK
- CBS = CONCRETE BLOCK STRUCTURE
- R/W = RIGHT OF WAY
- ELEV = ELEVATION
- SEC = SECTION
- T = TOWNSHIP
- R = RANGE
- (M) = FIELD MEASURED
- (C) = CALCULATED
- (R) = RECORD
- (P) = PER PLAT

I HEREBY CERTIFY TO:
 Main Street Engineering, that this Survey conforms to the Standards of Practice as set forth by the Florida Board of Professional Surveyors and Mappers in applicable provisions of Chapter 5J-17, Florida Administrative Code pursuant to Section 472.027 Florida Statutes. This Survey is accurate and correct to the best of my knowledge and belief.

Odalys C. Bello
 c=US, o=Bello and Bello Land Surveying Corp.
 dnQualifier=A01410C000001884E38
 67E8060DD40A, cn=Odalys C. Bello
 2023.09.11 10:18:55 -0400

Odalys C. Bello-Iznaga
 Professional Surveyor and Mapper LS6169 - State of Florida
 Field Work Date: 07/27/2023

Additional and deletions to this Survey Map are prohibited. This Survey Map and Report are not valid without the signature and original raised seal or without the authenticated electronic signature and seal of the undersigning Florida licensed Surveyor and Mapper.

Property Address:
 200 Lincoln Road, Miami Beach, Florida 33139
 Project No. 23259 D.B.: EO Page 1 of 1

BELLO & BELLO LAND SURVEYING
 12230 SW 131 AVENUE • SUITE 201 • MIAMI FL 33186
 Phone: 305.251.9606 • Fax: 305.251.6057 • LB#7262
 e-mail: info@belloand.com • www.belloand.com



8. Collins Ave & Lincoln Rd



MIAMI BEACH

PUBLIC WORKS DEPARTMENT
INTERACTIVE DIGITAL KIOSK DEPLOYMENT PROJECT
OCTOBER 2023
IKE SMART CITY
MIB-023: COLLINS AVENUE (SR-A1A) & LINCOLN ROAD
MIB-024: COLLINS AVENUE (SR-A1A) & 16TH STREET

CITY OF MIAMI BEACH

MAYOR: DAN GELBER


COMMISSIONERS: MICKY STEINBERG
 MARK SAMUELIAN
 MICHAEL GONGORA
 STEVEN MEINER
 RICKEY ARRIOLA
 DAVID RICHARDSON

CITY MANAGER: ALINA T. HUDAK

CITY ATTORNEY: RAFAEL A. PAZ

PUBLIC WORKS DIRECTOR: JOE GOMEZ, P.E., F.FES

CITY ENGINEER: NELSON PEREZ-JACOME, PE

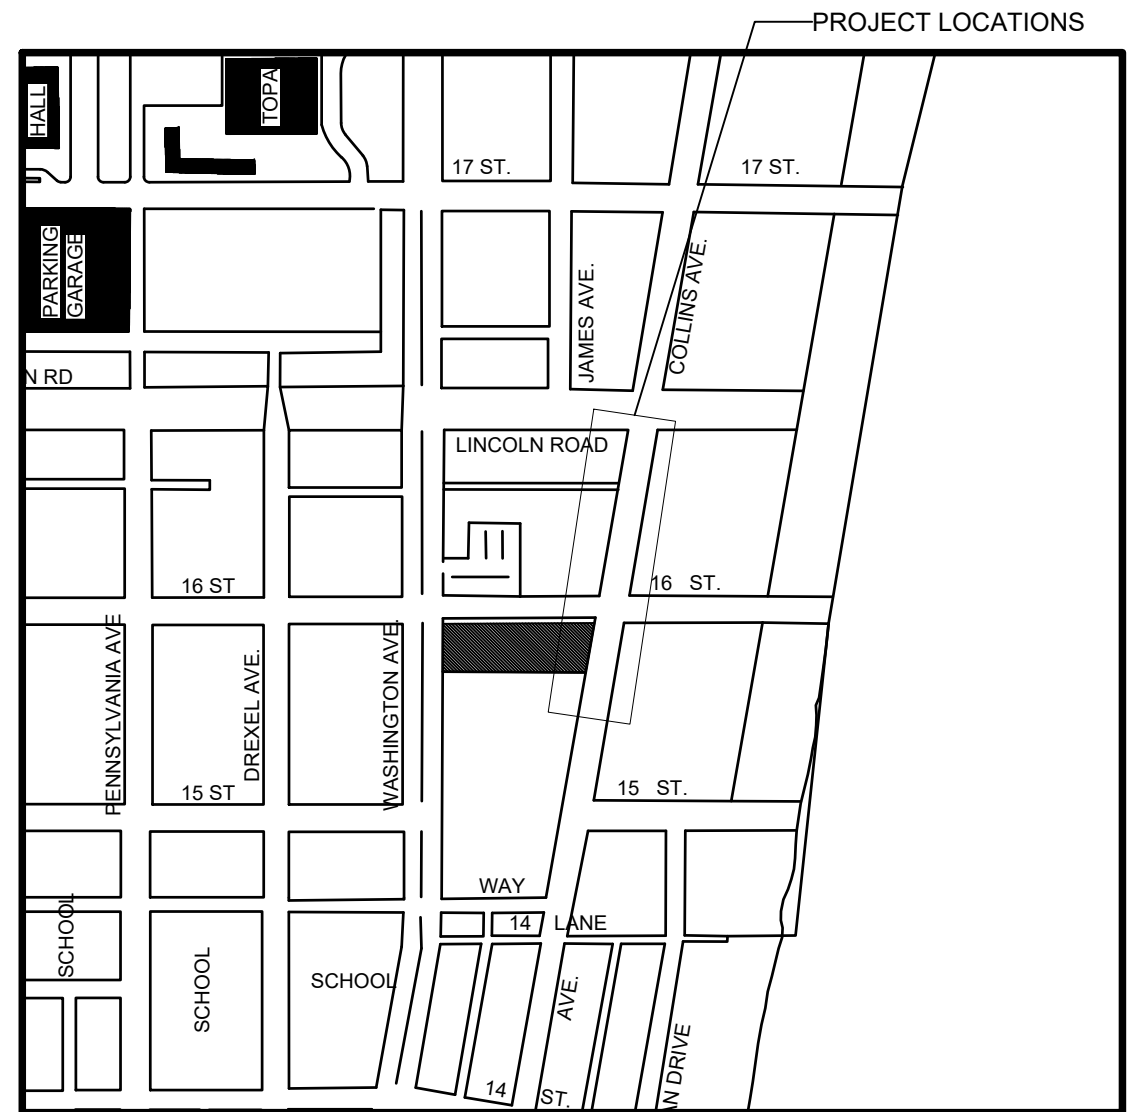

LOCATION MAP



INDEX OF PLANS

NUMBER	DISCIPLINE	SHEET NO.	DESCRIPTION	NOTES
1	GENERAL	G0-03	INDEX OF SHEETS	
2	GENERAL	G0-04	ADA NOTES, SCOPE OF WORK & KIOSK SPECIFICATIONS	
3	CIVIL	C1-01	CIVIL SITE PLAN	
4	CIVIL	C1-02	KIOSK MIB-023 ENGINEERING PLAN	
5	CIVIL	C1-03	KIOSK MIB-024 ENGINEERING PLAN	
6	ELECTRICAL	E0-01	ELECTRICAL SITE PLAN	
7	ELECTRICAL	E1-01	KIOSK MIB-023 ELECTRICAL PLAN	
8	ELECTRICAL	E1-02	KIOSK MIB-024 ELECTRICAL PLAN	
9	SURVEY		KIOSK MIB-023 & MIB-024 SITE SURVEY	

SCOPE OF WORK: THE PROJECT CONSISTS OF THE INSTALLATION OF TWO (2) DIGITAL INTERACTIVE KIOSK AND APPLICABLE INFRASTRUCTURE; STRUCTURAL FOUNDATION AND ELECTRICAL SERVICE AT THE LOCATION INDICATED ON THESE DESIGN PLANS.


FINAL SUBMITTAL 10/09/2023

Always call 811 two full business days before you dig to have underground utilities located and marked.



INDEX OF PLANS

NUMBER	DISCIPLINE	SHEET NO.	DESCRIPTION	NOTES
1	GENERAL	G0-03	INDEX OF SHEETS	
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7	ELECTRICAL	E1-01	KIOSK MIB-023 ELECTRICAL PLAN	
8	ELECTRICAL	E1-02	KIOSK MIB-024 ELECTRICAL PLAN	
9	SURVEY		KIOSK MIB-023 & MIB-024 SITE SURVEY	

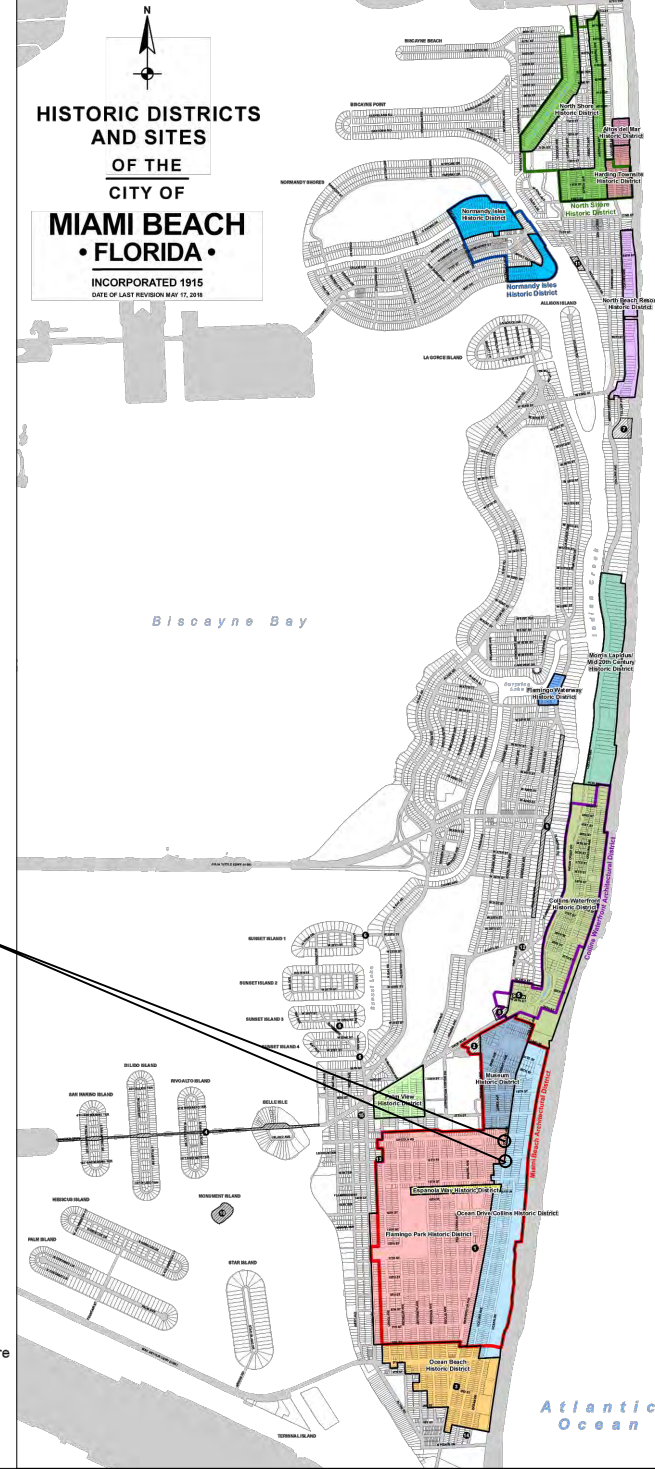

LEGEND AND ABBREVIATIONS

- = PALM TREE
- = TREE
- = ORNAMENTAL TREE
- O.R.B. = OFFICIAL RECORDS BOOK
- PG. = PAGE
- ELEV. = ELEVATION
- TYP. = TYPICAL
- CATV = CABLE TELEVISION
- OHE = OVERHEAD ELECTRIC LINE
- X 0.00 = SPOT ELEVATION
- CONC. = CONCRETE
- C.B.S. = CONCRETE BLOCK STUCCO
- C.L.F. = CHAIN LINK FENCE
- W.F. = WOOD FENCE
- M.F. = METAL FENCE
- RCP = REINFORCED CONCRETE PIPE
- FF = FINISH FLOOR
- (R) = RECORD
- (C) = CALCULATED
- (M) = MEASURE
- LB = LICENSE BUSINESS
- L = LENGTH
- Δ = CENTRAL ANGLE
- R = RADIUS
- T = TANGENT
- PT = POINT OF TANGENCY
- PC = POINT OF CURVATURE
- STA. = STATION
- PI = POINT OF INTERSECTION
- ID = IDENTIFICATION
- MLP = METAL LIGHT POLE
- CLP = CONCRETE LIGHT POLE
- R/W = RIGHT-OF-WAY
- P.B. = PLAT BOOK
- = SECTION LINE
- = CENTERLINE
- = BASELINE
- = MONUMENT LINE
- = TRAFFIC SIGNAL BOX
- = TRAFFIC SIGNAL CABINET
- = BOLLARD
- = PEDESTRIAN SIGNAL
- = TRAFFIC SIGNAL MAST ARM
- = SIGN
- = CABLE TELEVISION BOX
- = LIGHT POLE
- = ELECTRIC BOX
- = UTILITY POLE
- = ELECTRIC TRANSFORMER
- = GUY ANCHOR
- = ELECTRIC MANHOLE
- = ELECTRIC METER
- = GAS VALVE
- = GAS UTILITY BOX
- = GAS MANHOLE
- = GAS TANK
- = GAS METER
- = COMMUNICATION BOX
- = COMMUNICATION MANHOLE
- = GARBAGE RECEPTACLE
- = HANDICAP PARKING SPACE
- = WATER METER
- = IRRIGATION VALVE
- = WATER VALVE
- = FIRE HYDRANT
- = WATER BOX
- = WATER CONNECTION
- = WATER MANHOLE
- = WATER TANK
- = WATER WELL
- = WATER MARKING FLAG
- = WATER MARKING SIGN
- = STORM MANHOLE
- = STORM METER
- = CATCH BASIN
- = TELEPHONE MANHOLE
- = TELEPHONE BOX
- = NEWSPAPER DISPENSER
- = MAILBOX
- = SANITARY MANHOLE
- = SANITARY BOX
- = SANITARY TANK
- = SANITARY LIFT STATION
- = GREASE TRAP MANHOLE
- = CLEANOUT
- = PARKING METER
- = FIBER OPTIC BOX
- = FIBER OPTIC MARKER SIGN
- = MONITORING WELL
- = FUEL TANK
- = UNKNOWN UTILITY BOX
- = UNKNOWN UTILITY METER
- = UNKNOWN UTILITY MANHOLE
- = UNKNOWN UTILITY VALVE
- = UNKNOWN UTILITY MARKER FLAG
- = SANITARY VALVE
- = RAILROAD SIGN
- = FLAGPOLE
- = PROPERTY LINE
- = ELECTRICAL OUTLET

PROJECT LOCATIONS
MIB-023: FLAMINGO PARK HISTORIC DISTRICT
MIB-024: OCEAN DRIVE/COLLINS AVENUE HISTORIC DISTRICT

LOCAL HISTORIC DISTRICTS

	Espanola Way Historic District		Palm View Historic District
	Altos del Mar Historic District		Collins Waterfront Historic District
	Flamingo Park Historic District		North Beach Resort Historic District
	Ocean Drive/Collins Avenue Historic District		Flamingo Waterway Historic District
	Museum Historic District		Morris Lapidus/Mid 20th Century Historic District
	Ocean Beach Historic District		North Shore Historic District
	Harding Townsite Historic District		Normandy Isles Historic District

NATIONAL REGISTER HISTORIC DISTRICTS

	Miami Beach Architectural District
	Normandy Isles Historic District
	North Shore Historic District
	Collins Waterfront Architectural District

LOCAL HISTORIC SITES

	1 Old City Hall Historic Site		8 Dade Blvd Fire Station Historic Site
	2 21st St Recreation Center Historic Site		9 PineTree Dr Historic Roadway
	3 Congregation Beth Jacob Historic Site		10 Flagler Memorial and Monument Island Historic Site
	4 Venetian Causeway Historic Site		11 69th St Fire Station Historic Site
	5 Miami Beach Woman's Club Historic Site		12 28th St Obelisk and Pumping Station Historic Structure
	6 Sunset Island Bridges Historic Structures		13 1600 Lenox Ave Historic Site
	7 The Bath Club Historic Site		14 36 Ocean Dr Historic Site
			15 1700 Alton Rd Historic Site

PROJECT DIRECTORY:

PROJECT NAME:
INTERACTIVE DIGITAL INFORMATION
KIOSKS DEPLOYMENT PROJECT

JURISDICTION:
CITY OF MIAMI
DEPARTMENT OF RESILIENCE AND
PUBLIC WORKS
MIAMI RIVERSIDE CENTER
444 S.W. 2nd AVENUE, 8th FLOOR
MIAMI, FLORIDA 33130
TEL: 305-416-1200

OWNER:
IKE SMART CITY
250 N HARTOFORD AVE
COLUMBUS, OH 43222
(614) 589-0087

ENGINEER OF RECORD:
MAINSTREET ENGINEERING
7035 SW 47 STREET, SUITE A
MIAMI, FL 33155
(305) 456-3505
PROJ. MGR: VANESSA MELA, P.E.
VMELA@MAINSTREETENG.COM

KIOSK MANUFACTURER:
DISPLAY DEVICE INC.
21075 WESTGATE RD.
GOLDEN, CO 80403
CONTACT: ERIC PERKINS
PHONE: (303) 929-4071


UTILITIES:
ELECTRICAL POWER: FLORIDA
POWER & LIGHT COMPANY (FPL)
WATER & SEWER: MIAMI-DADE
WATER & SEWAGE DEPARTMENT

TELEPHONE: AT&T
CABLE: COMCAST, XFINITY,
ATT-UVERSE
GAS: FLORIDA GAS

SIDEWALK & STREET SYMBOLS

	ASPHALT		BRICK
	PAVER		CONCRETE
	UNIMPROVED		TILE
	GRAVEL		STAMPED CONCRETE

KEY PLAN (NOT TO SCALE):

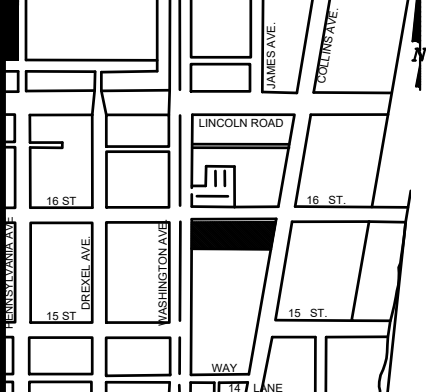

P.E. SEAL:

VANESSA A. MELÁ
LICENSE
No. 77676
STATE OF FLORIDA
PROFESSIONAL ENGINEER

ADA NOTES

- ALL CONSTRUCTION ACTIVITIES SHALL BE COMPLETED IN FULL COMPLIANCE WITH THE AMERICANS WITH DISABILITIES ACT (ADA). CLEAR SPACES IN FRONT OF KIOSK SHALL HAVE THE FOLLOWING CHARACTERISTICS:
- SURFACES SHALL BE FIRM, STABLE, AND SLIP RESISTANT AND OTHERWISE COMPLY WITH PROWAG SECTION R302.7 AND SHALL HAVE A RUNNING SLOPE CONSISTENT WITH GRADE OF THE ADJACENT PEDESTRIAN ACCESS ROUTE AND CROSS SLOPE OF 1.50% +/-0.50%)
- SIZE: CLEAR SPACES SHALL BE 48" MINIMUM BY 48" MINIMUM.
- POSITION: UNLESS OTHERWISE SPECIFIED, CLEAR SPACES SHALL BE POSITIONED FOR EITHER FORWARD OR PARALLEL APPROACH TO THE KIOSK.
- APPROACH: ONE FULL UNOBSTRUCTED SIDE OF A CLEAR SPACE SHALL ADJOIN A PEDESTRIAN ACCESS ROUTE OR ADJOIN ANOTHER CLEAR SPACE.
- MANEUVERING SPACE: WHERE A CLEAR SPACE IS CONFINED ON ALL OR PART OF THREE SIDES, ADDITIONAL MANEUVERING SPACE SHALL BE PROVIDED AS FOLLOWS:
 - FORWARD APPROACH: THE CLEAR SPACE AND ADDITIONAL MANEUVERING SPACE SHALL BE 36" WIDE MINIMUM WHERE THE DEPTH OF THE CONFINING ELEMENT EXCEEDS 24".
 - PARALLEL APPROACH: THE CLEAR SPACE AND ADDITIONAL MANEUVERING SPACE SHALL BE 60" WIDE MINIMUM WHERE THE DEPTH OF THE CONFINING ELEMENT EXCEEDS 15".
- THE MINIMUM WHEELCHAIR PASSAGE WIDTH OR CLEAR SPACE WIDTH FOR A SINGLE WHEELCHAIR PASSAGE SHALL BE 48" PER PROWAG SECTION R302.3.
- INITIAL OPERATION FOR THE KIOSK WILL HAVE 4G LTE CONNECTION SECTION R404. TO THE INTERNET.
- THE KIOSKS HAVE BEEN DESIGN TO COMPLY WITH ALL ADA GUIDELINES INCLUDING VIEWING, OPERATION, AND ACCESSIBILITY.
- THE MOBILE IKE EXPERIENCE WILL FOLLOW WEB CONTENT ACCESSIBILITY GUIDELINES (WCAG) TO WORK IN TANDEM WITH THE NATIVE ACCESSIBILITY FEATURES ON THE USER'S MOBILE DEVICE, INCLUDING TALKBACK AND VOICEOVER TOOLS.

SCOPE OF WORK

THE PROJECT CONSIST OF THE INSTALLATION OF TWO (2) DIGITAL INTERACTIVE KIOSKS AT THE LOCATION(S) INDICATED ON THIS PLANS SET. INSTALLER SHALL PROVIDE AND INCLUDE ALL WORKMANSHIP AND MATERIALS NECESSARY TO COMPLETE THE INSTALLATION INCLUDING BUT NOT LIMITED TO:


- INSTALLATION OF THE KIOSKS TO THE FOUNDATION AS INDICATED ON PLANS TO NEW RECTANGULAR CONCRETE FOUNDATION.
- ELECTRICAL SERVICE POINTS ARE EXISTING. CONNECT THE EXISTING ELECTRIC SERVICE TO THE NEW KIOSK AS INDICATED ON PLANS.
- TESTING OF THE ELECTRICAL SERVICE INFRASTRUCTURE SHALL BE PERFORMED IN CONJUNCTION WITH A REPRESENTATIVE OF THE ENGINEER OF RECORD.
- THE CONTRACTOR SHALL INSTALL THE KIOSK IN SUCH A WAY THAT THE KIOSK IS WITHIN THE PUBLIC R.O.W. AND IN COMPLIANCE WITH ALL APPLICABLE A.D.A. REQUIREMENTS
- THE LOCATION OF KIOSKS HAS BEEN COORDINATE TO ENSURE THERE IS NO OBSTRUCTION OF THE SIGHT OF VEHICULAR SIGNS.
- STAND-ALONE PEDESTRIAN KIOSKS SHOULD NOT BE INSTALLED WITHIN PEDESTRIAN CIRCULATION PATHS IN A MANNER THAT PERSONS AT THE KIOSK LOCK THE EFFECTIVE WIDTH OF THE PEDESTRIAN TRAVEL WAY.

MONUMENT SIGN SPECIFICATIONS AND FUNCTIONS


THE UNIT CONSISTS OF A UL/NRTL LISTED WEATHER AND VANDAL RESISTANT FREE STANDING ENCLOSURE DESIGNED TO COMPLY WITH THE FLORIDA BUILDING CODE AND OTHER APPLICABLE CODES INCLUDING THE NATIONAL ELECTRICAL CODE. THE UNIT HAS BEEN DESIGNED TO WITHSTAND WINDS OF 165 MPH. THE UNIT'S MAIN COMPONENTS ARE:

- TWO (2) INTERACTIVE 65" VIDEO TOUCH SCREENS.
- TWO (2) CAMERAS
- ONE (1) CPU
- ONE (1) WI-FI TRANSMITTER

MANUFACTURER: DYNASCAN MODEL NUMBER: CIO651DR5
 NATIVE RESOLUTION: 1920 X 1080
 ELECTRICAL POWER REQUIREMENT:
 1. ONE-2-POLE, 20 AMP, 240 VOLTS CIRCUIT.
 2. TOTAL LOAD: 1400/2200 WATTS (OPERATIONAL/PEAK)
 3. VOLTAGE: 100-240 VOLTS AC, 50-60 HZ
 WEIGHT: 832 LBS
 CERTIFICATION CE / FCC / RoHS

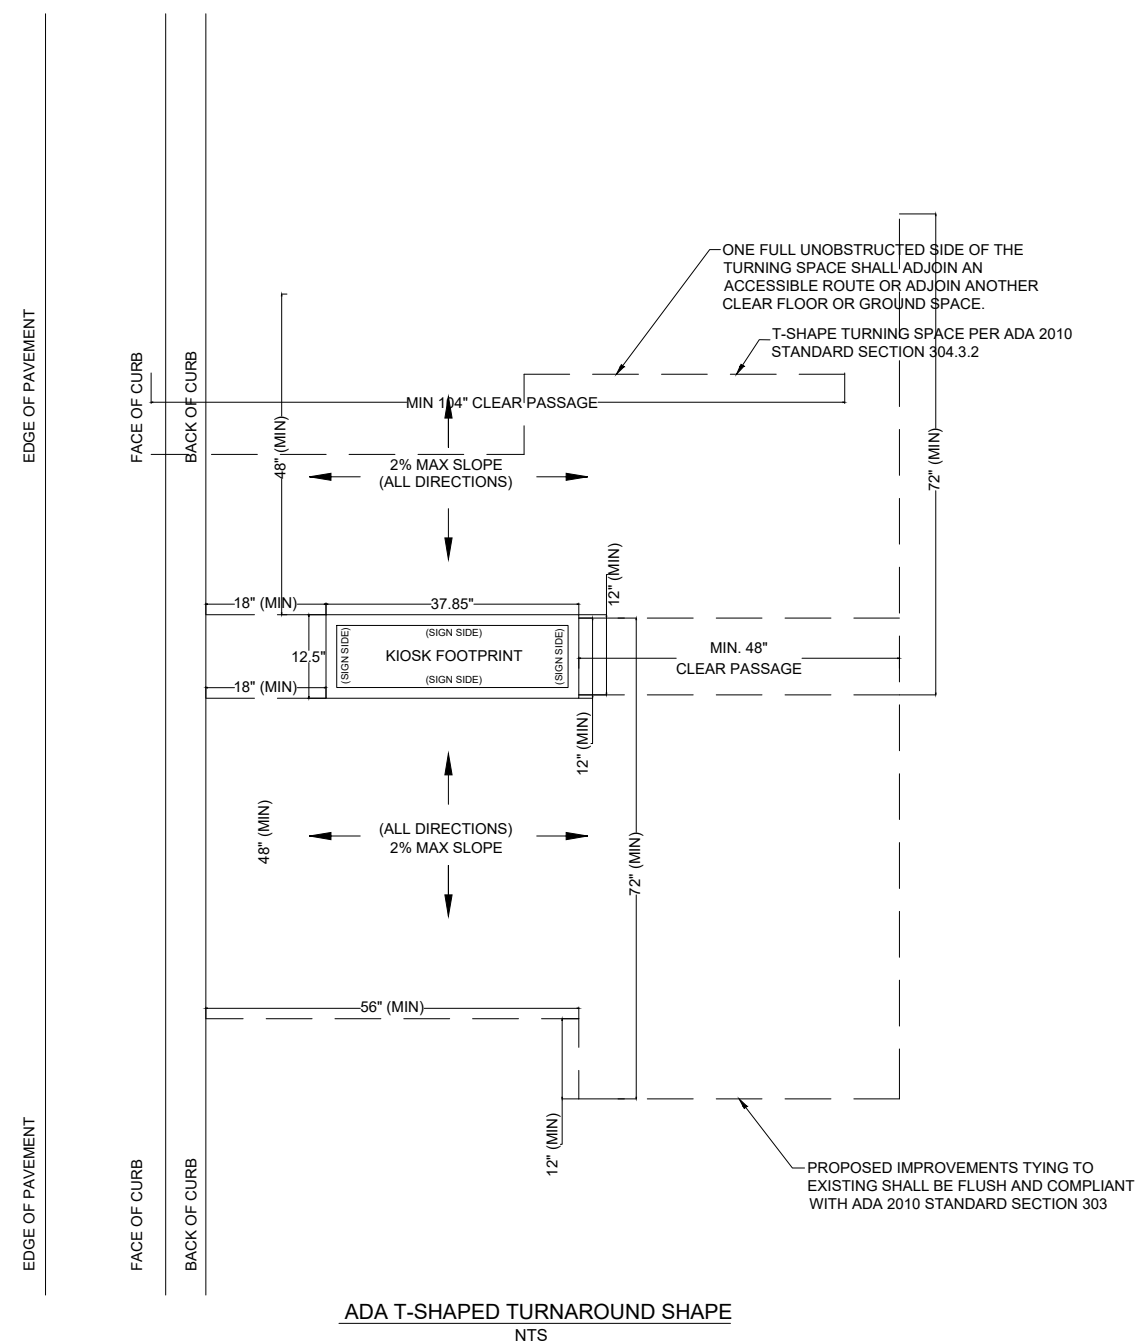

NOTES:

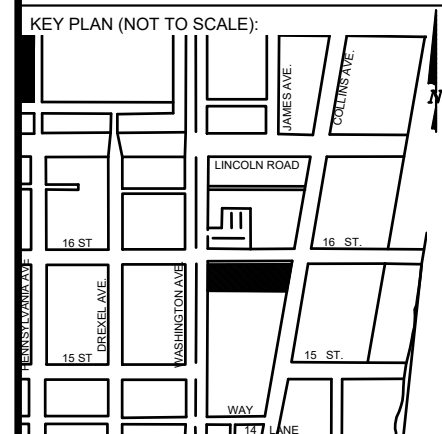

P.E. SEAL:

MIAMI BEACH
 PUBLIC WORKS DEPARTMENT
 1700 CONVENTION CENTER DRIVE, MIAMI BEACH, FL 33139

CITY MANAGER: ALINA T. HUDAK
 DIRECTOR: JOE GOMEZ, P.E.
 CITY ENGINEER: CRISTINA ORTEGA CASTINEIRAS, P.E.

NO.	DATE	REVISION	APP'D. BY
5			
4			
3			
2			
1			

Main Street ENGINEERING
 7035 SW 47th Street, Ste A, Miami, FL 33155
 Tel: (305) 406-3055 Fax: (305) 476-9894
 FL PE Certificate No: 00008751


ENGINEER OF RECORD: VANESSA A. MELA, P.E. NO. 77676

ENGINEER OF RECORD: VM
 DESIGN ENGINEER: VM
 DRAWN BY: KM
 CHECKER: WP
 SCALE: _____

NEIGHBORHOOD: MIB-023: COLLINS AVENUE & LINCOLN ROAD
 MIB-024: COLLINS AVENUE & 16TH STREET


TITLE: ADA NOTES, SCOPE OF WORK & KIOSK SPECIFICATIONS

File Name: MIB-023 & MIB-024 - GENERAL AND FOUNDATION.dwg
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 Date: 10/09/2023 Sheet: 2 of 9 Drawing: G0-04

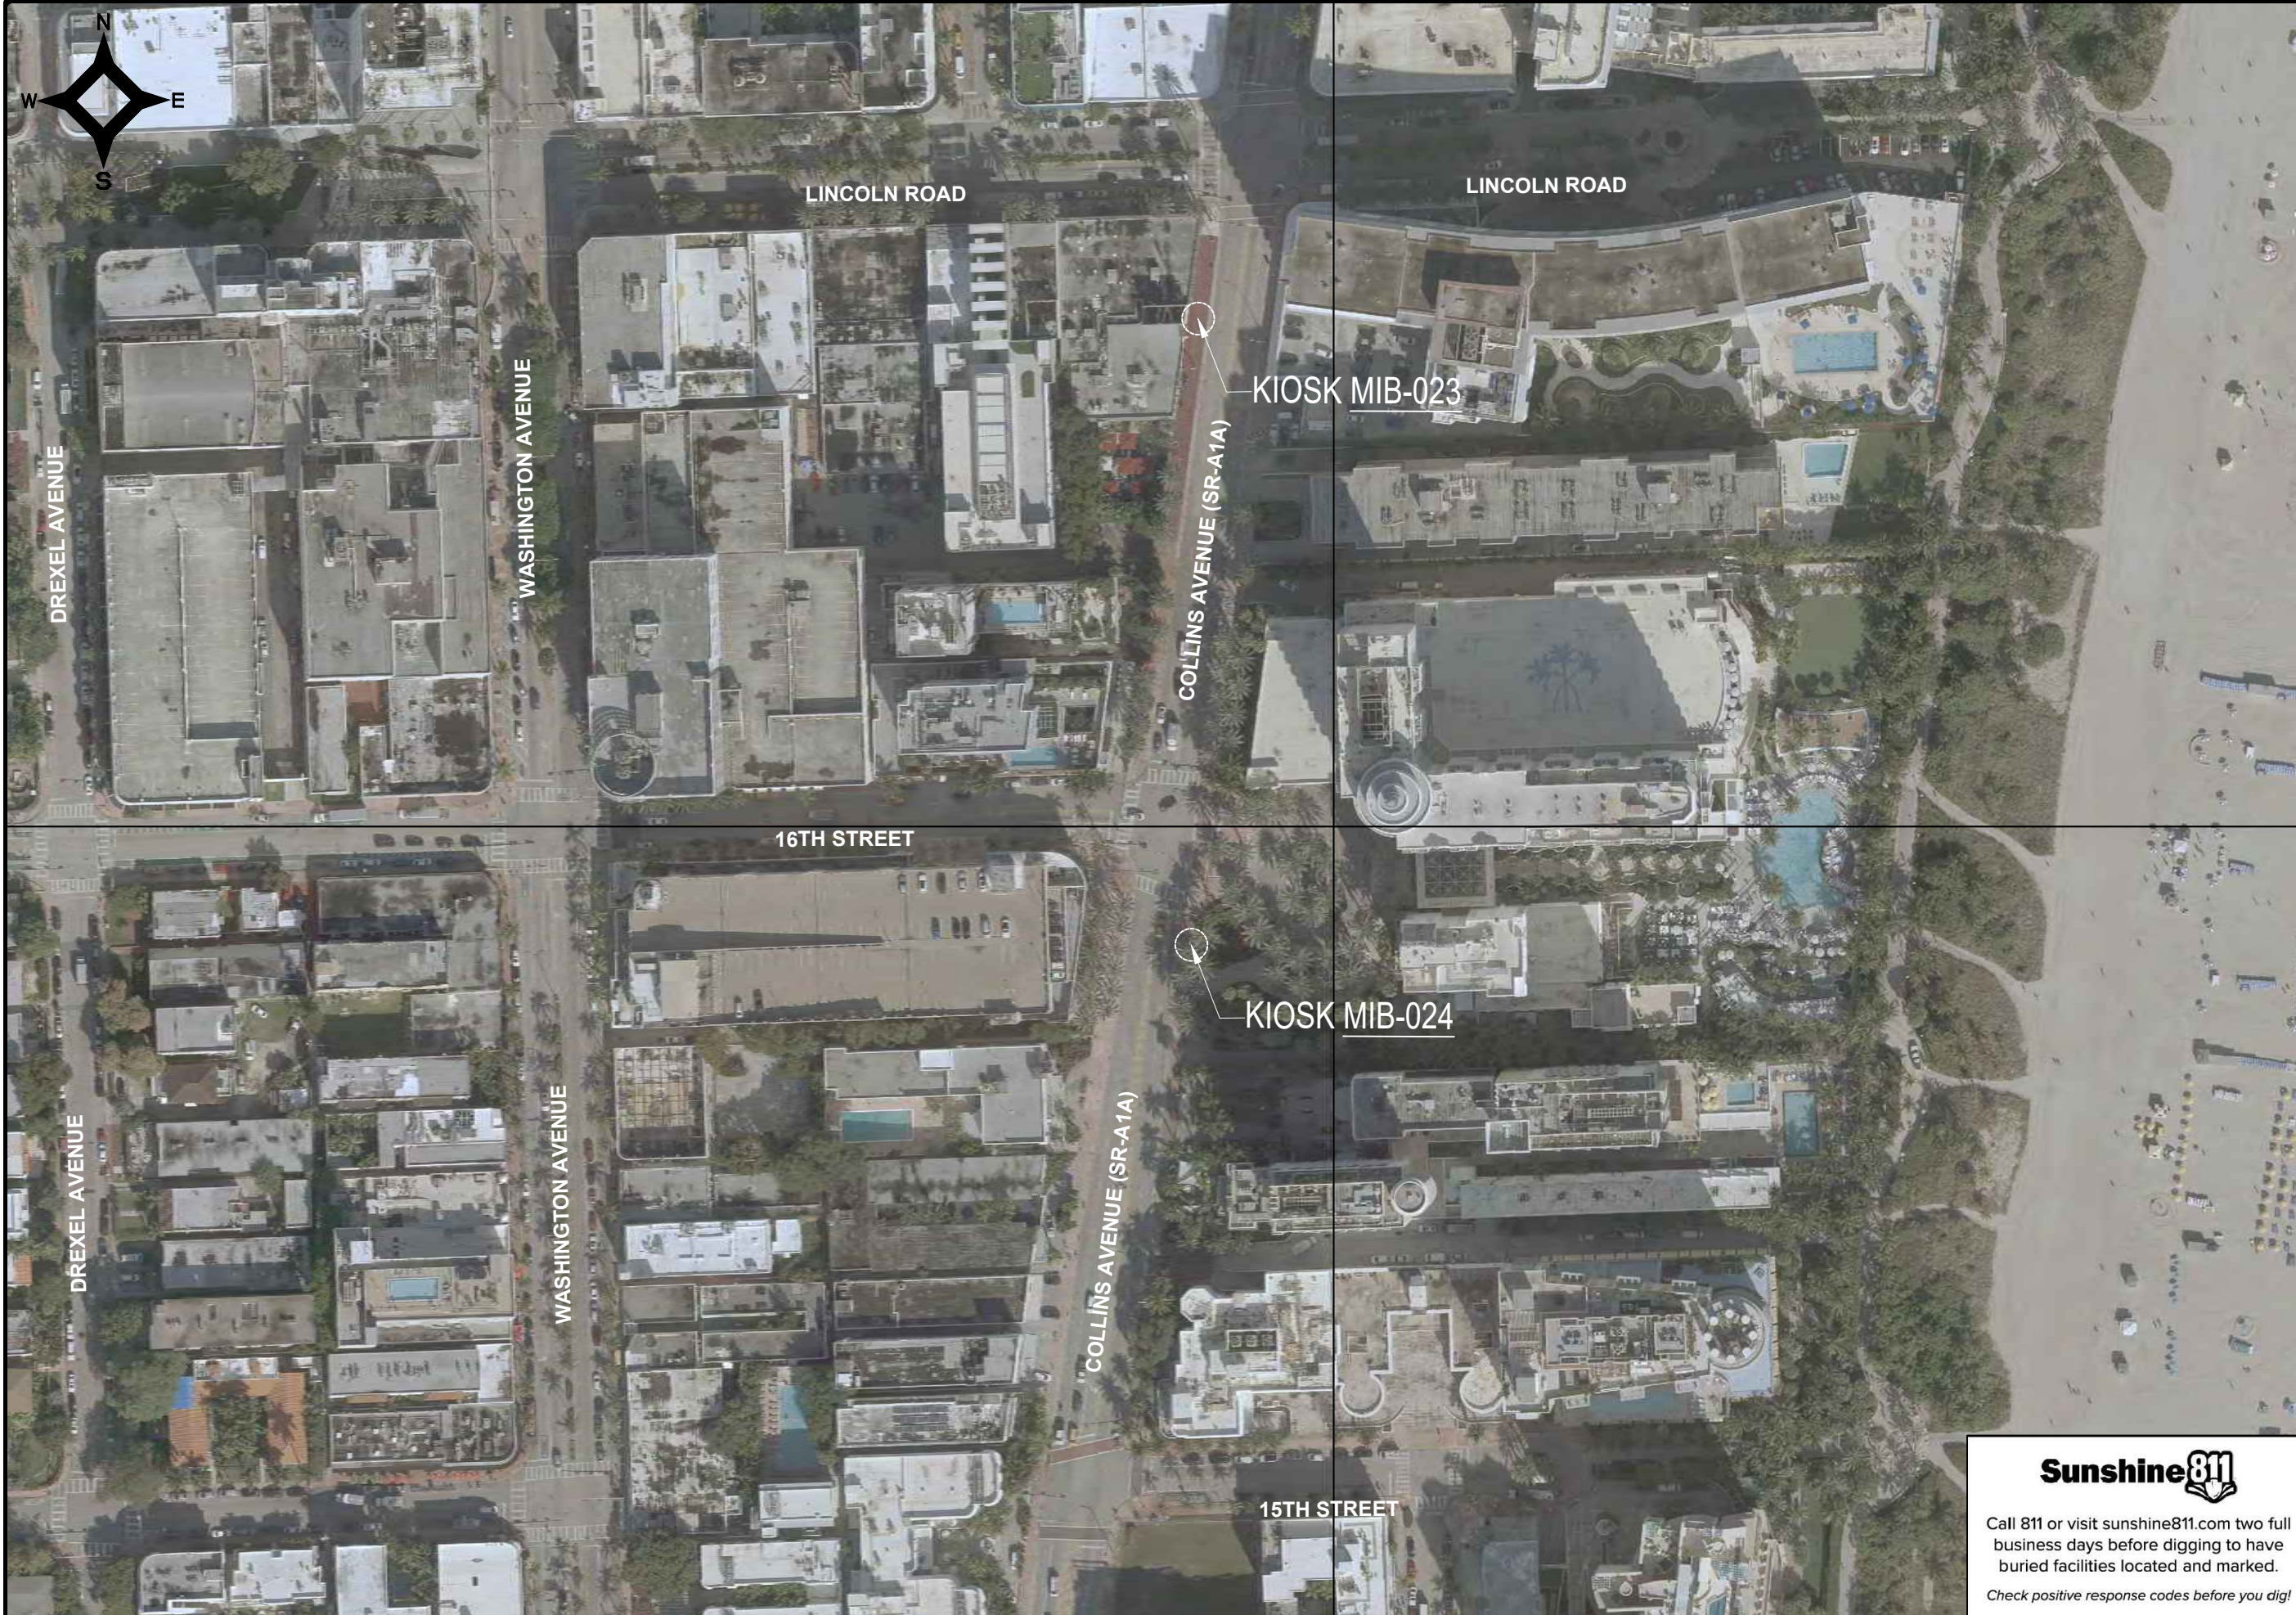


NOTES:

KEY PLAN (NOT TO SCALE):

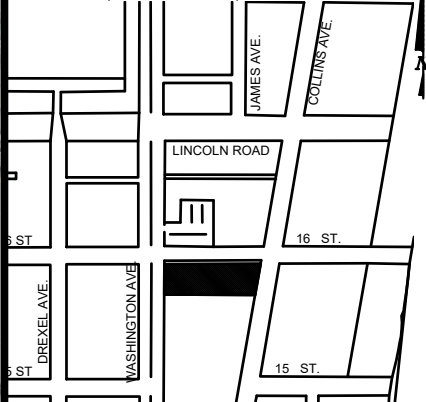

P.E. SEAL:

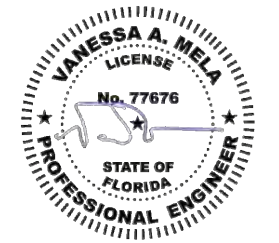

Sunshine811
 Call 811 or visit sunshine811.com two full business days before digging to have buried facilities located and marked.
 Check positive response codes before you dig!

MIAMI BEACH
 PUBLIC WORKS DEPARTMENT
 1700 CONVENTION CENTER DRIVE, MIAMI BEACH, FL 33139

CITY MANAGER: ALINA T. HUDAK
 DIRECTOR: JOE GOMEZ, P.E.
 CITY ENGINEER: CRISTINA ORTEGA CASTINEIRAS, P.E.



NO.	DATE	REVISION	APP'D. BY
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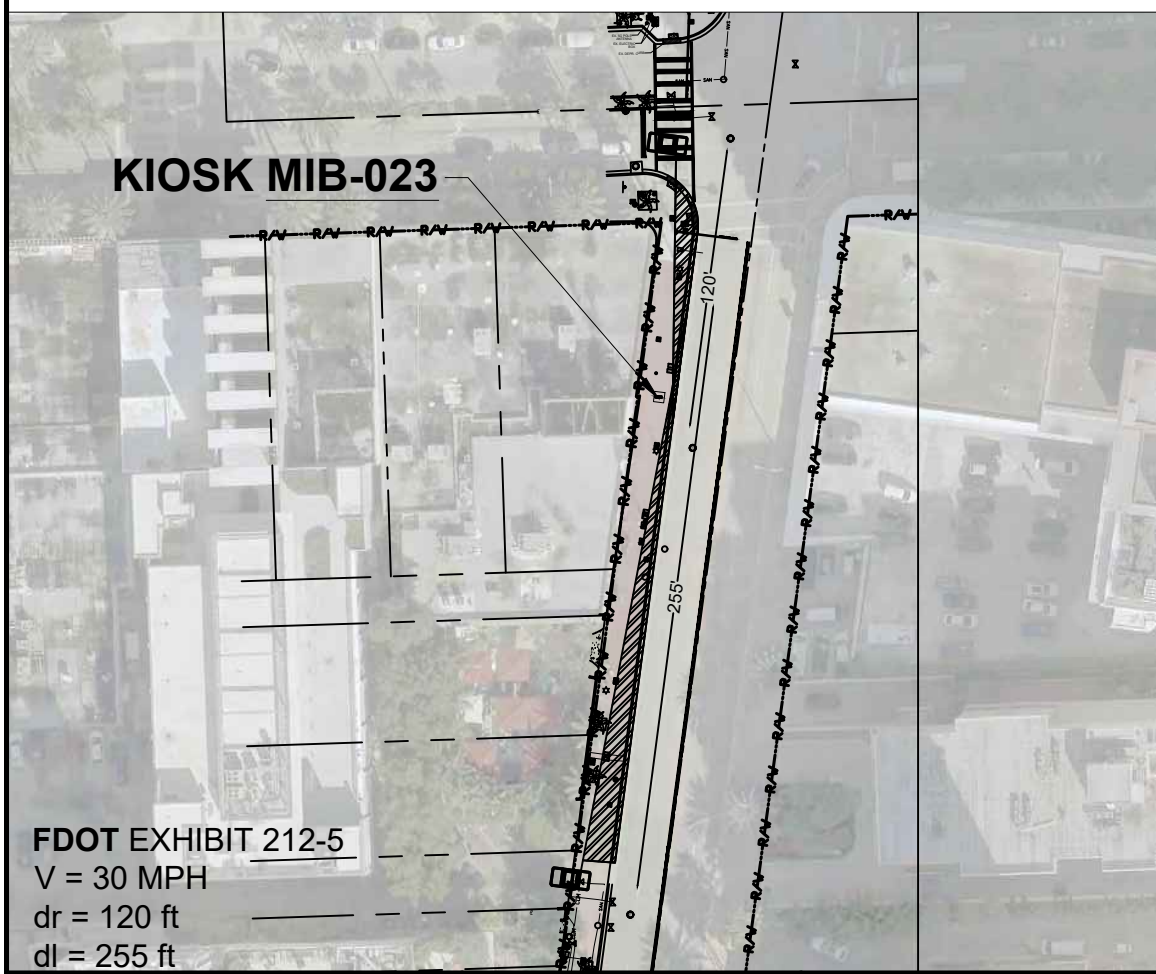
ENGINEER OF RECORD: VANESSA A. MELA, P.E. NO. 77676
 ENGINEER OF RECORD: VM
 DESIGN ENGINEER: VM
 DRAWN BY: KM
 CHECKER: WP
 SCALE:

NEIGHBORHOOD: MIB-023: COLLINS AVENUE & LINCOLN ROAD
 MIB-024: COLLINS AVENUE & 16TH STREET
 TITLE: CIVIL SITE PLAN

File Name: MIB-023 & MIB-024 - CIVIL PLANS.dwg
 Survey Reference:
 Field Book: N/A Page: N/A Work Order: N/A
 Date: 10/09/2023 Sheet: 3 of 9 Drawing: C1-01





VISIBILITY TRIANGLE CLEARANCE ANALYSIS
SCALE: 1'-40"

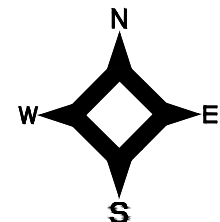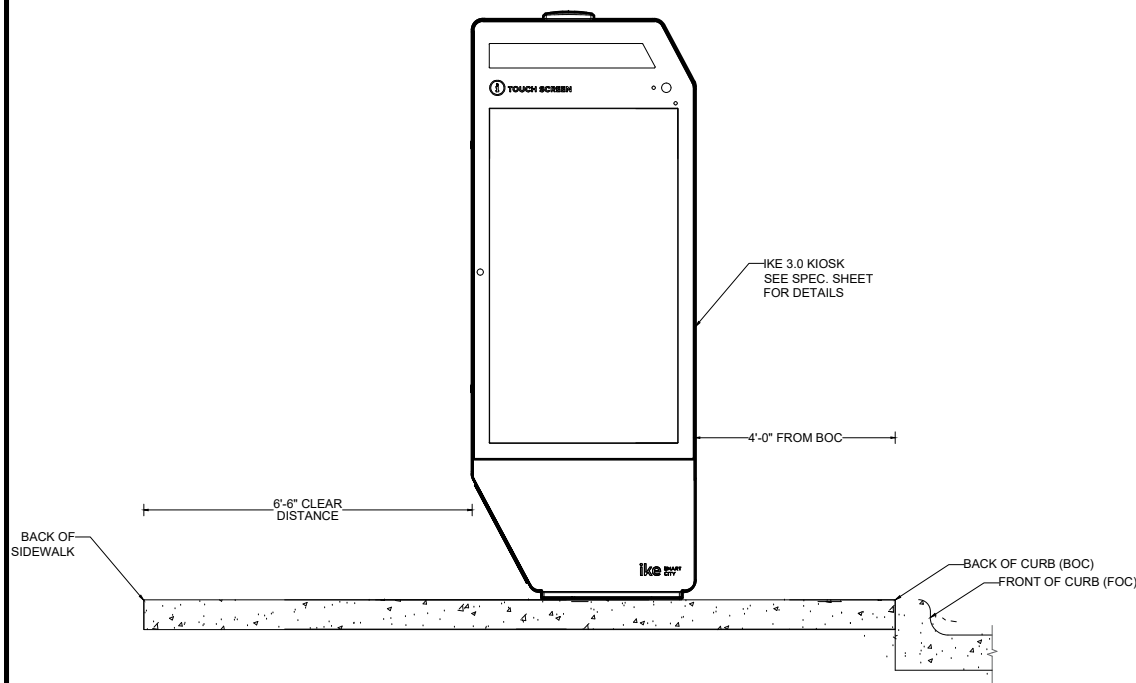

6'-6" CLEAR DISTANCE

14'-6" FROM BOC TO R/W

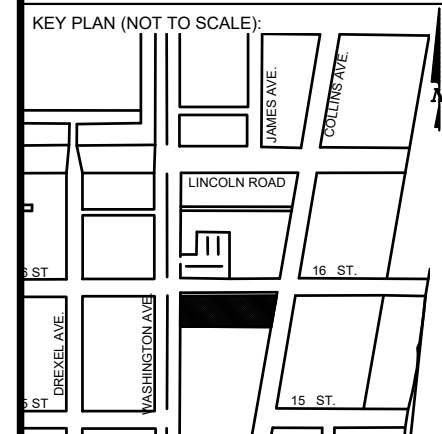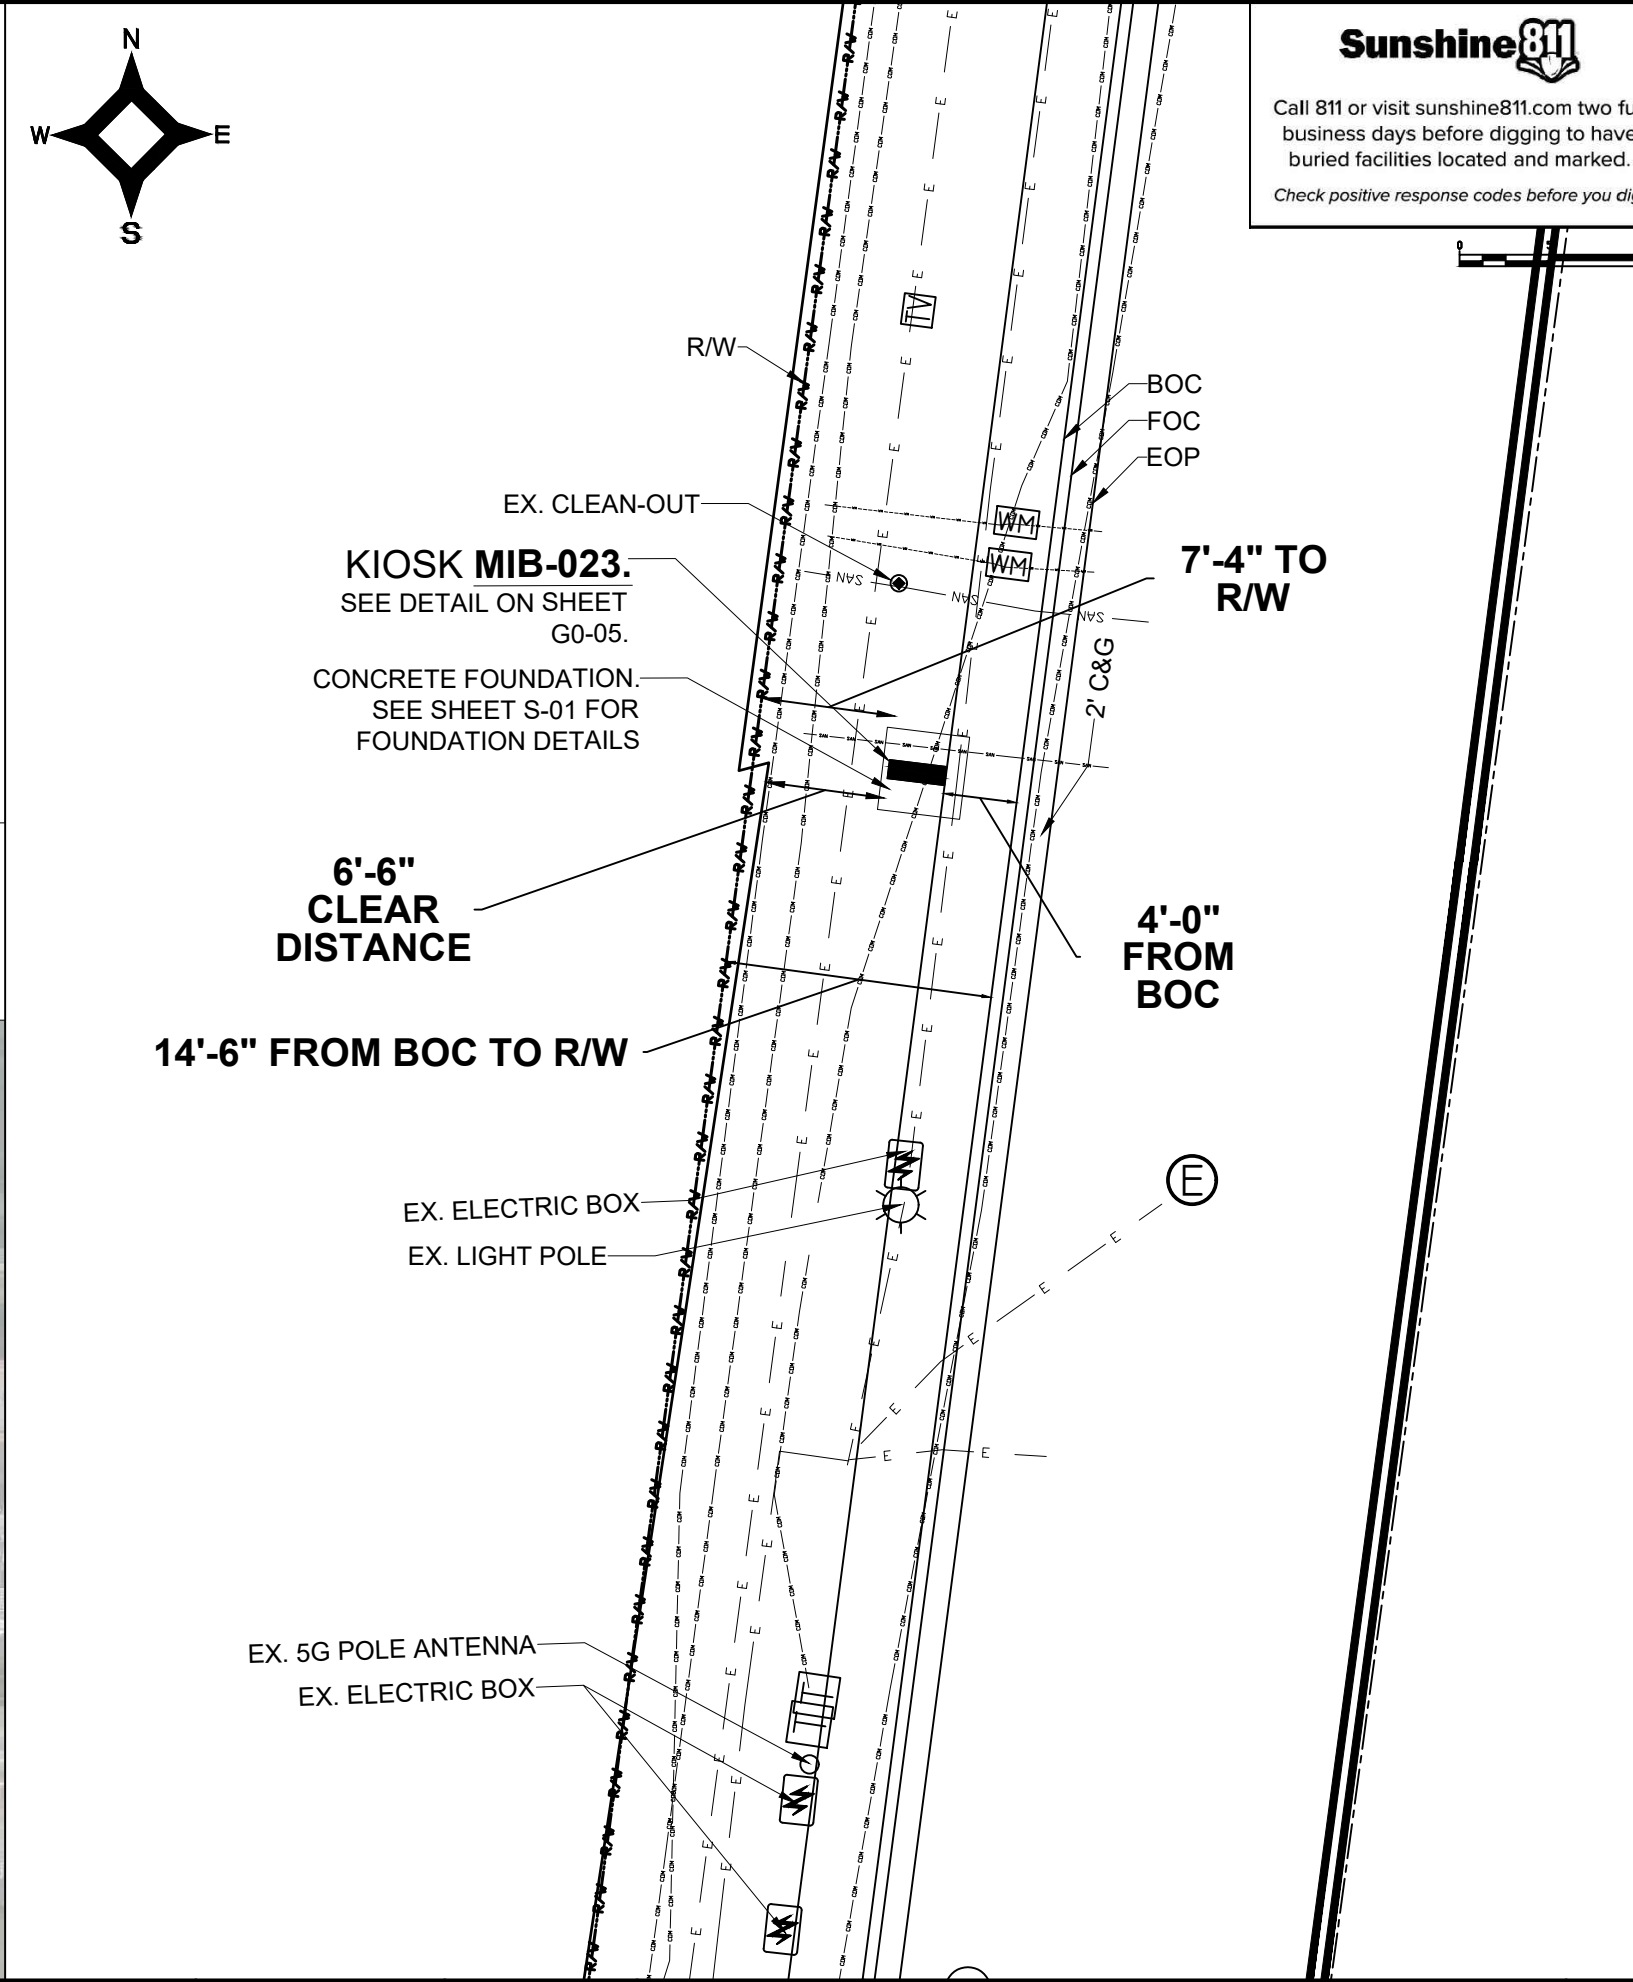


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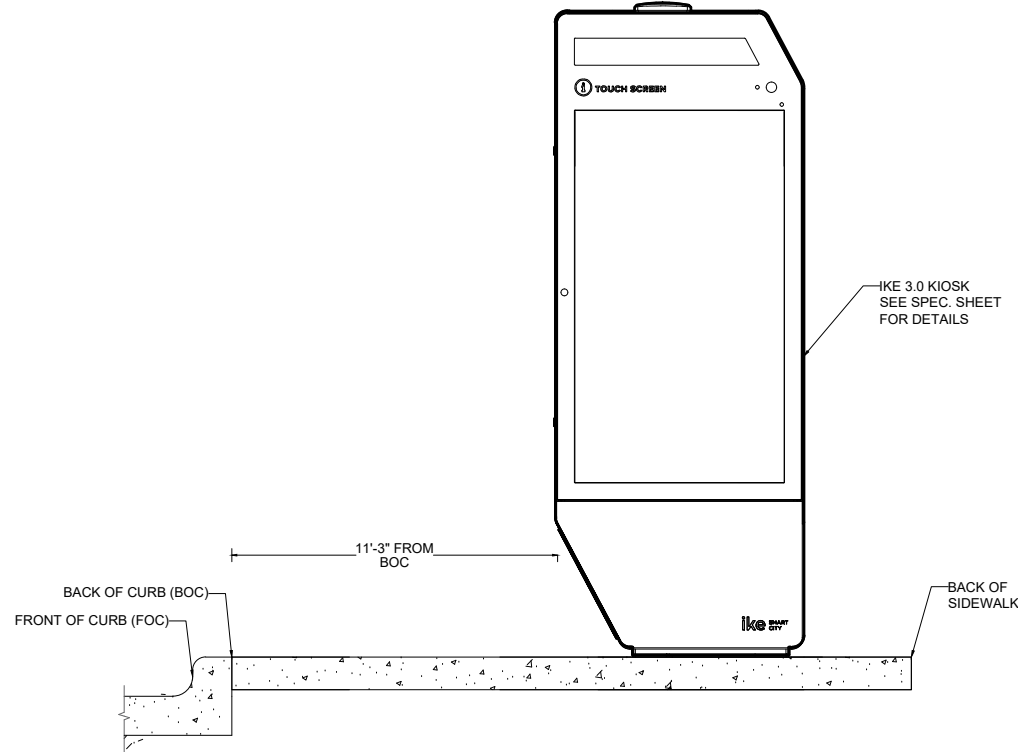
VANESSA A. MELA
LICENSE
No. 77676
STATE OF FLORIDA
PROFESSIONAL ENGINEER

FDOT EXHIBIT 212-5
V = 30 MPH
dr = 120 ft
dl = 255 ft




5			
4			
3			
2			
1			
NO.	DATE	REVISION	APP'D. BY

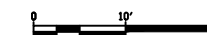

NOTES:



VISIBILITY TRIANGLE CLEARANCE ANALYSIS
SCALE: 1'-30"

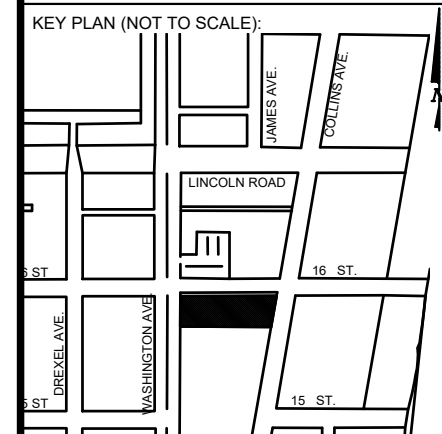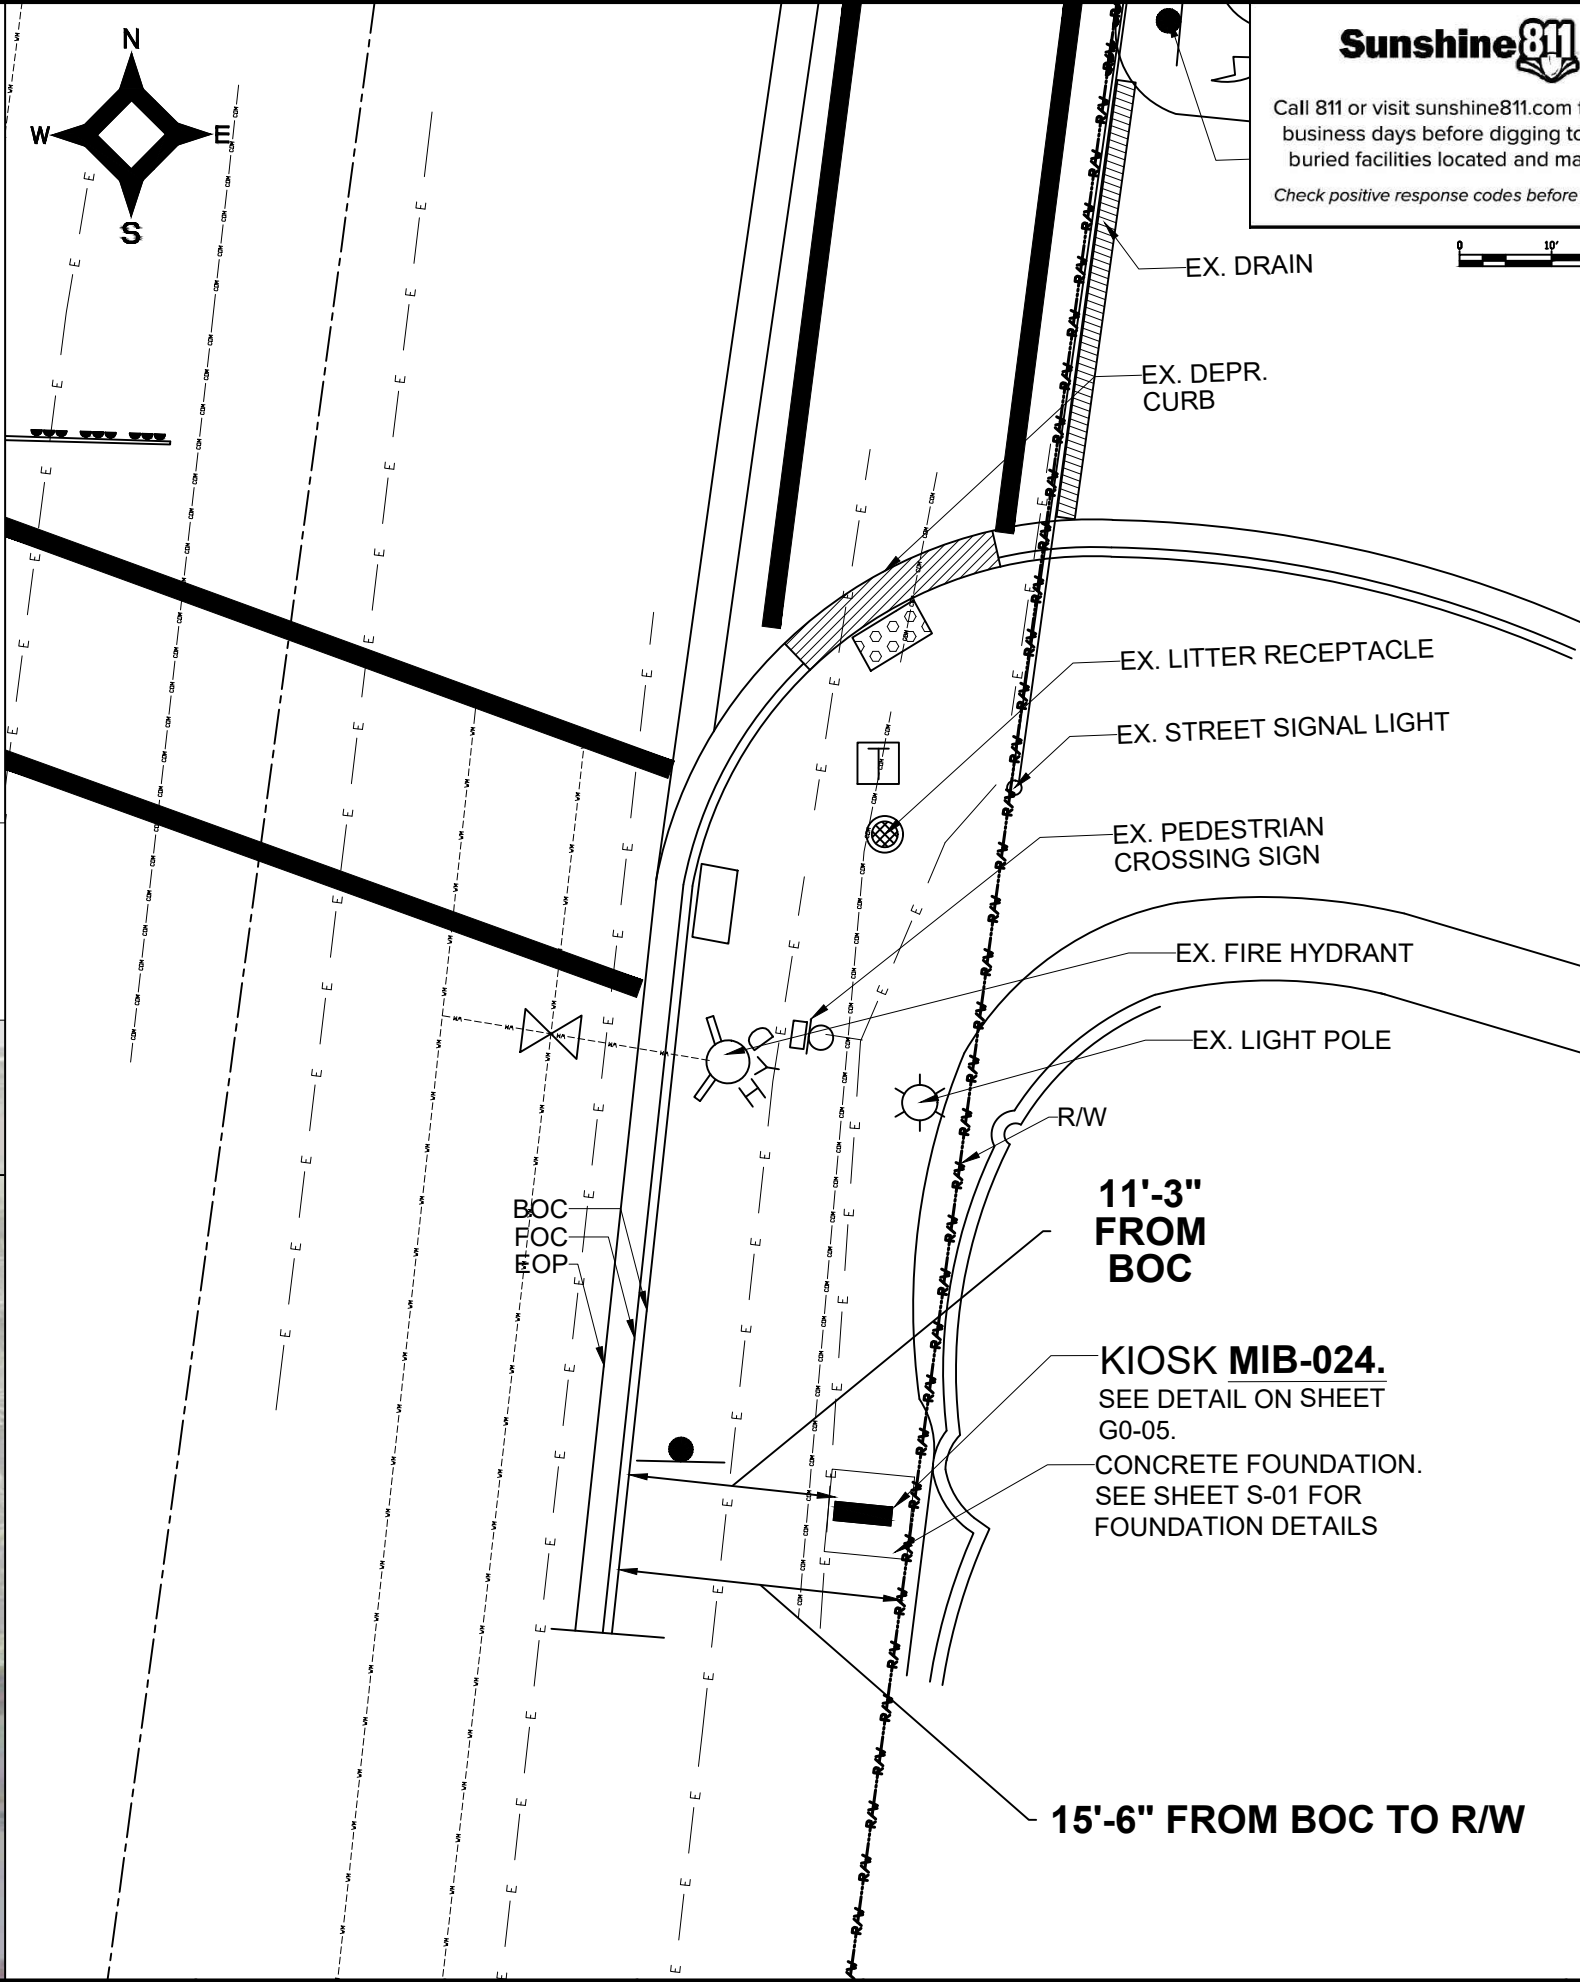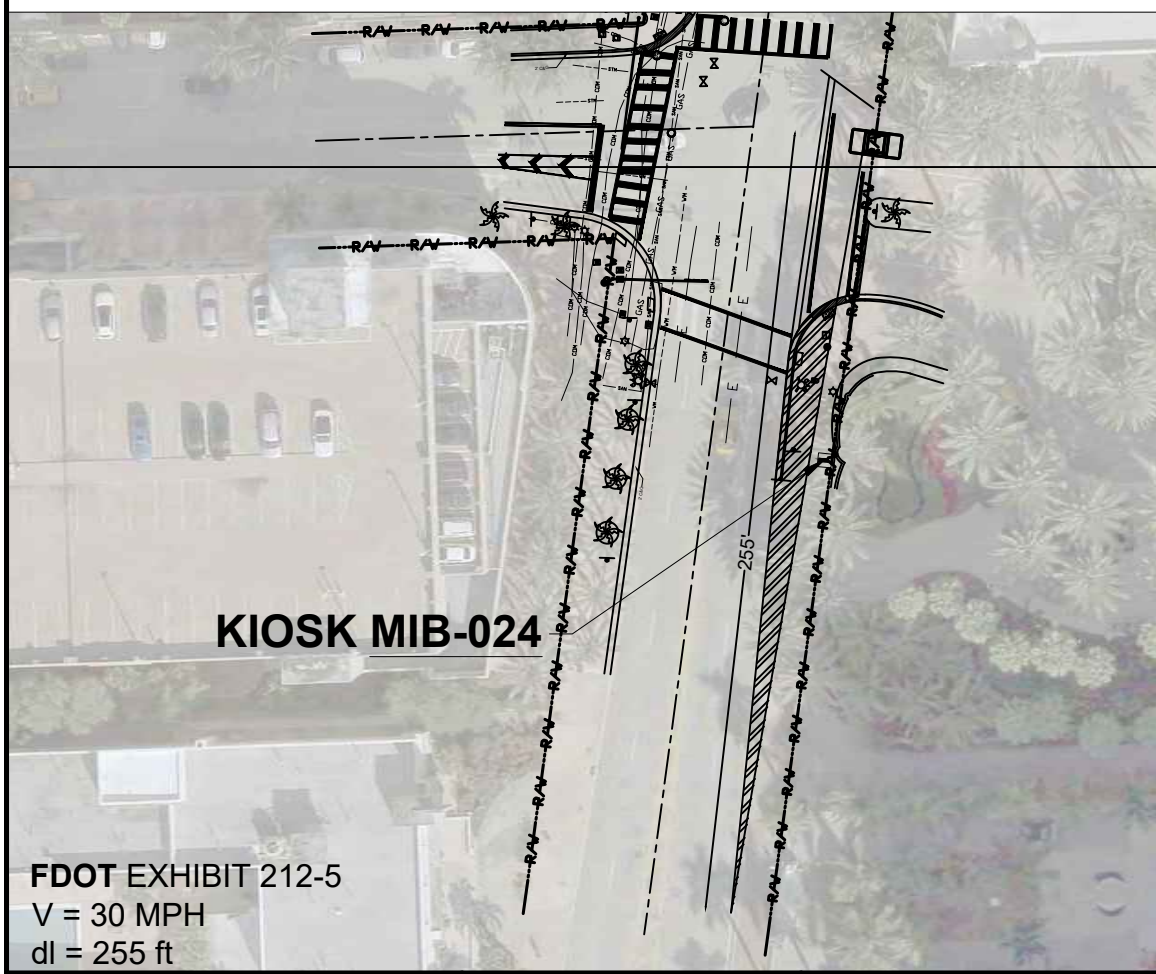

P.E. SEAL:

FDOT EXHIBIT 212-5
V = 30 MPH
dl = 255 ft

MIAMI BEACH
PUBLIC WORKS DEPARTMENT
1700 CONVENTION CENTER DRIVE, MIAMI BEACH, FL 33139

CITY MANAGER: ALINA T. HUDAK
DIRECTOR: JOE GOMEZ, P.E.
CITY ENGINEER: CRISTINA ORTEGA CASTINEIRAS, P.E.

NO.	DATE	REVISION	APP'D. BY
5			
4			
3			
2			
1			

Main Street ENGINEERING
7035 SW 47th Street, Ste A, Miami, FL 33155
Tel: (305) 406-3055 Fax: (305) 476-9894
FL PE Certificate No: 00008751

ENGINEER OF RECORD: VANESSA A. MELA, P.E. NO. 77676

ENGINEER OF RECORD: VM
DESIGN ENGINEER: VM
DRAWN BY: KM
CHECKER: WP
SCALE: 1"=5'

NEIGHBORHOOD: MIB-023: COLLINS AVENUE & LINCOLN ROAD
MIB-024: COLLINS AVENUE & 16TH STREET

TITLE: **KIOSK MIB-024 ENGINEERING PLAN**

File Name: MIB-023 & MIB-024 - CIVIL PLANS.dwg
Survey Reference:
Field Book: N/A Page: N/A Work Order: N/A
Date: 10/09/2023 Sheet: 5 of 9 Drawing: C1-03



EXISTING FPL PULLBOX
JB-1 W/ 120-240V BOOTS

AREA 1
SHEET E1-01

NEW FPL PULLBOX JB-2

NEW PULLBOX JB-3

NEW PULLBOX JB-4

NEW FPL METER

NEW KIOSK MIB-023

NEW PULLBOX JB-5

NEW PULLBOX JB-6


NEW PULLBOX JB-7

NEW KIOSK MIB-024


AREA 2
SHEET E1-02

ELECTRICAL SITE PLAN

SCALE: 1"=50'


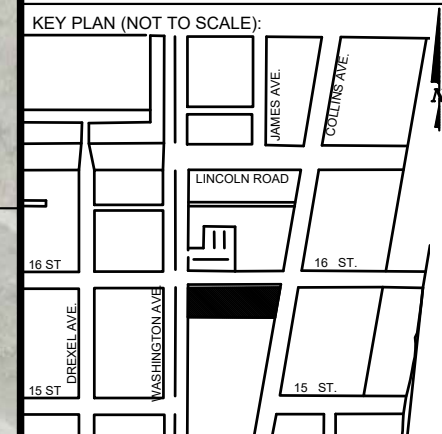


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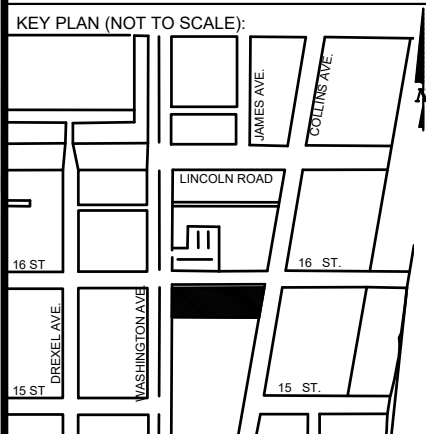


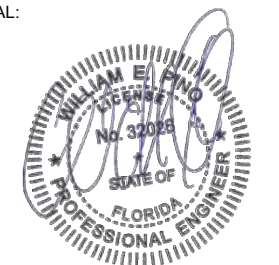NO.	DATE	REVISION	APP'D. BY
5			
4			
3			
2			
1			




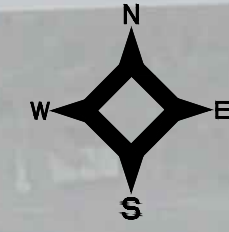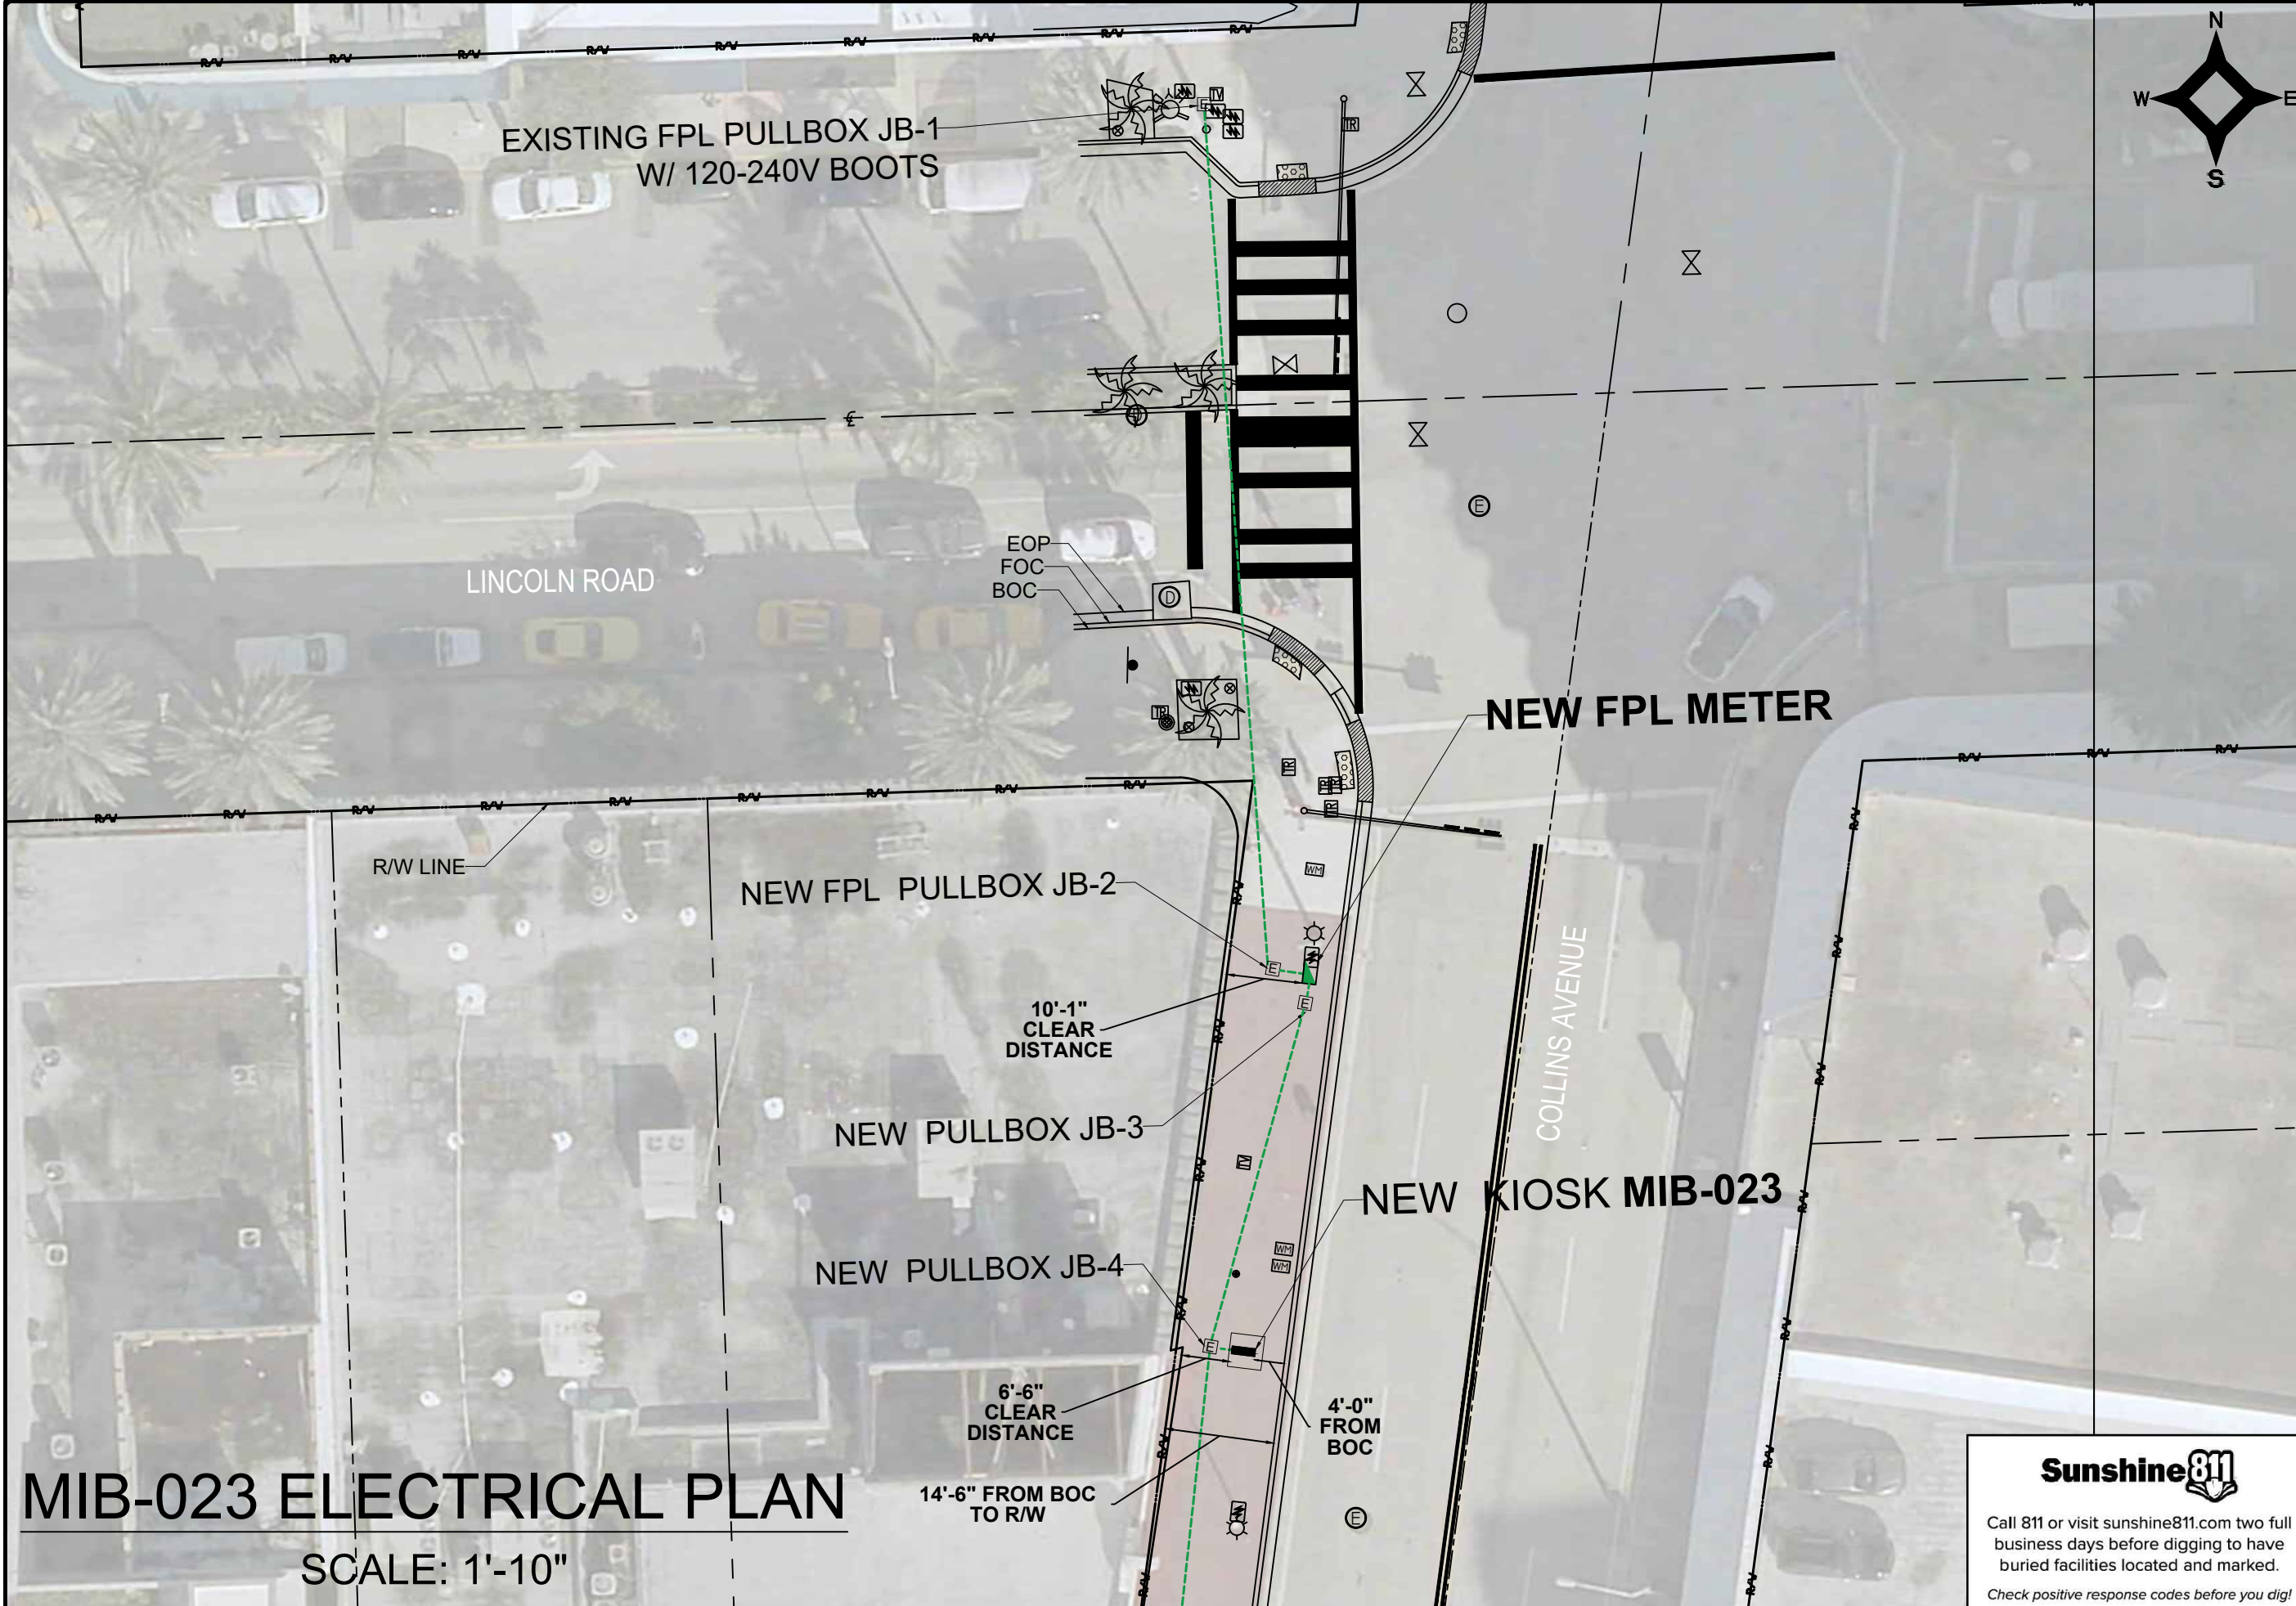

NOTES:



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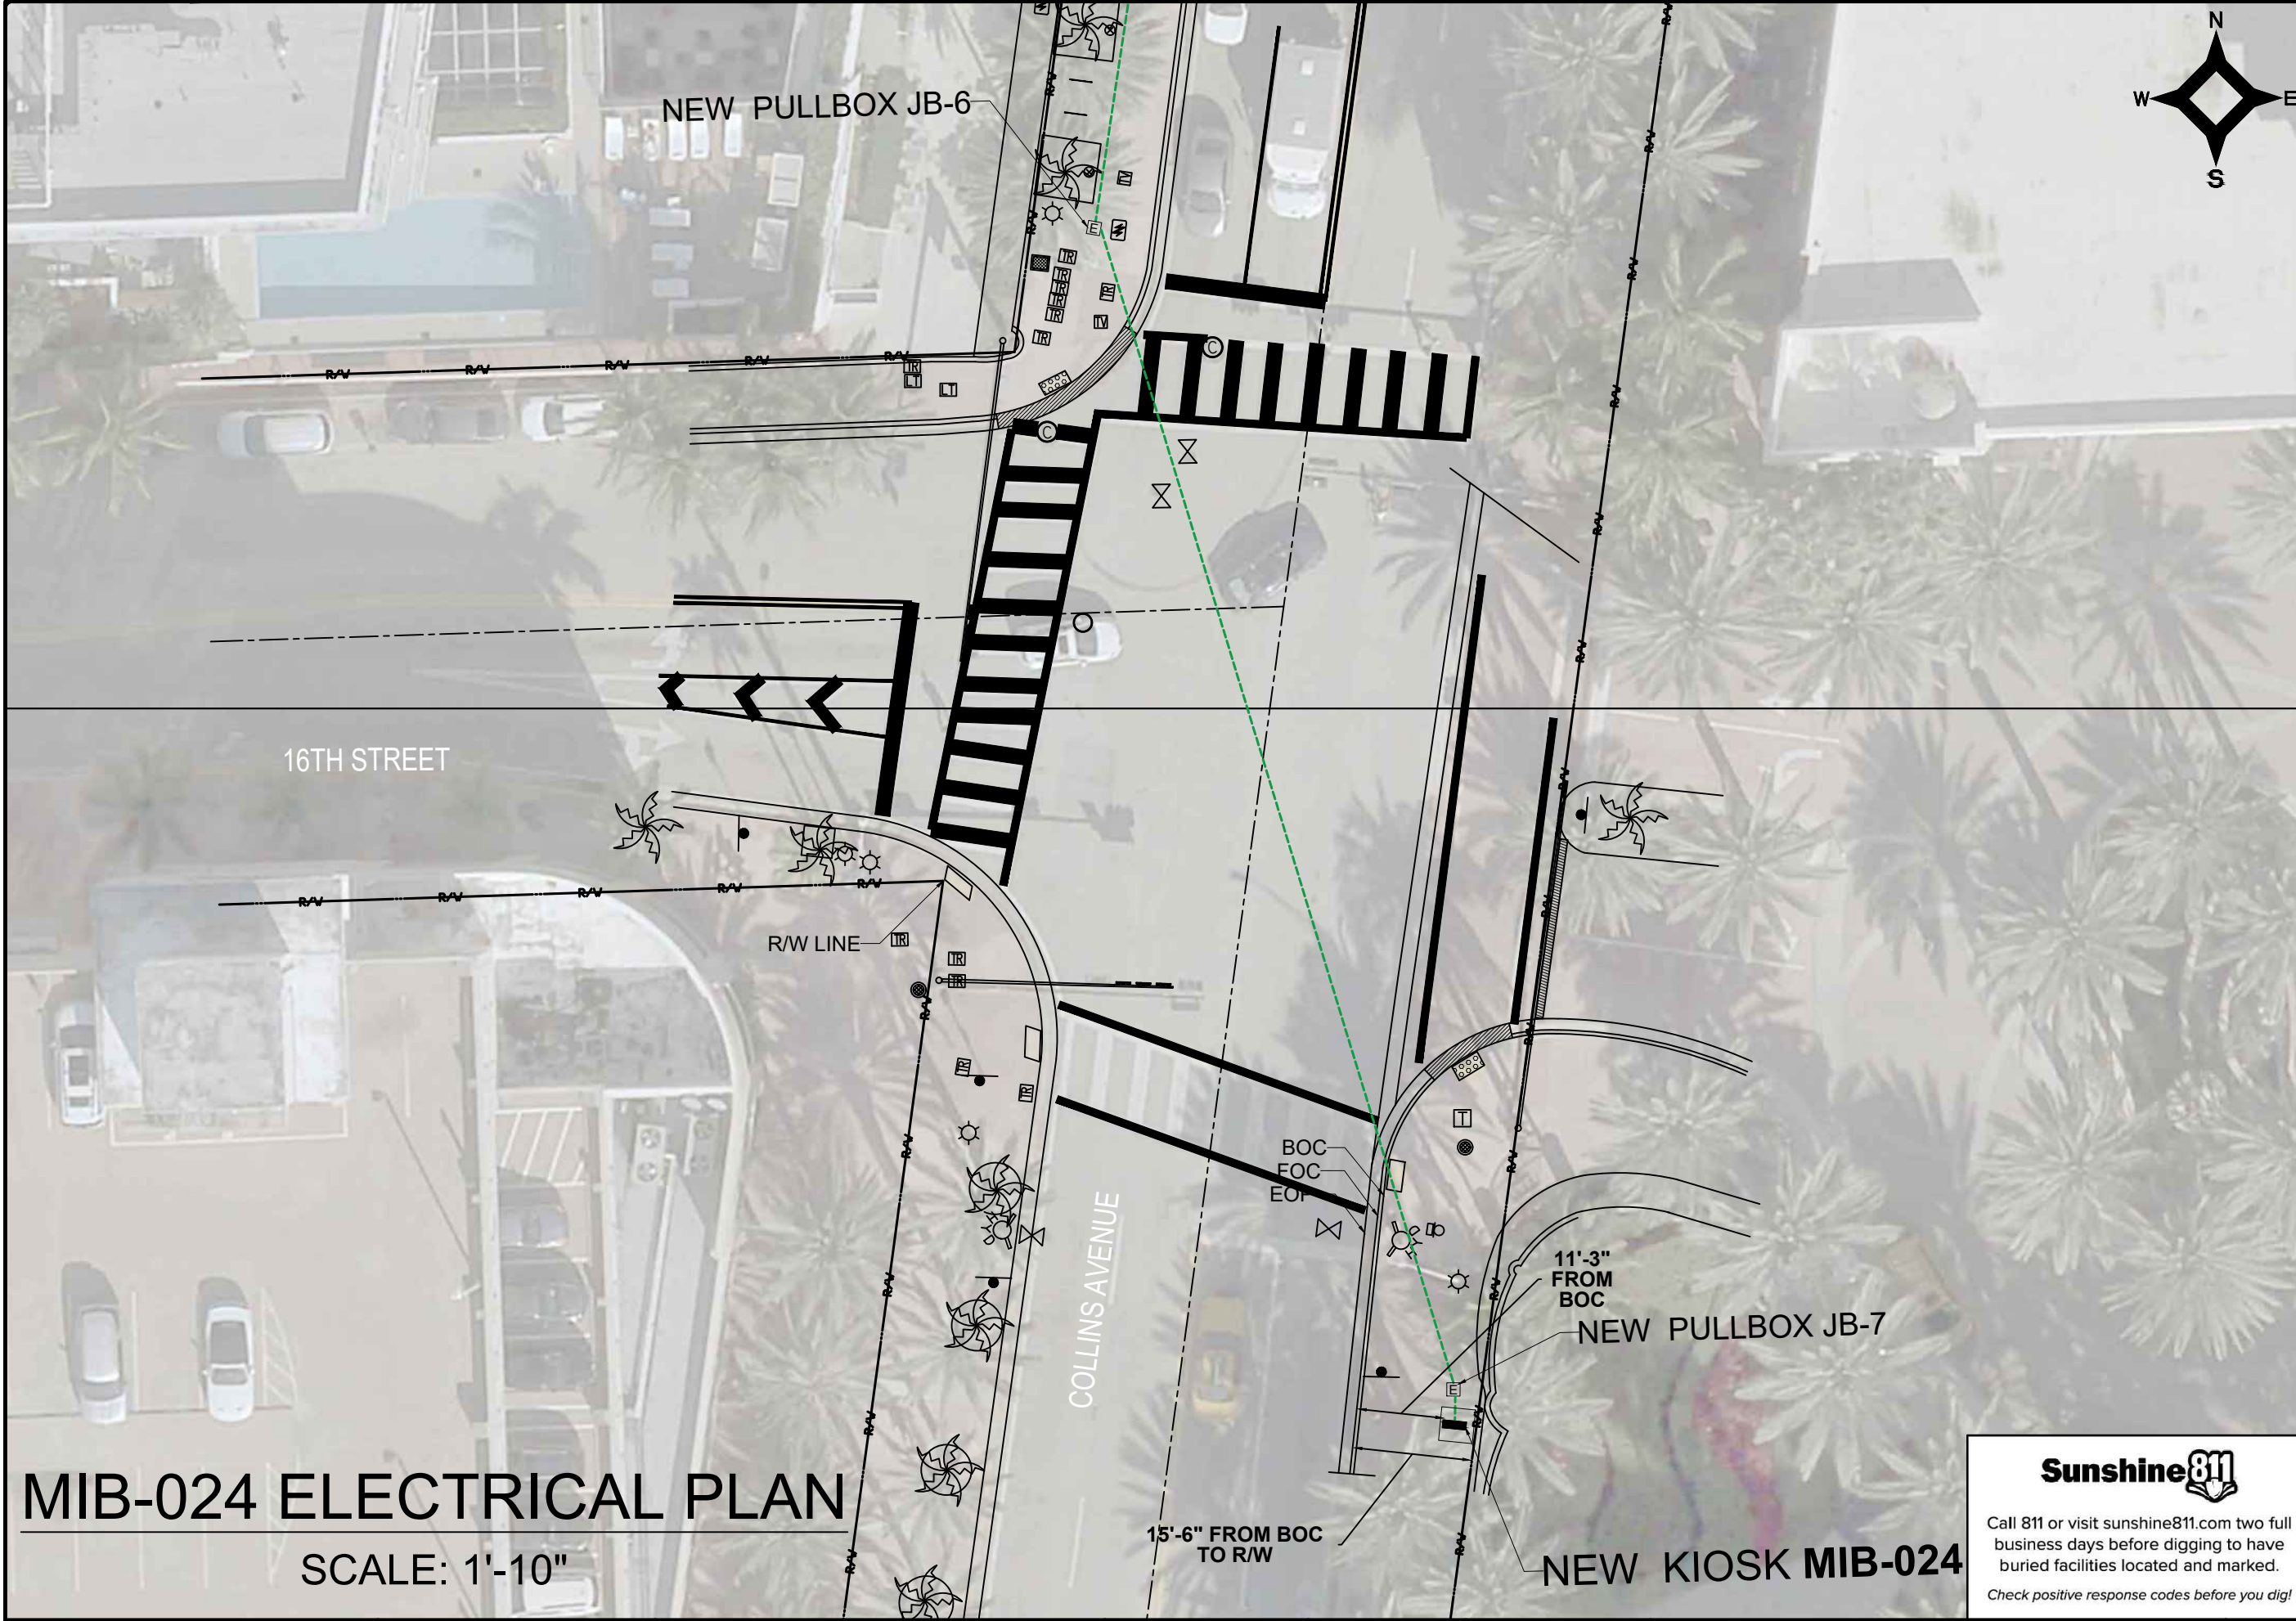


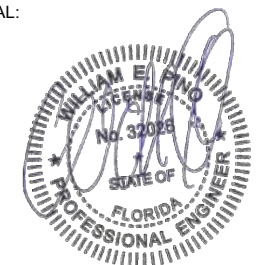Sunshine811
 Call 811 or visit sunshine811.com two full business days before digging to have buried facilities located and marked.
 Check positive response codes before you dig!



MIB-023 ELECTRICAL PLAN
 SCALE: 1'-10"

NO.	DATE	REVISION	APP'D. BY
5			
4			
3			
2			
1			






NOTES:

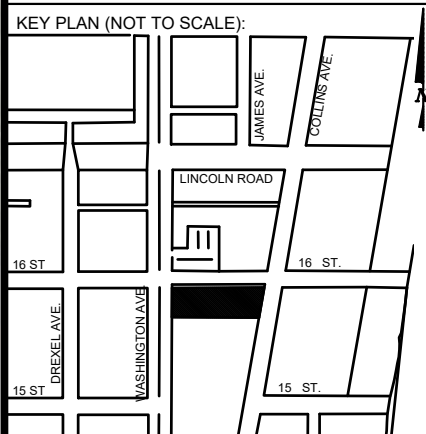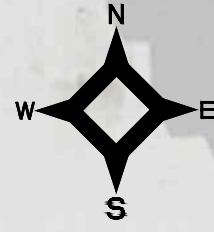

P.E. SEAL:

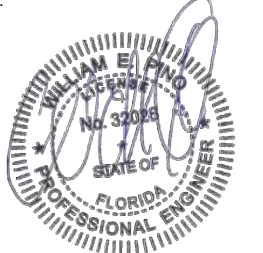

Sunshine811
 Call 811 or visit sunshine811.com two full business days before digging to have buried facilities located and marked.
 Check positive response codes before you dig!

MIB-024 ELECTRICAL PLAN
 SCALE: 1'-10"

MIAMI BEACH
 PUBLIC WORKS DEPARTMENT
 1700 CONVENTION CENTER DRIVE, MIAMI BEACH, FL 33139

CITY MANAGER: ALINA T. HUDAK
 DIRECTOR: JOE GOMEZ, P.E.
 CITY ENGINEER: CRISTINA ORTEGA CASTINEIRAS, P.E.

NO.	DATE	REVISION	APP'D. BY
5			
4			
3			
2			
1			



ENGINEER OF RECORD:
 WILLIAM E. PINO,
 P.E. NO. 32028

ENGINEER OF RECORD: WP
 DESIGN ENGINEER: WP
 DRAWN BY: KM
 CHECKER: WP
 SCALE: 1"=10'

NEIGHBORHOOD: MIB-023: COLLINS AVENUE & LINCOLN ROAD
 MIB-024: COLLINS AVENUE & 16TH STREET
 TITLE: KIOSK MIB-024 ELECTRICAL PLAN

File Name: MIB-023 & MIB-024 - ELECTRICAL & TTC PLANS.dwg
 Survey Reference:
 Field Book: N/A Page: N/A Work Order: N/A
 Date: 10/09/2023 Sheet: 8 of 9 Drawing: E1-02

SPECIFIC PURPOSE SURVEY



LOCATION MAP

Not to Scale

SURVEYOR'S REPORT AND GENERAL NOTES

(Not valid without the attached Survey Map)

- This is not a Boundary Survey.
- These lands are subject to additional restrictions of record that were not furnished to the undersigning registered surveyor. A title search has not been performed by the surveyor.
- North arrow direction is based on an assumed Meridian. Bearings are based on an assumed meridian on a well-established line, said line is being noted as BR on the Survey Map.
- Only above ground improvements are shown herein. Foundations, underground features and utilities have not been located by this surveyor. Refer to SUE effort notes below.
- Survey markers found in the field have no identification unless otherwise shown. Any survey marker set by our company is labeled LB 7262 or PSM 6169.
- This Survey Map is intended to be displayed at the scale shown hereon. Data is expressed in U.S. Survey Foot.
- This Survey Map is being prepared for the use of the party/parties that it is certified to and does not extend to any unnamed individual, entity or assignee.
- FLOODPLAIN INFORMATION:** As scaled from Federal Insurance Rate Map (FIRM) of Community No. 120651 (City of Miami Beach), Panel 0317, Suffix L, revised on Sept 11th, 2009, this real property falls in Zone "AE" with Base Flood Elevation 8 feet (NGVD 1929)
- HORIZONTAL ACCURACY:** Accuracy obtained thru measurements and calculations meets and exceeds the minimum horizontal feature accuracy for a Suburban area being equal to 1 foot in 7,500 feet.
- VERTICAL CONTROL AND ACCURACY:** The elevations as shown are referred to the National American Vertical Datum of 1988 (NAVD 1988). The closure in feet, as computed, meets the standard of plus or minus 0.05 feet times the squared root of the loop distance in miles. Elevation are based on a level loop from and to the following official Bench Marks:
 Bench Mark # 1: City Miami Beach Bench Mark CMB W 16, Elevation = 4.00 feet (NAVD'88)
 Description: PK nail & washer @ Northeast quadrant of intersection Washington Avenue and 16th Street.
 Bench Mark # 2: City Miami Beach Bench Mark CMB 16 02R, Elevation = 2.03 feet (NAVD'88)
 Description: PK nail & washer @ Northwest quadrant of intersection Pennsylvania Avenue & 16th Street.




11. SUE NOTES:

Subsurface Utility Investigation was performed by South Florida Utility Location Services using GPR (Ground Penetrating Radar) and RD (Radiodetection Technology) for designation and location of underground facilities. The horizontal accuracy of this method is +/- 1.5 feet approximately, and is subject to equipment limitations. This Survey depicts the location of the marks indicating the approximate location of the buried pipes and conduits. There might be additional underground facilities not discovered at the time of this survey. Underground utility references as shown on this survey drawing is solely based on information marked on the field by South Florida Utility Location Services for this project. Contact information below:

South Florida Utility Location Services
 15323 SW 31st Terrace, Miami, Florida 33185
 (786) 547 9086 Office, Email: rogerh@sf-uls.com, Contact Person: Roger Hasbani

Surveyor is not responsible for any errors or omissions that could arise from the information provided. Call 811 or visit www.sunshine811.com before digging.

- **E** --- = RED PAINT LINE APPARENT ELECTRIC CONDUIT
- **W** --- = BLUE PAINT LINE APPARENT WATER LINE
- **SAN** --- = GREEN PAINT LINE APPARENT SANITARY SEWER LINE
- **GAS** --- = YELLOW PAINT LINE APPARENT GAS LINE
- **COM** --- = ORANGE PAINT LINE APPARENT COMMUNICATION LINE
- **STM** --- = GREEN PAINT LINE APPARENT STORM SEWER LINE

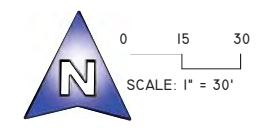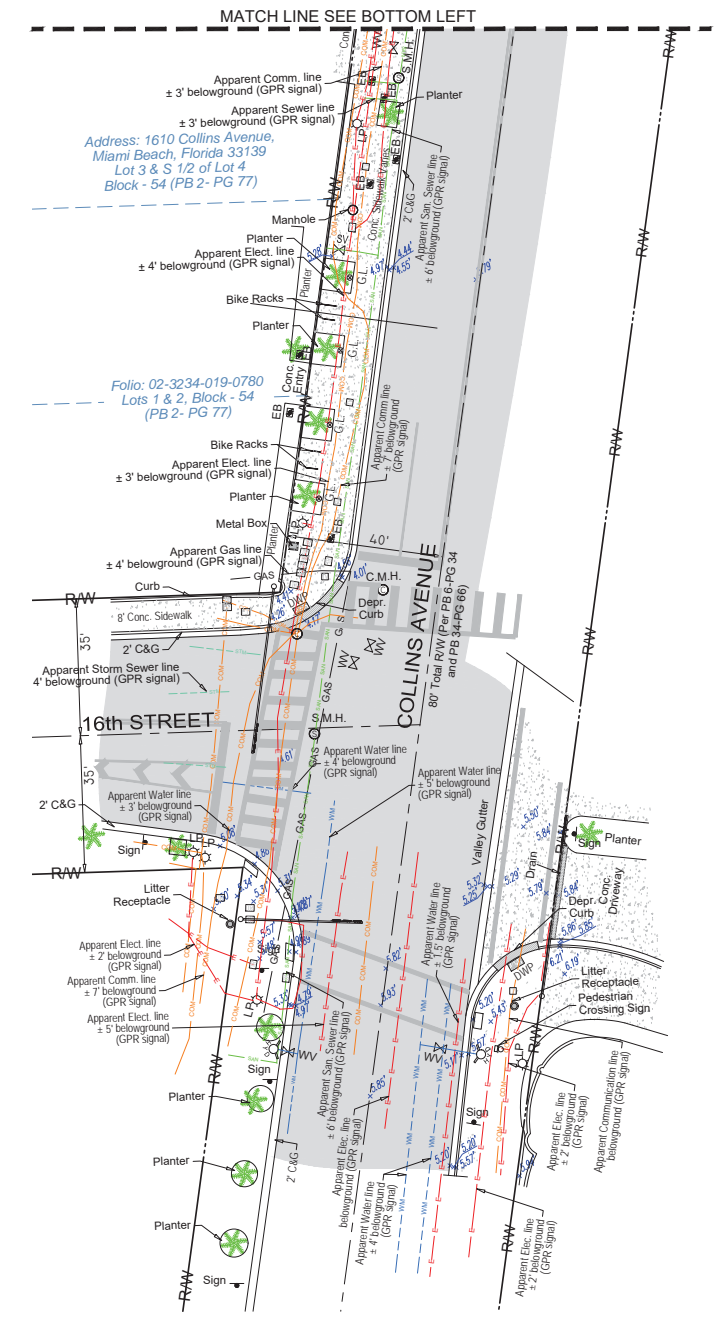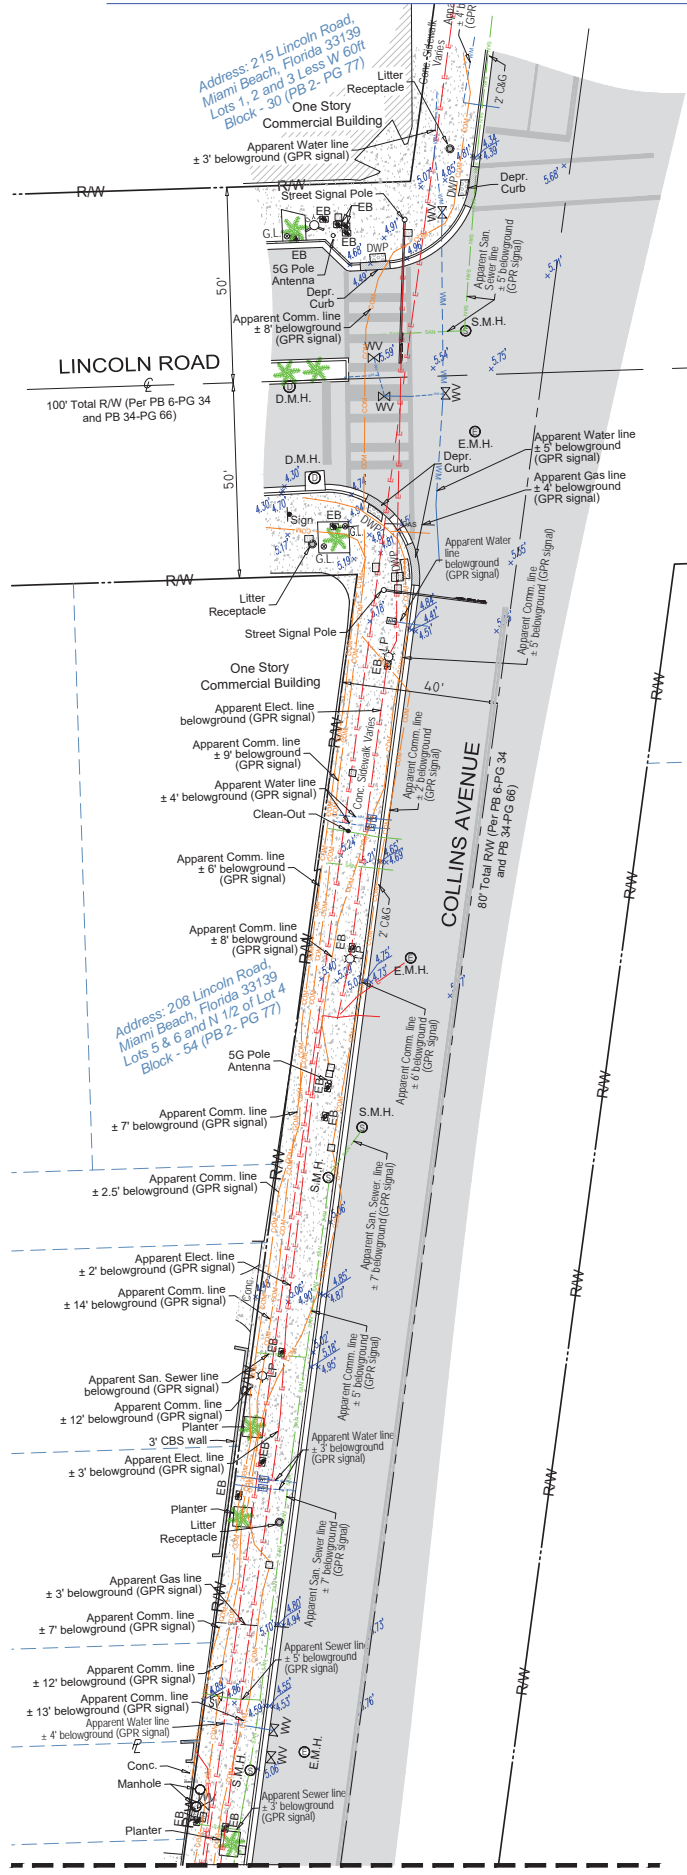

LEGEND & ABBREVIATIONS

- = CONCRETE (CONC.)
- = CONCRETE BLOCK WALL
- = WOOD DECK
- = COVERED AREA
- = ASPHALT
- = TILE
- = PAVERS
- = DETECTABLE WARNING PAD (DWP)
- = CHAIN LINK FENCE (CLF)
- = WOOD FENCE (WF)
- = IRON METAL BARS FENCE (IF)
- = OVERHEAD WIRES
- = SEWER VALVE (S.V.)
- = POWER POLE (PP)
- = GUY ANCHOR
- = WATER METER (WM)
- = CONC. LIGHT POLE (LP)
- = ELECTRIC BOX (EB)
- = GARDEN LIGHT (G.L.)
- = STREET SIGN
- = SANITARY MANHOLE
- = DRAINAGE MANHOLE
- = ELECTRIC MANHOLE (E.M.H.)
- = CABLE MANHOLE (C.M.H.)
- = FIRE HYDRANT
- = BOX TELEPHONE
- = CABLE BOX (CATV)
- = TRAFFIC BOX
- = STREET LIGHT BOX
- = CATCH BASIN OR INLET
- = EXISTING ELEVATION
- = PALM (NO IDENTIFIED)
- = TREE (NO IDENTIFIED)
- PT** = POINT OF TANGENCY
- PC** = POINT OF CURVATURE
- PCC** = POINT OF COMPOUND CURVE
- PRC** = POINT OF REVERSE CURVE
- BM** = BENCH MARK
- BR** = BEARING REFERENCE
- DWP** = DETECTABLE WARNING PAD
- DEPR.** = DEPRESSED
- E** = PROPERTY LINE
- CL** = CENTER LINE
- BL** = BASE LINE
- PSM** = PROFESSIONAL SURVEYOR AND MAPPER
- C&G** = CURB & GUTTER
- GA** = GUY ANCHOR
- ENCR** = ENCROACHMENT
- VG** = VALLEY GUTTER
- (XX-XX)** = DENOTES PLAT BOOK XX - PAGE XX
- ORB** = OFFICIAL RECORD BOOK
- CBS** = CONCRETE BLOCK STRUCTURE
- R/W** = RIGHT OF WAY
- ELEV** = ELEVATION
- SEC** = SECTION
- T** = TOWNSHIP
- R** = RANGE
- (M)** = FIELD MEASURED
- (C)** = CALCULATED
- (R)** = RECORD
- (P)** = PER PLAT

I HEREBY CERTIFY TO:
 Main Street Engineering, that this Survey conforms to the Standards of Practice as set forth by the Florida Board of Professional Surveyors and Mappers in applicable provisions of Chapter 5J-17, Florida Administrative Code pursuant to Section 472.027 Florida Statutes. This Survey is accurate and correct to the best of my knowledge and belief.

Odalys C. Bello
 c=US, o=Bello and Bello Land Surveying Corp.
 dnQualifier=A01410C000001884E3B
 67E806DD40A, cn=Odalys C. Bello
 2023.09.11 10:18:55 -0400

Odalys C. Bello-Iznaga
 Professional Surveyor and Mapper LS6169 - State of Florida
 Field Work Date: 07/27/2023

Additional and deletions to this Survey Map are prohibited. This Survey Map and Report are not valid without the signature and original raised seal or without the authenticated electronic signature and seal of the undersigning Florida licensed Surveyor and Mapper.

Property Address:
 200 Lincoln Road, Miami Beach, Florida 33139
 Project No. 23259 D.B.: EO Page 1 of 1

BELLO & BELLO LAND SURVEYING
 12230 SW 131 AVENUE • SUITE 201 • MIAMI FL 33186
 Phone: 305.251.9606 • Fax: 305.251.6057 • LB#7262
 e-mail: info@belloland.com • www.bellolandsurveying.com



9. Collins Ave & 16th Street



APPROXIMATE LOCATION

MIAMI BEACH

PUBLIC WORKS DEPARTMENT

INTERACTIVE DIGITAL KIOSK DEPLOYMENT PROJECT

OCTOBER 2023

IKE SMART CITY

MIB-007: OCEAN DRIVE & 14TH PLACE

CITY OF MIAMI BEACH

MAYOR: DAN GELBER

COMMISSIONERS: MICKY STEINBERG
MARK SAMUELIAN
MICHAEL GONGORA
STEVEN MEINER
RICKEY ARRIOLA
DAVID RICHARDSON

CITY MANAGER: ALINA T. HUDAK

CITY ATTORNEY: RAFAEL A. PAZ

PUBLIC WORKS DIRECTOR: JOE GOMEZ, P.E., F.FES

CITY ENGINEER: NELSON PEREZ-JACOME, PE



LOCATION MAP



INDEX OF PLANS

NUMBER	DISCIPLINE	SHEET NO.	DESCRIPTION	NOTES
1	GENERAL	G0-03	INDEX OF SHEETS	
2	GENERAL	G0-04	ADA NOTES, SCOPE OF WORK & KIOSK SPECIFICATIONS	
3	CIVIL	C1-01	CIVIL SITE PLAN	
4	CIVIL	C1-02	MIB-007 ENGINEERING PLAN	
5	ELECTRICAL	E0-01	ELECTRICAL SITE PLAN	
6	ELECTRICAL	E1-01	KIOSK MIB-007 ELECTRICAL PLAN	
7	ELECTRICAL	E1-02	SERVICE POINT ELECTRICAL PLAN	
8	SURVEY		KIOSK MIB-007 SITE SURVEY	
9	SURVEY		SERVICE POINT SITE SURVEY	

SCOPE OF WORK: THE PROJECT CONSISTS OF THE INSTALLATION OF ONE (1) DIGITAL INTERACTIVE KIOSK AND APPLICABLE INFRASTRUCTURE; STRUCTURAL FOUNDATION AND ELECTRICAL SERVICE AT THE LOCATION INDICATED ON THESE DESIGN PLANS.


FINAL SUBMITTAL 10/09/2023

Always call 811 two full business days before you dig to have underground utilities located and marked.



INDEX OF PLANS

NUMBER	DISCIPLINE	SHEET NO.	DESCRIPTION	NOTES
1	GENERAL	G0-03	INDEX OF SHEETS	
2	GENERAL	G0-04	ADA NOTES, SCOPE OF WORK & KIOSK SPECIFICATIONS	
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5	ELECTRICAL	E0-01	ELECTRICAL SITE PLAN	
6	ELECTRICAL	E1-01	KIOSK MIB-007 ELECTRICAL PLAN	
7	ELECTRICAL	E1-02	SERVICE POINT ELECTRICAL PLAN	
8	SURVEY		KIOSK MIB-007 SITE SURVEY	
9	SURVEY		SERVICE POINT SITE SURVEY	

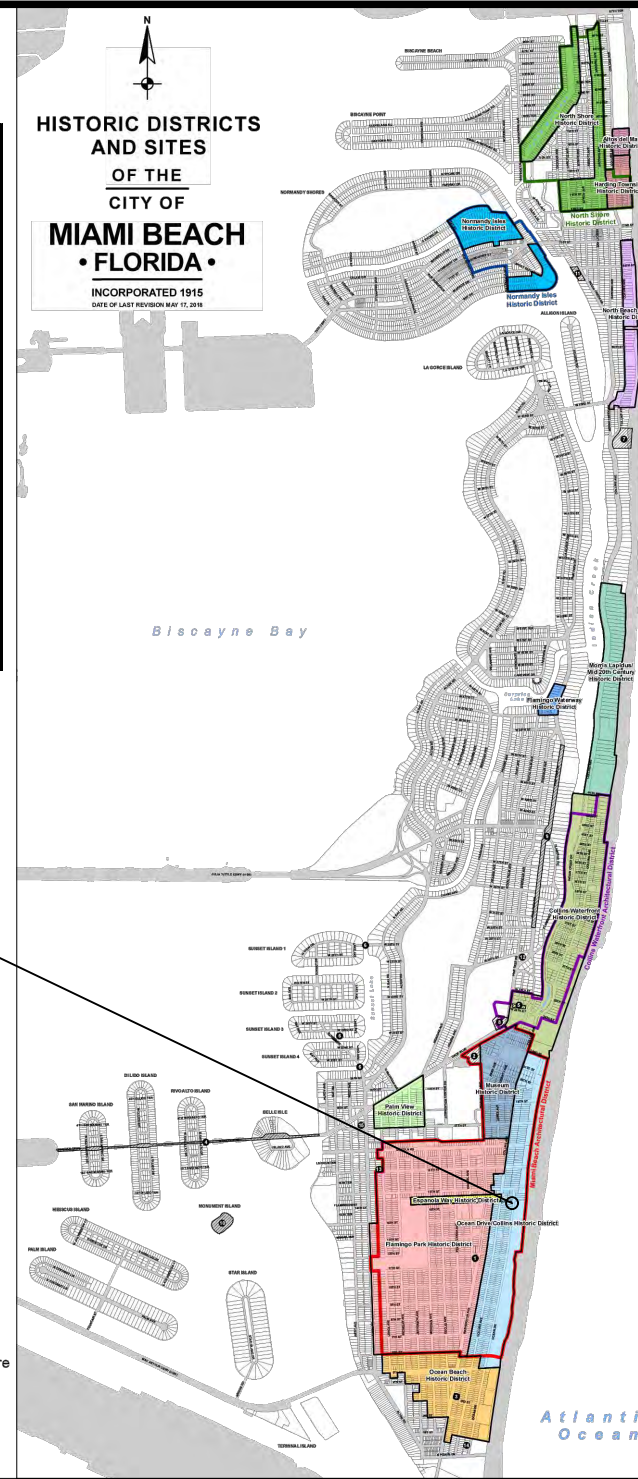

LEGEND AND ABBREVIATIONS

- = PALM TREE
- = TREE
- = ORNAMENTAL TREE
- O.R.B. = OFFICIAL RECORDS BOOK
- PG. = PAGE
- ELEV. = ELEVATION
- TYP. = TYPICAL
- CATV = CABLE TELEVISION
- OHE = OVERHEAD ELECTRIC LINE
- X 0.00 = SPOT ELEVATION
- CONC. = CONCRETE
- C.B.S. = CONCRETE BLOCK STUCCO
- C.L.F. = CHAIN LINK FENCE
- W.F. = WOOD FENCE
- M.F. = METAL FENCE
- RCP = REINFORCED CONCRETE PIPE
- FF = FINISH FLOOR
- (R) = RECORD
- (C) = CALCULATED
- (M) = MEASURE
- LB = LICENSE BUSINESS
- L = LENGTH
- Δ = CENTRAL ANGLE
- R = RADIUS
- T = TANGENT
- PT = POINT OF TANGENCY
- PC = POINT OF CURVATURE
- STA. = STATION
- PI = POINT OF INTERSECTION
- ID = IDENTIFICATION
- MLP = METAL LIGHT POLE
- CLP = CONCRETE LIGHT POLE
- R/W = RIGHT-OF-WAY
- P.B. = PLAT BOOK
- § = SECTION LINE
- = CENTERLINE
- = BASELINE
- = MONUMENT LINE
- = TRAFFIC SIGNAL BOX
- = TRAFFIC SIGNAL CABINET
- = BOLLARD
- = PEDESTRIAN SIGNAL
- = TRAFFIC SIGNAL MAST ARM
- = SIGN
- = CABLE TELEVISION BOX
- = LIGHT POLE
- = ELECTRIC BOX
- = UTILITY POLE
- = ELECTRIC TRANSFORMER
- = GUY ANCHOR
- = ELECTRIC MANHOLE
- = ELECTRIC METER
- = GAS VALVE
- = GAS UTILITY BOX
- = GAS MANHOLE
- = GAS TANK
- = GAS METER
- = COMMUNICATION BOX
- = COMMUNICATION MANHOLE
- = GARBAGE RECEPTACLE
- = HANDICAP PARKING SPACE
- = WATER METER
- = IRRIGATION VALVE
- = WATER VALVE
- = FIRE HYDRANT
- = WATER BOX
- = WATER CONNECTION
- = WATER MANHOLE
- = WATER TANK
- = WATER WELL
- = WATER MARKING FLAG
- = WATER MARKING SIGN
- = STORM MANHOLE
- = STORM METER
- = CATCH BASIN
- = TELEPHONE MANHOLE
- = TELEPHONE BOX
- = NEWSPAPER DISPENSER
- = MAILBOX
- = SANITARY MANHOLE
- = SANITARY BOX
- = SANITARY TANK
- = SANITARY LIFT STATION
- = GREASE TRAP MANHOLE
- = CLEANOUT
- = PARKING METER
- = FIBER OPTIC BOX
- = FIBER OPTIC MARKER SIGN
- = MONITORING WELL
- = FUEL TANK
- = UNKNOWN UTILITY BOX
- = UNKNOWN UTILITY METER
- = UNKNOWN UTILITY MANHOLE
- = UNKNOWN UTILITY VALVE
- = UNKNOWN UTILITY MARKER FLAG
- = SANITARY VALVE
- = RAILROAD SIGN
- = FLAGPOLE
- = PROPERTY LINE
- = ELECTRICAL OUTLET

PROJECT LOCATION OCEAN DRIVE/COLLINS AVENUE HISTORIC DISTRICT

LOCAL HISTORIC DISTRICTS

	Espanola Way Historic District		Palm View Historic District
	Altos del Mar Historic District		Collins Waterfront Historic District
	Flamingo Park Historic District		North Beach Resort Historic District
	Ocean Drive/Collins Avenue Historic District		Flamingo Waterway Historic District
	Museum Historic District		Morris Lapidus/Mid 20th Century Historic District
	Ocean Beach Historic District		North Shore Historic District
	Harding Townsite Historic District		Normandy Isles Historic District

NATIONAL REGISTER HISTORIC DISTRICTS

	Miami Beach Architectural District
	Normandy Isles Historic District
	North Shore Historic District
	Collins Waterfront Architectural District

LOCAL HISTORIC SITES

	1 Old City Hall Historic Site		8 Dade Blvd Fire Station Historic Site
	2 21st St Recreation Center Historic Site		9 PineTree Dr Historic Roadway
	3 Congregation Beth Jacob Historic Site		10 Flagler Memorial and Monument Island Historic Site
	4 Venetian Causeway Historic Site		11 69th St Fire Station Historic Site
	5 Miami Beach Woman's Club Historic Site		12 28th St Obelisk and Pumping Station Historic Structure
	6 Sunset Island Bridges Historic Structures		13 1600 Lenox Ave Historic Site
	7 The Bath Club Historic Site		14 36 Ocean Dr Historic Site
			15 1700 Alton Rd Historic Site

PROJECT DIRECTORY:

PROJECT NAME:
INTERACTIVE DIGITAL INFORMATION
KIOSKS DEPLOYMENT PROJECT

JURISDICTION:
CITY OF MIAMI
DEPARTMENT OF RESILIENCE AND
PUBLIC WORKS
MIAMI RIVERSIDE CENTER
444 S.W. 2nd AVENUE, 8th FLOOR
MIAMI, FLORIDA 33130
TEL: 305-416-1200

OWNER:
IKE SMART CITY
250 N HARTOFORD AVE
COLUMBUS, OH 43222
(614) 589-0087

ENGINEER OF RECORD:
MAINSTREET ENGINEERING
7035 SW 47 STREET, SUITE A
MIAMI, FL 33155
(305) 456-3505
PROJ. MGR: VANESSA MELA, P.E.
VMELA@MAINSTREETENG.COM

KIOSK MANUFACTURER:
DISPLAY DEVICE INC.
21075 WESTGATE RD.
GOLDEN, CO 80403
CONTACT: ERIC PERKINS
PHONE: (303) 929-4071

UTILITIES:

ELECTRICAL POWER: FLORIDA
POWER & LIGHT COMPANY (FPL)

WATER & SEWER: MIAMI-DADE
WATER & SEWAGE DEPARTMENT

TELEPHONE: AT&T


CABLE: COMCAST, XFINITY,
ATT-UVERSE

GAS: FLORIDA GAS

SIDEWALK & STREET SYMBOLS

	ASPHALT		BRICK
	PAVER		CONCRETE
	UNIMPROVED		TILE
	GRAVEL		STAMPED CONCRETE

KEY PLAN (NOT TO SCALE):

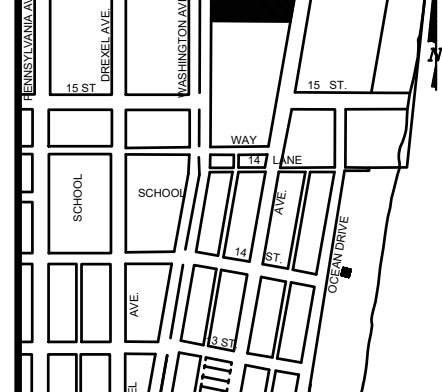

P.E. SEAL:

ADA NOTES

- ALL CONSTRUCTION ACTIVITIES SHALL BE COMPLETED IN FULL COMPLIANCE WITH THE AMERICANS WITH DISABILITIES ACT (ADA). CLEAR SPACES IN FRONT OF KIOSK SHALL HAVE THE FOLLOWING CHARACTERISTICS:
- SURFACES SHALL BE FIRM, STABLE, AND SLIP RESISTANT AND OTHERWISE COMPLY WITH PROWAG SECTION R302.7 AND SHALL HAVE A RUNNING SLOPE CONSISTENT WITH GRADE OF THE ADJACENT PEDESTRIAN ACCESS ROUTE AND CROSS SLOPE OF 1.50% +/-0.50%)
- SIZE: CLEAR SPACES SHALL BE 48" MINIMUM BY 48" MINIMUM.
- POSITION: UNLESS OTHERWISE SPECIFIED, CLEAR SPACES SHALL BE POSITIONED FOR EITHER FORWARD OR PARALLEL APPROACH TO THE KIOSK.
- APPROACH: ONE FULL UNOBSTRUCTED SIDE OF A CLEAR SPACE SHALL ADJOIN A PEDESTRIAN ACCESS ROUTE OR ADJOIN ANOTHER CLEAR SPACE.
- MANEUVERING SPACE: WHERE A CLEAR SPACE IS CONFINED ON ALL OR PART OF THREE SIDES, ADDITIONAL MANEUVERING SPACE SHALL BE PROVIDED AS FOLLOWS:
 - FORWARD APPROACH: THE CLEAR SPACE AND ADDITIONAL MANEUVERING SPACE SHALL BE 36" WIDE MINIMUM WHERE THE DEPTH OF THE CONFINING ELEMENT EXCEEDS 24".
 - PARALLEL APPROACH: THE CLEAR SPACE AND ADDITIONAL MANEUVERING SPACE SHALL BE 60" WIDE MINIMUM WHERE THE DEPTH OF THE CONFINING ELEMENT EXCEEDS 15".
- THE MINIMUM WHEELCHAIR PASSAGE WIDTH OR CLEAR SPACE WIDTH FOR A SINGLE WHEELCHAIR PASSAGE SHALL BE 48" PER PROWAG SECTION R302.3.
- INITIAL OPERATION FOR THE KIOSK WILL HAVE 4G LTE CONNECTION SECTION R404. TO THE INTERNET.
- THE KIOSKS HAVE BEEN DESIGN TO COMPLY WITH ALL ADA GUIDELINES INCLUDING VIEWING, OPERATION, AND ACCESSIBILITY.
- THE MOBILE IKE EXPERIENCE WILL FOLLOW WEB CONTENT ACCESSIBILITY GUIDELINES (WCAG) TO WORK IN TANDEM WITH THE NATIVE ACCESSIBILITY FEATURES ON THE USER'S MOBILE DEVICE, INCLUDING TALKBACK AND VOICEOVER TOOLS.

SCOPE OF WORK

THE PROJECT CONSIST OF THE INSTALLATION OF ONE (1) DIGITAL INTERACTIVE KIOSKS AT THE LOCATION(S) INDICATED ON THIS PLANS SET. INSTALLER SHALL PROVIDE AND INCLUDE ALL WORKMANSHIP AND MATERIALS NECESSARY TO COMPLETE THE INSTALLATION INCLUDING BUT NOT LIMITED TO:


- INSTALLATION OF THE KIOSKS TO THE FOUNDATION AS INDICATED ON PLANS TO NEW RECTANGULAR CONCRETE FOUNDATION.
- ELECTRICAL SERVICE POINTS ARE EXISTING. CONNECT THE EXISTING ELECTRIC SERVICE TO THE NEW KIOSK AS INDICATED ON PLANS.
- TESTING OF THE ELECTRICAL SERVICE INFRASTRUCTURE SHALL BE PERFORMED IN CONJUNCTION WITH A REPRESENTATIVE OF THE ENGINEER OF RECORD.
- THE CONTRACTOR SHALL INSTALL THE KIOSK IN SUCH A WAY THAT THE KIOSK IS WITHIN THE PUBLIC R.O.W. AND IN COMPLIANCE WITH ALL APPLICABLE A.D.A. REQUIREMENTS
- THE LOCATION OF KIOSKS HAS BEEN COORDINATE TO ENSURE THERE IS NO OBSTRUCTION OF THE SIGHT OF VEHICULAR SIGNS.
- STAND-ALONE PEDESTRIAN KIOSKS SHOULD NOT BE INSTALLED WITHIN PEDESTRIAN CIRCULATION PATHS IN A MANNER THAT PERSONS AT THE KIOSK LOCK THE EFFECTIVE WIDTH OF THE PEDESTRIAN TRAVEL WAY.

MONUMENT SIGN SPECIFICATIONS AND FUNCTIONS


THE UNIT CONSISTS OF A UL/NRTL LISTED WEATHER AND VANDAL RESISTANT FREE STANDING ENCLOSURE DESIGNED TO COMPLY WITH THE FLORIDA BUILDING CODE AND OTHER APPLICABLE CODES INCLUDING THE NATIONAL ELECTRICAL CODE. THE UNIT HAS BEEN DESIGNED TO WITHSTAND WINDS OF 165 MPH. THE UNIT'S MAIN COMPONENTS ARE:

- TWO (2) INTERACTIVE 65" VIDEO TOUCH SCREENS.
- TWO (2) CAMERAS
- ONE (1) CPU
- ONE (1) WI-FI TRANSMITTER

MANUFACTURER: DYNASCAN MODEL NUMBER: CIO651DR5
 NATIVE RESOLUTION: 1920 X 1080
 ELECTRICAL POWER REQUIREMENT:
 1. ONE-2-POLE, 20 AMP, 240 VOLTS CIRCUIT.
 2. TOTAL LOAD: 1400/2200 WATTS (OPERATIONAL/PEAK)
 3. VOLTAGE: 100-240 VOLTS AC, 50-60 HZ
 WEIGHT: 832 LBS
 CERTIFICATION CE / FCC / RoHS

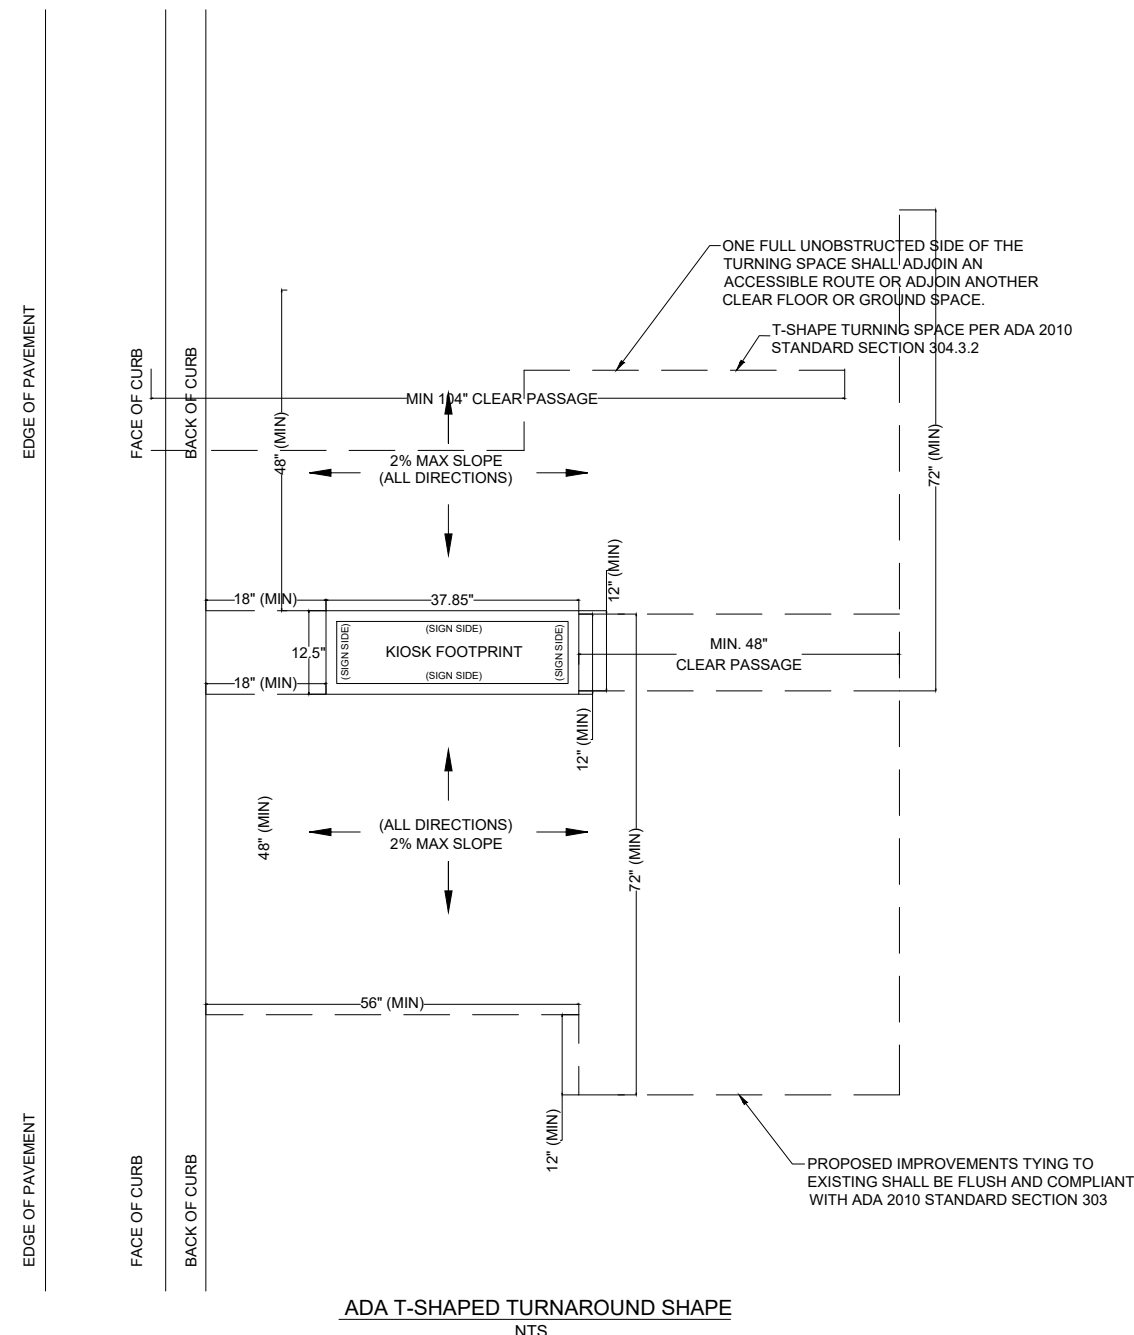

NOTES:

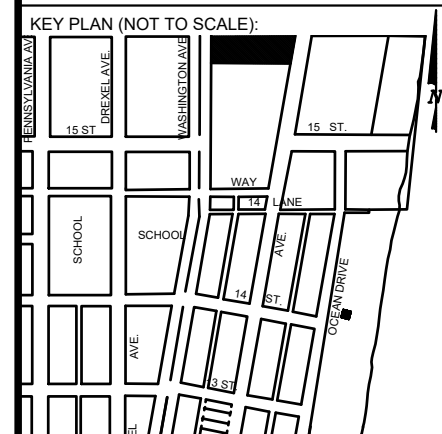

P.E. SEAL:

MIAMI BEACH
 PUBLIC WORKS DEPARTMENT
 1700 CONVENTION CENTER DRIVE, MIAMI BEACH, FL 33139

CITY MANAGER: ALINA T. HUDAK
 DIRECTOR: JOE GOMEZ, P.E.
 CITY ENGINEER: CRISTINA ORTEGA CASTINEIRAS, P.E.

NO.	DATE	REVISION	APP'D. BY
5			
4			
3			
2			
1			

Main Street ENGINEERING
 7035 SW 47th Street, Ste A, Miami, FL 33155
 Tel: (305) 466-3055 Fax: (305) 476-9894
 FL PE Certificate No: 00008751


ENGINEER OF RECORD: VANESSA A. MELA, P.E. NO. 77676

ENGINEER OF RECORD: VM
 DESIGN ENGINEER: VM
 DRAWN BY: KM
 CHECKER: WP
 SCALE: _____


NEIGHBORHOOD: MIB-007: OCEAN DRIVE & 14TH PLACE


TITLE: ADA NOTES, SCOPE OF WORK & KIOSK SPECIFICATIONS

File Name: MIB-007-GENERAL AND FOUNDATION.dwg
 Survey Reference:
 Field Book: N/A Page: N/A Work Order: N/A
 Date: 10/09/2023 Sheet: 2 of 9 Drawing: G0-04

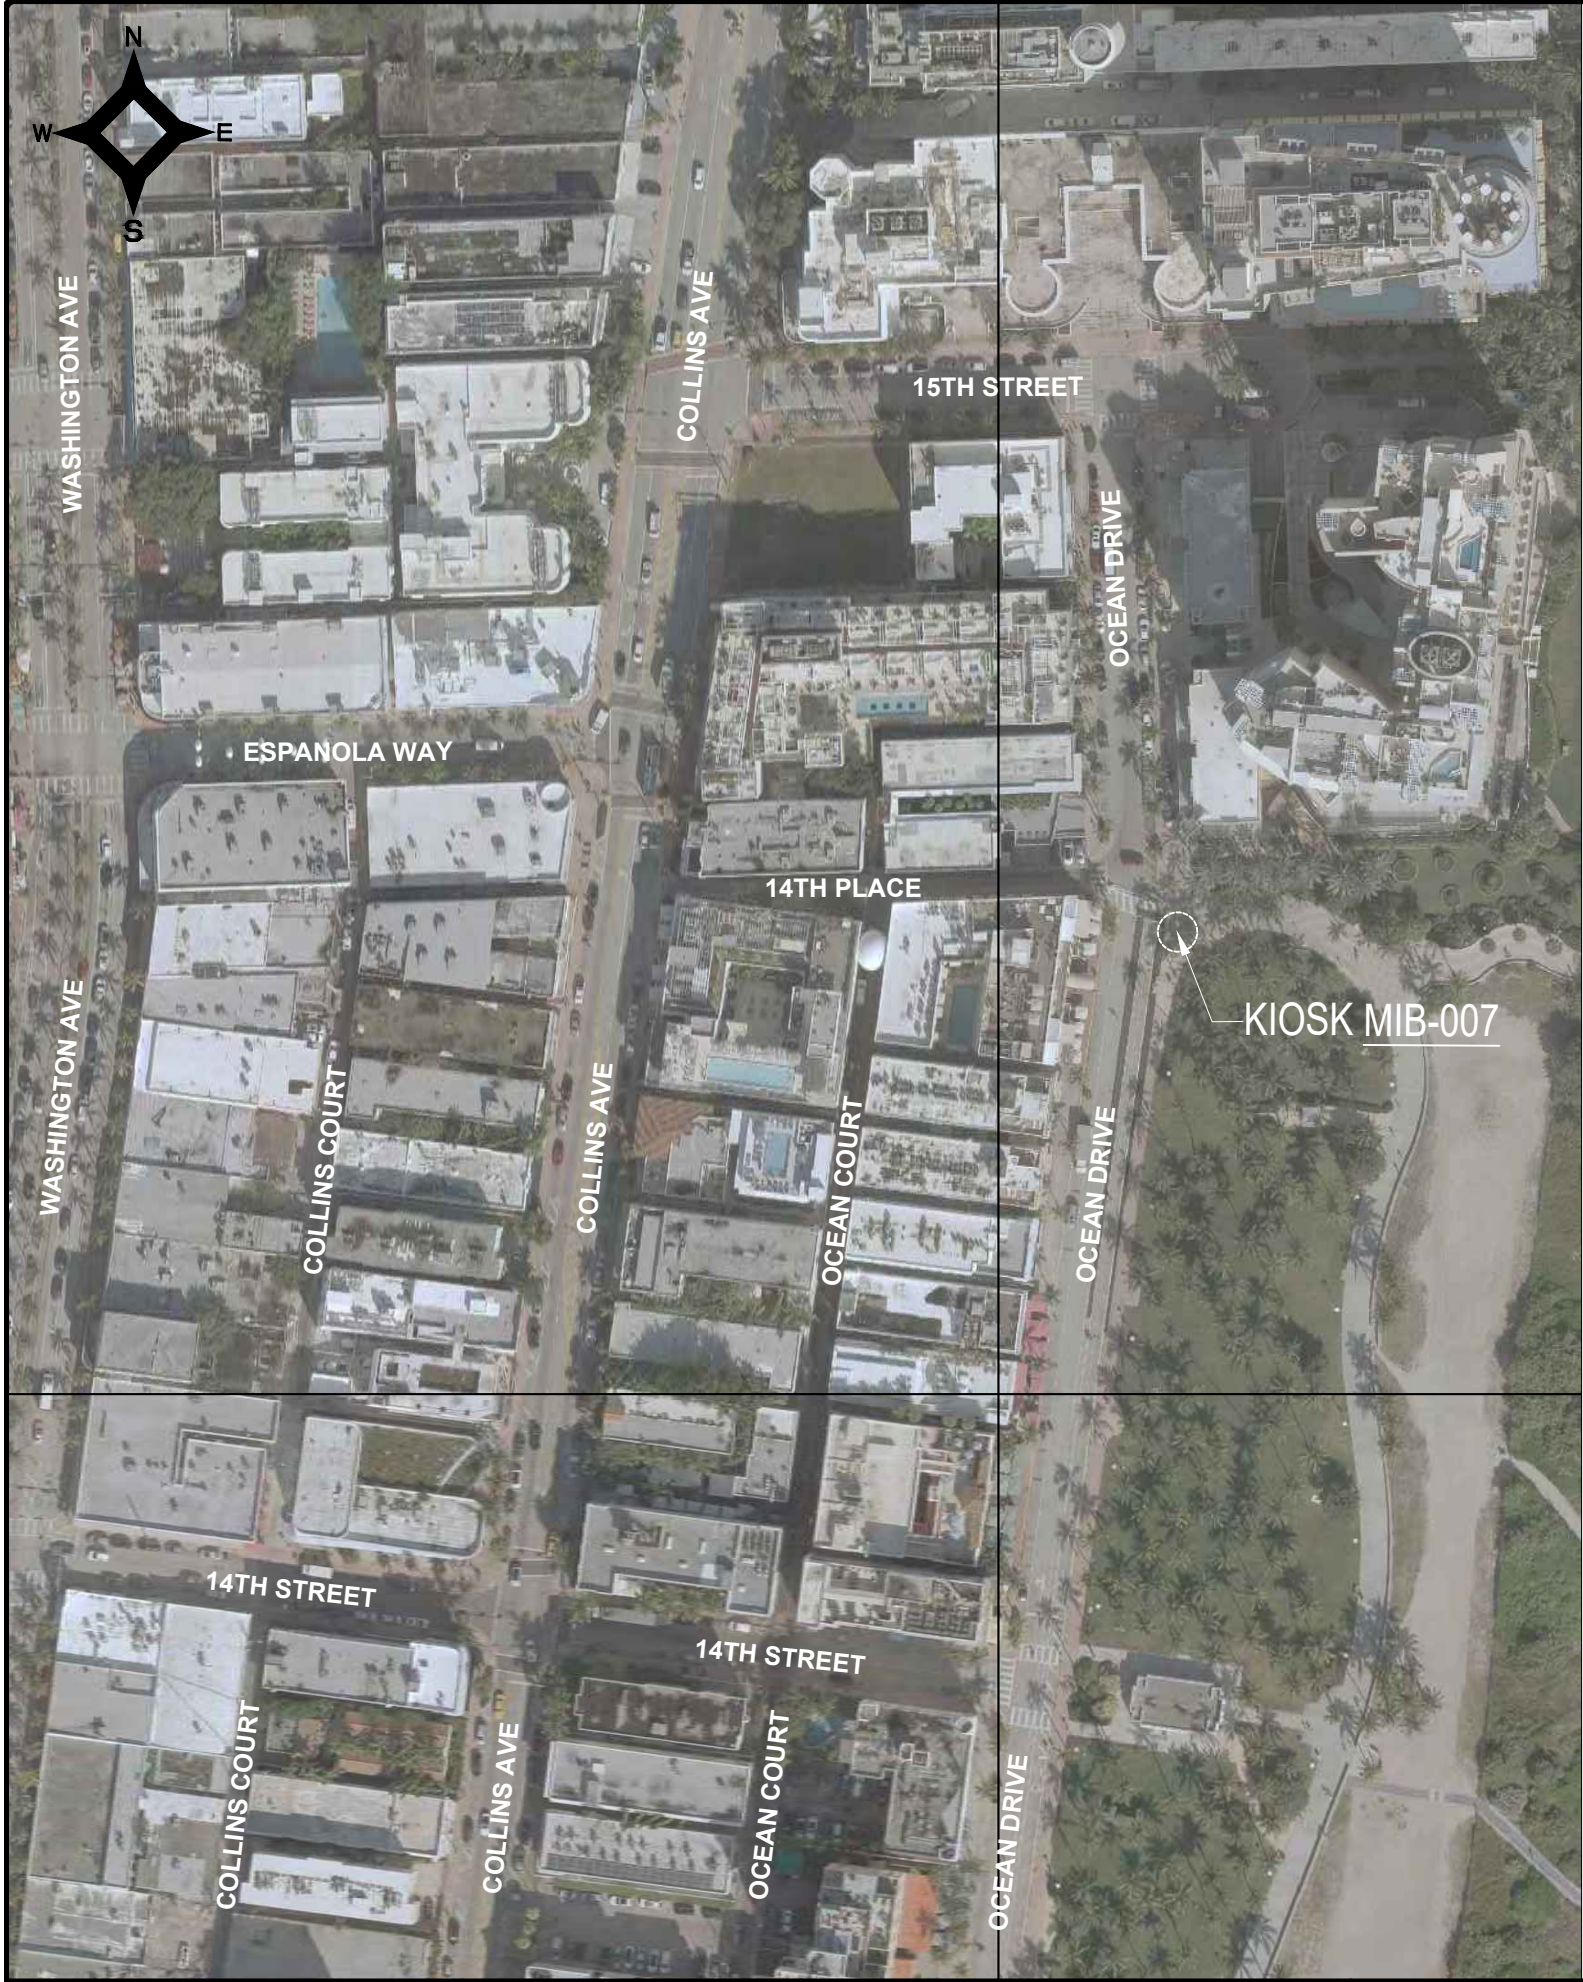


LEGEND

 AREA WHERE NO STRUCTURE OR PLANTING WHICH OBSTRUCTS TRAFFIC VISIBILITY BETWEEN THE HEIGHT OF TWO FEET AND TEN FEET ABOVE THE STREET CORNER GRADE IS ALLOWED. REFER TO CITY OF MIAMI BEACH CODE OF ORDINANCES SECTION 142-1135


 NO PLANTING OR STRUCTURE PERMITTED WITHIN THESE LIMITS WHICH OBSTRUCTS TRAFFIC VISIBILITY.

E.P. EDGE OF PAVEMENT

R/W RIGHT OF WAY

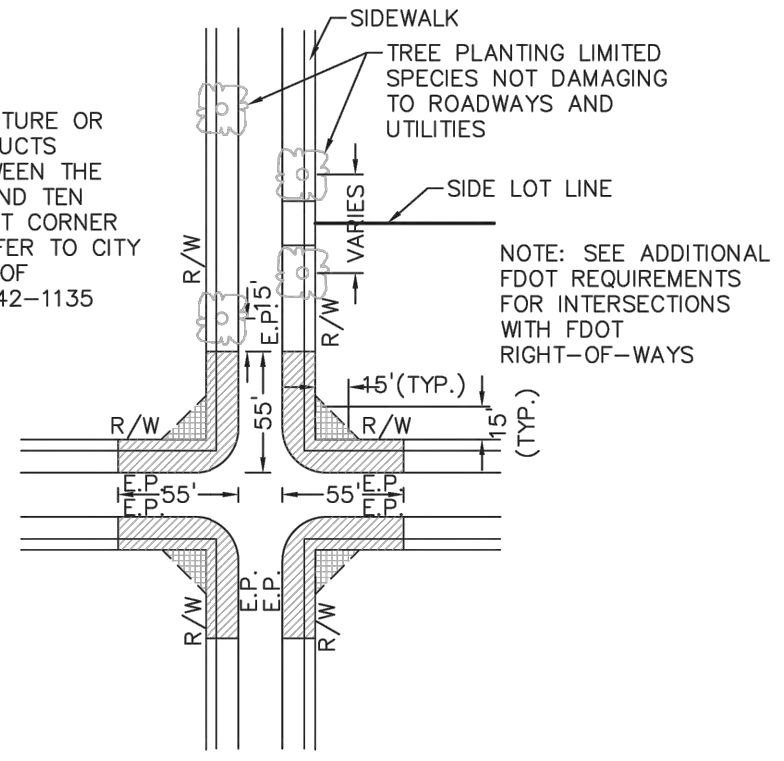


PLAN VIEW
N.T.S.

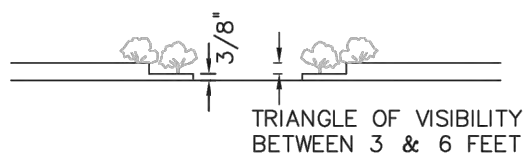

ELEVATION VIEW
N.T.S.

NOTES:

1. AT INTERSECTIONS WITH ALL-WAY STOP CONTROL, THE FIRST STOPPED VEHICLE ON ONE APPROACH SHOULD BE VISIBLE TO THE DRIVERS OF THE FIRST STOPPED VEHICLES ON EACH OF THE OTHER APPROACHES. THERE ARE NO OTHER SIGHT DISTANCE CRITERIA APPLICABLE TO INTERSECTIONS WITH ALL-WAY STOP CONTROL AND, INDEED, ALL-WAY CONTROL MAY BE THE BEST OPTION AT A LIMITED NUMBER OF INTERSECTIONS WHERE SIGHT DISTANCE FOR OTHER CONTROL TYPES CANNOT BE ATTAINED.
2. FOR TWO-WAY STOP INTERSECTIONS, SIGHT DISTANCE CRITERIA FOR STOP CONTROLLED INTERSECTIONS ARE LONGER THAN STOPPING SIGHT DISTANCE TO ENSURE THAT THE INTERSECTION OPERATES SMOOTHLY. MINOR-ROAD VEHICLE OPERATORS CAN WAIT UNTIL THEY CAN PROCEED SAFELY WITHOUT A MAJOR-ROAD VEHICLE TO STOP.

	APPROVED	REVISED 07/2020 09/2020	TITLE: SIGHT RESTRICTIONS AT INTERSECTIONS WITH NO DEDICATED RADII	DETAIL 10-26


SIGHT TRIANGLE CLEARANCE

Sunshine811


Call 811 or visit sunshine811.com two full business days before digging to have buried facilities located and marked.

Check positive response codes before you dig!

NOTES:

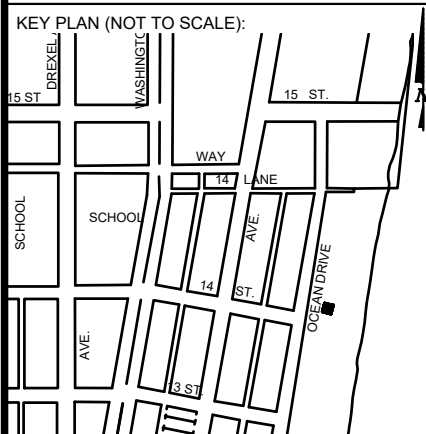



P.E. SEAL:

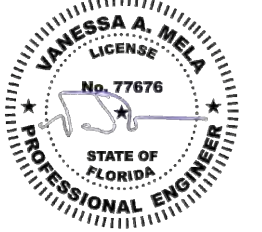


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NOTES:





IKE 3.0 KIOSK
SEE SPEC. SHEET
FOR DETAILS

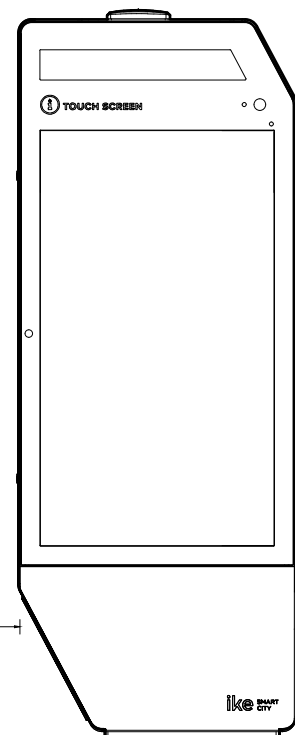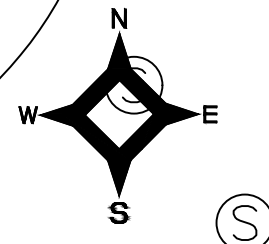



OCEAN DRIVE
BOB: N 07°35'39" E
55' TOTAL RIGHT-OF-WAY
VARIABLE PAVEMENT

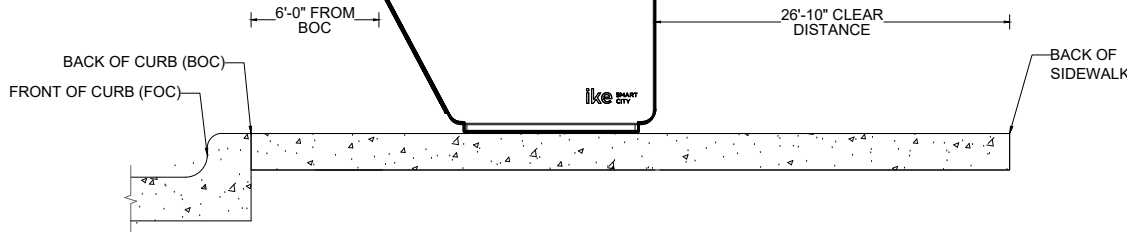KIOSK MIB-007. SEE
DETAIL ON SHEET G0-05.
CONCRETE FOUNDATION.
SEE SHEET S-01 FOR
FOUNDATION DETAILS

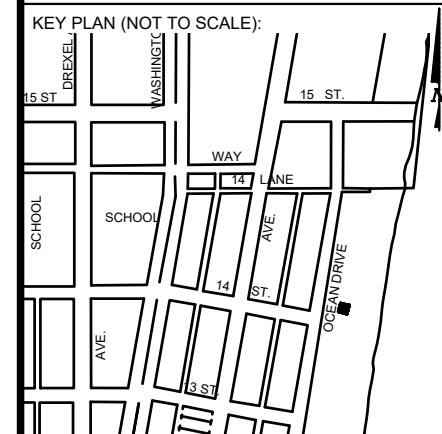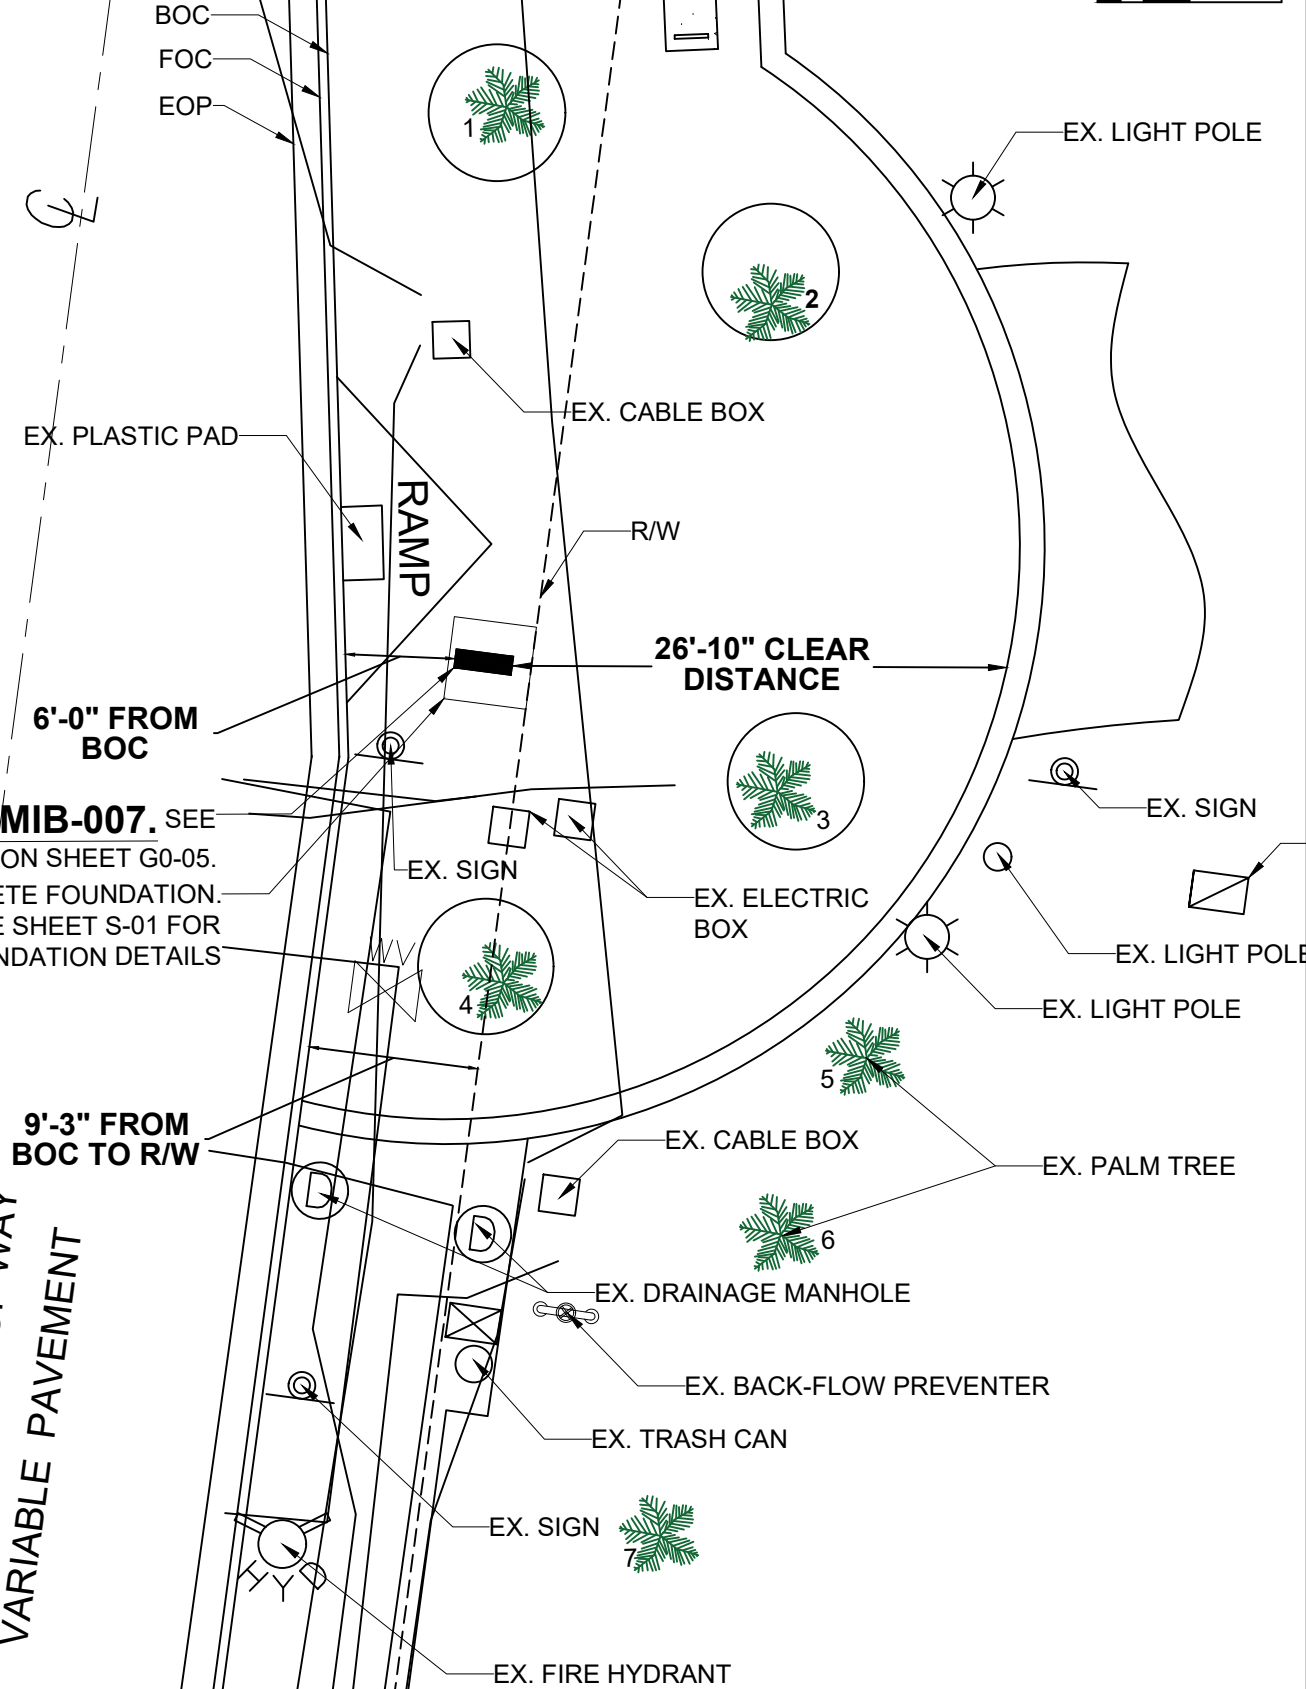

P.E. SEAL:

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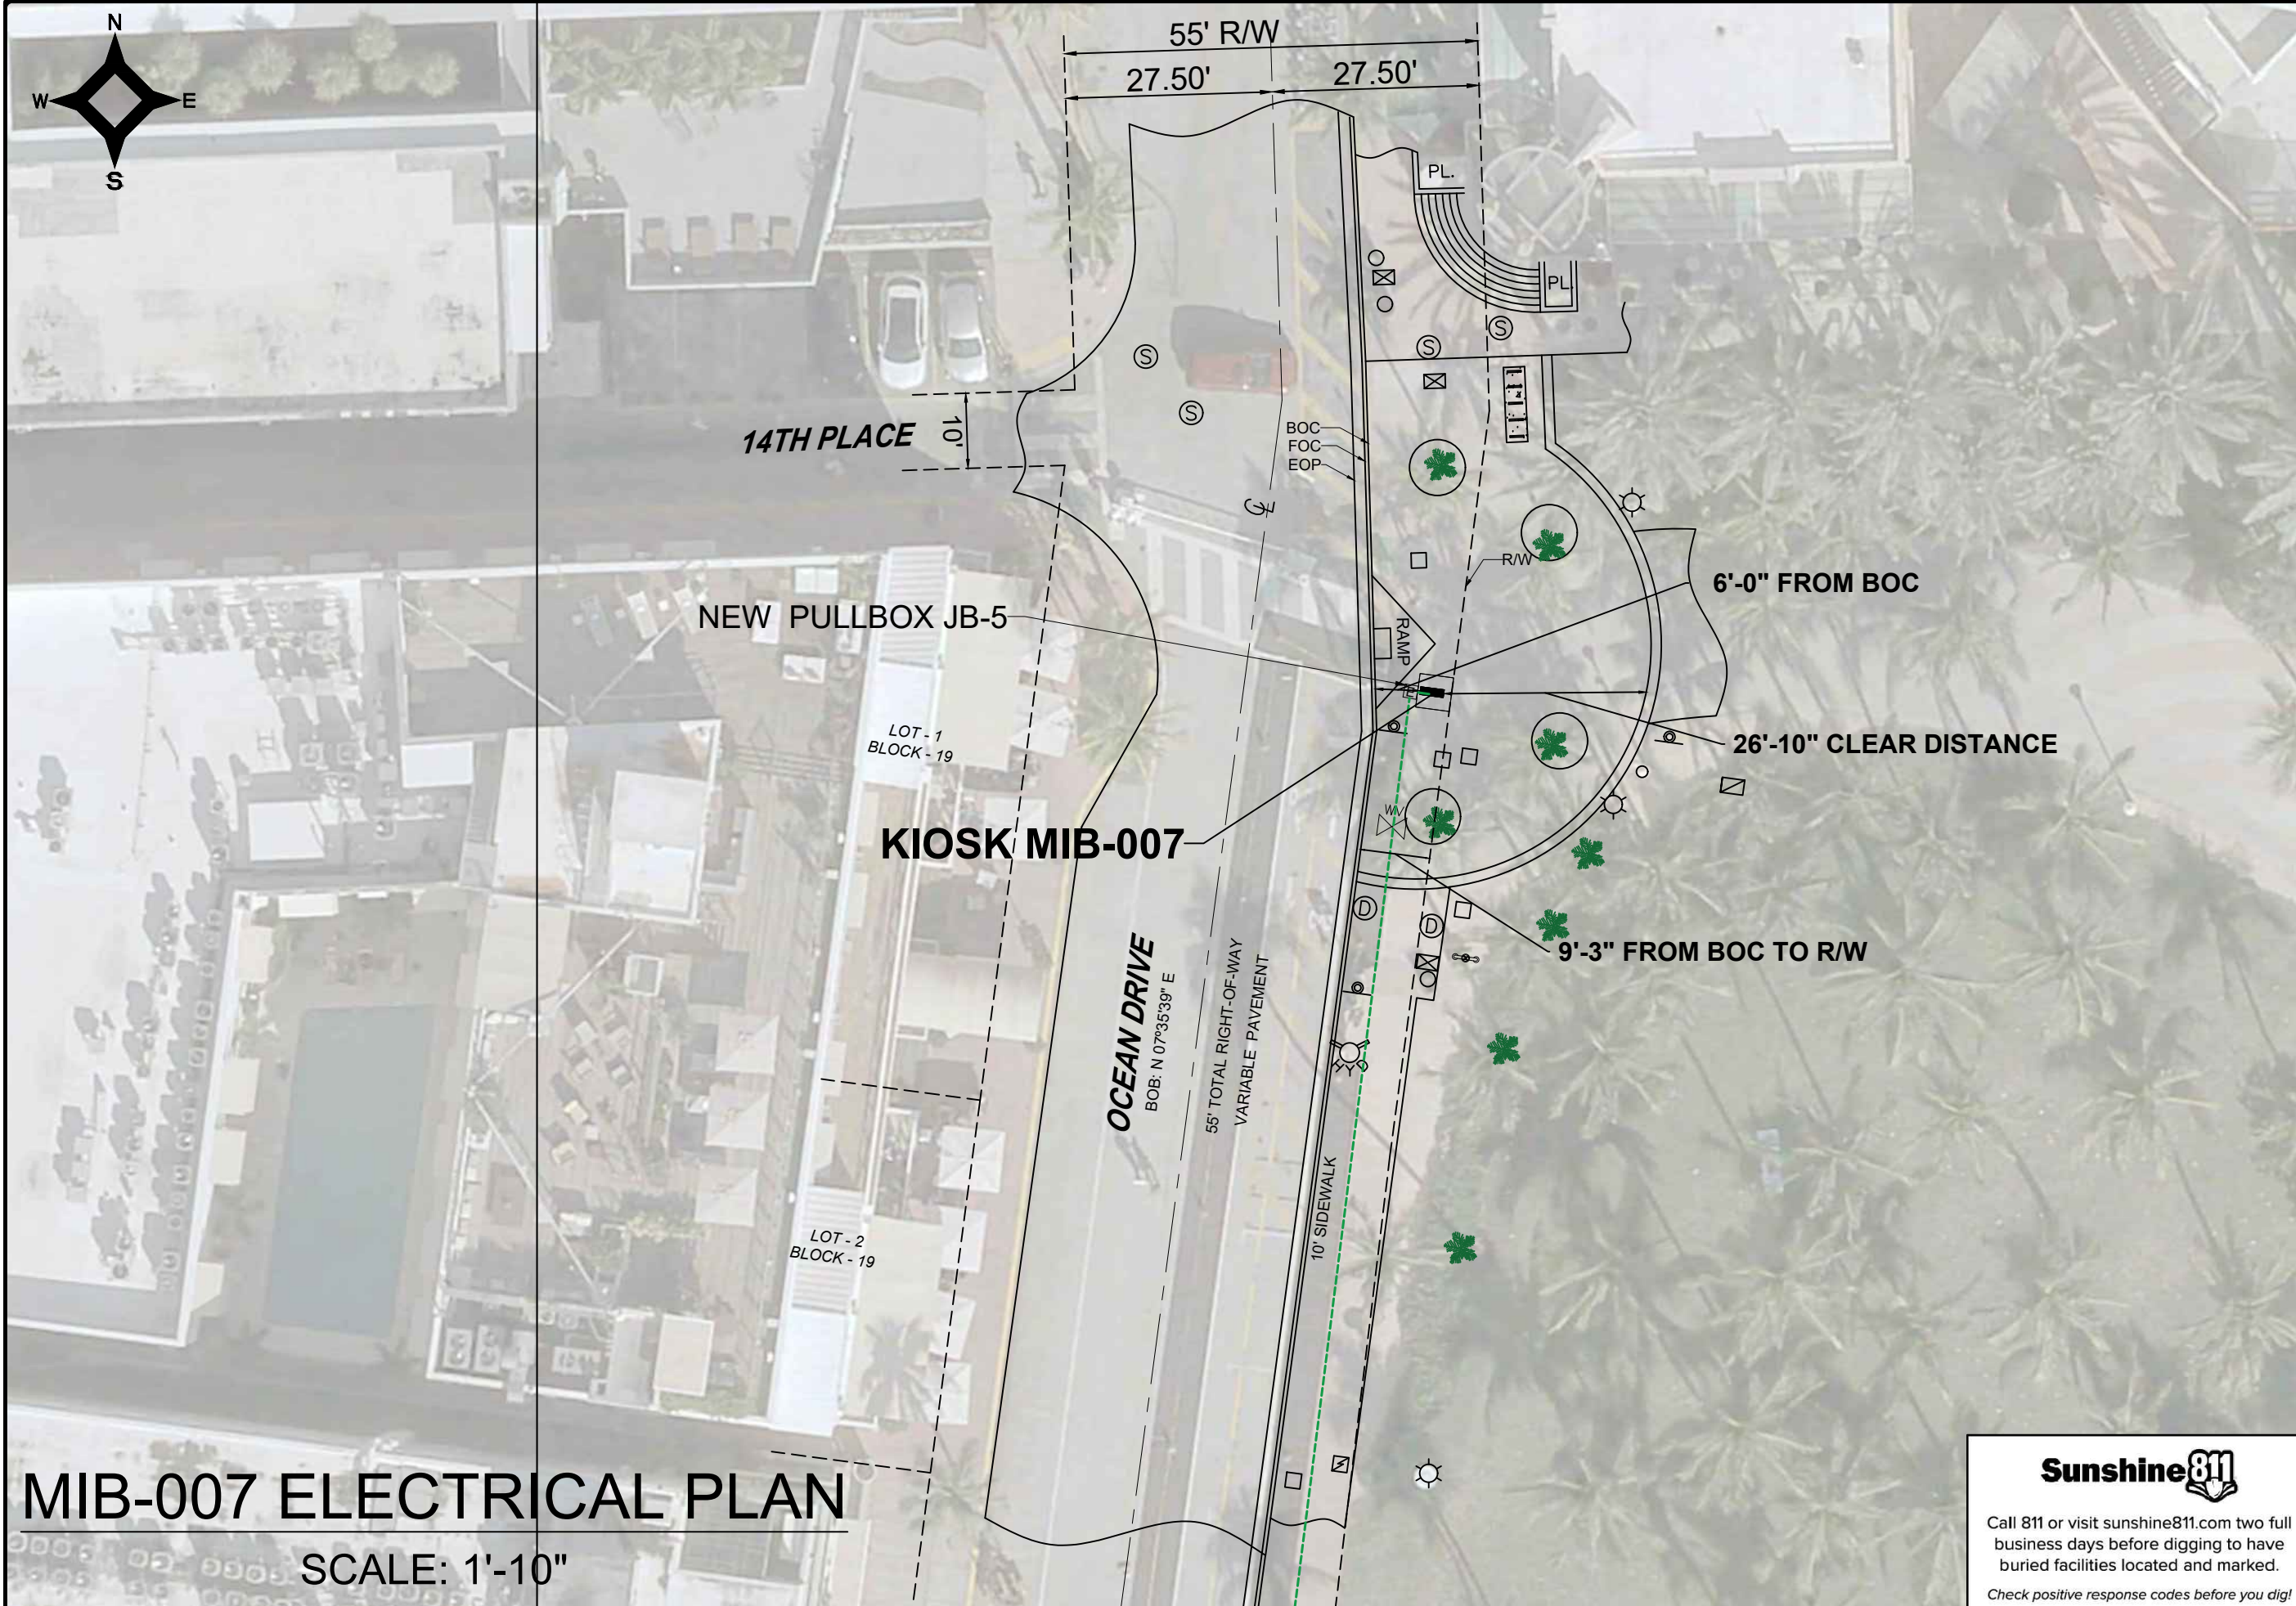
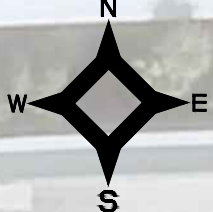

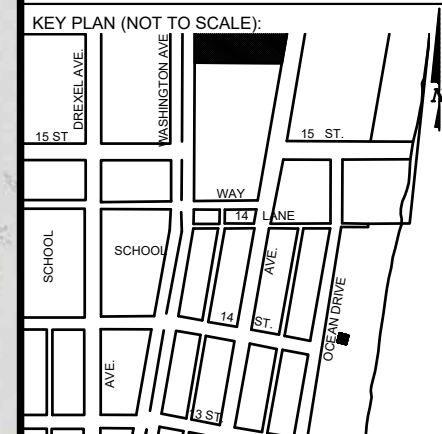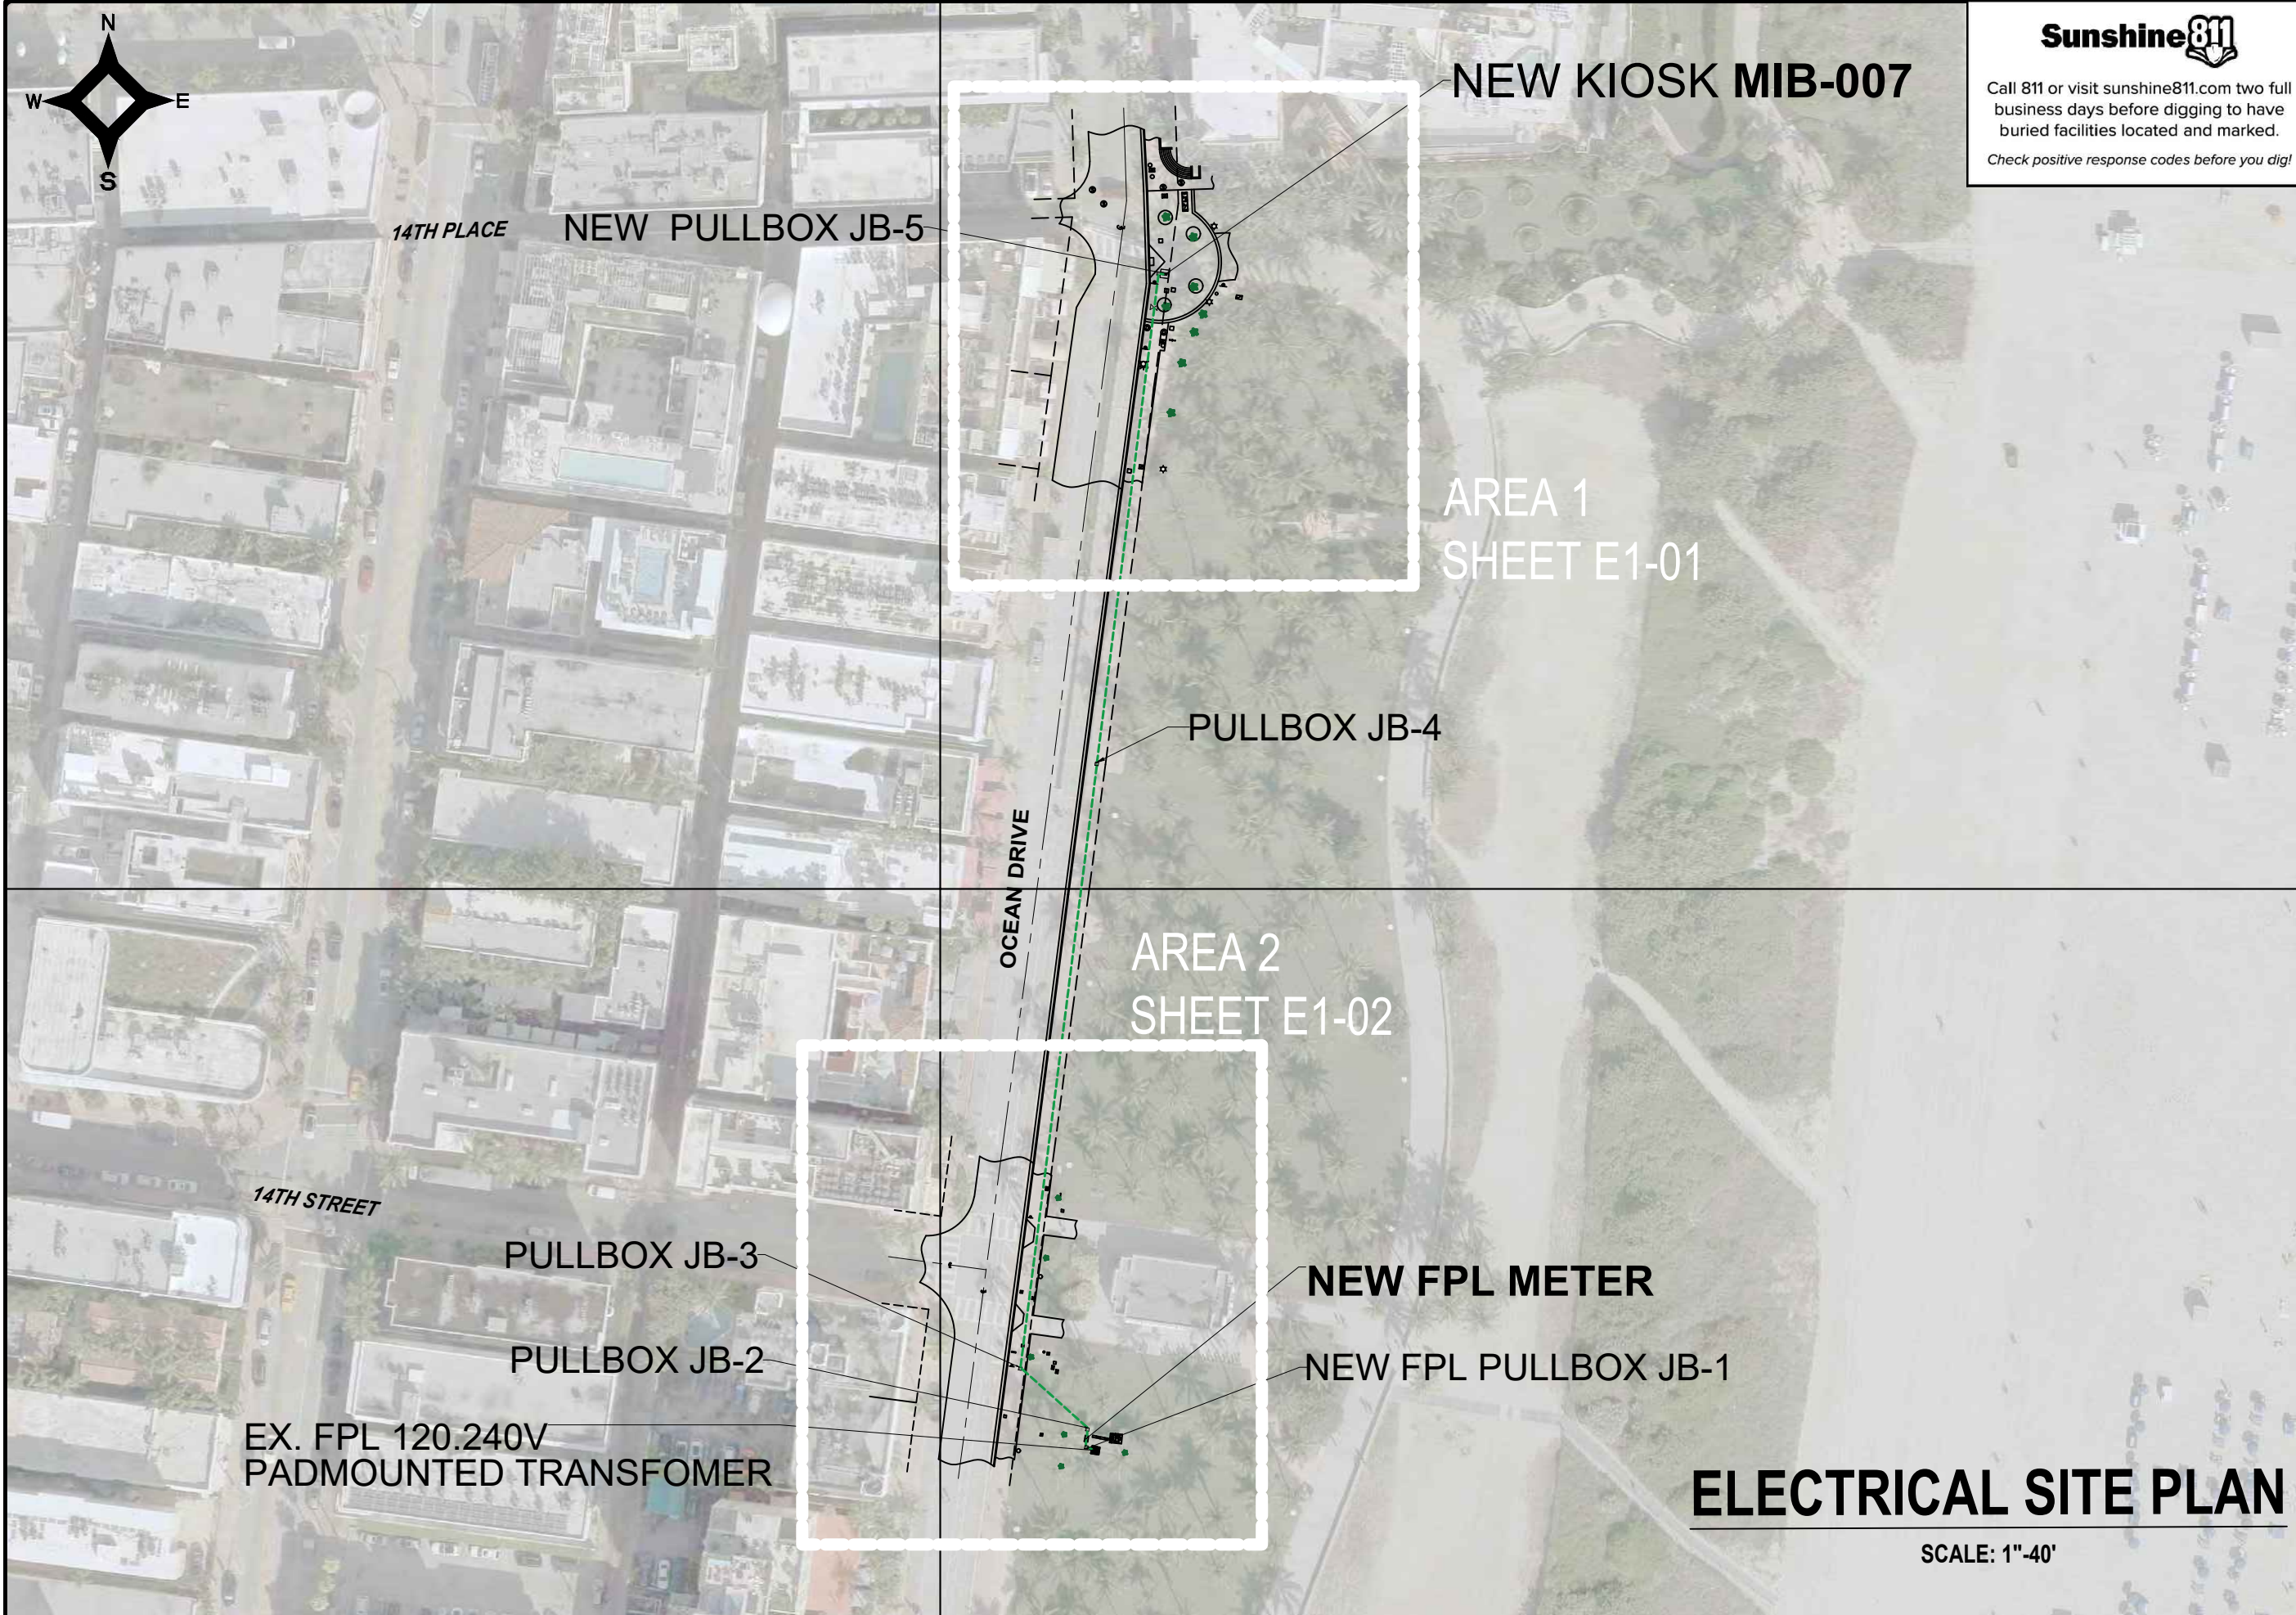
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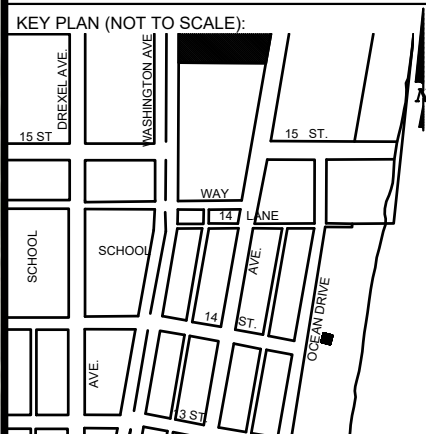
ELECTRICAL SITE PLAN

SCALE: 1"=40'

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NOTES:



P.E. SEAL:



Sunshine811

Call 811 or visit sunshine811.com two full business days before digging to have buried facilities located and marked.
Check positive response codes before you dig!

MIB-007 ELECTRICAL PLAN

SCALE: 1"-10"


NO.	DATE	REVISION	APP'D. BY
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SERVICE POINT LOCATION ELECTRICAL PLAN

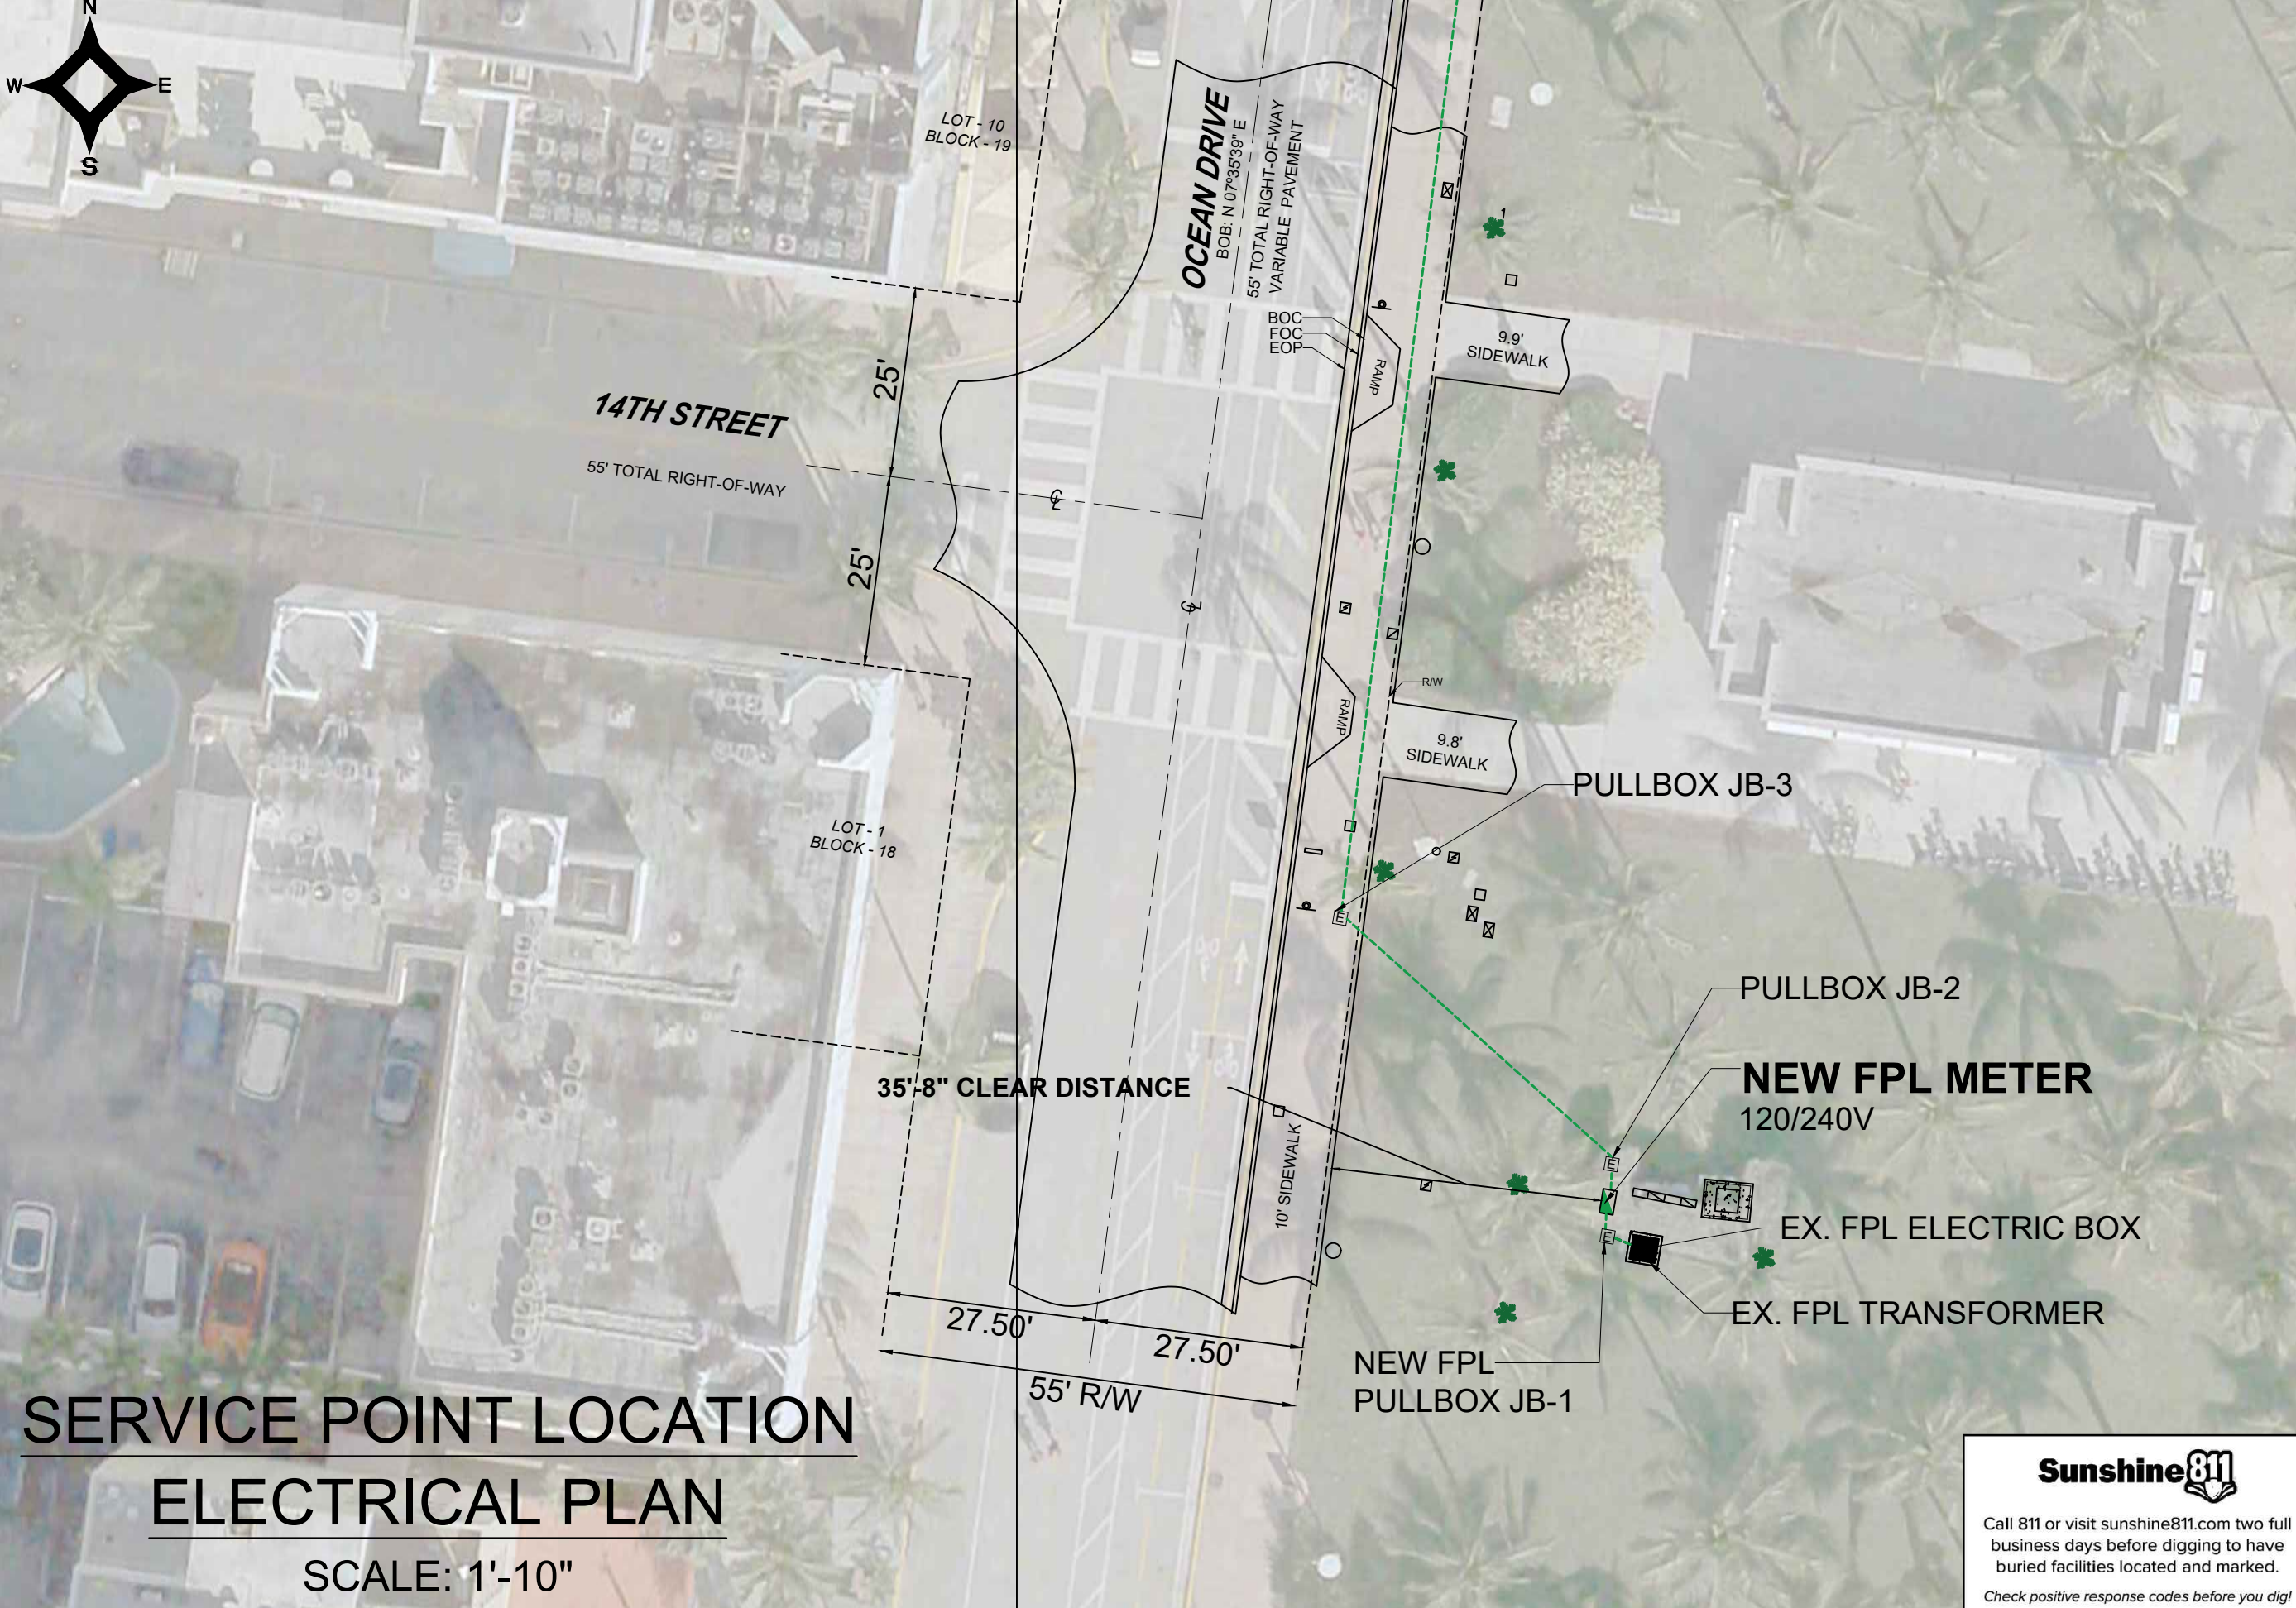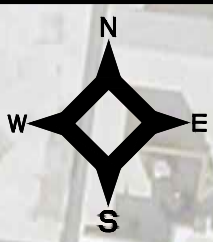SCALE: 1'-10"

NOTES:



P.E. SEAL:

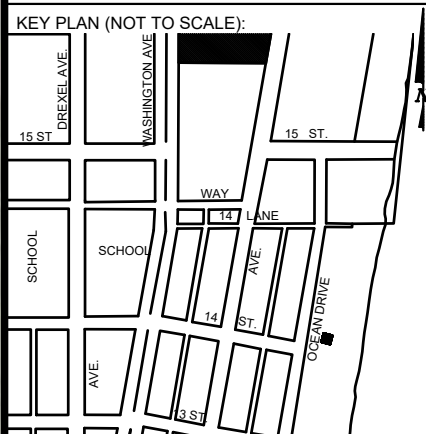Sunshine811

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Check positive response codes before you dig!

MIAMI BEACH
PUBLIC WORKS DEPARTMENT
1700 CONVENTION CENTER DRIVE, MIAMI BEACH, FL 33139

CITY MANAGER: ALINA T. HUDAK
DIRECTOR: JOE GOMEZ, P.E.
CITY ENGINEER: CRISTINA ORTEGA CASTINEIRAS, P.E.

NO.	DATE	REVISION	APP'D. BY
5			
4			
3			
2			
1			

Main Street ENGINEERING
7035 SW 47th Street, Suite A, Miami, FL 33155
Tel: (305) 406-3055 • Fax: (305) 476-9864
FL PE Certificate No.: 00006751

ENGINEER OF RECORD: WILLIAM E. PINO, P.E. NO. 32028
ENGINEER OF RECORD: WP
DESIGN ENGINEER: WP
DRAWN BY: KM
CHECKER: WP
SCALE: 1"=10'

NEIGHBORHOOD: MIB-007: OCEAN DRIVE & 14TH PLACE
TITLE: SERVICE POINT LOCATION ELECTRICAL PLAN

File Name: MIB-007 -ELECTRICAL & TTC PLANS.dwg
Survey Reference:
Field Book: N/A Page: N/A Work Order: N/A
Date: 10/09/2023 Sheet: 7 of 9 Drawing: E1-02

Survey Pros, Inc.

4348 SW 74TH AVENUE, MIAMI, FL. 33155
 PH: (305) 767-6802 (main)
 MIAMI-DADE | BROWARD | PALM BEACH | MONROE | HILLSBOROUGH | PINELLAS
www.survey-pros.com

MAP OF SPECIFIC PURPOSE TOPOGRAPHIC & TREE SURVEY

OF A PORTION OF
 "OCEAN DRIVE"
 CITY OF MIAMI BEACH, FL.
 PLAT OF "OCEAN BEACH ADDITION NO. 2"
 PLAT BOOK 2, PAGE 56, MDCR

LEGEND

ABBREVIATIONS:

- A = ARC DISTANCE
- AC = AIR CONDITIONER PAD
- BCR = BROWARD COUNTY RECORDS
- BLDG = BUILDING
- BM = BENCH MARK
- BOB = BASIS OF BEARINGS
- CBS = CONCRETE BLOCK & STUCCO
- (C) = CALCULATED
- C&G = CURB & GUTTER
- CLF = CHAIN LINK FENCE
- COL = COLUMN
- D.E. = DRAINAGE EASEMENT
- D.M.E. = DRAINAGE & MAINTENANCE EASEMENT
- D/W = DRIVEWAY
- EB = ELECTRIC BOX
- ENC. = ENCROACHMENT
- EP = EDGE OF PAVEMENT
- EW = EDGE OF WATER
- FDH = FOUND DRILL HOLE
- FFE = FINISHED FLOOR ELEVATION
- FIP = FOUND IRON PIPE (NO ID)
- FIR = FOUND IRON ROD (NO ID)
- FN = FOUND NAIL (NO ID)
- FN&D = FOUND NAIL & DISK
- FPL = FLORIDA POWER & LIGHT TRANSFORMER PAD
- L.E. = LANDSCAPE EASEMENT
- L.M.E. = LAKE MAINTENANCE EASEMENT
- (M) = MEASURED
- MDCR = MIAMI-DADE COUNTY RECORDS
- MH = MAN HOLE
- ML = MONUMENT LINE
- (P) = PLAT
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- PC = POINT OF CURVATURE
- PCP = PERMANENT CONTROL POINT
- PE = POOL EQUIPMENT PAD
- PG = PAGE
- PI = POINT OF INTERSECTION
- PL = PLANTER
- POB = POINT OF BEGINNING
- POC = POINT OF COMMENCEMENT
- PRC = POINT OF REVERSE CURVATURE
- PRM = PERMANENT REFERENCE MONUMENT
- PT = POINT OF TANGENCY
- R = RADIUS DISTANCE
- (R) = RECORD
- R/W = RIGHT-OF-WAY
- RES = RESIDENCE
- SIP = SIP LB#8023
- SND = SET NAIL & DISK LB#8023
- STL = SURVEY TIE LINE
- SWK = SIDEWALK
- (TYP) = TYPICAL
- UB = UTILITY BOX
- U.E. = UTILITY EASEMENT
- W/F = WOOD FENCE

TREE TABLE:

NO	COMMON NAME	DBH(ø)	HEIGHT	CANOPY
1	COCONUT PALM	8"	22'	14'
2	COCONUT PALM	8"	22'	14'
3	COCONUT PALM	8"	26'	14'
4	COCONUT PALM	12"	30	14'
5	COCONUT PALM	8"	22'	14'
6	COCONUT PALM	12"	30	14'
7	COCONUT PALM	12"	30	14'
8	COCONUT PALM	12"	30	14'

IN CASE OF A DISPUTE AN ARBORIST REPORT WILL GOVERN.



BENCHMARK INFORMATION:

NAME: D-166
 ELEVATION: 7.27' (NGVD29)
 LOCATION 1: VENETIAN CSWY --- 20' NORTH OF C/L
 LOCATION 2: BELLE ISLE EAST BRIDGE ---
 DESCRIPTION: PK NAIL AND BRASS WASHER IN CONCRETE SIDEWALK AT NE CORNER OF BRIDGE #874481

SYMBOLS:

- TELEPHONE RISER
- CABLE TV RISER
- WATER METER
- X 0.00 = ELEVATION
- (00') = ORIGINAL LOT DISTANCE
- Δ = CENTRAL ANGLE
- ⊕ = CENTER LINE
- wv WATER VALVE
- CURB INLET
- FIRE HYDRANT
- LIGHT POLE
- CATCH BASIN
- UTILITY POLE
- DRAINAGE MANHOLE
- SEWER MANHOLE
- SIGN
- METAL FENCE
- WOOD FENCE
- CHAIN LINK FENCE
- EASEMENT
- BOUNDARY LINE
- OVERHEAD UTILITY LINE
- ORIGINAL LOT LINE
- ASPHALT
- CONCRETE
- PAVERS/BRICK
- TILES
- COVERED AREA

GRAPHIC SCALE

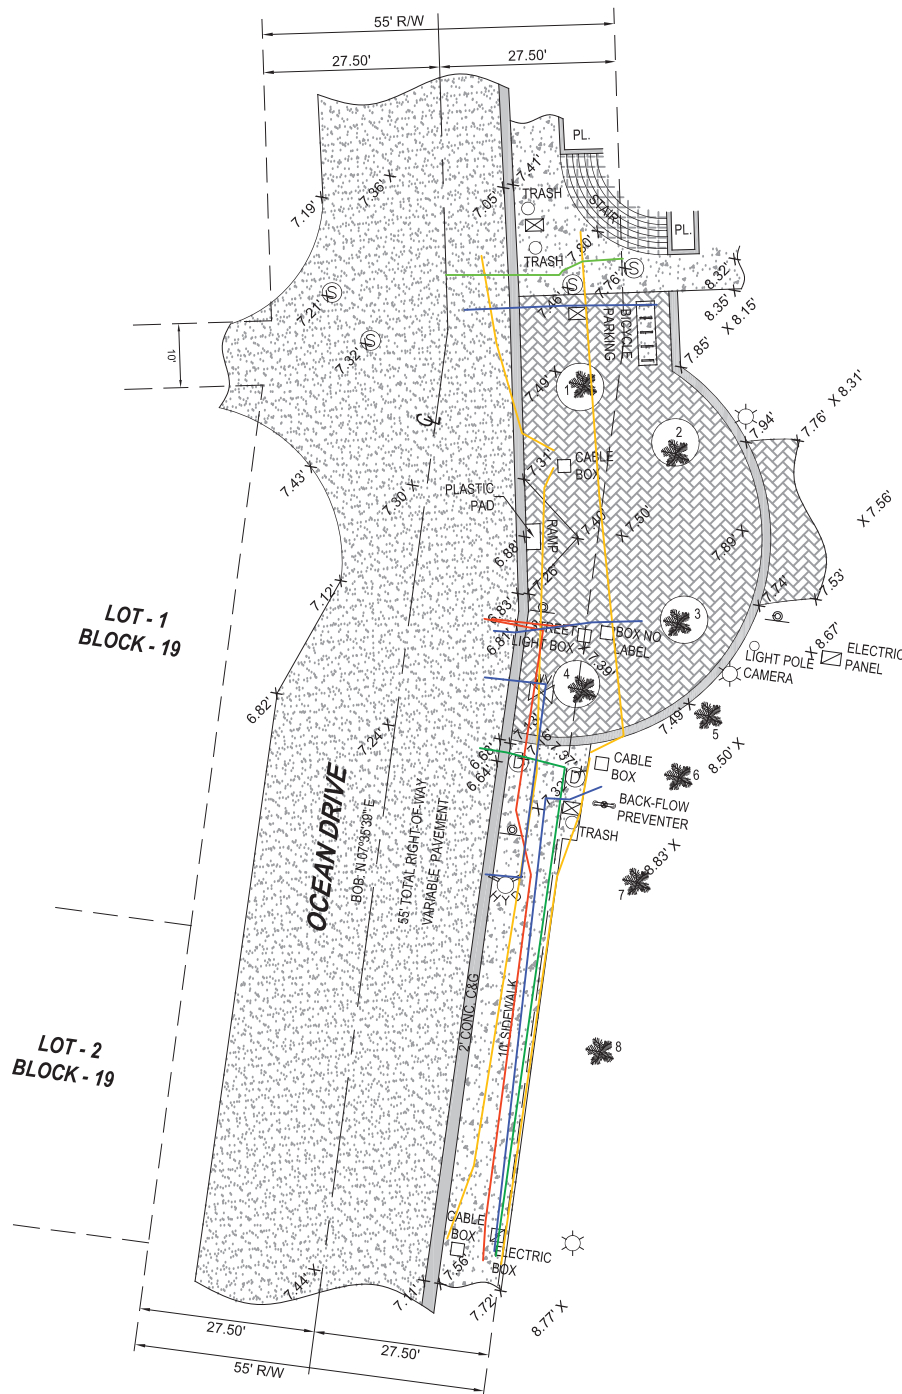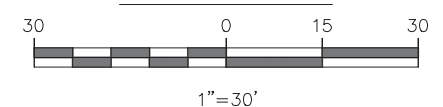

LOCATION SKETCH:

NOT TO SCALE



FLOOD ZONE INFORMATION:

THE GRAPHICALLY DEPICTED BUILDING(S) SHOWN ON THIS MAP OF SURVEY IS WITHIN ZONE AE BASE FLOOD ELEVATION 8
 COMMUNITY NAME & NUMBER CITY OF MIAMI BEACH 120651
 MAP & PANEL NUMBER 12086C0317 SUFFIX L

SURVEYOR'S NOTES:

1. ELEVATIONS WHEN SHOWN REFER TO 1929 NATIONAL GEODETIC VERTICAL DATUM (NGVD 1929).
2. NO ATTEMPT WAS MADE TO LOCATE FOOTINGS/FOUNDATIONS, OR UNDERGROUND UTILITIES UNLESS OTHERWISE NOTED.
3. THE LANDS SHOWN HEREON HAVE NOT BEEN ABSTRACTED IN REGARDS TO MATTERS OF INTEREST BY OTHER PARTIES, SUCH AS EASEMENTS, RIGHTS OF WAYS, RESERVATIONS, ETC. ONLY PLATTED EASEMENTS ARE SHOWN.
4. THIS SURVEY WAS PREPARED FOR AND CERTIFIED TO THE PARTY(IES) INDICATED HEREON AND IS NOT TRANSFERABLE OR ASSIGNABLE WITHOUT WRITTEN CONSENT OF THIS FIRM.
5. ALL BOUNDARY LIMIT INDICATORS SET ARE STAMPED LB#8023.
6. THE BOUNDARY LIMITS ESTABLISHED ON THIS SURVEY ARE BASED ON THE LEGAL DESCRIPTION PROVIDED BY THE CLIENT OR ITS REPRESENTATIVE.
7. FENCE OWNERSHIP IS NOT DETERMINED. DIMENSIONS ARE TO THE INTERIOR PORTION OF THE FENCE.
8. ADDITIONS OR DELETIONS TO THIS SURVEY MAP AND/OR REPORT BY SOMEONE OTHER THAN THE SIGNING PARTY(IES) IS PROHIBITED WITHOUT WRITTEN CONSENT OF THE SIGNING PARTY(IES).
9. THIS SURVEY IS NOT VALID WITHOUT THE ORIGINAL SIGNATURE AND RAISED SEAL OF A FLORIDA LICENSED SURVEYOR AND MAPPER. OTHERWISE THIS MAP IS FOR INFORMATIONAL PURPOSES ONLY.
10. BEARINGS WHEN SHOWN ARE TO AN ASSUMED MERIDIAN AND BASED ON PLAT. THE CENTERLINE OF OCEAN DRIVE BEARS N 07°35'39" E.

SURVEYOR'S CERTIFICATION:

I HEREBY CERTIFY THAT THIS SURVEY IS TRUE AND CORRECT TO THE BEST OF MY KNOWLEDGE AND BELIEF AS RECENTLY SURVEYED AND DRAWN UNDER MY DIRECTION AND MEETS THE MINIMUM TECHNICAL STANDARDS SET FORTH BY THE FLORIDA STATE BOARD OF SURVEYORS AND MAPPERS IN CHAPTER 5J-17 FLORIDA ADMINISTRATIVE CODE PURSUANT TO SECTION 472.027 FLORIDA STATUTE.

CERTIFIED TO:

MAIN STREET ENGINEERING

SEAL

NICOLAS DEL VENTO
 PROFESSIONAL SURVEYOR & MAPPER
 STATE OF FLORIDA LIC. # 6945

DATE OF ORIGINAL FIELD WORK:
 07/27/2023
 JOB NUMBER: 23079740
 DRAWN BY: ADRIEL
 CAD FILE: MAIN STREET ENG
 SHEET 1 OF 1
 REVISION(S):

Survey Pros, Inc.

4348 SW 74TH AVENUE, MIAMI, FL. 33155
PH: (305) 767-6802 (main)
MIAMI-DADE | BROWARD | PALM BEACH | MONROE | HILLSBOROUGH | PINELLAS
www.survey-pros.com

MAP OF SPECIFIC PURPOSE TOPOGRAPHIC & TREE SURVEY

LEGEND

ABBREVIATIONS:


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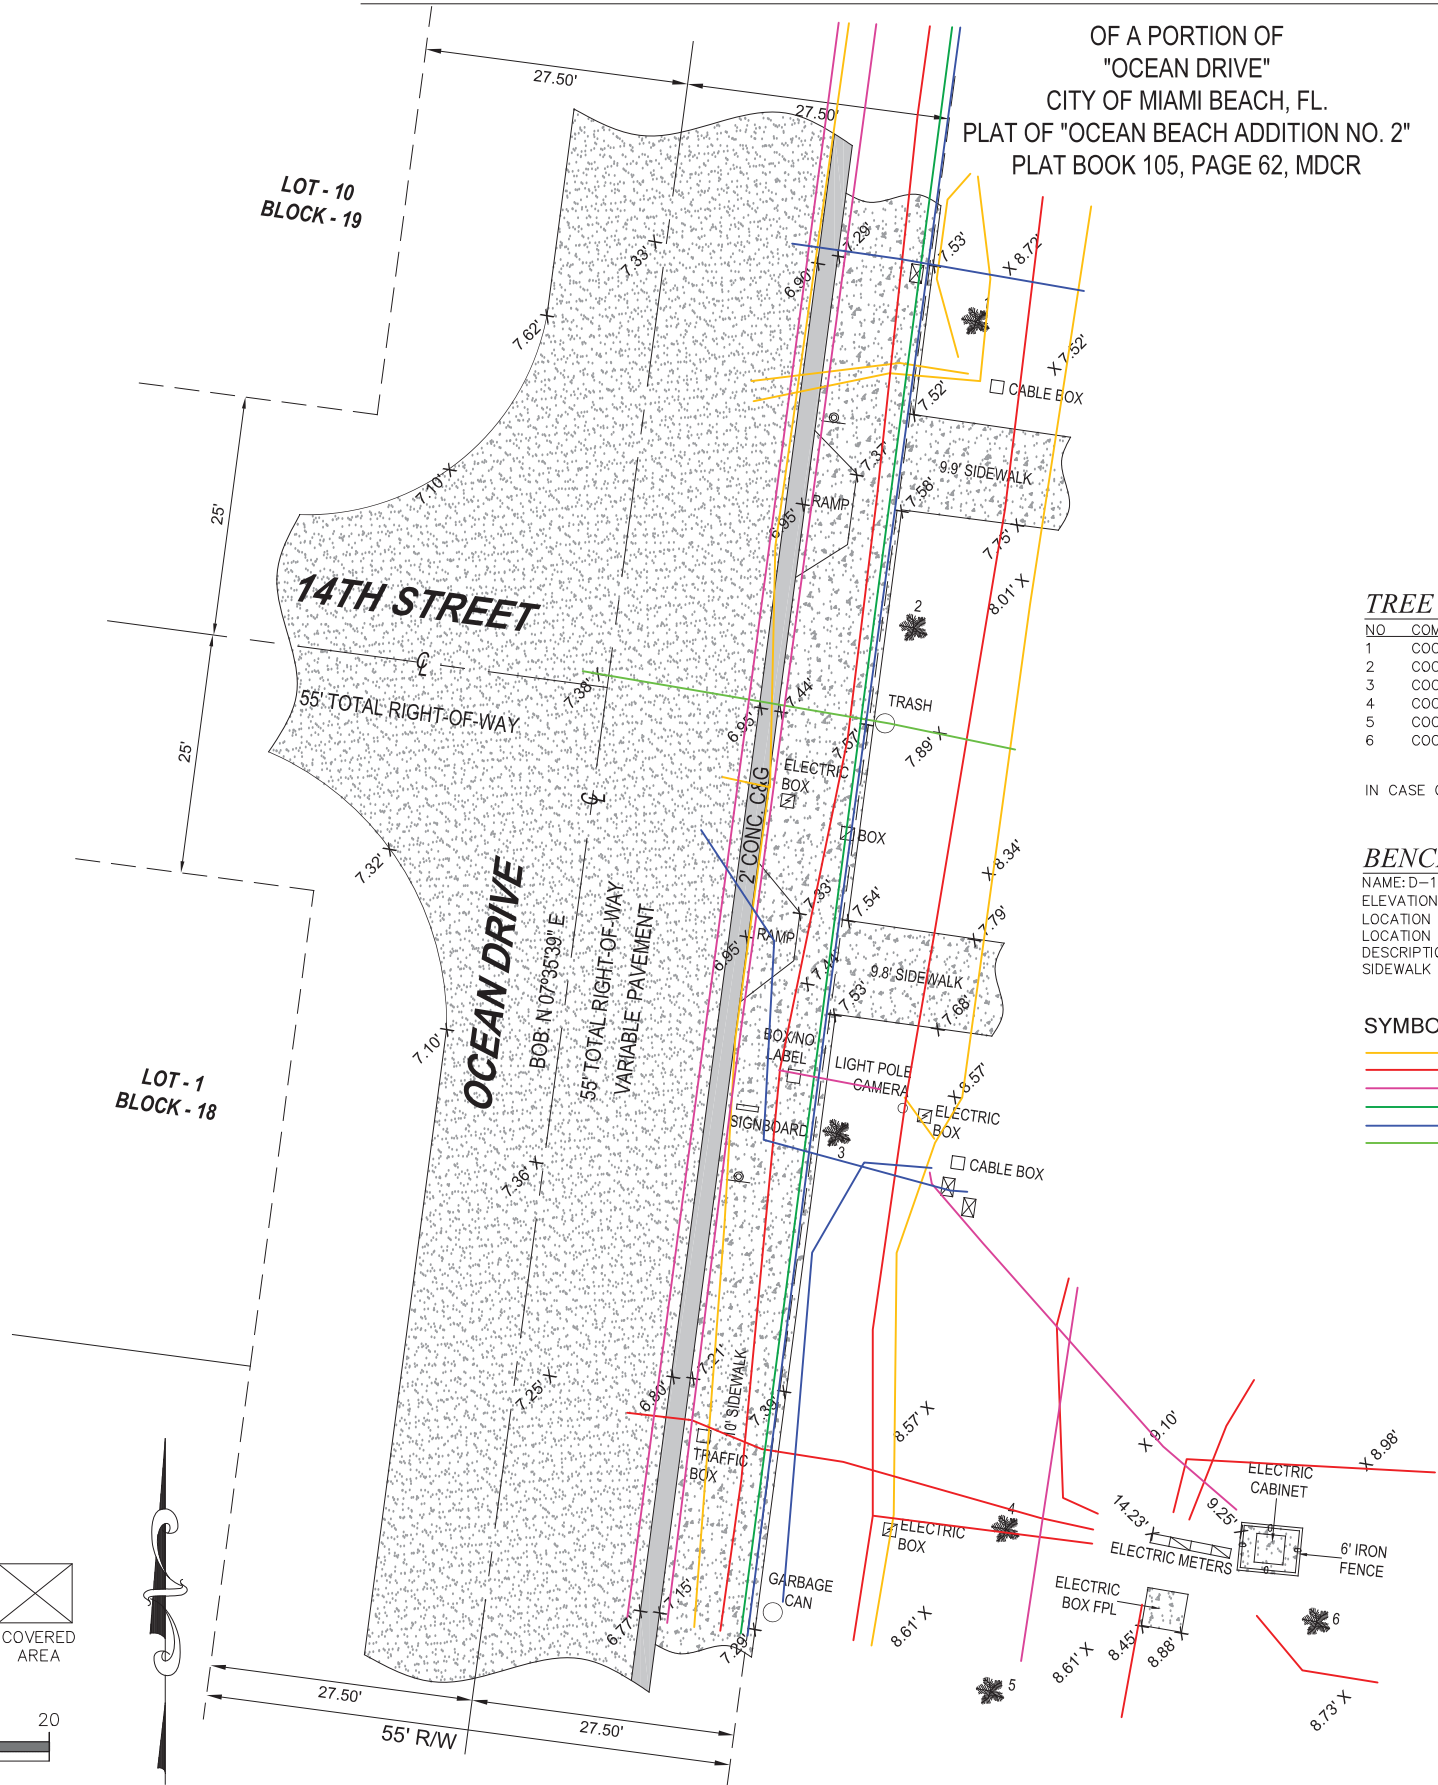
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- X 0.00 = ELEVATION
- (00') = ORIGINAL LOT DISTANCE
- Δ = CENTRAL ANGLE
- \ominus = CENTER LINE
- = WATER VALVE
- = CURB INLET
- = FIRE HYDRANT
- = LIGHT POLE
- = CATCH BASIN
- = UTILITY POLE
- = DRAINAGE MANHOLE
- = SEWER MANHOLE
- = SIGN
- = METAL FENCE
- = WOOD FENCE
- = CHAIN LINK FENCE
- = EASEMENT
- = BOUNDARY LINE
- = OVERHEAD UTILITY LINE
- = ORIGINAL LOT LINE

- ASPHALT
- CONCRETE
- PAVERS/BRICK
- TILES
- COVERED AREA

GRAPHIC SCALE



OF A PORTION OF
"OCEAN DRIVE"
CITY OF MIAMI BEACH, FL.
PLAT OF "OCEAN BEACH ADDITION NO. 2"
PLAT BOOK 105, PAGE 62, MDCR

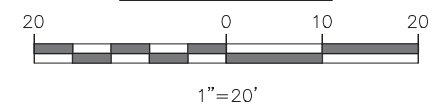

TREE TABLE:

NO	COMMON NAME	DBH(Ø)	HEIGHT	CANOPY
1	COCONUT PALM	12"	18'	13'
2	COCONUT PALM	12"	35'	14'
3	COCONUT PALM	12"	35'	14'
4	COCONUT PALM	12"	16'	14'
5	COCONUT PALM	12"	35'	14'
6	COCONUT PALM	12"	35'	14'

IN CASE OF A DISPUTE AN ARBORIST REPORT WILL GOVERN.

BENCHMARK INFORMATION:

NAME: D-166
ELEVATION: 7.27' (NGVD29)
LOCATION 1: VENETIAN CSWY --- 20' NORTH OF C/L
LOCATION 2: BELLE ISLE EAST BRIDGE ---
DESCRIPTION: PK NAIL AND BRASS WASHER IN CONCRETE SIDEWALK AT NE CORNER OF BRIDGE #874481

SYMBOLS:

- = COMMUNICATION LINE
- = ELECTRIC LINE
- = UNKNOWN
- = STORM LINE
- = WATER LINE
- = SANITARY LINE

LOCATION SKETCH:

NOT TO SCALE



FLOOD ZONE INFORMATION:

THE GRAPHICALLY DEPICTED BUILDING(S) SHOWN ON THIS MAP OF SURVEY IS WITHIN ZONE AE, BASE FLOOD ELEVATION 8, COMMUNITY NAME & NUMBER CITY OF MIAMI BEACH 120651, MAP & PANEL NUMBER 12086C0317 SUFFIX L

SURVEYOR'S NOTES:

1. ELEVATIONS WHEN SHOWN REFER TO 1929 NATIONAL GEODETIC VERTICAL DATUM (NGVD 1929).
2. NO ATTEMPT WAS MADE TO LOCATE FOOTINGS/FOUNDATIONS, OR UNDERGROUND UTILITIES UNLESS OTHERWISE NOTED.
3. THE LANDS SHOWN HEREON HAVE NOT BEEN ABSTRACTED IN REGARDS TO MATTERS OF INTEREST BY OTHER PARTIES, SUCH AS EASEMENTS, RIGHTS OF WAYS, RESERVATIONS, ETC. ONLY PLATTED EASEMENTS ARE SHOWN.
4. THIS SURVEY WAS PREPARED FOR AND CERTIFIED TO THE PARTY(IES) INDICATED HEREON AND IS NOT TRANSFERABLE OR ASSIGNABLE WITHOUT WRITTEN CONSENT OF THIS FIRM.
5. ALL BOUNDARY LIMIT INDICATORS SET ARE STAMPED LB#8023.
6. THE BOUNDARY LIMITS ESTABLISHED ON THIS SURVEY ARE BASED ON THE LEGAL DESCRIPTION PROVIDED BY THE CLIENT OR ITS REPRESENTATIVE.
7. FENCE OWNERSHIP IS NOT DETERMINED. DIMENSIONS ARE TO THE INTERIOR PORTION OF THE FENCE.
8. ADDITIONS OR DELETIONS TO THIS SURVEY MAP AND/OR REPORT BY SOMEONE OTHER THAN THE SIGNING PARTY(IES) IS PROHIBITED WITHOUT WRITTEN CONSENT OF THE SIGNING PARTY(IES).
9. THIS SURVEY IS NOT VALID WITHOUT THE ORIGINAL SIGNATURE AND RAISED SEAL OF A FLORIDA LICENSED SURVEYOR AND MAPPER. OTHERWISE THIS MAP IS FOR INFORMATIONAL PURPOSES ONLY.
10. BEARINGS WHEN SHOWN ARE TO AN ASSUMED MERIDIAN AND BASED ON PLAT. THE CENTERLINE OF OCEAN DRIVE BEARS N 07°35'39" E.

SURVEYOR'S CERTIFICATION:

I HEREBY CERTIFY THAT THIS SURVEY IS TRUE AND CORRECT TO THE BEST OF MY KNOWLEDGE AND BELIEF AS RECENTLY SURVEYED AND DRAWN UNDER MY DIRECTION AND MEETS THE MINIMUM TECHNICAL STANDARDS SET FORTH BY THE FLORIDA STATE BOARD OF SURVEYORS AND MAPPERS IN CHAPTER 5J-17 FLORIDA ADMINISTRATIVE CODE PURSUANT TO SECTION 472.027 FLORIDA STATUTE.

CERTIFIED TO:

MAIN STREET ENGINEERING

SEAL

DATE OF ORIGINAL FIELD WORK:
07/26/2023
JOB NUMBER: 23079737
DRAWN BY: ADRIEL
CAD FILE: MAIN STREET ENG
SHEET 1 OF 1
REVISION(S):

NICOLAS DEL VENTO
PROFESSIONAL SURVEYOR & MAPPER
STATE OF FLORIDA LIC. # 6945

10. Ocean Drive & 14th Place



MIAMI BEACH

PUBLIC WORKS DEPARTMENT

OCEAN DRIVE & 10TH STREET
 INTERACTIVE DIGITAL KIOSK DEPLOYMENT PROJECT
 OCTOBER 2023
 IKE SMART CITY
MIB-001

CITY OF MIAMI BEACH

MAYOR: DAN GELBER


COMMISSIONERS: MICKY STEINBERG
 MARK SAMUELIAN
 MICHAEL GONGORA
 STEVEN MEINER
 RICKEY ARRIOLA
 DAVID RICHARDSON

CITY MANAGER: ALINA T. HUDAK

CITY ATTORNEY: RAFAEL A. PAZ

PUBLIC WORKS DIRECTOR: JOE GOMEZ, P.E., F.FES

CITY ENGINEER: NELSON PEREZ-JACOME, PE

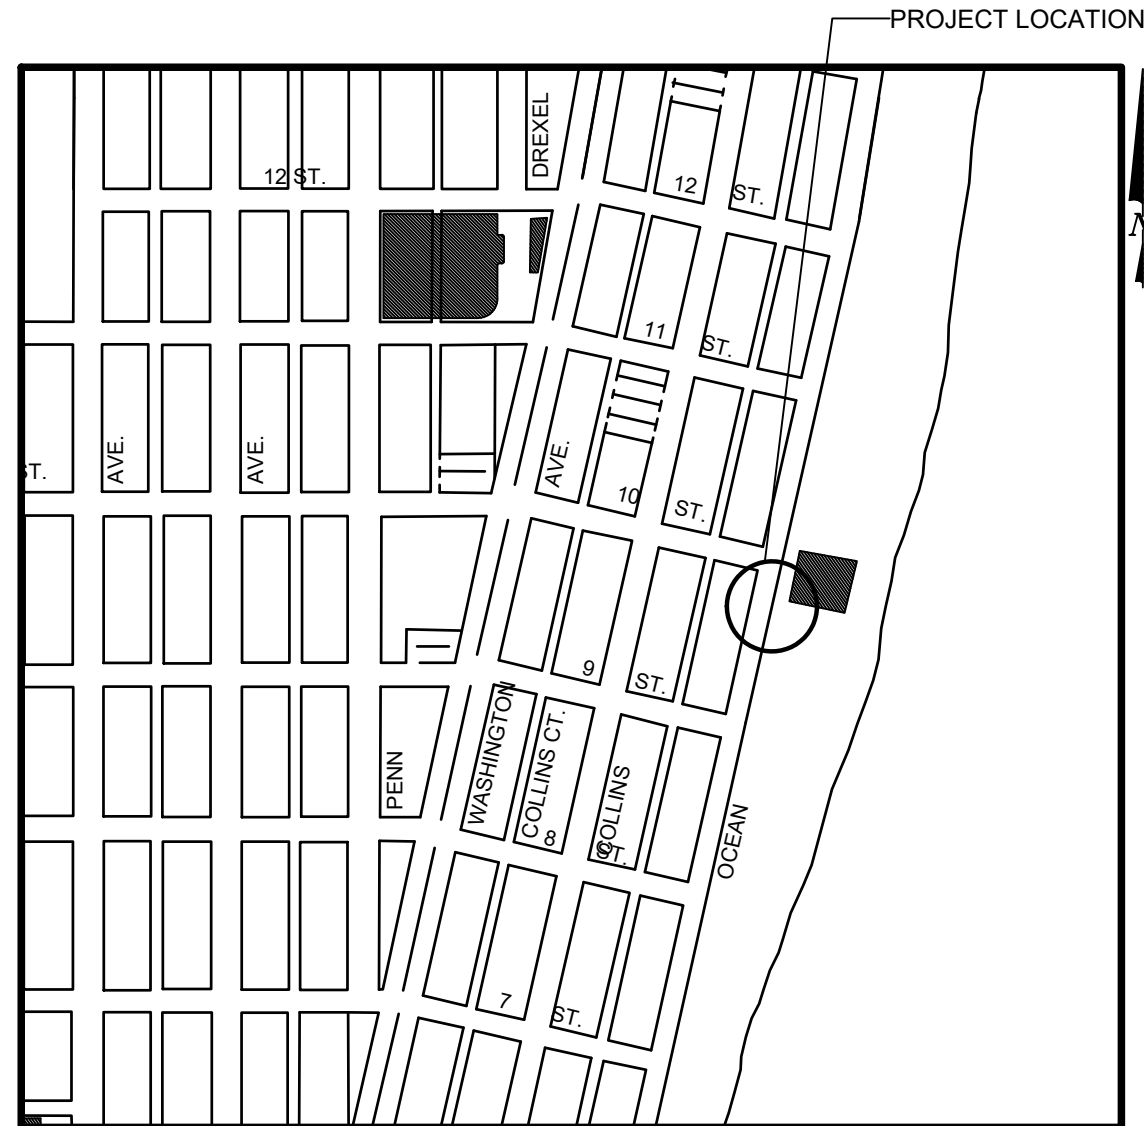

INDEX OF PLANS

NUMBER	DISCIPLINE	SHEET NO.	DESCRIPTION	NOTES
1	GENERAL	G0-03	INDEX OF SHEETS	
2	GENERAL	G0-04	ADA NOTES, SCOPE OF WORK & KIOSK SPECIFICATIONS	
3	CIVIL	C1-01	CIVIL SITE PLAN	
4	CIVIL	C1-02	KIOSK MIB-001 ENGINEERING PLAN	
5	ELECTRICAL	E1-01	KIOSK MIB-001 ELECTRICAL PLAN	
6	SURVEY		KIOSK MIB-001 SITE SURVEY	

SCOPE OF WORK: THE PROJECT CONSISTS OF THE INSTALLATION OF ONE (1) DIGITAL INTERACTIVE KIOSK AND APPLICABLE INFRASTRUCTURE; STRUCTURAL FOUNDATION AND ELECTRICAL SERVICE AT THE LOCATION INDICATED ON THESE DESIGN PLANS.

FINAL SUBMITTAL 10/09/2023


Always call 811 two full business days before you dig to have underground utilities located and marked.



LOCATION MAP

INDEX OF PLANS

NUMBER	DISCIPLINE	SHEET NO.	DESCRIPTION	NOTES
1	GENERAL	G0-03	INDEX OF SHEETS	
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5	ELECTRICAL	E1-01	KIOSK MIB-001 ELECTRICAL PLAN	
6	SURVEY		KIOSK MIB-001 SITE SURVEY	

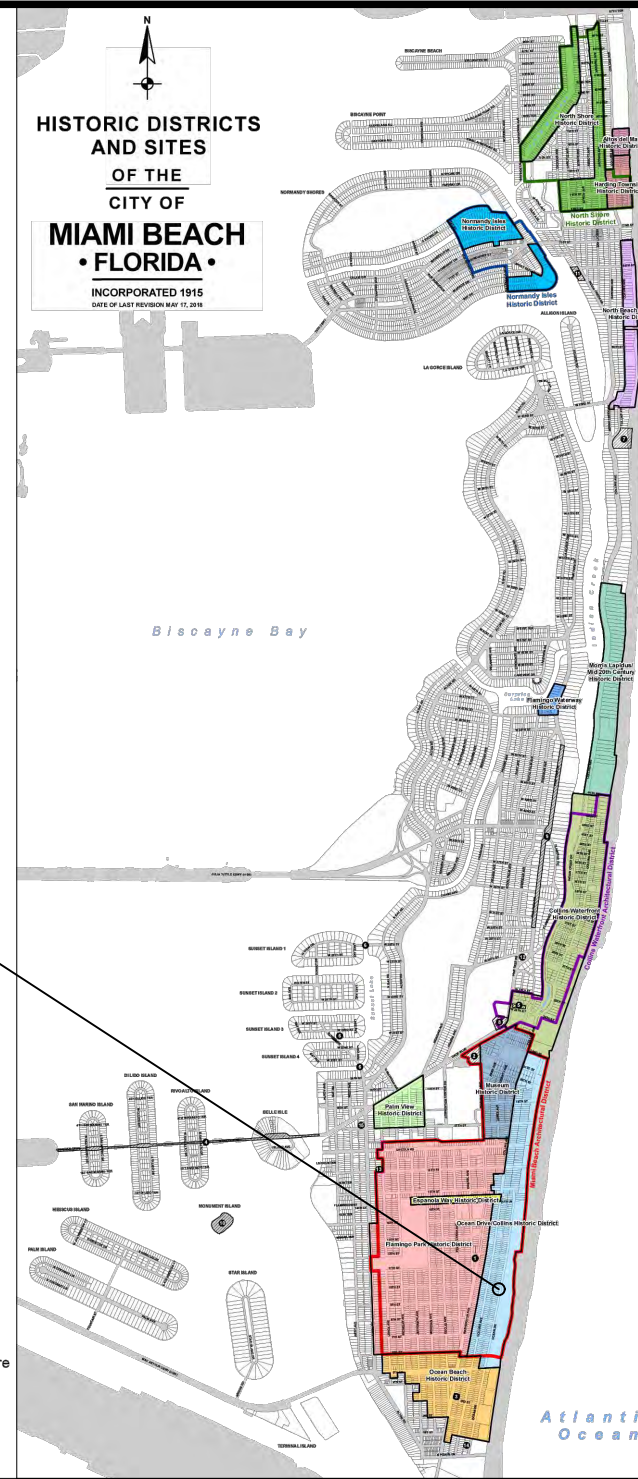

LEGEND AND ABBREVIATIONS

- = PALM TREE
- = TREE
- = ORNAMENTAL TREE
- O.R.B. = OFFICIAL RECORDS BOOK
- PG. = PAGE
- ELEV. = ELEVATION
- TYP. = TYPICAL
- CATV = CABLE TELEVISION
- OHE = OVERHEAD ELECTRIC LINE
- X 0.00 = SPOT ELEVATION
- CONC. = CONCRETE
- C.B.S. = CONCRETE BLOCK STUCCO
- C.L.F. = CHAIN LINK FENCE
- W.F. = WOOD FENCE
- M.F. = METAL FENCE
- RCP = REINFORCED CONCRETE PIPE
- FF = FINISH FLOOR
- (R) = RECORD
- (C) = CALCULATED
- (M) = MEASURE
- LB = LICENSE BUSINESS
- L = LENGTH
- Δ = CENTRAL ANGLE
- R = RADIUS
- T = TANGENT
- PT = POINT OF TANGENCY
- PC = POINT OF CURVATURE
- STA. = STATION
- PI = POINT OF INTERSECTION
- ID = IDENTIFICATION
- MLP = METAL LIGHT POLE
- CLP = CONCRETE LIGHT POLE
- R/W = RIGHT-OF-WAY
- P.B. = PLAT BOOK
- = SECTION LINE
- = CENTERLINE
- = BASELINE
- = MONUMENT LINE
- = TRAFFIC SIGNAL BOX
- = TRAFFIC SIGNAL CABINET
- = BOLLARD
- = PEDESTRIAN SIGNAL
- = TRAFFIC SIGNAL MAST ARM
- = SIGN
- = CABLE TELEVISION BOX
- = LIGHT POLE
- = ELECTRIC BOX
- = UTILITY POLE
- = ELECTRIC TRANSFORMER
- = GUY ANCHOR
- = ELECTRIC MANHOLE
- = ELECTRIC METER
- = GAS VALVE
- = GAS UTILITY BOX
- = GAS MANHOLE
- = GAS TANK
- = GAS METER
- = COMMUNICATION BOX
- = COMMUNICATION MANHOLE
- = GARBAGE RECEPTACLE
- = HANDICAP PARKING SPACE
- = WATER METER
- = IRRIGATION VALVE
- = WATER VALVE
- = FIRE HYDRANT
- = WATER BOX
- = WATER CONNECTION
- = WATER MANHOLE
- = WATER TANK
- = WATER WELL
- = WATER MARKING FLAG
- = WATER MARKING SIGN
- = STORM MANHOLE
- = STORM METER
- = CATCH BASIN
- = TELEPHONE MANHOLE
- = TELEPHONE BOX
- = NEWSPAPER DISPENSER
- = MAILBOX
- = SANITARY MANHOLE
- = SANITARY BOX
- = SANITARY TANK
- = SANITARY LIFT STATION
- = GREASE TRAP MANHOLE
- = CLEANOUT
- = PARKING METER
- = FIBER OPTIC BOX
- = FIBER OPTIC MARKER SIGN
- = MONITORING WELL
- = FUEL TANK
- = UNKNOWN UTILITY BOX
- = UNKNOWN UTILITY METER
- = UNKNOWN UTILITY MANHOLE
- = UNKNOWN UTILITY VALVE
- = UNKNOWN UTILITY MARKER FLAG
- = SANITARY VALVE
- = RAILROAD SIGN
- = FLAGPOLE
- = PROPERTY LINE
- = ELECTRICAL OUTLET

PROJECT LOCATION
OCEAN DRIVE/COLLINS AVENUE HISTORIC DISTRICT

LOCAL HISTORIC DISTRICTS

	Espanola Way Historic District		Palm View Historic District
	Altos del Mar Historic District		Collins Waterfront Historic District
	Flamingo Park Historic District		North Beach Resort Historic District
	Ocean Drive/Collins Avenue Historic District		Flamingo Waterway Historic District
	Museum Historic District		Morris Lapidus/Mid 20th Century Historic District
	Ocean Beach Historic District		North Shore Historic District
	Harding Townsite Historic District		Normandy Isles Historic District

NATIONAL REGISTER HISTORIC DISTRICTS

	Miami Beach Architectural District
	Normandy Isles Historic District
	North Shore Historic District
	Collins Waterfront Architectural District

LOCAL HISTORIC SITES

1	Old City Hall Historic Site	8	Dade Blvd Fire Station Historic Site
2	21st St Recreation Center Historic Site	9	PineTree Dr Historic Roadway
3	Congregation Beth Jacob Historic Site	10	Flagler Memorial and Monument Island Historic Site
4	Venetian Causeway Historic Site	11	69th St Fire Station Historic Site
5	Miami Beach Woman's Club Historic Site	12	28th St Obelisk and Pumping Station Historic Structure
6	Sunset Island Bridges Historic Structures	13	1600 Lenox Ave Historic Site
7	The Bath Club Historic Site	14	36 Ocean Dr Historic Site
		15	1700 Alton Rd Historic Site

PROJECT DIRECTORY:

PROJECT NAME:
INTERACTIVE DIGITAL INFORMATION
KIOSKS DEPLOYMENT PROJECT

JURISDICTION:
CITY OF MIAMI
DEPARTMENT OF RESILIENCE AND
PUBLIC WORKS
MIAMI RIVERSIDE CENTER
444 S.W. 2nd AVENUE, 8th FLOOR
MIAMI, FLORIDA 33130
TEL: 305-416-1200

OWNER:
IKE SMART CITY
250 N HARTOFORD AVE
COLUMBUS, OH 43222
(614) 589-0087

ENGINEER OF RECORD:
MAINSTREET ENGINEERING
7035 SW 47 STREET, SUITE A
MIAMI, FL 33155
(305) 456-3505
PROJ. MGR: VANESSA MELA, P.E.
VMELA@MAINSTREETENG.COM

KIOSK MANUFACTURER:
DISPLAY DEVICE INC.
21075 WESTGATE RD.
GOLDEN, CO 80403
CONTACT: ERIC PERKINS
PHONE: (303) 929-4071

UTILITIES:

ELECTRICAL POWER: FLORIDA
POWER & LIGHT COMPANY (FPL)

WATER & SEWER: MIAMI-DADE
WATER & SEWAGE DEPARTMENT

TELEPHONE: AT&T


CABLE: COMCAST, XFINITY,
ATT-UVERSE

GAS: FLORIDA GAS


SIDEWALK & STREET SYMBOLS

	ASPHALT		BRICK
	PAVER		CONCRETE
	UNIMPROVED		TILE
	GRAVEL		STAMPED CONCRETE

KEY PLAN (NOT TO SCALE):

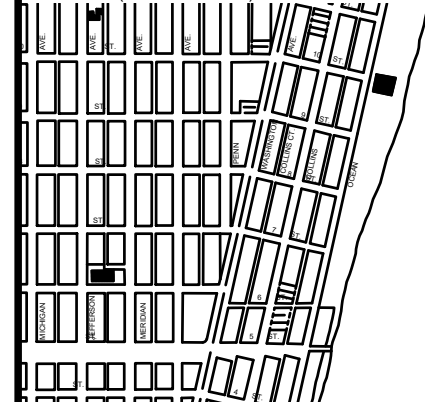

P.E. SEAL:

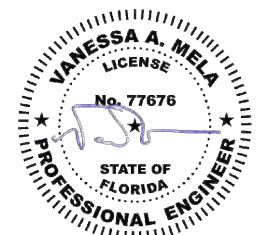

NO.	DATE	REVISION	APP'D. BY
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2			
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ADA NOTES

- ALL CONSTRUCTION ACTIVITIES SHALL BE COMPLETED IN FULL COMPLIANCE WITH THE AMERICANS WITH DISABILITIES ACT (ADA). CLEAR SPACES IN FRONT OF KIOSK SHALL HAVE THE FOLLOWING CHARACTERISTICS:
- SURFACES SHALL BE FIRM, STABLE, AND SLIP RESISTANT AND OTHERWISE COMPLY WITH PROWAG SECTION R302.7 AND SHALL HAVE A RUNNING SLOPE CONSISTENT WITH GRADE OF THE ADJACENT PEDESTRIAN ACCESS ROUTE AND CROSS SLOPE OF 1.50% +/-0.50%)
- SIZE: CLEAR SPACES SHALL BE 48" MINIMUM BY 48" MINIMUM.
- POSITION: UNLESS OTHERWISE SPECIFIED, CLEAR SPACES SHALL BE POSITIONED FOR EITHER FORWARD OR PARALLEL APPROACH TO THE KIOSK.
- APPROACH: ONE FULL UNOBSTRUCTED SIDE OF A CLEAR SPACE SHALL ADJOIN A PEDESTRIAN ACCESS ROUTE OR ADJOIN ANOTHER CLEAR SPACE.
- MANEUVERING SPACE: WHERE A CLEAR SPACE IS CONFINED ON ALL OR PART OF THREE SIDES, ADDITIONAL MANEUVERING SPACE SHALL BE PROVIDED AS FOLLOWS:
 - FORWARD APPROACH: THE CLEAR SPACE AND ADDITIONAL MANEUVERING SPACE SHALL BE 36" WIDE MINIMUM WHERE THE DEPTH OF THE CONFINING ELEMENT EXCEEDS 24".
 - PARALLEL APPROACH: THE CLEAR SPACE AND ADDITIONAL MANEUVERING SPACE SHALL BE 60" WIDE MINIMUM WHERE THE DEPTH OF THE CONFINING ELEMENT EXCEEDS 15".
- THE MINIMUM WHEELCHAIR PASSAGE WIDTH OR CLEAR SPACE WIDTH FOR A SINGLE WHEELCHAIR PASSAGE SHALL BE 48" PER PROWAG SECTION R302.3.
- INITIAL OPERATION FOR THE KIOSK WILL HAVE 4G LTE CONNECTION SECTION R404. TO THE INTERNET.
- THE KIOSKS HAVE BEEN DESIGN TO COMPLY WITH ALL ADA GUIDELINES INCLUDING VIEWING, OPERATION, AND ACCESSIBILITY.
- THE MOBILE IKE EXPERIENCE WILL FOLLOW WEB CONTENT ACCESSIBILITY GUIDELINES (WCAG) TO WORK IN TANDEM WITH THE NATIVE ACCESSIBILITY FEATURES ON THE USER'S MOBILE DEVICE, INCLUDING TALKBACK AND VOICEOVER TOOLS.

SCOPE OF WORK

THE PROJECT CONSIST OF THE INSTALLATION OF ONE (1) DIGITAL INTERACTIVE KIOSKS AT THE LOCATION(S) INDICATED ON THIS PLANS SET. INSTALLER SHALL PROVIDE AND INCLUDE ALL WORKMANSHIP AND MATERIALS NECESSARY TO COMPLETE THE INSTALLATION INCLUDING BUT NOT LIMITED TO:


- INSTALLATION OF THE KIOSKS TO THE FOUNDATION AS INDICATED ON PLANS TO NEW RECTANGULAR CONCRETE FOUNDATION.
- ELECTRICAL SERVICE POINTS ARE EXISTING. CONNECT THE EXISTING ELECTRIC SERVICE TO THE NEW KIOSK AS INDICATED ON PLANS.
- TESTING OF THE ELECTRICAL SERVICE INFRASTRUCTURE SHALL BE PERFORMED IN CONJUNCTION WITH A REPRESENTATIVE OF THE ENGINEER OF RECORD.
- THE CONTRACTOR SHALL INSTALL THE KIOSK IN SUCH A WAY THAT THE KIOSK IS WITHIN THE PUBLIC R.O.W. AND IN COMPLIANCE WITH ALL APPLICABLE A.D.A. REQUIREMENTS
- THE LOCATION OF KIOSKS HAS BEEN COORDINATE TO ENSURE THERE IS NO OBSTRUCTION OF THE SIGHT OF VEHICULAR SIGNS.
- STAND-ALONE PEDESTRIAN KIOSKS SHOULD NOT BE INSTALLED WITHIN PEDESTRIAN CIRCULATION PATHS IN A MANNER THAT PERSONS AT THE KIOSK LOCK THE EFFECTIVE WIDTH OF THE PEDESTRIAN TRAVEL WAY.

MONUMENT SIGN SPECIFICATIONS AND FUNCTIONS


THE UNIT CONSISTS OF A UL/NRTL LISTED WEATHER AND VANDAL RESISTANT FREE STANDING ENCLOSURE DESIGNED TO COMPLY WITH THE FLORIDA BUILDING CODE AND OTHER APPLICABLE CODES INCLUDING THE NATIONAL ELECTRICAL CODE. THE UNIT HAS BEEN DESIGNED TO WITHSTAND WINDS OF 165 MPH. THE UNIT'S MAIN COMPONENTS ARE:


- TWO (2) INTERACTIVE 65" VIDEO TOUCH SCREENS.
- TWO (2) CAMERAS
- ONE (1) CPU
- ONE (1) WI-FI TRANSMITTER

MANUFACTURER: DYNASCAN MODEL NUMBER: CIO651DR5
 NATIVE RESOLUTION: 1920 X 1080
 ELECTRICAL POWER REQUIREMENT:
 1. ONE-2-POLE, 20 AMP, 240 VOLTS CIRCUIT.
 2. TOTAL LOAD: 1400/2200 WATTS (OPERATIONAL/PEAK)
 3. VOLTAGE: 100-240 VOLTS AC, 50-60 HZ
 WEIGHT: 832 LBS
 CERTIFICATION CE / FCC / RoHS


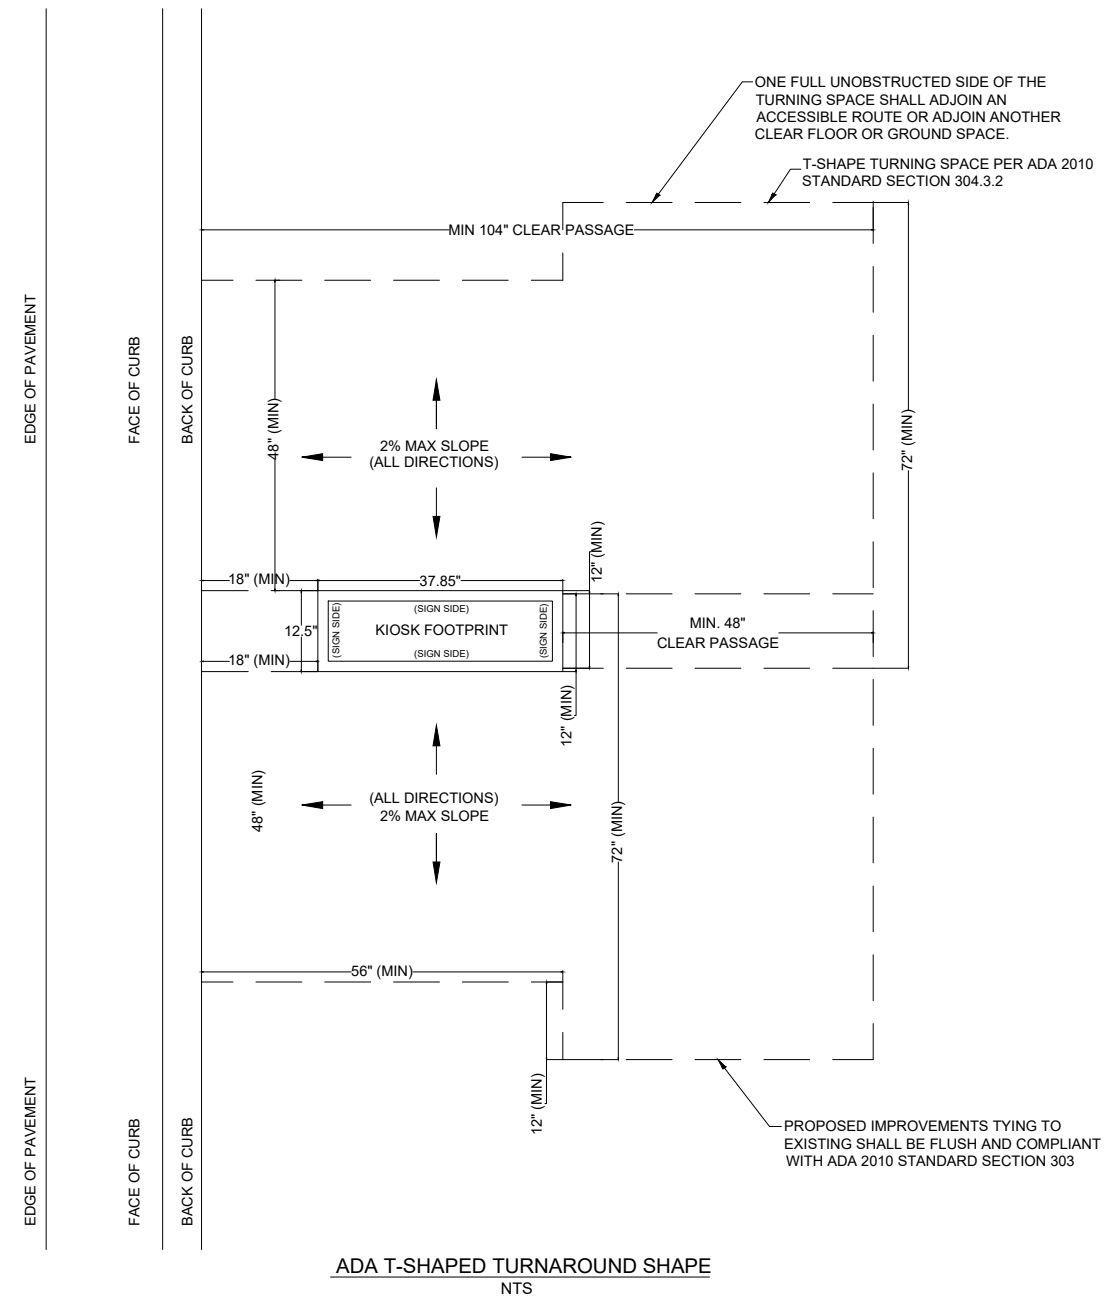


NOTES:

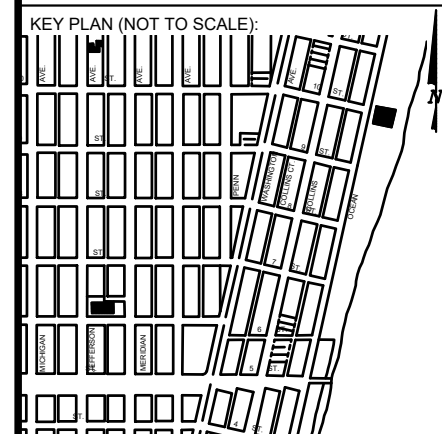

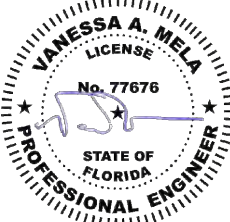P.E. SEAL:


NO.	DATE	REVISION	APP'D. BY
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SIGHT TRIANGLE CLEARANCE

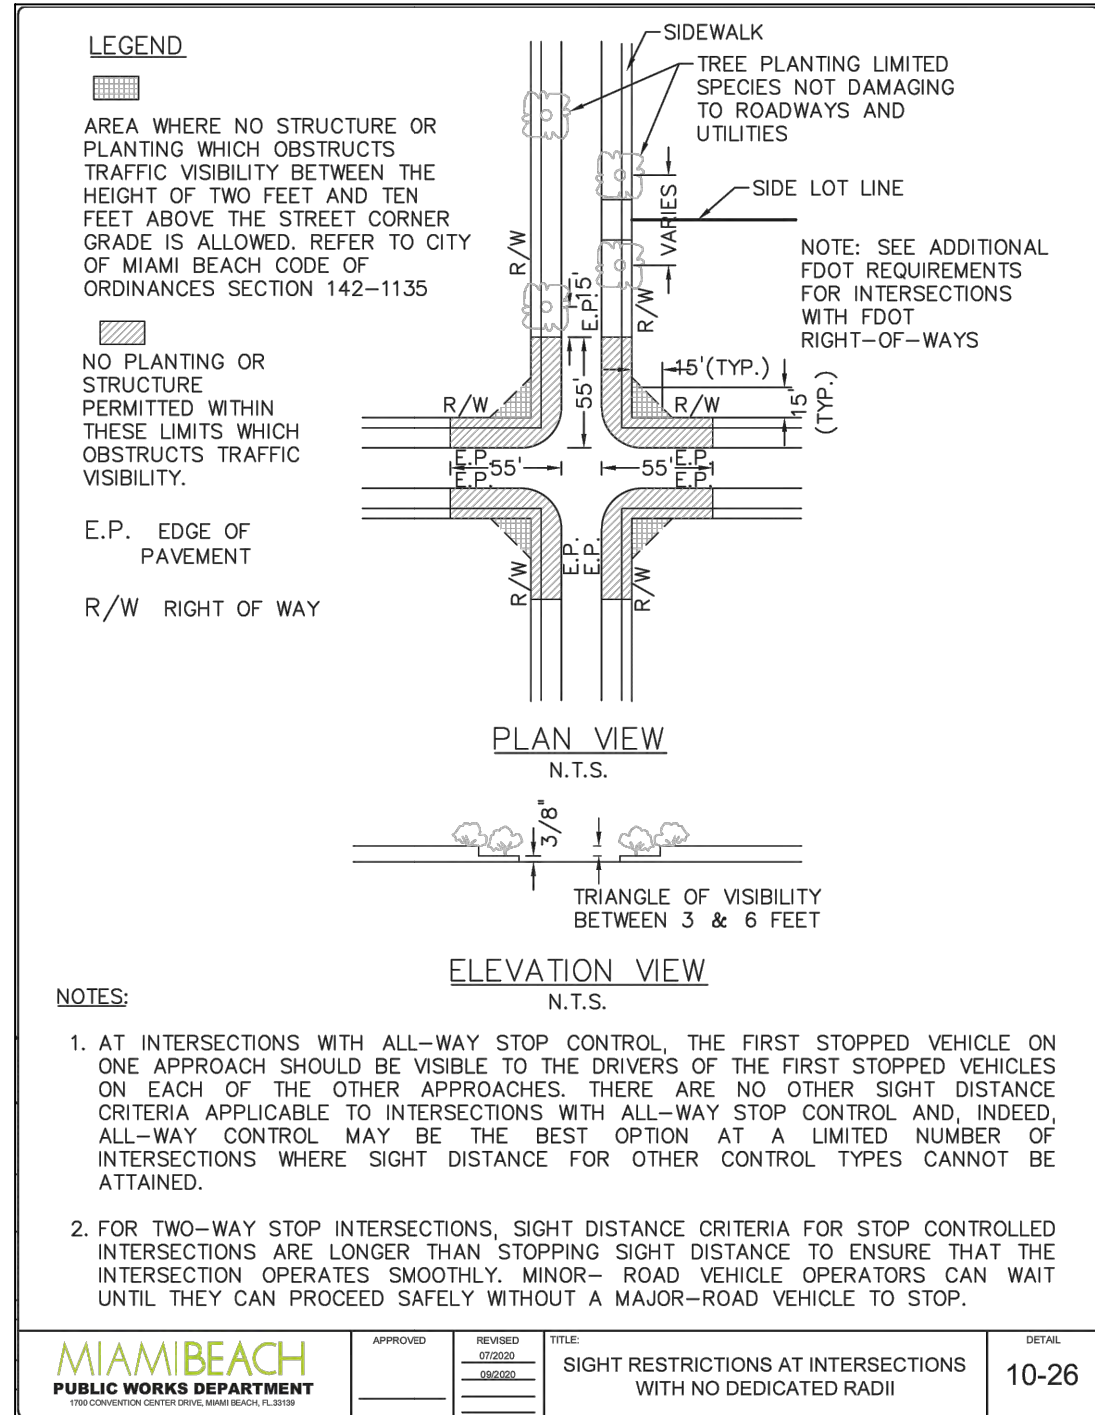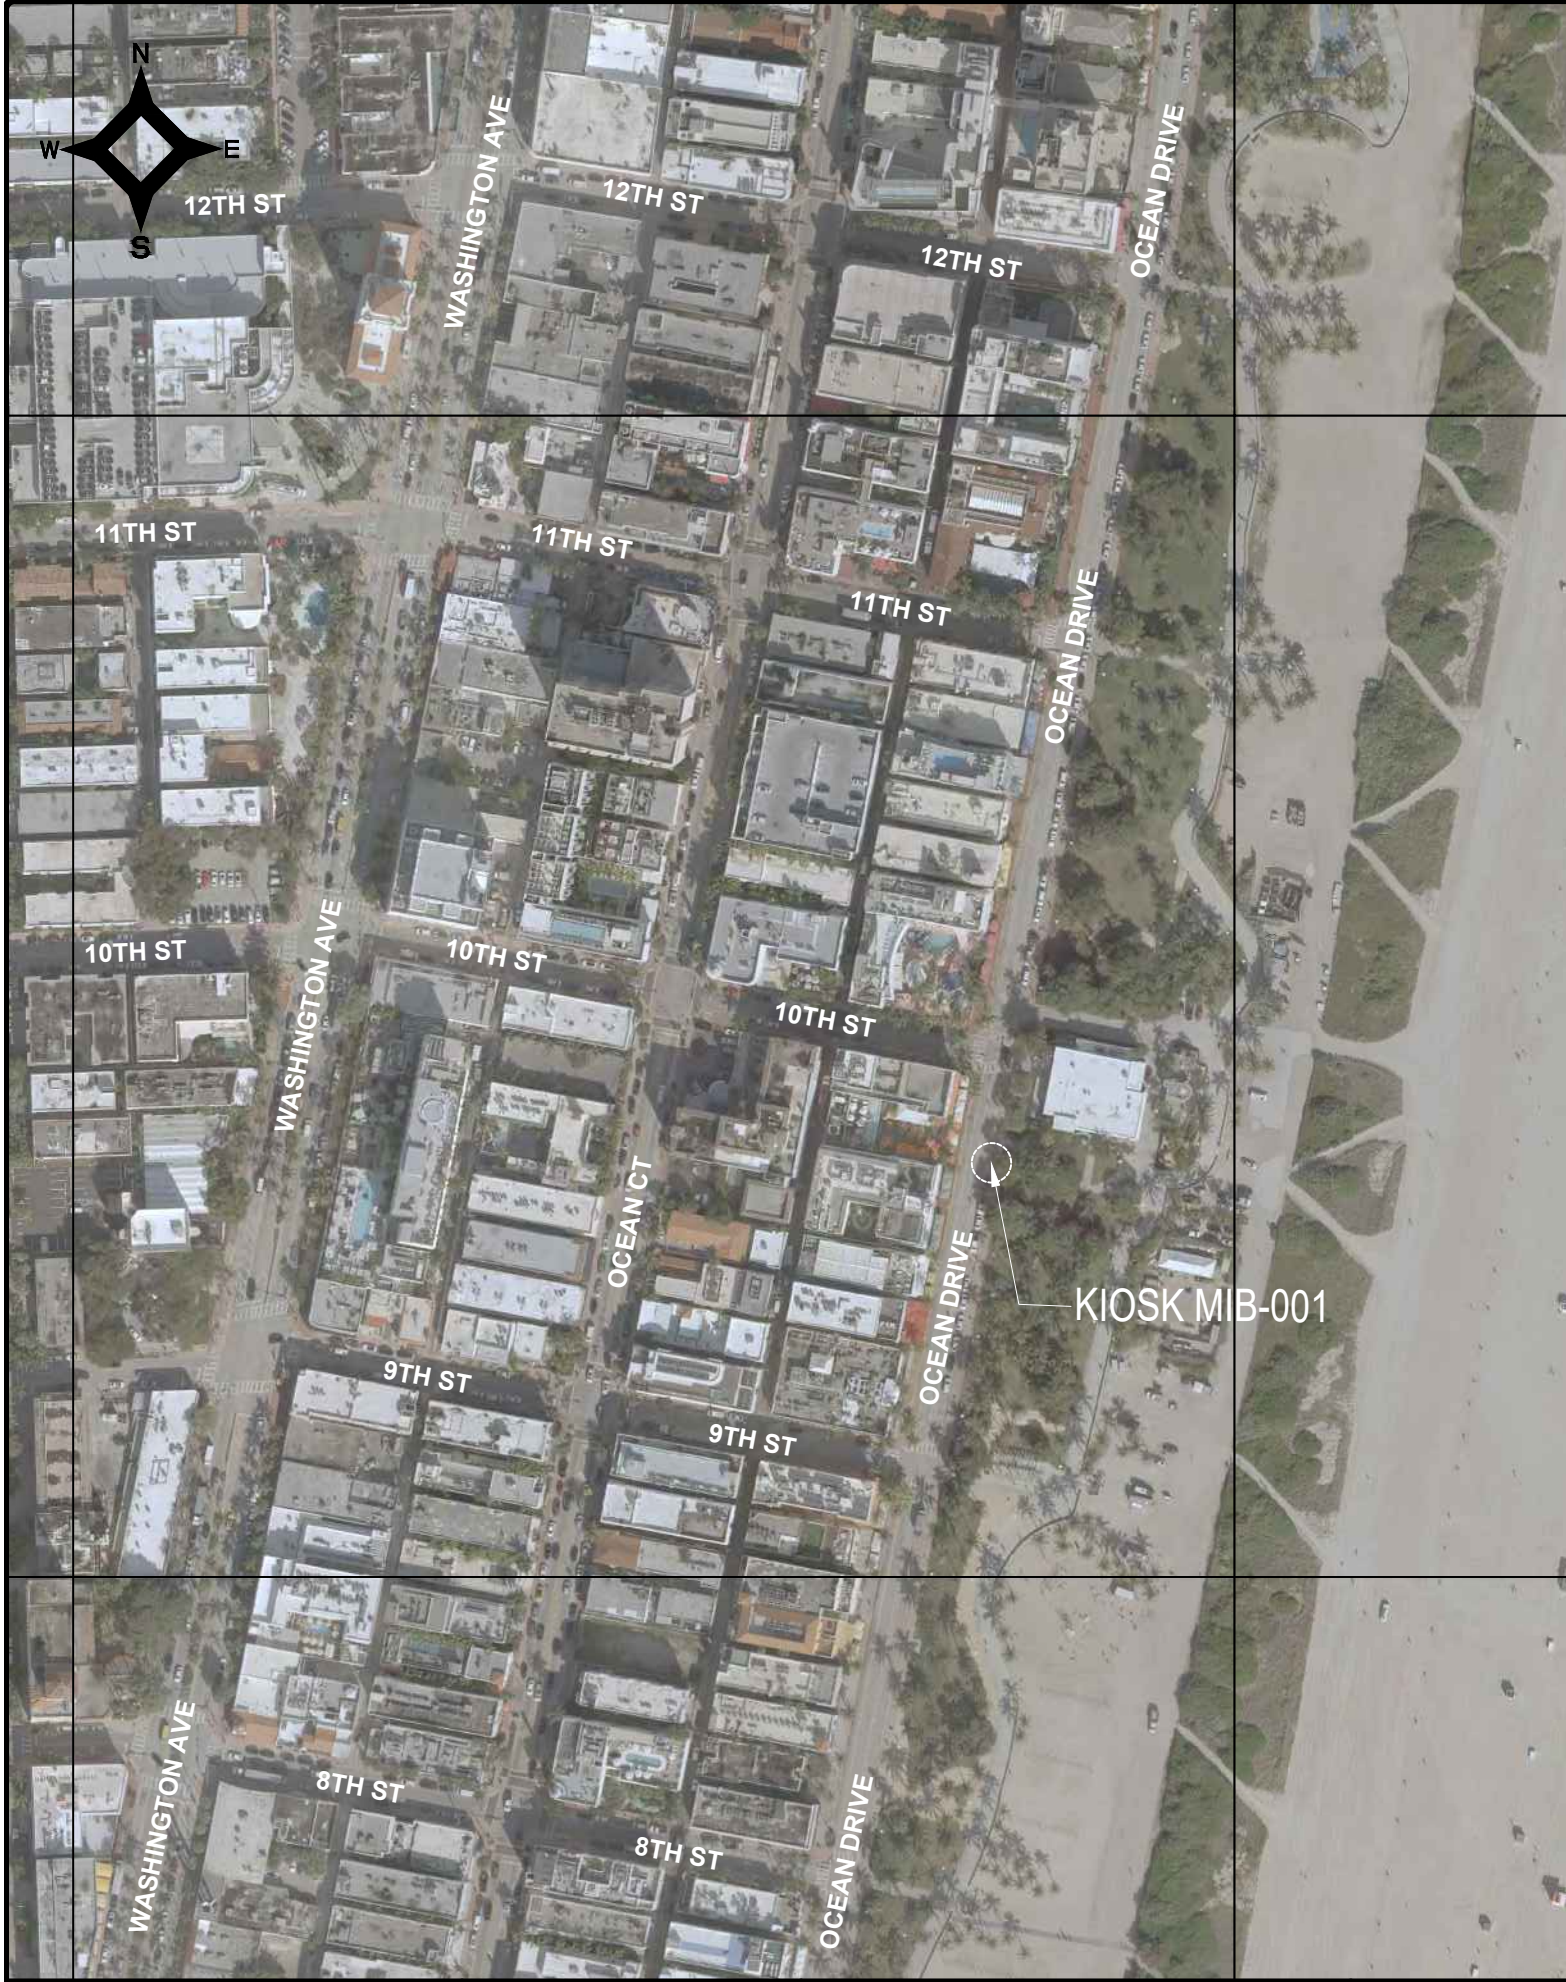Sunshine811

Call 811 or visit sunshine811.com two full business days before digging to have buried facilities located and marked.

Check positive response codes before you dig!

NOTES:

KEY PLAN (NOT TO SCALE):

P.E. SEAL:

ENGINEER OF RECORD: VANESSA A. MELA, P.E. NO. 77676
 ENGINEER OF RECORD: VM
 DESIGN ENGINEER: VM
 DRAWN BY: KM
 CHECKER: WP
 SCALE:

NEIGHBORHOOD: MIB-001: OCEAN DRIVE & 10TH STREET
 TITLE: CIVIL SITE PLAN

CITY MANAGER: ALINA T. HUDAK
 DIRECTOR: JOE GOMEZ, P.E.
 CITY ENGINEER: CRISTINA ORTEGA CASTINEIRAS, P.E.

5			
4			
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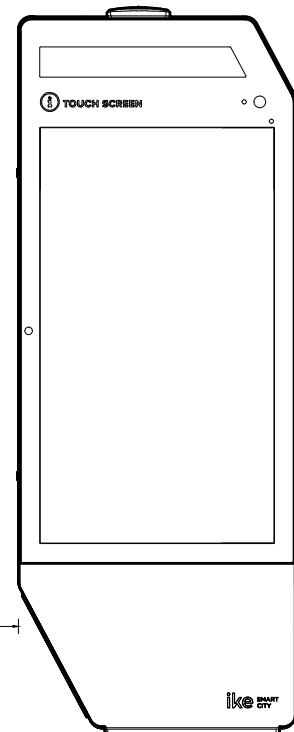
MIAMI BEACH PUBLIC WORKS DEPARTMENT
 1700 CONVENTION CENTER DRIVE, MIAMI BEACH, FL 33139

MainStreet ENGINEERING
 7035 SW 47th Street, Ste A, Miami, FL 33155
 Tel: (305) 496-3055 Fax: (305) 476-8894
 FL PE Certificate No: 00008751

File Name: MIB-CIVIL PLANS REV1.dwg
 Survey Reference:
 Field Book: N/A Page: N/A Work Order: N/A
 Date: 10/09/2023 Sheet: 3 of 6 Drawing: C1-01






NOTES:



IKE 3.0 KIOSK
SEE SPEC. SHEET
FOR DETAILS


6'-9" CLEAR
DISTANCE

1'-6" FROM
BOC

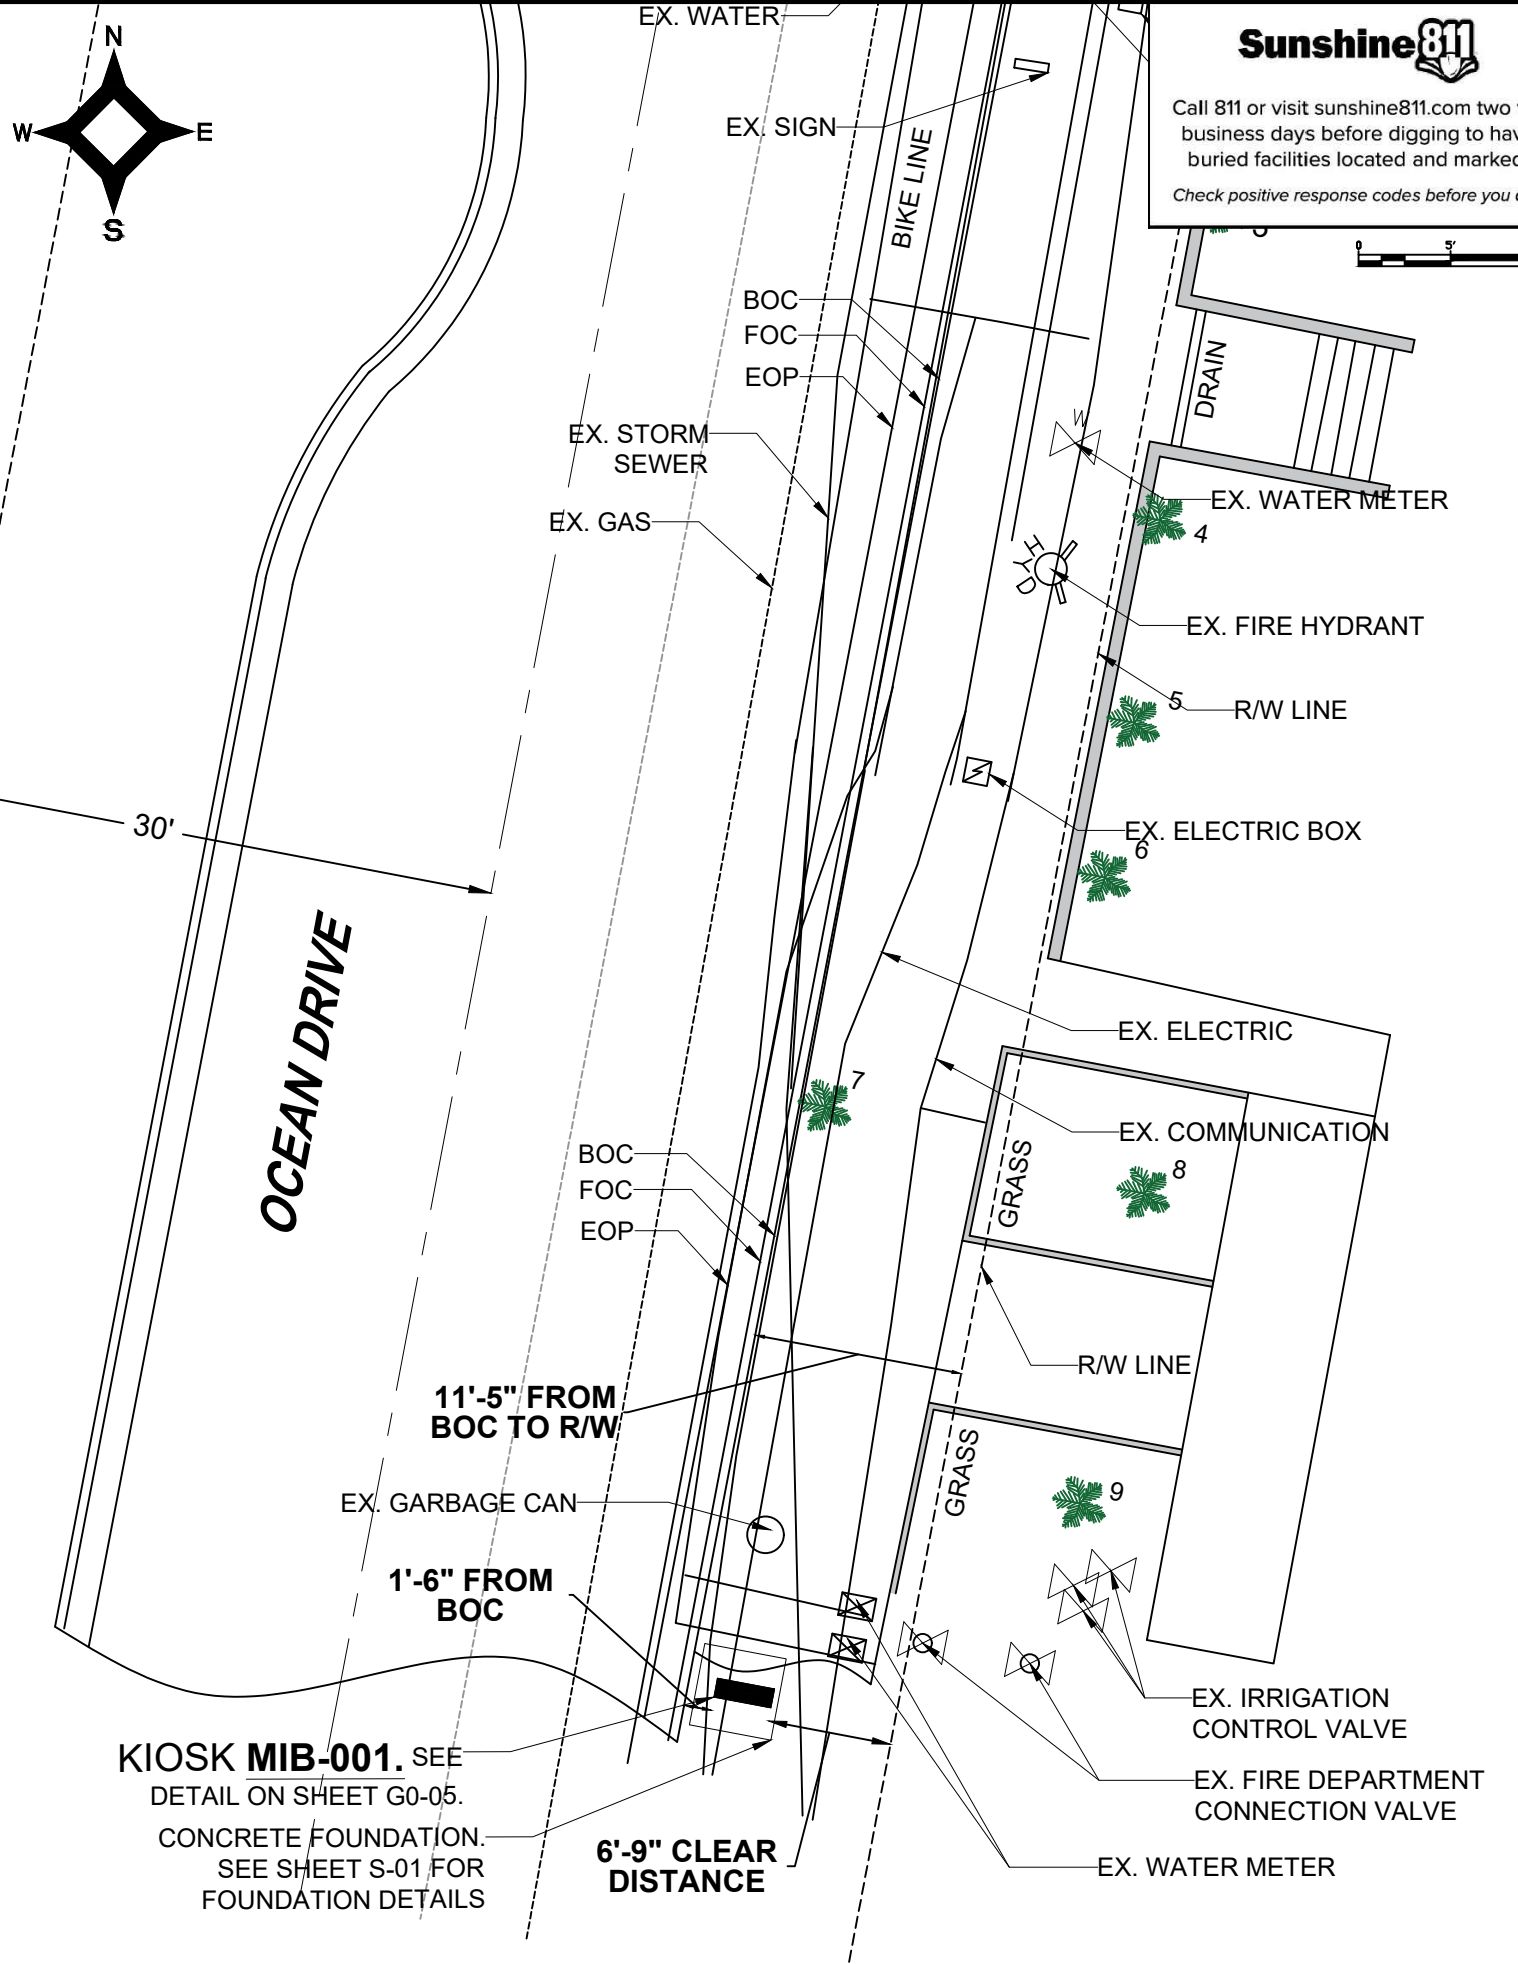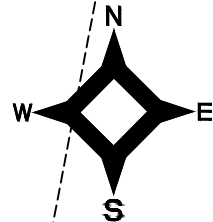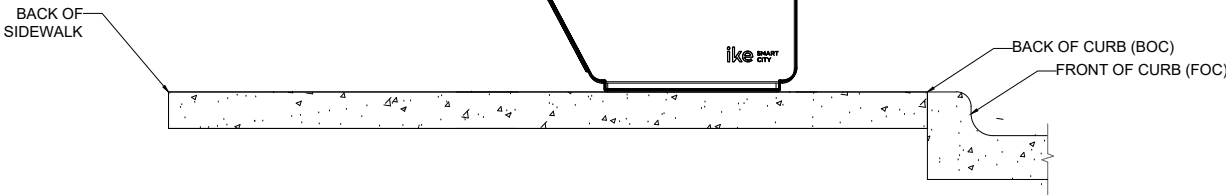

VISIBILITY TRIANGLE CLEARANCE ANALYSIS

SCALE: 1'-20"

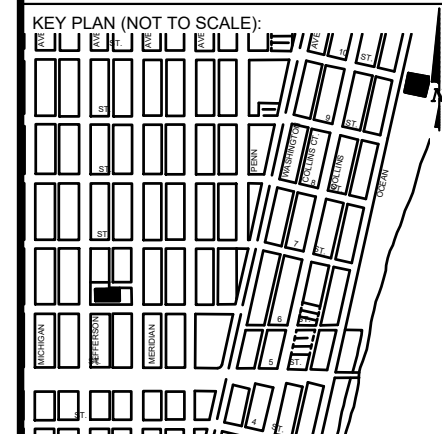

P.E. SEAL:


KIOSK MIB-001. SEE
DETAIL ON SHEET G0-05.
CONCRETE FOUNDATION.
SEE SHEET S-01 FOR
FOUNDATION DETAILS

6'-9" CLEAR
DISTANCE

11'-5" FROM
BOC TO R/W

1'-6" FROM
BOC

5			
4			
3			
2			
1			
NO.	DATE	REVISION	APP'D. BY

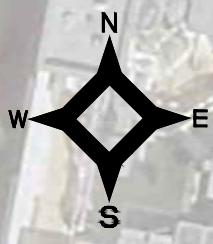

LOT - 8
BLOCK - 15

10'-0" SIDEWALK
11'-1" CLEAR DISTANCE

OCEAN DRIVE
BOB: N 10°46'57" E
RIGHT-OF-WAY
VARIABLE PAVEMENT WIDTH

6.5'
NEW FPL METER
EXISTING FPL PULLBOX JB-1
NEW PULLBOX JB-2

10TH STREET
50' TOTAL
RIGHT-OF-WAY
20.9' PAVEMENT

LOT - 1
BLOCK - 14

BOC
FOC
EOP

11'-5" FROM BOC TO R/W

LOT - 2
BLOCK - 14

PULLBOX JB-3
1'-6" FROM BOC

KIOSK MIB-001


6'-9" CLEAR DISTANCE

ELECTRICAL PLAN

SCALE: 1'-10"

Sunshine811

Call 811 or visit sunshine811.com two full business days before digging to have buried facilities located and marked.
Check positive response codes before you dig!

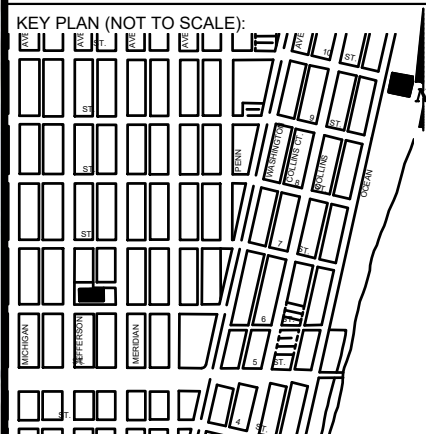

P.E. SEAL:

MIAMI BEACH
PUBLIC WORKS DEPARTMENT
1700 CONVENTION CENTER DRIVE, MIAMI BEACH, FL 33139

CITY MANAGER: ALINA T. HUDAK
DIRECTOR: JOE GOMEZ, P.E.
CITY ENGINEER: CRISTINA ORTEGA CASTINEIRAS, P.E.

NO.	DATE	REVISION	APP'D. BY
5			
4			
3			
2			
1			

Main Street ENGINEERING
7035 SW 47th Street, Ste A, Miami, FL 33155
Tel: (305) 490-3025 Fax: (305) 478-9864
FL PE Certificate No: 00006751

ENGINEER OF RECORD: WILLIAM E. PINO, P.E. NO. 32028
ENGINEER OF RECORD: WP
DESIGN ENGINEER: WP
DRAWN BY: KM
CHECKER: WP
SCALE: 1"=10'

NEIGHBORHOOD: MIB-001: OCEAN DRIVE & 10TH STREET
TITLE: KIOSK MIB-001 ELECTRICAL PLAN

File Name: ELECTRICAL & TTC PLANS REV1.dwg
Survey Reference:
Field Book: N/A Page: N/A Work Order: N/A
Date: 10/09/2023 Sheet: 5 of 6 Drawing: E1-01

Survey Pros, Inc.

4348 SW 74TH AVENUE, MIAMI, FL. 33155
 PH: (305) 767-6802 (main)
 MIAMI-DADE | BROWARD | PALM BEACH | MONROE | HILLSBOROUGH | PINELLAS
www.survey-pros.com

MAP OF SPECIFIC PURPOSE, TOPOGRAPHIC & TREE SURVEY

OF A PORTION OF
 "OCEAN DRIVE"
 CITY OF MIAMI BEACH, FL.
 PLAT OF "OCEAN BEACH ADDITION NO. 2"
 PLAT BOOK 2, PAGE 56, MDCR

LEGEND

ABBREVIATIONS:

- A = ARC DISTANCE
- AC = AIR CONDITIONER PAD
- BCR = BROWARD COUNTY RECORDS
- BLDG = BUILDING
- BM = BENCH MARK
- BOB = BASIS OF BEARINGS
- CBS = CONCRETE BLOCK & STUCCO
- (C) = CALCULATED
- C&G = CURB & GUTTER
- CLF = CHAIN LINK FENCE
- COL = COLUMN
- D.E. = DRAINAGE EASEMENT
- D.M.E. = DRAINAGE & MAINTENANCE EASEMENT
- D/W = DRIVEWAY
- EB = ELECTRIC BOX
- ENC. = ENCROACHMENT
- EP = EDGE OF PAVEMENT
- EW = EDGE OF WATER
- FDH = FOUND DRILL HOLE
- FFE = FINISHED FLOOR ELEVATION
- FIP = FOUND IRON PIPE (NO ID)
- FIR = FOUND IRON ROD (NO ID)
- FN = FOUND NAIL (NO ID)
- FN&D = FOUND NAIL & DISK
- FPL = FLORIDA POWER & LIGHT TRANSFORMER PAD
- L.E. = LANDSCAPE EASEMENT
- L.M.E. = LAKE MAINTENANCE EASEMENT
- (M) = MEASURED
- MDCR = MIAMI-DADE COUNTY RECORDS
- MH = MAN HOLE
- ML = MONUMENT LINE
- (P) = PLAT
- PB = PLAT BOOK
- PC = POINT OF CURVATURE
- PCP = PERMANENT CONTROL POINT
- PE = POOL EQUIPMENT PAD
- PG = PAGE
- PI = POINT OF INTERSECTION
- PL = PLANTER
- POB = POINT OF BEGINNING
- POC = POINT OF COMMENCEMENT
- PRC = POINT OF REVERSE CURVATURE
- PRM = PERMANENT REFERENCE MONUMENT
- PT = POINT OF TANGENCY
- R = RADIUS DISTANCE
- (R) = RECORD
- R/W = RIGHT-OF-WAY
- RES = RESIDENCE
- SIP = SIP LB#8023
- SND = SET NAIL & DISK LB#8023
- STL = SURVEY TIE LINE
- SWK = SIDEWALK
- (TYP) = TYPICAL
- UB = UTILITY BOX
- U.E. = UTILITY EASEMENT
- W/F = WOOD FENCE

TREE TABLE:

NO	COMMON NAME	DBH(Ø)	HEIGHT	CANOPY
1	TREE	27"	28'	19'
2	PALMETTO	11"	18'	8'
3	PALMETTO	11"	18'	8'
4	PALMETTO	11"	18'	8'
5	PALMETTO	11"	18'	8'
6	PALMETTO	11"	18'	8'
7	PALMETTO (3)	3"	5'	6'
8	PALMETTO (3)	3"	5'	6'
9	PALMETTO (3)	3"	5'	6'


IN CASE OF A DISPUTE AN ARBORIST REPORT WILL GOVERN.

SYMBOLS:


- = COMMUNICATION LINE
- = ELECTRIC LINE
- = UNKNOWN
- = STORM LINE
- = WATER LINE
- = SANITARY LINE

SYMBOLS:

- = TELEPHONE RISER
- = CABLE TV RISER
- = WATER METER
- X 0.00 = ELEVATION
- (00') = ORIGINAL LOT DISTANCE
- Δ = CENTRAL ANGLE
- = CENTER LINE
- = WATER VALVE
- = CURB INLET
- = FIRE HYDRANT
- = LIGHT POLE
- = CATCH BASIN
- = UTILITY POLE
- = DRAINAGE MANHOLE
- = SEWER MANHOLE
- = ELECTRIC BOX
- = SIGN
- = METAL FENCE
- = WOOD FENCE
- = CHAIN LINK FENCE
- = EASEMENT
- = BOUNDARY LINE
- = OVERHEAD UTILITY LINE
- = ORIGINAL LOT LINE

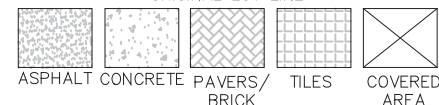

GRAPHIC SCALE

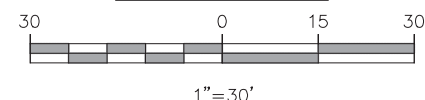

BENCHMARK INFORMATION:

NAME: E-03
 ELEVATION: 9.47' (NGVD29)
 LOCATION1: MACARTHUR CSWY --- 6.5' SW OF SW EDGE OF PAVEMENT
 LOCATION2: BRIDGE ROAD --- 50' NW OF PROJECTED C/L
 DESCRIPTION: BRASS DISK IN CONC SIDEWALK.
 (STAMPED 87 93 E-03)



LOCATION SKETCH:

NOT TO SCALE



FLOOD ZONE INFORMATION:

THE GRAPHICALLY DEPICTED BUILDING(S) SHOWN ON THIS MAP OF SURVEY IS WITHIN ZONE AE. BASE FLOOD ELEVATION 8. COMMUNITY NAME & NUMBER CITY OF MIAMI BEACH 120651. MAP & PANEL NUMBER 12086C0319 SUFFIX L.

SURVEYOR'S NOTES:

1. ELEVATIONS WHEN SHOWN REFER TO 1929 NATIONAL GEODETIC VERTICAL DATUM (NGVD 1929).
2. NO ATTEMPT WAS MADE TO LOCATE FOOTINGS/FOUNDATIONS, OR UNDERGROUND UTILITIES UNLESS OTHERWISE NOTED.
3. THE LANDS SHOWN HEREON HAVE NOT BEEN ABSTRACTED IN REGARDS TO MATTERS OF INTEREST BY OTHER PARTIES, SUCH AS EASEMENTS, RIGHTS OF WAYS, RESERVATIONS, ETC. ONLY PLATTED EASEMENTS ARE SHOWN.
4. THIS SURVEY WAS PREPARED FOR AND CERTIFIED TO THE PARTY(IES) INDICATED HEREON AND IS NOT TRANSFERABLE OR ASSIGNABLE WITHOUT WRITTEN CONSENT OF THIS FIRM.
5. ALL BOUNDARY LIMIT INDICATORS SET ARE STAMPED LB#8023.
6. THE BOUNDARY LIMITS ESTABLISHED ON THIS SURVEY ARE BASED ON THE LEGAL DESCRIPTION PROVIDED BY THE CLIENT OR ITS REPRESENTATIVE.
7. FENCE OWNERSHIP IS NOT DETERMINED. DIMENSIONS ARE TO THE INTERIOR PORTION OF THE FENCE.
8. ADDITIONS OR DELETIONS TO THIS SURVEY MAP AND/OR REPORT BY SOMEONE OTHER THAN THE SIGNING PARTY(IES) IS PROHIBITED WITHOUT WRITTEN CONSENT OF THE SIGNING PARTY(IES).
9. THIS SURVEY IS NOT VALID WITHOUT THE ORIGINAL SIGNATURE AND RAISED SEAL OF A FLORIDA LICENSED SURVEYOR AND MAPPER. OTHERWISE THIS MAP IS FOR INFORMATIONAL PURPOSES ONLY.
10. BEARINGS WHEN SHOWN ARE TO AN ASSUMED MERIDIAN AND BASED ON PLAT. THE CENTERLINE OF OCEAN DRIVE BEARS N10°46'57"E.

SURVEYOR'S CERTIFICATION:

I HEREBY CERTIFY THAT THIS SURVEY IS TRUE AND CORRECT TO THE BEST OF MY KNOWLEDGE AND BELIEF AS RECENTLY SURVEYED AND DRAWN UNDER MY DIRECTION AND MEETS THE MINIMUM TECHNICAL STANDARDS SET FORTH BY THE FLORIDA STATE BOARD OF SURVEYORS AND MAPPERS IN CHAPTER 5J-17 FLORIDA ADMINISTRATIVE CODE PURSUANT TO SECTION 472.027 FLORIDA STATUTE.

CERTIFIED TO:

MAIN STREET ENGINEERING

REVISION(S):

07/26/2023 - UPDATE SURVEY, JOB#23039119

<p>SEAL</p>	<p>DATE OF ORIGINAL FIELD WORK: 03/11/2023</p> <p>JOB NUMBER: 23039119</p> <p>DRAWN BY: ADRIEL</p> <p>CAD FILE: MAIN STREET ENG</p> <p>SHEET 1 OF 1</p> <p>REVISION(S):</p>
-------------	---

NICOLAS DEL VENTO
 PROFESSIONAL SURVEYOR & MAPPER
 STATE OF FLORIDA LIC. # 6945

11. Ocean Drive & 10th Street



MIAMI BEACH

PUBLIC WORKS DEPARTMENT

WASHINGTON AVENUE & 10TH STREET
 INTERACTIVE DIGITAL KIOSK DEPLOYMENT PROJECT
 OCTOBER 2023
 IKE SMART CITY
MIB-005

CITY OF MIAMI BEACH

MAYOR: DAN GELBER


COMMISSIONERS: MICKY STEINBERG
 MARK SAMUELIAN
 MICHAEL GONGORA
 STEVEN MEINER
 RICKEY ARRIOLA
 DAVID RICHARDSON

CITY MANAGER: ALINA T. HUDAK

CITY ATTORNEY: RAFAEL A. PAZ

PUBLIC WORKS DIRECTOR: JOE GOMEZ, P.E., F.FES

CITY ENGINEER: NELSON PEREZ-JACOME, PE

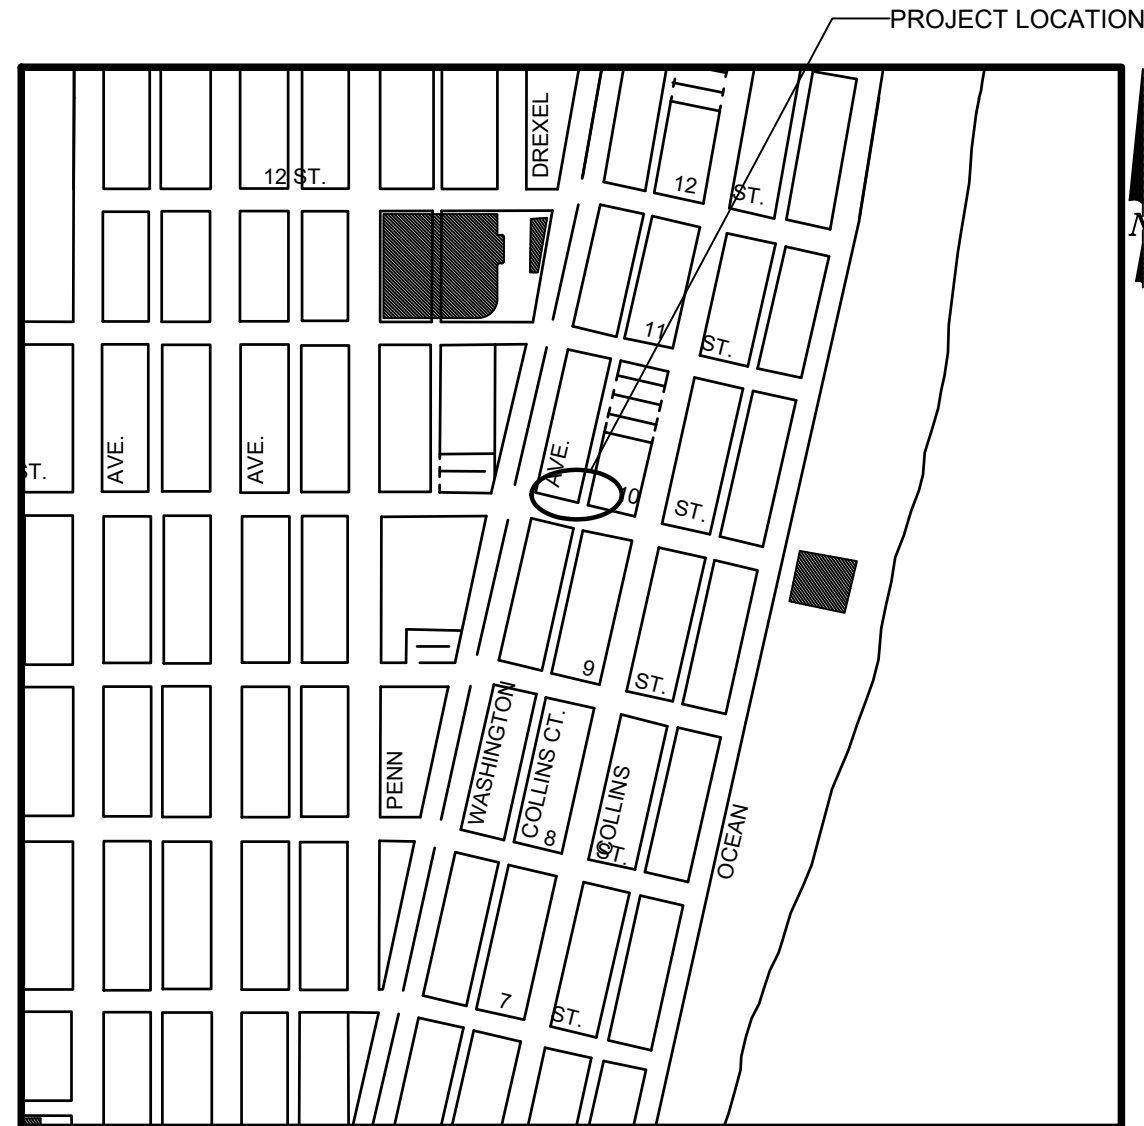

LOCATION MAP



INDEX OF PLANS

NUMBER	DISCIPLINE	SHEET NO.	DESCRIPTION	NOTES
1	GENERAL	G0-03	INDEX OF SHEETS	
2	GENERAL	G0-04	ADA NOTES, SCOPE OF WORK & KIOSK SPECIFICATIONS	
3	CIVIL	C1-01	CIVIL SITE PLAN	
4	CIVIL	C1-02	MIB-005 ENGINEERING PLAN	
5	ELECTRICAL	E1-01	KIOSK MIB-005 ELECTRICAL PLAN	
6	SURVEY		MIB-005 SITE SURVEY	

SCOPE OF WORK: THE PROJECT CONSISTS OF THE INSTALLATION OF ONE (1) DIGITAL INTERACTIVE KIOSK AND APPLICABLE INFRASTRUCTURE; STRUCTURAL FOUNDATION AND ELECTRICAL SERVICE AT THE LOCATION INDICATED ON THESE DESIGN PLANS.


FINAL SUBMITTAL 10/09/2023

Always call 811 two full business days before you dig to have underground utilities located and marked.



INDEX OF PLANS

NUMBER	DISCIPLINE	SHEET NO.	DESCRIPTION	NOTES
1	GENERAL	G0-03	INDEX OF SHEETS	
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6	SURVEY		MIB-005 SITE SURVEY	

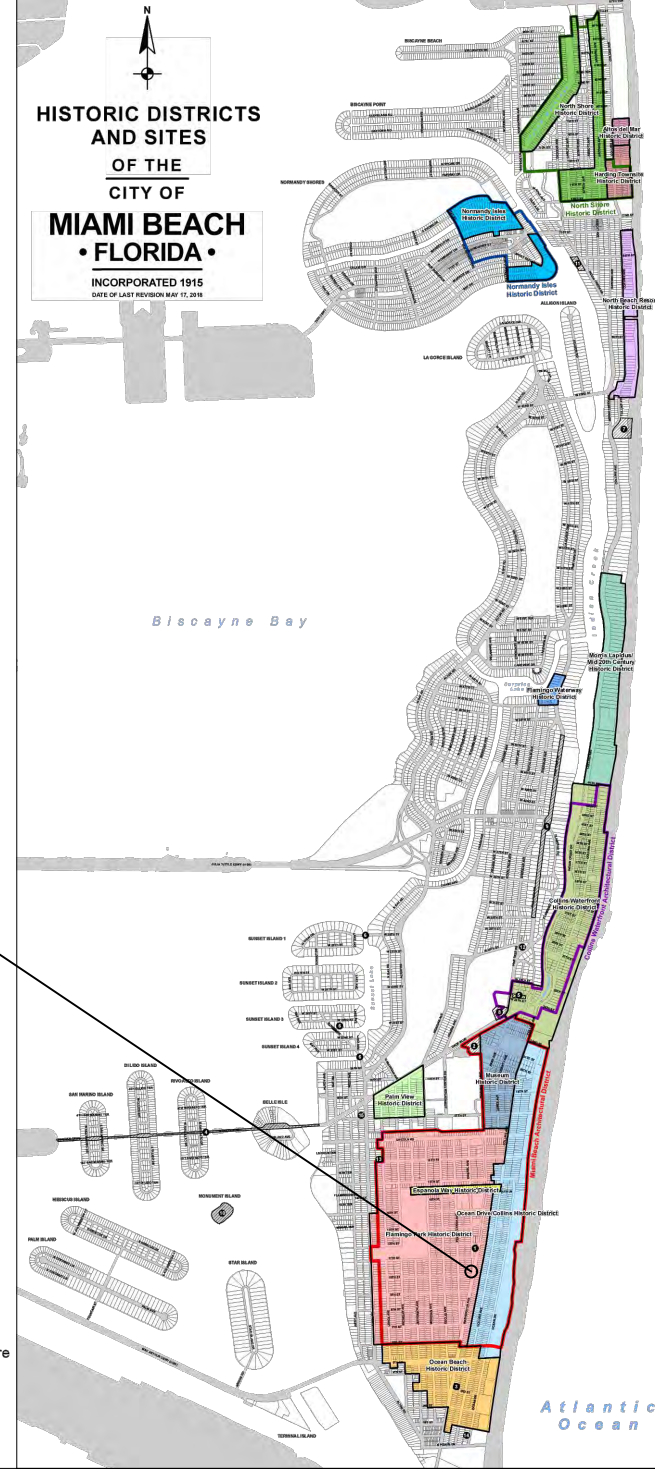


PROJECT LOCATION
FLAMINGO PARK HISTORIC DISTRICT


LEGEND AND ABBREVIATIONS

- = PALM TREE
- = TREE
- = ORNAMENTAL TREE
- O.R.B. = OFFICIAL RECORDS BOOK
- PG. = PAGE
- ELEV. = ELEVATION
- TYP. = TYPICAL
- CATV = CABLE TELEVISION
- OHE = OVERHEAD ELECTRIC LINE
- X 0.00 = SPOT ELEVATION
- CONC. = CONCRETE
- C.B.S. = CONCRETE BLOCK STUCCO
- C.L.F. = CHAIN LINK FENCE
- W.F. = WOOD FENCE
- M.F. = METAL FENCE
- RCP = REINFORCED CONCRETE PIPE
- FF = FINISH FLOOR
- (R) = RECORD
- (C) = CALCULATED
- (M) = MEASURE
- LB = LICENSE BUSINESS
- L = LENGTH
- Δ = CENTRAL ANGLE
- R = RADIUS
- T = TANGENT
- PT = POINT OF TANGENCY
- PC = POINT OF CURVATURE
- STA. = STATION
- PI = POINT OF INTERSECTION
- ID = IDENTIFICATION
- MLP = METAL LIGHT POLE
- CLP = CONCRETE LIGHT POLE
- R/W = RIGHT-OF-WAY
- P.B. = PLAT BOOK
- = SECTION LINE
- = CENTERLINE
- = BASELINE
- = MONUMENT LINE
- = TRAFFIC SIGNAL BOX
- = TRAFFIC SIGNAL CABINET
- = BOLLARD
- = PEDESTRIAN SIGNAL
- = TRAFFIC SIGNAL MAST ARM
- = SIGN
- = CABLE TELEVISION BOX
- = LIGHT POLE
- = ELECTRIC BOX
- = UTILITY POLE
- = ELECTRIC TRANSFORMER
- = GUY ANCHOR
- = ELECTRIC MANHOLE
- = ELECTRIC METER
- = GAS VALVE
- = GAS UTILITY BOX
- = GAS MANHOLE
- = GAS TANK
- = GAS METER
- = COMMUNICATION BOX
- = COMMUNICATION MANHOLE
- = GARBAGE RECEPTACLE
- = HANDICAP PARKING SPACE
- = WATER METER
- = IRRIGATION VALVE
- = WATER VALVE
- = FIRE HYDRANT
- = WATER BOX
- = WATER CONNECTION
- = WATER MANHOLE
- = WATER TANK
- = WATER WELL
- = WATER MARKING FLAG
- = WATER MARKING SIGN
- = STORM MANHOLE
- = STORM METER
- = CATCH BASIN
- = TELEPHONE MANHOLE
- = TELEPHONE BOX
- = NEWSPAPER DISPENSER
- = MAILBOX
- = SANITARY MANHOLE
- = SANITARY BOX
- = SANITARY TANK
- = SANITARY LIFT STATION
- = GREASE TRAP MANHOLE
- = CLEANOUT
- = PARKING METER
- = FIBER OPTIC BOX
- = FIBER OPTIC MARKER SIGN
- = MONITORING WELL
- = FUEL TANK
- = UNKNOWN UTILITY BOX
- = UNKNOWN UTILITY METER
- = UNKNOWN UTILITY MANHOLE
- = UNKNOWN UTILITY VALVE
- = UNKNOWN UTILITY MARKER FLAG
- = SANITARY VALVE
- = RAILROAD SIGN
- = FLAGPOLE
- = PROPERTY LINE
- = ELECTRICAL OUTLET

NOTES:

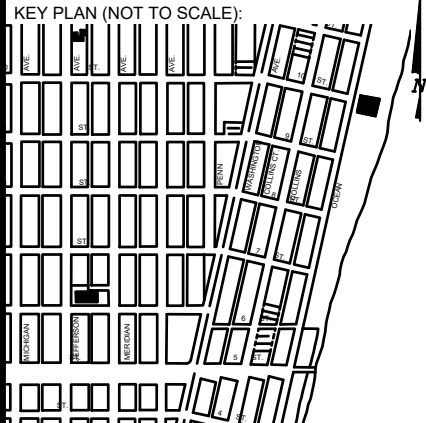

P.E. SEAL:

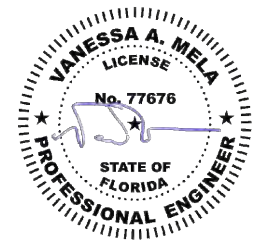

LOCAL HISTORIC DISTRICTS

	Espanola Way Historic District		Palm View Historic District
	Altos del Mar Historic District		Collins Waterfront Historic District
	Flamingo Park Historic District		North Beach Resort Historic District
	Ocean Drive/Collins Avenue Historic District		Flamingo Waterway Historic District
	Museum Historic District		Morris Lapidus/Mid 20th Century Historic District
	Ocean Beach Historic District		North Shore Historic District
	Harding Townsite Historic District		Normandy Isles Historic District

NATIONAL REGISTER HISTORIC DISTRICTS

	Miami Beach Architectural District
	Normandy Isles Historic District
	North Shore Historic District
	Collins Waterfront Architectural District

LOCAL HISTORIC SITES

1	Old City Hall Historic Site	8	Dade Blvd Fire Station Historic Site
2	21st St Recreation Center Historic Site	9	PineTree Dr Historic Roadway
3	Congregation Beth Jacob Historic Site	10	Flagler Memorial and Monument Island Historic Site
4	Venetian Causeway Historic Site	11	69th St Fire Station Historic Site
5	Miami Beach Woman's Club Historic Site	12	28th St Obelisk and Pumping Station Historic Structure
6	Sunset Island Bridges Historic Structures	13	1600 Lenox Ave Historic Site
7	The Bath Club Historic Site	14	36 Ocean Dr Historic Site
		15	1700 Alton Rd Historic Site

PROJECT DIRECTORY:

PROJECT NAME:
INTERACTIVE DIGITAL INFORMATION
KIOSKS DEPLOYMENT PROJECT

JURISDICTION:
CITY OF MIAMI
DEPARTMENT OF RESILIENCE AND
PUBLIC WORKS
MIAMI RIVERSIDE CENTER
444 S.W. 2nd AVENUE, 8th FLOOR
MIAMI, FLORIDA 33130
TEL: 305-416-1200

OWNER:
IKE SMART CITY
250 N HARTOFORD AVE
COLUMBUS, OH 43222
(614) 589-0087

ENGINEER OF RECORD:
MAINSTREET ENGINEERING
7035 SW 47 STREET, SUITE A
MIAMI, FL 33155
(305) 456-3505
PROJ. MGR: VANESSA MELA, P.E.
VMELA@MAINSTREETENG.COM

KIOSK MANUFACTURER:
DISPLAY DEVICE INC.
21075 WESTGATE RD.
GOLDEN, CO 80403
CONTACT: ERIC PERKINS
PHONE: (303) 929-4071

UTILITIES:

ELECTRICAL POWER: FLORIDA
POWER & LIGHT COMPANY (FPL)

WATER & SEWER: MIAMI-DADE
WATER & SEWAGE DEPARTMENT

TELEPHONE: AT&T

CABLE: COMCAST, XFINITY,
ATT-UVERSE

GAS: FLORIDA GAS

SIDEWALK & STREET SYMBOLS

	ASPHALT		BRICK
	PAVER		CONCRETE
	UNIMPROVED		TILE
	GRAVEL		STAMPED CONCRETE

NO.	DATE	REVISION	APP'D. BY
5			
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2			
1			

ADA NOTES

- ALL CONSTRUCTION ACTIVITIES SHALL BE COMPLETED IN FULL COMPLIANCE WITH THE AMERICANS WITH DISABILITIES ACT (ADA). CLEAR SPACES IN FRONT OF KIOSK SHALL HAVE THE FOLLOWING CHARACTERISTICS:
- SURFACES SHALL BE FIRM, STABLE, AND SLIP RESISTANT AND OTHERWISE COMPLY WITH PROWAG SECTION R302.7 AND SHALL HAVE A RUNNING SLOPE CONSISTENT WITH GRADE OF THE ADJACENT PEDESTRIAN ACCESS ROUTE AND CROSS SLOPE OF 1.50% +/-0.50%)
- SIZE: CLEAR SPACES SHALL BE 48" MINIMUM BY 48" MINIMUM.
- POSITION: UNLESS OTHERWISE SPECIFIED, CLEAR SPACES SHALL BE POSITIONED FOR EITHER FORWARD OR PARALLEL APPROACH TO THE KIOSK.
- APPROACH: ONE FULL UNOBSTRUCTED SIDE OF A CLEAR SPACE SHALL ADJOIN A PEDESTRIAN ACCESS ROUTE OR ADJOIN ANOTHER CLEAR SPACE.
- MANEUVERING SPACE: WHERE A CLEAR SPACE IS CONFINED ON ALL OR PART OF THREE SIDES, ADDITIONAL MANEUVERING SPACE SHALL BE PROVIDED AS FOLLOWS:
 - FORWARD APPROACH: THE CLEAR SPACE AND ADDITIONAL MANEUVERING SPACE SHALL BE 36" WIDE MINIMUM WHERE THE DEPTH OF THE CONFINING ELEMENT EXCEEDS 24".
 - PARALLEL APPROACH: THE CLEAR SPACE AND ADDITIONAL MANEUVERING SPACE SHALL BE 60" WIDE MINIMUM WHERE THE DEPTH OF THE CONFINING ELEMENT EXCEEDS 15".
- THE MINIMUM WHEELCHAIR PASSAGE WIDTH OR CLEAR SPACE WIDTH FOR A SINGLE WHEELCHAIR PASSAGE SHALL BE 48" PER PROWAG SECTION R302.3.
- INITIAL OPERATION FOR THE KIOSK WILL HAVE 4G LTE CONNECTION SECTION R404. TO THE INTERNET.
- THE KIOSKS HAVE BEEN DESIGN TO COMPLY WITH ALL ADA GUIDELINES INCLUDING VIEWING, OPERATION, AND ACCESSIBILITY.
- THE MOBILE IKE EXPERIENCE WILL FOLLOW WEB CONTENT ACCESSIBILITY GUIDELINES (WCAG) TO WORK IN TANDEM WITH THE NATIVE ACCESSIBILITY FEATURES ON THE USER'S MOBILE DEVICE, INCLUDING TALKBACK AND VOICEOVER TOOLS.

SCOPE OF WORK

THE PROJECT CONSIST OF THE INSTALLATION OF ONE (1) DIGITAL INTERACTIVE KIOSKS AT THE LOCATION(S) INDICATED ON THIS PLANS SET. INSTALLER SHALL PROVIDE AND INCLUDE ALL WORKMANSHIP AND MATERIALS NECESSARY TO COMPLETE THE INSTALLATION INCLUDING BUT NOT LIMITED TO:


- INSTALLATION OF THE KIOSKS TO THE FOUNDATION AS INDICATED ON PLANS TO NEW RECTANGULAR CONCRETE FOUNDATION.
- ELECTRICAL SERVICE POINTS ARE EXISTING. CONNECT THE EXISTING ELECTRIC SERVICE TO THE NEW KIOSK AS INDICATED ON PLANS.
- TESTING OF THE ELECTRICAL SERVICE INFRASTRUCTURE SHALL BE PERFORMED IN CONJUNCTION WITH A REPRESENTATIVE OF THE ENGINEER OF RECORD.
- THE CONTRACTOR SHALL INSTALL THE KIOSK IN SUCH A WAY THAT THE KIOSK IS WITHIN THE PUBLIC R.O.W. AND IN COMPLIANCE WITH ALL APPLICABLE A.D.A. REQUIREMENTS
- THE LOCATION OF KIOSKS HAS BEEN COORDINATE TO ENSURE THERE IS NO OBSTRUCTION OF THE SIGHT OF VEHICULAR SIGNS.
- STAND-ALONE PEDESTRIAN KIOSKS SHOULD NOT BE INSTALLED WITHIN PEDESTRIAN CIRCULATION PATHS IN A MANNER THAT PERSONS AT THE KIOSK LOCK THE EFFECTIVE WIDTH OF THE PEDESTRIAN TRAVEL WAY.

MONUMENT SIGN SPECIFICATIONS AND FUNCTIONS


THE UNIT CONSISTS OF A UL/NRTL LISTED WEATHER AND VANDAL RESISTANT FREE STANDING ENCLOSURE DESIGNED TO COMPLY WITH THE FLORIDA BUILDING CODE AND OTHER APPLICABLE CODES INCLUDING THE NATIONAL ELECTRICAL CODE. THE UNIT HAS BEEN DESIGNED TO WITHSTAND WINDS OF 165 MPH. THE UNIT'S MAIN COMPONENTS ARE:

- TWO (2) INTERACTIVE 65" VIDEO TOUCH SCREENS.
- TWO (2) CAMERAS
- ONE (1) CPU
- ONE (1) WI-FI TRANSMITTER

MANUFACTURER: DYNASCAN MODEL NUMBER: CIO651DR5
 NATIVE RESOLUTION: 1920 X 1080
 ELECTRICAL POWER REQUIREMENT:
 1. ONE-2-POLE, 20 AMP, 240 VOLTS CIRCUIT.
 2. TOTAL LOAD: 1400/2200 WATTS (OPERATIONAL/PEAK)
 3. VOLTAGE: 100-240 VOLTS AC, 50-60 HZ
 WEIGHT: 832 LBS
 CERTIFICATION CE / FCC / RoHS

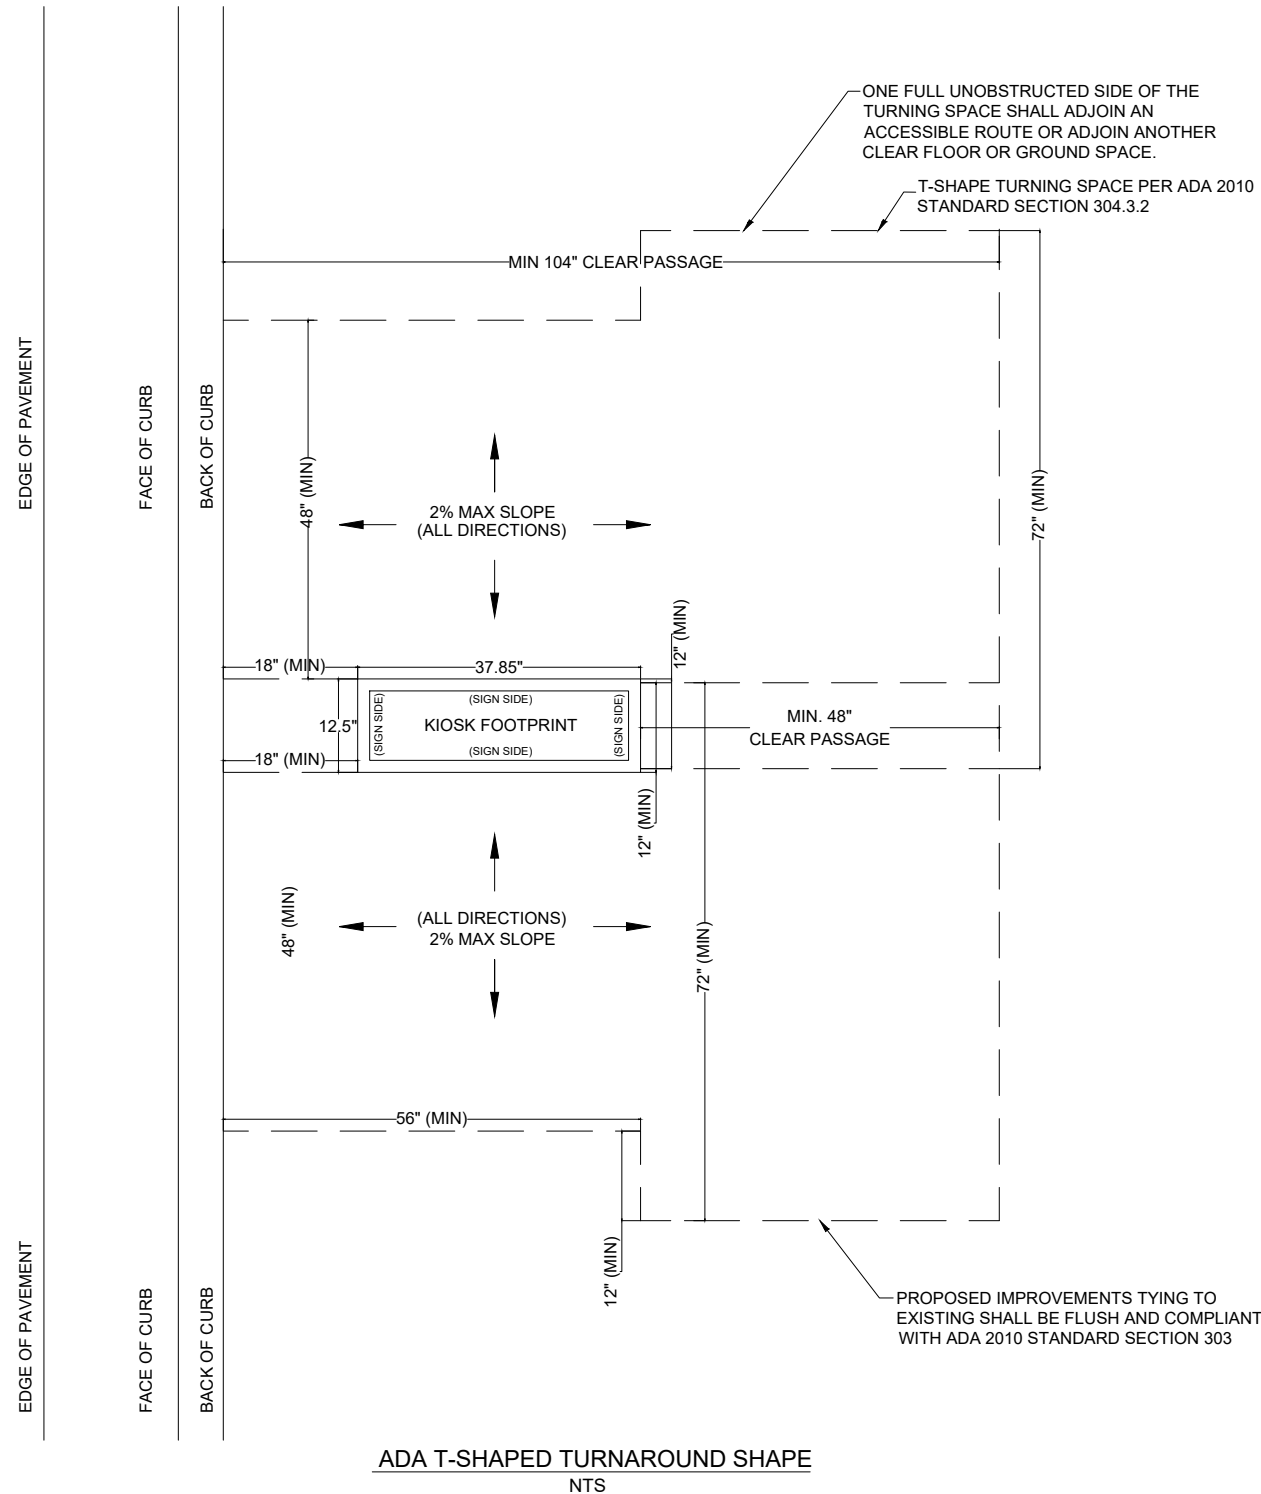

NOTES:

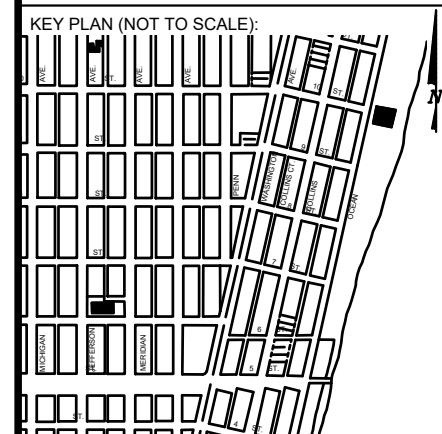

P.E. SEAL:

MIAMI BEACH
 PUBLIC WORKS DEPARTMENT
 1700 CONVENTION CENTER DRIVE, MIAMI BEACH, FL 33139

CITY MANAGER: ALINA T. HUDAK
 DIRECTOR: JOE GOMEZ, P.E.
 CITY ENGINEER: CRISTINA ORTEGA CASTINEIRAS, P.E.

NO.	DATE	REVISION	APP'D. BY
5			
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1			


7055 SW 47th Street, Ste A, Miami, FL 33155
 Tel: (305) 496-3055 Fax: (305) 476-8894
 FL PE Certificate No: 00008751

ENGINEER OF RECORD:
 VANESSA A. MELA,
 P.E. NO. 77676


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 DESIGN ENGINEER: VM
 DRAWN BY: KM
 CHECKER: WP
 SCALE:


NEIGHBORHOOD:
MIB-005: WASHINGTON AVE & 10TH STREET
 TITLE:
ADA NOTES, SCOPE OF WORK & KIOSK SPECIFICATIONS

File Name: MIB-005-GENERAL AND FOUNDATION.dwg
 Survey Reference:
 Field Book: N/A Page: N/A Work Order: N/A
 Date: 10/09/2023 Sheet: 2 of 6 Drawing: G0-04

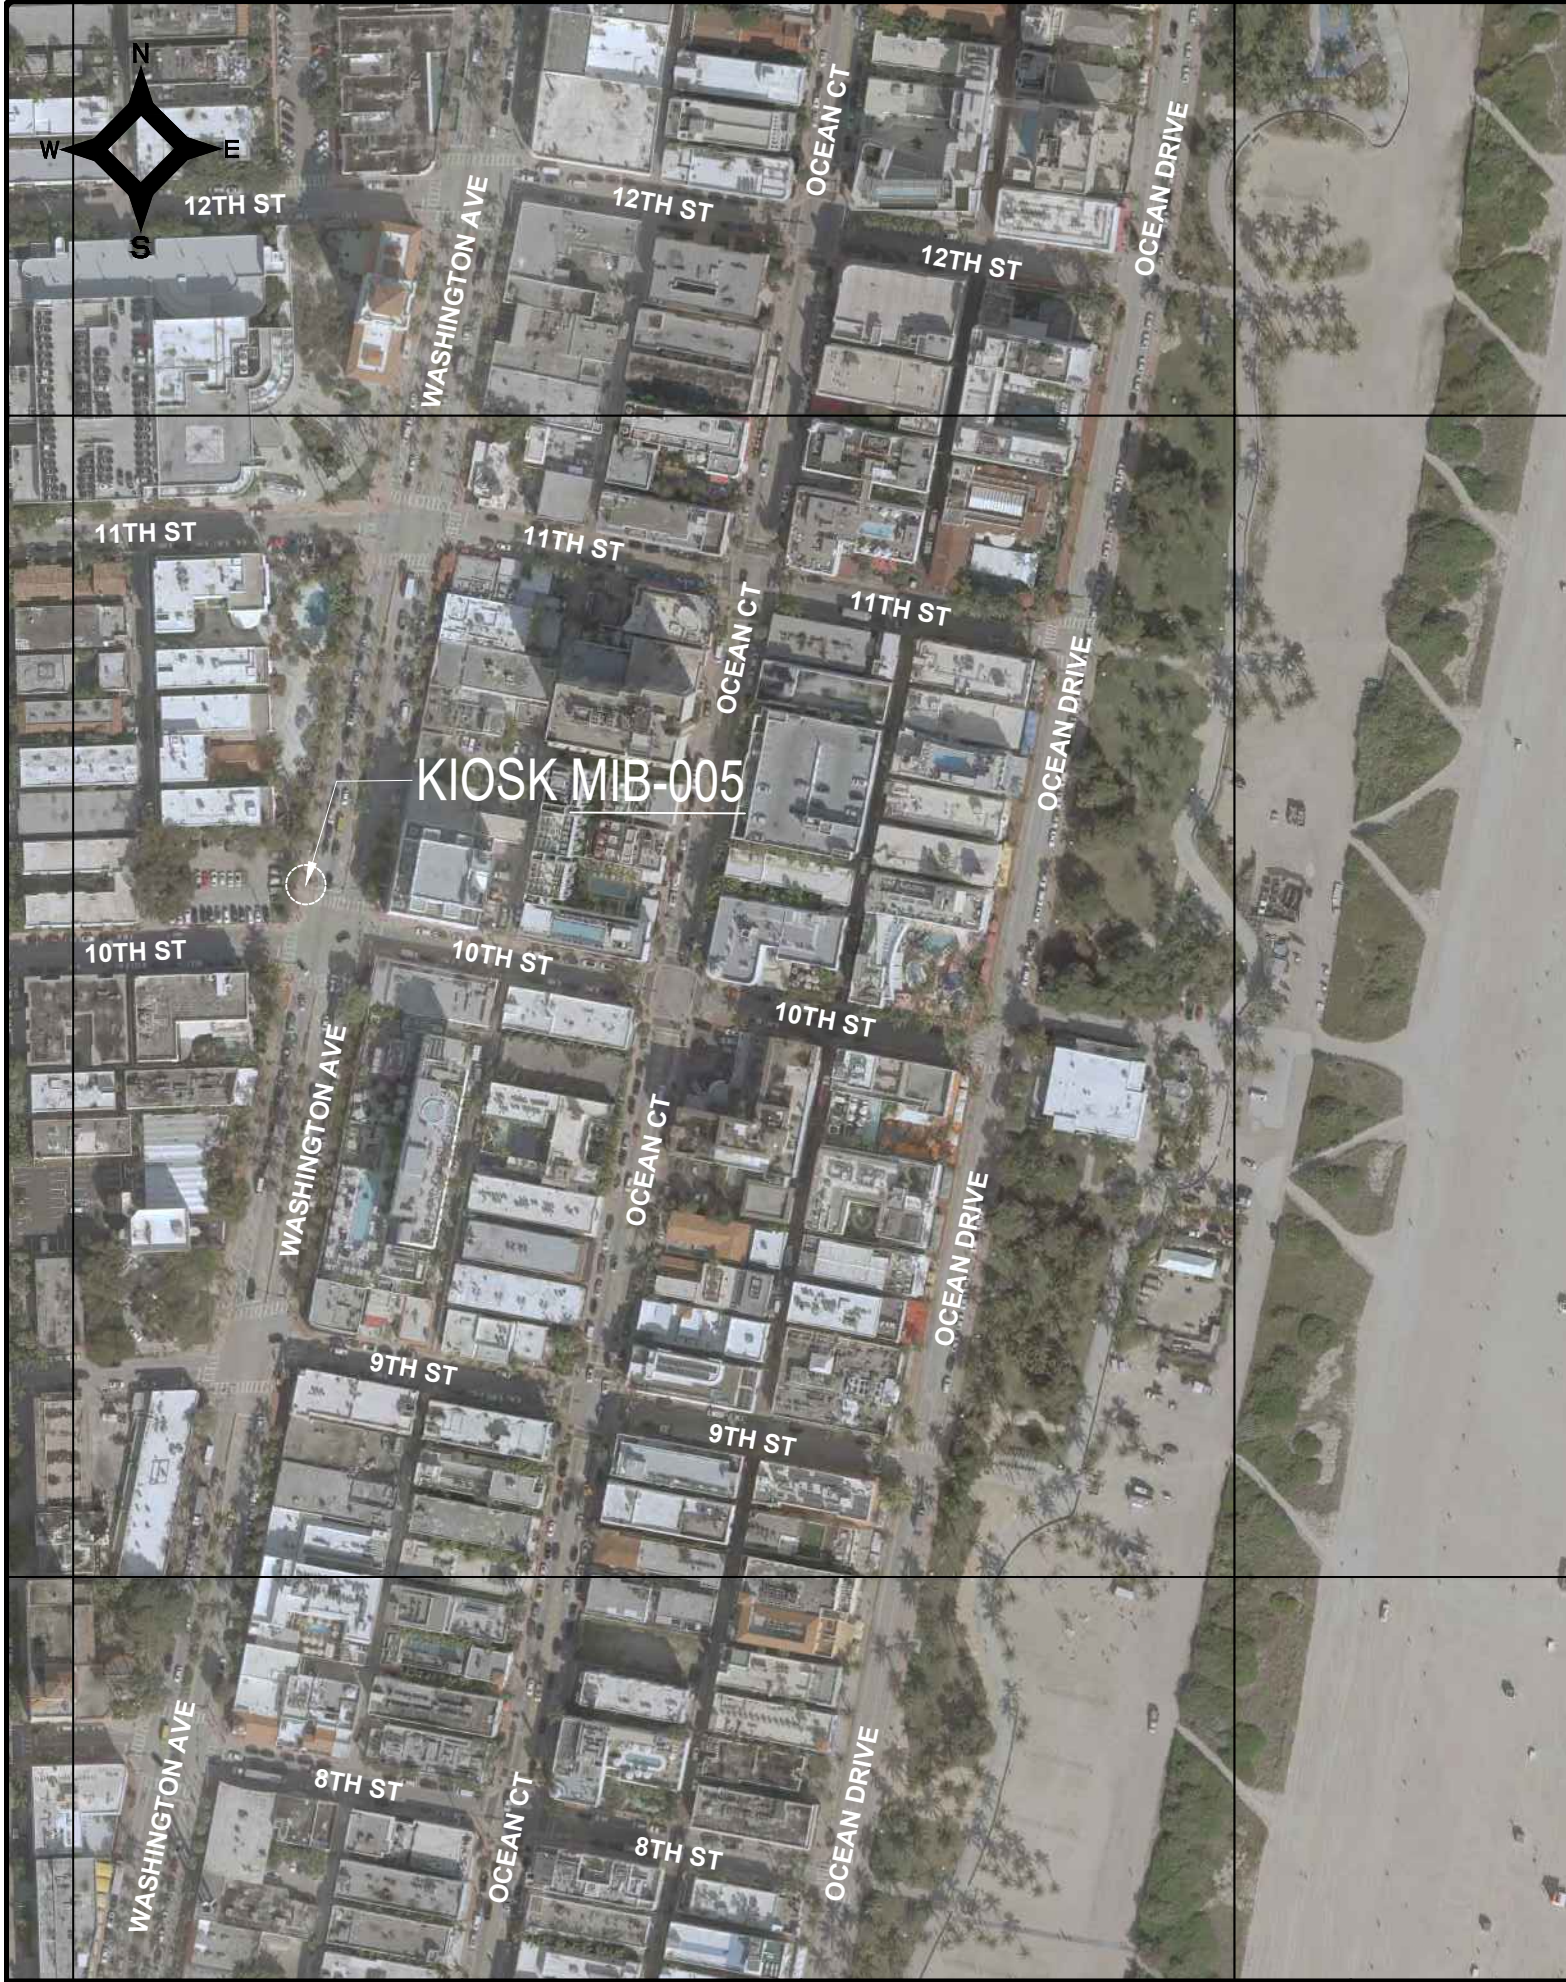


LEGEND

 AREA WHERE NO STRUCTURE OR PLANTING WHICH OBSTRUCTS TRAFFIC VISIBILITY BETWEEN THE HEIGHT OF TWO FEET AND TEN FEET ABOVE THE STREET CORNER GRADE IS ALLOWED. REFER TO CITY OF MIAMI BEACH CODE OF ORDINANCES SECTION 142-1135


 NO PLANTING OR STRUCTURE PERMITTED WITHIN THESE LIMITS WHICH OBSTRUCTS TRAFFIC VISIBILITY.

E.P. EDGE OF PAVEMENT

R/W RIGHT OF WAY

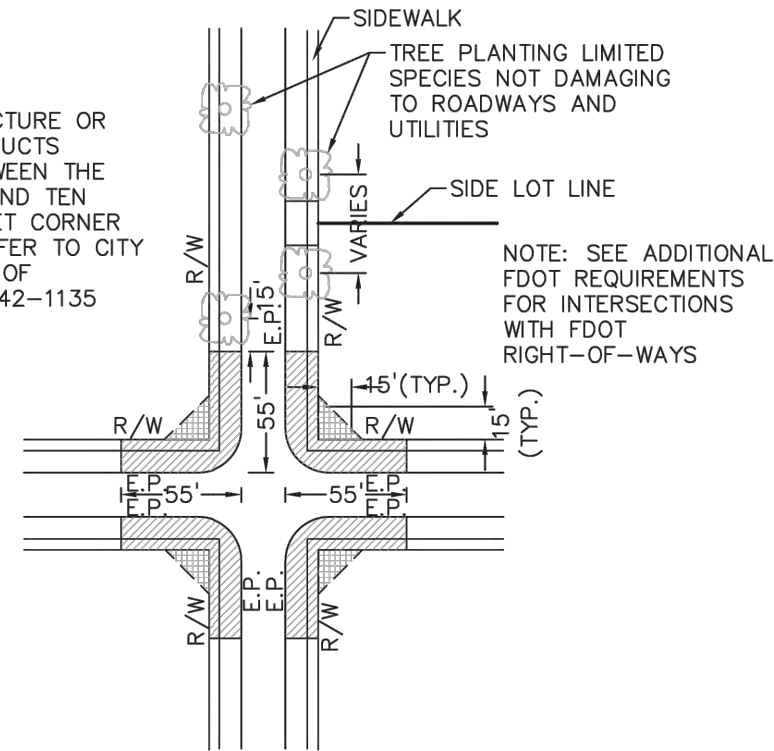

PLAN VIEW
N.T.S.

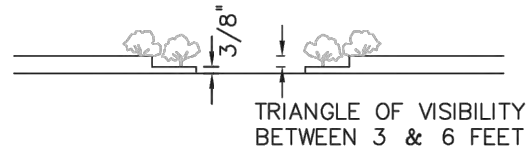

ELEVATION VIEW
N.T.S.

NOTES:

1. AT INTERSECTIONS WITH ALL-WAY STOP CONTROL, THE FIRST STOPPED VEHICLE ON ONE APPROACH SHOULD BE VISIBLE TO THE DRIVERS OF THE FIRST STOPPED VEHICLES ON EACH OF THE OTHER APPROACHES. THERE ARE NO OTHER SIGHT DISTANCE CRITERIA APPLICABLE TO INTERSECTIONS WITH ALL-WAY STOP CONTROL AND, INDEED, ALL-WAY CONTROL MAY BE THE BEST OPTION AT A LIMITED NUMBER OF INTERSECTIONS WHERE SIGHT DISTANCE FOR OTHER CONTROL TYPES CANNOT BE ATTAINED.
2. FOR TWO-WAY STOP INTERSECTIONS, SIGHT DISTANCE CRITERIA FOR STOP CONTROLLED INTERSECTIONS ARE LONGER THAN STOPPING SIGHT DISTANCE TO ENSURE THAT THE INTERSECTION OPERATES SMOOTHLY. MINOR-ROAD VEHICLE OPERATORS CAN WAIT UNTIL THEY CAN PROCEED SAFELY WITHOUT A MAJOR-ROAD VEHICLE TO STOP.

MIAMI BEACH
PUBLIC WORKS DEPARTMENT
1700 CONVENTION CENTER DRIVE, MIAMI BEACH, FL 33139

APPROVED

REVISED
07/2020
09/2020

TITLE:
SIGHT RESTRICTIONS AT INTERSECTIONS
WITH NO DEDICATED RADII


DETAIL
10-26

SIGHT TRIANGLE CLEARANCE




Call 811 or visit sunshine811.com two full business days before digging to have buried facilities located and marked.
Check positive response codes before you dig!

KEY PLAN (NOT TO SCALE):

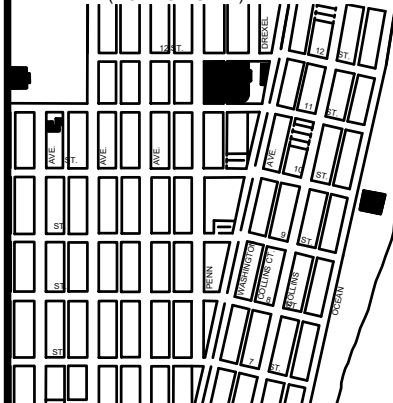

P.E. SEAL:

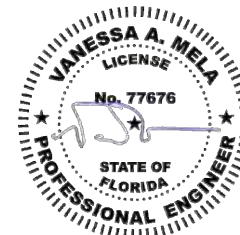

MIAMI BEACH
PUBLIC WORKS DEPARTMENT
1700 CONVENTION CENTER DRIVE, MIAMI BEACH, FL 33139

CITY MANAGER: ALINA T. HUDAK
DIRECTOR: JOE GOMEZ, P.E.
CITY ENGINEER: CRISTINA ORTEGA CASTINEIRAS, P.E.

5			
4			
3			
2			
1			
NO.	DATE	REVISION	APP'D. BY



ENGINEER OF RECORD:
VANESSA A. MELA,
P.E. NO. 77676

ENGINEER OF RECORD: VM
DESIGN ENGINEER: VM
DRAWN BY: KM
CHECKER: WP
SCALE:

NEIGHBORHOOD:
MIB-005: WASHINGTON AVE & 10TH STREET

TITLE:
CIVIL SITE PLAN

File Name: MIB-005-CIVIL PLANS.dwg



Survey Reference:

Field Book: N/A Page: N/A Work Order: N/A



Date: 10/09/2023 Sheet: 3 of 6 Drawing: C1-01




NOTES:

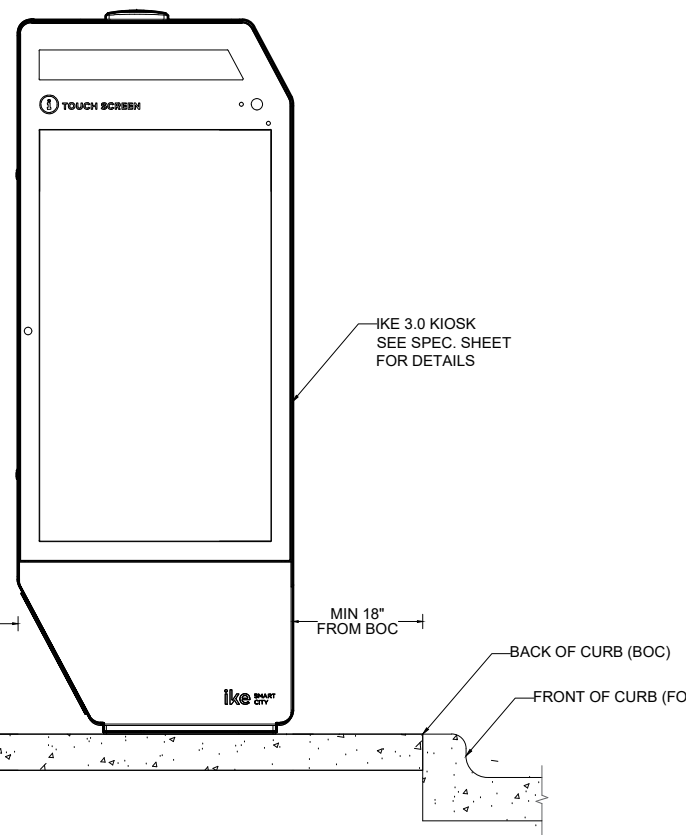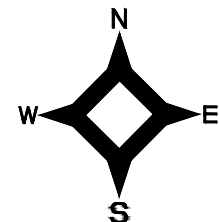

VISIBILITY TRIANGLE CLEARANCE ANALYSIS
SCALE: 1'-10"

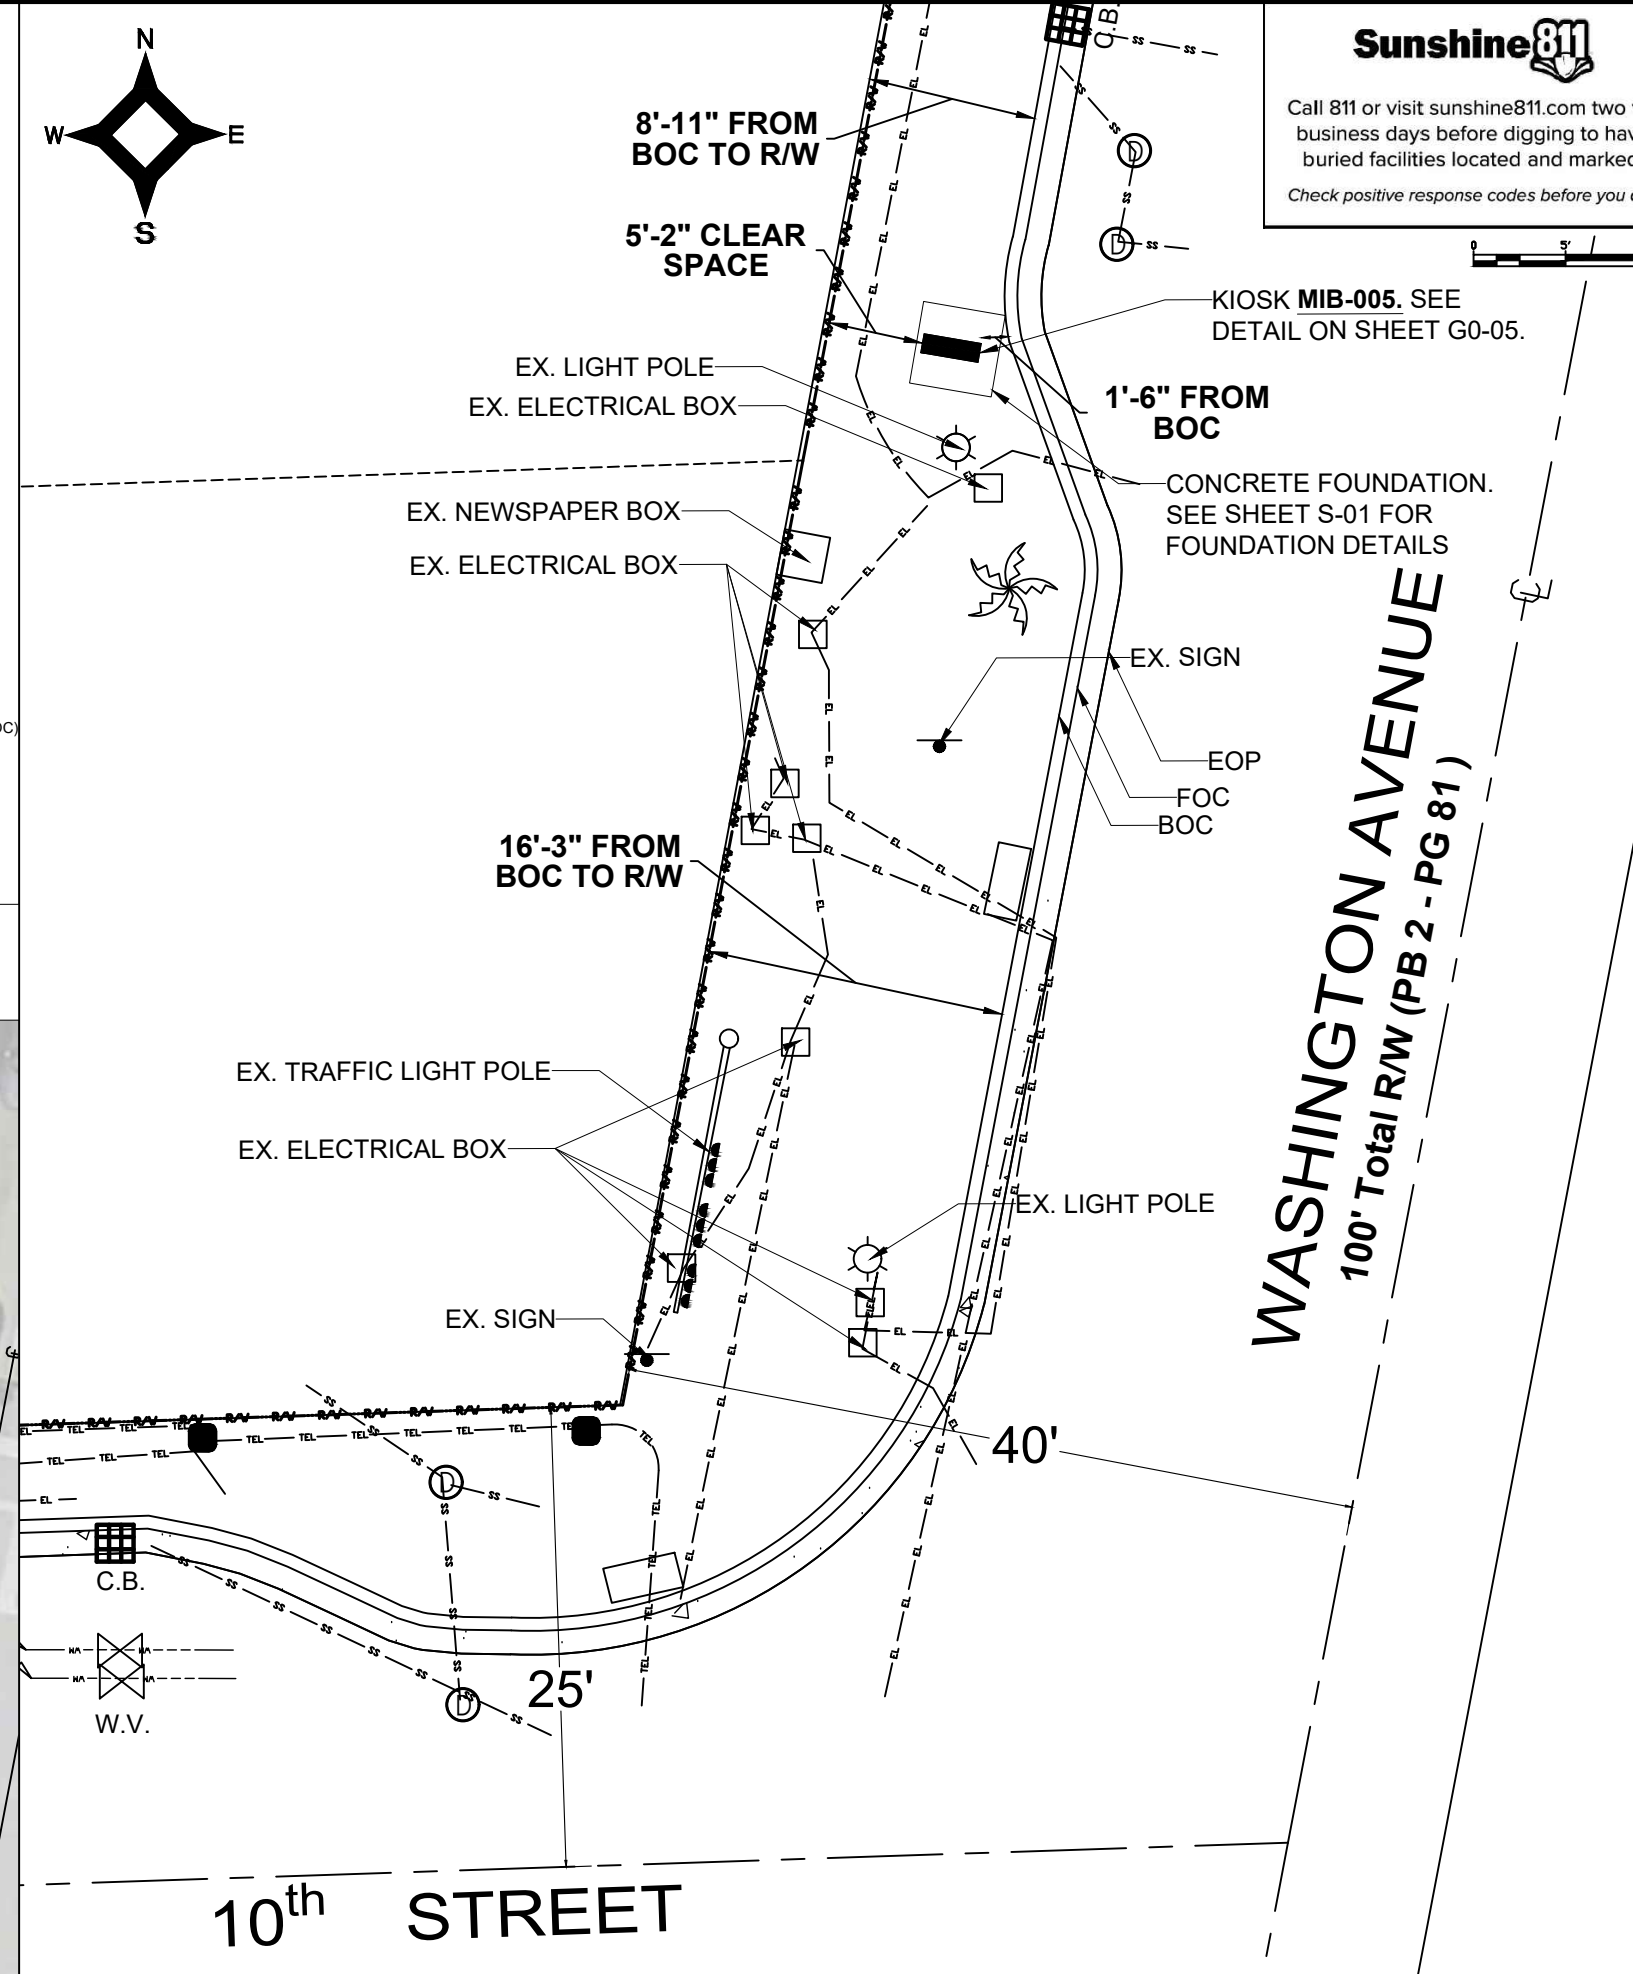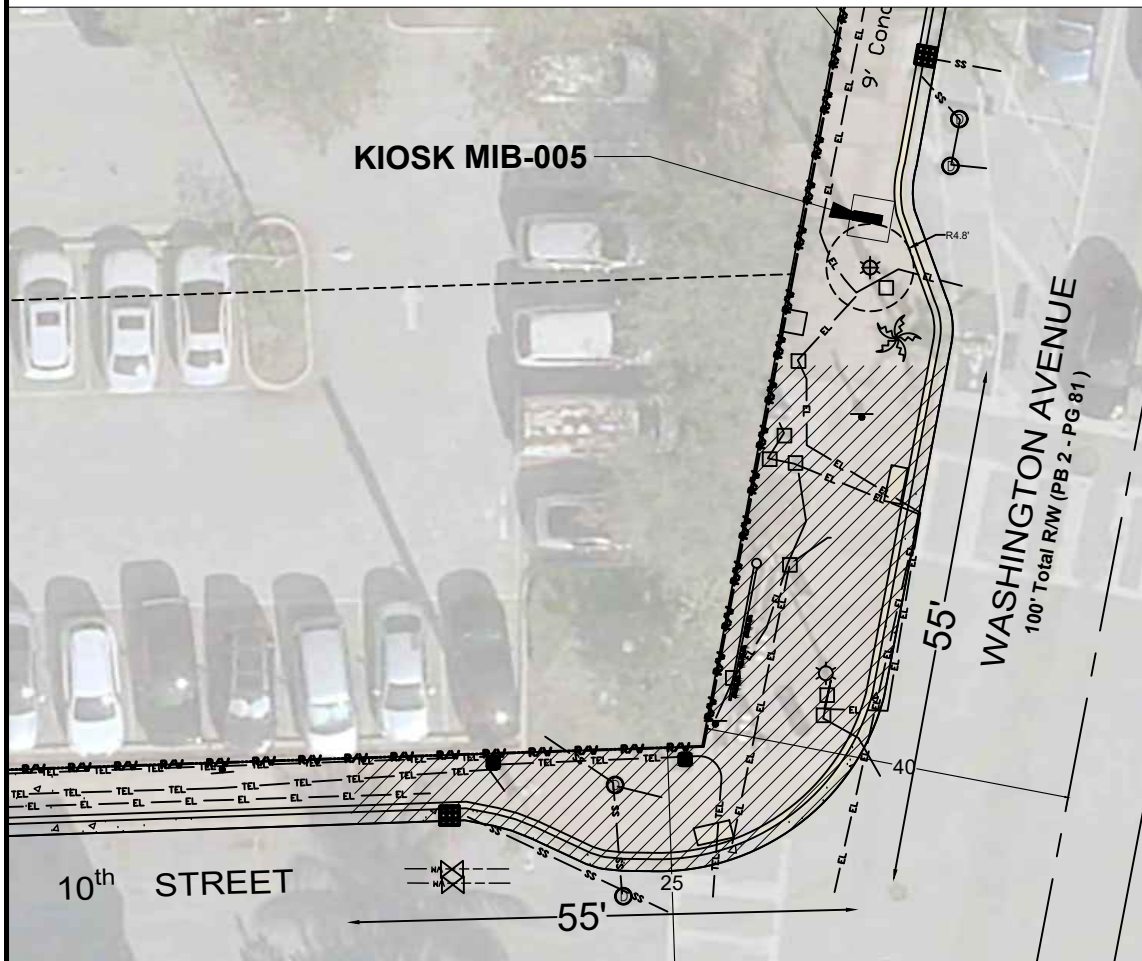

WASHINGTON AVENUE
100' Total R/W (PB 2 - PG 81)


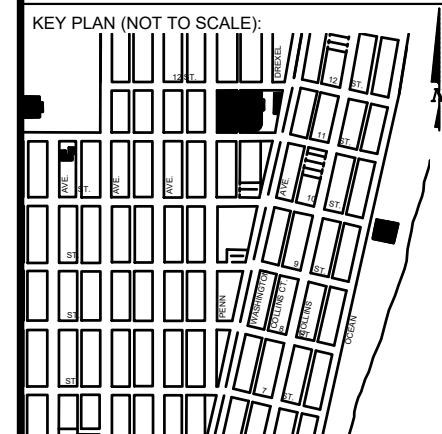


P.E. SEAL:


5			
4			
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NO.	DATE	REVISION	APP'D. BY

MAP OF TOPOGRAPHIC SURVEY

PORTION OF LANDS LYING IN SECTIONS 3, TOWNSHIP 54 SOUTH,
RANGE 42 EAST, CITY OF MIAMI, MIAMI-DADE COUNTY, FLORIDA.

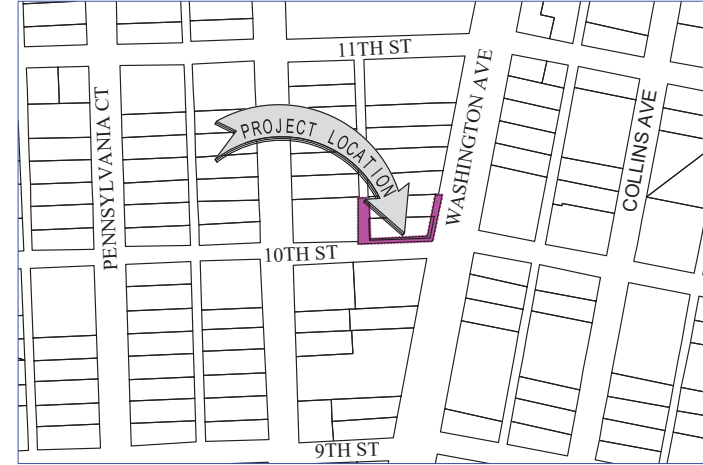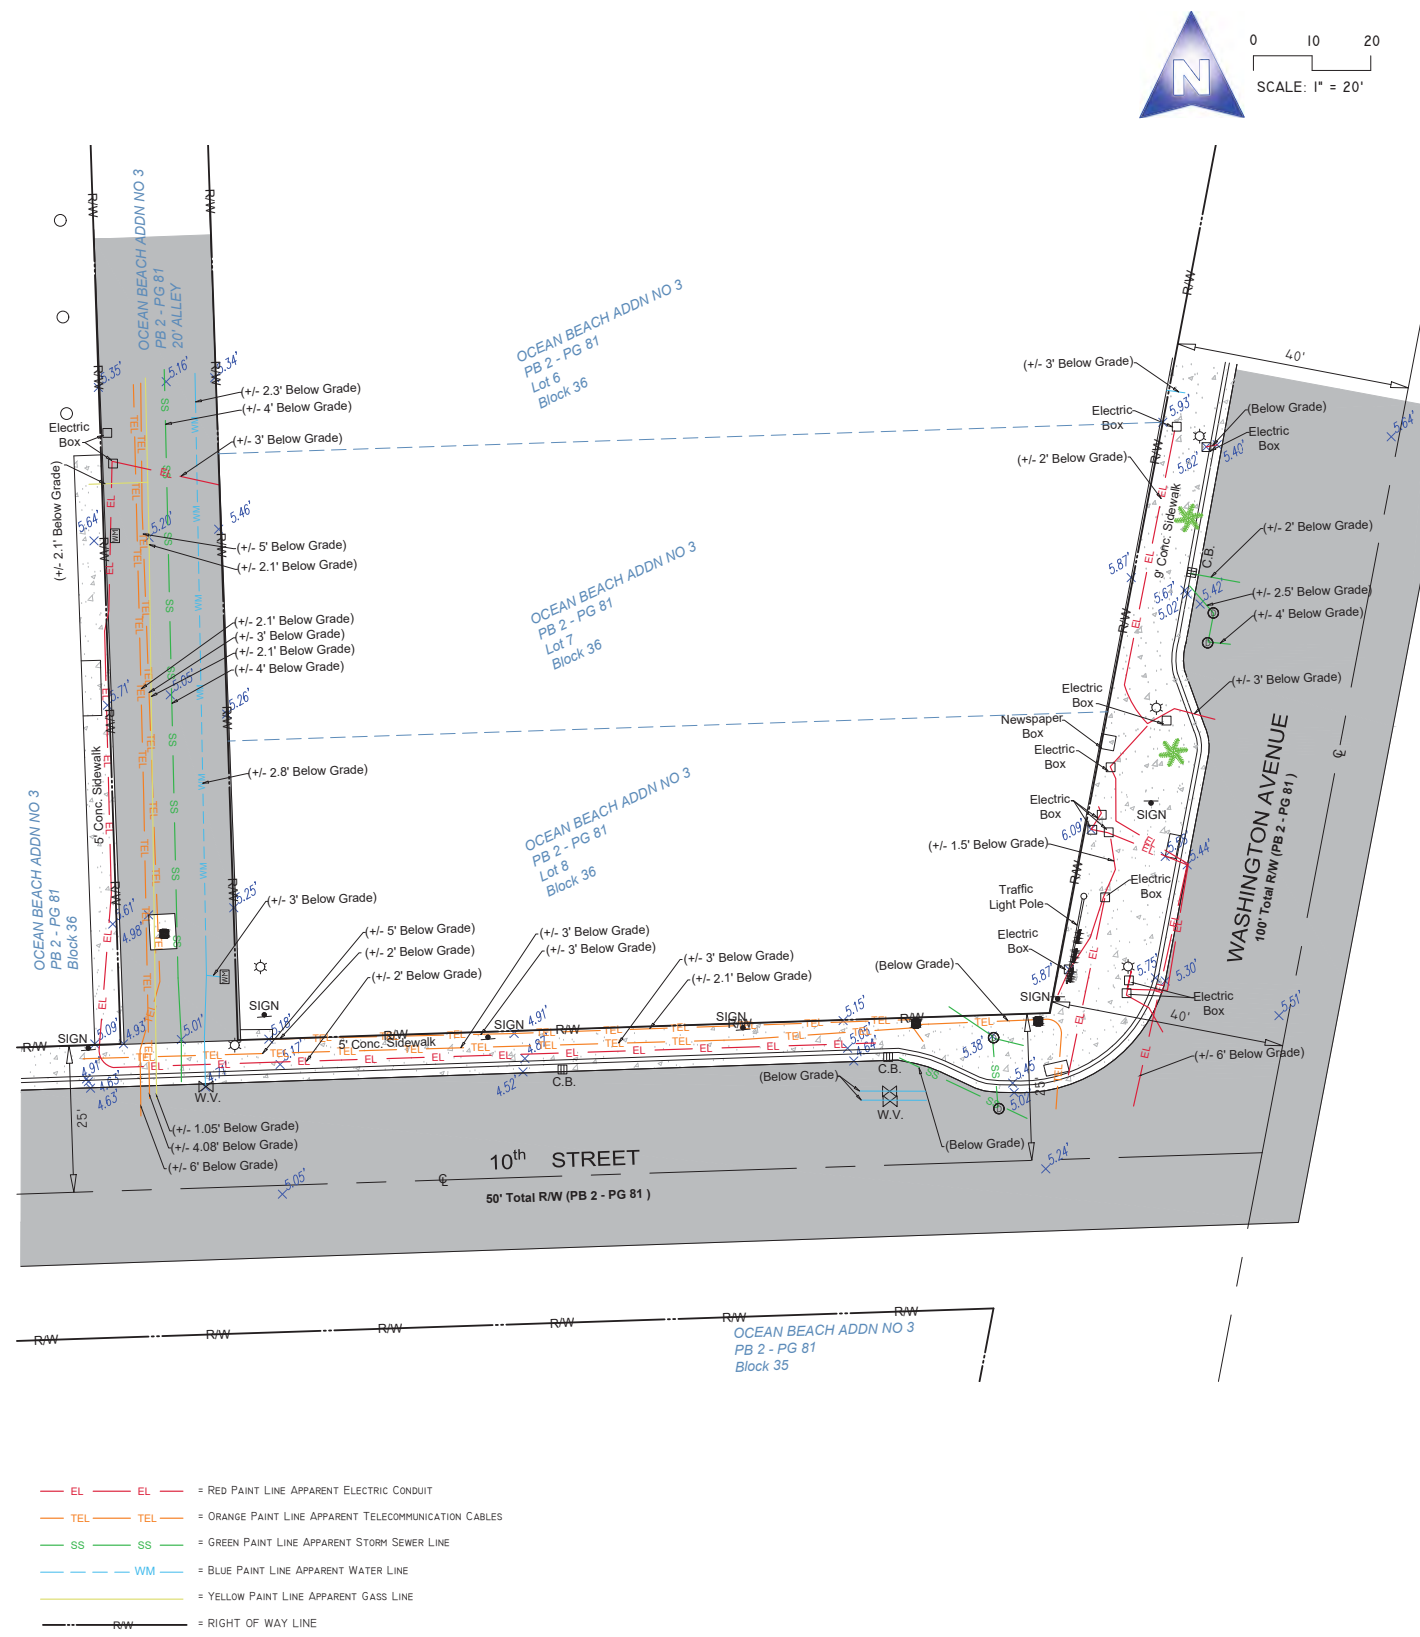

LOCATION MAP
Not to Scale

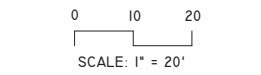

LEGEND & ABBREVIATIONS

	= CONCRETE (CONC.)
	= CONCRETE BLOCK WALL
	= WOOD DECK
	= COVERED AREA
	= ASPHALT
	= TILE
	= PAVERS
	= STONE
	= CHAIN LINK FENCE (CLF)
	= WOOD FENCE (WF)
	= IRON METAL BARS FENCE (IF)
	= OVERHEAD WIRES
	= WATER VALVE (WV)
	= POWER POLE (PP)
	= GUY ANCHOR
	= WATER METER (WM)
	= CONC. LIGHT POLE (LP)
	= WELL
	= STREET SIGN
	= SANITARY MANHOLE
	= DRAINAGE MANHOLE
	= MANHOLE
	= FIRE HYDRANT
	= CABLE BOX (CATV)
	= FPL TRANSFORMER
	= CATCH BASIN OR INLET
	= EXISTING ELEVATION
	= PERMANENT REFERENCE MONUMENT (PRM)
	= PROPERTY CORNER
	= PERMANENT CONTROL POINT (PCP)
	= POINT OF TANGENCY
	= POINT OF CURVATURE
	= POINT OF COMPOUND CURVE
	= POINT OF REVERSE CURVE
	= BENCH MARK
	= BEARING REFERENCE
	= TEMPORARY BENCH MARK
	= PROPERTY LINE
	= CENTER LINE
	= MONUMENT LINE
	= BASE LINE
	= FIELD MEASURED
	= PER FLAT
	= PROFESSIONAL SURVEYOR AND MAPPER
	= AIR CONDITIONER PAD
	= ENCROACHMENT
	= FINISHED FLOOR ELEVATION
	= DENOTES PLAT BOOK XX - PAGE XX
	= OFFICIAL RECORD BOOK
	= CONCRETE BLOCK STRUCTURE
	= RIGHT OF WAY
	= ELEVATION
	= SECTION
	= TOWNSHIP
	= RANGE
	= CALCULATED
	= RECORD
	= CITY OF MIAMI MUNICIPAL ATLAS X-X

SURVEYOR'S REPORT AND GENERAL NOTES
(Not valid without the attached Survey Map)

- This is not a Boundary Survey. This is a Topographic survey of a portion of public right of ways. The underlying subdivisions as depicted on the survey is the following:
Plat of **OCEAN BEACH ADDITION No. 3**, according to the plat thereof, as recorded in Plat Book 2, Page 81 of the Public Records of Miami-Dade County, Florida. These lands are subject to restrictions of record that were not furnished to the undersigning registered surveyor. A title search has not been performed by the surveyor.
- North arrow direction is based on an assumed Meridian. Bearings are based on an assumed meridian on a well-established line, said line is being noted as BR on the Survey Map.
- Foundations and/or any other underground structures have not been located.
- Survey markers found in the field have no identification unless otherwise shown. Any survey marker set by our company is labeled LB 7262 or PSM 6169.
- This Survey Map is intended to be displayed at the scale shown hereon. Data is expressed in U.S. Survey Foot.
- This Survey Map is being prepared for the use of the party/parties that it is certified to and does not extend to any unnamed individual, entity or assignee.
- FLOODPLAIN INFORMATION:** As scaled from Federal Insurance Rate Map (FIRM) of Community No. 120651 (City of Miami Beach), Panel 0314, Suffix L, revised on Sept 11th, 2009, this real property falls in Zone "AE" with Base Flood Elevation 8 feet (NGVD 1929)
- SUBSURFACE UTILITY ENGINEERING (SUE) QUALITY LEVEL B** for investigation of underground utilities was performed as part of this survey using GPR (Ground Penetrating Radar) and RD (Radiodetection Technology) for designation and location of underground facilities. This Survey depicts apparent location of underground piping and conduits found during this investigation, and located as accurately as possible, based on best interpretation of signals received and combining it with utility evidences. Horizontal location of utilities is subject to a horizontal clearance of 3 (three) feet, plus or minus. Softdigs/excavation was not performed as part of this locating effort. There might be additional underground facilities not discovered at the time of this survey. AS-Builts of underground utilities were not furnished to this surveyor. This surveyor can't certify if the lines located are actively in service or not. This firm recommends that underground utilities be verified by electromagnetic technology and/or excavation prior to any construction work.
- HORIZONTAL ACCURACY:** Accuracy obtained thru measurements and calculations meets and exceeds the minimum horizontal feature accuracy for a Suburban area being equal to 1 foot in 7, 500 feet.
- VERTICAL CONTROL AND ACCURACY:** The elevations as shown are referred to the National Geodetic Vertical Datum of 1929 (NGVD 1929). The closure in feet, as computed, meets the standard of plus or minus 0.05 feet times the squared root of the loop distance in miles. Elevation are based on a level loop from and to the following official Bench Marks:
Bench Mark # 1: Miami-Dade County Public Works Department Bench Mark X-310-R, Elevation = 8.12 feet (NGVD29), Elevation = 6.57 feet (NAVD88)
Bench Mark # 2: Miami-Dade County Public Works Department Bench Mark W-310, Elevation = 5.47 feet (NGVD29), Elevation = 3.91ft (NAVD88)

I hereby certify to Main Street Engineering that this Survey conforms to the Standards of Practice as set forth by the Florida Board of Professional Surveyors and Mappers in applicable provisions of Chapter 5J-17, Florida Administrative Code pursuant to Section 472.027 Florida Statutes. This Survey is accurate and correct to the best of my knowledge and belief.

Odalys C Bello
c=US, o=Bello and Bello Land
Surveying Corp.,
dnQualifier=A01410D00000180
BDD60853000C0823,
cn=Odalys C Bello
2023.05.12 09:51:58 -04'00'

Odalys C. Bello-Iznaga
Professional Surveyor and Mapper LS6169 - State of Florida
Field Work Date: 05/05/2023

Property Address: (Reference)
1001 Pennsylvania Avenue, Miami Beach, Florida 33139
Project No. 22986 D.B.: UR Page 1 of 1

BELLO & BELLO LAND SURVEYING
12230 SW 131 AVENUE • SUITE 201 • MIAMI FL 33186
Phone: 305.251.9606 • Fax: 305.251.6057 • LB#7262
e-mail: info@belloland.com • www.bellolandsurveying.com



12. Washington Ave & 10th Street



APPROXIMATE LOCATION

MIAMI BEACH

PUBLIC WORKS DEPARTMENT

5th STREET & OCEAN DR
 INTERACTIVE DIGITAL KIOSK DEPLOYMENT PROJECT
 OCTOBER 2023
 IKE SMART CITY
MIB-006

CITY OF MIAMI BEACH

MAYOR: DAN GELBER


COMMISSIONERS: MICKY STEINBERG
 MARK SAMUELIAN
 MICHAEL GONGORA
 STEVEN MEINER
 RICKEY ARRIOLA
 DAVID RICHARDSON

CITY MANAGER: ALINA T. HUDAK

CITY ATTORNEY: RAFAEL A. PAZ

PUBLIC WORKS DIRECTOR: JOE GOMEZ, P.E., F.FES

CITY ENGINEER: NELSON PEREZ-JACOME, PE

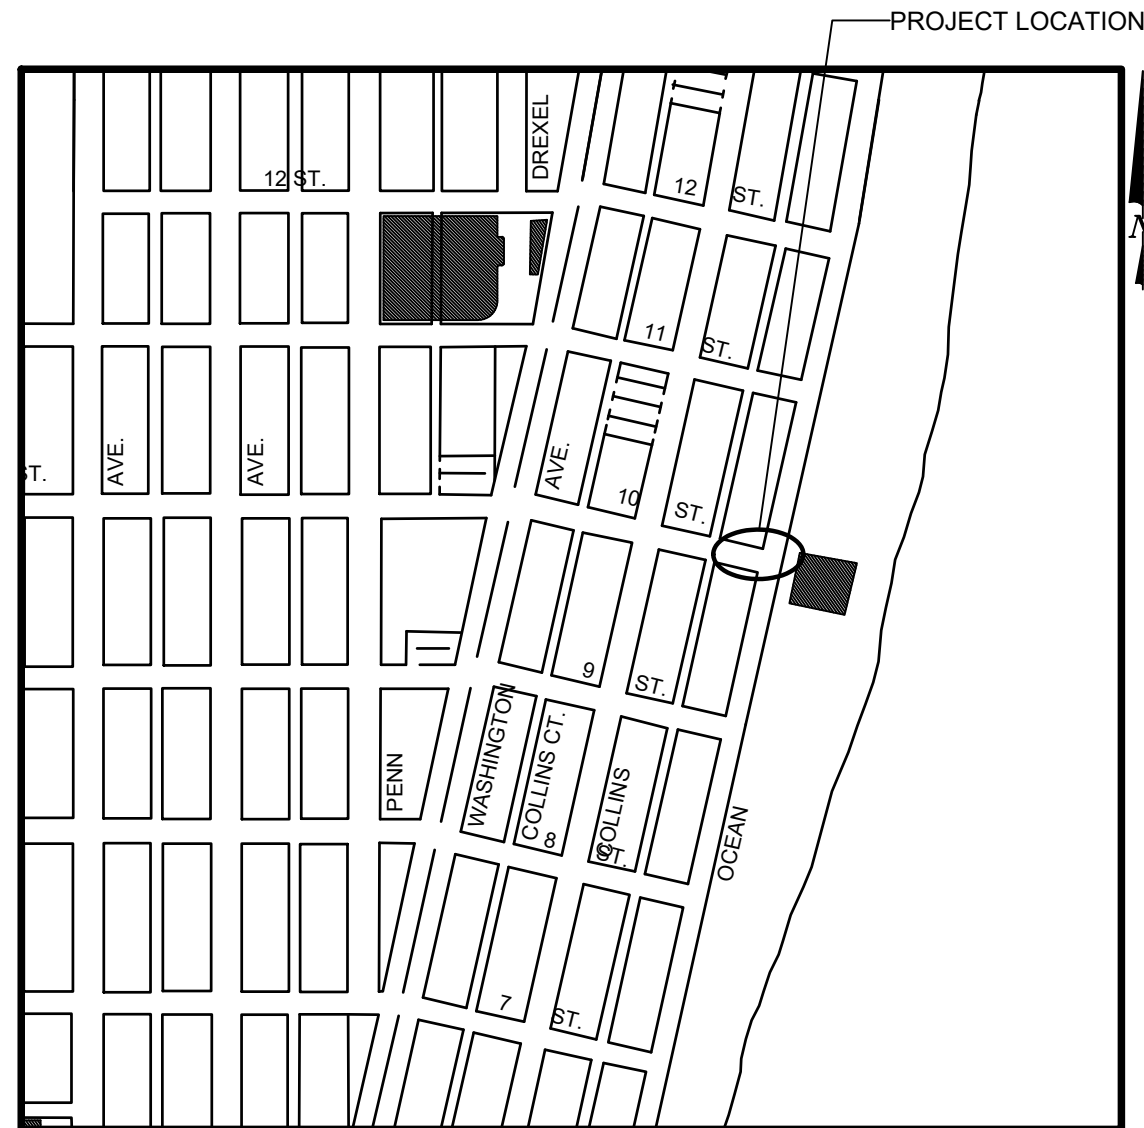

INDEX OF PLANS

NUMBER	DISCIPLINE	SHEET NO.	DESCRIPTION	NOTES
1	GENERAL	G0-03	INDEX OF SHEETS	
2	GENERAL	G0-04	ADA NOTES, SCOPE OF WORK & KIOSK SPECIFICATIONS	
3	CIVIL	C1-01	CIVIL SITE PLAN	
4	CIVIL	C1-02	KIOSK MIB-006 ENGINEERING PLAN	
5	ELECTRICAL	E1-01	KIOSK MIB-006 ELECTRICAL PLAN	
6	SURVEY		KIOSK MIB-006 SITE SURVEY	

SCOPE OF WORK: THE PROJECT CONSISTS OF THE INSTALLATION OF ONE (1) DIGITAL INTERACTIVE KIOSK AND APPLICABLE INFRASTRUCTURE; STRUCTURAL FOUNDATION AND ELECTRICAL SERVICE AT THE LOCATION INDICATED ON THESE DESIGN PLANS.

FINAL SUBMITTAL 10/09/2023


Always call 811 two full business days before you dig to have underground utilities located and marked.



LOCATION MAP

INDEX OF PLANS

NUMBER	DISCIPLINE	SHEET NO.	DESCRIPTION	NOTES
1	GENERAL	G0-03	INDEX OF SHEETS	
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5	ELECTRICAL	E1-01	KIOSK MIB-006 ELECTRICAL PLAN	
6	SURVEY		KIOSK MIB-006 SITE SURVEY	

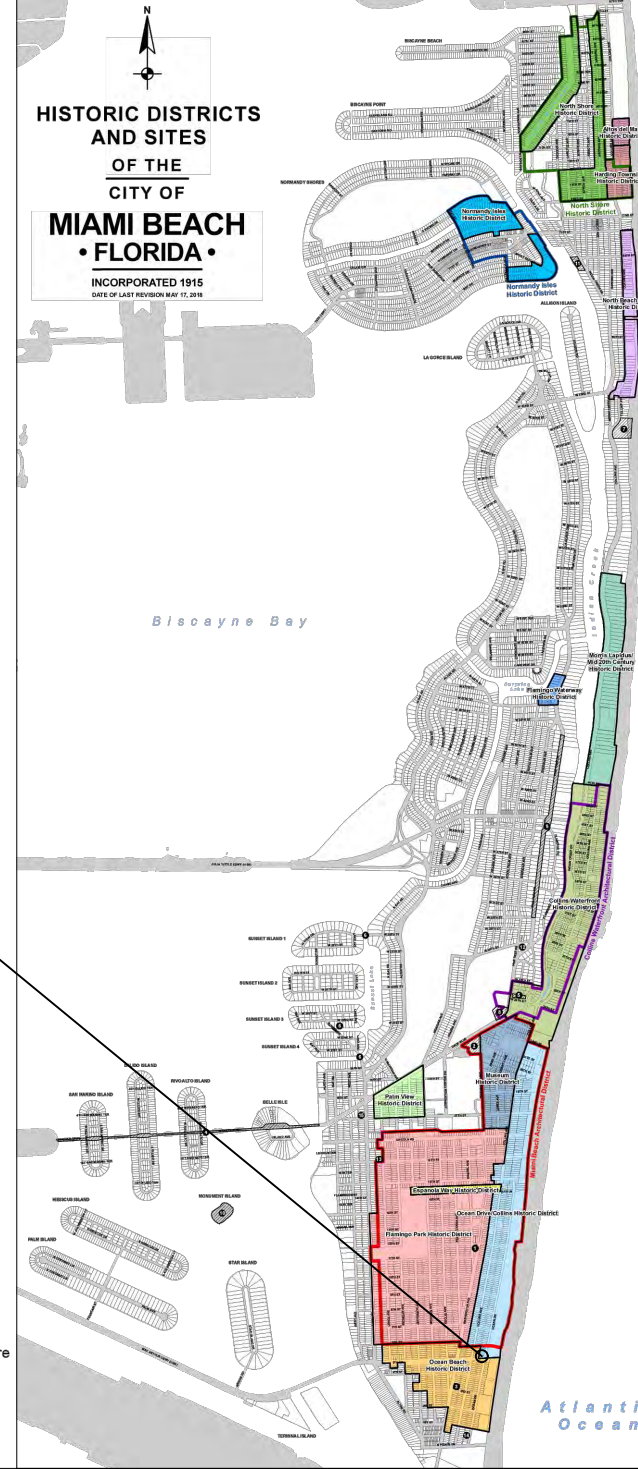

LEGEND AND ABBREVIATIONS

- = PALM TREE
- = TREE
- = ORNAMENTAL TREE
- O.R.B. = OFFICIAL RECORDS BOOK
- PG. = PAGE
- ELEV. = ELEVATION
- TYP. = TYPICAL
- CATV = CABLE TELEVISION
- OHE = OVERHEAD ELECTRIC LINE
- X 0.00 = SPOT ELEVATION
- CONC. = CONCRETE
- C.B.S. = CONCRETE BLOCK STUCCO
- C.L.F. = CHAIN LINK FENCE
- W.F. = WOOD FENCE
- M.F. = METAL FENCE
- RCP = REINFORCED CONCRETE PIPE
- FF = FINISH FLOOR
- (R) = RECORD
- (C) = CALCULATED
- (M) = MEASURE
- LB = LICENSE BUSINESS
- L = LENGTH
- Δ = CENTRAL ANGLE
- R = RADIUS
- T = TANGENT
- PT = POINT OF TANGENCY
- PC = POINT OF CURVATURE
- STA. = STATION
- PI = POINT OF INTERSECTION
- ID = IDENTIFICATION
- MLP = METAL LIGHT POLE
- CLP = CONCRETE LIGHT POLE
- R/W = RIGHT-OF-WAY
- P.B. = PLAT BOOK
- = SECTION LINE
- = CENTERLINE
- = BASELINE
- = MONUMENT LINE
- = TRAFFIC SIGNAL BOX
- = TRAFFIC SIGNAL CABINET
- = BOLLARD
- = PEDESTRIAN SIGNAL
- = TRAFFIC SIGNAL MAST ARM
- = SIGN
- = CABLE TELEVISION BOX
- = LIGHT POLE
- = ELECTRIC BOX
- = UTILITY POLE
- = ELECTRIC TRANSFORMER
- = GUY ANCHOR
- = ELECTRIC MANHOLE
- = ELECTRIC METER
- = GAS VALVE
- = GAS UTILITY BOX
- = GAS MANHOLE
- = GAS TANK
- = GAS METER
- = COMMUNICATION BOX
- = COMMUNICATION MANHOLE
- = GARBAGE RECEPTACLE
- = HANDICAP PARKING SPACE
- = WATER METER
- = IRRIGATION VALVE
- = WATER VALVE
- = FIRE HYDRANT
- = WATER BOX
- = WATER CONNECTION
- = WATER MANHOLE
- = WATER TANK
- = WATER WELL
- = WATER MARKING FLAG
- = WATER MARKING SIGN
- = STORM MANHOLE
- = STORM METER
- = CATCH BASIN
- = TELEPHONE MANHOLE
- = TELEPHONE BOX
- = NEWSPAPER DISPENSER
- = MAILBOX
- = SANITARY MANHOLE
- = SANITARY BOX
- = SANITARY TANK
- = SANITARY LIFT STATION
- = GREASE TRAP MANHOLE
- = CLEANOUT
- = PARKING METER
- = FIBER OPTIC BOX
- = FIBER OPTIC MARKER SIGN
- = MONITORING WELL
- = FUEL TANK
- = UNKNOWN UTILITY BOX
- = UNKNOWN UTILITY METER
- = UNKNOWN UTILITY MANHOLE
- = UNKNOWN UTILITY VALVE
- = UNKNOWN UTILITY MARKER FLAG
- = SANITARY VALVE
- = RAILROAD SIGN
- = FLAGPOLE
- = PROPERTY LINE
- = ELECTRICAL OUTLET

PROJECT LOCATION OCEAN DRIVE/COLLINS AVENUE HISTORIC DISTRICT

LOCAL HISTORIC DISTRICTS

	Espanola Way Historic District		Palm View Historic District
	Altos del Mar Historic District		Collins Waterfront Historic District
	Flamingo Park Historic District		North Beach Resort Historic District
	Ocean Drive/Collins Avenue Historic District		Flamingo Waterway Historic District
	Museum Historic District		Morris Lapidus/Mid 20th Century Historic District
	Ocean Beach Historic District		North Shore Historic District
	Harding Townsite Historic District		Normandy Isles Historic District

NATIONAL REGISTER HISTORIC DISTRICTS

	Miami Beach Architectural District
	Normandy Isles Historic District
	North Shore Historic District
	Collins Waterfront Architectural District

LOCAL HISTORIC SITES

1	Old City Hall Historic Site	8	Dade Blvd Fire Station Historic Site
2	21st St Recreation Center Historic Site	9	PineTree Dr Historic Roadway
3	Congregation Beth Jacob Historic Site	10	Flagler Memorial and Monument Island Historic Site
4	Venetian Causeway Historic Site	11	69th St Fire Station Historic Site
5	Miami Beach Woman's Club Historic Site	12	28th St Obelisk and Pumping Station Historic Structure
6	Sunset Island Bridges Historic Structures	13	1600 Lenox Ave Historic Site
7	The Bath Club Historic Site	14	36 Ocean Dr Historic Site
		15	1700 Alton Rd Historic Site

PROJECT DIRECTORY:

PROJECT NAME:
INTERACTIVE DIGITAL INFORMATION
KIOSKS DEPLOYMENT PROJECT

JURISDICTION:
CITY OF MIAMI
DEPARTMENT OF RESILIENCE AND
PUBLIC WORKS
MIAMI RIVERSIDE CENTER
444 S.W. 2nd AVENUE, 8th FLOOR
MIAMI, FLORIDA 33130
TEL: 305-416-1200

OWNER:
IKE SMART CITY
250 N HARTOFORD AVE
COLUMBUS, OH 43222
(614) 589-0087

ENGINEER OF RECORD:
MAINSTREET ENGINEERING
7035 SW 47 STREET, SUITE A
MIAMI, FL 33155
(305) 456-3505
PROJ. MGR: VANESSA MELA, P.E.
VMELA@MAINSTREETENG.COM

KIOSK MANUFACTURER:
DISPLAY DEVICE INC.
21075 WESTGATE RD.
GOLDEN, CO 80403
CONTACT: ERIC PERKINS
PHONE: (303) 929-4071

UTILITIES:

ELECTRICAL POWER: FLORIDA
POWER & LIGHT COMPANY (FPL)

WATER & SEWER: MIAMI-DADE
WATER & SEWAGE DEPARTMENT

TELEPHONE: AT&T


CABLE: COMCAST, XFINITY,
ATT-UVERSE

GAS: FLORIDA GAS


SIDEWALK & STREET SYMBOLS

	ASPHALT		BRICK
	PAVER		CONCRETE
	UNIMPROVED		TILE
	GRAVEL		STAMPED CONCRETE

KEY PLAN (NOT TO SCALE):

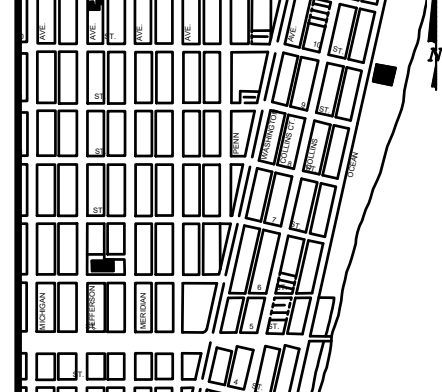

P.E. SEAL:

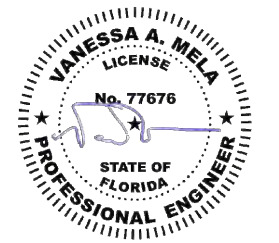

NO.	DATE	REVISION	APP'D. BY
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ADA NOTES

1. ALL CONSTRUCTION ACTIVITIES SHALL BE COMPLETED IN FULL COMPLIANCE WITH THE AMERICANS WITH DISABILITIES ACT (ADA). CLEAR SPACES IN FRONT OF KIOSK SHALL HAVE THE FOLLOWING CHARACTERISTICS:
2. SURFACES SHALL BE FIRM, STABLE, AND SLIP RESISTANT AND OTHERWISE COMPLY WITH PROWAG SECTION R302.7 AND SHALL HAVE A RUNNING SLOPE CONSISTENT WITH GRADE OF THE ADJACENT PEDESTRIAN ACCESS ROUTE AND CROSS SLOPE OF 1.50% +/-0.50%)
3. SIZE: CLEAR SPACES SHALL BE 48" MINIMUM BY 48" MINIMUM.
4. POSITION: UNLESS OTHERWISE SPECIFIED, CLEAR SPACES SHALL BE POSITIONED FOR EITHER FORWARD OR PARALLEL APPROACH TO THE KIOSK.
5. APPROACH: ONE FULL UNOBSTRUCTED SIDE OF A CLEAR SPACE SHALL ADJOIN A PEDESTRIAN ACCESS ROUTE OR ADJOIN ANOTHER CLEAR SPACE.
6. MANEUVERING SPACE: WHERE A CLEAR SPACE IS CONFINED ON ALL OR PART OF THREE SIDES, ADDITIONAL MANEUVERING SPACE SHALL BE PROVIDED AS FOLLOWS:
 - 6.1.1. FORWARD APPROACH: THE CLEAR SPACE AND ADDITIONAL MANEUVERING SPACE SHALL BE 36" WIDE MINIMUM WHERE THE DEPTH OF THE CONFINING ELEMENT EXCEEDS 24".
 - 6.1.2. PARALLEL APPROACH: THE CLEAR SPACE AND ADDITIONAL MANEUVERING SPACE SHALL BE 60" WIDE MINIMUM WHERE THE DEPTH OF THE CONFINING ELEMENT EXCEEDS 15".
7. THE MINIMUM WHEELCHAIR PASSAGE WIDTH OR CLEAR SPACE WIDTH FOR A SINGLE WHEELCHAIR PASSAGE SHALL BE 48" PER PROWAG SECTION R302.3.
8. INITIAL OPERATION FOR THE KIOSK WILL HAVE 4G LTE CONNECTION SECTION R404. TO THE INTERNET.
9. THE KIOSKS HAVE BEEN DESIGN TO COMPLY WITH ALL ADA GUIDELINES INCLUDING VIEWING, OPERATION, AND ACCESSIBILITY.
10. THE MOBILE IKE EXPERIENCE WILL FOLLOW WEB CONTENT ACCESSIBILITY GUIDELINES (WCAG) TO WORK IN TANDEM WITH THE NATIVE ACCESSIBILITY FEATURES ON THE USER'S MOBILE DEVICE, INCLUDING TALKBACK AND VOICEOVER TOOLS.

SCOPE OF WORK

THE PROJECT CONSIST OF THE INSTALLATION OF ONE (1) DIGITAL INTERACTIVE KIOSKS AT THE LOCATION(S) INDICATED ON THIS PLANS SET. INSTALLER SHALL PROVIDE AND INCLUDE ALL WORKMANSHIP AND MATERIALS NECESSARY TO COMPLETE THE INSTALLATION INCLUDING BUT NOT LIMITED TO:


1. INSTALLATION OF THE KIOSKS TO THE FOUNDATION AS INDICATED ON PLANS TO NEW RECTANGULAR CONCRETE FOUNDATION.
2. ELECTRICAL SERVICE POINTS ARE EXISTING. CONNECT THE EXISTING ELECTRIC SERVICE TO THE NEW KIOSK AS INDICATED ON PLANS.
3. TESTING OF THE ELECTRICAL SERVICE INFRASTRUCTURE SHALL BE PERFORMED IN CONJUNCTION WITH A REPRESENTATIVE OF THE ENGINEER OF RECORD.
4. THE CONTRACTOR SHALL INSTALL THE KIOSK IN SUCH A WAY THAT THE KIOSK IS WITHIN THE PUBLIC R.O.W. AND IN COMPLIANCE WITH ALL APPLICABLE A.D.A. REQUIREMENTS
5. THE LOCATION OF KIOSKS HAS BEEN COORDINATE TO ENSURE THERE IS NO OBSTRUCTION OF THE SIGHT OF VEHICULAR SIGNS.
6. STAND-ALONE PEDESTRIAN KIOSKS SHOULD NOT BE INSTALLED WITHIN PEDESTRIAN CIRCULATION PATHS IN A MANNER THAT PERSONS AT THE KIOSK LOCK THE EFFECTIVE WIDTH OF THE PEDESTRIAN TRAVEL WAY.

MONUMENT SIGN SPECIFICATIONS AND FUNCTIONS


THE UNIT CONSISTS OF A UL/NRTL LISTED WEATHER AND VANDAL RESISTANT FREE STANDING ENCLOSURE DESIGNED TO COMPLY WITH THE FLORIDA BUILDING CODE AND OTHER APPLICABLE CODES INCLUDING THE NATIONAL ELECTRICAL CODE. THE UNIT HAS BEEN DESIGNED TO WITHSTAND WINDS OF 165 MPH. THE UNIT'S MAIN COMPONENTS ARE:

1. TWO (2) INTERACTIVE 65" VIDEO TOUCH SCREENS.
2. TWO (2) CAMERAS
3. ONE (1) CPU
4. ONE (1) WI-FI TRANSMITTER

MANUFACTURER: DYNASCAN MODEL NUMBER: CIO651DR5
 NATIVE RESOLUTION: 1920 X 1080
 ELECTRICAL POWER REQUIREMENT:
 1. ONE-2-POLE, 20 AMP, 240 VOLTS CIRCUIT.
 2. TOTAL LOAD: 1400/2200 WATTS (OPERATIONAL/PEAK)
 3. VOLTAGE: 100-240 VOLTS AC, 50-60 HZ
 WEIGHT: 832 LBS
 CERTIFICATION CE / FCC / RoHS

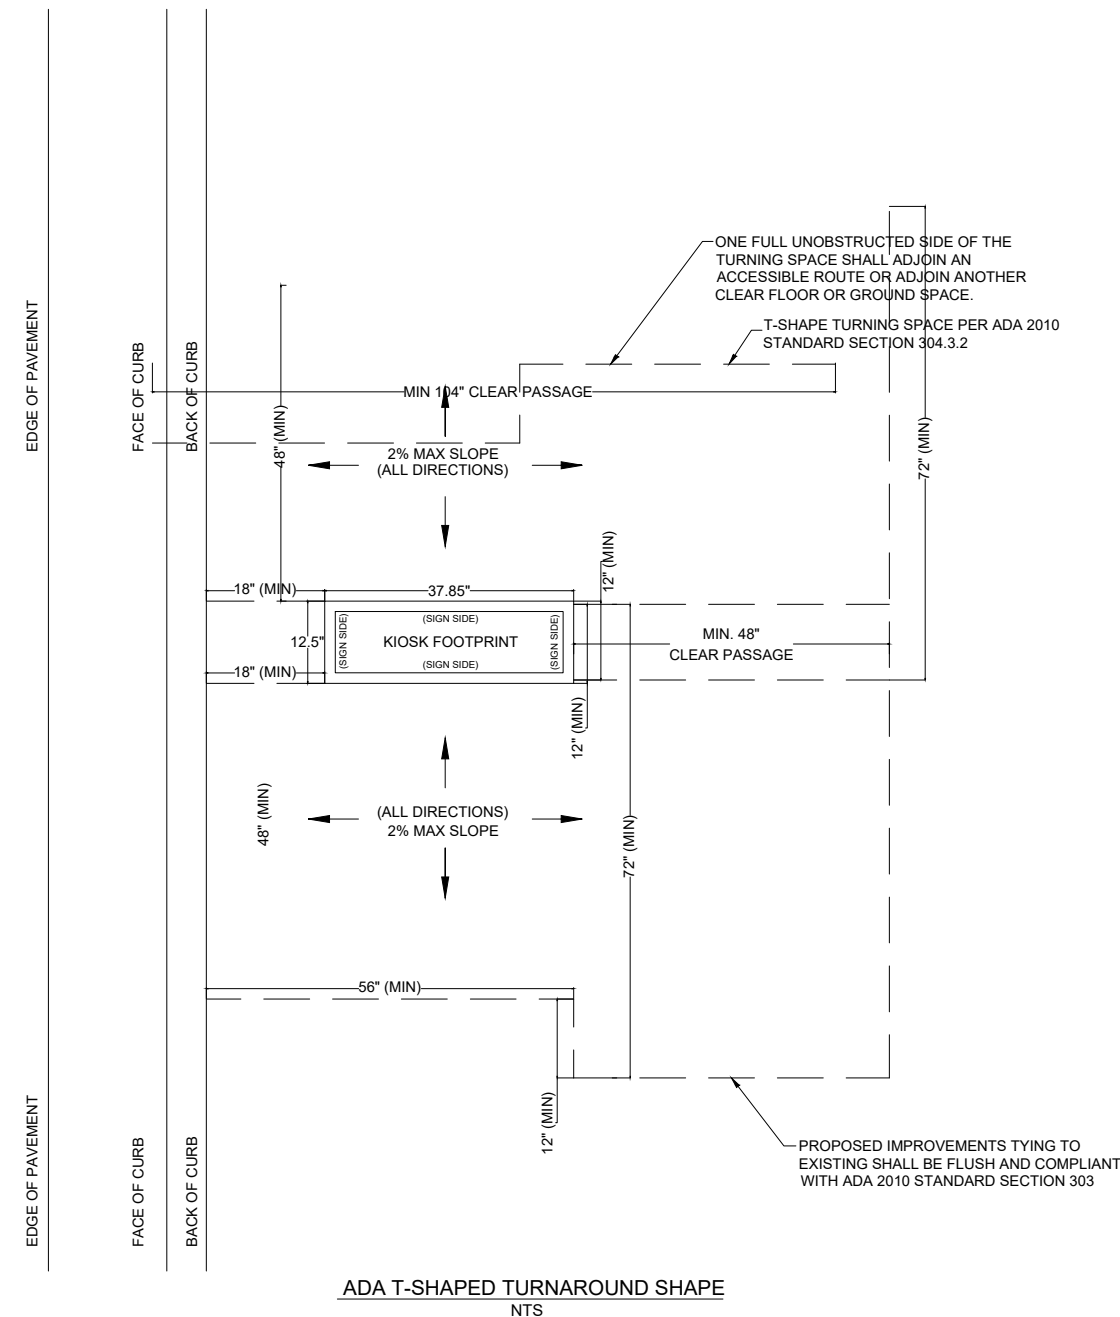

NOTES:

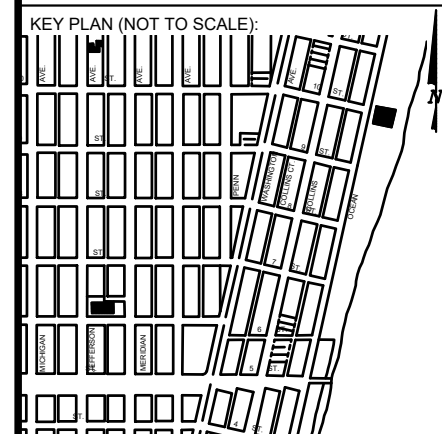

P.E. SEAL:

MIAMI BEACH
 PUBLIC WORKS DEPARTMENT
 1700 CONVENTION CENTER DRIVE, MIAMI BEACH, FL 33139

CITY MANAGER: ALINA T. HUDAK
 DIRECTOR: JOE GOMEZ, P.E.
 CITY ENGINEER: CRISTINA ORTEGA CASTINEIRAS, P.E.


NO.	DATE	REVISION	APP'D. BY
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2			
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Main Street ENGINEERING
 7035 SW 47th Street, Ste A, Miami, FL 33155
 Tel: (305) 406-3055 Fax: (305) 476-8864
 FL PE Certificate No: 00008751


ENGINEER OF RECORD: VANESSA A. MELA, P.E. NO. 77676
 ENGINEER OF RECORD: VM
 DESIGN ENGINEER: VM
 DRAWN BY: KM
 CHECKER: WP
 SCALE:


NEIGHBORHOOD: MIB-006: 5TH STREET & OCEAN DRIVE
 TITLE: ADA NOTES, SCOPE OF WORK & KIOSK SPECIFICATIONS

File Name: MIB-006-GENERAL AND FOUNDATION.dwg
 Survey Reference:
 Field Book: N/A Page: N/A Work Order: N/A
 Date: 10/09/2023 Sheet: 2 of 6 Drawing: G0-04

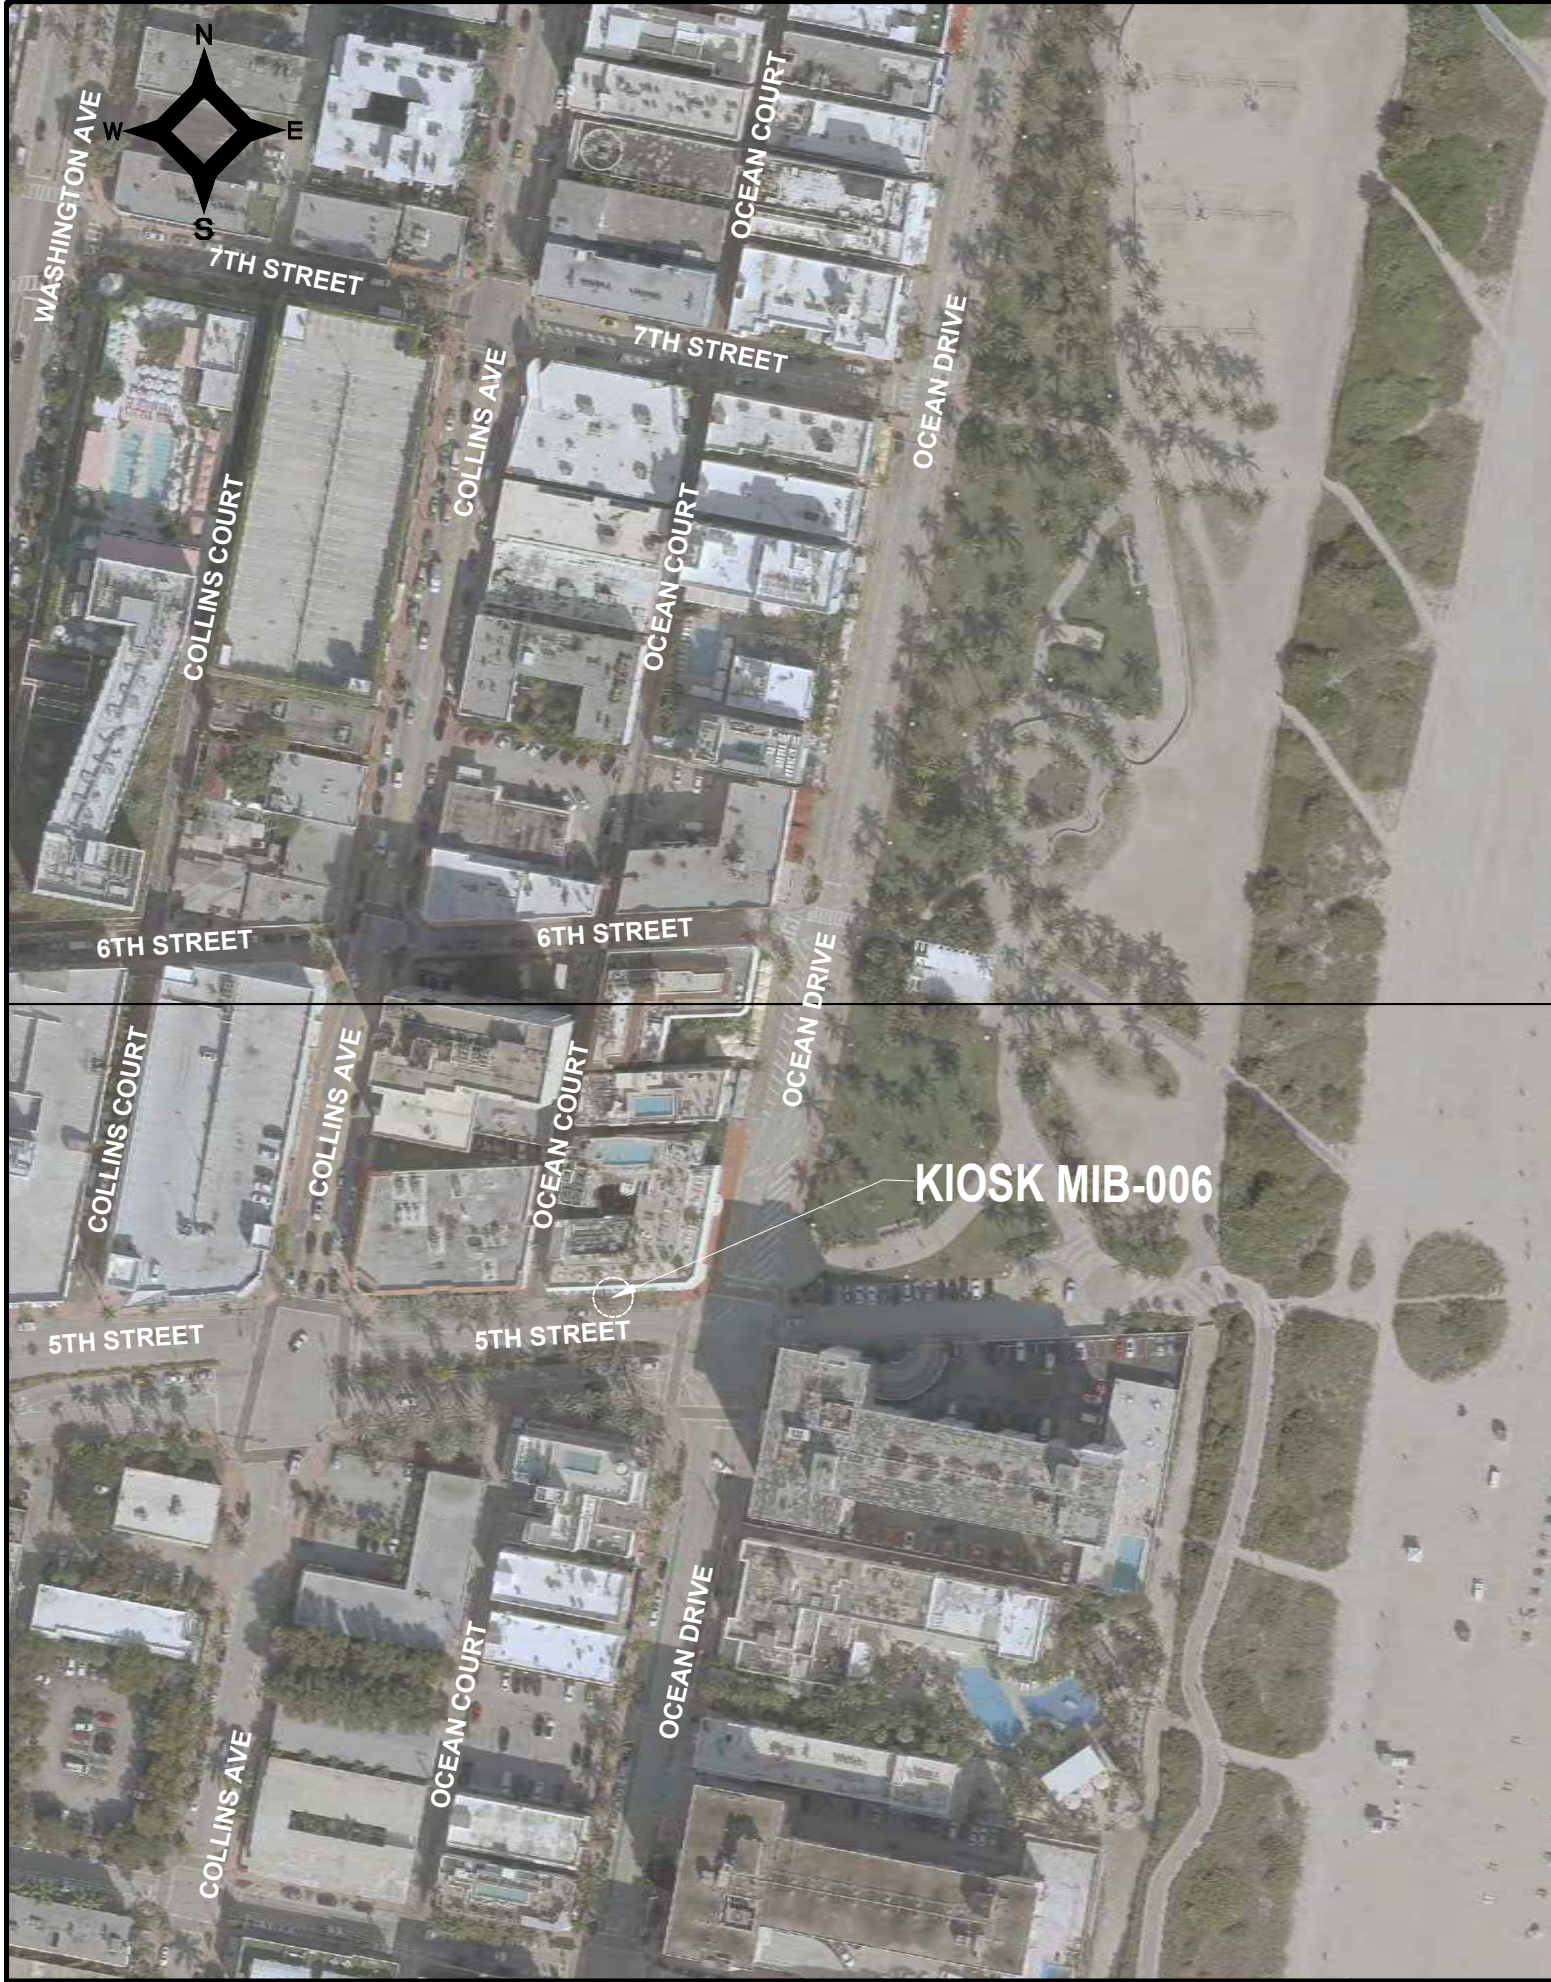


LEGEND

 AREA WHERE NO STRUCTURE OR PLANTING WHICH OBSTRUCTS TRAFFIC VISIBILITY BETWEEN THE HEIGHT OF TWO FEET AND TEN FEET ABOVE THE STREET CORNER GRADE IS ALLOWED. REFER TO CITY OF MIAMI BEACH CODE OF ORDINANCES SECTION 142-1135


 NO PLANTING OR STRUCTURE PERMITTED WITHIN THESE LIMITS WHICH OBSTRUCTS TRAFFIC VISIBILITY.

E.P. EDGE OF PAVEMENT

R/W RIGHT OF WAY

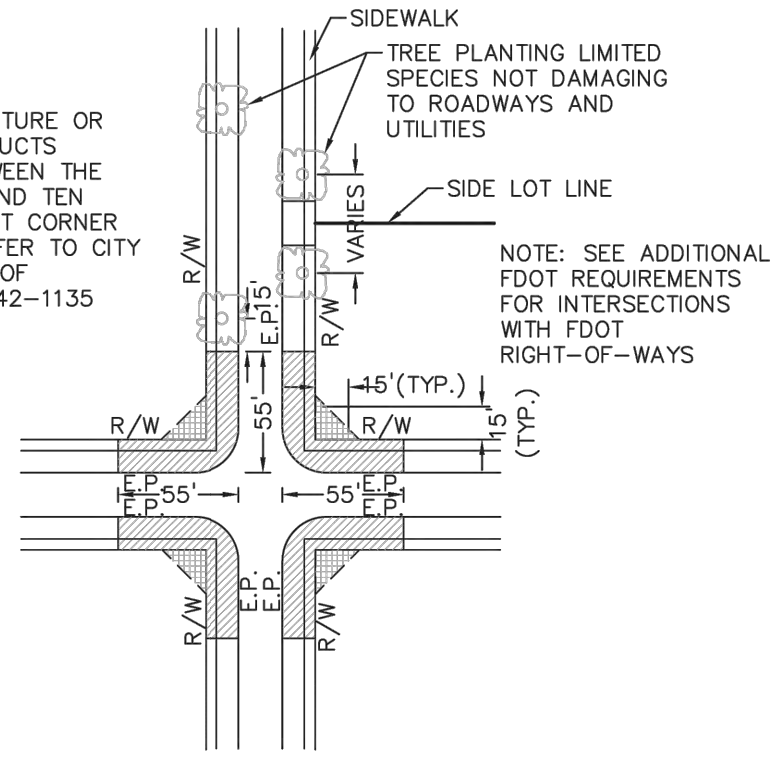


PLAN VIEW
N.T.S.

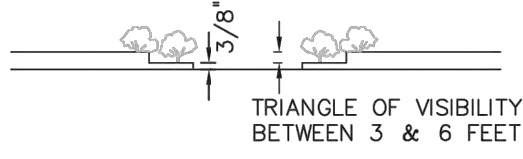

ELEVATION VIEW
N.T.S.

NOTES:

1. AT INTERSECTIONS WITH ALL-WAY STOP CONTROL, THE FIRST STOPPED VEHICLE ON ONE APPROACH SHOULD BE VISIBLE TO THE DRIVERS OF THE FIRST STOPPED VEHICLES ON EACH OF THE OTHER APPROACHES. THERE ARE NO OTHER SIGHT DISTANCE CRITERIA APPLICABLE TO INTERSECTIONS WITH ALL-WAY STOP CONTROL AND, INDEED, ALL-WAY CONTROL MAY BE THE BEST OPTION AT A LIMITED NUMBER OF INTERSECTIONS WHERE SIGHT DISTANCE FOR OTHER CONTROL TYPES CANNOT BE ATTAINED.
2. FOR TWO-WAY STOP INTERSECTIONS, SIGHT DISTANCE CRITERIA FOR STOP CONTROLLED INTERSECTIONS ARE LONGER THAN STOPPING SIGHT DISTANCE TO ENSURE THAT THE INTERSECTION OPERATES SMOOTHLY. MINOR-ROAD VEHICLE OPERATORS CAN WAIT UNTIL THEY CAN PROCEED SAFELY WITHOUT A MAJOR-ROAD VEHICLE TO STOP.

	APPROVED	REVISED 07/2020 09/2020	TITLE: SIGHT RESTRICTIONS AT INTERSECTIONS WITH NO DEDICATED RADII	DETAIL 10-26


SIGHT TRIANGLE CLEARANCE

Sunshine811


Call 811 or visit sunshine811.com two full business days before digging to have buried facilities located and marked.

Check positive response codes before you dig!

NOTES:

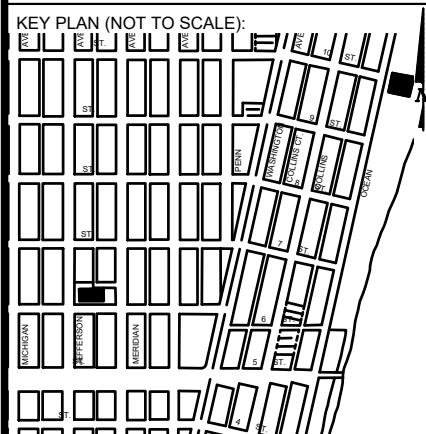

P.E. SEAL:

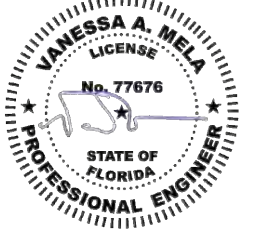


5			
4			
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2			
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NO.	DATE	REVISION	APP'D. BY







NOTES:

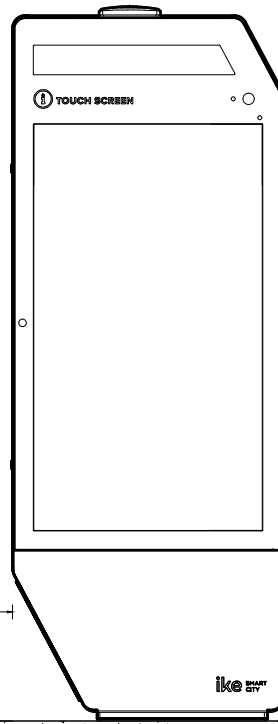

IKE 3.0 KIOSK
SEE SPEC. SHEET
FOR DETAILS

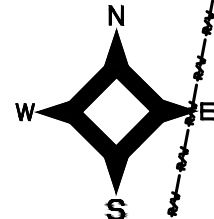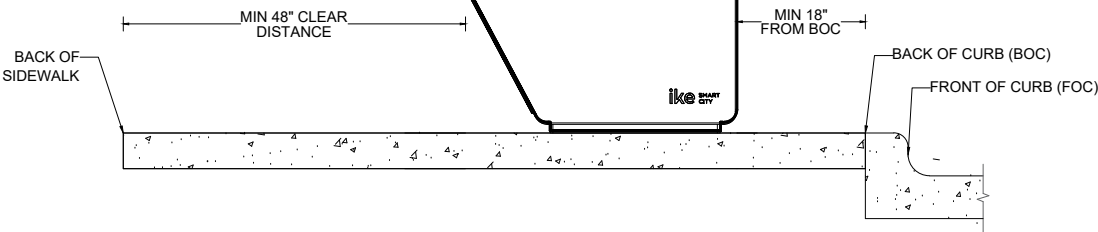

20' ALLEY
(PB 4 - PG 83)

Lot 6, Block 2
FRIEDMAN AND COPE
(PB 4 - PG 83)

KIOSK MIB-006.
SEE DETAIL ON SHEET
G0-05.

7'-9" CLEAR DISTANCE

EX. ELECTRICAL

EX. WATER VALVE

EX. TRAFFIC SIGN




12'-8" FROM BOC TO R/W

1'-6" FROM BOC

CONCRETE FOUNDATION.
SEE SHEET S-01 FOR
FOUNDATION DETAILS


VISIBILITY TRIANGLE CLEARANCE ANALYSIS

SCALE: 1'-10"

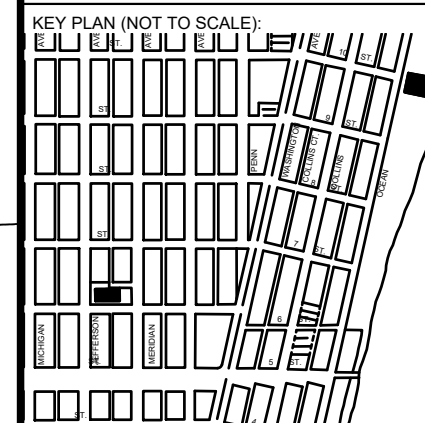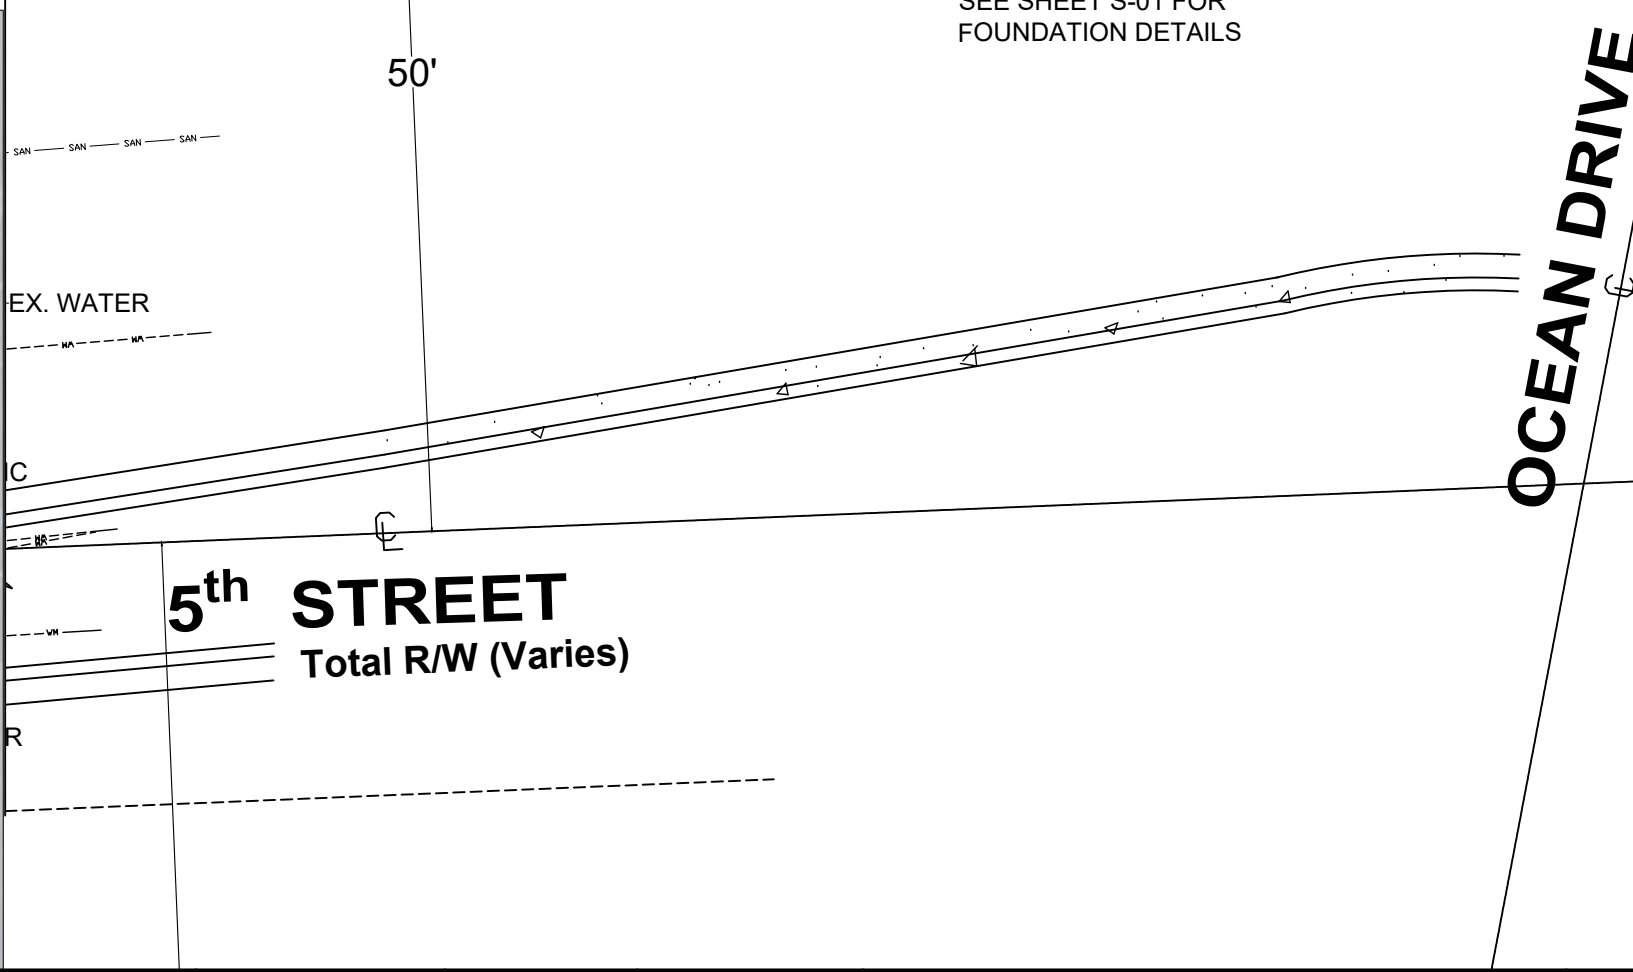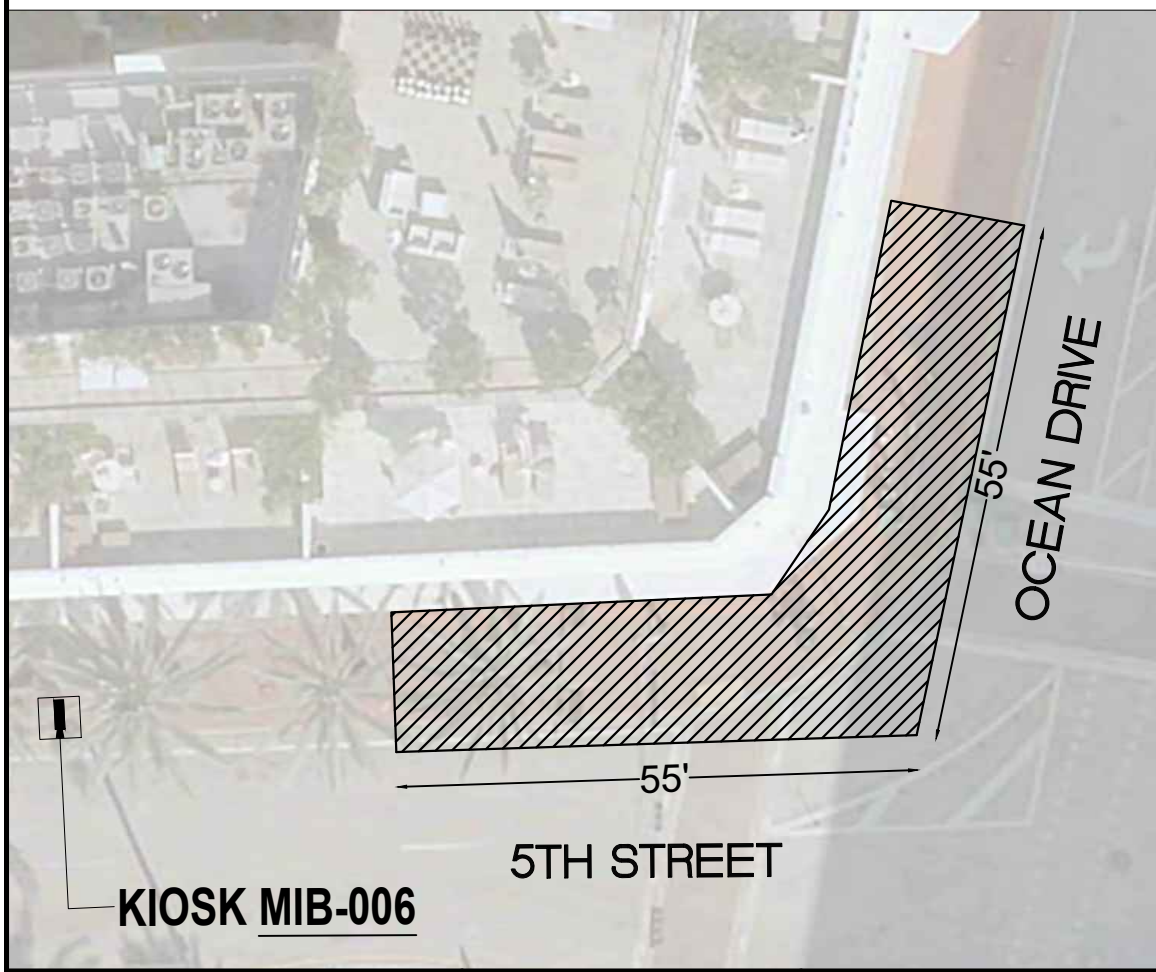


P.E. SEAL:

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NO.	DATE	REVISION	APP'D. BY

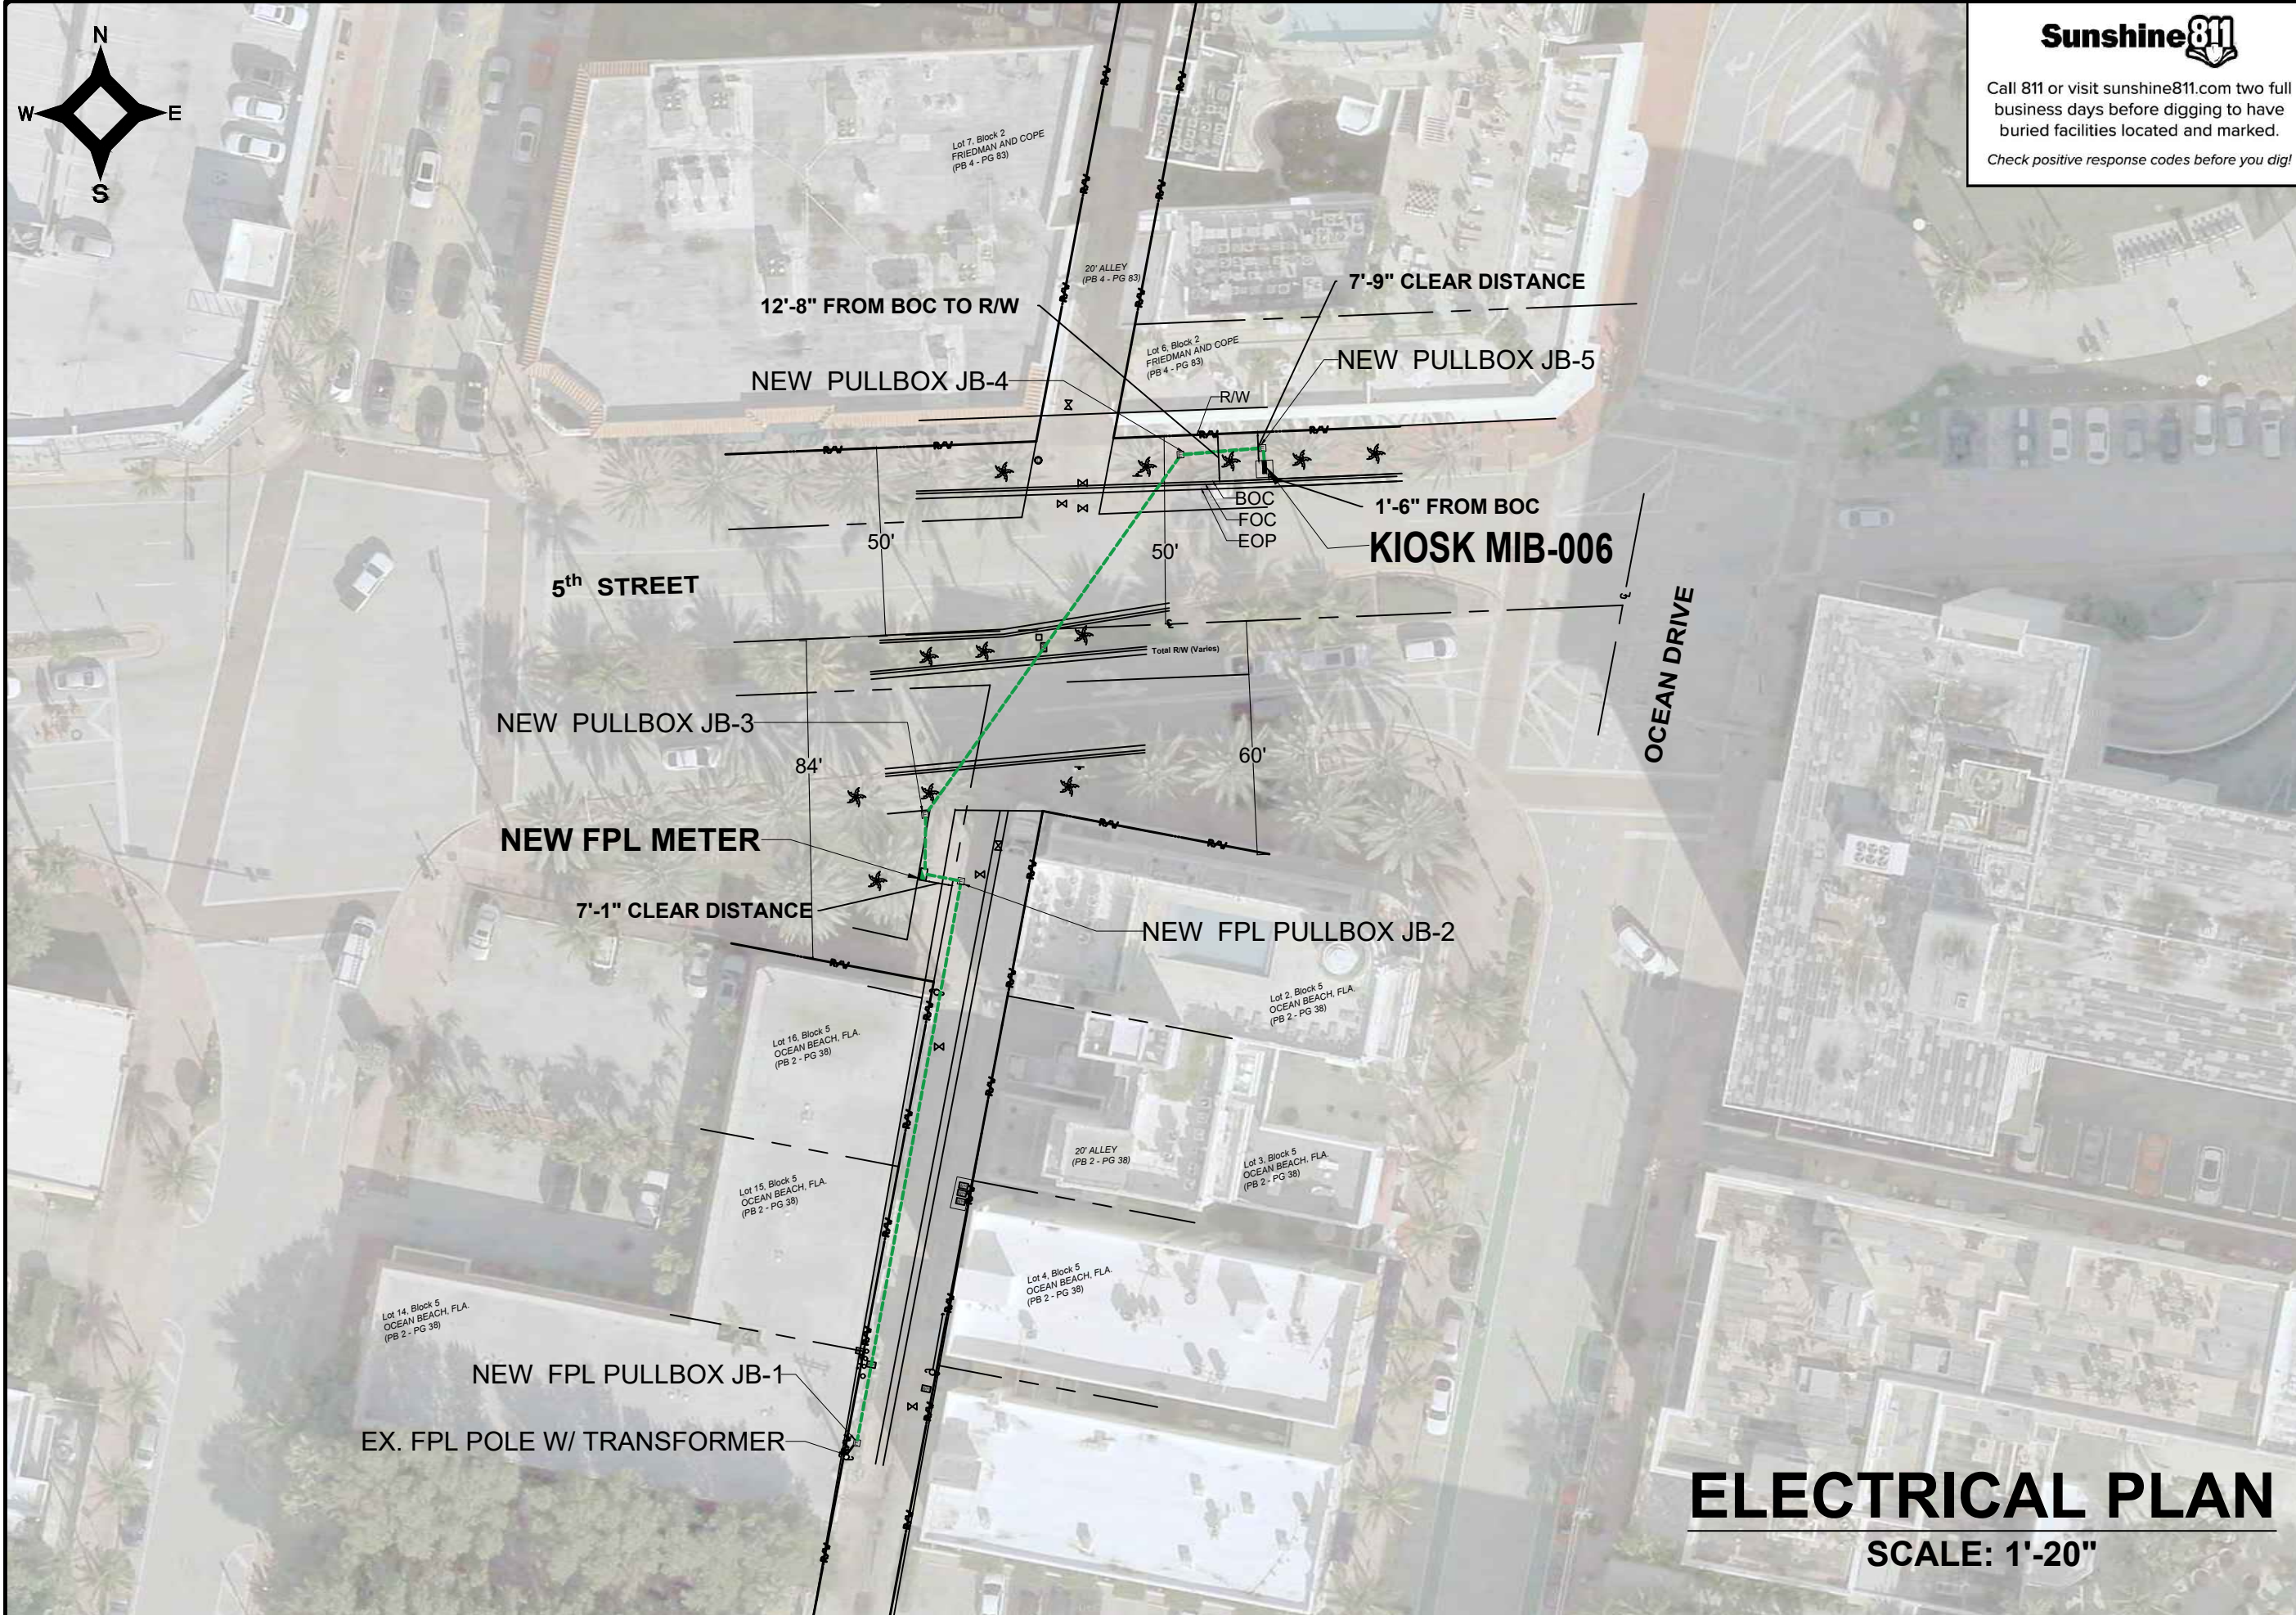


Call 811 or visit sunshine811.com two full business days before digging to have buried facilities located and marked.
Check positive response codes before you dig!

NOTES:

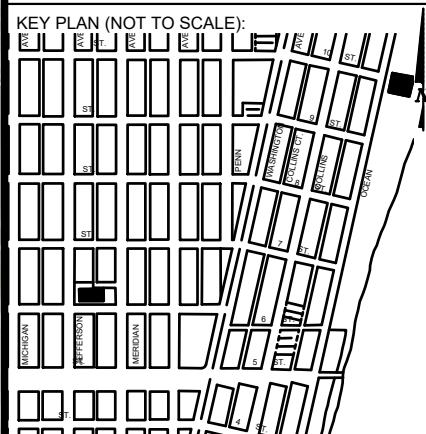

P.E. SEAL:

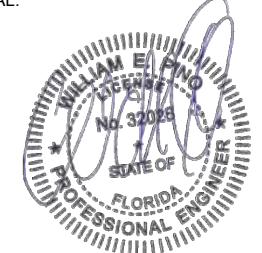

ELECTRICAL PLAN




SCALE: 1'-20"

NO.	DATE	REVISION	APP'D. BY
5			
4			
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2			
1			



MAP OF TOPOGRAPHIC SURVEY

PORTION OF LANDS LYING IN SECTIONS 3, TOWNSHIP 54 SOUTH, RANGE 42 EAST
CITY OF MIAMI, MIAMI-DADE COUNTY, FLORIDA.

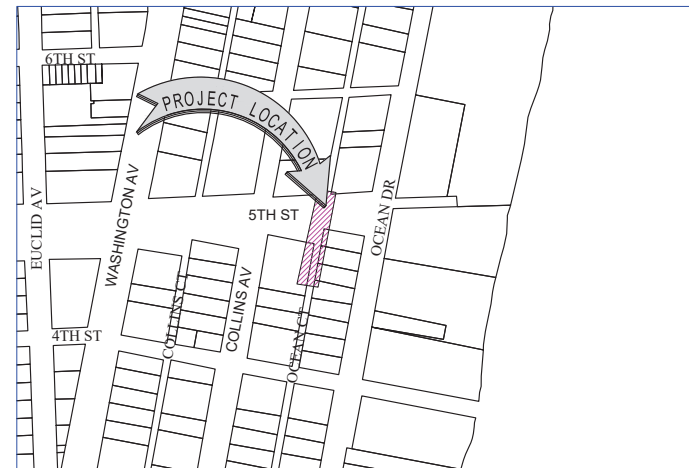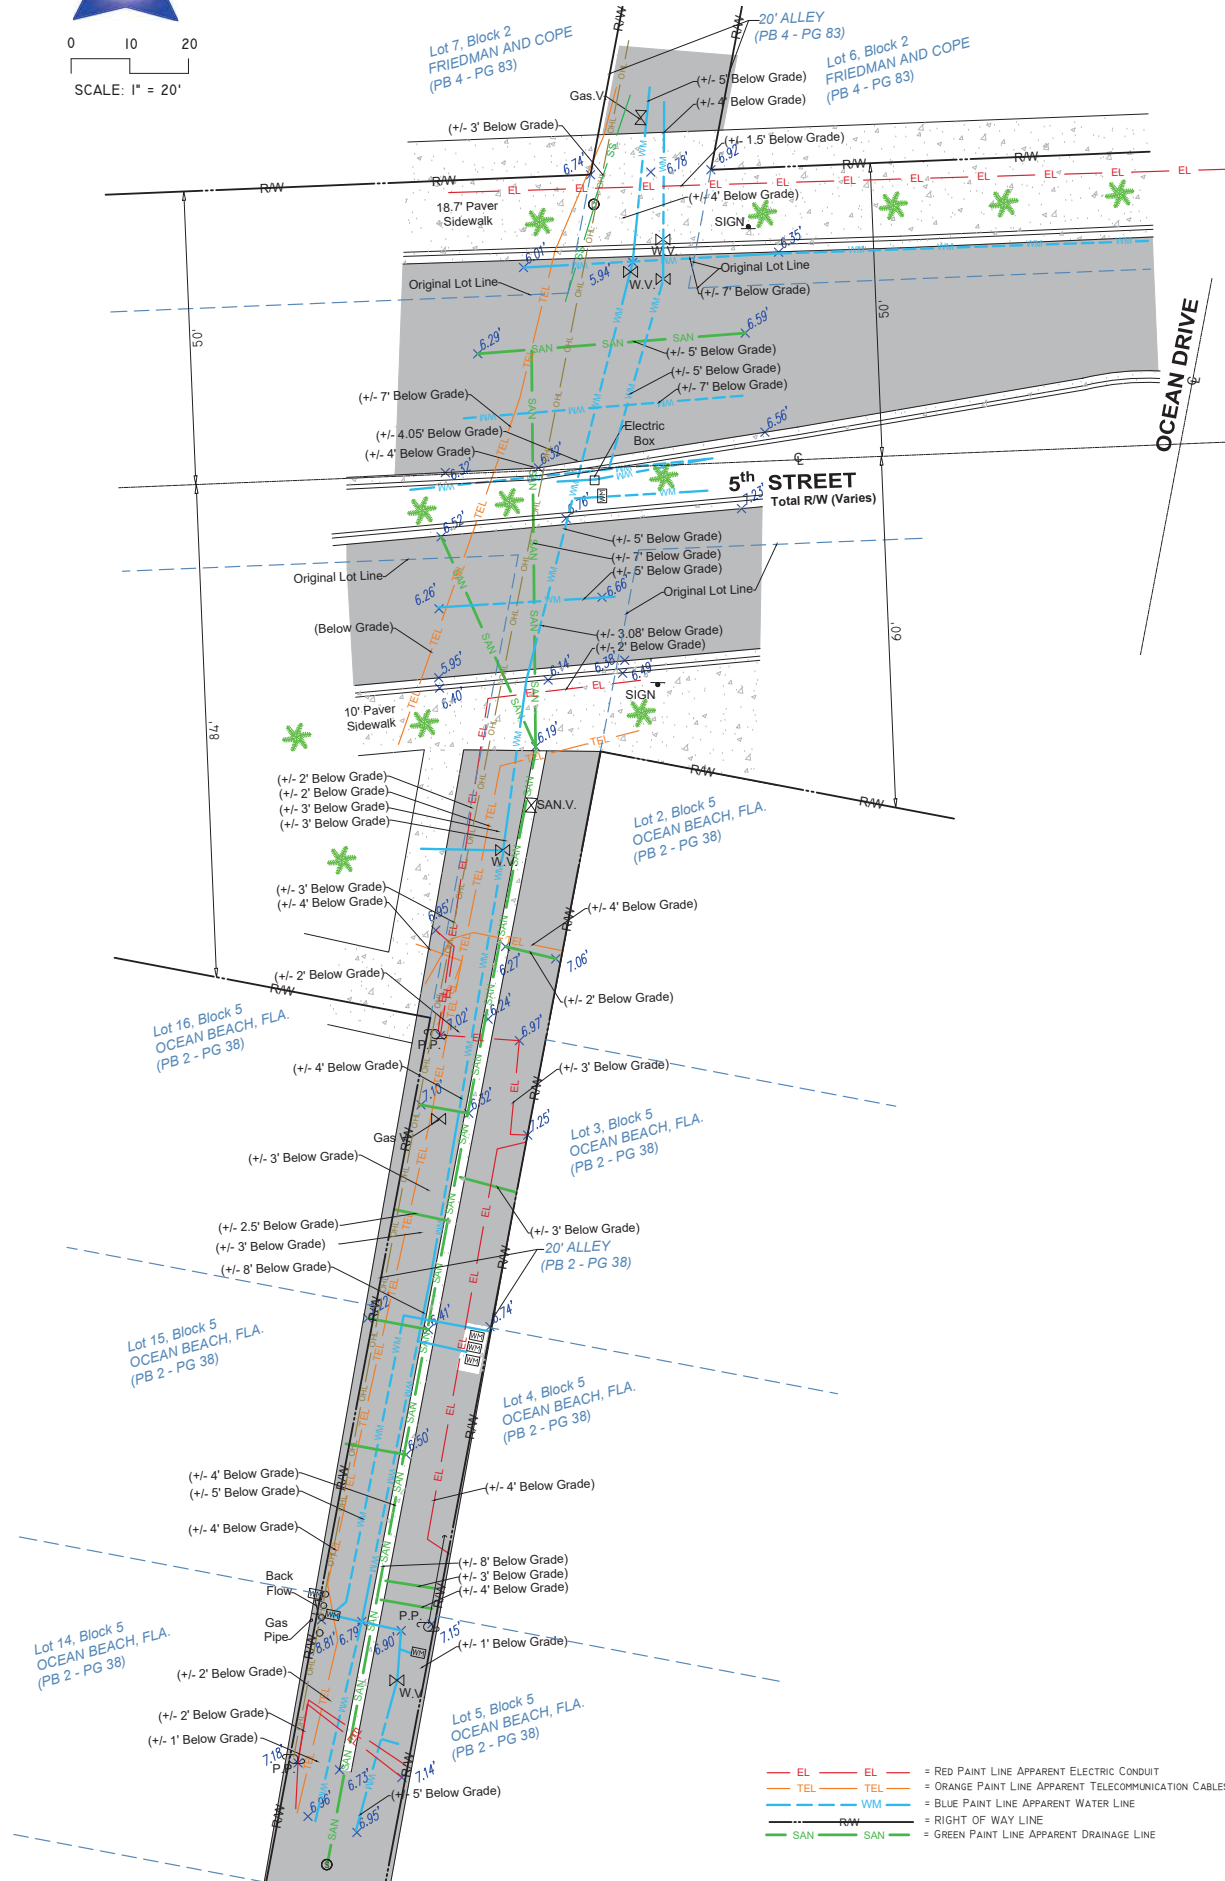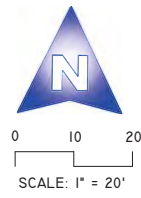

LOCATION MAP

Not to Scale

SURVEYOR'S REPORT AND GENERAL NOTES

(Not valid without the attached Survey Map)

- This is not a Boundary Survey. This is a Topographic survey of a portion of public right of ways. The underlying subdivisions as depicted on the survey is the following:
That Plat of **OCEAN BEACH, FLA. & FRIEDMAN AND COPE**, according to the plat thereof, as recorded in Plat Book 2, Page 38, Plat Book 4, Page 83 of the Public Records of Miami-Dade County, Florida. These lands are subject to restrictions of record that were not furnished to the undersigning registered surveyor. A title search has not been performed by the surveyor.
- North arrow direction is based on an assumed Meridian. Bearings are based on an assumed meridian on a well-established line, said line is being noted as BR on the Survey Map.
- Foundations and/or any other underground structures have not been located.
- Survey markers found in the field have no identification unless otherwise shown. Any survey marker set by our company is labeled LB 7262 or PSM 6169.
- This Survey Map is intended to be displayed at the scale shown hereon. Data is expressed in U.S. Survey Foot.
- This Survey Map is being prepared for the use of the party/parties that it is certified to and does not extend to any unnamed individual, entity or assignee.
- FLOODPLAIN INFORMATION:** As scaled from Federal Insurance Rate Map (FIRM) of Community No. 120651 (City of Miami), Panel 0319, Suffix L, revised on Sept 11th, 2009, this real property falls in Zone "AE" with Base Flood Elevation 8 feet (NGVD 1929)
- SUBSURFACE UTILITY ENGINEERING (SUE) QUALITY LEVEL B for investigation of underground utilities was performed as part of this survey using GPR (Ground Penetrating Radar) and RD (Radiodetection Technology) for designation and location of underground facilities.** This Survey depicts apparent location of underground piping and conduits found during this investigation, and located as accurately as possible, based on best interpretation of signals received and combining it with utility evidences. Horizontal location of utilities is subject to a horizontal clearance of 3 (three) feet, plus or minus. Softdigs/excavation was not performed as part of this locating effort. There might be additional underground facilities not discovered at the time of this survey. AS-Built of underground utilities were not furnished to this surveyor. This surveyor can't certify if the lines located are actively in service or not. This firm recommends that underground utilities be verified by electromagnetic technology and/or excavation prior to any construction work.
- HORIZONTAL ACCURACY:** Accuracy obtained thru measurements and calculations meets and exceeds the minimum horizontal feature accuracy for a Suburban area being equal to 1 foot in 7, 500 feet.
- VERTICAL CONTROL AND ACCURACY:** The elevations as shown are referred to the National Geodetic Vertical Datum of 1929 (NGVD 1929). The closure in feet, as computed, meets the standard of plus or minus 0.05 feet times the squared root of the loop distance in miles. Elevation are based on a level loop from and to the following official Bench Marks:
Bench Mark # 1: Miami-Dade County Public Works Department Bench Mark D-146,
Elevation = 8.80 feet (NGVD29), Elevation = 7.25 feet (NAVD88)
Bench Mark # 2: Miami-Dade County Public Works Department Bench Mark D-116,
Elevation = 5.03 feet (NGVD29), Elevation = 3.48 feet (NAVD88)

I hereby certify to Main Street Engineering that this Survey conforms to the Standards of Practice as set forth by the Florida Board of Professional Surveyors and Mappers in applicable provisions of Chapter 5J-17, Florida Administrative Code pursuant to Section 472.027 Florida Statutes. This Survey is accurate and correct to the best of my knowledge and belief.

Odalys C. Bello-Iznaga
Professional Surveyor and Mapper LS6169 - State of Florida
Field Work Date: 05/10/2023

LEGEND & ABBREVIATIONS

	= CONCRETE (CONC.)
	= CONCRETE BLOCK WALL
	= WOOD DECK
	= COVERED AREA
	= ASPHALT
	= TILE
	= PAVERS
	= STONE
	= CHAIN LINK FENCE (CLF)
	= WOOD FENCE (WF)
	= IRON METAL BARS FENCE (IF)
	= OVERHEAD WIRES
	= WATER VALVE (WV)
	= POWER POLE (PP)
	= GUY ANCHOR
	= WATER METER (WM)
	= CONC. LIGHT POLE (LP)
	= WELL
	= STREET SIGN
	= SANITARY MANHOLE
	= DRAINAGE MANHOLE
	= MANHOLE
	= FIRE HYDRANT
	= CABLE BOX (CATV)
	= FPL TRANSFORMER
	= CATCH BASIN OR INLET
	= EXISTING ELEVATION
	= PERMANENT REFERENCE MONUMENT (FRM)
	= PROPERTY CORNER
	= PERMANENT CONTROL POINT (PCP)
	PT = POINT OF TANGENCY
	PC = POINT OF CURVATURE
	PCC = POINT OF COMPOUND CURVE
	PRC = POINT OF REVERSE CURVE
	BM = BENCH MARK
	BR = BEARING REFERENCE
	TBM = TEMPORARY BENCH MARK
	PL = PROPERTY LINE
	CL = CENTER LINE
	M = MONUMENT LINE
	B = BASE LINE
	MEAS = FIELD MEASURED
	P = PER FLAT
	PSM = PROFESSIONAL SURVEYOR AND MAPPER
	A/C = AIR CONDITIONER PAD
	ENCR = ENCROACHMENT
	FF ELEV = FINISHED FLOOR ELEVATION
	(XX-XX) = DENOTES PLAT BOOK XX - PAGE XX
	ORB = OFFICIAL RECORD BOOK
	CBS = CONCRETE BLOCK STRUCTURE
	R/W = RIGHT OF WAY
	ELEV = ELEVATION
	SEC = SECTION
	T = TOWNSHIP
	R = RANGE
	CALC = CALCULATED
	(R) = RECORD
	(CMA X-X) = CITY OF MIAMI MUNICIPAL ATLAS X-X

Property Address:
436 Ocean Drive, Miami Beach, Florida 33139 (Reference)
Project No. 22985 D.B.: UR Page 1 of 1

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e-mail: info@belloland.com • www.bellolandsurveying.com



13. Ocean Drive & 5th Street

