PUBLIC WORKS DEPARTMENT

INDIAN CREEK DRIVE (SR-A1A) & 41ST STREET (SR-112) INTERACTIVE DIGITAL KIOSK DEPLOYMENT PROJECT OCTOBER 2023 **IKE SMART CITY MIB-020**

CITY OF MIAMI BEACH

DAN GELBER MAYOR:

MICKY STEINBERG **COMMISSIONERS:**

> MARK SAMUELIAN MICHAEL GONGORA STEVEN MEINER RICKEY ARRIOLA DAVID RICHARDSON


CITY MANAGER: ALINA T. HUDAK

CITY ATTORNEY: RAFAEL A. PAZ

PUBLIC WORKS DIRECTOR: JOE GOMEZ, P.E., F.FES

> NELSON PEREZ-JACOME, PE CITY ENGINEER:



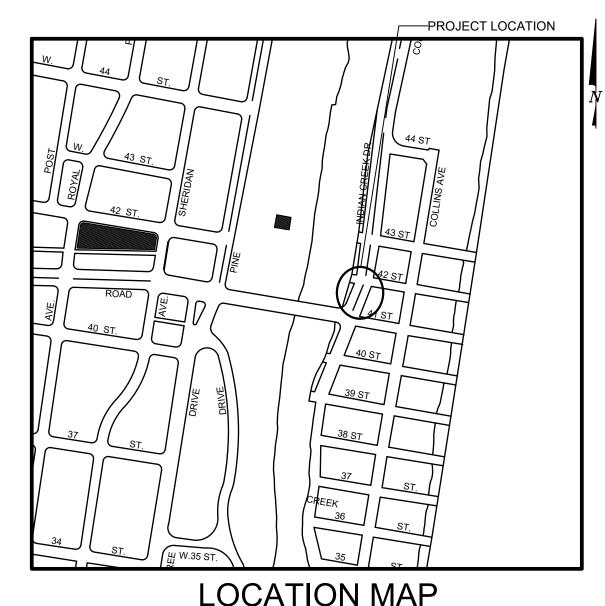





INDEX OF PLANS						
NUMBER	DISCIPLINE	SHEET NO.	DESCRIPTION	NOTES		
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2	GENERAL	G0-04	ADA NOTES, SCOPE OF WORK & KIOSK SPECIFICATIONS			
3	CIVIL	C1-01	CIVIL SITE PLAN			
4	CIVIL	C1-02	KIOSK MIB-020 ENGINEERING PLAN			
5	ELECTRICAL	E1-01	KIOSK MIB-020 ELECTRICAL PLAN			
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SCOPE OF WORK: THE PROJECT CONSISTS OF THE INSTALLATION OF ONE (1) DIGITAL INTERACTIVE KIOSK AND APPLICABLE INFRASTRUCTURE; STRUCTURAL FOUNDATION AND ELECTRICAL SERVICE AT THE LOCATION INDICATED ON THESE DESIGN PLANS.

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PROJECT LOCATION

COLLINS WATERFRONT HISTORIC DISTRICT

LOCAL HISTORIC DISTRICTS

Espanola Way Historic District

Altos del Mar Historic District
Flamingo Park Historic District
Ocean Drive/Collins Avenue Historic Dist

Ocean Beach Historic District Harding Townsite Historic District Collins Waterfront Historic District

Palm View Historic District

Morris Lapidus/Mid 20th Century Historic District North Shore Historic District

NATIONAL REGISTER HISTORIC DISTRICTS

Miami Beach Architectural District Normandy Isles Historic District

North Shore Historic District

Collins Waterfront Architectural District

LOCAL HISTORIC SITES

1 Old City Hall Historic Site

2 21st St Recreation Center Historic Site Congregation Beth Jacob Historic Site

Venetian Causeway Historic Site

The Bath Club Historic Site

13 1600 Lenox Ave Historic Site

8 Dade Blvd Fire Station Historic Site

9 PineTree Dr Historic Roadway

14 36 Ocean Dr Historic Site

1700 Alton Rd Historic Site

PROJECT DIRECTORY: OWNER:

PROJECT NAME:

INTERACTIVE DIGITAL INFORMATION KIOSKS DEPLOYMENT PROJECT

JURISDICTION:

CITY OF MIAMI DEPARTMENT OF RESILIENCE AND PUBLIC WORKS MIAMI RIVERSIDE CENTER 444 S.W. 2nd AVENUE, 8th FLOOR MIAMI, FLORIDA 33130

IKE SMART CITY 250 N HARTOFORD AVE COLUMBUS, OH 43222 (614) 589-0087

ENGINEER OF RECORD:

MAINSTREET ENGINEERING 7035 SW 47 STREET, SUITE A MIAMI, FL 33155 (305) 456-3505 PROJ. MGR: VANESSA MELA, P.E. VMELA@MAINSTREETENG.COM

KIOSK MANUFACTURER:

DISPLAY DEVICE INC. 21075 WESTGATE RD. **GOLDEN, CO 80403 CONTACT: ERIC PERKINS** PHONE: (303) 929-4071

UTILITIES:

ELECTRICAL POWER: FLORIDA POWER & LIGHT COMPANY (FPL)

WATER & SEWER: MIAMI-DADE WATER & SEWAGE DEPARTMENT

TELEPHONE: AT&T

CABLE: COMCAST, XFINITY, ATT-UVERSE

GAS: FLORIDA GAS

HISTORIC DISTRICTS

AND SITES


CITY OF

MIAMI BEACH


FLORIDA .

INCORPORATED 1915

Biscayne Bay

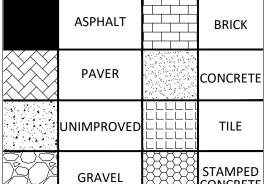

SIDEWALK & STREET SYMBOLS

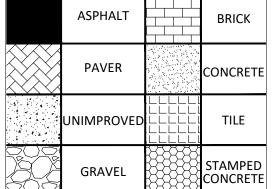

LEGEND AND ABBREVIATIONS

NOTES:

= PALM TREE

= ORNAMENTAL TREE O.R.B.

= OFFICIAL RECORDS BOOK

ELEV. = ELEVATION = TYPICAL = CABLE TELEVISION

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= WATER VALVE

= WATER BOX

= WATER CONNECTION

= WATER MANHOLE = WATER TANK

= WATER WELL = WATER MARKING FLAG

= WATER MARKING SIGN = STORM MANHOLE

= STORM METER = CATCH BASIN

= TELEPHONE MANHOLE = TELEPHONE BOX

= NEWSPAPER DISPENSER

= MAILBOX = SANITARY MANHOLE = SANITARY BOX = SANITARY TANK

= SANITARY LIFT STATION = GREASE TRAP MANHOLE

= CLEANOUT = PARKING METER

= FIBER OPTIC BOX = FIBER OPTIC MARKER SIGN

= MONITORING WELL

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= UNKNOWN UTILITY MARKER FLAG

= SANITARY VALVE = RAILROAD SIGN

= FLAGPOLE = PROPERTY LINE = ELECTRICAL OUTLET

SSA A. M STATE OF FLORIDA SONAL EN

PUBLIC WORKS DEPARTMENT 1700 CONVENTION CENTER DRIVE, MIAMI BEACH, FL.33139

TEL: 305-416-1200

ITY MANAGER: ALINA T. HUDAK JOE GOMEZ, P.E.

VANESSA A. MELA

P F NO 77676

ESIGN ENGINEER: VM DRAWN BY: KM HECKER: WP SCALE:

MIB-020: INDIAN CREEK DRIVE & 41ST STREET

Atlantic

INDEX OF SHEETS

File Name: MIB-020-GENERAL AND FOUNDATION.dwg

P.E. SEAL:

KEY PLAN (NOT TO SCALE)

- 1. ALL CONSTRUCTION ACTIVITIES SHALL BE COMPLETED IN FULL COMPLIANCE WITH THE AMERICANS WITH DISABILITIES ACT (ADA). CLEAR SPACES IN FRONT OF KIOSK SHALL HAVE THE FOLLOWING CHARACTERISTICS:
- 2. SURFACES SHALL BE FIRM, STABLE, AND SLIP RESISTANT AND OTHERWISE COMPLY WITH PROWAG SECTION R302.7 AND SHALL HAVE A RUNNING SLOPE CONSISTENT WITH GRADE OF THE ADJACENT PEDESTRIANT ACCESS ROUTE AND CROSS SLOPE OF 1.50% +/-0.50%)
- 3. SIZE: CLEAR SPACES SHALL BE 48" MINIMUM BY 48" MINIMUM.
- 4. POSITION: UNLESS OTHERWISE SPECIFIED. CLEAR SPACES SHALL BE POSITIONED FOR EITHER FORWARD OR PARALLEL APPROACH TO THE KIOSK.
- 5. APPROACH: ONE FULL UNOBSTRUCTED SIDE OF A CLEAR SPACE SHALL ADJOIN A PEDESTRIAN ACCESS ROUTE OR ADJOIN ANOTHER CLEAR SPACE.
- 6. MANEUVERING SPACE: WHERE A CLEAR SPACE IS CONFINED ON ALL OR PART OF THREE SIDES. ADDITIONAL MANEUVERING SPACE SHALL BE PROVIDED AS FOLLOWS:
- 6.1.1. FORWARD APPROACH: THE CLEAR SPACE AND ADDITIONAL MANEUVERING SPACE SHALL BE 36" WIDE MINIMUM WHERE THE DEPTH OF THE CONFINING ELEMENT EXCEEDS 24".
- 6.1.2. PARALLEL APPROACH: THE CLEAR SPACE AND ADDITIONAL MANEUVERING SPACE SHALL BE 60" WIDE MINIMUM WHERE THE DEPTH OF THE CONFINING ELEMENT EXCEEDS 15".
- 7. THE MINIMUM WHEELCHAIR PASSAGE WIDTH OR CLEAR SPACE WIDTH FOR A SINGLE WHEELCHAIR PASSAGE SHALL BE 48" PER PROWAG SECTION R302.3.
- 8. INITIAL OPERATION FOR THE KIOSK WILL HAVE 4G LTE CONNECTION SECTION R404. TO THE INTERNET.
- 9. THE KIOSKS HAVE BEEN DESIGN TO COMPLY WITH ALL ADA GUIDELINES INCLUDING VIEWING, OPERATION, AND ACCESSIBILITY.
- 10. THE MOBILE IKE EXPERIENCE WILL FOLLOW WEB CONTENT ACCESSIBILITY GUIDELINES (WCAG) TO WORK IN TANDEM WITH THE NATIVE ACCESSIBILITY FEATURES ON THE USER'S MOBILE DEVICE, INCLUDING TALKBACK AND VOICEOVER TOOLS.

SCOPE OF WORK

THE PROJECT CONSIST OF THE INSTALLATION OF ONE (1) DIGITAL INTERACTIVE KIOSKS AT THE LOCATION(S) INDICATED ON THIS PLANS SET. INSTALLER SHALL PROVIDE AND INCLUDE ALL WORKMANSHIP AND MATERIALS NECESSARY TO COMPLETE THE INSTALLATION INCLUDING BUT NOT LIMITED TO:

- 1. INSTALLATION OF THE KIOSKS TO THE FOUNDATION AS INDICATED ON PLANS TO NEW RECTANGULAR CONCRETE FOUNDATION.
- 2. ELECTRICAL SERVICE POINTS ARE EXISTING. CONNECT THE EXISTING ELECTRIC SERVICE TO THE NEW KIOSK AS INDICATED ON PLANS.
- 3. TESTING OF THE ELECTRICAL SERVICE INFRASTRUCTURE SHALL BE PERFORMED IN CONJUNCTION WITH A REPRESENTATIVE OF THE ENGINEER OF RECORD
- 4. THE CONTRACTOR SHALL INSTALL THE KIOSK IN SUCH A WAY THAT THE KIOSK IS WITHIN THE PUBLIC R.O.W. AND IN COMPLIANCE WITH ALL APPLICABLE A.D.A. REQUIREMENTS
- 5. THE LOCATION OF KIOSKS HAS BEEN COORDINATE TO ENSURE THERE IS NO OBSTRUCTION OF THE SIGHT OF VEHICULAR SIGNS.
- 6. STAND-ALONE PEDESTRIAN KIOSKS SHOULD NOT BE INSTALLED WITHIN PEDESTRIAN CIRCULATION PATHS IN A MANNER THAT PERSONS AT THE KIOSK LOCK THE EFFECTIVE WIDTH OF THE PEDESTRIAN TRAVEL WAY.

MONUMENT SIGN SPECIFICATIONS AND FUNCTIONS

THE UNIT CONSISTS OF A UL/NRTL LISTED WEATHER AND VANDAL RESISTANT FREE STANDING ENCLOSURE DESIGNED TO COMPLY WITH THE FLORIDA BUILDING CODE AND OTHER APPLICABLE CODES INCLUDING THE NATIONAL ELECTRICAL CODE. THE UNIT HAS BEEN DESIGNED TO WITHSTAND WINDS OF 165 MPH. THE UNIT'S MAIN COMPONENTS ARE:


NO. DATE

- 1. TWO (2) INTERACTIVE 65" VIDEO TOUCH SCREENS.
- 2. TWO (2) CAMERAS
- 3. ONE (1) CPU
- 4. ONE (1) WI-FI TRANSMITTER

MANUFACTURER: DYNASCAN MODEL NUMBER: CIO651DR5 NATIVE RESOLUTION: 1920 X 1080 **ELECTRICAL POWER REQUIREMENT:** 1. ONE-2-POLE, 20 AMP, 240 VOLTS CIRCUIT.

- 2. TOTAL LOAD: 1400/2200 WATTS (OPERATIONAL/PEAK)
- 3. VOLTAGE: 100-240 VOLTS AC, 50-60 HZ WEIGHT: 832 LBS

CERTIFICATION CE / FCC / RoHS

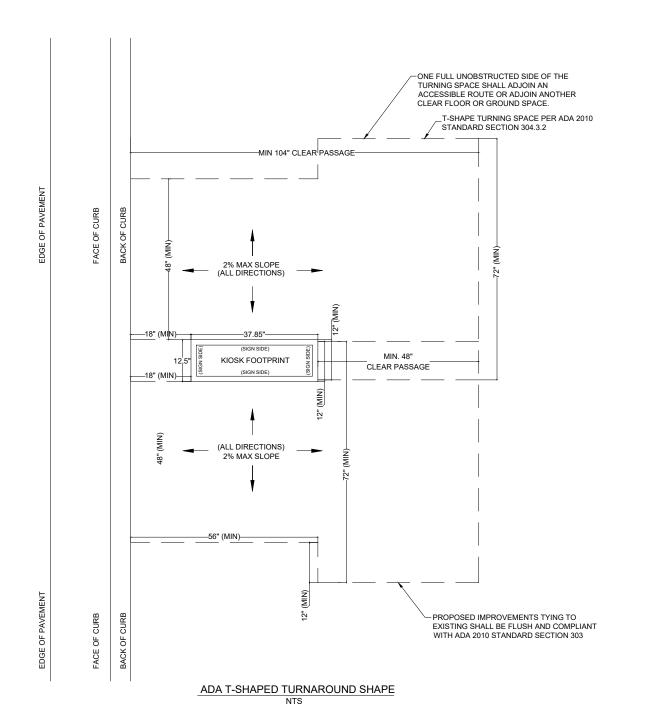



PUBLIC WORKS DEPARTMENT 1700 CONVENTION CENTER DRIVE, MIAMI BEACH, FL.33139

ITY MANAGER: ALINA T. HUDAK JOE GOMEZ, P.E. CITY ENGINEER: CRISTINA ORTEGA CASTINEIRAS, P.E.

VANESSA A. MELA

P F NO 77676

ESIGN ENGINEER: VM DRAWN BY: KM HECKER: WP

SCALE:

MIB-020: INDIAN CREEK DRIVE & 41ST STREET

ADA NOTES, SCOPE OF WORK & KIOSK SPECIFICATIONS

ile Name: MIB-020-GENERAL AND FOUNDATION.dwo

NOTES:


Sheet: 2 of 6





PUBLIC WORKS DEPARTMENT 1700 CONVENTION CENTER DRIVE, MIAMI BEACH, FL.33139


CITY ENGINEER: CRISTINA ORTEGA CASTINEIRAS, P.E.

CIVIL SITE PLAN

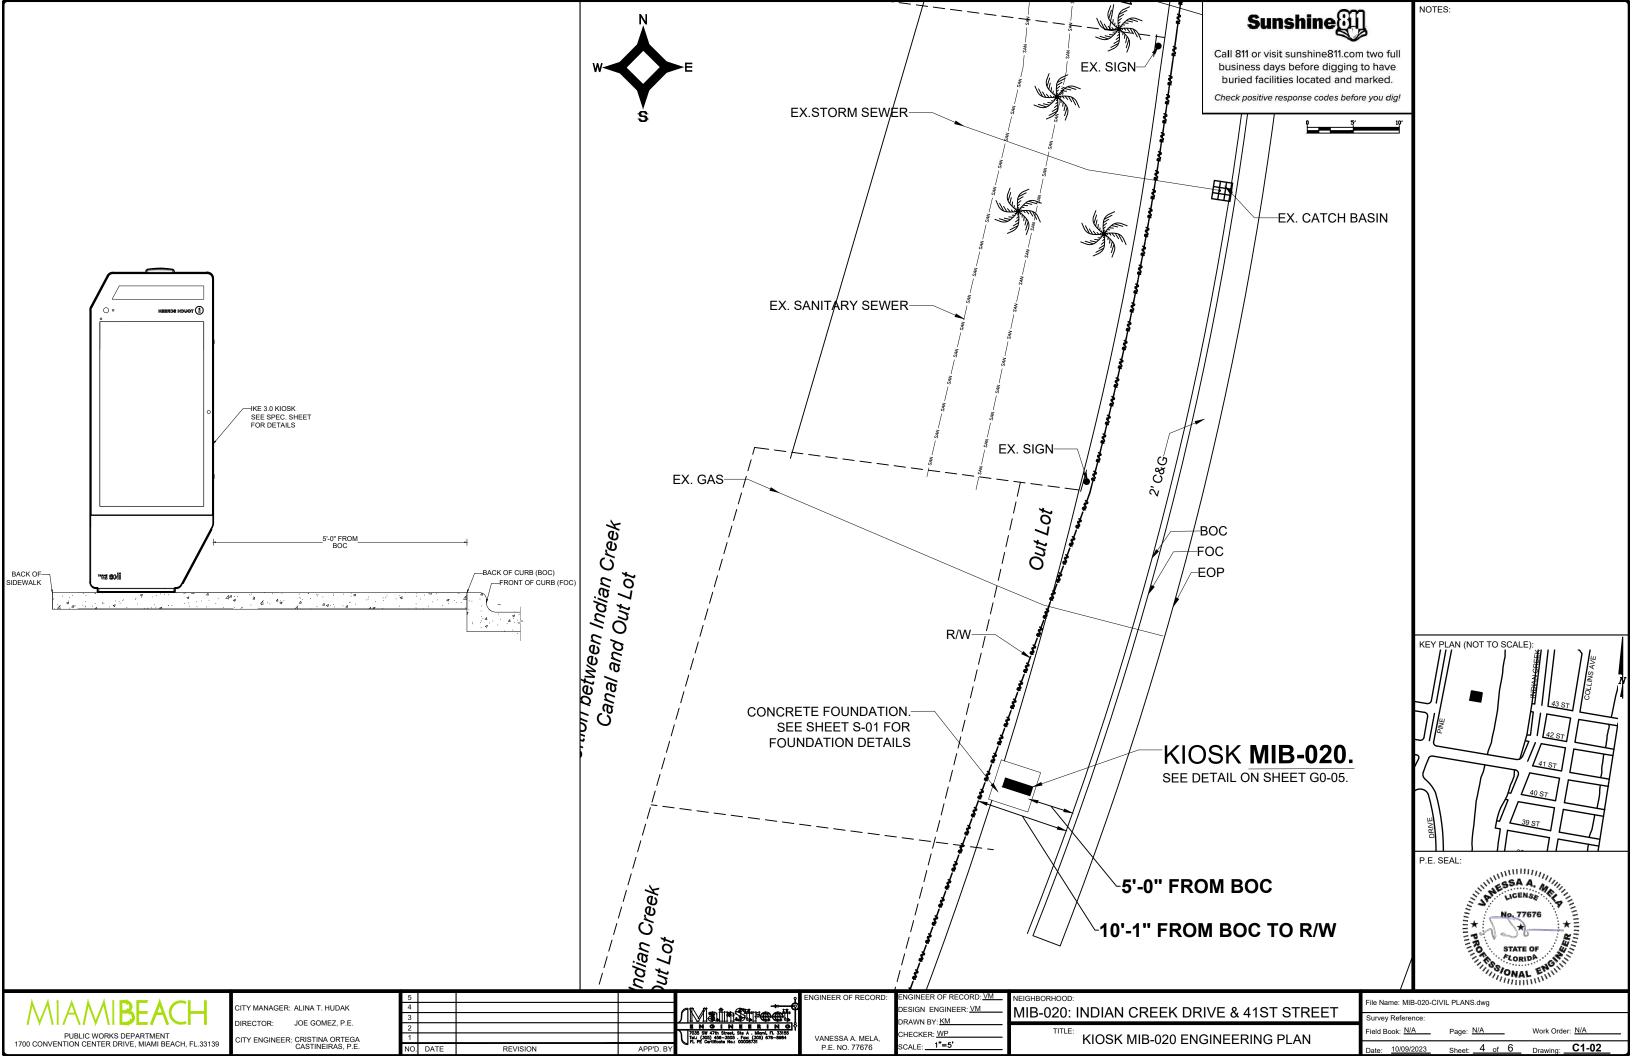

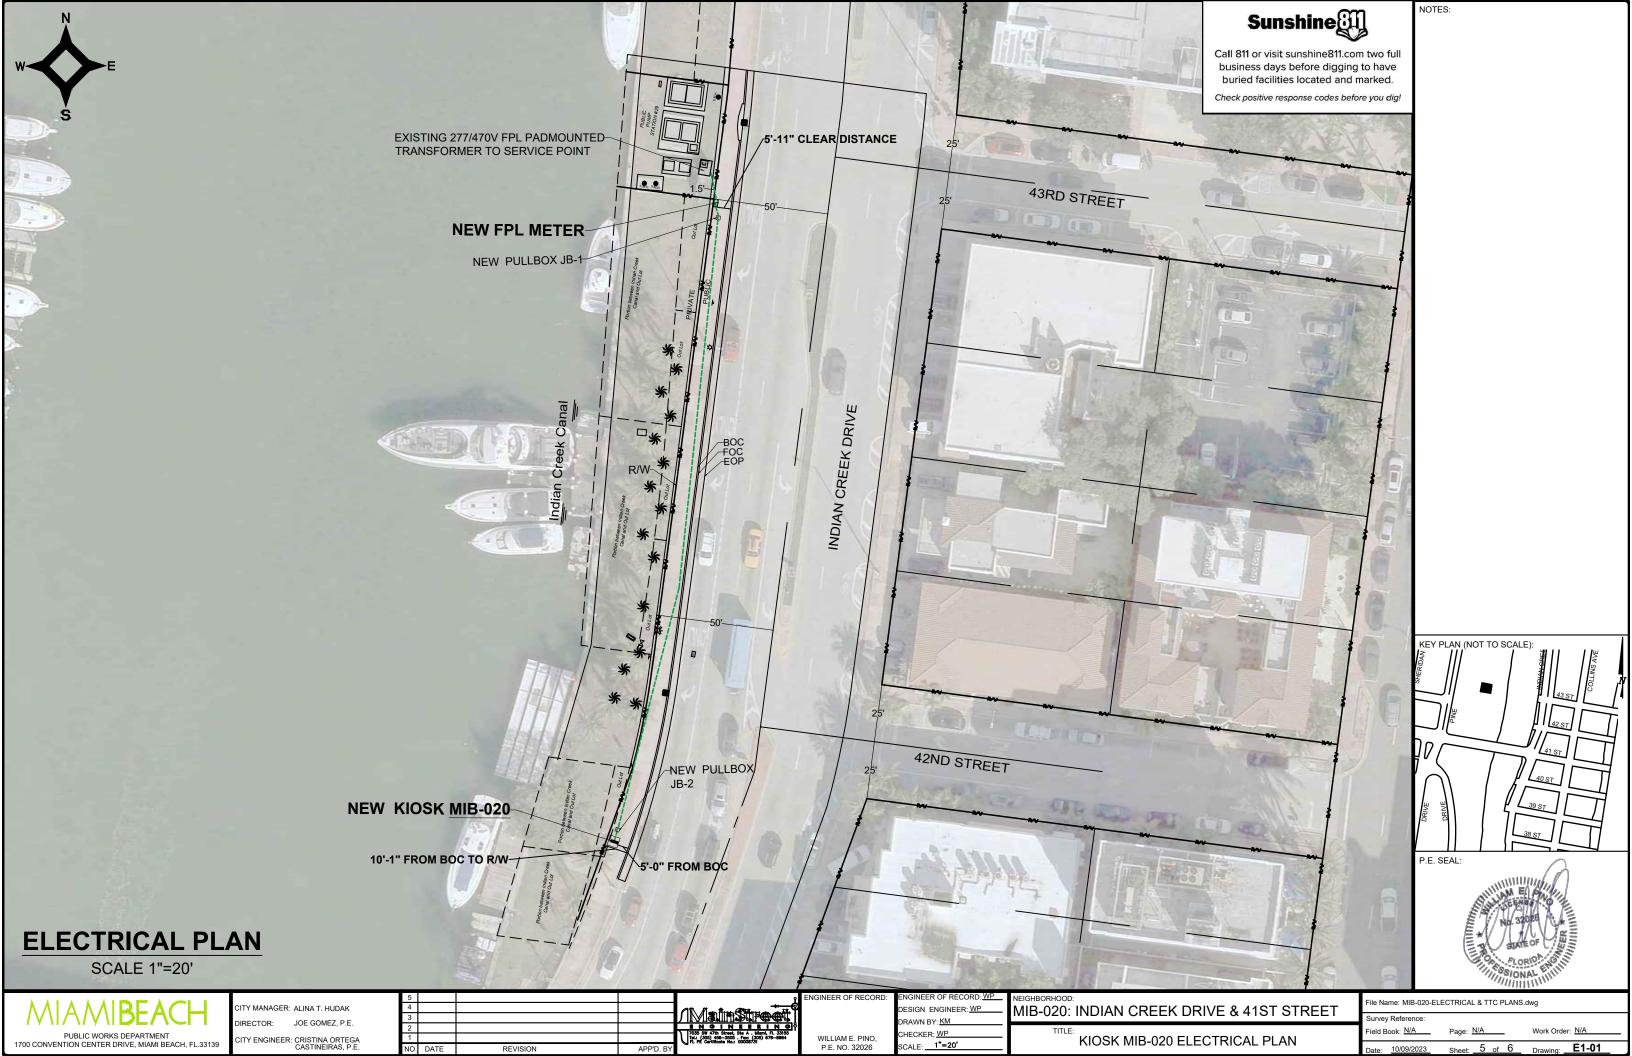

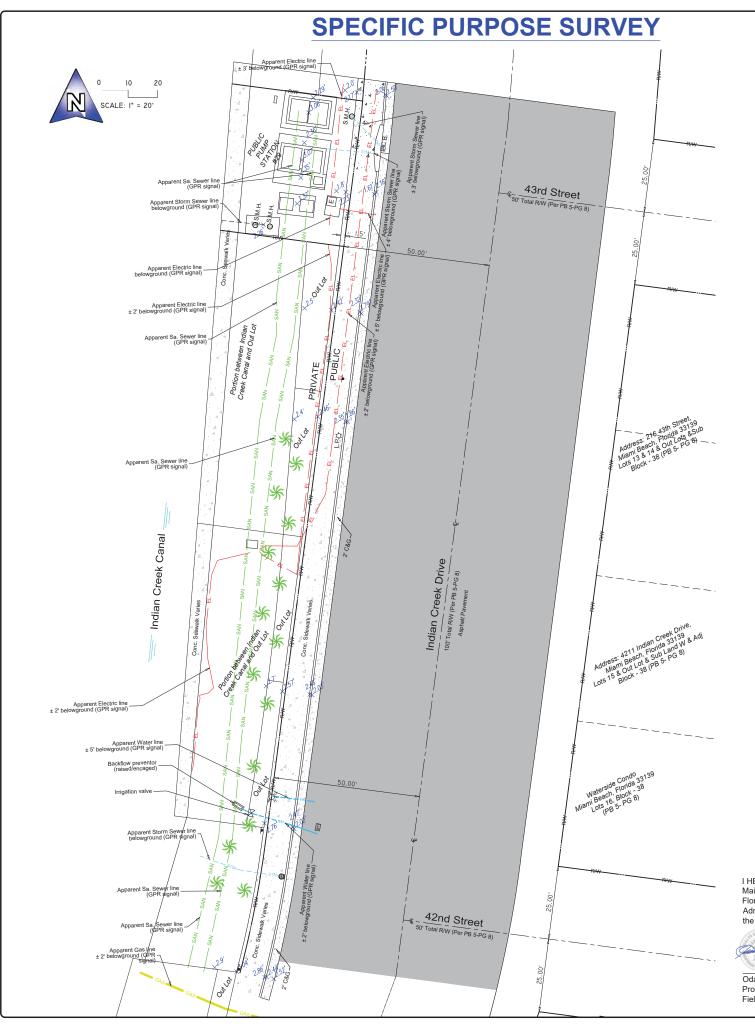

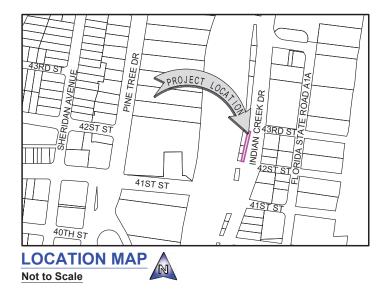

SURVEYOR'S REPORT AND GENERAL NOTES

(Not valid without the attached Survey Map)

- This is not a Boundary Survey.
- These lands are subject to additional restrictions of record that were not furnished to the undersigning registered surveyor. A title search has not been performed by the surveyor.
- North arrow direction is based on an assumed Meridian. Bearings are based on an assumed meridian on a well-established line, said line is being noted as BR on the Survey Map.
- Only above ground improvements are shown herein. Foundations, underground features and utilities have not been located by this surveyor. Refer to SUE effort notes below.

 Survey markers found in the field have no identification unless otherwise shown. Any survey
- marker set by our company is labeled LB 7262 or PSM 6169.
- This Survey Map is intended to be displayed at the scale shown hereon. Data is expressed in U.S.
- This Survey Map is being prepared for the use of the party/parties that it is certified to and does not extend to any unnamed individual, entity or assignee.
- 8. FLOODPLAIN INFORMATION: As scaled from Federal Insurance Rate Map (FIRM) of Community No. 120651 (City of Miami Beach), Panel 0328, Suffix L, revised on Sept 11th, 2009, this real property falls in Zone "AE" with Base Flood Elevation 7 feet (NGVD 1929)
- 9. HORIZONTAL ACCURACY: Accuracy obtained thru measurements and calculations meets and exceeds the minimum horizontal feature accuracy for a Suburban area being equal to 1 foot in 7.
- 10. VERTICAL CONTROL AND ACCURACY: The elevations as shown are referred to the National American Vertical Datum of 1988 (NAVD 1988). The closure in feet, as computed, meets the standard of plus or minus 0.05 feet times the squared root of the loop distance in miles. Elevation are based on a level loop from and to the following official Bench Marks:

Bench Mark # 1: City Miami Beach Bench Mark CMB 42 01 06, Elevation = 2.06 feet (NAVD'88) Bench Mark # 2: City Miami Beach FDOT 87-03-PN01C, Elevation = 3.81 feet (NAVD'88)

11. SUE NOTES:

Subsurface Utility investigation was performed by South Florida Utility Location Services using GPR (Ground Penetrating Radar) and RD (Radiodetection Technology) for designation and location of underground facilities. The horizontal accuracy of this method is +/- 1.5 feet approximately, and is subject to equipment limitations. This Survey depicts the location of the marks indicating the approximate location of the buried pipes and conduits. There might be additional underground facilities not discovered at the time of this survey. Underground utility references as shown on this survey drawing is solely based on information marked on the field by South Florida Utility Location Services for this project. Contact information below:

South Florida Utility Location Services 15323 SW 31st Terrace, Miami, Florida 33185 (786) 547 9086 Office, Emai: rogerh@sf-uls.com, Contact Person: Roger Hasbani

Surveyor is not responsible for any errors or omissions that could arise from the information provided. Call 811 or visit www.sunshine811.com before digging.

- E- E = RED PAINT LINE APPARENT ELECTRIC CONDUIT = BLUE PAINT LINE APPARENT WATER LINE - SAN - = GREEN PAINT LINE APPARENT SANITARY SEWER LINE GAS = YELLOW PAINT LINE APPARENT GAS LINE ____ STM____ = GREEN PAINT LINE APPARENT STORM SEWER LINE

I HEREBY CERTIFY TO:

Main Street Engineering, that this Survey conforms to the Standards of Practice as set forth by the Florida Board of Professional Surveyors and Mappers in applicable provisions of Chapter 5J-17, Florida Administrative Code pursuant to Section 472.027 Florida Statutes. This Survey is accurate and correct to the best of my knowledge and belief



Odalys C. Bello-Iznaga Professional Surveyor and Mapper LS6169 State of Florida Field Work Date: 09/12/2023

Additions and deletions to this Survey Map are prohibited. This Survey Map and Report are not valid without the signature and original raised seal or without the authenticated electronic signature and se of the undersigning Florida licensed Surveyor and Mapper.

Page 1 of 1

MIB-020

Project No. 23258 D.B.: I.C

BELLO LAND SURVEYING
VENUE · SUITE 201 · MIAMI FL 33188
800 · Fax: 305.251.6057 · LB#7262
loland.com · www.bellolandsurveving.com B

BELLO 412230 SW 137 Phone: 305.22 e-mail: info@

LEGEND & ABBREVIATIONS

= STONE

X X = CHAIN LINK FENCE (CLF)

/// = WOOD FENCE (WF)

O = IRON METAL BARS FENCE (IF)

OH = OVERHEAD WIRES

W = WATER VALVE (WV)

= POWER POLE (PP) = GUY ANCHOR WM = WATER METER (WM) = CONC. LIGHT POLE (LP)
= WELL = STREET SIGN

S = SANITARY MANHOLE D = DRAINAGE MANHOLE

= CATCH BASIN OR INLET = EXISTING ELEVATION E = ELECTRIC BOX

= MANHOLE = FIRE HYDRANT = CABLE BOX (CATV) = FPL TRANSFORMER

= PROPERTY CORNER

= BEARING REFERENCE

= PROPERTY LINE

= CENTER LINE

= BASE LINE

MEAS = FIELD MEASURED = PER PLAT PSM = PROFESSIONAL SURVEYOR AND

MAPPER

R/W = RIGHT OF WAY

= TOWNSHIP

= RECORD

ELEV = ELEVATION

SEC = SECTION

R = RANGE CALC = CALCULATED

A/C = AIR CONDITIONER PAD ENCR = ENCROACHEMENT

FF ELEV= FINISHED FLOOR ELEVATION

(XX-XX) = DENOTES PLAT BOOK XX - PAGE X

CBS = CONCRETE BLOCK STRUCTURE

ORB = OFFICIAL RECORD BOOK

= MONUMENT LINE

= TEMPORARY BENCH MARK


BM = BENCH MARK

 PERMANENT CONTROL POINT (PCP) PT = POINT OF TANGENCY PC = POINT OF CURVATURE PCC = POINT OF COMPOUND CURVE PRC = POINT OF REVERSE CURVE

/////// = WOOD DECK

STONE = STONE

1. Indian Creek Drive & W 41st Street

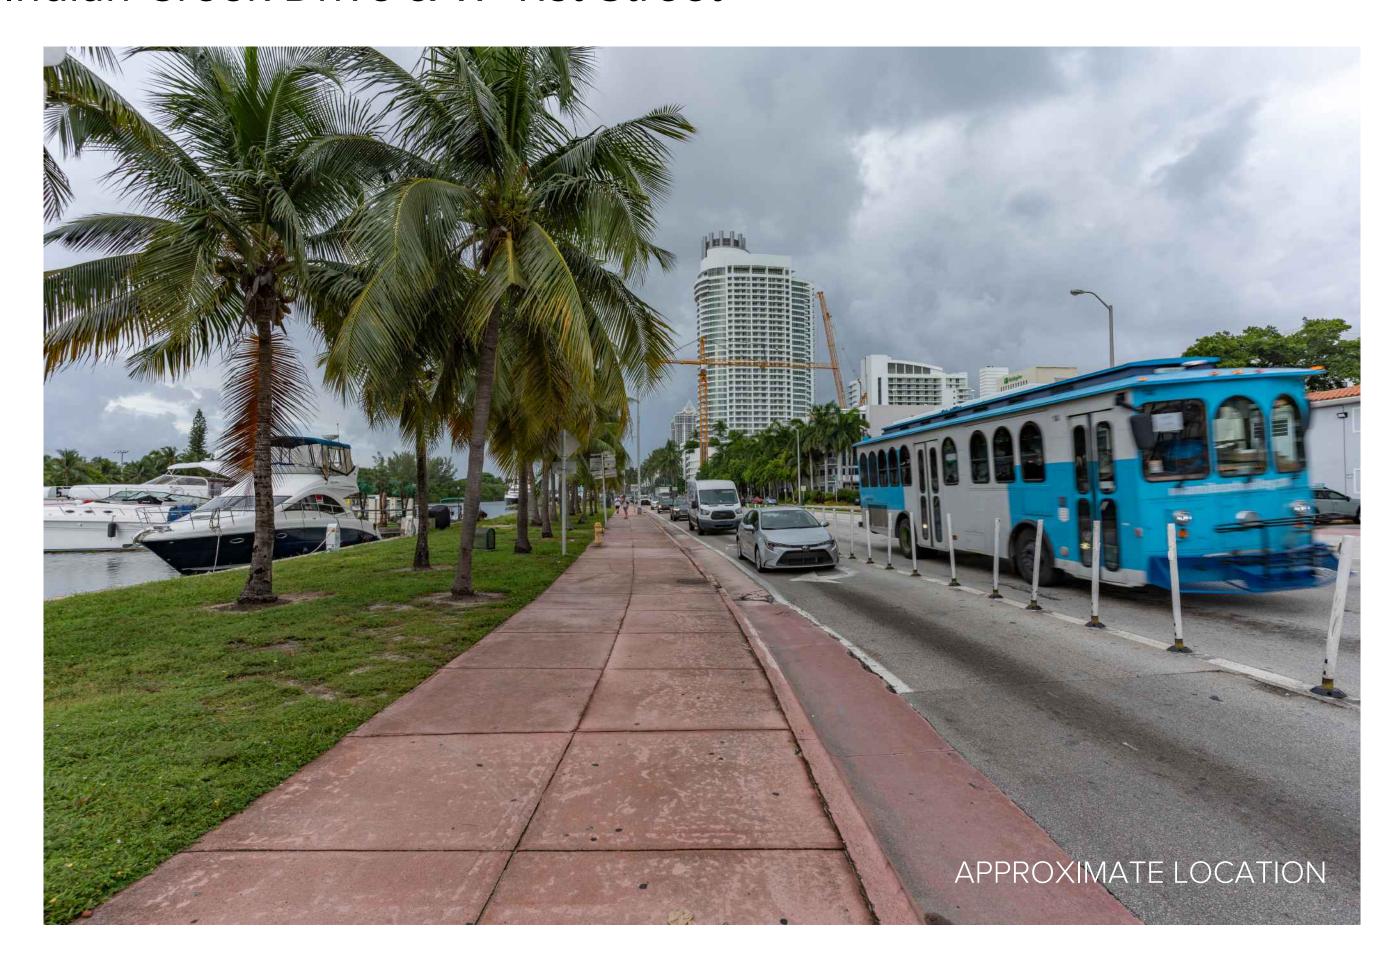

PUBLIC WORKS DEPARTMENT

COLLINS AVENUE (SR-A1A) & 34TH STREET
INTERACTIVE DIGITAL KIOSK DEPLOYMENT PROJECT
OCTOBER 2023
IKE SMART CITY
MIB-025

CITY OF MIAMI BEACH

MAYOR: DAN GELBER

COMMISSIONERS: MICKY STEINBERG

MARK SAMUELIAN MICHAEL GONGORA STEVEN MEINER RICKEY ARRIOLA DAVID RICHARDSON

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FINAL SUBMITTAL 10/09/2023

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MIAMI BEACH FLORIDA . INCORPORATED 1915 Biscayne Bay

HISTORIC DISTRICTS

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CITY OF

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COLLINS WATERFRONT HISTORIC DISTRICT

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1700 Alton Rd Historic Site

CABLE: COMCAST, XFINITY, ATT-UVERSE

PROJECT DIRECTORY:

PROJECT NAME:

INTERACTIVE DIGITAL INFORMATION KIOSKS DEPLOYMENT PROJECT

JURISDICTION:

CITY OF MIAMI DEPARTMENT OF RESILIENCE AND PUBLIC WORKS MIAMI RIVERSIDE CENTER 444 S.W. 2nd AVENUE, 8th FLOOR MIAMI, FLORIDA 33130

OWNER:

IKE SMART CITY 250 N HARTOFORD AVE COLUMBUS, OH 43222 (614) 589-0087

ENGINEER OF RECORD:

MAINSTREET ENGINEERING 7035 SW 47 STREET, SUITE A MIAMI, FL 33155 (305) 456-3505 PROJ. MGR: VANESSA MELA, P.E. VMELA@MAINSTREETENG.COM

KIOSK MANUFACTURER: DISPLAY DEVICE INC.

21075 WESTGATE RD. **GOLDEN, CO 80403 CONTACT: ERIC PERKINS** PHONE: (303) 929-4071

UTILITIES:

ELECTRICAL POWER: FLORIDA POWER & LIGHT COMPANY (FPL)

WATER & SEWER: MIAMI-DADE WATER & SEWAGE DEPARTMENT

TELEPHONE: AT&T

GAS: FLORIDA GAS

SIDEWALK & STREET SYMBOLS **ASPHALT** BRICK **PAVER** CONCRETE UNIMPROVED TILE STAMPED **GRAVEL** CONCRETE

= WATER CONNECTION = WATER WELL = WATER MARKING FLAG = WATER MARKING SIGN W.35 ST = TELEPHONE MANHOLE = TELEPHONE BOX = NEWSPAPER DISPENSER = MAILBOX = SANITARY MANHOLE = SANITARY LIFT STATION = GREASE TRAP MANHOLE P.E. SEAL: = FIBER OPTIC MARKER SIGN = UNKNOWN UTILITY METER = UNKNOWN UTILITY MANHOLE = UNKNOWN UTILITY VALVE = UNKNOWN UTILITY MARKER FLAG

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O.R.B.

ELEV.

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Atlantic

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55A A. M

STATE OF

FLORIDA

SONAL EN

- 1. ALL CONSTRUCTION ACTIVITIES SHALL BE COMPLETED IN FULL COMPLIANCE WITH THE AMERICANS WITH DISABILITIES ACT (ADA). CLEAR SPACES IN FRONT OF KIOSK SHALL HAVE THE FOLLOWING CHARACTERISTICS:
- 2. SURFACES SHALL BE FIRM, STABLE, AND SLIP RESISTANT AND OTHERWISE COMPLY WITH PROWAG SECTION R302.7 AND SHALL HAVE A RUNNING SLOPE CONSISTENT WITH GRADE OF THE ADJACENT PEDESTRIANT ACCESS ROUTE AND CROSS SLOPE OF 1.50% +/-0.50%)
- 3. SIZE: CLEAR SPACES SHALL BE 48" MINIMUM BY 48" MINIMUM.
- 4. POSITION: UNLESS OTHERWISE SPECIFIED. CLEAR SPACES SHALL BE POSITIONED FOR EITHER FORWARD OR PARALLEL APPROACH TO THE KIOSK.
- 5. APPROACH: ONE FULL UNOBSTRUCTED SIDE OF A CLEAR SPACE SHALL ADJOIN A PEDESTRIAN ACCESS ROUTE OR ADJOIN ANOTHER CLEAR SPACE.
- 6. MANEUVERING SPACE: WHERE A CLEAR SPACE IS CONFINED ON ALL OR PART OF THREE SIDES. ADDITIONAL MANEUVERING SPACE SHALL BE PROVIDED AS FOLLOWS:
- 6.1.1. FORWARD APPROACH: THE CLEAR SPACE AND ADDITIONAL MANEUVERING SPACE SHALL BE 36" WIDE MINIMUM WHERE THE DEPTH OF THE CONFINING ELEMENT EXCEEDS 24".
- 6.1.2. PARALLEL APPROACH: THE CLEAR SPACE AND ADDITIONAL MANEUVERING SPACE SHALL BE 60" WIDE MINIMUM WHERE THE DEPTH OF THE CONFINING ELEMENT EXCEEDS 15".
- 7. THE MINIMUM WHEELCHAIR PASSAGE WIDTH OR CLEAR SPACE WIDTH FOR A SINGLE WHEELCHAIR PASSAGE SHALL BE 48" PER PROWAG SECTION R302.3.
- 8. INITIAL OPERATION FOR THE KIOSK WILL HAVE 4G LTE CONNECTION SECTION R404. TO THE INTERNET.
- 9. THE KIOSKS HAVE BEEN DESIGN TO COMPLY WITH ALL ADA GUIDELINES INCLUDING VIEWING, OPERATION, AND ACCESSIBILITY.
- 10. THE MOBILE IKE EXPERIENCE WILL FOLLOW WEB CONTENT ACCESSIBILITY GUIDELINES (WCAG) TO WORK IN TANDEM WITH THE NATIVE ACCESSIBILITY FEATURES ON THE USER'S MOBILE DEVICE, INCLUDING TALKBACK AND VOICEOVER TOOLS.

SCOPE OF WORK

THE PROJECT CONSIST OF THE INSTALLATION OF ONE (1) DIGITAL INTERACTIVE KIOSKS AT THE LOCATION(S) INDICATED ON THIS PLANS SET. INSTALLER SHALL PROVIDE AND INCLUDE ALL WORKMANSHIP AND MATERIALS NECESSARY TO COMPLETE THE INSTALLATION INCLUDING BUT NOT LIMITED TO:

- 1. INSTALLATION OF THE KIOSKS TO THE FOUNDATION AS INDICATED ON PLANS TO NEW RECTANGULAR CONCRETE FOUNDATION.
- 2. ELECTRICAL SERVICE POINTS ARE EXISTING. CONNECT THE EXISTING ELECTRIC SERVICE TO THE NEW KIOSK AS INDICATED ON PLANS.
- 3. TESTING OF THE ELECTRICAL SERVICE INFRASTRUCTURE SHALL BE PERFORMED IN CONJUNCTION WITH A REPRESENTATIVE OF THE ENGINEER OF RECORD
- 4. THE CONTRACTOR SHALL INSTALL THE KIOSK IN SUCH A WAY THAT THE KIOSK IS WITHIN THE PUBLIC R.O.W. AND IN COMPLIANCE WITH ALL APPLICABLE A.D.A. REQUIREMENTS
- 5. THE LOCATION OF KIOSKS HAS BEEN COORDINATE TO ENSURE THERE IS NO OBSTRUCTION OF THE SIGHT OF VEHICULAR SIGNS.
- 6. STAND-ALONE PEDESTRIAN KIOSKS SHOULD NOT BE INSTALLED WITHIN PEDESTRIAN CIRCULATION PATHS IN A MANNER THAT PERSONS AT THE KIOSK LOCK THE EFFECTIVE WIDTH OF THE PEDESTRIAN TRAVEL WAY.

MONUMENT SIGN SPECIFICATIONS AND FUNCTIONS

THE UNIT CONSISTS OF A UL/NRTL LISTED WEATHER AND VANDAL RESISTANT FREE STANDING ENCLOSURE DESIGNED TO COMPLY WITH THE FLORIDA BUILDING CODE AND OTHER APPLICABLE CODES INCLUDING THE NATIONAL ELECTRICAL CODE. THE UNIT HAS BEEN DESIGNED TO WITHSTAND WINDS OF 165 MPH. THE UNIT'S MAIN COMPONENTS ARE:


NO. DATE


- 1. TWO (2) INTERACTIVE 65" VIDEO TOUCH SCREENS.
- 2. TWO (2) CAMERAS
- 3. ONE (1) CPU
- 4. ONE (1) WI-FI TRANSMITTER

MANUFACTURER: DYNASCAN MODEL NUMBER: CIO651DR5 NATIVE RESOLUTION: 1920 X 1080 **ELECTRICAL POWER REQUIREMENT:** 1. ONE-2-POLE, 20 AMP, 240 VOLTS CIRCUIT.


- 2. TOTAL LOAD: 1400/2200 WATTS (OPERATIONAL/PEAK)
- 3. VOLTAGE: 100-240 VOLTS AC, 50-60 HZ WEIGHT: 832 LBS

CERTIFICATION CE / FCC / RoHS

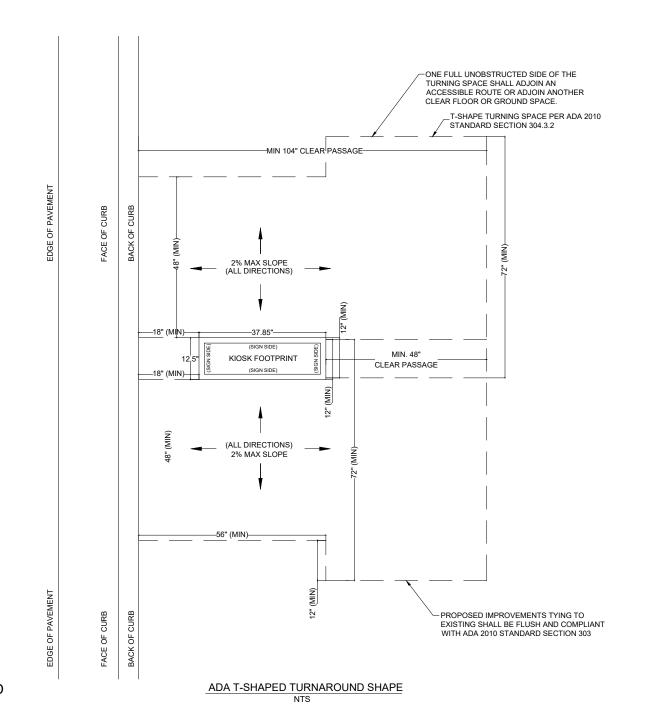


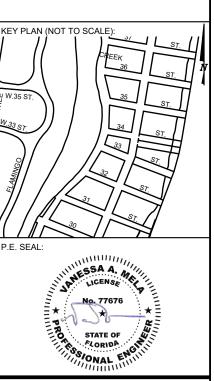



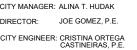



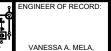

P F NO 77676

ESIGN ENGINEER: VM DRAWN BY: KM HECKER: WP

SCALE:


MIB-025: COLLINS AVENUE & 34TH STREET

ADA NOTES, SCOPE OF WORK & KIOSK SPECIFICATIONS


ile Name: MIB-025-GENERAL AND FOUNDATION.dwo

NOTES:



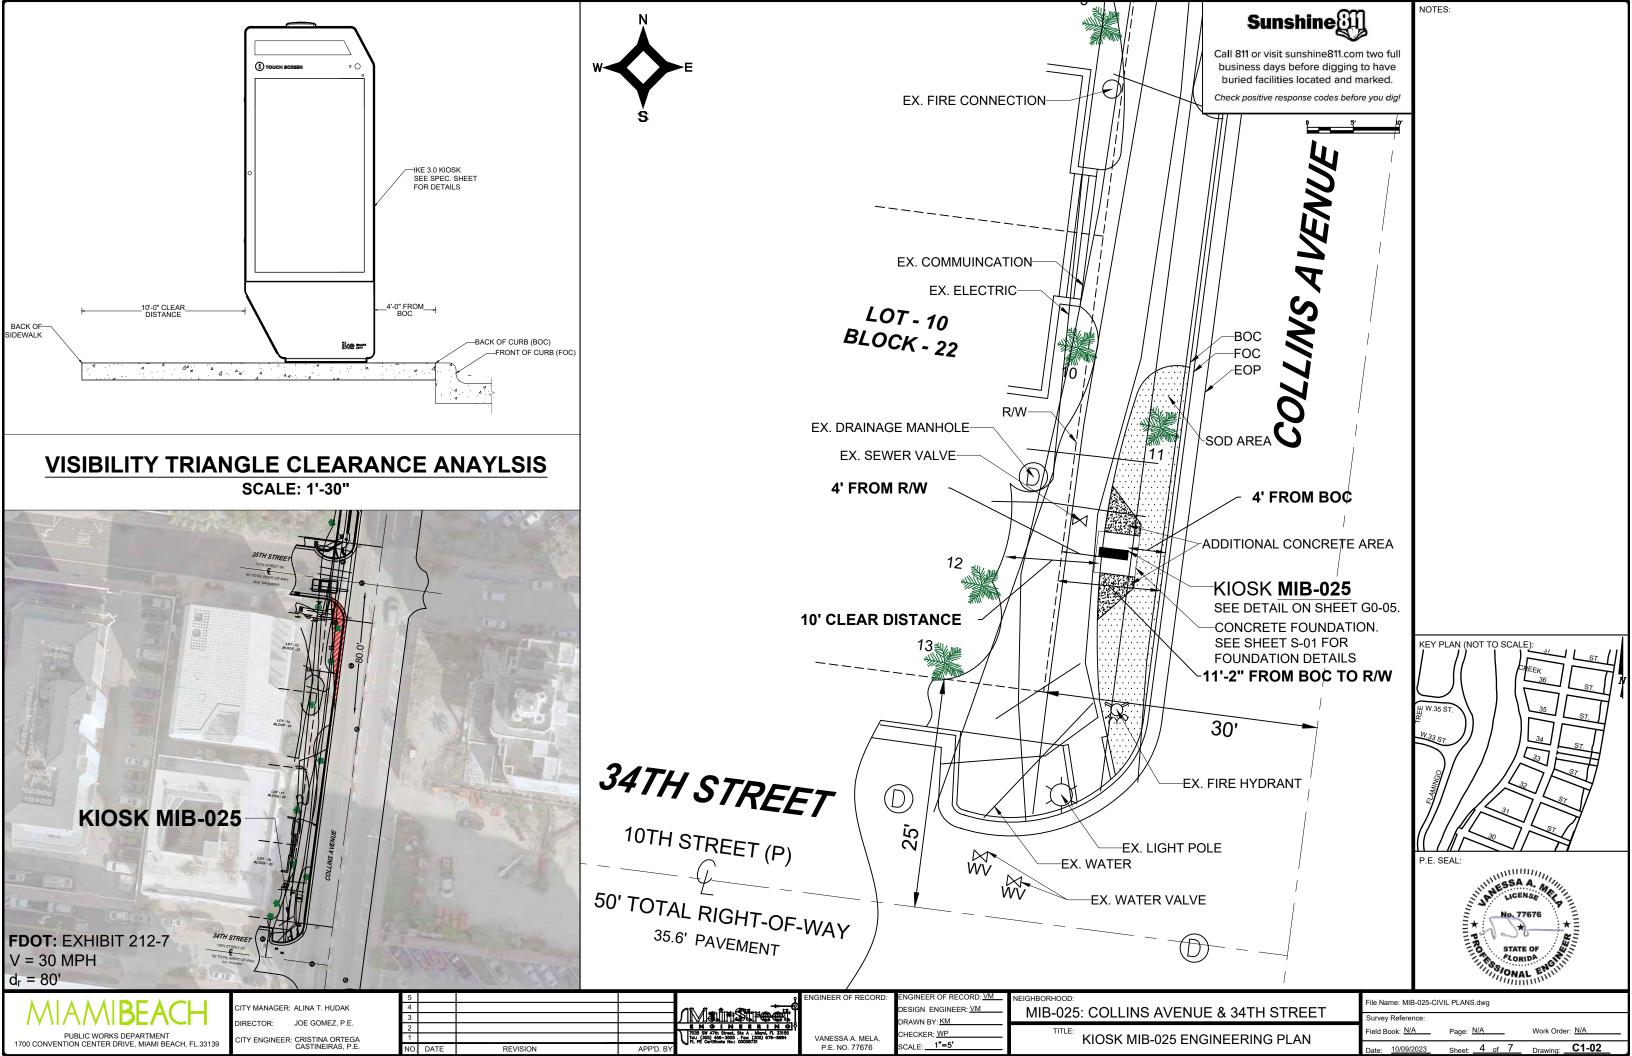




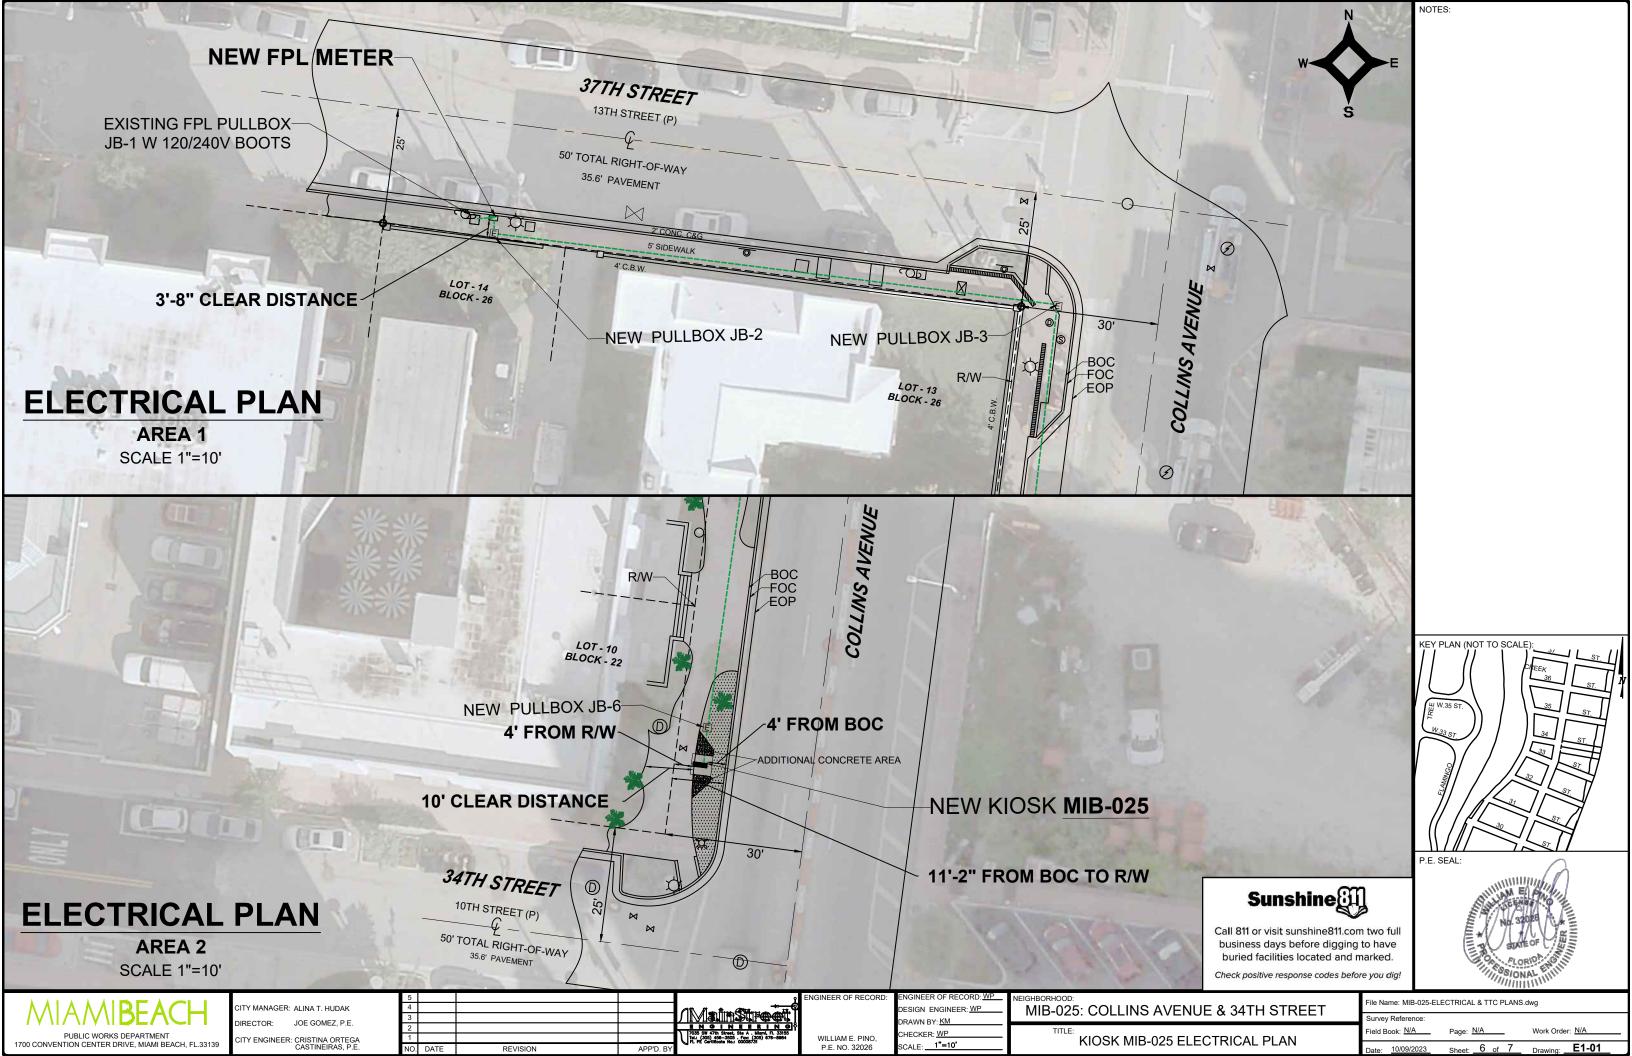

MAP OF SPECIFIC PURPOSE SURVEY

OF A PORTION OF "COLLINS AVENUE" AND "37TH STREET" Survey Pros, Inc.

4348 SW 74TH AVENUE, MIAMI, FL. 33155 Tel: 305.767.6802 www.survey-pros.com

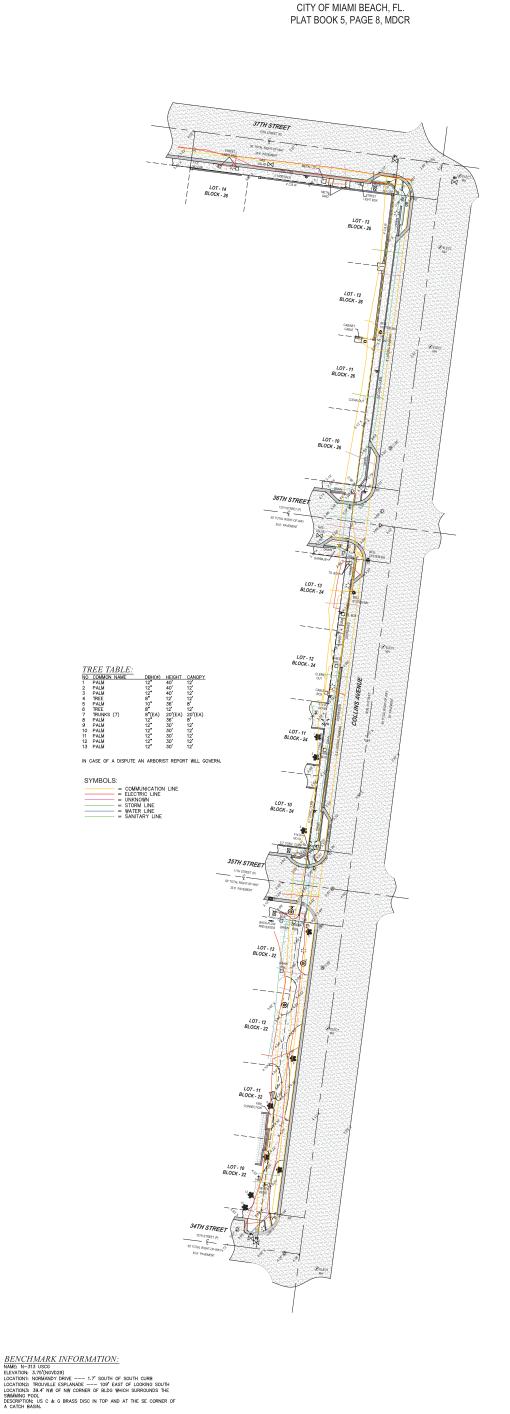

<u>LEGEND</u> ABBREVIATIONS:

ABBREVIATIONS:

A = ARC DISTANCE
AC = AR CONDITIONER PAD
BOR = BROWARD COUNTY RECORDS
BUD = BLULDING
BUD = BLULDING
BOB = BASS OF
BOB = BASS OF
BOB = BASS OF
CONCRETE BLOCK & STUCCO
(O) = CALCULA TEUTER
CLF = OFAIN LINK FENE
CL = OFAIN LINK FENE
CL = COLOR EL STUCCO
(D) = CALCULA TEUTER
CLF = OFAIN LINK FENE
CL = COLOR EL STUCCO
(D) = CALCULA TEUTER
CLF = OFAIN LOW ENSEMBLY
DE STUCKE STUCKE STUCKE
DE STUCKE STUCK

FIP = FOUND IRON PIPE (NO ID)
FIR = FOUND INTO ROY ROY (NO ID)
FIP = FOUND INTO ROY (NO ID)
FIR = FOUND

ULE - UTILITY EASENT
W/F = WOOD FENCE

SYMBOLS:

III = TELEPHONE RISER

III = WHITE PHERE

1"=30'



FLOOD ZONE INFORMATION:
THE GRAPHICALLY DEPICTED BUILDING(S) SHOWN ON THIS MAP OF SURFRY'S WITHIN ZONE AE.
BASE FLOOD ELEVATION, T.
COMMUNITY NAME & NUMBER 1208603386 SUFFIX L.
MAP & PANEL NUMBER 1208603386 SUFFIX L.

BASE HOUSEN LANGER DITY OF MAM. BEACH 120861

WAY & PARKE NAMERS 12086203S SHIPN L

SURVEYOR'S NOTES:

1. ELEVATIONS WERE SHOWN BEEFE TO 1929 NATIONAL

SURVEYOR'S NOTES:

1. ELEVATIONS HERE SHOWN BEEFE TO 1929 NATIONAL

LONG ATTEMPT WAS MADE TO LOCATE POOTINGS/FOUNDATIONS,
OR UNDERGROUND UTILITIES UNLESS OTHERWISE NOTED.

S. THE LANDS SHOWN HEREON LANGE NOTED.

S. THE LANDS SHOWN HEREON LAND IS NOT TRANSFERABLE OR

ASSIGNABLE WHOLL WHITTEN CONSENT OF THIS SURVEY ARE

BASED ON THE LEGAL DESCRIPTION PROVIDED BY THE CUENT

OF THE LEGAL DESCRIPTION PROVIDED BY THE CUENT

OF THE LEGAL DESCRIPTION PROVIDED BY THE CUENT

OF THE LEGAL DESCRIPTION PROVIDED STATES ONLY IN THE LEGAL DESCRIPTION PROVIDED BY THE CUENT

OF THE LEGAL DESCRIPTION PROVIDED

CERTIFIED TO:

NICOLAS DEL VENTO PROFESSIONAL SURVEYOR & MAPPER STATE OF FLORIDA LIC. # 6945

JOB NUMBER: 230910046 SEAL CAD FILE: MAIN STREET ENGINEERING SHEET 1 OF 1

REVISION(S):

2. Collins Ave & 34th Street



PUBLIC WORKS DEPARTMENT

COLLINS AVENUE (SR-A1A) & 23RD STREET
INTERACTIVE DIGITAL KIOSK DEPLOYMENT PROJECT
OCTOBER 2023
IKE SMART CITY
MIB-022

CITY OF MIAMI BEACH

MAYOR: DAN GELBER

COMMISSIONERS: MICKY STEINBERG

MARK SAMUELIAN MICHAEL GONGORA STEVEN MEINER RICKEY ARRIOLA DAVID RICHARDSON


CITY MANAGER: ALINA T. HUDAK

CITY ATTORNEY: RAFAEL A. PAZ

PUBLIC WORKS DIRECTOR: JOE GOMEZ, P.E., F.FES

CITY ENGINEER: NELSON PEREZ-JACOME, PE



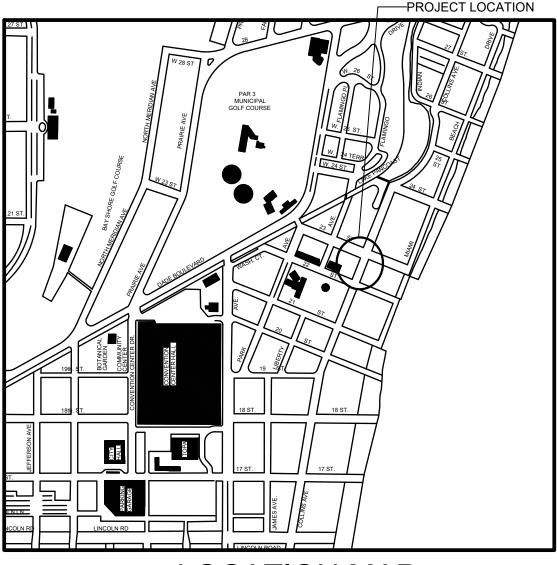

LOCATION MAP



INDEX OF PLANS						
NUMBER	DISCIPLINE	SHEET NO.	DESCRIPTION	NOTES		
1	GENERAL	G0-03	INDEX OF SHEETS			
2	GENERAL	G0-04	ADA NOTES, SCOPE OF WORK & KIOSK SPECIFICATIONS			
3	CIVIL	C1-01	CIVIL SITE PLAN			
4	CIVIL	C1-02	KIOSK MIB-022 ENGINEERING PLAN			
5	ELECTRICAL	E1-01	KIOSK MIB-022 ELECTRICAL PLAN			
6	SURVEY		KIOSK MIB-022 SITE SURVEY			

SCOPE OF WORK: THE PROJECT CONSISTS OF THE INSTALLATION OF ONE (1) DIGITAL INTERACTIVE KIOSK AND APPLICABLE INFRASTRUCTURE; STRUCTURAL FOUNDATION AND ELECTRICAL SERVICE AT THE LOCATION INDICATED ON THESE DESIGN PLANS.

FINAL SUBMITTAL 10/09/2023

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PROJECT LOCATION

COLLINS WATERFRONT HISTORIC DISTRICT

LOCAL HISTORIC DISTRICTS

Espanola Way Historic District Altos del Mar Historic District

Flamingo Park Historic District

Ocean Drive/Collins Avenue Historic Dis

Ocean Beach Historic District Harding Townsite Historic District Collins Waterfront Historic District

Palm View Historic District

Morris Lapidus/Mid 20th Century Historic District North Shore Historic District

NATIONAL REGISTER HISTORIC DISTRICTS

Miami Beach Architectural District

Normandy Isles Historic District North Shore Historic District

Collins Waterfront Architectural District

6 Sunset Island Bridges Historic Structures

LOCAL HISTORIC SITES

2 21st St Recreation Center Historic Site

Congregation Beth Jacob Historic Site

Venetian Causeway Historic Site

1 Old City Hall Historic Site

The Bath Club Historic Site

KIOSK MANUFACTURER: DISPLAY DEVICE INC.

21075 WESTGATE RD. **GOLDEN, CO 80403**

CONTACT: ERIC PERKINS PHONE: (303) 929-4071

UTILITIES:

ELECTRICAL POWER: FLORIDA POWER & LIGHT COMPANY (FPL)

WATER & SEWER: MIAMI-DADE

TELEPHONE: AT&T

8 Dade Blvd Fire Station Historic Site

9 PineTree Dr Historic Roadway

13 1600 Lenox Ave Historic Site

36 Ocean Dr Historic Site

1700 Alton Rd Historic Site

CABLE: COMCAST, XFINITY, ATT-UVERSE

GAS: FLORIDA GAS

HISTORIC DISTRICTS

AND SITES

CITY OF

MIAMI BEACH

FLORIDA .

INCORPORATED 1915

Biscayne Bay

SIDEWALK & STREET SYMBOLS **ASPHALT** BRICK **PAVER** CONCRETE UNIMPROVED TILE STAMPED **GRAVEL**

= RECORD = CALCULATED = MEASURE = LICENSE BUSINESS = LENGTH = CENTRAL ANGLE = RADIUS = TANGENT = POINT OF TANGENCY = POINT OF CURVATURE = STATION = POINT OF INTERSECTION = IDENTIFICATION = METAL LIGHT POLE = SECTION LINE = CENTERLINE = MONUMENT LINE = TRAFFIC SIGNAL BOX = TRAFFIC SIGNAL CABINET = BOLLARD = PEDESTRIAN SIGNAL = TRAFFIC SIGNAL MAST ARM = SIGN = CABLE TELEVISION BOX = LIGHT POLE = ELECTRIC BOX = UTILITY POLE = ELECTRIC TRANSFORMER = GUY ANCHOR = ELECTRIC MANHOLE = ELECTRIC METER = GAS VALVE = GAS UTILITY BOX = GAS MANHOLE = GAS TANK = GAS METER = COMMUNICATION BOX = COMMUNICATION MANHOLE = GARBAGE RECEPTACLE = HANDICAP PARKING SPACE = WATER METER = IRRIGATION VALVE = WATER VALVE

LEGEND AND ABBREVIATIONS

= ORNAMENTAL TREE

= OFFICIAL RECORDS BOOK

= OVERHEAD ELECTRIC LINE = SPOT ELEVATION

= CONCRETE = CONCRETE BLOCK STUCCO = CHAIN LINK FENCE

= METAL FENCE = REINFORCED CONCRETE PIPE

= PALM TREE

= ELEVATION

= WOOD FENCE

= FINISH FLOOR


= TYPICAL = CABLE TELEVISION

O.R.B.

ELEV.

NOTES:

= WATER BOX = WATER CONNECTION = WATER MANHOLE = WATER TANK = WATER WELL = WATER MARKING FLAG = WATER MARKING SIGN = STORM MANHOLE = STORM METER = CATCH BASIN = TELEPHONE MANHOLE = TELEPHONE BOX = NEWSPAPER DISPENSER = MAILBOX = SANITARY MANHOLE = SANITARY BOX = SANITARY TANK = SANITARY LIFT STATION = GREASE TRAP MANHOLE = CLEANOUT = PARKING METER = FIBER OPTIC BOX = FIBER OPTIC MARKER SIGN = MONITORING WELL = UNKNOWN UTILITY METER = UNKNOWN UTILITY MANHOLE = UNKNOWN UTILITY VALVE = UNKNOWN UTILITY MARKER FLAG = SANITARY VALVE = RAILROAD SIGN = FLAGPOLE = PROPERTY LINE = ELECTRICAL OUTLET

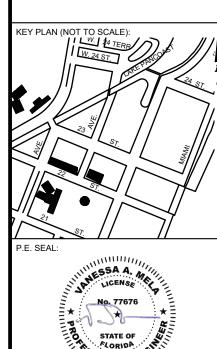

PROJECT DIRECTORY:

PROJECT NAME:

INTERACTIVE DIGITAL INFORMATION KIOSKS DEPLOYMENT PROJECT

JURISDICTION:

CITY OF MIAMI DEPARTMENT OF RESILIENCE AND PUBLIC WORKS MIAMI RIVERSIDE CENTER 444 S.W. 2nd AVENUE, 8th FLOOR MIAMI, FLORIDA 33130 TEL: 305-416-1200

OWNER:

IKE SMART CITY 250 N HARTOFORD AVE COLUMBUS, OH 43222 (614) 589-0087

ENGINEER OF RECORD: MAINSTREET ENGINEERING

7035 SW 47 STREET, SUITE A MIAMI, FL 33155 (305) 456-3505 PROJ. MGR: VANESSA MELA, P.E. VMELA@MAINSTREETENG.COM

WATER & SEWAGE DEPARTMENT

ESIGN ENGINEER: VM DRAWN BY: KM

MIB-022: COLLINS AVENUE & 23RD STREET

CONCRETE

Atlantic

File Name: MIB-022-GENERAL AND FOUNDATION.dwg

SONAL EN

PUBLIC WORKS DEPARTMENT 1700 CONVENTION CENTER DRIVE, MIAMI BEACH, FL.33139 ITY MANAGER: ALINA T. HUDAK JOE GOMEZ, P.E.

VANESSA A. MELA P F NO 77676

HECKER: WP SCALE:

INDEX OF SHEETS

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MONUMENT SIGN SPECIFICATIONS AND FUNCTIONS


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- 1. TWO (2) INTERACTIVE 65" VIDEO TOUCH SCREENS.
- 2. TWO (2) CAMERAS
- 3. ONE (1) CPU
- 4. ONE (1) WI-FI TRANSMITTER

MANUFACTURER: DYNASCAN MODEL NUMBER: CIO651DR5 NATIVE RESOLUTION: 1920 X 1080 **ELECTRICAL POWER REQUIREMENT:**

- 1. ONE-2-POLE, 20 AMP, 240 VOLTS CIRCUIT.
- 2. TOTAL LOAD: 1400/2200 WATTS (OPERATIONAL/PEAK)
- 3. VOLTAGE: 100-240 VOLTS AC, 50-60 HZ WEIGHT: 832 LBS

CERTIFICATION CE / FCC / RoHS

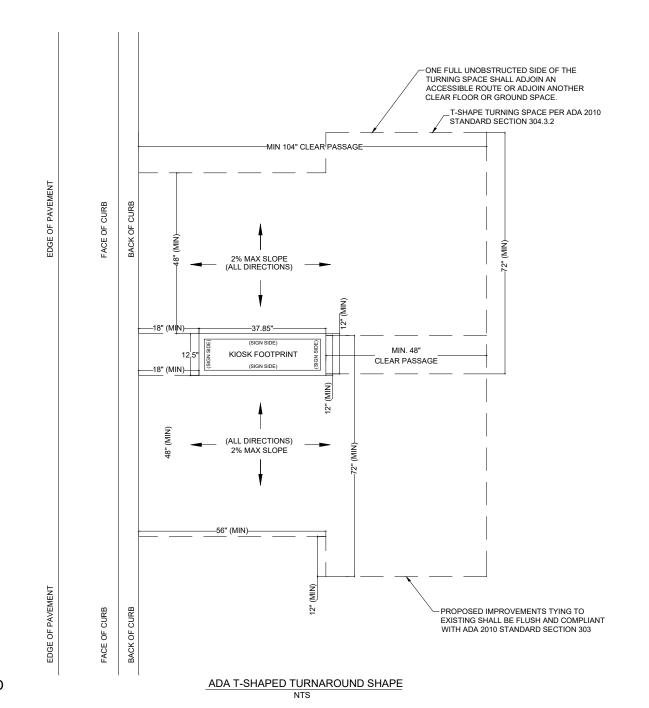

SSA A. STATE OF FLORID

KEY PLAN (NOT TO SCALE):

PUBLIC WORKS DEPARTMENT 1700 CONVENTION CENTER DRIVE, MIAMI BEACH, FL.33139

ITY MANAGER: ALINA T. HUDAK JOE GOMEZ, P.E. CITY ENGINEER: CRISTINA ORTEGA CASTINEIRAS, P.E. NO. DATE

VANESSA A. MELA

P F NO 77676

ESIGN ENGINEER: VM DRAWN BY: KM HECKER: WP SCALE:


MIB-022: COLLINS AVENUE & 23RD STREET


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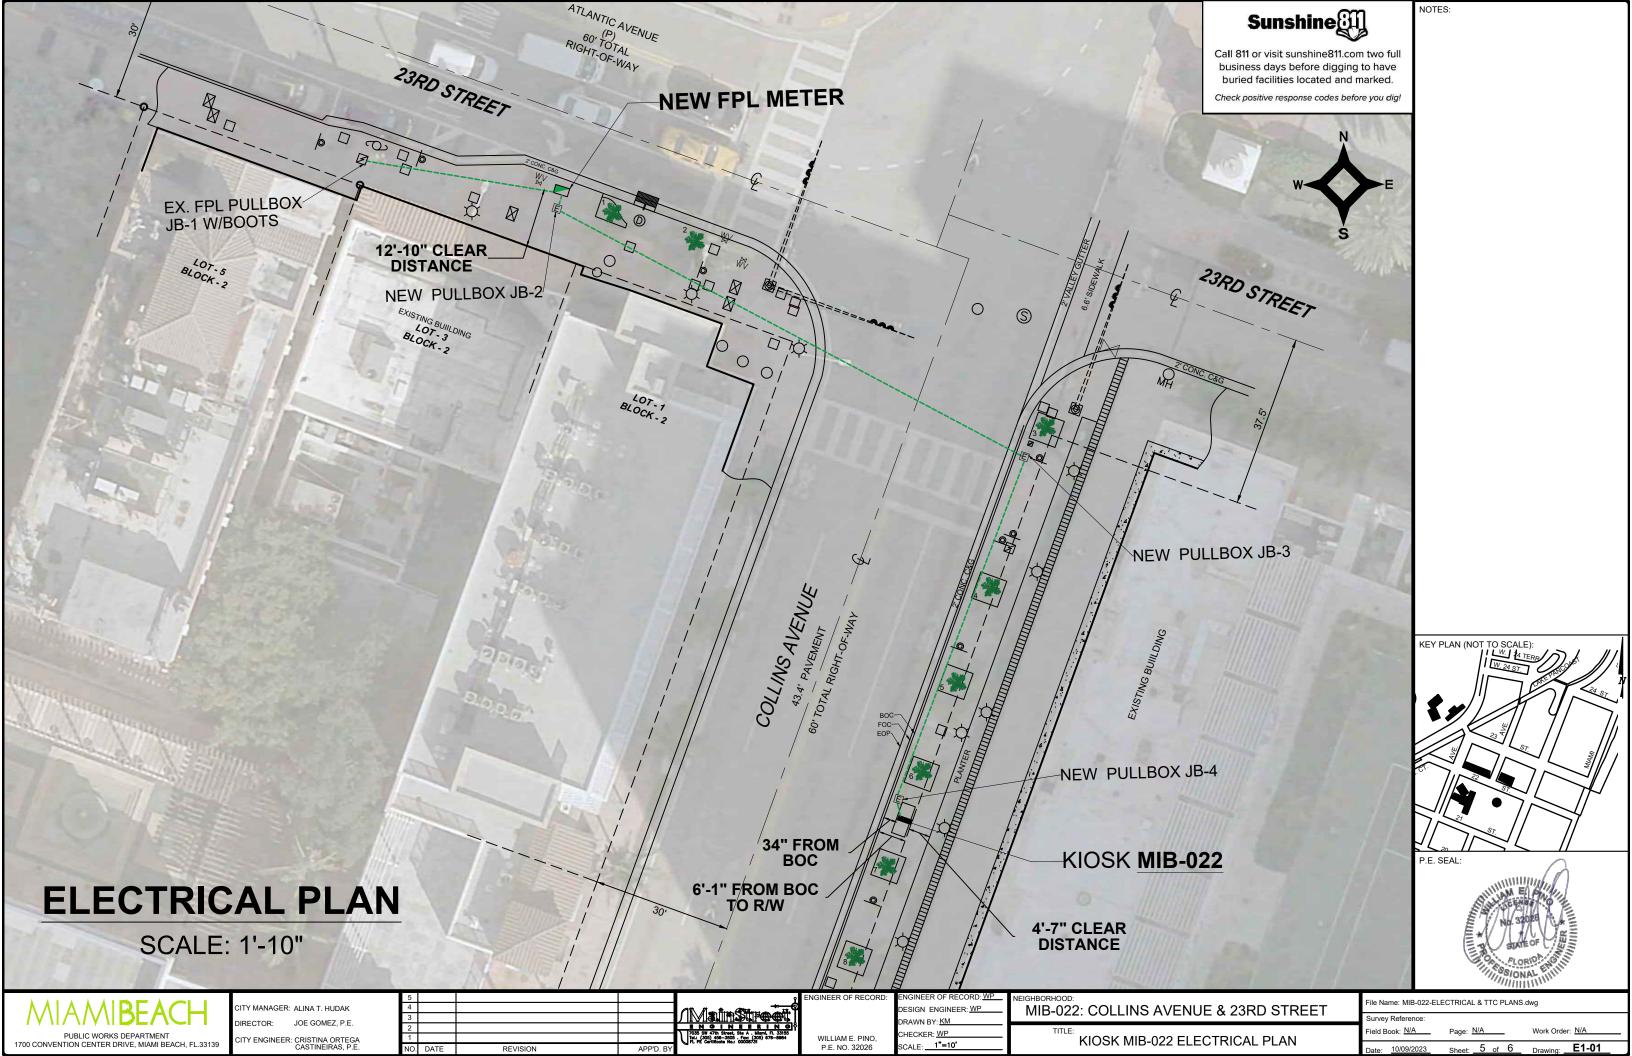
ile Name: MIB-022-GENERAL AND FOUNDATION.dwo

NOTES:

2 of 6



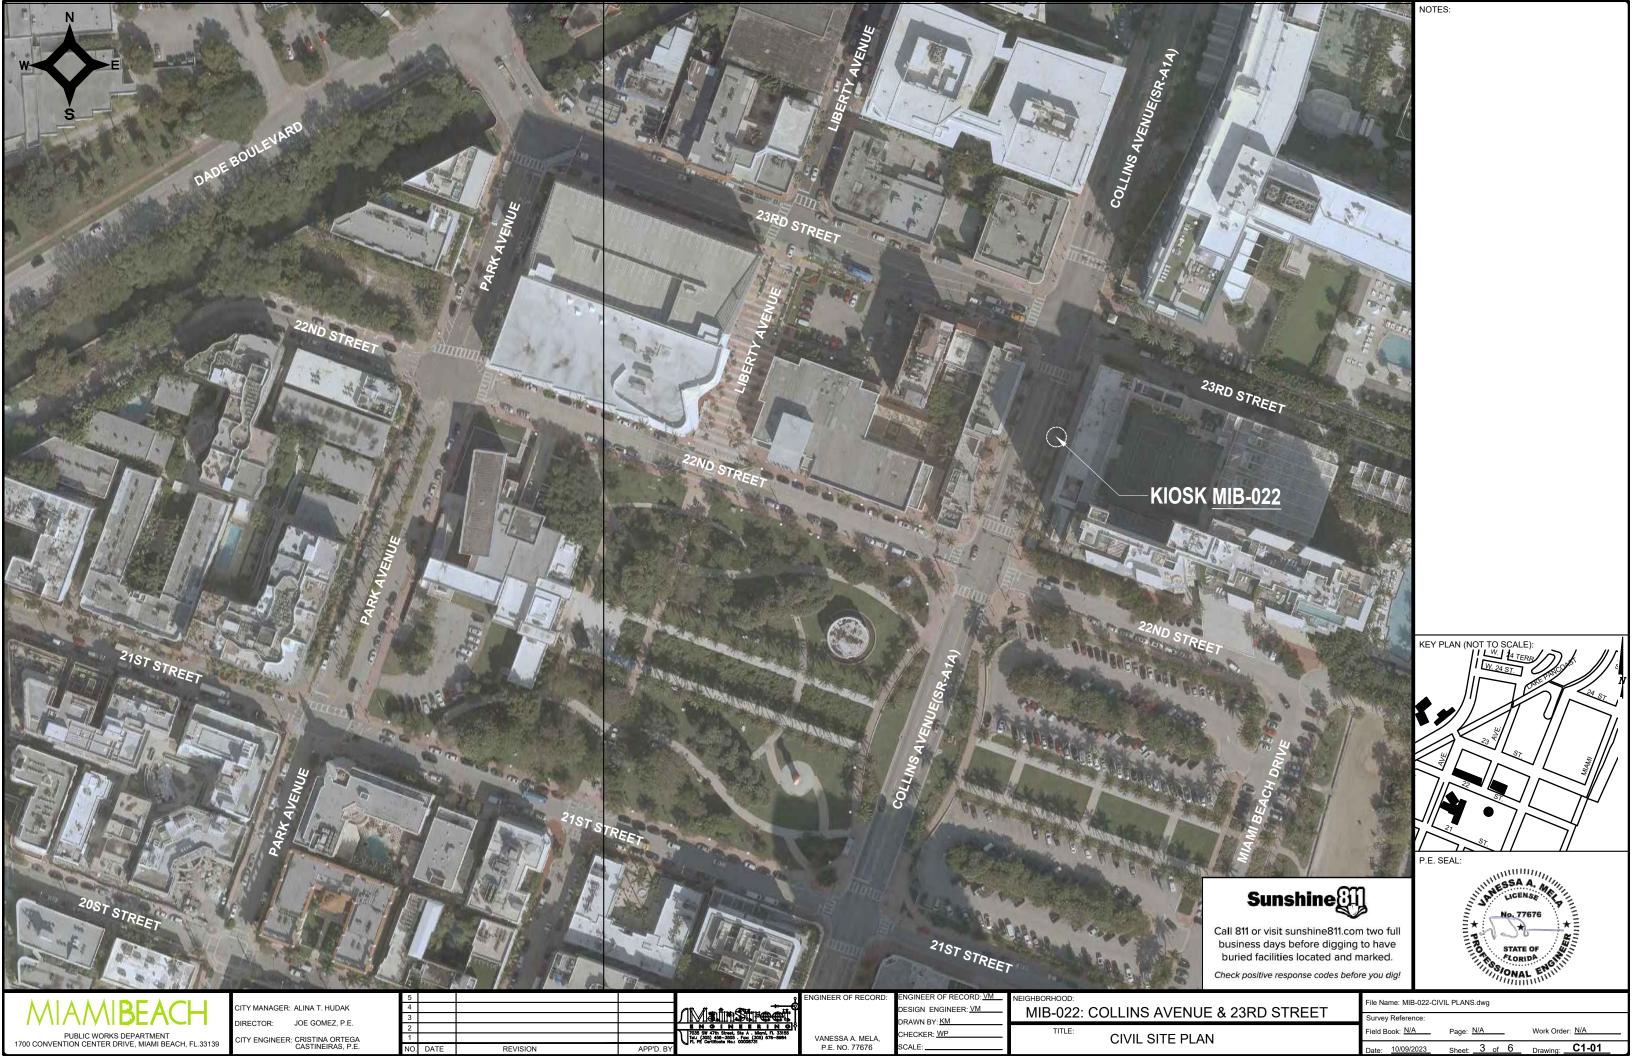

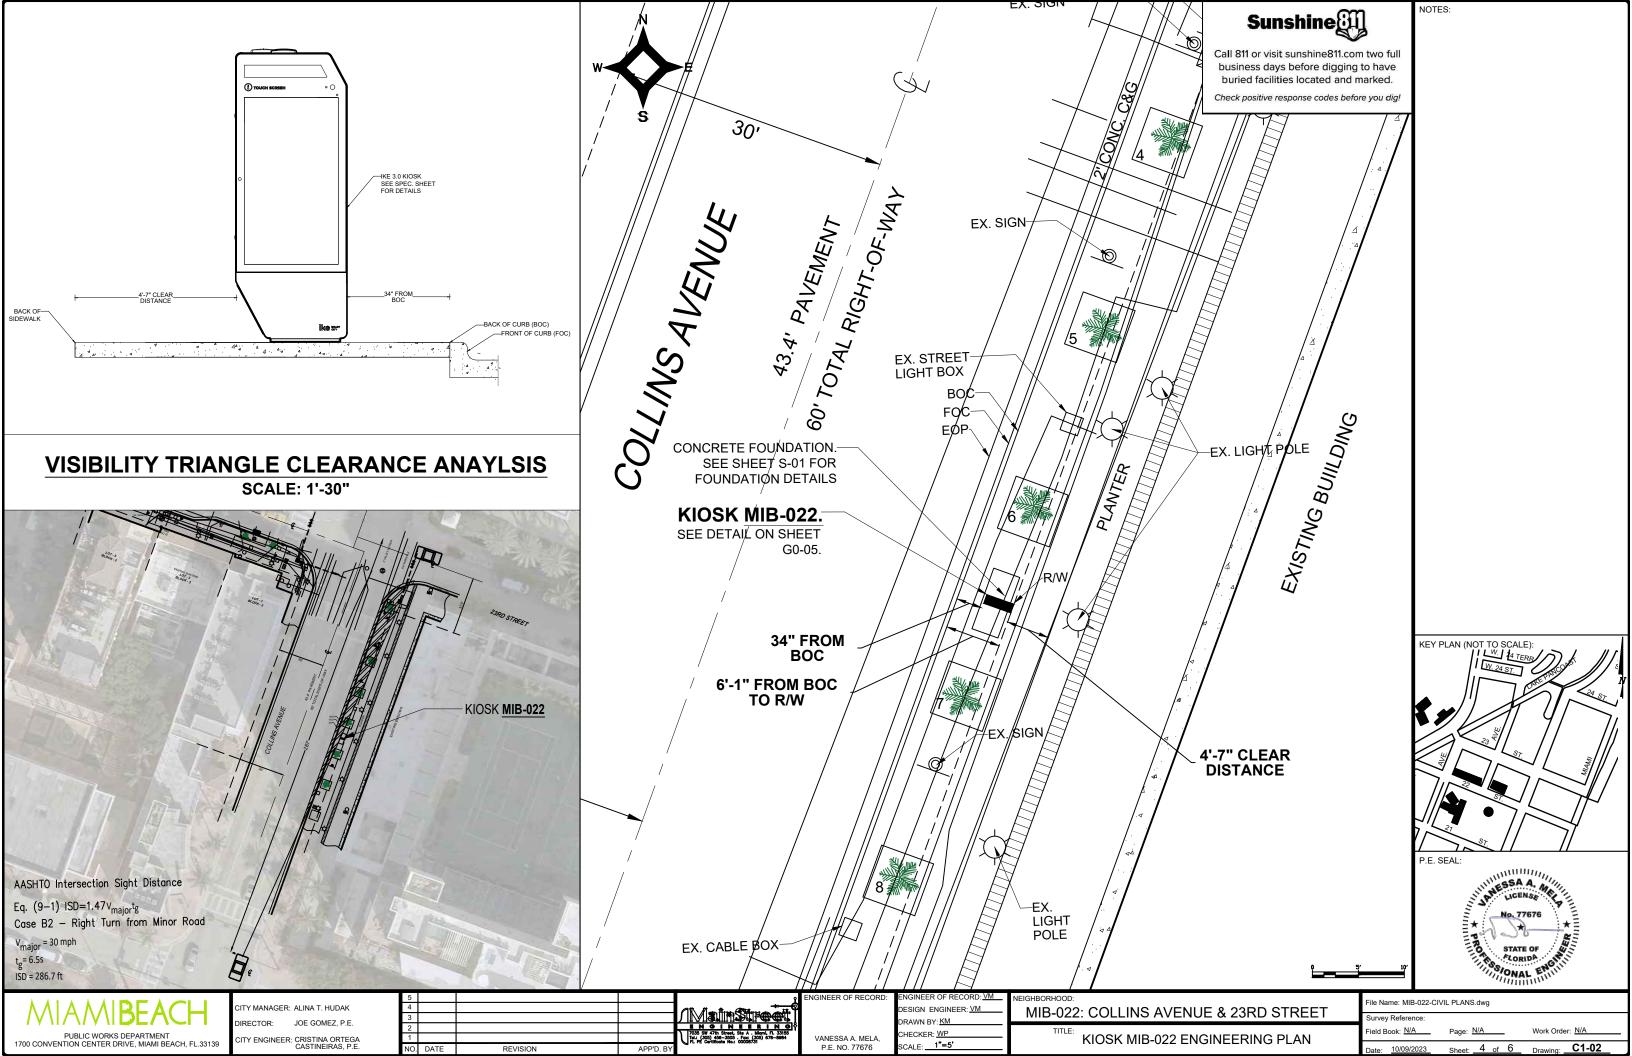

1"=30


NICOLAS DEL VENTO

PROFESSIONAL SURVEYOR & MAPPER STATE OF FLORIDA LIC. # 6945

CERTIFICATE OF AUTHORIZATION # LB-8023

Survey Pros, Inc.

Tel: 305.767.6802

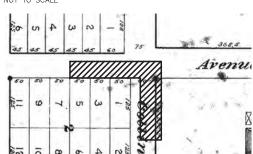

THE GRAPHICALLY DEPICTED BUILDING(S) SHOWN ON THIS MAP OF SURVEY IS WITHIN ZONE AE

1. ELEVATIONS WHEN SHOWN REFER TO 1929 NATIONAL GEODETIC VERTICAL DATUM

2. NO ATTEMPT WAS MADE TO LOCATE FOOTINGS/FOUNDATIONS, OR UNDERGROUND


7. FENCE OWNERSHIP IS NOT DETERMINED. DIMENSIONS ARE TO THE INTERIOR PORTION OF THE FENCE.

BORTION OF THE FERCE.


8. ADDITIONS OR DELETIONS TO THIS SURVEY MAP AND/OR REPORT BY SOMEONE OTHER THAN THE SIGNING PARTY(IES) IS PROHIBITED WITHOUT WRITTEN CONSENT OF

THE CENTERLINE OF COLLINS AVENUE BEARS N 19°53'17" E.

I HEREBY CERTIFY THAT THIS SURVEY IS TRUE AND CORRECT TO THE BEST OF MY KNOWLEDGE AND BELIEF AS RECENTLY SURVEYED AND DRAWN UNDER MY DIRECTION AND MEETS THE MINIMUM TECHNICAL STANDARDS SET FORTH BY THE FLORIDA STATE BOARD OF SURVEYORS AND MAPPERS IN CHAPTER 5J-17 FLORIDA ADMINISTRATIVE CODE PURSUANT TO SECTION 472.027 FLORIDA STATUE.

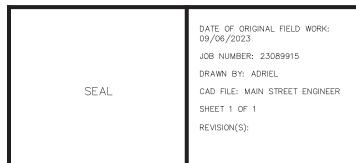

3. Collins Ave & 23rd Street

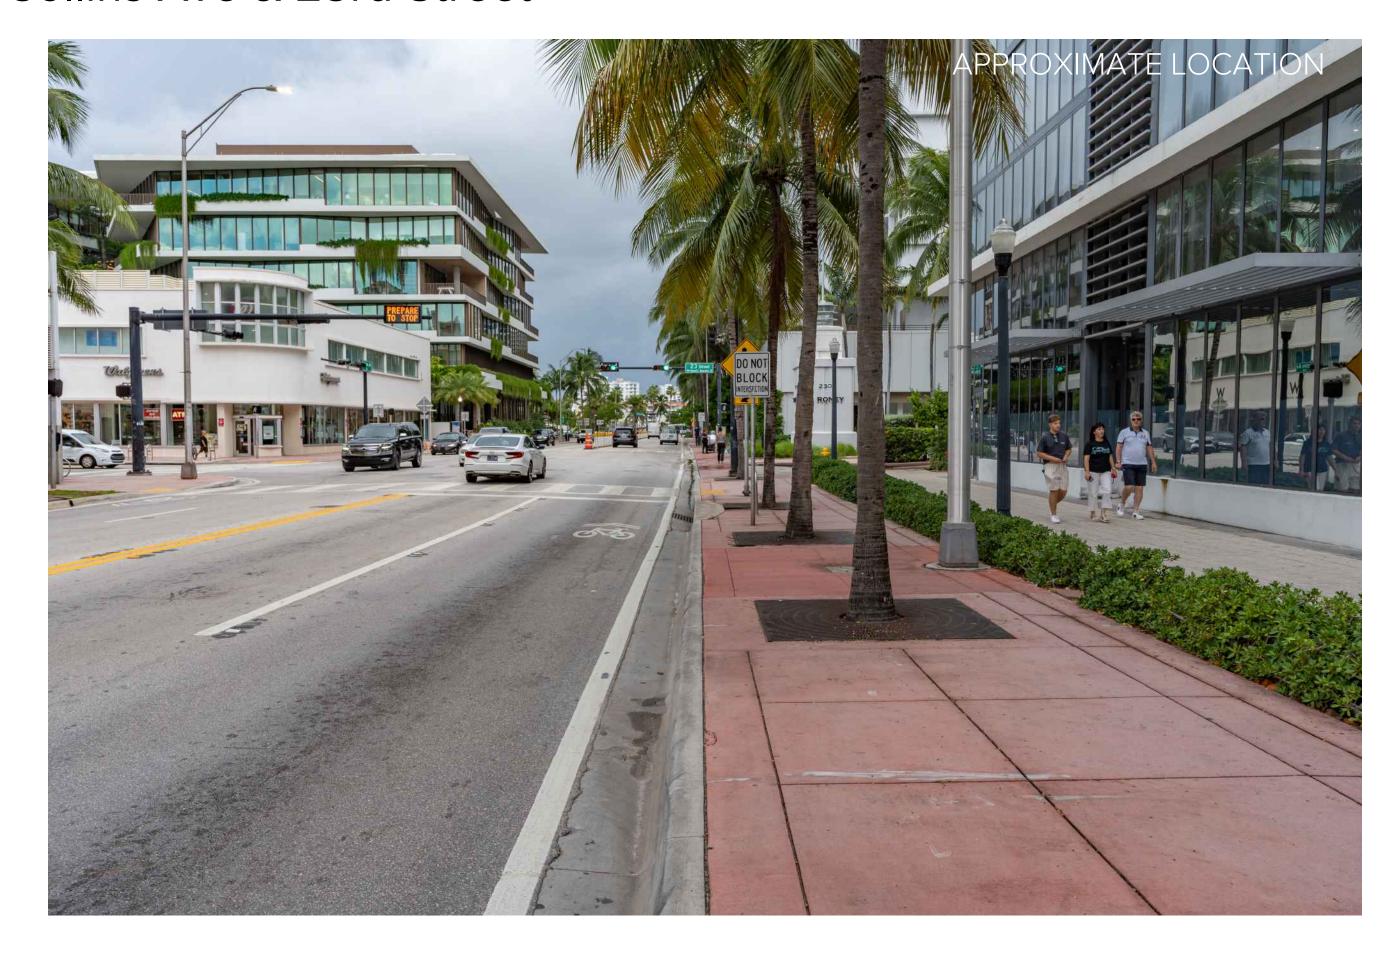

PUBLIC WORKS DEPARTMENT

COLLINS AVENUE (SR-A1A) & 20TH STREET
INTERACTIVE DIGITAL KIOSK DEPLOYMENT PROJECT
OCTOBER 2023
IKE SMART CITY
MIB-021

CITY OF MIAMI BEACH

MAYOR: DAN GELBER

COMMISSIONERS: MICKY STEINBERG

MARK SAMUELIAN MICHAEL GONGORA STEVEN MEINER RICKEY ARRIOLA DAVID RICHARDSON


CITY MANAGER: ALINA T. HUDAK

CITY ATTORNEY: RAFAEL A. PAZ

PUBLIC WORKS DIRECTOR: JOE GOMEZ, P.E., F.FES

CITY ENGINEER: NELSON PEREZ-JACOME, PE



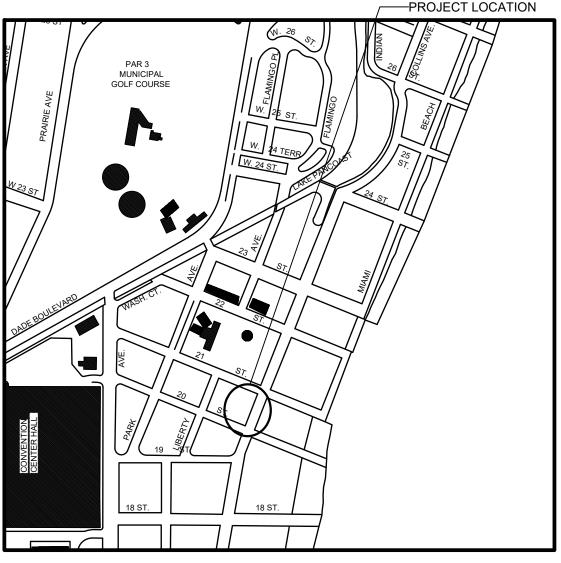





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FINAL SUBMITTAL 10/09/2023

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4	CIVIL	C1-02	KIOSK MIB-021 ENGINEERING PLAN	
5	ELECTRICAL	E1-01	KIOSK MIB-021 ELECTRICAL PLAN	
6	SURVEY		KIOSK MIB-021 SITE SURVEY	

FLORIDA . INCORPORATED 1915 Biscayne Bay

HISTORIC DISTRICTS

AND SITES

CITY OF

MIAMI BEACH

PROJECT LOCATION MUSEUM HISTORIC DISTRICT

LOCAL HISTORIC DISTRICTS

Espanola Way Historic District

Altos del Mar Historic District
Flamingo Park Historic District
Ocean Drive/Collins Avenue Historic Dis

Ocean Beach Historic District Harding Townsite Historic District Palm View Historic District Collins Waterfront Historic District

Morris Lapidus/Mid 20th Century Historic District North Shore Historic District

NATIONAL REGISTER

HISTORIC DISTRICTS Miami Beach Architectural District Normandy Isles Historic District

North Shore Historic District

Collins Waterfront Architectural District

6 Sunset Island Bridges Historic Structures

The Bath Club Historic Site

 Venetian Causeway Historic Site 13 1600 Lenox Ave Historic Site

LOCAL HISTORIC SITES

2 21st St Recreation Center Historic Site

Congregation Beth Jacob Historic Site

1 Old City Hall Historic Site

1700 Alton Rd Historic Site

KIOSK MANUFACTURER: DISPLAY DEVICE INC. 21075 WESTGATE RD. **GOLDEN, CO 80403**

CONTACT: ERIC PERKINS PHONE: (303) 929-4071

UTILITIES:

ELECTRICAL POWER: FLORIDA

TELEPHONE: AT&T


8 Dade Blvd Fire Station Historic Site

14 36 Ocean Dr Historic Site

CABLE: COMCAST, XFINITY, ATT-UVERSE

GAS: FLORIDA GAS

SIDEWALK & STREET SYMBOLS

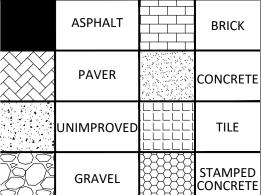

SSA 4. W

STATE OF

FLORIDA

SONAL EN

JURISDICTION:

PROJECT NAME:

CITY OF MIAMI DEPARTMENT OF RESILIENCE AND PUBLIC WORKS MIAMI RIVERSIDE CENTER 444 S.W. 2nd AVENUE, 8th FLOOR MIAMI, FLORIDA 33130 TEL: 305-416-1200

INTERACTIVE DIGITAL INFORMATION

KIOSKS DEPLOYMENT PROJECT

PROJECT DIRECTORY:

OWNER:

IKE SMART CITY 250 N HARTOFORD AVE COLUMBUS, OH 43222 (614) 589-0087

ENGINEER OF RECORD: MAINSTREET ENGINEERING

7035 SW 47 STREET, SUITE A MIAMI, FL 33155 (305) 456-3505 PROJ. MGR: VANESSA MELA, P.E. VMELA@MAINSTREETENG.COM

POWER & LIGHT COMPANY (FPL)

WATER & SEWER: MIAMI-DADE WATER & SEWAGE DEPARTMENT

ESIGN ENGINEER: VM DRAWN BY: KM

MIB-021: COLLINS AVENUE & 20TH STREET

Atlantic

INDEX OF SHEETS

File Name: MIB-021-GENERAL AND FOUNDATION.dwg

PUBLIC WORKS DEPARTMENT 1700 CONVENTION CENTER DRIVE, MIAMI BEACH, FL.33139 ITY MANAGER: ALINA T. HUDAK JOE GOMEZ, P.E.

VANESSA A. MELA P F NO 77676

HECKER: WP SCALE:

LEGEND AND ABBREVIATIONS

= ORNAMENTAL TREE

= OFFICIAL RECORDS BOOK

= OVERHEAD ELECTRIC LINE = SPOT ELEVATION

= CONCRETE = CONCRETE BLOCK STUCCO = CHAIN LINK FENCE

= METAL FENCE = REINFORCED CONCRETE PIPE

= POINT OF TANGENCY = POINT OF CURVATURE = STATION = POINT OF INTERSECTION = IDENTIFICATION = METAL LIGHT POLE

= PALM TREE

= ELEVATION

= WOOD FENCE

= FINISH FLOOR = RECORD = CALCULATED = MEASURE = LICENSE BUSINESS = LENGTH = CENTRAL ANGLE = RADIUS = TANGENT

= SECTION LINE = CENTERLINE

= ELECTRIC BOX

= UTILITY POLE

= ELECTRIC TRANSFORMER = GUY ANCHOR = ELECTRIC METER = GAS VALVE = GAS UTILITY BOX = GAS MANHOLE = GAS TANK

= GAS METER = COMMUNICATION BOX = COMMUNICATION MANHOLE = GARBAGE RECEPTACLE = HANDICAP PARKING SPACE

= WATER METER = IRRIGATION VALVE

= WATER VALVE

= WATER CONNECTION = WATER MANHOLE = WATER TANK

= WATER WELL = WATER MARKING FLAG

= WATER MARKING SIGN

= NEWSPAPER DISPENSER = MAILBOX = SANITARY MANHOLE

= SANITARY LIFT STATION

= GREASE TRAP MANHOLE

= FIBER OPTIC MARKER SIGN

= UNKNOWN UTILITY METER = UNKNOWN UTILITY MANHOLE

= UNKNOWN UTILITY VALVE

= UNKNOWN UTILITY MARKER FLAG

= STORM MANHOLE

= STORM METER = CATCH BASIN = TELEPHONE MANHOLE = TELEPHONE BOX

= SANITARY BOX = SANITARY TANK

= PARKING METER

= FIBER OPTIC BOX

= SANITARY VALVE = RAILROAD SIGN

= PROPERTY LINE = ELECTRICAL OUTLET

= FLAGPOLE

= MONITORING WELL

= CLEANOUT

= WATER BOX

= MONUMENT LINE = TRAFFIC SIGNAL BOX = TRAFFIC SIGNAL CABINET = BOLLARD = PEDESTRIAN SIGNAL = TRAFFIC SIGNAL MAST ARM = SIGN = CABLE TELEVISION BOX = LIGHT POLE

= TYPICAL = CABLE TELEVISION

O.R.B.

ELEV.

NOTES:

- 1. ALL CONSTRUCTION ACTIVITIES SHALL BE COMPLETED IN FULL COMPLIANCE WITH THE AMERICANS WITH DISABILITIES ACT (ADA). CLEAR SPACES IN FRONT OF KIOSK SHALL HAVE THE FOLLOWING CHARACTERISTICS:
- 2. SURFACES SHALL BE FIRM, STABLE, AND SLIP RESISTANT AND OTHERWISE COMPLY WITH PROWAG SECTION R302.7 AND SHALL HAVE A RUNNING SLOPE CONSISTENT WITH GRADE OF THE ADJACENT PEDESTRIANT ACCESS ROUTE AND CROSS SLOPE OF 1.50% +/-0.50%)
- 3. SIZE: CLEAR SPACES SHALL BE 48" MINIMUM BY 48" MINIMUM.
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- 6. MANEUVERING SPACE: WHERE A CLEAR SPACE IS CONFINED ON ALL OR PART OF THREE SIDES. ADDITIONAL MANEUVERING SPACE SHALL BE PROVIDED AS FOLLOWS:
- 6.1.1. FORWARD APPROACH: THE CLEAR SPACE AND ADDITIONAL MANEUVERING SPACE SHALL BE 36" WIDE MINIMUM WHERE THE DEPTH OF THE CONFINING ELEMENT EXCEEDS 24".
- 6.1.2. PARALLEL APPROACH: THE CLEAR SPACE AND ADDITIONAL MANEUVERING SPACE SHALL BE 60" WIDE MINIMUM WHERE THE DEPTH OF THE CONFINING ELEMENT EXCEEDS 15".
- 7. THE MINIMUM WHEELCHAIR PASSAGE WIDTH OR CLEAR SPACE WIDTH FOR A SINGLE WHEELCHAIR PASSAGE SHALL BE 48" PER PROWAG SECTION R302.3.
- 8. INITIAL OPERATION FOR THE KIOSK WILL HAVE 4G LTE CONNECTION SECTION R404. TO THE INTERNET.
- 9. THE KIOSKS HAVE BEEN DESIGN TO COMPLY WITH ALL ADA GUIDELINES INCLUDING VIEWING, OPERATION, AND ACCESSIBILITY.
- 10. THE MOBILE IKE EXPERIENCE WILL FOLLOW WEB CONTENT ACCESSIBILITY GUIDELINES (WCAG) TO WORK IN TANDEM WITH THE NATIVE ACCESSIBILITY FEATURES ON THE USER'S MOBILE DEVICE, INCLUDING TALKBACK AND VOICEOVER TOOLS.

SCOPE OF WORK

THE PROJECT CONSIST OF THE INSTALLATION OF ONE (1) DIGITAL INTERACTIVE KIOSKS AT THE LOCATION(S) INDICATED ON THIS PLANS SET. INSTALLER SHALL PROVIDE AND INCLUDE ALL WORKMANSHIP AND MATERIALS NECESSARY TO COMPLETE THE INSTALLATION INCLUDING BUT NOT LIMITED TO:

- 1. INSTALLATION OF THE KIOSKS TO THE FOUNDATION AS INDICATED ON PLANS TO NEW RECTANGULAR CONCRETE FOUNDATION.
- 2. ELECTRICAL SERVICE POINTS ARE EXISTING. CONNECT THE EXISTING ELECTRIC SERVICE TO THE NEW KIOSK AS INDICATED ON PLANS.
- 3. TESTING OF THE ELECTRICAL SERVICE INFRASTRUCTURE SHALL BE PERFORMED IN CONJUNCTION WITH A REPRESENTATIVE OF THE ENGINEER OF RECORD
- 4. THE CONTRACTOR SHALL INSTALL THE KIOSK IN SUCH A WAY THAT THE KIOSK IS WITHIN THE PUBLIC R.O.W. AND IN COMPLIANCE WITH ALL APPLICABLE A.D.A. REQUIREMENTS
- 5. THE LOCATION OF KIOSKS HAS BEEN COORDINATE TO ENSURE THERE IS NO OBSTRUCTION OF THE SIGHT OF VEHICULAR SIGNS.
- 6. STAND-ALONE PEDESTRIAN KIOSKS SHOULD NOT BE INSTALLED WITHIN PEDESTRIAN CIRCULATION PATHS IN A MANNER THAT PERSONS AT THE KIOSK LOCK THE EFFECTIVE WIDTH OF THE PEDESTRIAN TRAVEL WAY.

MONUMENT SIGN SPECIFICATIONS AND FUNCTIONS


THE UNIT CONSISTS OF A UL/NRTL LISTED WEATHER AND VANDAL RESISTANT FREE STANDING ENCLOSURE DESIGNED TO COMPLY WITH THE FLORIDA BUILDING CODE AND OTHER APPLICABLE CODES INCLUDING THE NATIONAL ELECTRICAL CODE. THE UNIT HAS BEEN DESIGNED TO WITHSTAND WINDS OF 165 MPH. THE UNIT'S MAIN COMPONENTS ARE:


- 1. TWO (2) INTERACTIVE 65" VIDEO TOUCH SCREENS.
- 2. TWO (2) CAMERAS
- 3. ONE (1) CPU
- 4. ONE (1) WI-FI TRANSMITTER

MANUFACTURER: DYNASCAN MODEL NUMBER: CIO651DR5 NATIVE RESOLUTION: 1920 X 1080 **ELECTRICAL POWER REQUIREMENT:**

- 1. ONE-2-POLE, 20 AMP, 240 VOLTS CIRCUIT.
- 2. TOTAL LOAD: 1400/2200 WATTS (OPERATIONAL/PEAK)
- 3. VOLTAGE: 100-240 VOLTS AC, 50-60 HZ WEIGHT: 832 LBS

CERTIFICATION CE / FCC / RoHS

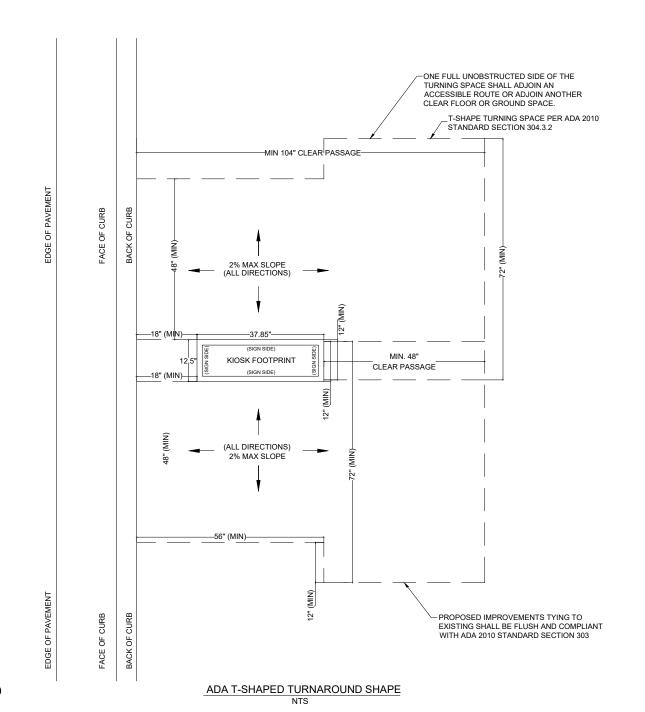

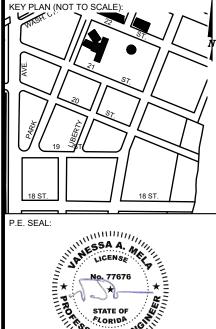

PUBLIC WORKS DEPARTMENT 1700 CONVENTION CENTER DRIVE, MIAMI BEACH, FL.33139

ITY MANAGER: ALINA T. HUDAK JOE GOMEZ, P.E. CITY ENGINEER: CRISTINA ORTEGA CASTINEIRAS, P.E. NO. DATE

VANESSA A. MELA P F NO 77676

ESIGN ENGINEER: VM DRAWN BY: KM HECKER: WP SCALE:

MIB-021: COLLINS AVENUE & 20TH STREET


ADA NOTES, SCOPE OF WORK & KIOSK SPECIFICATIONS


ile Name: MIB-021-GENERAL AND FOUNDATION.dwo

NOTES:

2 of 6



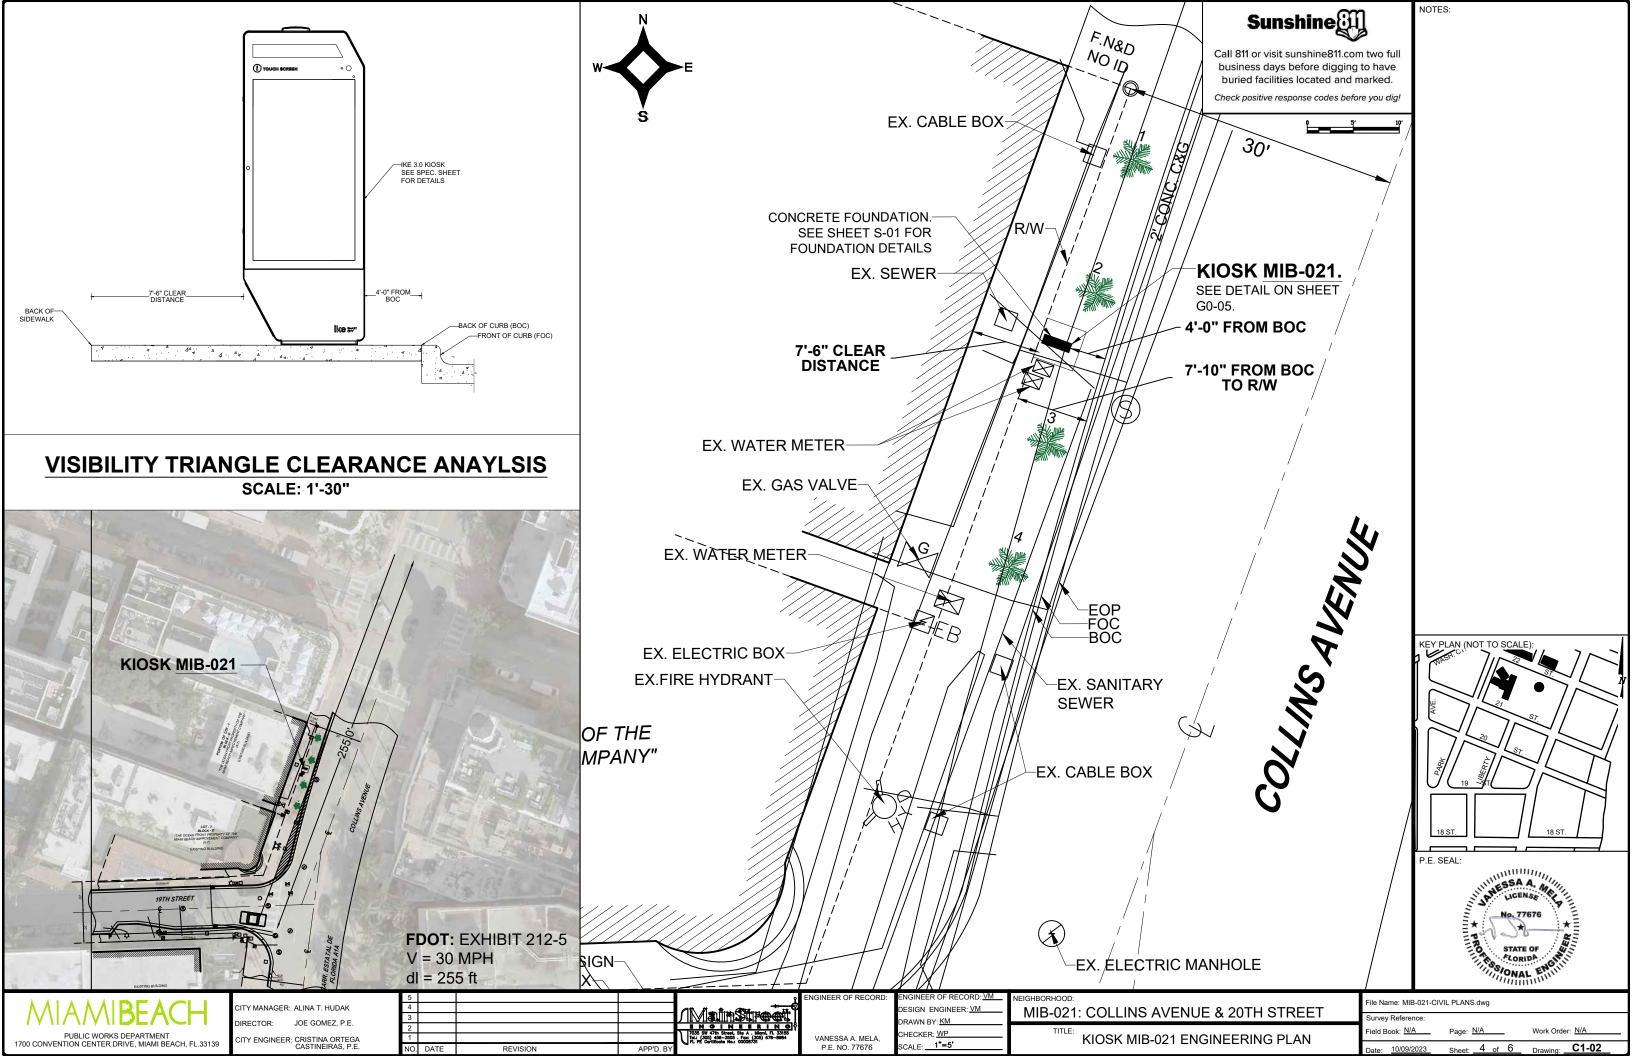

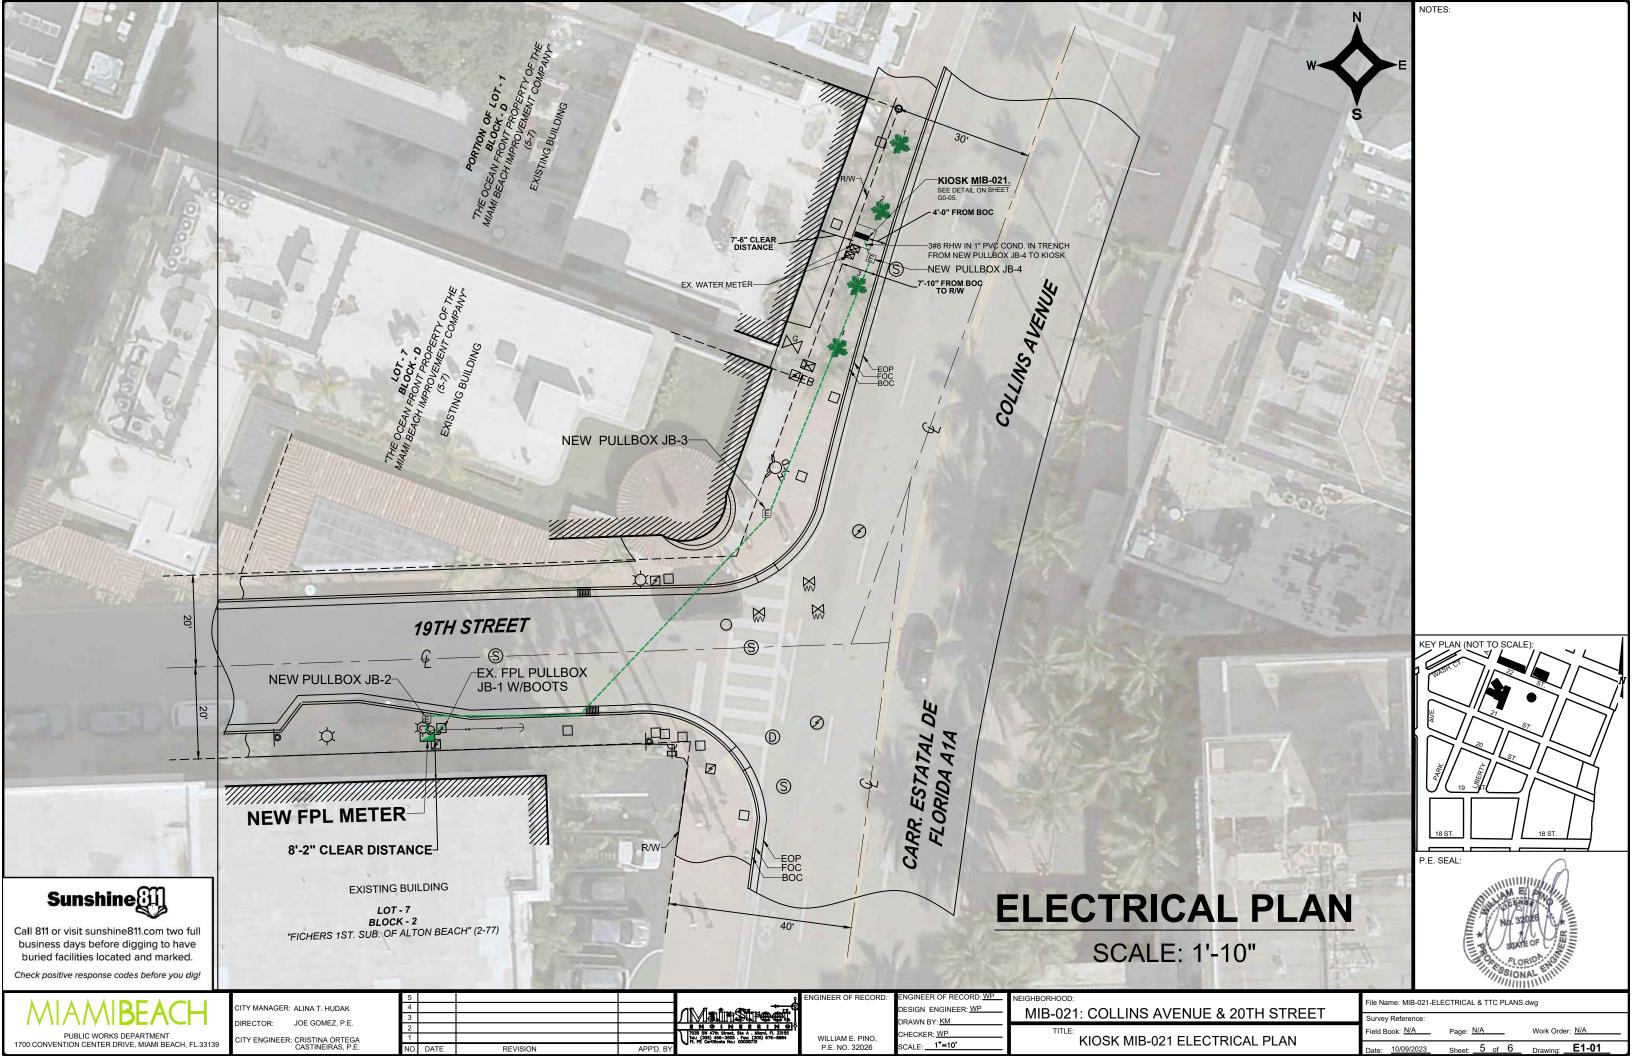

LEGEND ABBREVIATIONS: A = ARC DISTANCE AC = AIR CONDITIONER PAD BCR = BROWARD COUNTY RECORDS BLDG = BUILDING BM = BENCH MARK BOB = BASIS OF BEARINGS CBS = CONCRETE BLOCK & STUCCO (C) = CALCULATED C&G = CURB & GUTTER CLF = CHAIN LINK FENCE OLE. = UDLUMN D.E. = DRAINAGE EASEMENT D.M.E. = DRAINAGE & MAINTENANCE EASEMENT COL = COLUMN EASEMENT D/W = DRIVEWAY EB = ELECTRIC BOX ENC. = ENCROACHMENT EP = EDGE OF PAVEMENT EW = EDGE OF WATER FDH = FOUND DRILL HOLE FFE = FINISHED FLOOR ELEVATION FIP = FOUND IRON PIPE (NO ID) EIR = FOUND IRON PIPE (NO ID) FIR = FOUND IRON ROD (NO ID) FN = FOUND NAIL (NO ID) FPL = FLORIDA POWER & LIGHT TRANSFORMER PAD L.E. = LANDSCAPE EASEMENT L.M.E. = LAKE MAINTENANCE EASEMENT (M) = MEASURED MDCR = MIAMI-DADE COUNTY RECORDS MH = MAN HOLE ML = MONUMENT LINE (P) = PLAT PB = PLAT BOOK PC = POINT OF CURVATURE PCP = PERMANENT CONTROL POINT PE = POOL EQUIPMENT PAD PG = PAGE PG = PAGE PI = POINT OF INTERSECTION PL = PLANTER POB = POINT OF BEGINNING POC = POINT OF COMMENCEMENT PRC = POINT OF REVERSE CURVATURE PRM = PERMANENT REFERENCE MONUMENT PT = POINT OF TANGENCY R = RADIUS DISTANCE (R) = RECORDR/W = RIGHT-OF-WAY RES = RESIDENCE SIP = SIP LB#8023 SND = SET NAIL & DISK LB#8023 STL = SURVEY TIE LINE SWK = SIDEWALK (TYP) = TYPICAL UB = UTILITY BOX U.E. = UTILITY EASEMENT W/F = WOOD FENCE SYMBOLS: T = TELEPHONE RISER C = CABLE TV RISER X = WATER METER X 0.00 = ELEVATION(00') = ORIGINAL LOT DISTANCE Δ = CENTRAL ANGLE = CENTER LINE 1 = WATER VALVE = CURB INLET = FIRE HYDRANT T = LIGHT POLE · = CATCH BASIN = UTILITY POLE (D) = DRAINAGE MANHOLE (S) = SEWER MANHOLE O = SIGN = GAS VALVE # # # = WOOD FENCE -x - x - x - = CHAIN LINK FENCE - - - = EASEMENT = BOUNDARY LINE = OVERHEAD UTILITY LINE ----= ORIGINAL LOT LINE

ASPHALT CONCRETE PAVERS/

GRAPHIC SCALE

1"=30"

COVERED

LOCATION 1: VENETIAN CSWY --- 20' NORTH OF C/L LOCATION 2: BELLE ISLE EAST BRIDGE ——
DESCRIPTION: PK NAIL AND BRASS WASHER IN
CONCRETE SIDEWALK AT NE CORNER OF BRIDGE


TILES

MAP OF SPECIFIC PURPOSE TOPOGRAPHIC & TREE SURVEY

OF A PORTION OF "COLLINS AVENUE" AND "19TH STREET" CITY OF MIAMI BEACH, FL.

PLAT OF "THE OCEAN FRONT PROPERTY OF THE MIAMI BEACH IMPROVEMENT COMPANY" PLAT BOOK 5, PAGE 7, MDCR : AND PLAT OF "FICHERS 1ST. SUB. OF ALTON BEACH"

PLAT BOOK 2, PAGE 77, MDCR

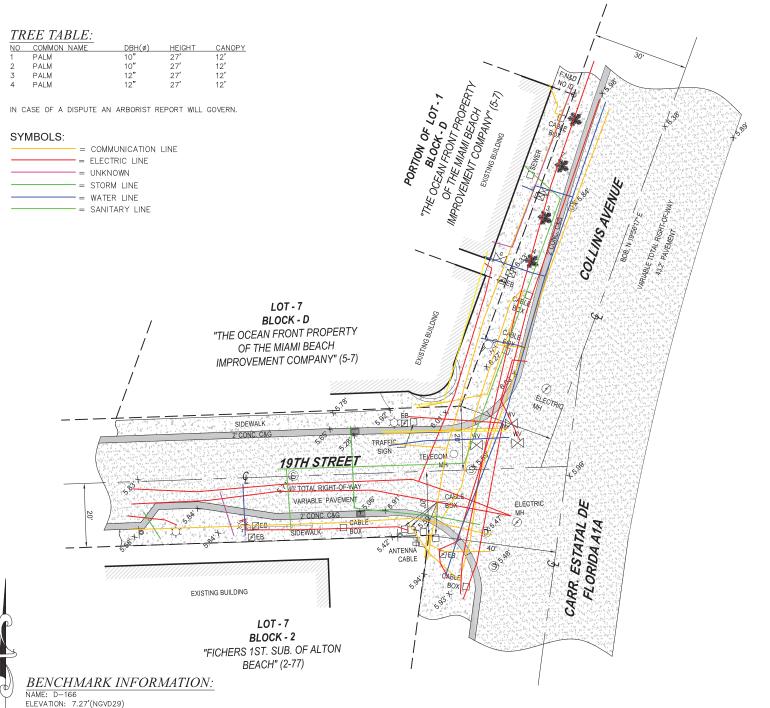

CERTIFICATE OF AUTHORIZATION # LB-8023

Survey Pros, Inc.

4348 SW 74TH AVENUE, MIAMI, FL. 33155 Tel: 305.767.6802 www.survey-pros.com

LOCATION SKETCH:



FLOOD ZONE INFORMATION:

THE GRAPHICALLY DEPICTED BUILDING(S) SHOWN ON THIS MAP OF SURVEY IS WITHIN ZONE AE BASE FLOOD FLEVATION 8

COMMUNITY NAME & NUMBER CITY OF MIAMI BEACH 120651

MAP & PANEL NUMBER 12086C0317 SUFFIX L

SURVEYOR'S NOTES:

1. ELEVATIONS WHEN SHOWN REFER TO 1929 NATIONAL GEODETIC VERTICAL DATUM

(NGVD 1929).

2. NO ATTEMPT WAS MADE TO LOCATE FOOTINGS/FOUNDATIONS, OR UNDERGROUND UTILITIES UNLESS OTHERWISE NOTED.

3. THE LANDS SHOWN HEREON HAVE NOT BEEN ABSTRACTED IN REGARDS TO MATTERS OF INTEREST BY OTHER PARTIES, SUCH AS EASEMENTS, RIGHTS OF WAYS, RESERVATIONS, ETC. ONLY PLATTED EASEMENTS ARE SHOWN.

4. THIS SURVEY WAS PREPARED FOR AND CERTIFIED TO THE PARTY(IES) INDICATED HEREON AND IS NOT TRANSFERABLE OR ASSIGNABLE WITHOUT WRITTEN CONSENT OF

HEREON AND IS NOT IRANSFERABLE OR ASSIGNABLE WITHOUT WRITTEN CONSENT OF THIS FIRM.

5. ALL BOUNDARY LIMIT INDICATORS SET ARE STAMPED LB#8023.

6. THE BOUNDARY LIMITS ESTABLISHED ON THIS SURVEY ARE BASED ON THE LEGAL DESCRIPTION PROVIDED BY THE CLIENT OR ITS REPRESENTATIVE.

7. FENCE OWNERSHIP IS NOT DETERMINED. DIMENSIONS ARE TO THE INTERIOR

PORTION OF THE FENCE

8. ADDITIONS OR DELETIONS TO THIS SURVEY MAP AND/OR REPORT BY SOMEONE OTHER THAN THE SIGNING PARTY(IES) IS PROHIBITED WITHOUT WRITTEN CONSENT OF THE SIGNING PARTY(IES).

9. THIS SURVEY IS NOT VALID WITHOUT THE ORIGINAL SIGNATURE AND RAISED SEAL OF A FLORIDA LICENSED SURVEYOR AND MAPPER. OTHERWISE THIS MAP IS FOR INFORMATIONAL PURPOSES ONLY.

10. BEARINGS WHEN SHOWN ARE TO AN ASSUMED MERIDIAN AND BASED ON PLAT. THE CENTERLINE OF COLLINS AVENUE BEARS N 19°56'17" E.

SURVEYOR'S CERTIFICATION:

I HEREBY CERTIFY THAT THIS SURVEY IS TRUE AND CORRECT TO THE BEST OF MY KNOWLEDGE AND BELIEF AS RECENTLY SURVEYED AND DRAWN UNDER MY DIRECTION AND MEETS THE MINIMUM TECHNICAL STANDARDS SET FORTH BY THE FLORIDA STATE BOARD OF SURVEYORS AND MAPPERS IN CHAPTER 5J—17 FLORIDA ADMINISTRATIVE CODE PURSUANT TO SECTION 472.027 FLORIDA STATUE.

CERTIFIED TO:


MAIN STREET ENGINEERING

NICOLAS DEL VENTO

PROFESSIONAL SURVEYOR & MAPPER STATE OF FLORIDA LIC. # 6945

DATE OF ORIGINAL FIELD WORK: 09/07/2023 JOB NUMBER: 23099919 DRAWN BY: ADRIEL SEAL CAD FILE: MAIN STREET ENGINEERING SHEET 1 OF 1 REVISION(S):

4. Collins Ave & 20th Street

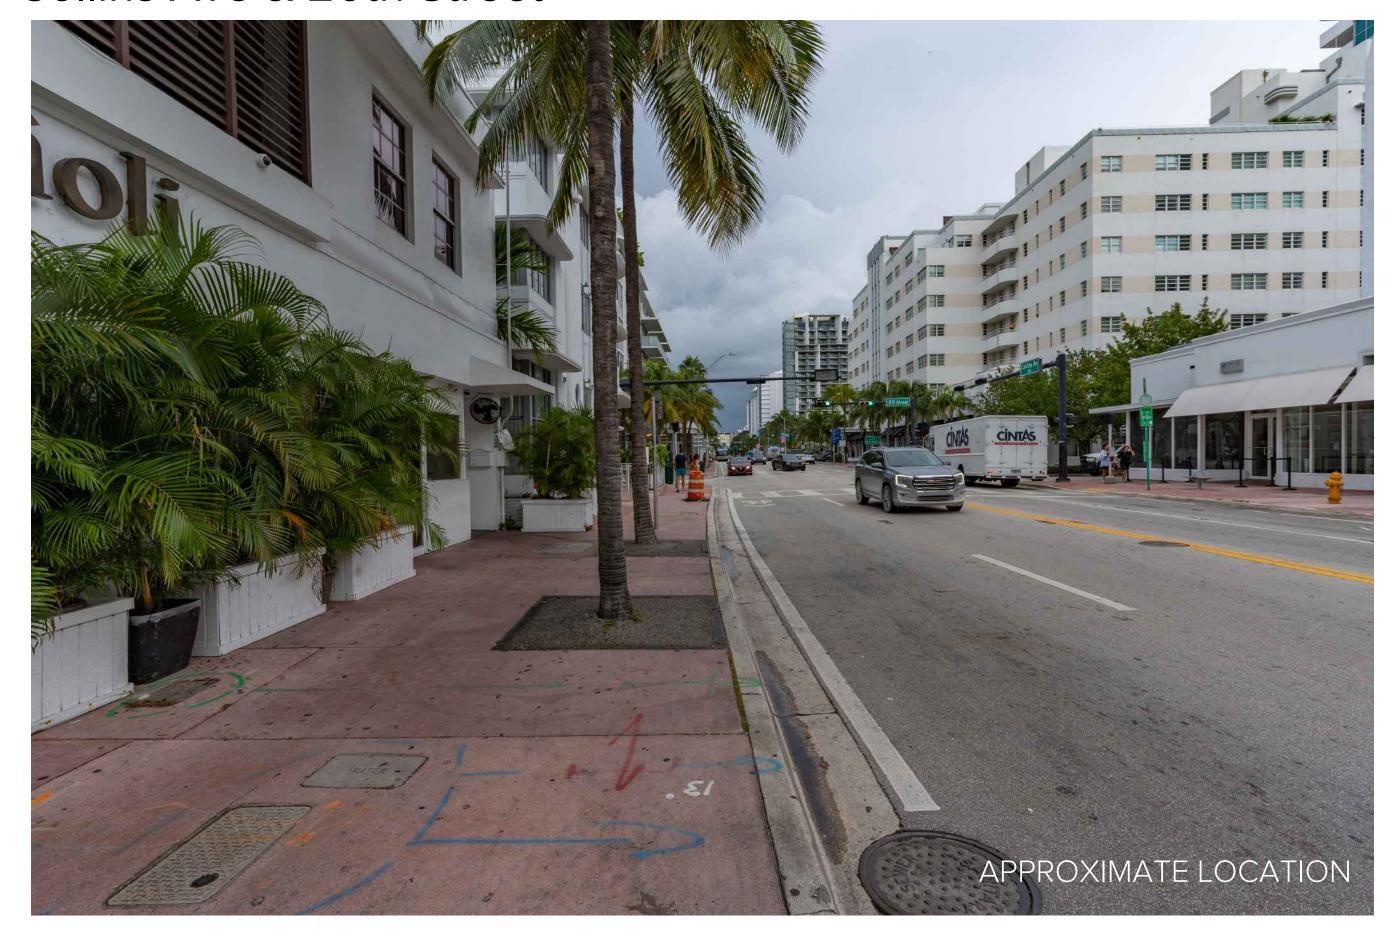

PUBLIC WORKS DEPARTMENT

LINCOLN ROAD & WASHINGTON AVENUE
INTERACTIVE DIGITAL KIOSK DEPLOYMENT PROJECT
OCTOBER 2023
IKE SMART CITY
MIB-004

CITY OF MIAMI BEACH

MAYOR: DAN GELBER

COMMISSIONERS: MICKY STEINBERG

MARK SAMUELIAN MICHAEL GONGORA STEVEN MEINER RICKEY ARRIOLA DAVID RICHARDSON


CITY MANAGER: ALINA T. HUDAK

CITY ATTORNEY: RAFAEL A. PAZ

PUBLIC WORKS DIRECTOR: JOE GOMEZ, P.E., F.FES

CITY ENGINEER: NELSON PEREZ-JACOME, PE



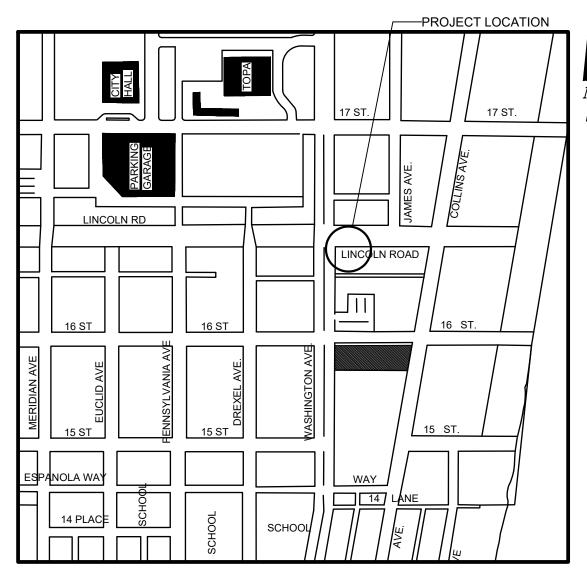



INDEX OF PLANS						
NUMBER	DISCIPLINE	SHEET NO.	DESCRIPTION	NOTES		
1	GENERAL	G0-03	INDEX OF SHEETS			
2	GENERAL	G0-04	ADA NOTES, SCOPE OF WORK & KIOSK SPECIFICATIONS			
3	CIVIL	C1-01	CIVIL SITE PLAN			
4	CIVIL	C1-02	KIOSK MIB-004 ENGINEERING PLAN			
5	ELECTRICAL	E1-01	KIOSK MIB-004 ELECTRICAL PLAN			
6	SURVEY		KIOSK MIB-004 SITE SURVEY			

SCOPE OF WORK: THE PROJECT CONSISTS OF THE INSTALLATION OF ONE (1) DIGITAL INTERACTIVE KIOSK AND APPLICABLE INFRASTRUCTURE; STRUCTURAL FOUNDATION AND ELECTRICAL SERVICE AT THE LOCATION INDICATED ON THESE DESIGN PLANS.

FINAL SUBMITTAL 10/09/2023

LOCATION MAP

NUMBER	DISCIPLINE	SHEET NO.	DESCRIPTION	NOTES
1	GENERAL	G0-03	INDEX OF SHEETS	
2	GENERAL	G0-04	ADA NOTES, SCOPE OF WORK & KIOSK SPECIFICATIONS	
3	CIVIL	C1-01	CIVIL SITE PLAN	
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6	SURVEY		KIOSK MIB-004 SITE SURVEY	

PROJECT LOCATION FLAMINGO PARK HISTORIC DISTRICT

LOCAL HISTORIC DISTRICTS

Espanola Way Historic District

Altos del Mar Historic District
Flamingo Park Historic District
Ocean Drive/Collins Avenue Historic Dis

Ocean Beach Historic District

Harding Townsite Historic District

Palm View Historic District Collins Waterfront Historic District

North Shore Historic District

NATIONAL REGISTER HISTORIC DISTRICTS

Miami Beach Architectural District Normandy Isles Historic District

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2 21st St Recreation Center Historic Site

Congregation Beth Jacob Historic Site

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The Bath Club Historic Site

KIOSK MANUFACTURER:

DISPLAY DEVICE INC. 21075 WESTGATE RD. **GOLDEN, CO 80403 CONTACT: ERIC PERKINS**

PHONE: (303) 929-4071

UTILITIES:

TELEPHONE: AT&T

8 Dade Blvd Fire Station Historic Site

14 36 Ocean Dr Historic Site

1700 Alton Rd Historic Site

CABLE: COMCAST, XFINITY, ATT-UVERSE

GAS: FLORIDA GAS

HISTORIC DISTRICTS AND SITES CITY OF **MIAMI BEACH** FLORIDA . INCORPORATED 1915 Biscayne Bay Atlantic SIDEWALK & STREET SYMBOLS

LEGEND AND ABBREVIATIONS

= ORNAMENTAL TREE

= OFFICIAL RECORDS BOOK

= PALM TREE

= ELEVATION

= TYPICAL = CABLE TELEVISION

O.R.B.

ELEV.

NOTES:

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PROJECT DIRECTORY:

PROJECT NAME:

INTERACTIVE DIGITAL INFORMATION KIOSKS DEPLOYMENT PROJECT

JURISDICTION:

CITY OF MIAMI DEPARTMENT OF RESILIENCE AND PUBLIC WORKS MIAMI RIVERSIDE CENTER 444 S.W. 2nd AVENUE, 8th FLOOR MIAMI, FLORIDA 33130 TEL: 305-416-1200

OWNER:

IKE SMART CITY 250 N HARTOFORD AVE COLUMBUS, OH 43222 (614) 589-0087

ENGINEER OF RECORD: MAINSTREET ENGINEERING

7035 SW 47 STREET, SUITE A MIAMI, FL 33155 (305) 456-3505 PROJ. MGR: VANESSA MELA, P.E. VMELA@MAINSTREETENG.COM

ELECTRICAL POWER: FLORIDA POWER & LIGHT COMPANY (FPL)

WATER & SEWER: MIAMI-DADE WATER & SEWAGE DEPARTMENT

DRAWN BY: KM

ASPHALT

PAVER

UNIMPROVED

GRAVEL

MIB-004: LINCOLN RD & WASHINGTON AVE

BRICK

CONCRETE

TILE

STAMPED

CONCRETE

INDEX OF SHEETS

File Name: MIB-004-GENERAL AND FOUNDATION.dwg

PUBLIC WORKS DEPARTMENT 1700 CONVENTION CENTER DRIVE, MIAMI BEACH, FL.33139

JOE GOMEZ, P.E.

ITY MANAGER: ALINA T. HUDAK

P F NO 77676

HECKER: WP SCALE:

= FLAGPOLE = PROPERTY LINE = ELECTRICAL OUTLET

FLORIDA

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- WHEELCHAIR PASSAGE SHALL BE 48" PER PROWAG SECTION R302.3. 8. INITIAL OPERATION FOR THE KIOSK WILL HAVE 4G LTE CONNECTION SECTION R404. TO THE INTERNET.
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- 10. THE MOBILE IKE EXPERIENCE WILL FOLLOW WEB CONTENT ACCESSIBILITY GUIDELINES (WCAG) TO WORK IN TANDEM WITH THE NATIVE ACCESSIBILITY FEATURES ON THE USER'S MOBILE DEVICE. INCLUDING TALKBACK AND VOICEOVER TOOLS.

SCOPE OF WORK

THE PROJECT CONSIST OF THE INSTALLATION OF ONE (1) DIGITAL INTERACTIVE KIOSKS AT THE LOCATION(S) INDICATED ON THIS PLANS SET. INSTALLER SHALL PROVIDE AND INCLUDE ALL WORKMANSHIP AND MATERIALS NECESSARY TO COMPLETE THE INSTALLATION INCLUDING BUT NOT LIMITED TO:

- 1. INSTALLATION OF THE KIOSKS TO THE FOUNDATION AS INDICATED ON PLANS TO NEW RECTANGULAR CONCRETE FOUNDATION.
- 2. ELECTRICAL SERVICE POINTS ARE EXISTING. CONNECT THE EXISTING ELECTRIC SERVICE TO THE NEW KIOSK AS INDICATED ON PLANS.
- 3. TESTING OF THE ELECTRICAL SERVICE INFRASTRUCTURE SHALL BE PERFORMED IN CONJUNCTION WITH A REPRESENTATIVE OF THE ENGINEER OF RECORD.
- 4. THE CONTRACTOR SHALL INSTALL THE KIOSK IN SUCH A WAY THAT THE KIOSK IS WITHIN THE PUBLIC R.O.W. AND IN COMPLIANCE WITH ALL APPLICABLE A.D.A. REQUIREMENTS
- 5. THE LOCATION OF KIOSKS HAS BEEN COORDINATE TO ENSURE THERE IS NO OBSTRUCTION OF THE SIGHT OF VEHICULAR SIGNS.
- 6. STAND-ALONE PEDESTRIAN KIOSKS SHOULD NOT BE INSTALLED WITHIN PEDESTRIAN CIRCULATION PATHS IN A MANNER THAT PERSONS AT THE KIOSK LOCK THE EFFECTIVE WIDTH OF THE PEDESTRIAN TRAVEL WAY.

MONUMENT SIGN SPECIFICATIONS AND FUNCTIONS

THE UNIT CONSISTS OF A UL/NRTL LISTED WEATHER AND VANDAL RESISTANT FREE STANDING ENCLOSURE DESIGNED TO COMPLY WITH THE FLORIDA BUILDING CODE AND OTHER APPLICABLE CODES INCLUDING THE NATIONAL ELECTRICAL CODE. THE UNIT HAS BEEN DESIGNED TO WITHSTAND WINDS OF 165 MPH. THE UNIT'S MAIN COMPONENTS ARE:

NO. DATE

- 1. TWO (2) INTERACTIVE 65" VIDEO TOUCH SCREENS.
- 2. TWO (2) CAMERAS
- 3. ONE (1) CPU
- 4. ONE (1) WI-FI TRANSMITTER

NATIVE RESOLUTION: 1920 X 1080


MANUFACTURER: DYNASCAN MODEL NUMBER: CIO651DR5


ELECTRICAL POWER REQUIREMENT:

- 1. ONE-2-POLE, 20 AMP, 240 VOLTS CIRCUIT.
- 2. TOTAL LOAD: 1400/2200 WATTS (OPERATIONAL/PEAK)
- 3. VOLTAGE: 100-240 VOLTS AC, 50-60 HZ

WEIGHT: 832 LBS

CERTIFICATION CE / FCC / RoHS

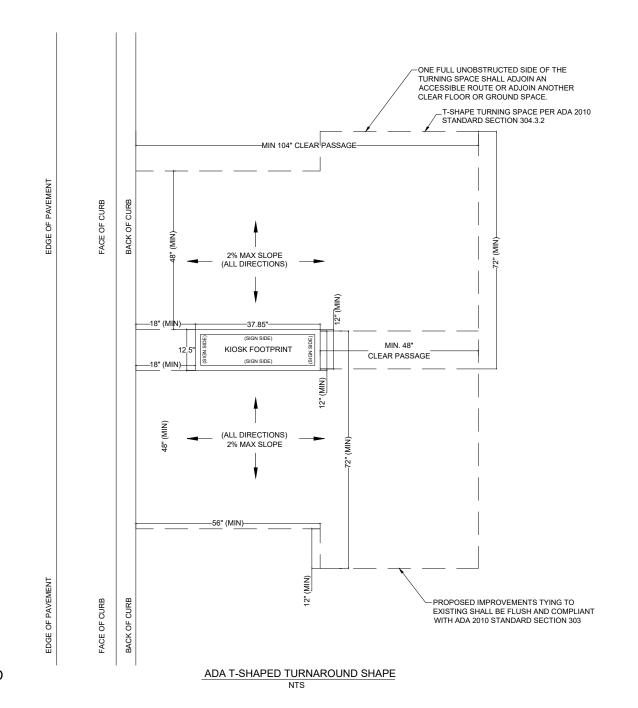


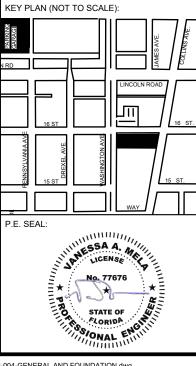

P F NO 77676

SCALE:

NOTES:

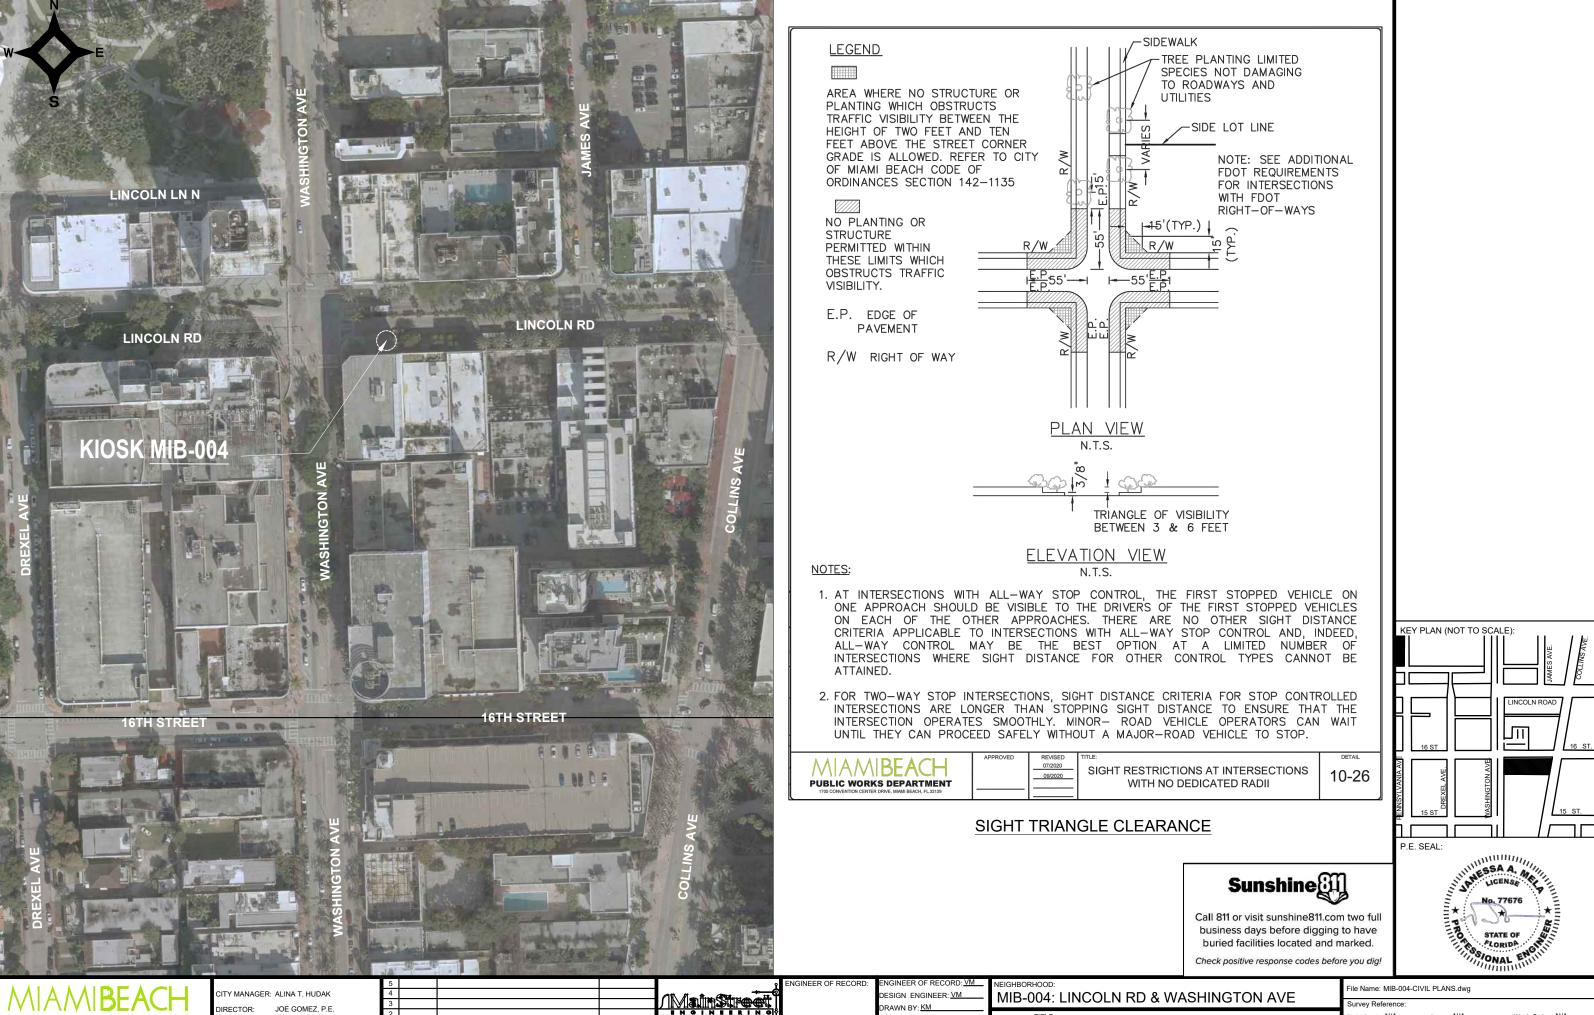

PUBLIC WORKS DEPARTMENT 1700 CONVENTION CENTER DRIVE, MIAMI BEACH, FL.33139


CITY ENGINEER: CRISTINA ORTEGA CASTINEIRAS. P.E.


HECKER: WP VANESSA A. MELA, P.E. NO. 77676


SCALE:

CIVIL SITE PLAN

NOTES:

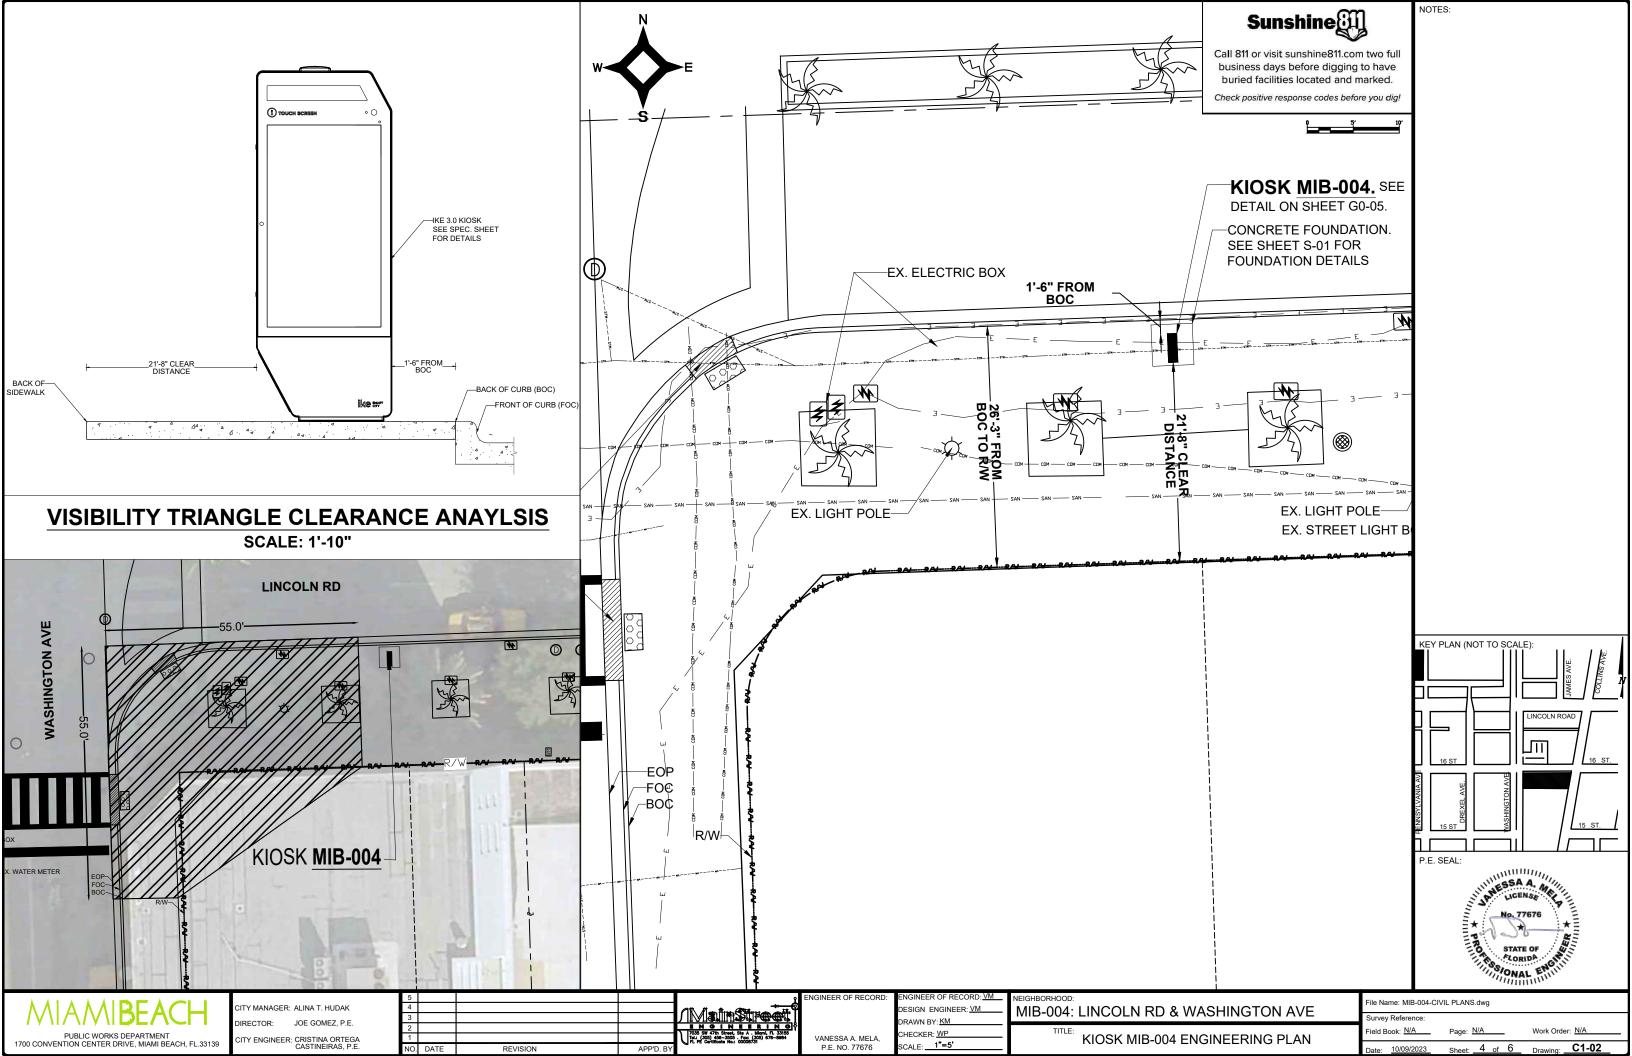

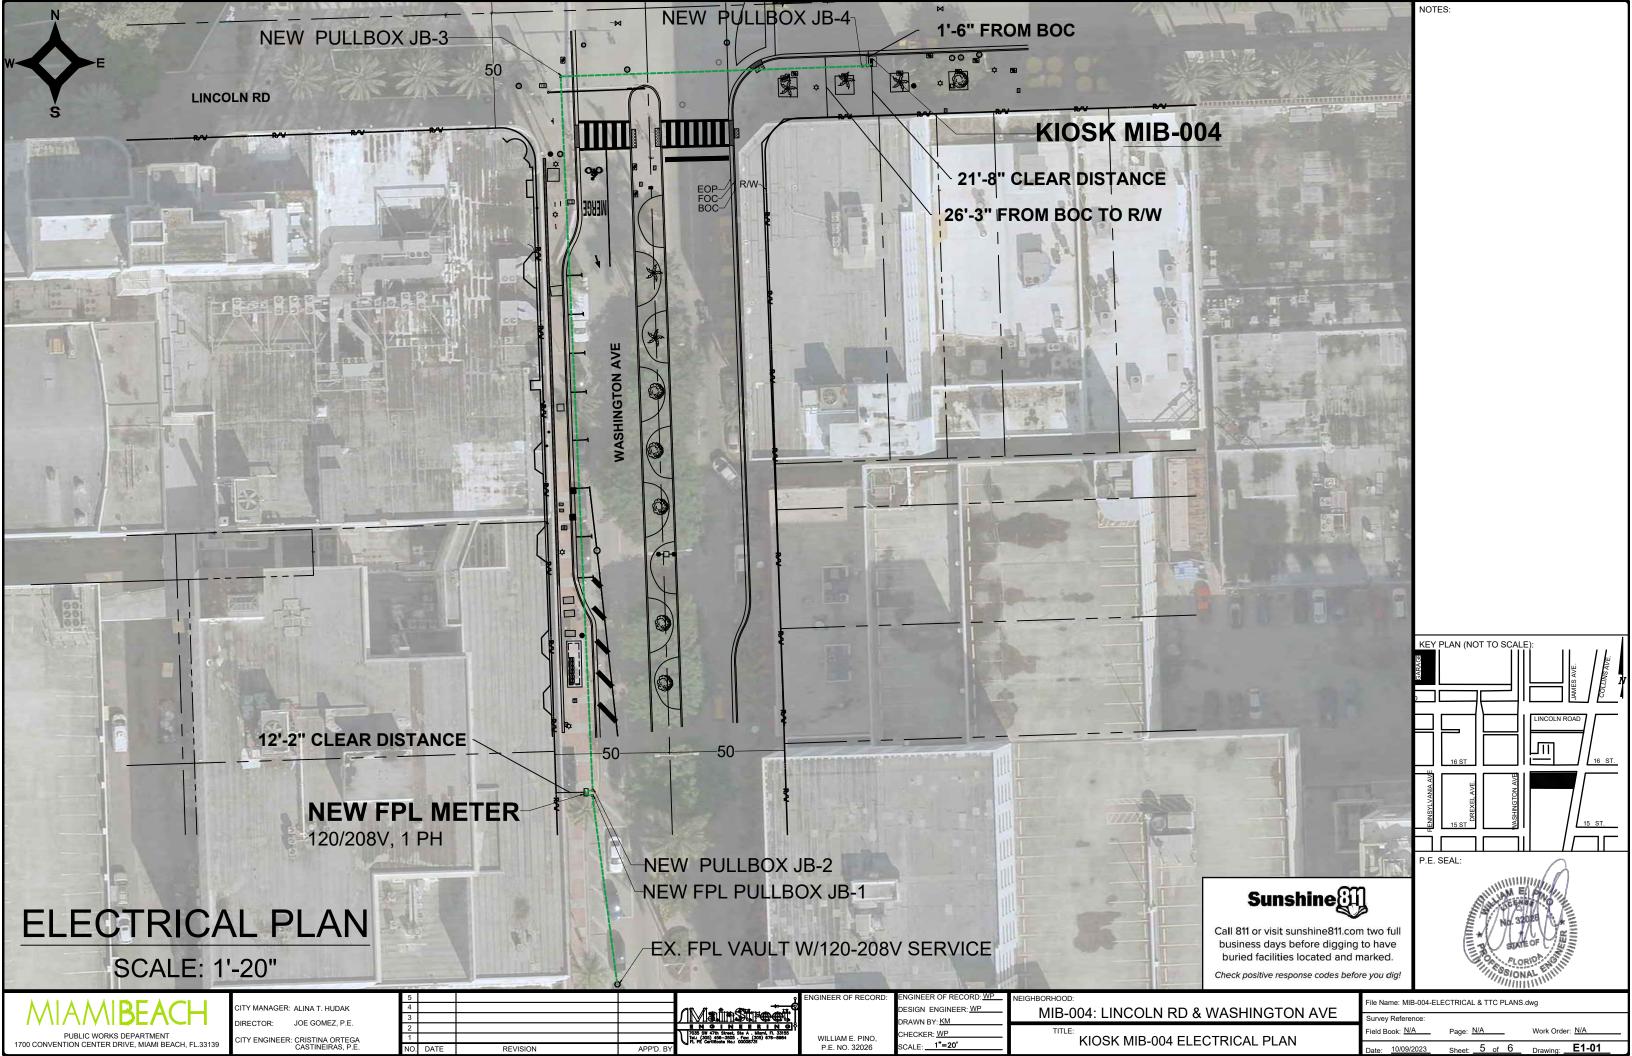

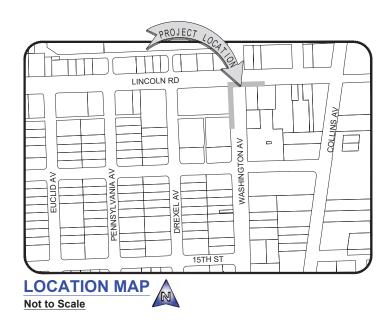

SURVEYOR'S REPORT AND GENERAL NOTES

(Not valid without the attached Survey Map)

- This is not a Boundary Survey.
- References to "Deed", "Record" or "Plat" refer to documents and instruments of record as part of the pertinent information used for this survey work. Measured distances, directions and angles along boundary lines are in consistency with corresponding values from records, unless otherwise shown.
- These lands are subject to additional restrictions of record that were not furnished to the undersigning registered surveyor. A title search has not been performed by the surveyor.
- 4. North arrow direction is based on an assumed Meridian. Bearings are based on an assumed meridian on a well-established line, said line is being noted as BR on the Survey Map.
- Only above ground improvements are shown herein. Foundations, underground features and utilities have not been located. 6. Survey markers found in the field have no identification unless otherwise shown. Any survey marker set by our
- company is labeled LB 7262 or PSM 6169.
- This Survey Map is intended to be displayed at the scale shown hereon. Data is expressed in U.S. Survey Foot.
- This Survey Map is being prepared for the use of the party/parties that it is certified to and does not extend to any unnamed individual, entity or assignee.
- 9. FLOODPLAIN INFORMATION: As scaled from Federal Insurance Rate Map (FIRM) of Community No. 120651 (City of Miami Beach), Panel 0319, Suffix L, revised on Sept 11th, 2009, this real property falls in Zone "AE" with Base Flood Elevation 8 feet (NGVD 1929)
- 10. HORIZONTAL ACCURACY: Accuracy obtained thru measurements and calculations meets and exceeds the
- minimum horizontal feature accuracy for a Suburban area being equal to 1 foot in 7, 500 feet.

 11. VERTICAL CONTROL AND ACCURACY: The elevations as shown are referred to the National American Vertical Datum of 1988 (NAVD 1988). The closure in feet, as computed, meets the standard of plus or minus 0.05 feet times the squared root of the loop distance in miles. Elevation are based on a level loop from and to the following official Bench Marks:

Bench Mark # 1: City Miami Beach Bench Mark CMB W 16. Elevation = 4.00 feet (NAVD'88) Description: PK nail & washer @ Northeast quadrant of intersection Washington Avenue and 16th Street. Bench Mark # 2: City Miami Beach Bench Mark CMB 16 02R, Elevation = 2.03 feet (NAVD'88) Description: PK nail & washer @ Northwest quadrant of intersection Pennsylvania Avenue & 16th Street.


- Data collected for this Survey had been determined using GNSS (RTK/GPS) conventional TS and differential leveling. Dimensions obtained are subject to equipment limitations.
- 2. Subsurface Utility investigation was performed as part of this survey using GPR (Ground Penetrating Radar) and RD (Radiodetection Technology) for designation and location of underground facilities. This Survey dépicts apparent location of underground piping found during this investigation. This method accuracy is plus or minus 1.5 feet approximately. There might be additional underground facilities not discovered at the time of this survey.



Main Street Engineering, that this Survey conforms to the Standards of Practice as set forth by the Florida Board of Professional Surveyors and Mappers in applicable provisions of Chapter 5J-17, Florida Administrative Code pursuant to Section 472.027 Florida Statutes. This Survey is accurate and correct to the best of my knowledge and belief



Odalys C. Bello-Iznaga Professional Surveyor and Mapper LS6169 State of Florida

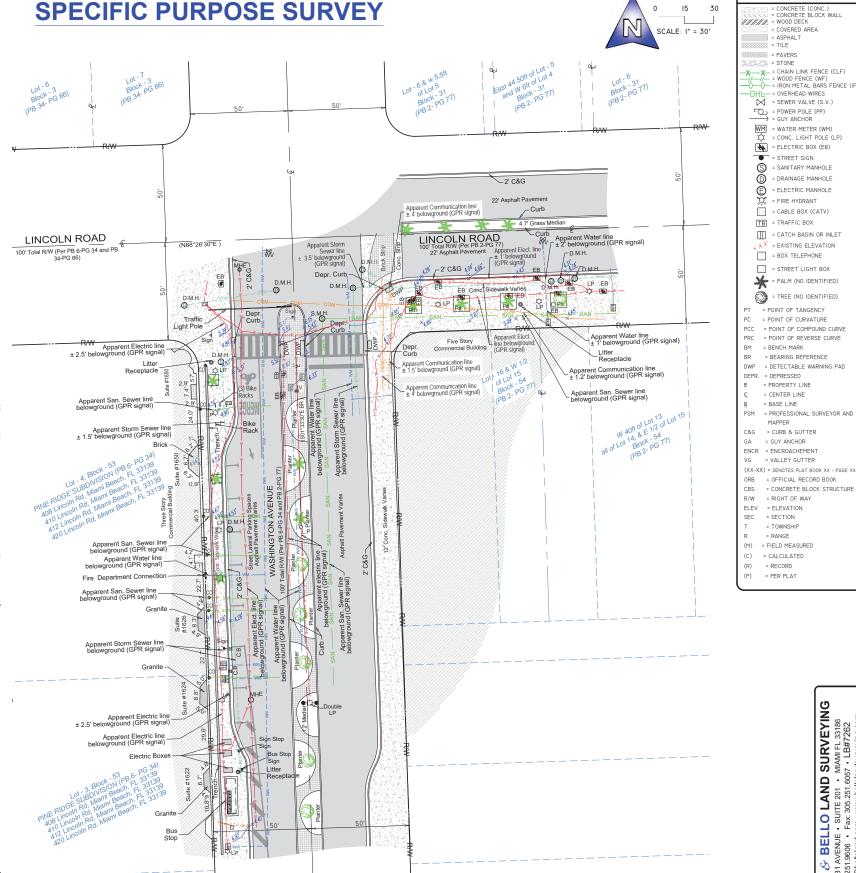

Additions and deletions to this Survey Map are prohibited. This Survey Map and Report are not valid without the signature and original raised seal or without the authenticated electronic signature and see of the undersign

Washington Avenue & Lincoln Road, Miami Beach, Florida 33139 Project No. 23182 D.B.: EO Page 1 of 1



SURVEYING MIAMI FL 33186 557 - LB#7262

BELLO LAND S

VENUE SUITE 201 · N

9606 · Fax: 305.251.6057

BELLO 412230 SW 13: Phone: 305.23 e-mail: info@

LEGEND & ABBREVIATIONS

= EXISTING ELEVATION

= POINT OF CURVATURE

= BEARING REFERENCE

MAPPER

7. Lincoln Rd & Washington Ave





PUBLIC WORKS DEPARTMENT

INTERACTIVE DIGITAL KIOSK DEPLOYMENT PROJECT
OCTOBER 2023
IKE SMART CITY

MIB-023: COLLINS AVENUE (SR-A1A) & LINCOLN ROAD MIB-024: COLLINS AVENUE (SR-A1A) & 16TH STREET

CITY OF MIAMI BEACH

MAYOR: DAN GELBER

COMMISSIONERS: MICKY STEINBERG

MARK SAMUELIAN MICHAEL GONGORA STEVEN MEINER RICKEY ARRIOLA DAVID RICHARDSON


CITY MANAGER: ALINA T. HUDAK

CITY ATTORNEY: RAFAEL A. PAZ

PUBLIC WORKS DIRECTOR: JOE GOMEZ, P.E., F.FES

CITY ENGINEER: NELSON PEREZ-JACOME, PE



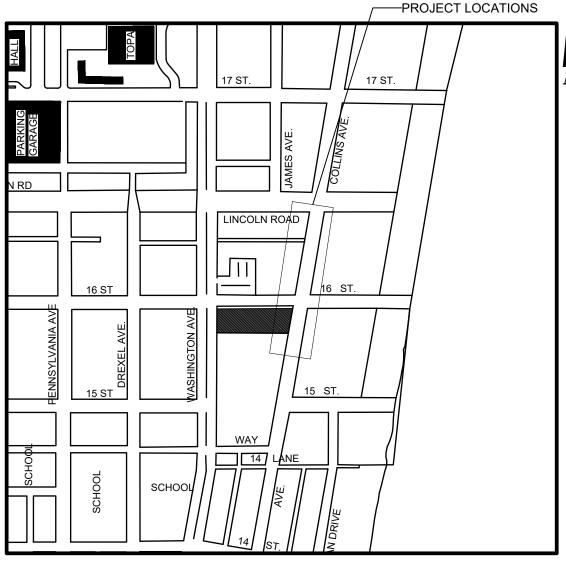



INDEX OF PLANS					
NUMBER	DISCIPLINE	SHEET NO.	DESCRIPTION	NOTES	
1	GENERAL	G0-03	INDEX OF SHEETS		
2	GENERAL	G0-04	ADA NOTES, SCOPE OF WORK & KIOSK SPECIFICATIONS		
3	CIVIL	C1-01	CIVIL SITE PLAN		
4	CIVIL	C1-02	KIOSK MIB-023 ENGINEERING PLAN		
5	CIVIL	C1-03	KIOSK MIB-024 ENGINEERING PLAN		
6	ELECTRICAL	E0-01	ELECTRICAL SITE PLAN		
7	ELECTRICAL	E1-01	KIOSK MIB-023 ELECTRICAL PLAN		
8	ELECTRICAL	E1-02	KIOSK MIB-024 ELECTRICAL PLAN		
9	SURVEY		KIOSK MIB-023 & MIB-024 SITE SURVEY		

SCOPE OF WORK: THE PROJECT CONSISTS OF THE INSTALLATION OF TWO (2) DIGITAL INTERACTIVE KIOSK AND APPLICABLE INFRASTRUCTURE; STRUCTURAL FOUNDATION AND ELECTRICAL SERVICE AT THE LOCATION INDICATED ON THESE DESIGN PLANS.

FINAL SUBMITTAL 10/09/2023

LOCATION MAP

INDEX OF PLANS

1					
	NUMBER	DISCIPLINE	SHEET NO.	DESCRIPTION	NOTES
	1	GENERAL	G0-03	INDEX OF SHEETS	
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	5	CIVIL	C1-03	KIOSK MIB-024 ENGINEERING PLAN	
	6	ELECTRICAL	E0-01	ELECTRICAL SITE PLAN	
	7	ELECTRICAL	E1-01	KIOSK MIB-023 ELECTRICAL PLAN	
	8	ELECTRICAL	E1-02	KIOSK MIB-024 ELECTRICAL PLAN	
	9	SURVEY		KIOSK MIB-023 & MIB-024 SITE SURVEY	

PROJECT LOCATIONS

MIB-023: FLAMINGO PARK HISTORIC DISTRICT MIB-024: OCEAN DRIVE/COLLINS AVENUE HISTORIC DISTRICT

LOCAL HISTORIC DISTRICTS Espanola Way Historic District Altos del Mar Historic District Flamingo Park Historic District

Palm View Historic District Collins Waterfront Historic District

Ocean Beach Historic District North Shore Historic District Harding Townsite Historic District

NATIONAL REGISTER HISTORIC DISTRICTS

Miami Beach Architectural District Normandy Isles Historic District

Collins Waterfront Architectural District

1 Old City Hall Historic Site

LOCAL HISTORIC SITES

2 21st St Recreation Center Historic Site Congregation Beth Jacob Historic Site

The Bath Club Historic Site

8 Dade Blvd Fire Station Historic Site

14 36 Ocean Dr Historic Site 1700 Alton Rd Historic Site

CABLE: COMCAST, XFINITY,

PROJECT DIRECTORY:

PROJECT NAME:

INTERACTIVE DIGITAL INFORMATION KIOSKS DEPLOYMENT PROJECT

JURISDICTION:

CITY OF MIAMI DEPARTMENT OF RESILIENCE AND **PUBLIC WORKS** MIAMI RIVERSIDE CENTER 444 S.W. 2nd AVENUE, 8th FLOOR MIAMI, FLORIDA 33130

OWNER:

IKE SMART CITY 250 N HARTOFORD AVE COLUMBUS, OH 43222 (614) 589-0087

ENGINEER OF RECORD: MAINSTREET ENGINEERING

7035 SW 47 STREET, SUITE A MIAMI, FL 33155 (305) 456-3505 PROJ. MGR: VANESSA MELA, P.E. VMELA@MAINSTREETENG.COM

KIOSK MANUFACTURER:

DISPLAY DEVICE INC. 21075 WESTGATE RD. **GOLDEN, CO 80403 CONTACT: ERIC PERKINS** PHONE: (303) 929-4071

UTILITIES:

ELECTRICAL POWER: FLORIDA POWER & LIGHT COMPANY (FPL)

WATER & SEWER: MIAMI-DADE WATER & SEWAGE DEPARTMENT

TELEPHONE: AT&T

ATT-UVERSE

GAS: FLORIDA GAS

SIDEWALK & STREET SYMBOLS **ASPHALT** BRICK **PAVER** CONCRETE UNIMPROVED TILE STAMPED **GRAVEL** CONCRETE

= PALM TREE = ORNAMENTAL TREE O.R.B. = OFFICIAL RECORDS BOOK ELEV. = ELEVATION = TYPICAL = CABLE TELEVISION = OVERHEAD ELECTRIC LINE = SPOT ELEVATION = CONCRETE = CONCRETE BLOCK STUCCO = CHAIN LINK FENCE = WOOD FENCE = METAL FENCE = REINFORCED CONCRETE PIPE = FINISH FLOOR = RECORD = CALCULATED = MEASURE = LICENSE BUSINESS = LENGTH = CENTRAL ANGLE = RADIUS = TANGENT = POINT OF TANGENCY = POINT OF CURVATURE = STATION = POINT OF INTERSECTION = IDENTIFICATION = METAL LIGHT POLE = SECTION LINE = CENTERLINE = MONUMENT LINE = TRAFFIC SIGNAL BOX = TRAFFIC SIGNAL CABINET = BOLLARD = PEDESTRIAN SIGNAL = TRAFFIC SIGNAL MAST ARM = SIGN = CABLE TELEVISION BOX = LIGHT POLE = UTILITY POLE = ELECTRIC TRANSFORMER = GUY ANCHOR = ELECTRIC METER = GAS VALVE = GAS UTILITY BOX = GAS MANHOLE = GAS TANK = GAS METER = COMMUNICATION BOX = COMMUNICATION MANHOLE = GARBAGE RECEPTACLE = HANDICAP PARKING SPACE = WATER METER = IRRIGATION VALVE = WATER VALVE = WATER BOX = WATER CONNECTION = WATER MANHOLE = WATER TANK = WATER WELL = WATER MARKING FLAG = WATER MARKING SIGN = STORM MANHOLE = STORM METER = CATCH BASIN = TELEPHONE MANHOLE = TELEPHONE BOX = NEWSPAPER DISPENSER = MAILBOX = SANITARY MANHOLE = SANITARY BOX = SANITARY TANK = SANITARY LIFT STATION = GREASE TRAP MANHOLE = CLEANOUT = PARKING METER = FIBER OPTIC BOX = FIBER OPTIC MARKER SIGN = MONITORING WELL = UNKNOWN UTILITY METER = UNKNOWN UTILITY MANHOLE = UNKNOWN UTILITY VALVE

= UNKNOWN UTILITY MARKER FLAG

= SANITARY VALVE = RAILROAD SIGN

= PROPERTY LINE = ELECTRICAL OUTLET

= FLAGPOLE

LEGEND AND ABBREVIATIONS

NOTES:

PUBLIC WORKS DEPARTMENT

1700 CONVENTION CENTER DRIVE, MIAMI BEACH, FL.33139

TEL: 305-416-1200

ITY MANAGER: ALINA T. HUDAK JOE GOMEZ, P.E.



ESIGN ENGINEER: VM DRAWN BY: KM HECKER: WP

P F NO 77676

SCALE:

HISTORIC DISTRICTS

AND SITES

CITY OF

MIAMI BEACH

FLORIDA .

INCORPORATED 1915

Biscayne Bay

NEIGHBORHOOD: MIB-023: COLLINS AVENUE & LINCOLN ROAD MIB-024: COLLINS AVENUE & 16TH STREET

INDEX OF SHEETS

Atlantic

File Name: MIB-023 & MIB-024 - GENERAL AND FOUNDATION.dwg

KEY PLAN (NOT TO SCALE)

SSA A. W

STATE OF

FLORIDA

SONAL

ADA NOTES

- 1. ALL CONSTRUCTION ACTIVITIES SHALL BE COMPLETED IN FULL COMPLIANCE WITH THE AMERICANS WITH DISABILITIES ACT (ADA). CLEAR SPACES IN FRONT OF KIOSK SHALL HAVE THE FOLLOWING CHARACTERISTICS:
- 2. SURFACES SHALL BE FIRM, STABLE, AND SLIP RESISTANT AND OTHERWISE COMPLY WITH PROWAG SECTION R302.7 AND SHALL HAVE A RUNNING SLOPE CONSISTENT WITH GRADE OF THE ADJACENT PEDESTRIANT ACCESS ROUTE AND CROSS SLOPE OF 1.50% +/-0.50%)
- 3. SIZE: CLEAR SPACES SHALL BE 48" MINIMUM BY 48" MINIMUM.
- 4. POSITION: UNLESS OTHERWISE SPECIFIED. CLEAR SPACES SHALL BE POSITIONED FOR EITHER FORWARD OR PARALLEL APPROACH TO THE KIOSK.
- 5. APPROACH: ONE FULL UNOBSTRUCTED SIDE OF A CLEAR SPACE SHALL ADJOIN A PEDESTRIAN ACCESS ROUTE OR ADJOIN ANOTHER CLEAR SPACE.
- 6. MANEUVERING SPACE: WHERE A CLEAR SPACE IS CONFINED ON ALL OR PART OF THREE SIDES, ADDITIONAL MANEUVERING SPACE SHALL BE PROVIDED AS FOLLOWS:
- 6.1.1. FORWARD APPROACH: THE CLEAR SPACE AND ADDITIONAL MANEUVERING SPACE SHALL BE 36" WIDE MINIMUM WHERE THE DEPTH OF THE CONFINING ELEMENT EXCEEDS 24".
- PARALLEL APPROACH: THE CLEAR SPACE AND ADDITIONAL MANEUVERING SPACE SHALL BE 60" WIDE MINIMUM WHERE THE DEPTH OF THE CONFINING ELEMENT EXCEEDS 15".
- 7. THE MINIMUM WHEELCHAIR PASSAGE WIDTH OR CLEAR SPACE WIDTH FOR A SINGLE WHEELCHAIR PASSAGE SHALL BE 48" PER PROWAG SECTION R302.3.
- 8. INITIAL OPERATION FOR THE KIOSK WILL HAVE 4G LTE CONNECTION SECTION R404. TO THE INTERNET.
- 9. THE KIOSKS HAVE BEEN DESIGN TO COMPLY WITH ALL ADA GUIDELINES INCLUDING VIEWING, OPERATION, AND ACCESSIBILITY.
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SCOPE OF WORK

THE PROJECT CONSIST OF THE INSTALLATION OF TWO (2) DIGITAL INTERACTIVE KIOSKS AT THE LOCATION(S) INDICATED ON THIS PLANS SET. INSTALLER SHALL PROVIDE AND INCLUDE ALL WORKMANSHIP AND MATERIALS NECESSARY TO COMPLETE THE INSTALLATION INCLUDING BUT NOT LIMITED TO:

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- 2. TWO (2) CAMERAS
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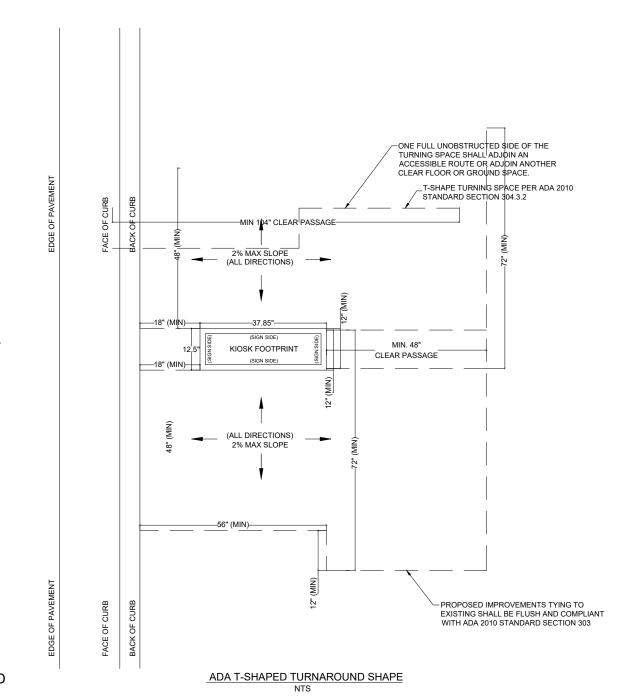
MANUFACTURER: DYNASCAN MODEL NUMBER: CIO651DR5 NATIVE RESOLUTION: 1920 X 1080

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- 1. ONE-2-POLE, 20 AMP, 240 VOLTS CIRCUIT.
- 2. TOTAL LOAD: 1400/2200 WATTS (OPERATIONAL/PEAK)
- 3. VOLTAGE: 100-240 VOLTS AC, 50-60 HZ

WEIGHT: 832 LBS

CERTIFICATION CE / FCC / RoHS



KEY PLAN (NOT TO SCALE) STATE OF FLORID

NOTES:



CITY MANAGER: ALINA T. HUDAK JOE GOMEZ, P.E. CITY ENGINEER: CRISTINA ORTEGA CASTINEIRAS, P.E.

VANESSA A. MELA

P F NO 77676

ESIGN ENGINEER VM RAWN BY: KM HECKER: WP SCALE:


EIGHBORHOOD: MIB-023: COLLINS AVENUE & LINCOLN ROAD MIB-024: COLLINS AVENUE & 16TH STREET


ADA NOTES, SCOPE OF WORK & KIOSK SPECIFICATIONS


File Name: MIB-023 & MIB-024 - GENERAL AND FOLINDATION dwo


2 of 9




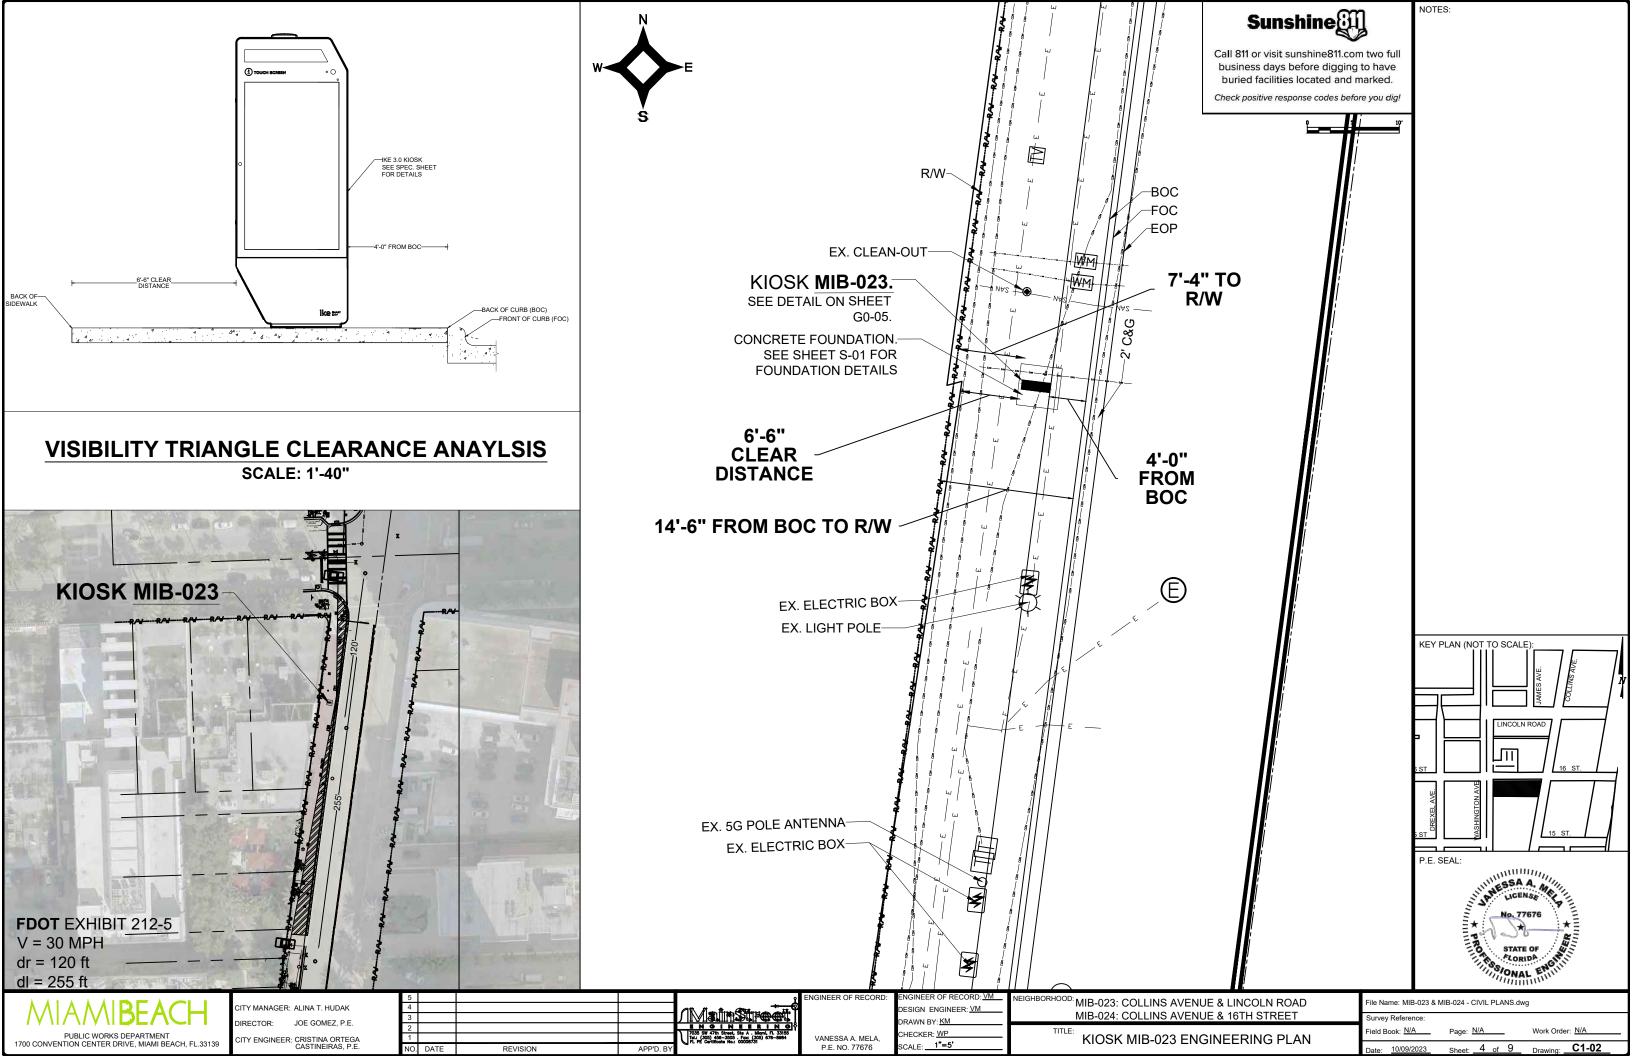


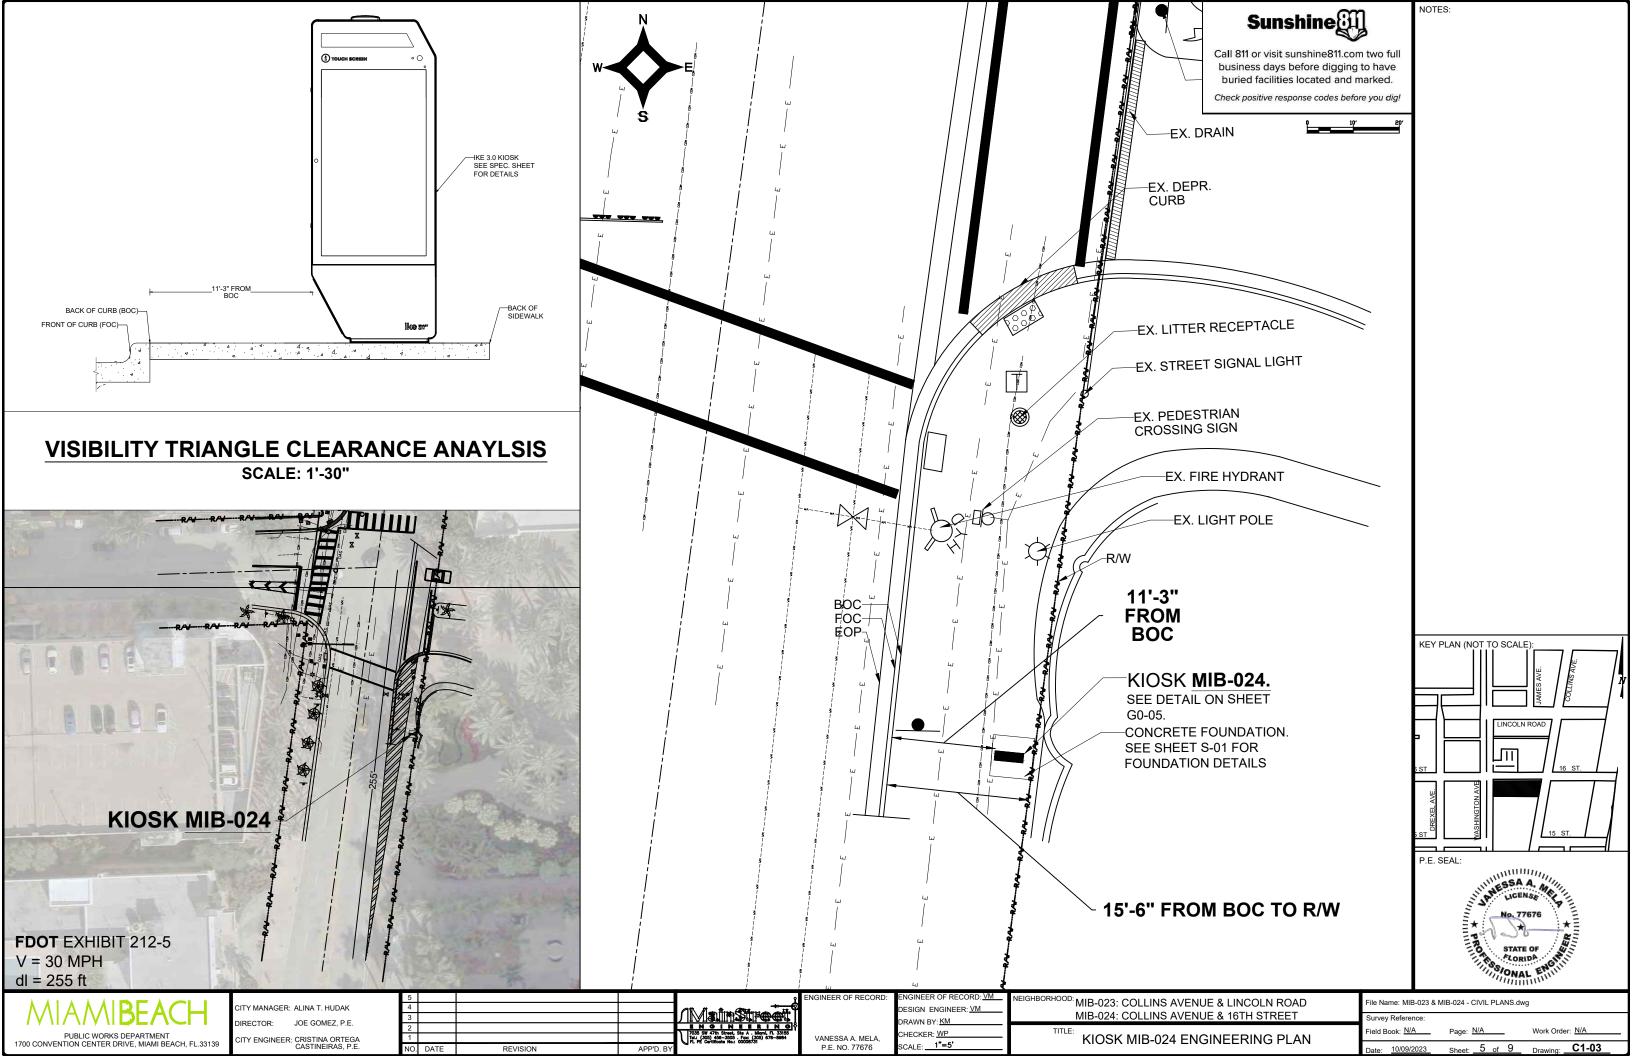

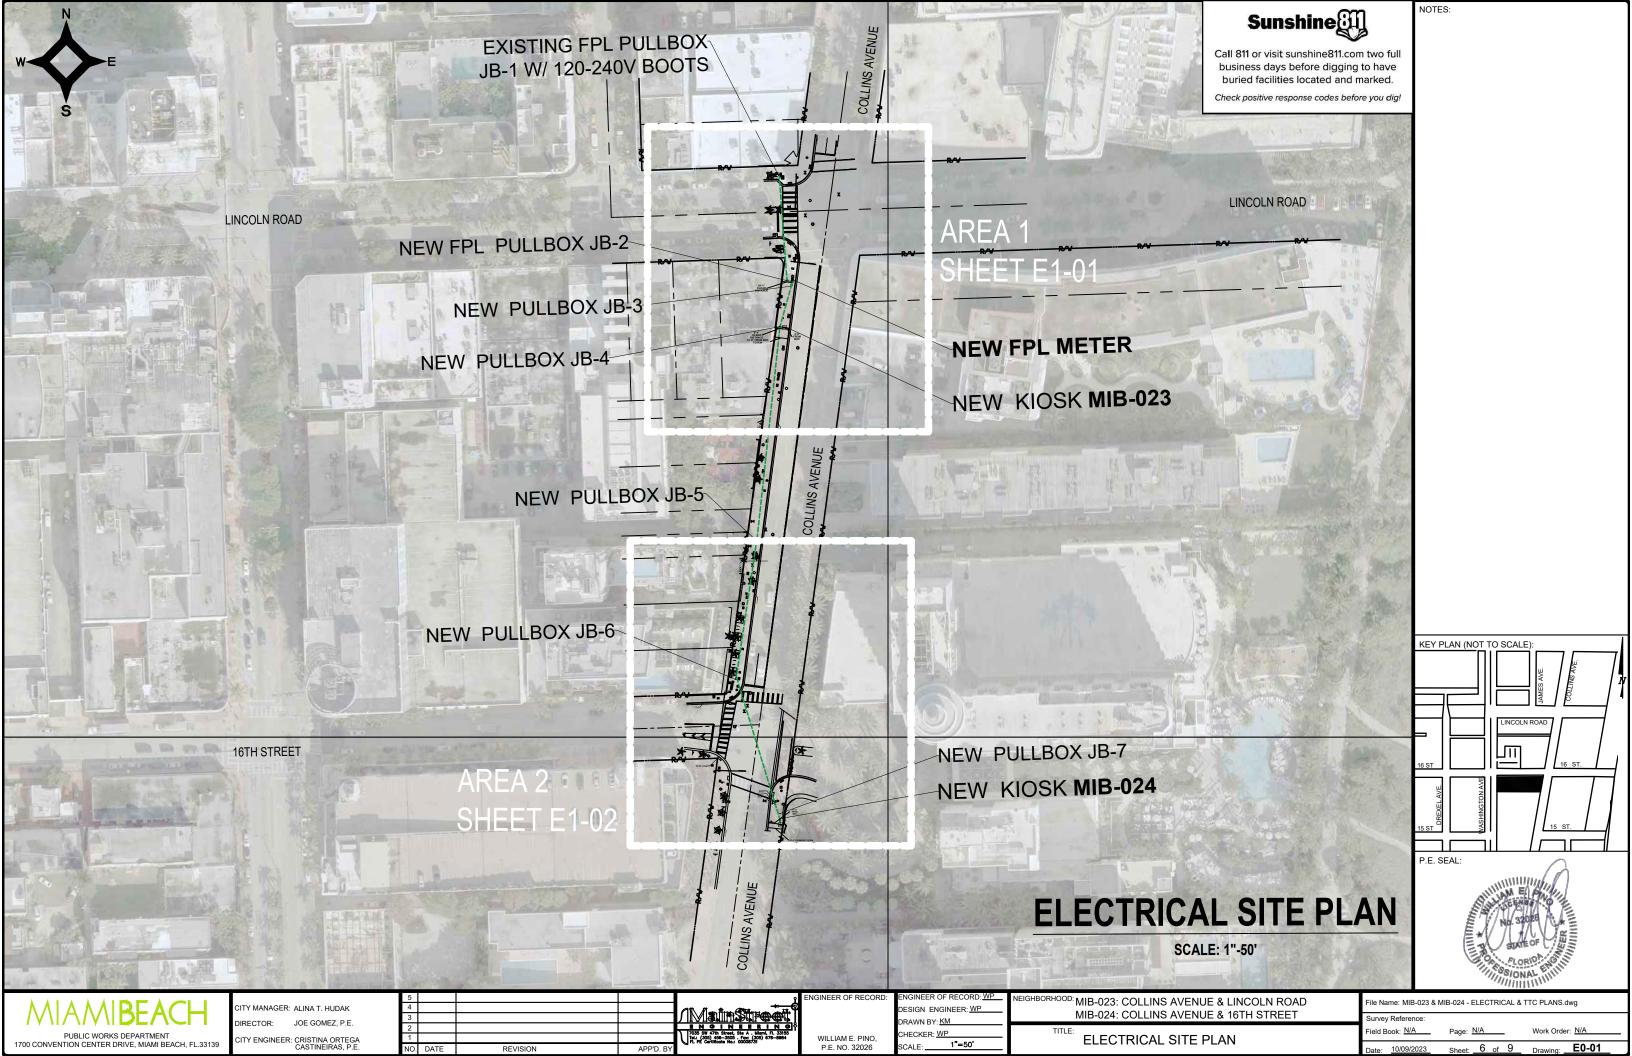

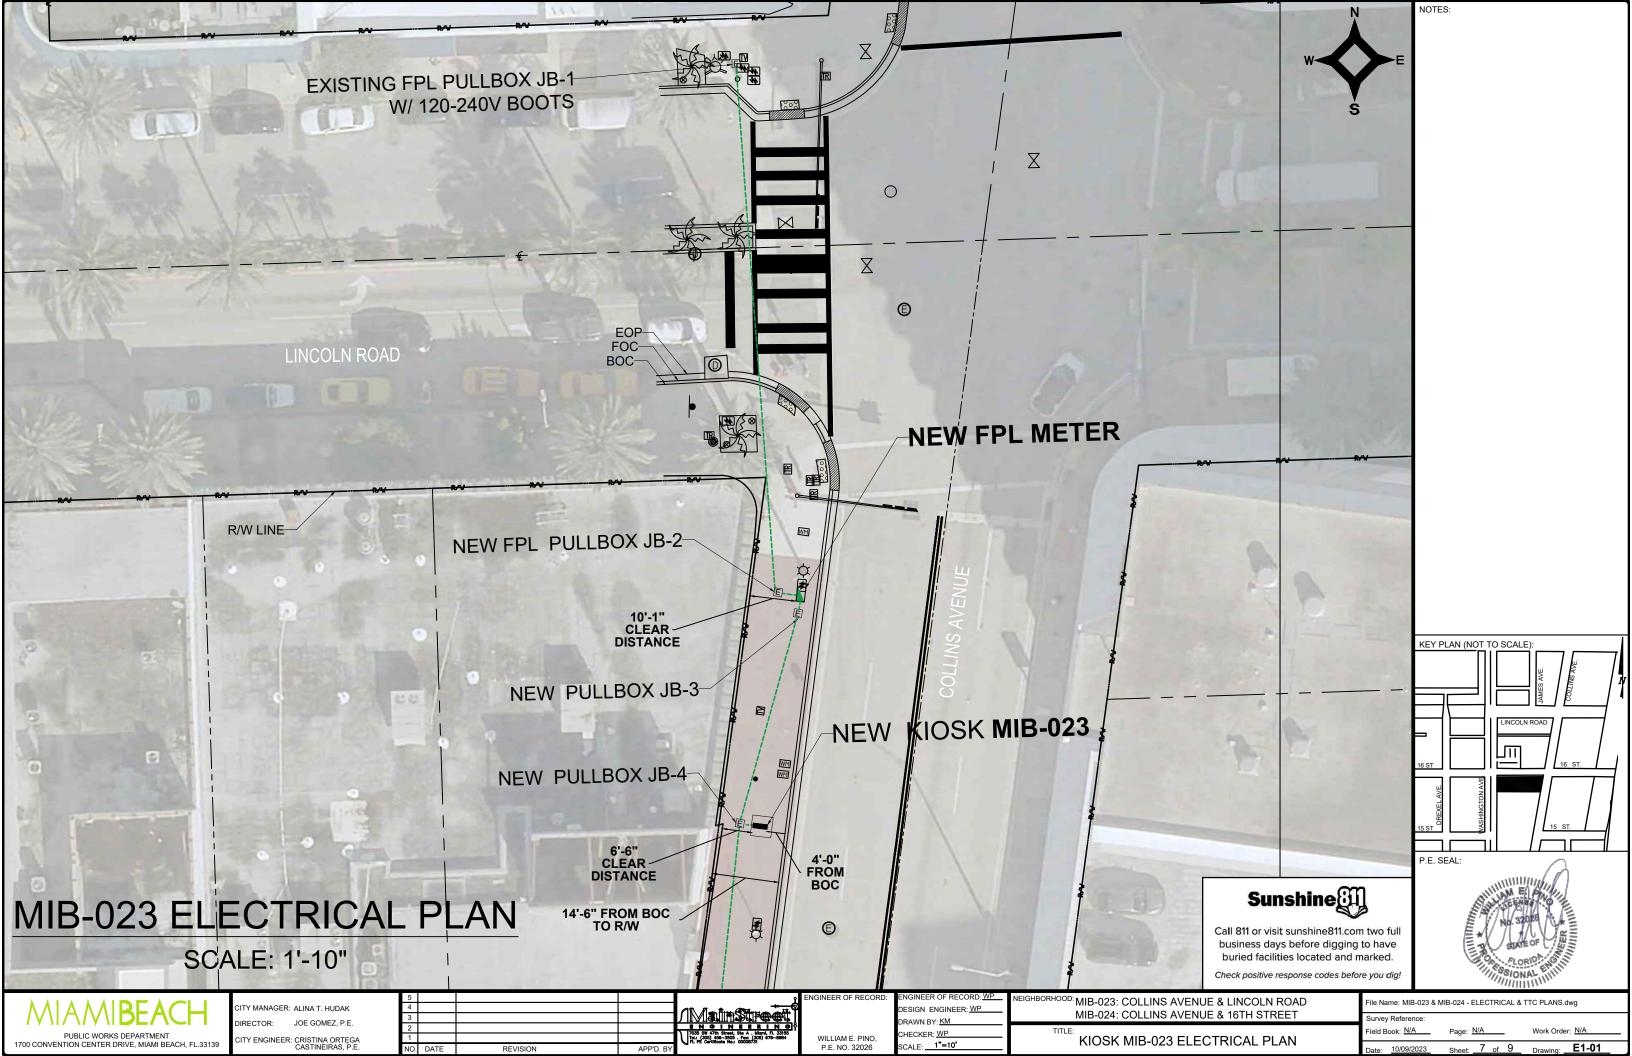

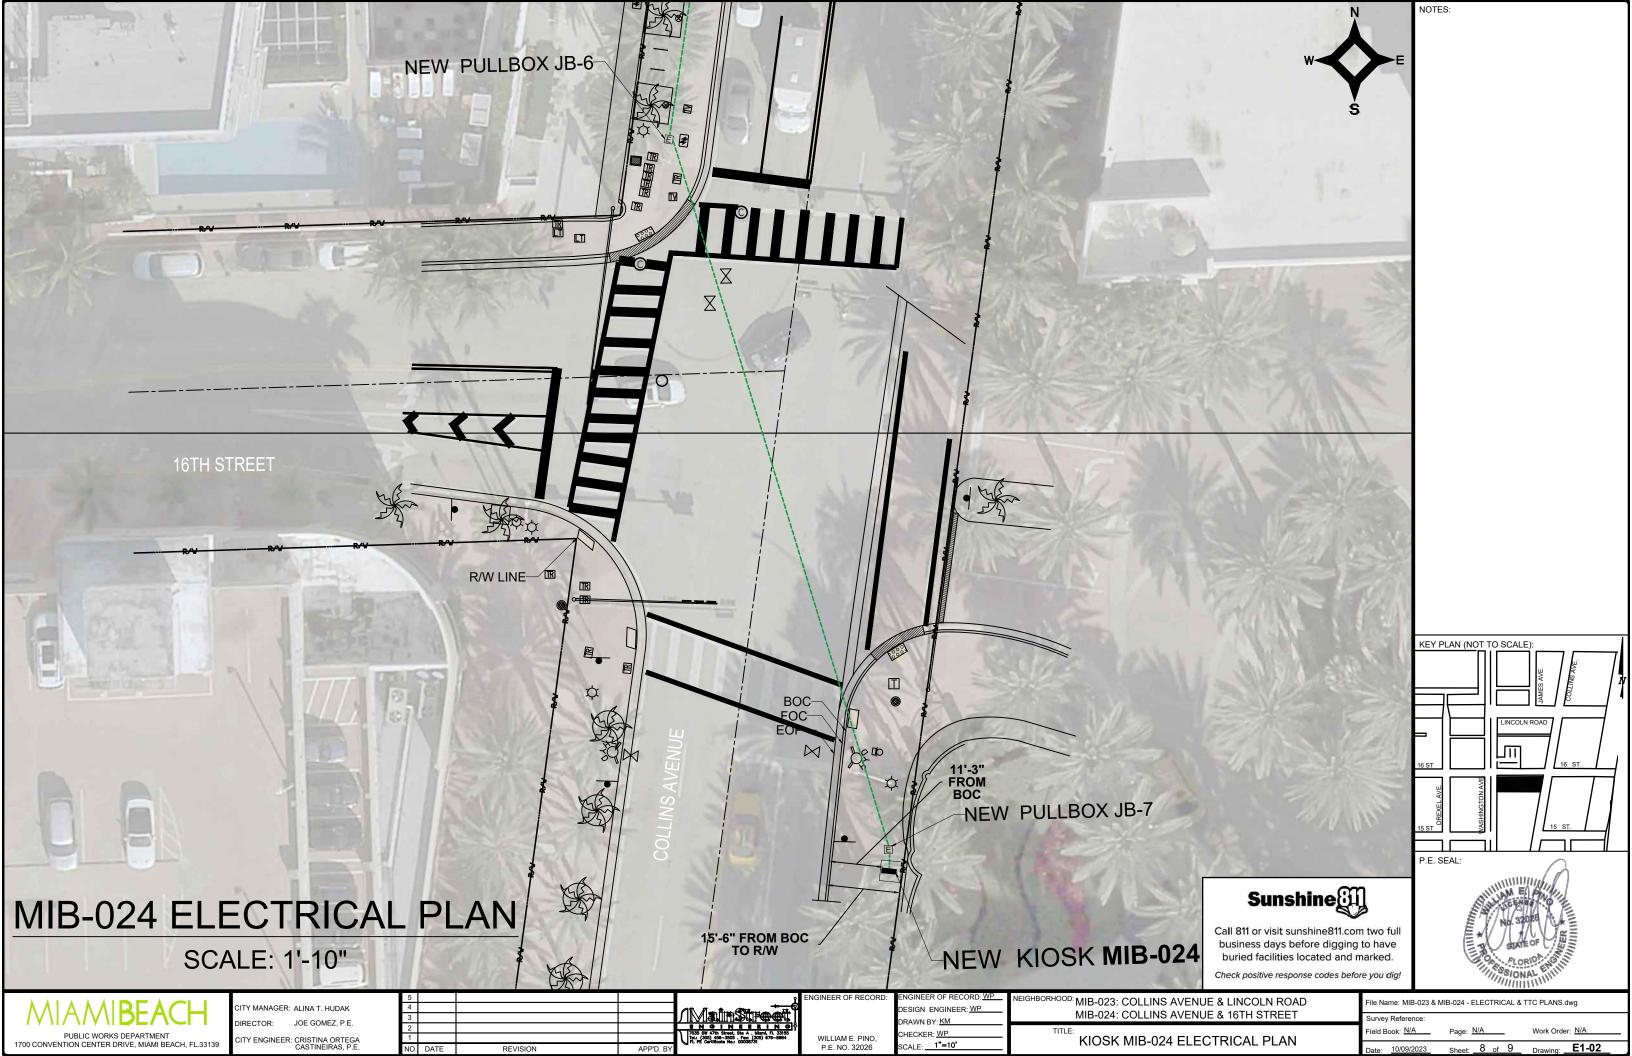

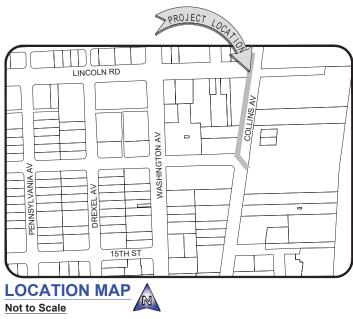

SURVEYOR'S REPORT AND GENERAL NOTES

- This is not a Boundary Survey.
- These lands are subject to additional restrictions of record that were not furnished to the undersigning registered surveyor. A title search has not been performed by the surveyor.
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Bench Mark # 1: City Miami Beach Bench Mark CMB W 16. Elevation = 4.00 feet (NAVD'88) Description: PK nail & washer @ Northeast quadrant of intersection Washington Avenue and 16th

Bench Mark # 2: City Miami Beach Bench Mark CMB 16 02R, Elevation = 2.03 feet (NAVD'88) Description: PK nail & washer @ Northwest quadrant of intersection Pennsylvania Avenue & 16th

11. SUE NOTES:

Subsurface Utility investigation was performed by South Florida Utility Location Services using GPR (Ground Penetrating Radar) and RD (Radiodetection Technology) for designation and location of underground facilities. The horizontal accuracy of this method is +/- 1.5 feet approximately, and is subject to equipment limitations. This Survey depicts the location of the marks indicating the approximate location of the buried pipes and conduits. There might be additional underground facilities not discovered at the time of this survey. Underground utility references as shown on this survey drawing is solely based on information marked on the field by South Florida Utility Location Services for this project. Contact information below:

South Florida Utility Location Services 15323 SW 31st Terrace, Miami, Florida 33185

(786) 547 9086 Office, Emai: rogerh@sf-uls.com, Contact Person: Roger Hasbani

Surveyor is not responsible for any errors or omissions that could arise from the information provided. Call 811 or visit www.sunshine811.com before digging.

- E- = RED PAINT LINE APPARENT ELECTRIC CONDUIT - - - WM - = BILLE PAINT LINE APPARENT WATER LINE - SAN - SAN - = GREEN PAINT LINE APPARENT SANITARY SEWER LINE GAS GAS = YELLOW PAINT LINE APPARENT GAS LINE - COM - COM = ORANGE PAINT LINE APPARENT COMMUNICATION LINE ____ STM___ = GREEN PAINT LINE APPARENT STORM SEWER LINE

SPECIFIC PURPOSE SURVEY LINCOLN ROAD 100' Total R/W (Per PB 6-PG 34 and PB 34-PG 66) Apparent San. Sewer III to allowaround (GPR signal) 3' CBS wall -

One Story Commercial Building

,30 O

One Story

± 9' belowground (GPR signal)

MATCH LINE SEE UPPER RIGHT

Commercial Building

Z≷

MATCH LINE SEE BOTTOM LEFT Bike Racks Lots 1 & 2, Block - 54 (PB 2- PG 77) 2' C&G orm Sewer line 6th STREET 3' belowground -(GPR signal)

LEGEND & ABBREVIATIONS

/////// = WOOD DECK

= COVERED AREA = ASPHALT = TILE

SCALE: I" = 30"

FOR a DETECTABLE WARNING PAD (DW = CHAIN LINK FENCE (CLF) = WOOD FENCE (WF)

= IRON METAL BARS FENCE (IF

= SEWER VALVE (S.V.) = POWER POLE (PP)

= GUY ANCHOR WM = WATER METER (WM)

XX = CONC. LIGHT POLE (= CONC. LIGHT POLE (LP) = ELECTRIC BOX (EB)

(X) = GARDEN LIGHT (G.L.) = STREET SIGN

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X.X = EXISTING ELEVATION

= TREE (NO IDENTIFIED)

= PALM (NO IDENTIFIED)

= POINT OF TANGENCY

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R/W = RIGHT OF WAY FLEV = FLEVATION

SEC = SECTION = TOWNSHIP

= RANGE = FIELD MEASURED

(C) = CALCULATED = PER PLAT

I HEREBY CERTIFY TO:

Main Street Engineering, that this Survey conforms to the Standards of Practice as set forth by the Florida Board of Professional Surveyors and Mappers in applicable provisions of Chapter 5J-17, Florida Administrative Code pursuant to Section 472.027 Florida Statutes. This Survey is accurate and correct to the best of my knowledge and belief.


Odalys C Bello 67E8000DD40A, cn=Odalys C Bello 2023.09.11 10:18:55 -04'00'

Odalys C. Bello-Iznaga Professional Surveyor and Mapper LS6169 · State of Florida Field Work Date: 07/27/2023

Additions and deletions to this Survey Map are prohibited. This Survey Map and Report are not valid without the signature and original raised seal or without the authenticated electronic signature and se of the undersigning Fortida licensed Surveyer and Manner.

Project No. 23259

200 Lincoln Road, Miami Beach, Florida 33139

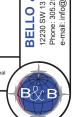


SURVEYING MIAMI FL 33186 557 - LB#7262

BELLO LAND S

VENUE SUITE 201 · N

9606 · Fax: 305.251.6057

8. Collins Ave & Lincoln Rd

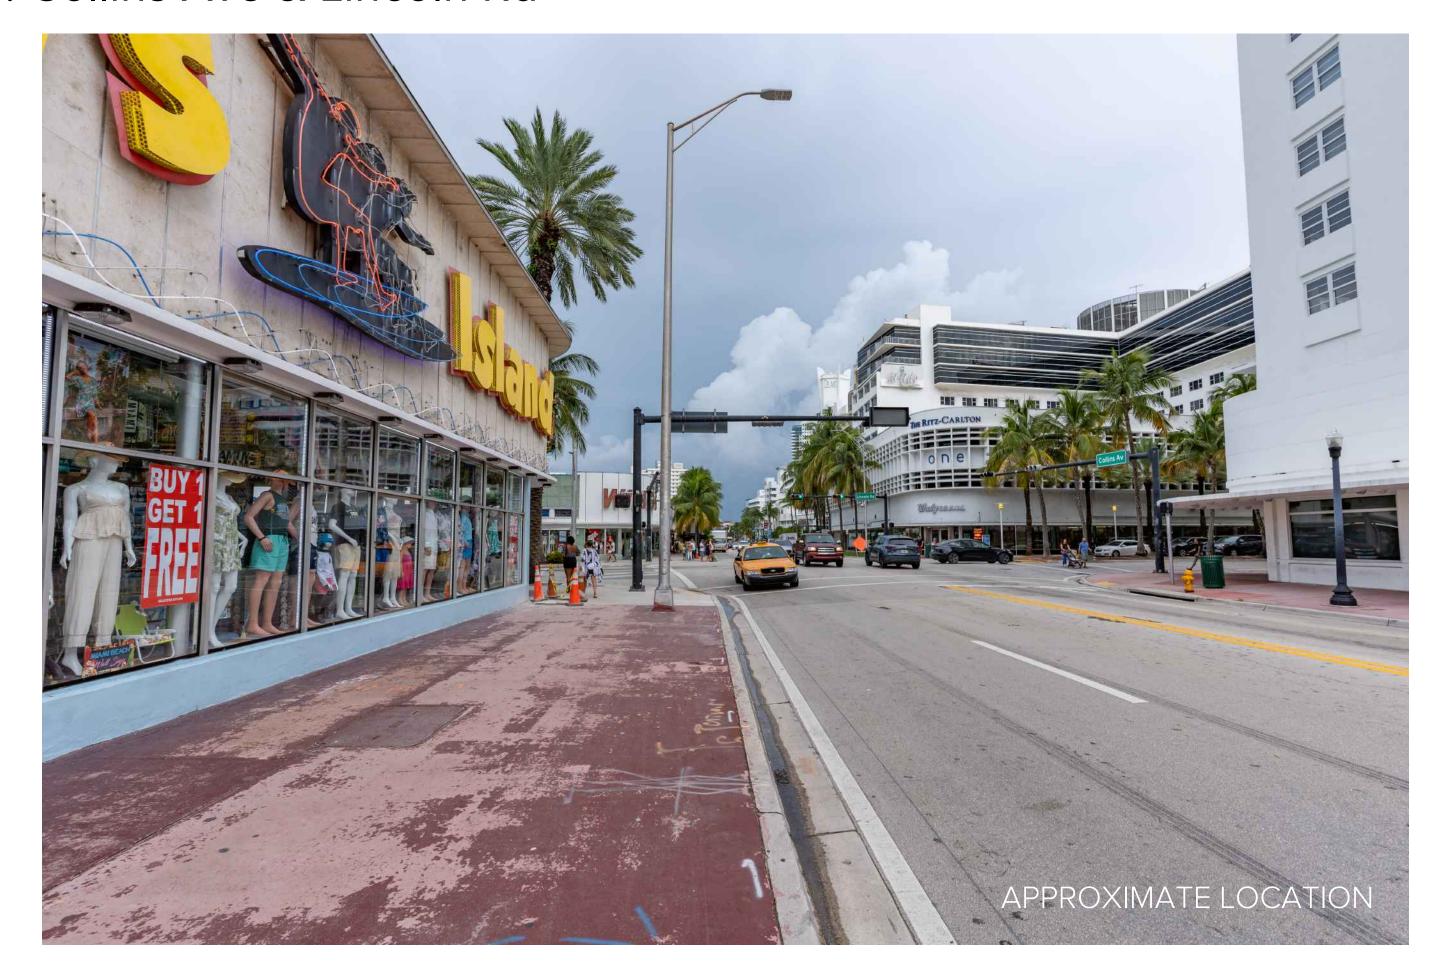



PUBLIC WORKS DEPARTMENT

INTERACTIVE DIGITAL KIOSK DEPLOYMENT PROJECT
OCTOBER 2023
IKE SMART CITY

MIB-023: COLLINS AVENUE (SR-A1A) & LINCOLN ROAD MIB-024: COLLINS AVENUE (SR-A1A) & 16TH STREET

CITY OF MIAMI BEACH

MAYOR: DAN GELBER

COMMISSIONERS: MICKY STEINBERG

MARK SAMUELIAN MICHAEL GONGORA STEVEN MEINER RICKEY ARRIOLA DAVID RICHARDSON


CITY MANAGER: ALINA T. HUDAK

CITY ATTORNEY: RAFAEL A. PAZ

PUBLIC WORKS DIRECTOR: JOE GOMEZ, P.E., F.FES

CITY ENGINEER: NELSON PEREZ-JACOME, PE



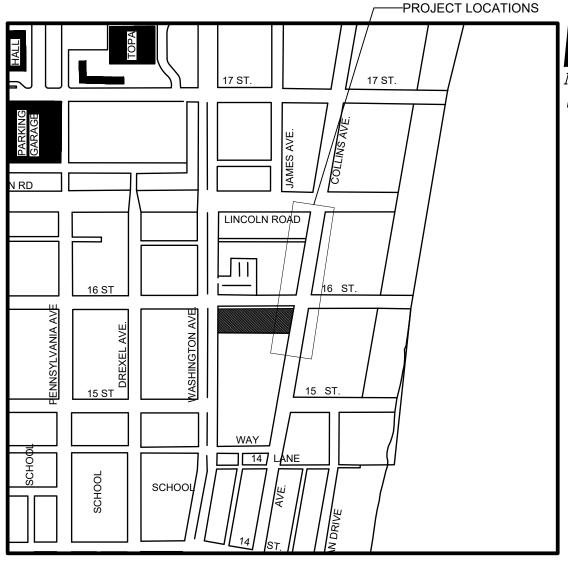



INDEX OF PLANS					
UMBER	DISCIPLINE	SHEET NO.	DESCRIPTION	NOTES	
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4	CIVIL	C1-02	KIOSK MIB-023 ENGINEERING PLAN		
5	CIVIL	C1-03	KIOSK MIB-024 ENGINEERING PLAN		
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7	ELECTRICAL	E1-01	KIOSK MIB-023 ELECTRICAL PLAN		
8	ELECTRICAL	E1-02	KIOSK MIB-024 ELECTRICAL PLAN		
9	SURVEY		KIOSK MIB-023 & MIB-024 SITE SURVEY		

SCOPE OF WORK: THE PROJECT CONSISTS OF THE INSTALLATION OF TWO (2) DIGITAL INTERACTIVE KIOSK AND APPLICABLE INFRASTRUCTURE; STRUCTURAL FOUNDATION AND ELECTRICAL SERVICE AT THE LOCATION INDICATED ON THESE DESIGN PLANS.

FINAL SUBMITTAL 10/09/2023

LOCATION MAP

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9	SURVEY		KIOSK MIB-023 & MIB-024 SITE SURVEY	

PROJECT LOCATIONS

MIB-023: FLAMINGO PARK HISTORIC DISTRICT MIB-024: OCEAN DRIVE/COLLINS AVENUE HISTORIC DISTRICT

LOCAL HISTORIC DISTRICTS Espanola Way Historic District Altos del Mar Historic District

Palm View Historic District Collins Waterfront Historic District

Flamingo Park Historic District

Ocean Beach Historic District North Shore Historic District Harding Townsite Historic District

NATIONAL REGISTER HISTORIC DISTRICTS

Miami Beach Architectural District Normandy Isles Historic District

Collins Waterfront Architectural District

The Bath Club Historic Site

DISPLAY DEVICE INC.

KIOSK MANUFACTURER:

LOCAL HISTORIC SITES

2 21st St Recreation Center Historic Site

Congregation Beth Jacob Historic Site

1 Old City Hall Historic Site

21075 WESTGATE RD. **GOLDEN, CO 80403**

CONTACT: ERIC PERKINS PHONE: (303) 929-4071

UTILITIES:

POWER & LIGHT COMPANY (FPL)

8 Dade Blvd Fire Station Historic Site

14 36 Ocean Dr Historic Site

1700 Alton Rd Historic Site

CABLE: COMCAST, XFINITY, ATT-UVERSE

HISTORIC DISTRICTS **AND SITES** CITY OF **MIAMI BEACH** FLORIDA . INCORPORATED 1915 Biscayne Bay Atlantic SIDEWALK & STREET SYMBOLS

ASPHALT

PAVER

UNIMPROVED

GRAVEL

ELEV. = ELEVATION = TYPICAL = CABLE TELEVISION = OVERHEAD ELECTRIC LINE = SPOT ELEVATION = CONCRETE = CONCRETE BLOCK STUCCO = CHAIN LINK FENCE = WOOD FENCE = METAL FENCE = REINFORCED CONCRETE PIPE = FINISH FLOOR = RECORD = CALCULATED = MEASURE = LICENSE BUSINESS = LENGTH = CENTRAL ANGLE = RADIUS = TANGENT = POINT OF TANGENCY = POINT OF CURVATURE = STATION = POINT OF INTERSECTION = IDENTIFICATION = METAL LIGHT POLE = SECTION LINE = CENTERLINE = MONUMENT LINE = TRAFFIC SIGNAL BOX = TRAFFIC SIGNAL CABINET = BOLLARD = PEDESTRIAN SIGNAL = TRAFFIC SIGNAL MAST ARM = SIGN = CABLE TELEVISION BOX = LIGHT POLE = UTILITY POLE = ELECTRIC TRANSFORMER = GUY ANCHOR = ELECTRIC METER = GAS VALVE = GAS UTILITY BOX = GAS MANHOLE = GAS TANK = GAS METER = COMMUNICATION BOX = COMMUNICATION MANHOLE = GARBAGE RECEPTACLE = HANDICAP PARKING SPACE = WATER METER = IRRIGATION VALVE = WATER VALVE = WATER BOX = WATER CONNECTION = WATER MANHOLE = WATER TANK = WATER WELL = WATER MARKING FLAG = WATER MARKING SIGN = STORM MANHOLE = STORM METER = CATCH BASIN = TELEPHONE MANHOLE = TELEPHONE BOX = NEWSPAPER DISPENSER = MAILBOX = SANITARY MANHOLE = SANITARY BOX = SANITARY TANK = SANITARY LIFT STATION = GREASE TRAP MANHOLE = CLEANOUT

LEGEND AND ABBREVIATIONS

= ORNAMENTAL TREE

= OFFICIAL RECORDS BOOK

= PALM TREE

O.R.B.

NOTES:

KEY PLAN (NOT TO SCALE) SSA A. W = UNKNOWN UTILITY METER = UNKNOWN UTILITY MANHOLE = UNKNOWN UTILITY MARKER FLAG

PROJECT DIRECTORY:

PROJECT NAME:

INTERACTIVE DIGITAL INFORMATION KIOSKS DEPLOYMENT PROJECT

JURISDICTION:

CITY OF MIAMI DEPARTMENT OF RESILIENCE AND **PUBLIC WORKS** MIAMI RIVERSIDE CENTER 444 S.W. 2nd AVENUE, 8th FLOOR MIAMI, FLORIDA 33130 TEL: 305-416-1200

OWNER:

IKE SMART CITY 250 N HARTOFORD AVE COLUMBUS, OH 43222 (614) 589-0087

ENGINEER OF RECORD: MAINSTREET ENGINEERING

7035 SW 47 STREET, SUITE A MIAMI, FL 33155 (305) 456-3505 PROJ. MGR: VANESSA MELA, P.E. VMELA@MAINSTREETENG.COM

ELECTRICAL POWER: FLORIDA

WATER & SEWER: MIAMI-DADE WATER & SEWAGE DEPARTMENT

TELEPHONE: AT&T

GAS: FLORIDA GAS

SCALE:

ESIGN ENGINEER: VM DRAWN BY: KM HECKER: WP

NEIGHBORHOOD: MIB-023: COLLINS AVENUE & LINCOLN ROAD MIB-024: COLLINS AVENUE & 16TH STREET

BRICK

CONCRETE

TILE

STAMPED

CONCRETE

File Name: MIB-023 & MIB-024 - GENERAL AND FOUNDATION.dwg

PUBLIC WORKS DEPARTMENT 1700 CONVENTION CENTER DRIVE, MIAMI BEACH, FL.33139

JOE GOMEZ, P.E.

ITY MANAGER: ALINA T. HUDAK

P F NO 77676

INDEX OF SHEETS

= PARKING METER

= FIBER OPTIC BOX

= SANITARY VALVE = RAILROAD SIGN

= PROPERTY LINE = ELECTRICAL OUTLET

= FLAGPOLE

= MONITORING WELL

= FIBER OPTIC MARKER SIGN

= UNKNOWN UTILITY VALVE

STATE OF

FLORIDA

SONAL

ADA NOTES

- 1. ALL CONSTRUCTION ACTIVITIES SHALL BE COMPLETED IN FULL COMPLIANCE WITH THE AMERICANS WITH DISABILITIES ACT (ADA). CLEAR SPACES IN FRONT OF KIOSK SHALL HAVE THE FOLLOWING CHARACTERISTICS:
- 2. SURFACES SHALL BE FIRM, STABLE, AND SLIP RESISTANT AND OTHERWISE COMPLY WITH PROWAG SECTION R302.7 AND SHALL HAVE A RUNNING SLOPE CONSISTENT WITH GRADE OF THE ADJACENT PEDESTRIANT ACCESS ROUTE AND CROSS SLOPE OF 1.50% +/-0.50%)
- 3. SIZE: CLEAR SPACES SHALL BE 48" MINIMUM BY 48" MINIMUM.
- 4. POSITION: UNLESS OTHERWISE SPECIFIED. CLEAR SPACES SHALL BE POSITIONED FOR EITHER FORWARD OR PARALLEL APPROACH TO THE KIOSK.
- 5. APPROACH: ONE FULL UNOBSTRUCTED SIDE OF A CLEAR SPACE SHALL ADJOIN A PEDESTRIAN ACCESS ROUTE OR ADJOIN ANOTHER CLEAR SPACE.
- 6. MANEUVERING SPACE: WHERE A CLEAR SPACE IS CONFINED ON ALL OR PART OF THREE SIDES, ADDITIONAL MANEUVERING SPACE SHALL BE PROVIDED AS FOLLOWS:
- 6.1.1. FORWARD APPROACH: THE CLEAR SPACE AND ADDITIONAL MANEUVERING SPACE SHALL BE 36" WIDE MINIMUM WHERE THE DEPTH OF THE CONFINING ELEMENT EXCEEDS 24".
- PARALLEL APPROACH: THE CLEAR SPACE AND ADDITIONAL MANEUVERING SPACE SHALL BE 60" WIDE MINIMUM WHERE THE DEPTH OF THE CONFINING ELEMENT EXCEEDS 15".
- 7. THE MINIMUM WHEELCHAIR PASSAGE WIDTH OR CLEAR SPACE WIDTH FOR A SINGLE WHEELCHAIR PASSAGE SHALL BE 48" PER PROWAG SECTION R302.3.
- 8. INITIAL OPERATION FOR THE KIOSK WILL HAVE 4G LTE CONNECTION SECTION R404. TO THE INTERNET.
- 9. THE KIOSKS HAVE BEEN DESIGN TO COMPLY WITH ALL ADA GUIDELINES INCLUDING VIEWING, OPERATION, AND ACCESSIBILITY.
- 10. THE MOBILE IKE EXPERIENCE WILL FOLLOW WEB CONTENT ACCESSIBILITY GUIDELINES (WCAG) TO WORK IN TANDEM WITH THE NATIVE ACCESSIBILITY FEATURES ON THE USER'S MOBILE DEVICE, INCLUDING TALKBACK AND VOICEOVER TOOLS.

SCOPE OF WORK

THE PROJECT CONSIST OF THE INSTALLATION OF TWO (2) DIGITAL INTERACTIVE KIOSKS AT THE LOCATION(S) INDICATED ON THIS PLANS SET. INSTALLER SHALL PROVIDE AND INCLUDE ALL WORKMANSHIP AND MATERIALS NECESSARY TO COMPLETE THE INSTALLATION INCLUDING BUT NOT LIMITED TO:

- 1. INSTALLATION OF THE KIOSKS TO THE FOUNDATION AS INDICATED ON PLANS TO NEW RECTANGULAR CONCRETE FOUNDATION.
- 2. ELECTRICAL SERVICE POINTS ARE EXISTING. CONNECT THE EXISTING ELECTRIC SERVICE TO THE NEW KIOSK AS INDICATED ON PLANS.
- 3. TESTING OF THE ELECTRICAL SERVICE INFRASTRUCTURE SHALL BE PERFORMED IN CONJUNCTION WITH A REPRESENTATIVE OF THE ENGINEER OF RECORD.
- 4. THE CONTRACTOR SHALL INSTALL THE KIOSK IN SUCH A WAY THAT THE KIOSK IS WITHIN THE PUBLIC R.O.W. AND IN COMPLIANCE WITH ALL APPLICABLE A.D.A. REQUIREMENTS
- 5. THE LOCATION OF KIOSKS HAS BEEN COORDINATE TO ENSURE THERE IS NO OBSTRUCTION OF THE SIGHT OF VEHICULAR SIGNS.
- 6. STAND-ALONE PEDESTRIAN KIOSKS SHOULD NOT BE INSTALLED WITHIN PEDESTRIAN CIRCULATION PATHS IN A MANNER THAT PERSONS AT THE KIOSK LOCK THE EFFECTIVE WIDTH OF THE PEDESTRIAN TRAVEL WAY.

MONUMENT SIGN SPECIFICATIONS AND FUNCTIONS

THE UNIT CONSISTS OF A UL/NRTL LISTED WEATHER AND VANDAL RESISTANT FREE STANDING ENCLOSURE DESIGNED TO COMPLY WITH THE FLORIDA BUILDING CODE AND OTHER APPLICABLE CODES INCLUDING THE NATIONAL ELECTRICAL CODE. THE UNIT HAS BEEN DESIGNED TO WITHSTAND WINDS OF 165 MPH. THE UNIT'S MAIN COMPONENTS ARE:

- 1. TWO (2) INTERACTIVE 65" VIDEO TOUCH SCREENS.
- 2. TWO (2) CAMERAS
- 3. ONE (1) CPU
- 4. ONE (1) WI-FI TRANSMITTER


MANUFACTURER: DYNASCAN MODEL NUMBER: CIO651DR5 NATIVE RESOLUTION: 1920 X 1080

ELECTRICAL POWER REQUIREMENT:

- 1. ONE-2-POLE, 20 AMP, 240 VOLTS CIRCUIT.
- 2. TOTAL LOAD: 1400/2200 WATTS (OPERATIONAL/PEAK)
- 3. VOLTAGE: 100-240 VOLTS AC, 50-60 HZ

WEIGHT: 832 LBS

CERTIFICATION CE / FCC / RoHS

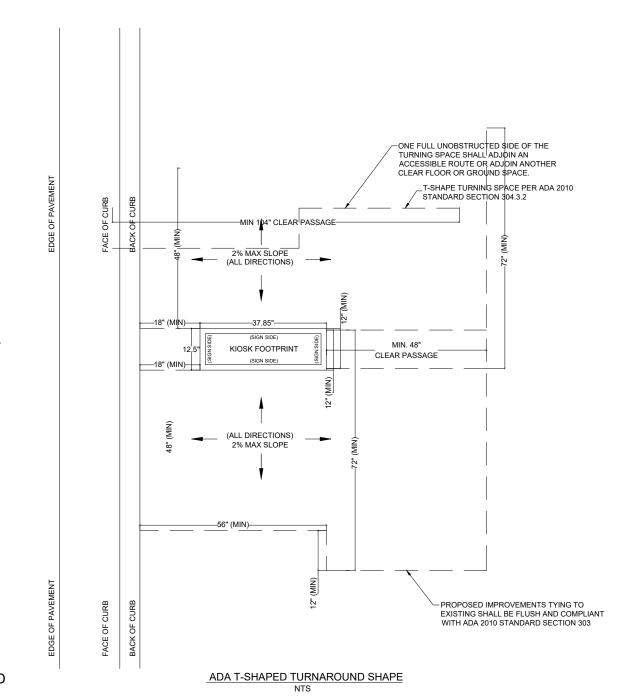

KEY PLAN (NOT TO SCALE) STATE OF FLORID

NOTES:



CITY MANAGER: ALINA T. HUDAK JOE GOMEZ, P.E. CITY ENGINEER: CRISTINA ORTEGA CASTINEIRAS, P.E.

VANESSA A. MELA

P F NO 77676

ESIGN ENGINEER VM RAWN BY: KM HECKER: WP SCALE:


EIGHBORHOOD: MIB-023: COLLINS AVENUE & LINCOLN ROAD MIB-024: COLLINS AVENUE & 16TH STREET


ADA NOTES, SCOPE OF WORK & KIOSK SPECIFICATIONS


File Name: MIB-023 & MIB-024 - GENERAL AND FOLINDATION dwo


2 of 9




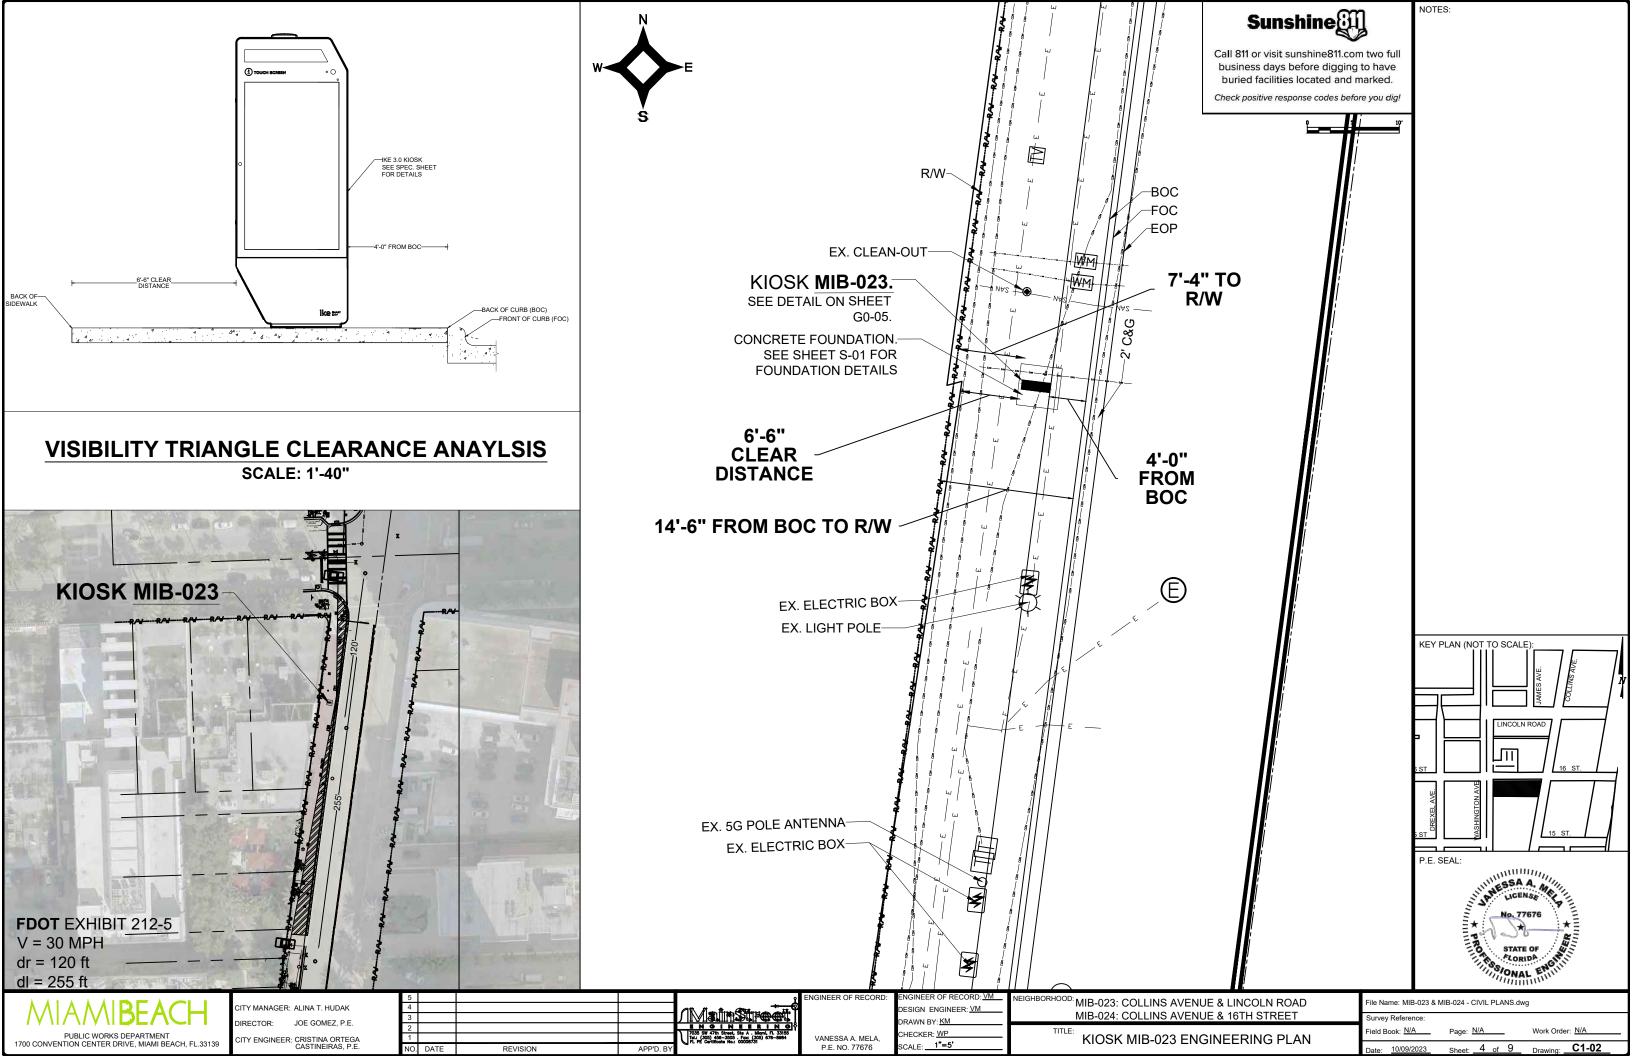


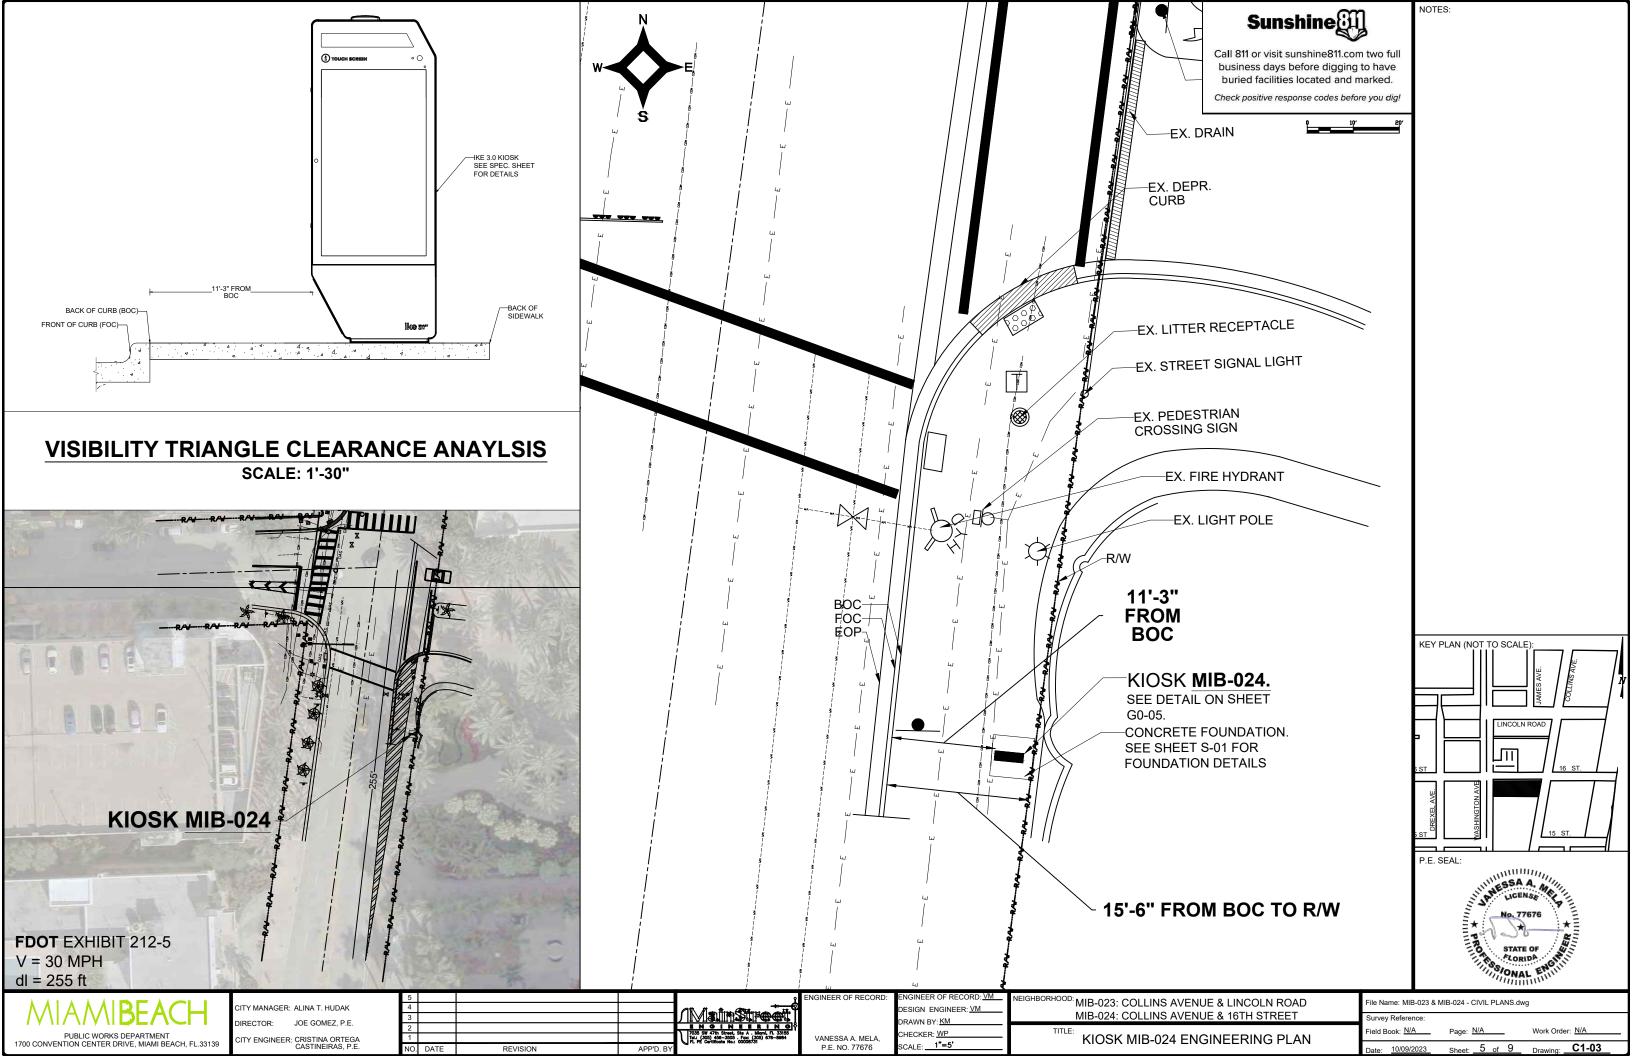

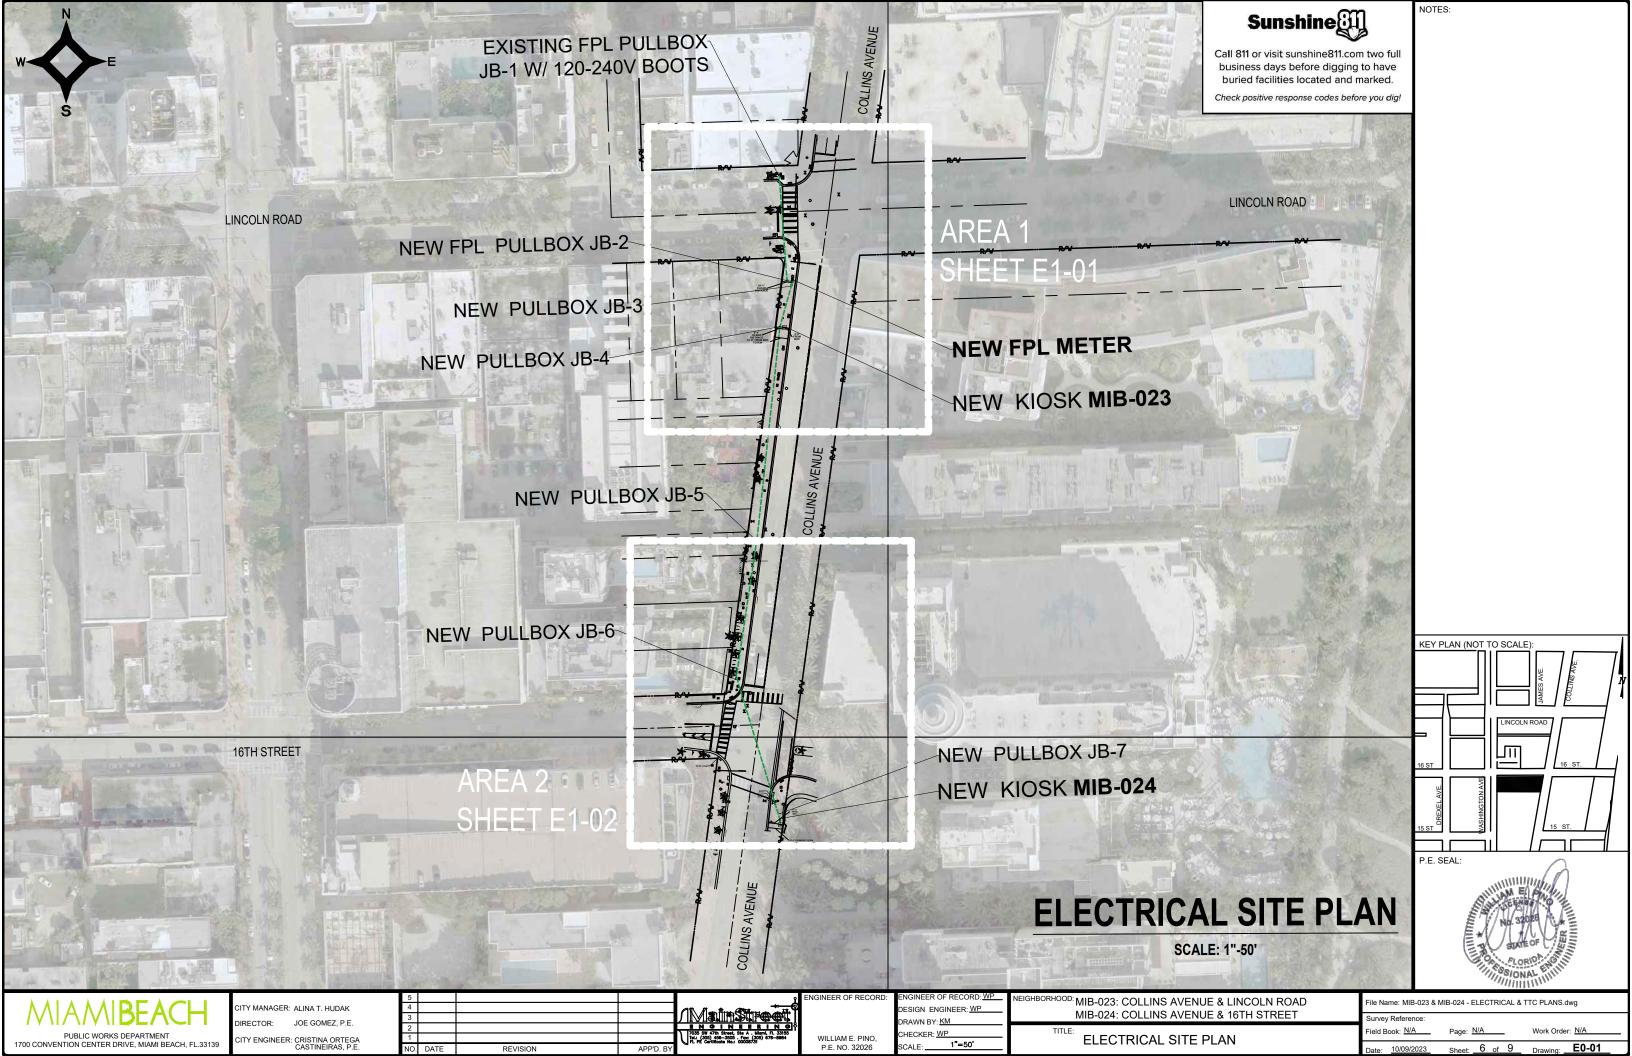

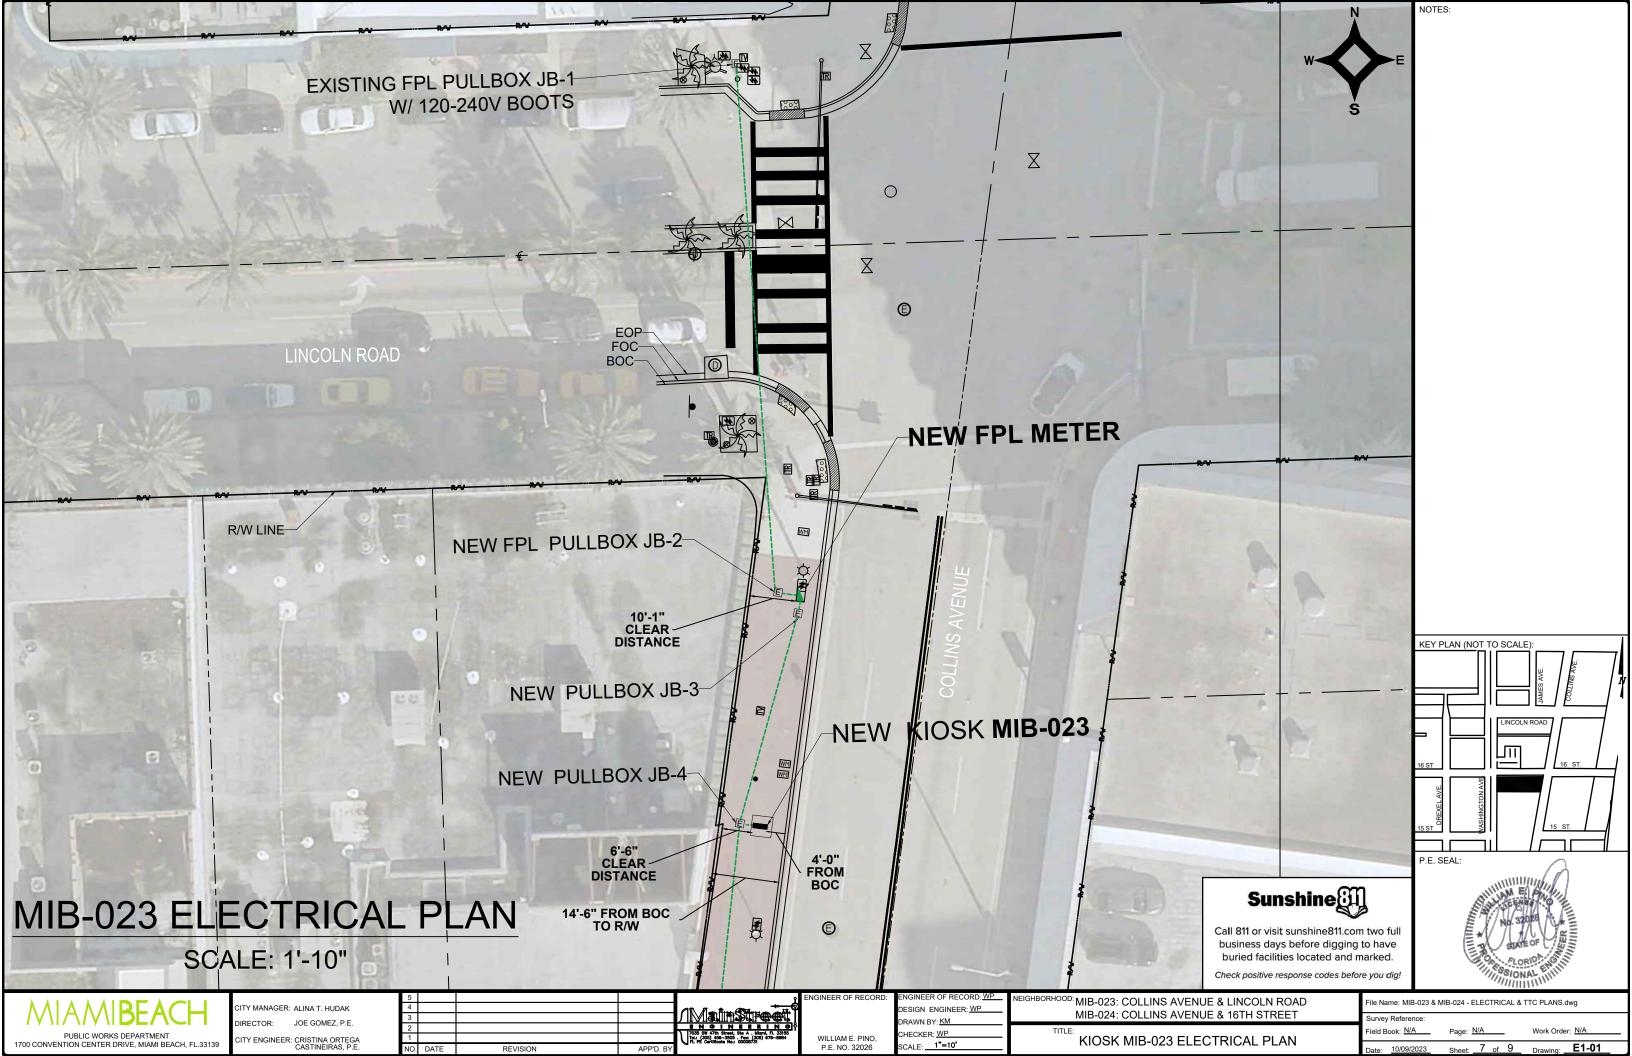

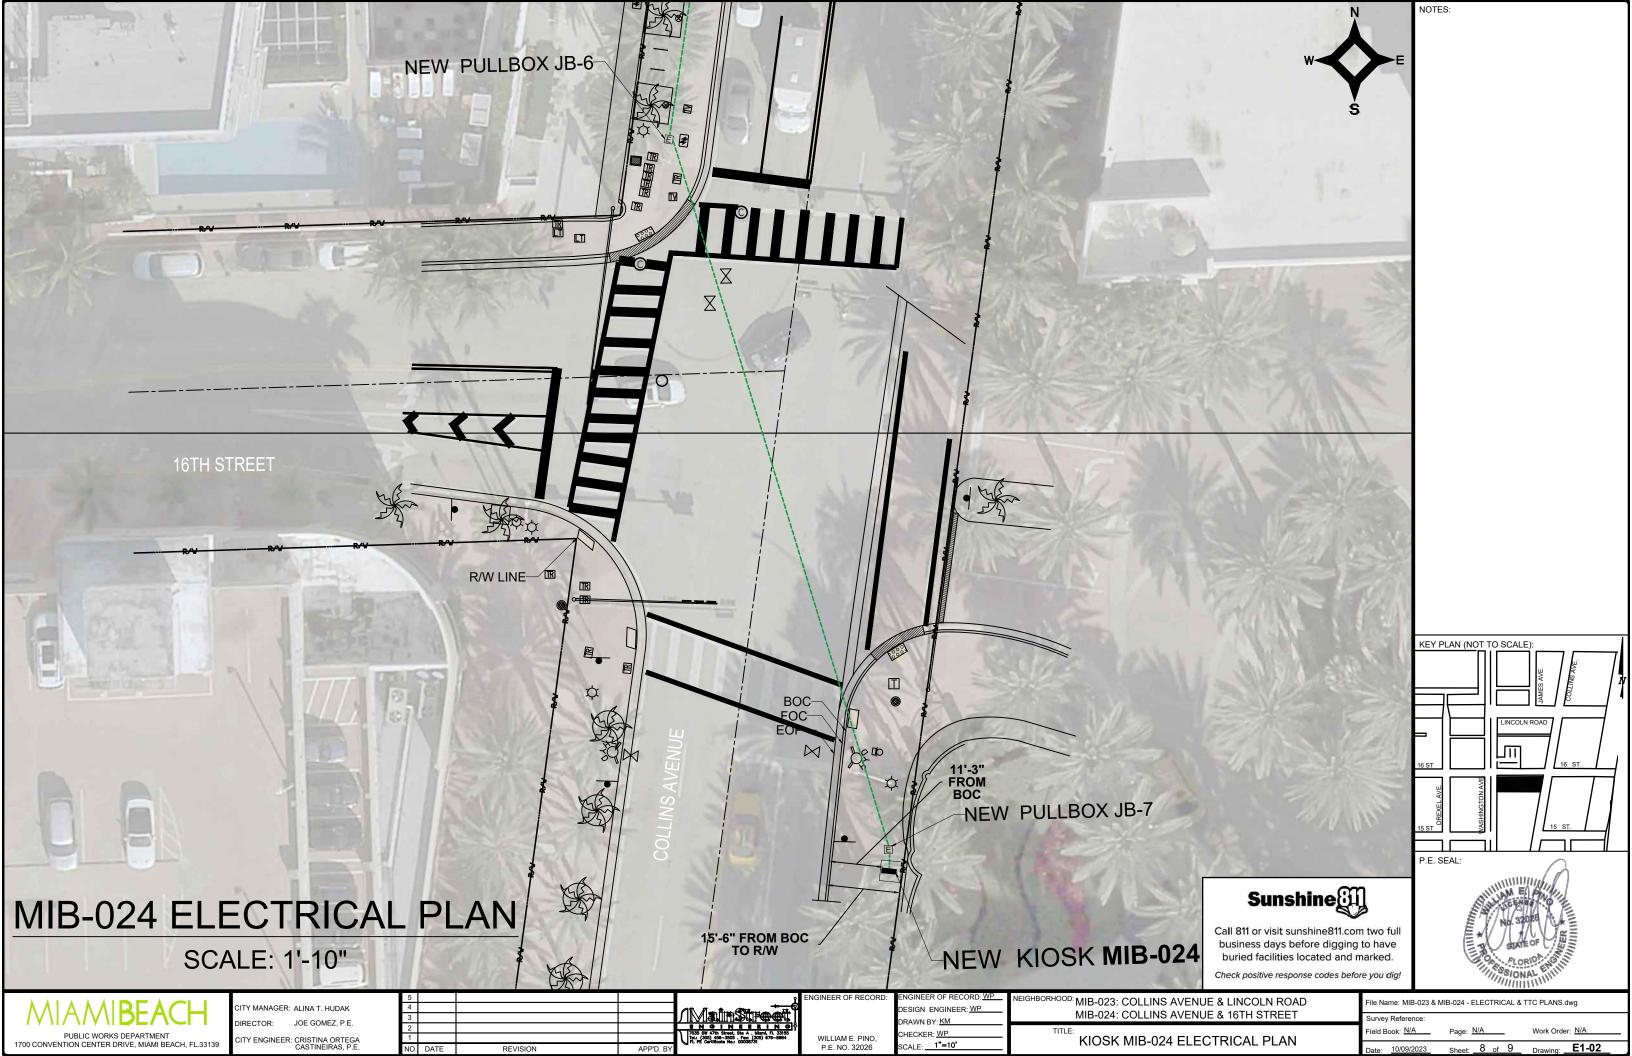

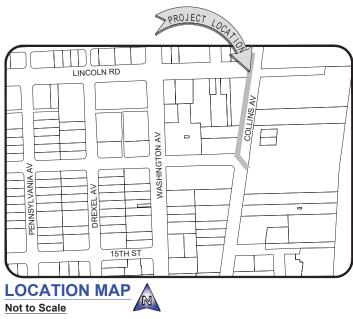

SURVEYOR'S REPORT AND GENERAL NOTES

- This is not a Boundary Survey.
- These lands are subject to additional restrictions of record that were not furnished to the undersigning registered surveyor. A title search has not been performed by the surveyor.
- North arrow direction is based on an assumed Meridian. Bearings are based on an assumed meridian on a well-established line, said line is being noted as BR on the Survey Map.
- Only above ground improvements are shown herein. Foundations, underground features and utilities have not been located by this surveyor. Refer to SUE effort notes below.
- Survey markers found in the field have no identification unless otherwise shown. Any survey marker set by our company is labeled LB 7262 or PSM 6169. This Survey Map is intended to be displayed at the scale shown hereon. Data is expressed in U.S.
- This Survey Map is being prepared for the use of the party/parties that it is certified to and does
- not extend to any unnamed individual, entity or assignee. FLOODPLAIN INFORMATION: As scaled from Federal Insurance Rate Map (FIRM) of Community No. 120651 (City of Miami Beach), Panel 0317, Suffix L, revised on Sept 11th, 2009, this real property falls in Zone "AE" with Base Flood Elevation 8 feet (NGVD 1929)
- HORIZONTAL ACCURACY: Accuracy obtained thru measurements and calculations meets and exceeds the minimum horizontal feature accuracy for a Suburban area being equal to 1 foot in 7,
- 10. VERTICAL CONTROL AND ACCURACY: The elevations as shown are referred to the National American Vertical Datum of 1988 (NAVD 1988). The closure in feet, as computed, meets the standard of plus or minus 0.05 feet times the squared root of the loop distance in miles. Elevation are based on a level loop from and to the following official Bench Marks:

Bench Mark # 1: City Miami Beach Bench Mark CMB W 16. Elevation = 4.00 feet (NAVD'88) Description: PK nail & washer @ Northeast quadrant of intersection Washington Avenue and 16th

Bench Mark # 2: City Miami Beach Bench Mark CMB 16 02R, Elevation = 2.03 feet (NAVD'88) Description: PK nail & washer @ Northwest quadrant of intersection Pennsylvania Avenue & 16th

11. SUE NOTES:

Subsurface Utility investigation was performed by South Florida Utility Location Services using GPR (Ground Penetrating Radar) and RD (Radiodetection Technology) for designation and location of underground facilities. The horizontal accuracy of this method is +/- 1.5 feet approximately, and is subject to equipment limitations. This Survey depicts the location of the marks indicating the approximate location of the buried pipes and conduits. There might be additional underground facilities not discovered at the time of this survey. Underground utility references as shown on this survey drawing is solely based on information marked on the field by South Florida Utility Location Services for this project. Contact information below:

South Florida Utility Location Services 15323 SW 31st Terrace, Miami, Florida 33185

(786) 547 9086 Office, Emai: rogerh@sf-uls.com, Contact Person: Roger Hasbani

Surveyor is not responsible for any errors or omissions that could arise from the information provided. Call 811 or visit www.sunshine811.com before digging.

- E- = RED PAINT LINE APPARENT ELECTRIC CONDUIT - - - WM - = BILLE PAINT LINE APPARENT WATER LINE - SAN - SAN - = GREEN PAINT LINE APPARENT SANITARY SEWER LINE GAS GAS = YELLOW PAINT LINE APPARENT GAS LINE - COM - COM = ORANGE PAINT LINE APPARENT COMMUNICATION LINE ____ STM___ = GREEN PAINT LINE APPARENT STORM SEWER LINE

SPECIFIC PURPOSE SURVEY LINCOLN ROAD 100' Total R/W (Per PB 6-PG 34 and PB 34-PG 66) Apparent San. Sewer III to allowaround (GPR signal) 3' CBS wall -

One Story Commercial Building

,30 O

One Story

± 9' belowground (GPR signal)

MATCH LINE SEE UPPER RIGHT

Commercial Building

Z≷

MATCH LINE SEE BOTTOM LEFT Bike Racks Lots 1 & 2, Block - 54 (PB 2- PG 77) 2' C&G orm Sewer line 6th STREET 3' belowground -(GPR signal)

LEGEND & ABBREVIATIONS

/////// = WOOD DECK

= COVERED AREA = ASPHALT = TILE

SCALE: I" = 30"

FOR a DETECTABLE WARNING PAD (DW = CHAIN LINK FENCE (CLF) = WOOD FENCE (WF)

= IRON METAL BARS FENCE (IF

= SEWER VALVE (S.V.) = POWER POLE (PP)

= GUY ANCHOR WM = WATER METER (WM)

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(C) = CALCULATED = PER PLAT

I HEREBY CERTIFY TO:

Main Street Engineering, that this Survey conforms to the Standards of Practice as set forth by the Florida Board of Professional Surveyors and Mappers in applicable provisions of Chapter 5J-17, Florida Administrative Code pursuant to Section 472.027 Florida Statutes. This Survey is accurate and correct to the best of my knowledge and belief.


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Odalys C. Bello-Iznaga Professional Surveyor and Mapper LS6169 · State of Florida Field Work Date: 07/27/2023

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Project No. 23259

200 Lincoln Road, Miami Beach, Florida 33139




SURVEYING MIAMI FL 33186 557 - LB#7262

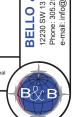BELLO LAND S

VENUE SUITE 201 · N

9606 · Fax: 305.251.6057

9. Collins Ave & 16th Street

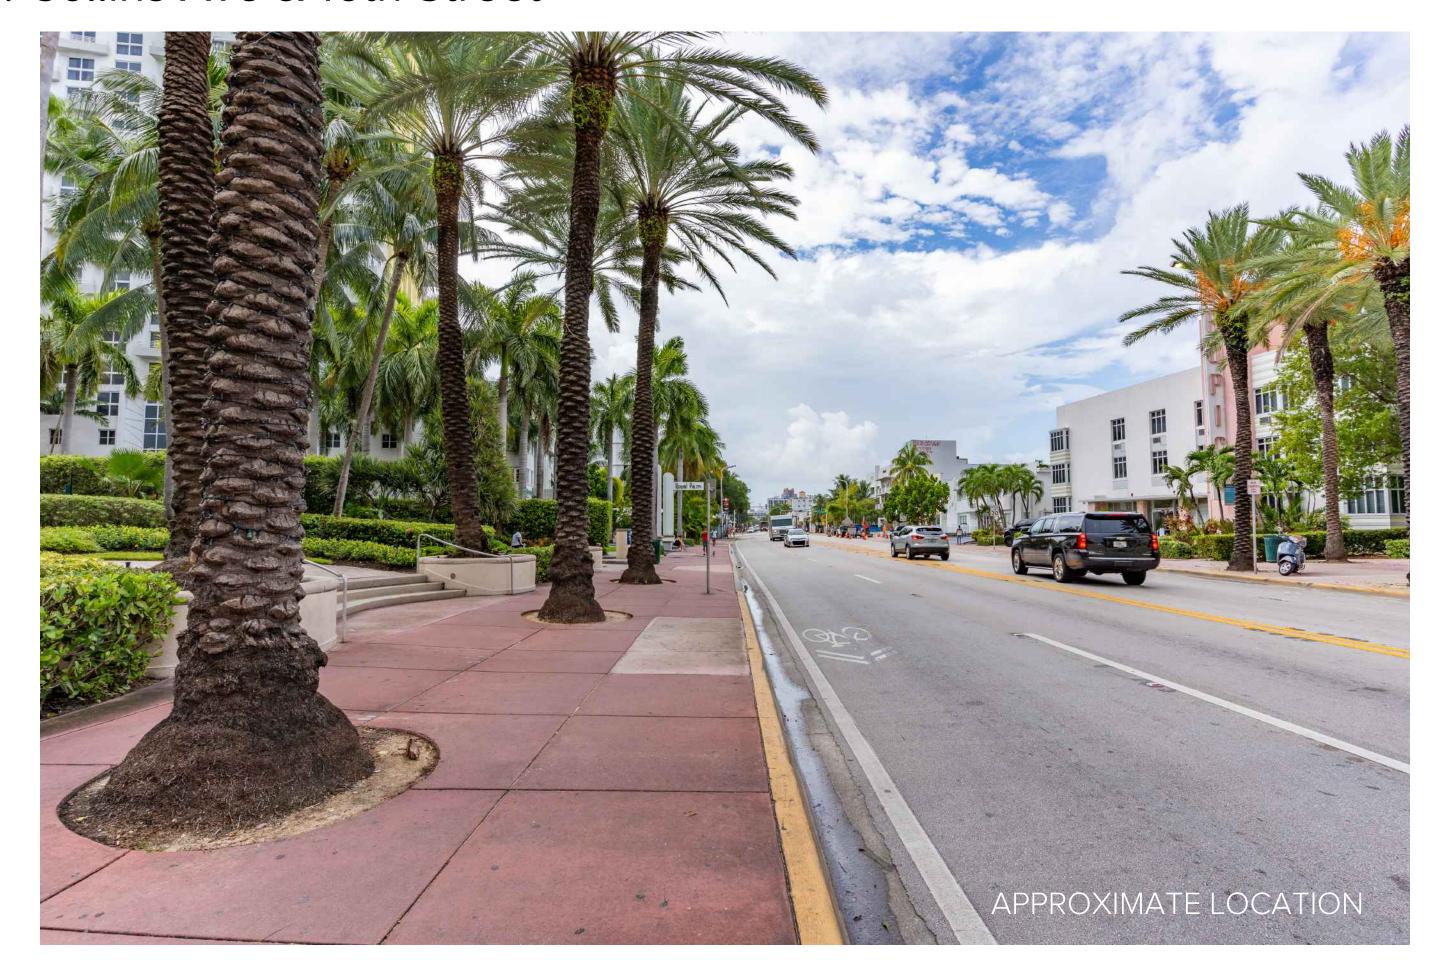



PUBLIC WORKS DEPARTMENT

INTERACTIVE DIGITAL KIOSK DEPLOYMENT PROJECT
OCTOBER 2023
IKE SMART CITY
MIB-007: OCEAN DRIVE & 14TH PLACE

CITY OF MIAMI BEACH

MAYOR: DAN GELBER

COMMISSIONERS: MICKY STEINBERG

MARK SAMUELIAN MICHAEL GONGORA STEVEN MEINER RICKEY ARRIOLA DAVID RICHARDSON

CITY MANAGER: ALINA T. HUDAK

CITY ATTORNEY: RAFAEL A. PAZ

PUBLIC WORKS DIRECTOR: JOE GOMEZ, P.E., F.FES

CITY ENGINEER: NELSON PEREZ-JACOME, PE







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SCOPE OF WORK: THE PROJECT CONSISTS OF THE INSTALLATION OF ONE (1) DIGITAL INTERACTIVE KIOSK AND APPLICABLE INFRASTRUCTURE; STRUCTURAL FOUNDATION AND ELECTRICAL SERVICE AT THE LOCATION INDICATED ON THESE DESIGN PLANS.

FINAL SUBMITTAL 10/09/2023

LOCATION MAP

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9	SURVEY		SERVICE POINT SITE SURVEY	

PROJECT LOCATION

OCEAN DRIVE/COLLINS AVENUE HISTORIC DISTRICT

LOCAL HISTORIC DISTRICTS Espanola Way Historic District Altos del Mar Historic District Flamingo Park Historic District

Palm View Historic District Collins Waterfront Historic District

Morris Lapidus/Mid 20th Century Historic District North Shore Historic District

NATIONAL REGISTER HISTORIC DISTRICTS

Miami Beach Architectural District Normandy Isles Historic District

Collins Waterfront Architectural District

LOCAL HISTORIC SITES

Old City Hall Historic Site

2 21st St Recreation Center Historic Site

Congregation Beth Jacob Historic Site

6 Sunset Island Bridges Historic Structures

The Bath Club Historic Site

8 Dade Blvd Fire Station Historic Site

36 Ocean Dr Historic Site

1700 Alton Rd Historic Site

CABLE: COMCAST, XFINITY, ATT-UVERSE

PROJECT DIRECTORY:

PROJECT NAME:

Ocean Beach Historic District

Harding Townsite Historic District

INTERACTIVE DIGITAL INFORMATION KIOSKS DEPLOYMENT PROJECT

JURISDICTION:

CITY OF MIAMI DEPARTMENT OF RESILIENCE AND **PUBLIC WORKS** MIAMI RIVERSIDE CENTER 444 S.W. 2nd AVENUE, 8th FLOOR MIAMI, FLORIDA 33130

OWNER:

IKE SMART CITY 250 N HARTOFORD AVE COLUMBUS, OH 43222 (614) 589-0087

ENGINEER OF RECORD: MAINSTREET ENGINEERING

7035 SW 47 STREET, SUITE A MIAMI, FL 33155 (305) 456-3505 PROJ. MGR: VANESSA MELA, P.E. VMELA@MAINSTREETENG.COM

21075 WESTGATE RD. **GOLDEN, CO 80403 CONTACT: ERIC PERKINS** PHONE: (303) 929-4071

KIOSK MANUFACTURER:

DISPLAY DEVICE INC.

UTILITIES:

ELECTRICAL POWER: FLORIDA POWER & LIGHT COMPANY (FPL)

WATER & SEWER: MIAMI-DADE WATER & SEWAGE DEPARTMENT

TELEPHONE: AT&T

GAS: FLORIDA GAS

SIDEWALK & STREET SYMBOLS **ASPHALT** BRICK **PAVER** CONCRETE UNIMPROVED TILE STAMPED **GRAVEL** CONCRETE

= PALM TREE = ORNAMENTAL TREE O.R.B. = OFFICIAL RECORDS BOOK ELEV. = ELEVATION = TYPICAL = CABLE TELEVISION = OVERHEAD ELECTRIC LINE = SPOT ELEVATION = CONCRETE = CONCRETE BLOCK STUCCO = CHAIN LINK FENCE = WOOD FENCE = METAL FENCE = REINFORCED CONCRETE PIPE = FINISH FLOOR = RECORD = CALCULATED = MEASURE = LICENSE BUSINESS = LENGTH = CENTRAL ANGLE = RADIUS = TANGENT = POINT OF TANGENCY = POINT OF CURVATURE = STATION = POINT OF INTERSECTION = IDENTIFICATION = METAL LIGHT POLE = SECTION LINE = CENTERLINE = MONUMENT LINE = TRAFFIC SIGNAL BOX = TRAFFIC SIGNAL CABINET = BOLLARD = PEDESTRIAN SIGNAL = TRAFFIC SIGNAL MAST ARM = SIGN = CABLE TELEVISION BOX = LIGHT POLE = UTILITY POLE = ELECTRIC TRANSFORMER = GUY ANCHOR = ELECTRIC METER = GAS VALVE = GAS UTILITY BOX = GAS MANHOLE = GAS TANK = GAS METER = COMMUNICATION BOX = COMMUNICATION MANHOLE = GARBAGE RECEPTACLE = HANDICAP PARKING SPACE = WATER METER = IRRIGATION VALVE = WATER VALVE KEY PLAN (NOT TO SCALE) = WATER BOX = WATER CONNECTION = WATER MANHOLE = WATER TANK = WATER WELL = WATER MARKING FLAG = WATER MARKING SIGN = STORM MANHOLE = STORM METER = CATCH BASIN = TELEPHONE MANHOLE = TELEPHONE BOX = NEWSPAPER DISPENSER = MAILBOX = SANITARY MANHOLE = SANITARY BOX = SANITARY TANK = SANITARY LIFT STATION = GREASE TRAP MANHOLE = CLEANOUT = PARKING METER = FIBER OPTIC BOX P.E. SEAL: = FIBER OPTIC MARKER SIGN = MONITORING WELL = UNKNOWN UTILITY METER = UNKNOWN UTILITY MANHOLE = UNKNOWN UTILITY VALVE = UNKNOWN UTILITY MARKER FLAG = SANITARY VALVE = RAILROAD SIGN = FLAGPOLE = PROPERTY LINE = ELECTRICAL OUTLET

LEGEND AND ABBREVIATIONS

NOTES:

PUBLIC WORKS DEPARTMENT

1700 CONVENTION CENTER DRIVE, MIAMI BEACH, FL.33139

TEL: 305-416-1200

ITY MANAGER: ALINA T. HUDAK JOE GOMEZ, P.E.

P F NO 77676

ESIGN ENGINEER: VM DRAWN BY: KM HECKER: WP

SCALE:

HISTORIC DISTRICTS

AND SITES

CITY OF

MIAMI BEACH

FLORIDA .

INCORPORATED 1915

Biscayne Bay

MIB-007: OCEAN DRIVE & 14TH PLACE

Atlantic

INDEX OF SHEETS

File Name: MIB-007-GENERAL AND FOUNDATION.dwg

SSA A. A

STATE OF

FLORIDA

ADA NOTES

- 1. ALL CONSTRUCTION ACTIVITIES SHALL BE COMPLETED IN FULL COMPLIANCE WITH THE AMERICANS WITH DISABILITIES ACT (ADA). CLEAR SPACES IN FRONT OF KIOSK SHALL HAVE THE FOLLOWING CHARACTERISTICS:
- 2. SURFACES SHALL BE FIRM, STABLE, AND SLIP RESISTANT AND OTHERWISE COMPLY WITH PROWAG SECTION R302.7 AND SHALL HAVE A RUNNING SLOPE CONSISTENT WITH GRADE OF THE ADJACENT PEDESTRIANT ACCESS ROUTE AND CROSS SLOPE OF 1.50% +/-0.50%)
- 3. SIZE: CLEAR SPACES SHALL BE 48" MINIMUM BY 48" MINIMUM.
- 4. POSITION: UNLESS OTHERWISE SPECIFIED. CLEAR SPACES SHALL BE POSITIONED FOR EITHER FORWARD OR PARALLEL APPROACH TO THE KIOSK.
- 5. APPROACH: ONE FULL UNOBSTRUCTED SIDE OF A CLEAR SPACE SHALL ADJOIN A PEDESTRIAN ACCESS ROUTE OR ADJOIN ANOTHER CLEAR SPACE.
- 6. MANEUVERING SPACE: WHERE A CLEAR SPACE IS CONFINED ON ALL OR PART OF THREE SIDES, ADDITIONAL MANEUVERING SPACE SHALL BE PROVIDED AS FOLLOWS:
- 6.1.1. FORWARD APPROACH: THE CLEAR SPACE AND ADDITIONAL MANEUVERING SPACE SHALL BE 36" WIDE MINIMUM WHERE THE DEPTH OF THE CONFINING ELEMENT EXCEEDS 24".
- PARALLEL APPROACH: THE CLEAR SPACE AND ADDITIONAL MANEUVERING SPACE SHALL BE 60" WIDE MINIMUM WHERE THE DEPTH OF THE CONFINING ELEMENT EXCEEDS 15".
- 7. THE MINIMUM WHEELCHAIR PASSAGE WIDTH OR CLEAR SPACE WIDTH FOR A SINGLE WHEELCHAIR PASSAGE SHALL BE 48" PER PROWAG SECTION R302.3.
- 8. INITIAL OPERATION FOR THE KIOSK WILL HAVE 4G LTE CONNECTION SECTION R404. TO THE INTERNET.
- 9. THE KIOSKS HAVE BEEN DESIGN TO COMPLY WITH ALL ADA GUIDELINES INCLUDING VIEWING, OPERATION, AND ACCESSIBILITY.
- 10. THE MOBILE IKE EXPERIENCE WILL FOLLOW WEB CONTENT ACCESSIBILITY GUIDELINES (WCAG) TO WORK IN TANDEM WITH THE NATIVE ACCESSIBILITY FEATURES ON THE USER'S MOBILE DEVICE, INCLUDING TALKBACK AND VOICEOVER TOOLS.

SCOPE OF WORK

THE PROJECT CONSIST OF THE INSTALLATION OF ONE (1) DIGITAL INTERACTIVE KIOSKS AT THE LOCATION(S) INDICATED ON THIS PLANS SET. INSTALLER SHALL PROVIDE AND INCLUDE ALL WORKMANSHIP AND MATERIALS NECESSARY TO COMPLETE THE INSTALLATION INCLUDING BUT NOT LIMITED TO:

- 1. INSTALLATION OF THE KIOSKS TO THE FOUNDATION AS INDICATED ON PLANS TO NEW RECTANGULAR CONCRETE FOUNDATION.
- 2. ELECTRICAL SERVICE POINTS ARE EXISTING. CONNECT THE EXISTING ELECTRIC SERVICE TO THE NEW KIOSK AS INDICATED ON PLANS.
- 3. TESTING OF THE ELECTRICAL SERVICE INFRASTRUCTURE SHALL BE PERFORMED IN CONJUNCTION WITH A REPRESENTATIVE OF THE ENGINEER OF RECORD.
- 4. THE CONTRACTOR SHALL INSTALL THE KIOSK IN SUCH A WAY THAT THE KIOSK IS WITHIN THE PUBLIC R.O.W. AND IN COMPLIANCE WITH ALL APPLICABLE A.D.A. REQUIREMENTS
- 5. THE LOCATION OF KIOSKS HAS BEEN COORDINATE TO ENSURE THERE IS NO OBSTRUCTION OF THE SIGHT OF VEHICULAR SIGNS.
- 6. STAND-ALONE PEDESTRIAN KIOSKS SHOULD NOT BE INSTALLED WITHIN PEDESTRIAN CIRCULATION PATHS IN A MANNER THAT PERSONS AT THE KIOSK LOCK THE EFFECTIVE WIDTH OF THE PEDESTRIAN TRAVEL WAY.

MONUMENT SIGN SPECIFICATIONS AND FUNCTIONS

THE UNIT CONSISTS OF A UL/NRTL LISTED WEATHER AND VANDAL RESISTANT FREE STANDING ENCLOSURE DESIGNED TO COMPLY WITH THE FLORIDA BUILDING CODE AND OTHER APPLICABLE CODES INCLUDING THE NATIONAL ELECTRICAL CODE. THE UNIT HAS BEEN DESIGNED TO WITHSTAND WINDS OF 165 MPH. THE UNIT'S MAIN COMPONENTS ARE:

- 1. TWO (2) INTERACTIVE 65" VIDEO TOUCH SCREENS.
- 2. TWO (2) CAMERAS
- 3. ONE (1) CPU
- 4. ONE (1) WI-FI TRANSMITTER


MANUFACTURER: DYNASCAN MODEL NUMBER: CIO651DR5 NATIVE RESOLUTION: 1920 X 1080


1. ONE-2-POLE, 20 AMP, 240 VOLTS CIRCUIT.

ELECTRICAL POWER REQUIREMENT:

- 2. TOTAL LOAD: 1400/2200 WATTS (OPERATIONAL/PEAK)
- 3. VOLTAGE: 100-240 VOLTS AC, 50-60 HZ
- WEIGHT: 832 LBS

CERTIFICATION CE / FCC / RoHS

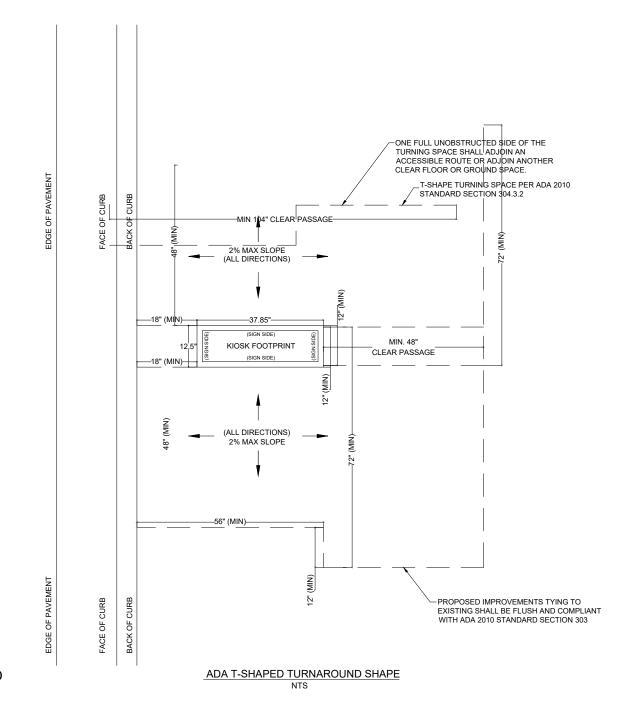

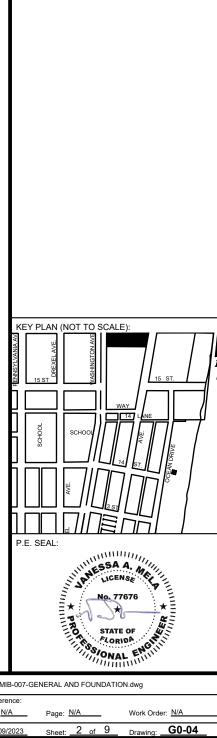

NOTES:

CITY MANAGER: ALINA T. HUDAK PUBLIC WORKS DEPARTMENT 1700 CONVENTION CENTER DRIVE, MIAMI BEACH, FL.33139

JOE GOMEZ, P.E. CITY ENGINEER: CRISTINA ORTEGA CASTINEIRAS, P.E.

VANESSA A. MELA

P F NO 77676


ESIGN ENGINEER: VM RAWN BY: KM HECKER: WP


SCALE:

MIB-007: OCEAN DRIVE & 14TH PLACE

ADA NOTES, SCOPE OF WORK & KIOSK SPECIFICATIONS

ile Name: MIB-007-GENERAL AND FOUNDATION.dwg

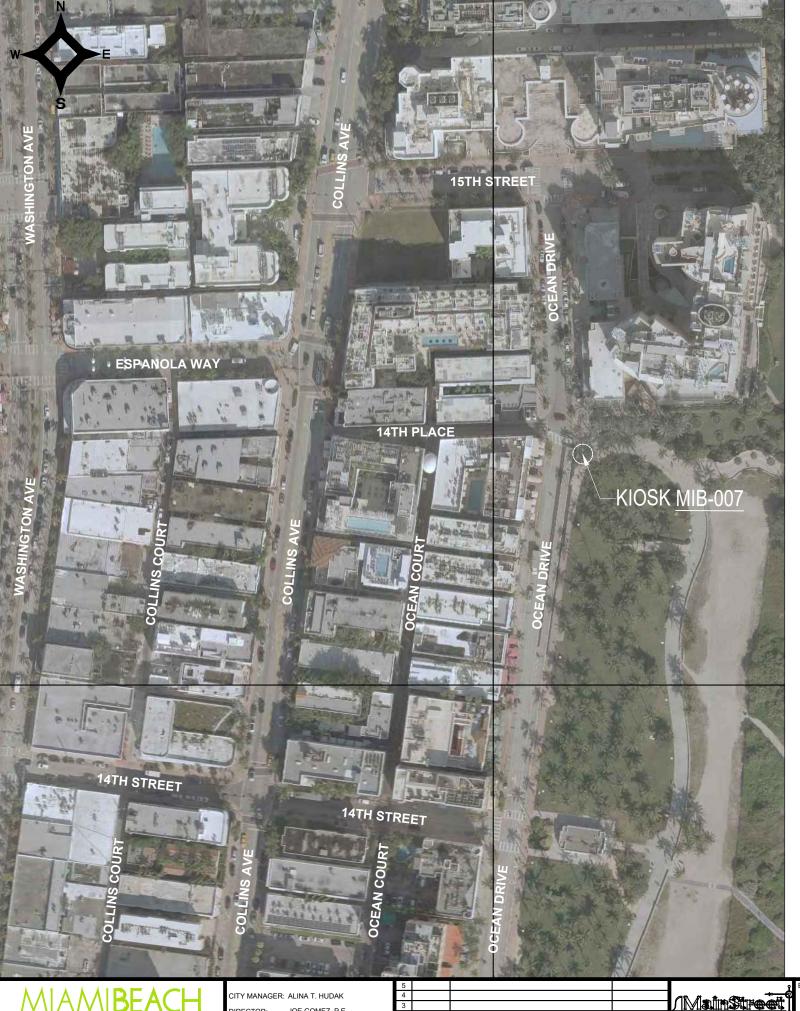

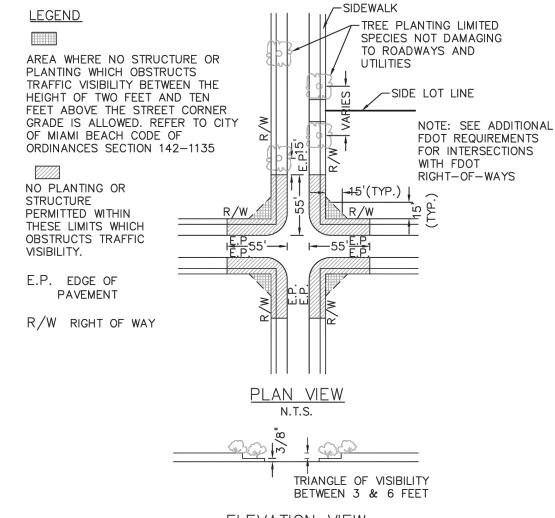

NOTES:

ELEVATION VIEW

- 1. AT INTERSECTIONS WITH ALL-WAY STOP CONTROL, THE FIRST STOPPED VEHICLE ON ONE APPROACH SHOULD BE VISIBLE TO THE DRIVERS OF THE FIRST STOPPED VEHICLES ON EACH OF THE OTHER APPROACHES. THERE ARE NO OTHER SIGHT DISTANCE CRITERIA APPLICABLE TO INTERSECTIONS WITH ALL-WAY STOP CONTROL AND, INDEED, ALL-WAY CONTROL MAY BE THE BEST OPTION AT A LIMITED NUMBER OF INTERSECTIONS WHERE SIGHT DISTANCE FOR OTHER CONTROL TYPES CANNOT BE ATTAINED.
- 2. FOR TWO-WAY STOP INTERSECTIONS, SIGHT DISTANCE CRITERIA FOR STOP CONTROLLED INTERSECTIONS ARE LONGER THAN STOPPING SIGHT DISTANCE TO ENSURE THAT THE INTERSECTION OPERATES SMOOTHLY. MINOR— ROAD VEHICLE OPERATORS CAN WAIT UNTIL THEY CAN PROCEED SAFELY WITHOUT A MAJOR-ROAD VEHICLE TO STOP.

PUBLIC WORKS DEPARTMENT

07/2020

SIGHT RESTRICTIONS AT INTERSECTIONS WITH NO DEDICATED RADII

10-26

SIGHT TRIANGLE CLEARANCE



Call 811 or visit sunshine811.com two full business days before digging to have buried facilities located and marked.

Check positive response codes before you dig!

STATE O SONAL EN

C1-01

PUBLIC WORKS DEPARTMENT 1700 CONVENTION CENTER DRIVE, MIAMI BEACH, FL.33139

JOE GOMEZ, P.E. CITY ENGINEER: CRISTINA ORTEGA CASTINEIRAS, P.E.



DESIGN ENGINEER: VM RAWN BY: KM

SCALE:

VANESSA A. MELA,

P.F. NO. 77676


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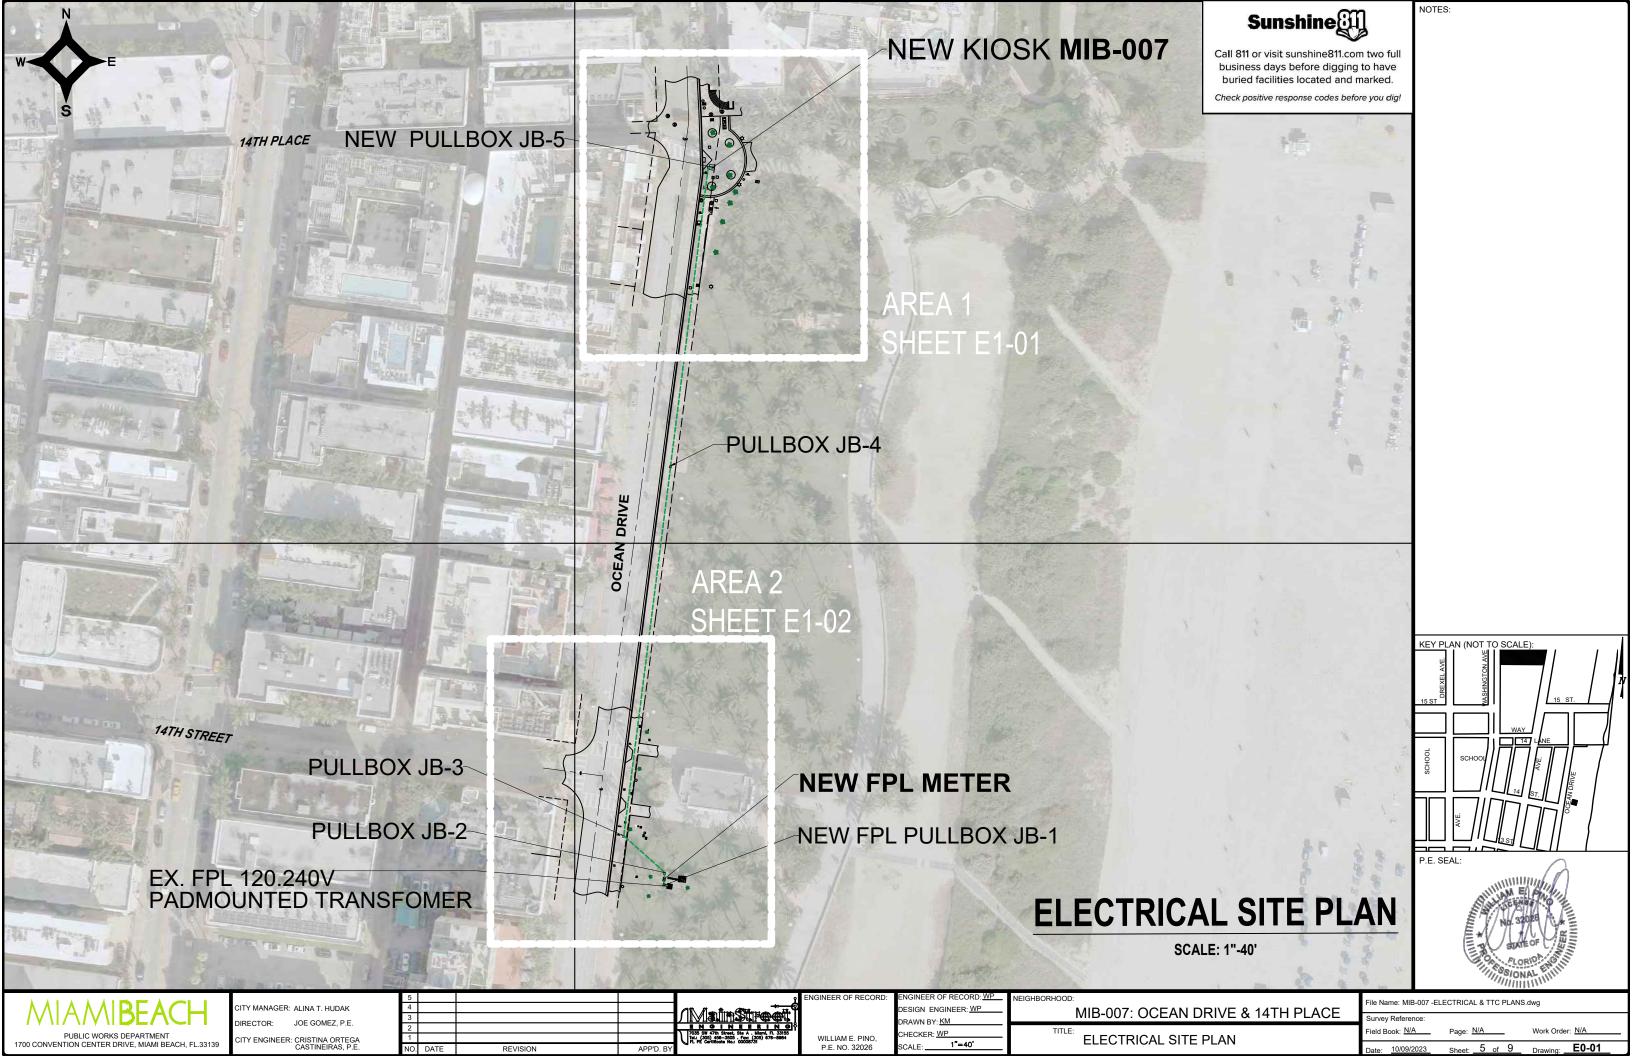
MIB-007: OCEAN DRIVE & 14TH PLACE


CIVIL SITE PLAN


File Name: MIB-007-CIVIL PLANS.dwg

KEY PLAN (NOT TO SCALE):



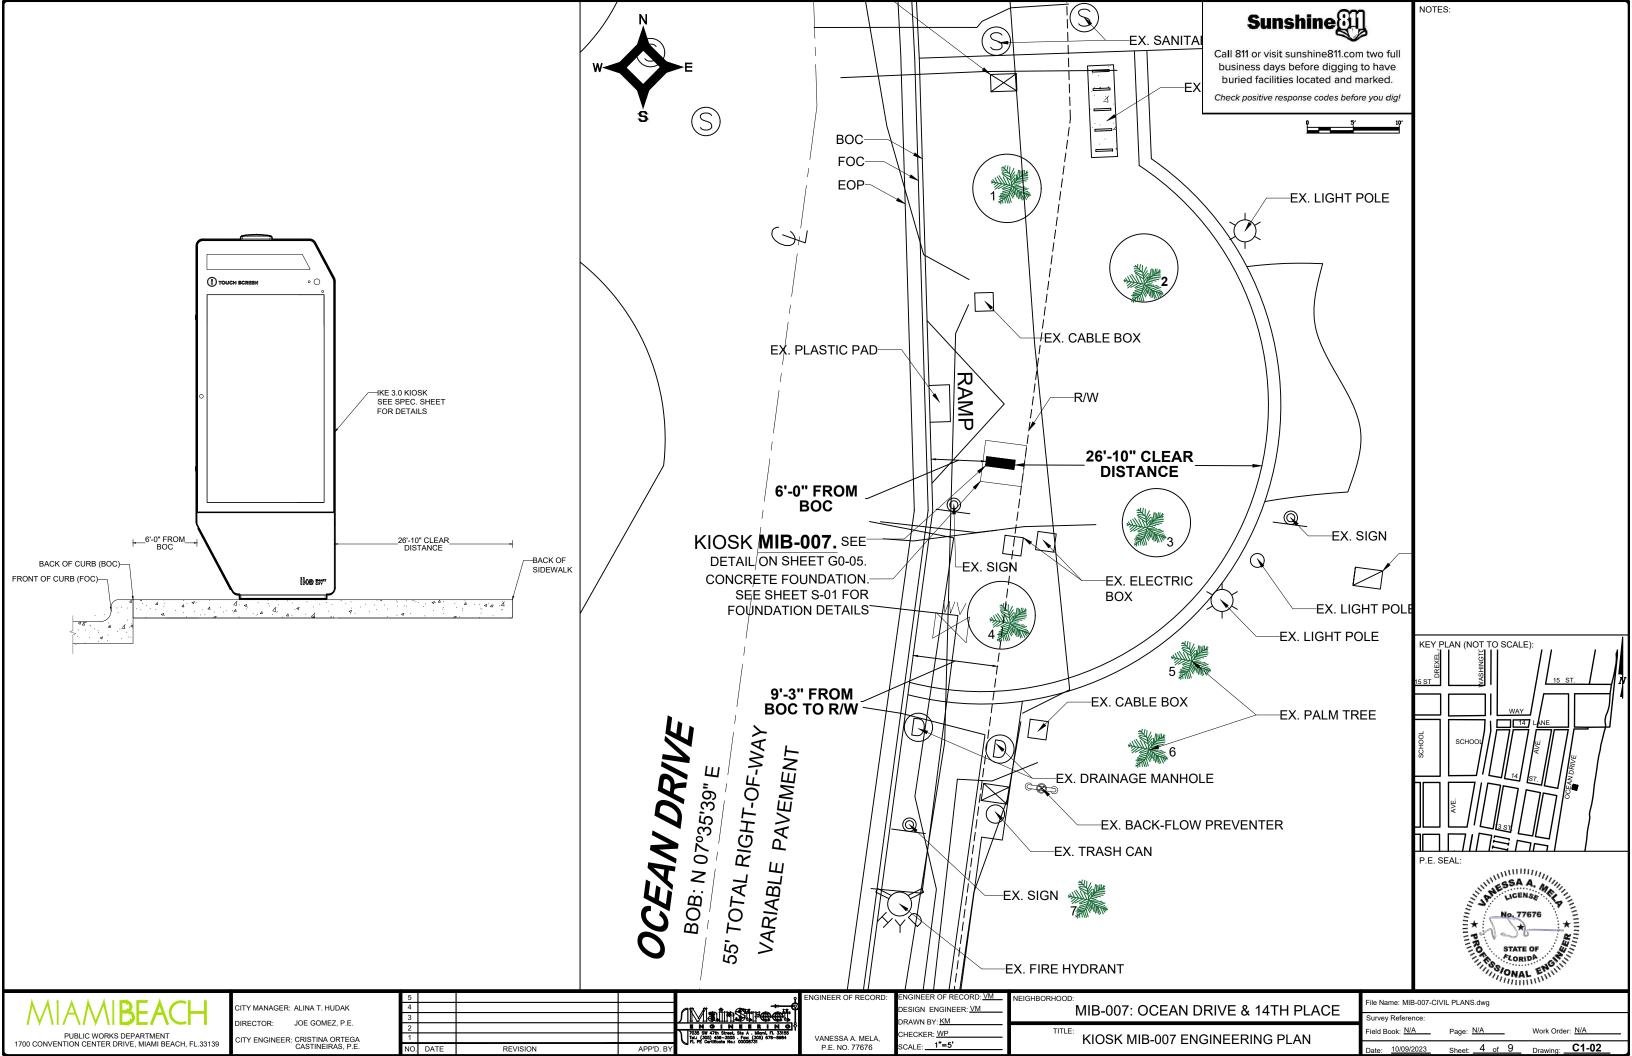

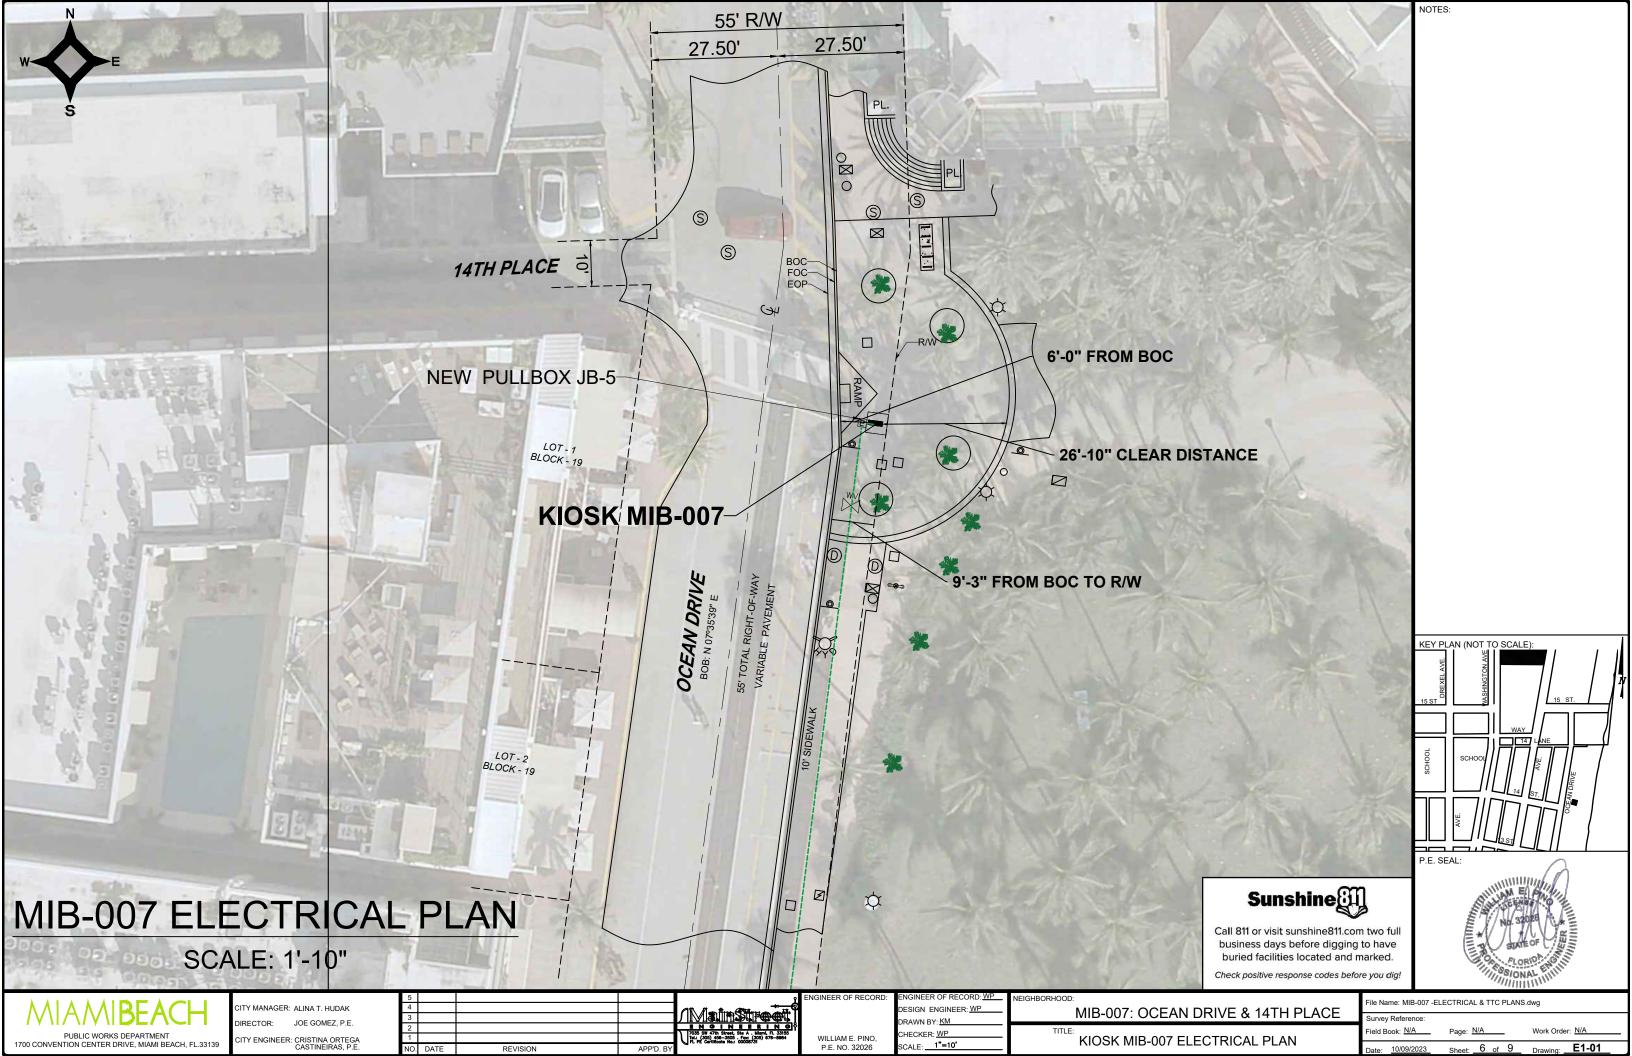

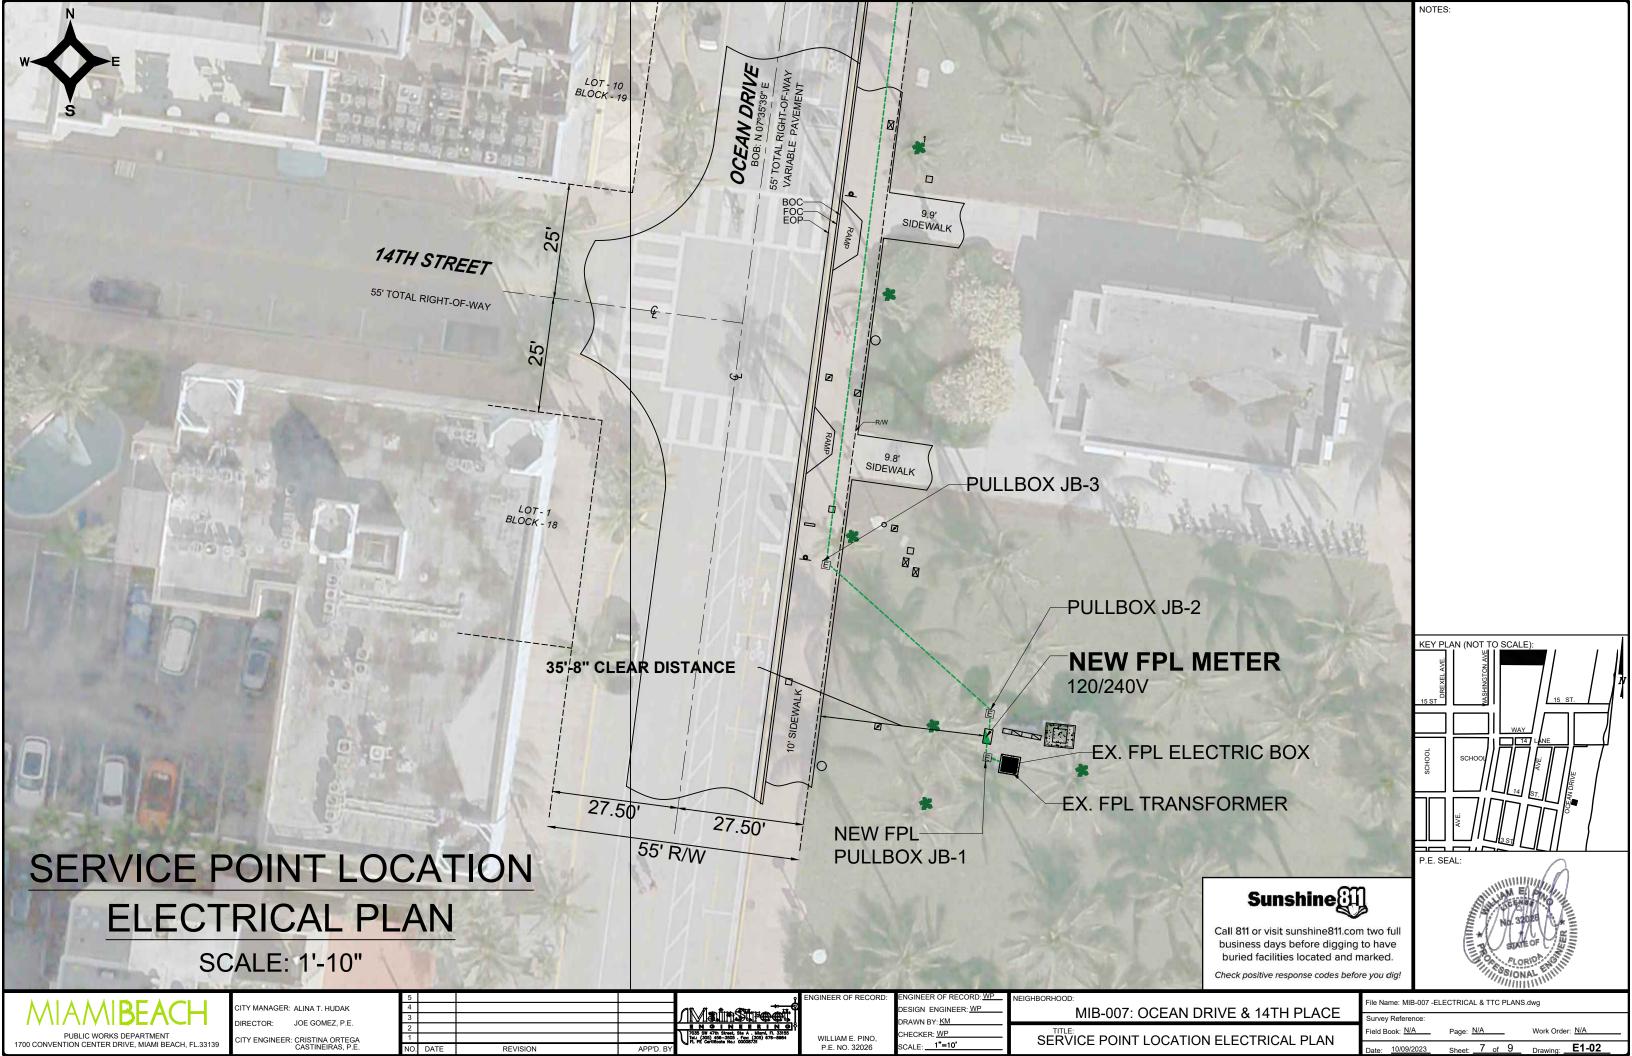

LEGEND

ABBREVIATIONS:

A = ARC DISTANCE AC = AIR CONDITIONER PAD BCR = BROWARD COUNTY RECORDS BLDG = BUILDING
BM = BENCH MARK
BOB = BASIS OF BEARINGS
CBS = CONCRETE BLOCK & STUCCO (C) = CALCULATED C&G = CURB & GUTTER CLF = CHAIN LINK FENCE COL = COLUMN
D.E. = DRAINAGE EASEMENT
D.M.E. = DRAINAGE & MAINTENANCE EASEMENT D/W = DRIVEWAY B = ELECTRIC BOX
ENC. = ENCROACHMENT
EP = EDGE OF PAVEMENT
EW = EDGE OF WATER

FIP = FOUND IRON PIPE (NO ID) FIR = FOUND IRON ROD (NO ID) FN = FOUND NAIL (NO ID) FN&D= FOUND NAIL & DISCK FPL = FLORIDA POWER & LIGHT TRANSFORMER PAD

IKANSFURMER PAU
L.E. = LANDSCAPE EASEMENT
L.M.E. = LAKE MAINTENANCE EASEMENT (M) = MFASURFD

MDCR = MIAMI-DADE COUNTY RECORDS MH = MAN HOLE ML = MONUMENT LINE

(P) = PLAT PB = PLAT E

(P) = PLAT BOOK
PC = POINT OF CURVATURE
PCP = PERMANENT CONTROL POINT PE = POOL EQUIPMENT PAD
PG = PAGE
PI = POINT OF INTERSECTION

PL = PLANTER
POB = POINT OF BEGINNING
POC = POINT OF COMMENCEMENT
PRC = POINT OF REVERSE CURVATURE

TREE TABLE:

NO COMMON NAME COCONUT PALM

COCONUT PALM

COCONUT PALM

COCONUT PALM COCONUT PALM

COCONUT PALM

COCONUT PALM

COCONUT PALM

SYMBOLS:

IN CASE OF A DISPUTE AN ARBORIST REPORT WILL GOVERN.

NAME: D-166
ELEVATION: 7.27' (NGVD29)
LOCATION: 7.27' (NGVD29)
LOCATION: VENETIAN CSWY --- 20' NORTH OF C/L
LOCATION: 2: BELLE ISLE EAST BRIDGE --DESCRIPTION: PK NAIL AND BRASS WASHER IN CONCRETE
SIDEWALK AT NE CORNER OF BRIDGE #874481

BENCHMARK INFORMATION:

= COMMUNICATION LINE

PRM = PERMANENT REFERENCE
MONUMENT
PT = POINT OF TANGENCY
R = RADIUS DISTANCE (R) = RECORD

 $\dot{R}/W = RIGHT-OF-WAY$

R/W = RIGHT-OF-WAY
RES = RESIDENCE
SIP = SIP LB#8023
SND = SET NAIL & DISK LB#8023
STL = SURVEY TIE LINE
SWK = SIDEWALK

(TYP) = TYPICAL UB = UTILITY BOX U.E. = UTILITY EASEMENT W/F = WOOD FENCE

SYMBOLS:

 □ = TELEPHONE RISER
 □ = CABLE TV RISER ■ WATER METER \times 0.00 = FLEVATION

(00') = ORIGINAL LOT DISTANCE Δ = CENTRAL ANGLE

 \mathbb{Q} = CENTER LINE

= WATER VALVE = CURB INLET

= FIRE HYDRANT


T = LIGHT POLE

= CATCH BASIN C = UTILITY POLE (D) = DRAINAGE MANHOLE

(S) = SEWER MANHOLE


____ = SIGN - - - - - METAL FENCE - -- -- = EASEMENT BOUNDARY LINE — = OVERHEAD UTILITY LINE

- - - - - = ORIGINAL LOT LINEASPHALT CONCRETE PAVERS/ TILES COVERED

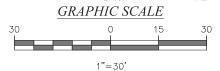

MAP OF SPECIFIC PURPOSE TOPOGRAPHIC & TREE SURVEY

"OCEAN DRIVE" CITY OF MIAMI BEACH, FL. PLAT OF "OCEAN BEACH ADDITION NO. 2" PLAT BOOK 2, PAGE 56, MDCR

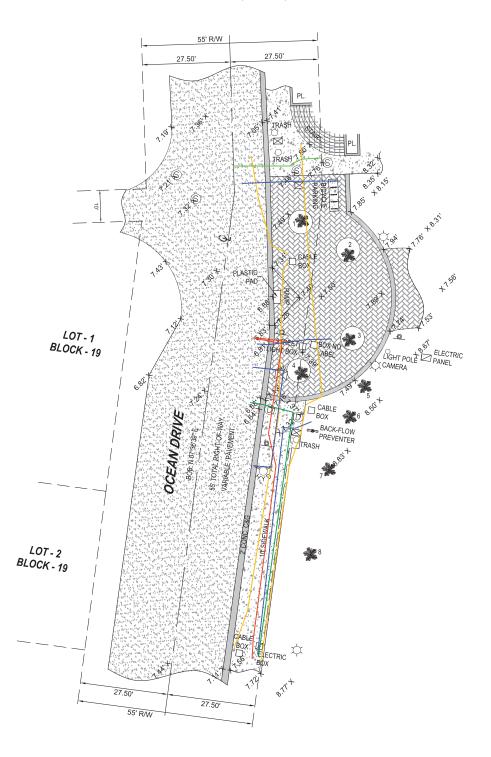

CERTIFICATE OF AUTHORIZATION # LB-8023

Survey Pros, Inc.

4348 SW 74TH AVENUE, MIAMI, FL. 33155 PH: (305) 767-6802 (main) MIAMI-DADE | BROWARD | PALM BEACH | MONROE | HILLSBOROUGH | PINELLAS www.survey-pros.com

LOCATION SKETCH:



FLOOD ZONE INFORMATION:

THE GRAPHICALLY DEPICTED BUILDING(S) SHOWN ON THIS MAP OF SURVEY IS WITHIN ZONE AE BASE FLOOD ELEVATION 8

COMMUNITY NAME & NUMBER CITY OF MIAMI BEACH 120651

MAP & PANEL NUMBER 12086C0317 SUFFIX L

SURVEYOR'S NOTES:

1. ELEVATIONS WHEN SHOWN REFER TO 1929 NATIONAL GEODETIC VERTICAL DATUM (NGVD 1929).

2. NO ATTEMPT WAS MADE TO LOCATE FOOTINGS/FOUNDATIONS, OR UNDERGROUND J. THE LANDS SHOWN HEREON HAVE NOT BEEN ABSTRACTED IN REGARDS TO MATTERS OF INTEREST BY OTHER PARTIES, SUCH AS EASEMENTS, RIGHTS OF WAYS,

4. THIS SURVEY WAS PREPARED FOR AND CERTIFIED TO THE PARTY(IES) INDICATED HEREON AND IS NOT TRANSFERABLE OR ASSIGNABLE WITHOUT WRITTEN CONSENT OF

5. ALL BOUNDARY LIMIT INDICATORS SET ARE STAMPED LB#8023

6. THE BOUNDARY LIMITS ESTABLISHED ON THIS SURVEY ARE BASED ON THE LEGAL DESCRIPTION PROVIDED BY THE CLIENT OR ITS REPRESENTATIVE.

7. FENCE OWNERSHIP IS NOT DETERMINED. DIMENSIONS ARE TO THE INTERIOR PORTION OF THE FENCE.

8. ADDITIONS OR DELETIONS TO THIS SURVEY MAP AND/OR REPORT BY SOMEONE OTHER THAN THE SIGNING PARTY(IES) IS PROHIBITED WITHOUT WRITTEN CONSENT OF

THE SIGNING PARTY(IES).

9. THIS SURVEY IS NOT VALID WITHOUT THE ORIGINAL SIGNATURE AND RAISED SEAL OF A FLORIDA LICENSED SURVEYOR AND MAPPER. OTHERWISE THIS MAP IS FOR

INFORMATIONAL PURPOSES ONLY.

10. BEARINGS WHEN SHOWN ARE TO AN ASSUMED MERIDIAN AND BASED ON PLAT. THE CENTERLINE OF OCEAN DRIVE BEARS N 07°35'39" E

SURVEYOR'S CERTIFICATION:


I HEREBY CERTIFY THAT THIS SURVEY IS TRUE AND CORRECT TO THE BEST OF MY KNOWLEDGE AND BELIEF AS RECENTLY SURVEYED AND DRAWN UNDER MY DIRECTION AND MEETS THE MINIMUM TECHNICAL STANDARDS SET FORTH BY THE FLORIDA STATE BOARD OF SURVEYORS AND MAPPERS IN CHAPTER 5J-17 FLORIDA ADMINISTRATIVE CODE PURSUANT TO SECTION 472.027 FLORIDA STATUE.

CERTIFIED TO:

MAIN STREET ENGINEERING

DATE OF ORIGINAL FIELD WORK: JOB NUMBER: 23079740 DRAWN BY: ADRIEL SEAL CAD FILE: MAIN STREET ENG SHEET 1 OF 1 REVISION(S):

NICOLAS DEL VENTO PROFESSIONAL SURVEYOR & MAPPER STATE OF FLORIDA LIC. # 6945

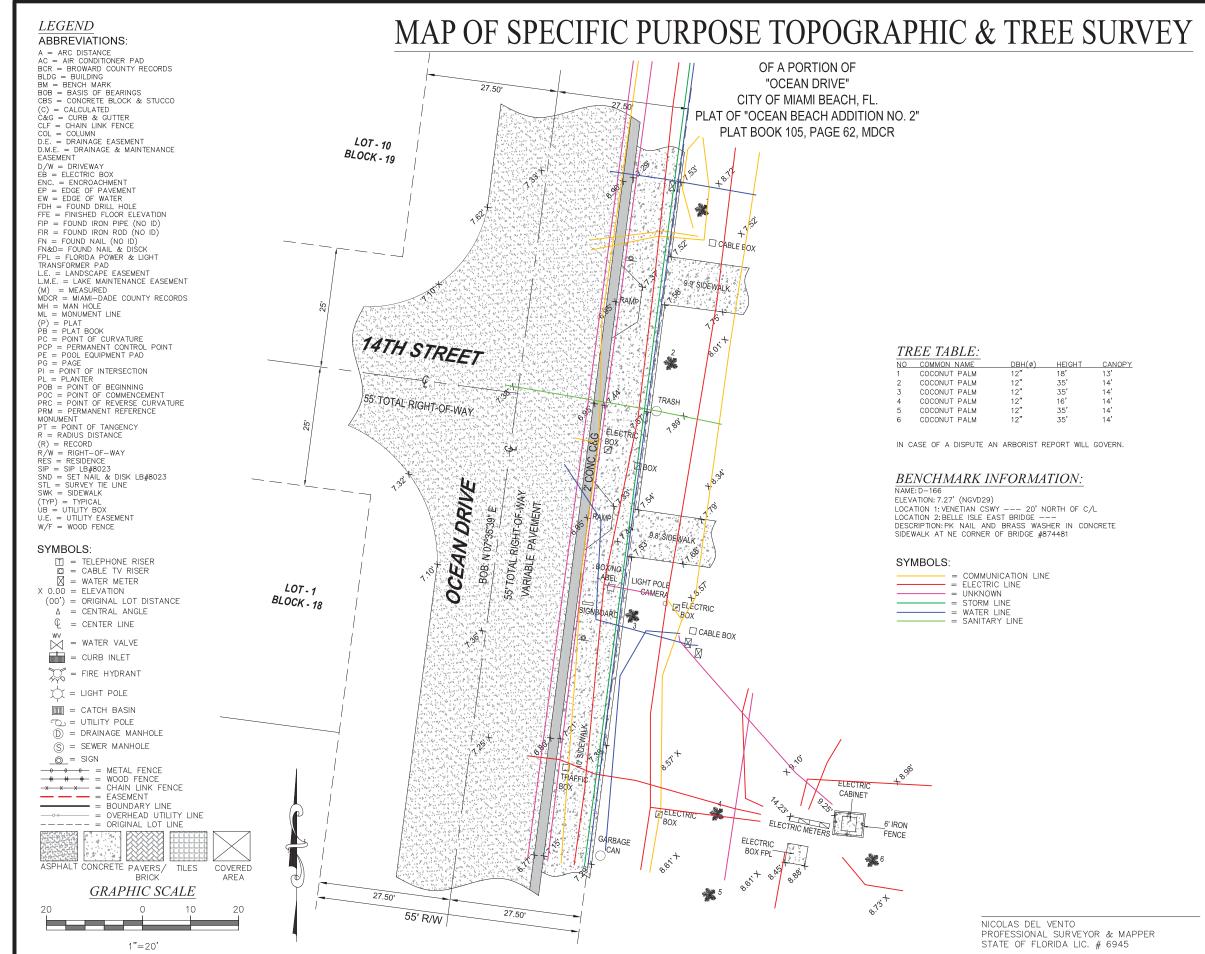

CERTIFICATE OF AUTHORIZATION # LB-8023

Survey Pros, Inc.

PH: (305) 767-6802 (main) MIAMI-DADE | BROWARD | PALM BEACH | MONROE | HILLSBOROUGH | PINELLAS

www.survey-pros.com

LOCATION SKETCH:



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3. THE LANDS SHOWN HEREON HAVE NOT BEEN ABSTRACTED IN REGARDS TO MATTERS OF INTEREST BY OTHER PARTIES, SUCH AS EASEMENTS, RIGHTS OF WAYS, RESERVATIONS, ETC. ONLY PLATTED EASEMENTS ARE SHOWN.

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IHIS FIRM.

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THE CENTERLINE OF OCEAN DRIVE BEARS N 07°35'39" E.

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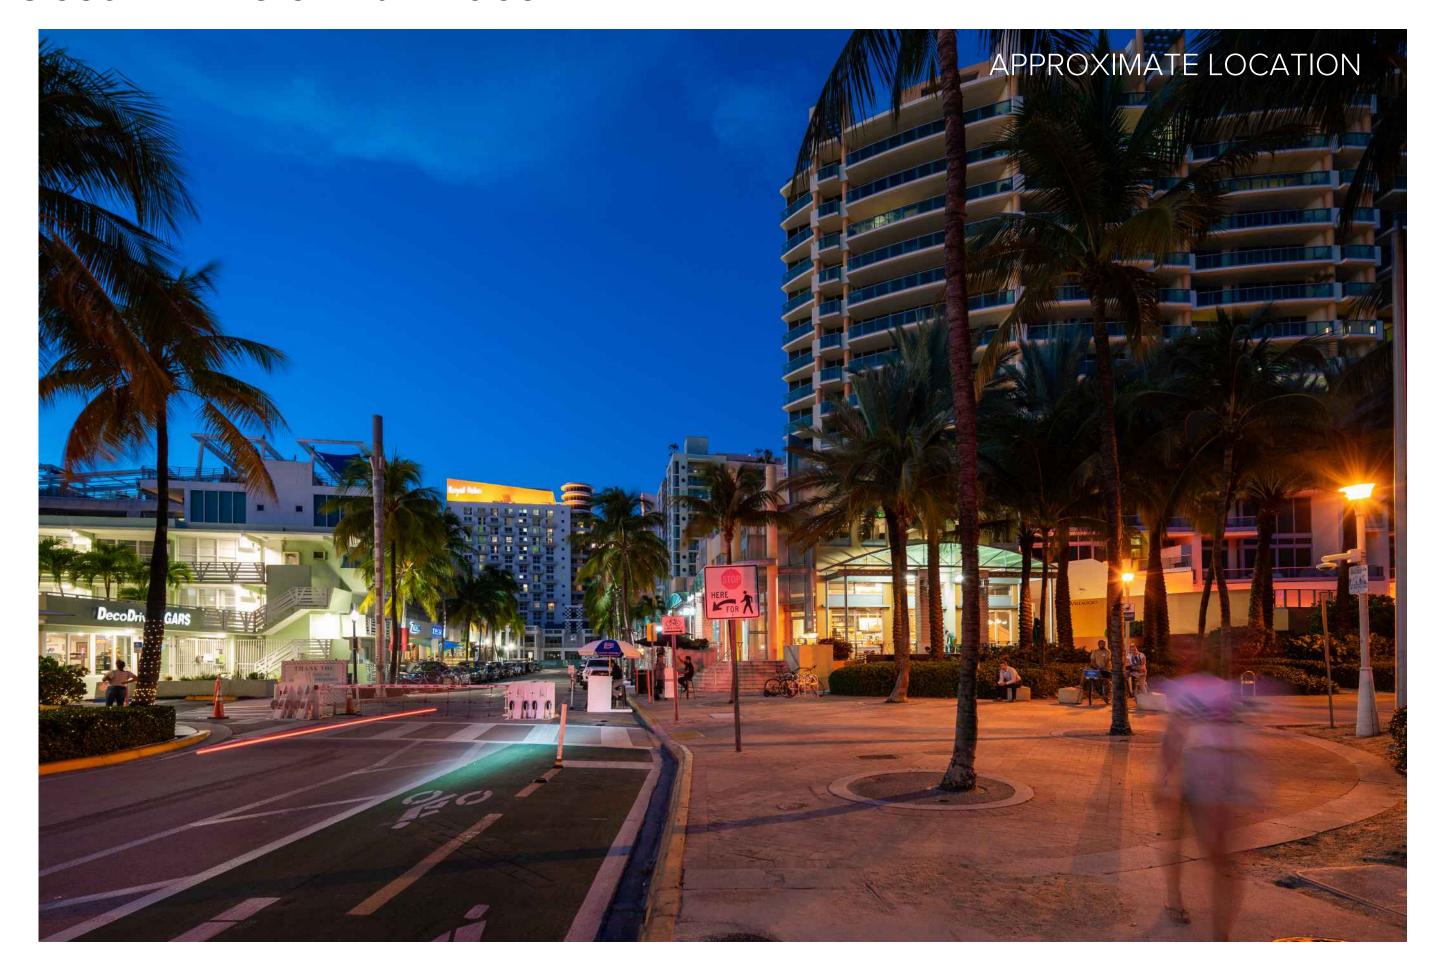
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CERTIFIED TO:

MAIN STREET ENGINEERING

DATE OF ORIGINAL FIELD WORK: JOB NUMBER: 23079737 DRAWN BY: ADRIEL SEAL CAD FILE: MAIN STREET ENG SHEET 1 OF 1 REVISION(S):

10. Ocean Drive & 14th Place





PUBLIC WORKS DEPARTMENT

OCEAN DRIVE & 10TH STREET
INTERACTIVE DIGITAL KIOSK DEPLOYMENT PROJECT
OCTOBER 2023
IKE SMART CITY
MIB-001

CITY OF MIAMI BEACH

MAYOR: DAN GELBER

COMMISSIONERS: MICKY STEINBERG

MARK SAMUELIAN MICHAEL GONGORA STEVEN MEINER RICKEY ARRIOLA DAVID RICHARDSON


CITY MANAGER: ALINA T. HUDAK

CITY ATTORNEY: RAFAEL A. PAZ

PUBLIC WORKS DIRECTOR: JOE GOMEZ, P.E., F.FES

CITY ENGINEER: NELSON PEREZ-JACOME, PE



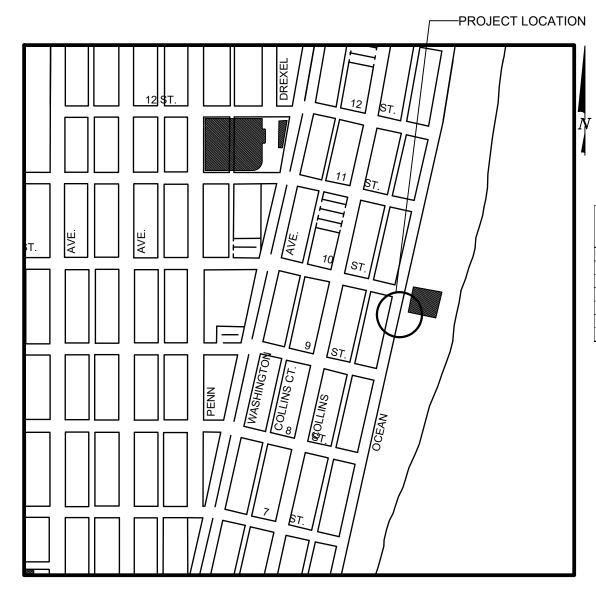



INDEX OF PLANS					
NUMBER	DISCIPLINE	SHEET NO.	DESCRIPTION	NOTES	
1	GENERAL	G0-03	INDEX OF SHEETS		
2	GENERAL	G0-04	ADA NOTES, SCOPE OF WORK & KIOSK SPECIFICATIONS		
3	CIVIL	C1-01	CIVIL SITE PLAN		
4	CIVIL	C1-02	KIOSK MIB-001 ENGINEERING PLAN		
5	ELECTRICAL	E1-01	KIOSK MIB-001 ELECTRICAL PLAN		
6	SURVEY		KIOSK MIB-001 SITE SURVEY		
		_		•	

SCOPE OF WORK: THE PROJECT CONSISTS OF THE INSTALLATION OF ONE (1) DIGITAL INTERACTIVE KIOSK AND APPLICABLE INFRASTRUCTURE; STRUCTURAL FOUNDATION AND ELECTRICAL SERVICE AT THE LOCATION INDICATED ON THESE DESIGN PLANS.

FINAL SUBMITTAL 10/09/2023

LOCATION MAP

INDEX OF PLANS

NUMBER	DISCIPLINE	SHEET NO.	DESCRIPTION	NOTES
1	GENERAL	G0-03	INDEX OF SHEETS	
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5	ELECTRICAL	E1-01	KIOSK MIB-001 ELECTRICAL PLAN	
6	SURVEY		KIOSK MIB-001 SITE SURVEY	

HISTORIC DISTRICTS **AND SITES** OF THE CITY OF **MIAMI BEACH** · FLORIDA · INCORPORATED 1915 Biscayne Bay Atlantic

PROJECT LOCATION

OCEAN DRIVE/COLLINS AVENUE HISTORIC DISTRICT

LOCAL HISTORIC DISTRICTS

Espanola Way Historic District Altos del Mar Historic District Flamingo Park Historic District

Ocean Drive/Collins Avenue Historic Dis

Ocean Beach Historic District Harding Townsite Historic District Palm View Historic District Collins Waterfront Historic District

Morris Lapidus/Mid 20th Century Historic District North Shore Historic District

NATIONAL REGISTER HISTORIC DISTRICTS

Miami Beach Architectural District Normandy Isles Historic District

North Shore Historic District

Collins Waterfront Architectural District

6 Sunset Island Bridges Historic Structures

LOCAL HISTORIC SITES

2 21st St Recreation Center Historic Site

3 Congregation Beth Jacob Historic Site

Old City Hall Historic Site

6 Miami Beach Woman's Club Historic Site

The Bath Club Historic Site

KIOSK MANUFACTURER: DISPLAY DEVICE INC. 21075 WESTGATE RD. **GOLDEN, CO 80403**

CONTACT: ERIC PERKINS PHONE: (303) 929-4071

UTILITIES:

ELECTRICAL POWER: FLORIDA POWER & LIGHT COMPANY (FPL)

WATER & SEWER: MIAMI-DADE WATER & SEWAGE DEPARTMENT **TELEPHONE: AT&T**

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36 Ocean Dr Historic Site

1700 Alton Rd Historic Site

CABLE: COMCAST, XFINITY, ATT-UVERSE

GAS: FLORIDA GAS

SIDEWALK & STREET SYMBOLS

ASPHALT BRICK **PAVER** CONCRETE UNIMPROVED TILE STAMPED **GRAVEL** CONCRETE

P.E. SEAL: = FIBER OPTIC MARKER SIGN SSA A. A = UNKNOWN UTILITY METER = UNKNOWN UTILITY MANHOLE = UNKNOWN UTILITY VALVE = UNKNOWN UTILITY MARKER FLAG

PROJECT DIRECTORY:

PROJECT NAME:

INTERACTIVE DIGITAL INFORMATION KIOSKS DEPLOYMENT PROJECT

JURISDICTION:

CITY OF MIAMI DEPARTMENT OF RESILIENCE AND **PUBLIC WORKS** MIAMI RIVERSIDE CENTER 444 S.W. 2nd AVENUE, 8th FLOOR MIAMI, FLORIDA 33130 TEL: 305-416-1200

OWNER:

IKE SMART CITY 250 N HARTOFORD AVE COLUMBUS, OH 43222 (614) 589-0087

ENGINEER OF RECORD: MAINSTREET ENGINEERING

7035 SW 47 STREET, SUITE A MIAMI, FL 33155 (305) 456-3505 PROJ. MGR: VANESSA MELA, P.E. VMELA@MAINSTREETENG.COM

ESIGN ENGINEER: VM DRAWN BY: KM

MIB-001: OCEAN DRIVE & 10TH STREET

File Name: MIB-001-GENERAL AND FOUNDATION REV1.dwg

STATE OF

FLORIDA

SONAL

PUBLIC WORKS DEPARTMENT 1700 CONVENTION CENTER DRIVE, MIAMI BEACH, FL.33139 JOE GOMEZ, P.E.

CITY MANAGER: ALINA T. HUDAK

VANESSA A. MELA P F NO 77676

HECKER: WP SCALE:

INDEX OF SHEETS

LEGEND AND ABBREVIATIONS

= ORNAMENTAL TREE

= OFFICIAL RECORDS BOOK

= OVERHEAD ELECTRIC LINE = SPOT ELEVATION

= CONCRETE = CONCRETE BLOCK STUCCO

= METAL FENCE = REINFORCED CONCRETE PIPE

= PALM TREE

= ELEVATION

= WOOD FENCE

= FINISH FLOOR

= SECTION LINE = CENTERLINE = BASELINE = MONUMENT LINE = TRAFFIC SIGNAL BOX = TRAFFIC SIGNAL CABINET = PEDESTRIAN SIGNAL = TRAFFIC SIGNAL MAST ARM = SIGN = CABLE TELEVISION BOX = LIGHT POLE

= ELECTRIC BOX

= UTILITY POLE = ELECTRIC TRANSFORMER = GUY ANCHOR = ELECTRIC METER = GAS VALVE = GAS UTILITY BOX = GAS MANHOLE = GAS TANK

= WATER VALVE

= WATER CONNECTION

= WATER WELL = WATER MARKING FLAG

= WATER MARKING SIGN

= NEWSPAPER DISPENSER = MAILBOX = SANITARY MANHOLE

= SANITARY LIFT STATION

= GREASE TRAP MANHOLE

= WATER MANHOLE = WATER TANK

= STORM MANHOLE

= STORM METER = CATCH BASIN = TELEPHONE MANHOLE = TELEPHONE BOX

= SANITARY BOX = SANITARY TANK

= PARKING METER

= FIBER OPTIC BOX

= SANITARY VALVE = RAILROAD SIGN

= PROPERTY LINE = ELECTRICAL OUTLET

= FLAGPOLE

= MONITORING WELL

= FUEL TANK = UNKNOWN UTILITY BOX

= CLEANOUT

= WATER BOX

= GAS METER = COMMUNICATION BOX = COMMUNICATION MANHOLE = GARBAGE RECEPTACLE = HANDICAP PARKING SPACE = WATER METER = IRRIGATION VALVE

= LICENSE BUSINESS = LENGTH = CENTRAL ANGLE = RADIUS = TANGENT

= POINT OF TANGENCY = POINT OF CURVATURE = STATION = POINT OF INTERSECTION = IDENTIFICATION = METAL LIGHT POLE

= TYPICAL = CABLE TELEVISION

O.R.B.

ELEV.

NOTES:

ADA NOTES

- 1. ALL CONSTRUCTION ACTIVITIES SHALL BE COMPLETED IN FULL COMPLIANCE WITH THE AMERICANS WITH DISABILITIES ACT (ADA). CLEAR SPACES IN FRONT OF KIOSK SHALL HAVE THE FOLLOWING CHARACTERISTICS:
- 2. SURFACES SHALL BE FIRM, STABLE, AND SLIP RESISTANT AND OTHERWISE COMPLY WITH PROWAG SECTION R302.7 AND SHALL HAVE A RUNNING SLOPE CONSISTENT WITH GRADE OF THE ADJACENT PEDESTRIANT ACCESS ROUTE AND CROSS SLOPE OF 1.50% +/-0.50%)
- 3. SIZE: CLEAR SPACES SHALL BE 48" MINIMUM BY 48" MINIMUM.
- 4. POSITION: UNLESS OTHERWISE SPECIFIED, CLEAR SPACES SHALL BE POSITIONED FOR EITHER FORWARD OR PARALLEL APPROACH TO THE KIOSK.
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- 6.1.1. FORWARD APPROACH: THE CLEAR SPACE AND ADDITIONAL MANEUVERING SPACE SHALL BE 36" WIDE MINIMUM WHERE THE DEPTH OF THE CONFINING ELEMENT EXCEEDS 24".
- 6.1.2. PARALLEL APPROACH: THE CLEAR SPACE AND ADDITIONAL MANEUVERING SPACE SHALL BE 60" WIDE MINIMUM WHERE THE DEPTH OF THE CONFINING ELEMENT EXCEEDS 15".
- 7. THE MINIMUM WHEELCHAIR PASSAGE WIDTH OR CLEAR SPACE WIDTH FOR A SINGLE WHEELCHAIR PASSAGE SHALL BE 48" PER PROWAG SECTION R302.3.
- 8. INITIAL OPERATION FOR THE KIOSK WILL HAVE 4G LTE CONNECTION SECTION R404. TO THE INTERNET.
- 9. THE KIOSKS HAVE BEEN DESIGN TO COMPLY WITH ALL ADA GUIDELINES INCLUDING VIEWING, OPERATION, AND ACCESSIBILITY.
- 10. THE MOBILE IKE EXPERIENCE WILL FOLLOW WEB CONTENT ACCESSIBILITY GUIDELINES (WCAG) TO WORK IN TANDEM WITH THE NATIVE ACCESSIBILITY FEATURES ON THE USER'S MOBILE DEVICE, INCLUDING TALKBACK AND VOICEOVER TOOLS.

SCOPE OF WORK

THE PROJECT CONSIST OF THE INSTALLATION OF ONE (1) DIGITAL INTERACTIVE KIOSKS AT THE LOCATION(S) INDICATED ON THIS PLANS SET. INSTALLER SHALL PROVIDE AND INCLUDE ALL WORKMANSHIP AND MATERIALS NECESSARY TO COMPLETE THE INSTALLATION INCLUDING BUT NOT LIMITED TO:

- 1. INSTALLATION OF THE KIOSKS TO THE FOUNDATION AS INDICATED ON PLANS TO NEW RECTANGULAR CONCRETE FOUNDATION.
- 2. ELECTRICAL SERVICE POINTS ARE EXISTING. CONNECT THE EXISTING ELECTRIC SERVICE TO THE NEW KIOSK AS INDICATED ON PLANS.
- 3. TESTING OF THE ELECTRICAL SERVICE INFRASTRUCTURE SHALL BE PERFORMED IN CONJUNCTION WITH A REPRESENTATIVE OF THE ENGINEER OF RECORD.
- 4. THE CONTRACTOR SHALL INSTALL THE KIOSK IN SUCH A WAY THAT THE KIOSK IS WITHIN THE PUBLIC R.O.W. AND IN COMPLIANCE WITH ALL APPLICABLE A.D.A. REQUIREMENTS
- 5. THE LOCATION OF KIOSKS HAS BEEN COORDINATE TO ENSURE THERE IS NO OBSTRUCTION OF THE SIGHT OF VEHICULAR SIGNS.
- 6. STAND-ALONE PEDESTRIAN KIOSKS SHOULD NOT BE INSTALLED WITHIN PEDESTRIAN CIRCULATION PATHS IN A MANNER THAT PERSONS AT THE KIOSK LOCK THE EFFECTIVE WIDTH OF THE PEDESTRIAN TRAVEL WAY.

MONUMENT SIGN SPECIFICATIONS AND FUNCTIONS

THE UNIT CONSISTS OF A UL/NRTL LISTED WEATHER AND VANDAL RESISTANT FREE STANDING ENCLOSURE DESIGNED TO COMPLY WITH THE FLORIDA BUILDING CODE AND OTHER APPLICABLE CODES INCLUDING THE NATIONAL ELECTRICAL CODE. THE UNIT HAS BEEN DESIGNED TO WITHSTAND WINDS OF 165 MPH. THE UNIT'S MAIN COMPONENTS ARE:

- 1. TWO (2) INTERACTIVE 65" VIDEO TOUCH SCREENS.
- 2. TWO (2) CAMERAS
- 3. ONE (1) CPU
- 4. ONE (1) WI-FI TRANSMITTER


MANUFACTURER: DYNASCAN MODEL NUMBER: CIO651DR5


NATIVE RESOLUTION: 1920 X 1080 ELECTRICAL POWER REQUIREMENT:

- 1. ONE-2-POLE, 20 AMP, 240 VOLTS CIRCUIT.
- TOTAL LOAD: 1400/2200 WATTS (OPERATIONAL/PEAK)
- 3. VOLTAGE: 100-240 VOLTS AC, 50-60 HZ

WEIGHT: 832 LBS

CERTIFICATION CE / FCC / RoHS

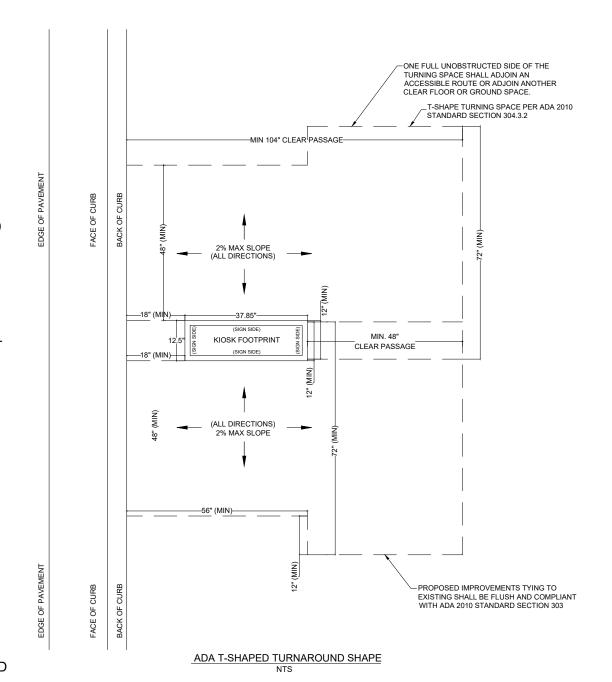

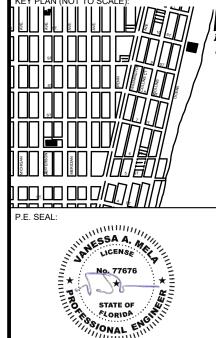

MIAMIBEACH
PUBLIC WORKS DEPARTMENT
1700 CONVENTION CENTER DRIVE, MIAMI BEACH, FL.33139

CITY MANAGER: ALINA T. HUDAK

DIRECTOR: JOE GOMEZ, P.E.

CITY ENGINEER: CRISTINA ORTEGA
CASTINEIRAS, P.E.

PANESSA A. MELA,

P F NO 77676

ENGINEER OF RECORD: <u>VM</u>
DESIGN ENGINEER: <u>VM</u>
DRAWN BY: <u>KM</u>
CHECKER: <u>WP</u>
SCAL E:

MIB-001: OCEAN DRIVE & 10TH STREET

TITLE: ADA NOTES, SCOPE OF WORK & KIOSK SPECIFICATIONS

File Name: MIB-001-GENERAL AND FOUNDATION REV1.dwg


Survey Reference:

NOTES:

k: N/A Page: N/A Work Order: N/A

0/09/2023 Sheet: 2 of 6 Drawing: **G0-**



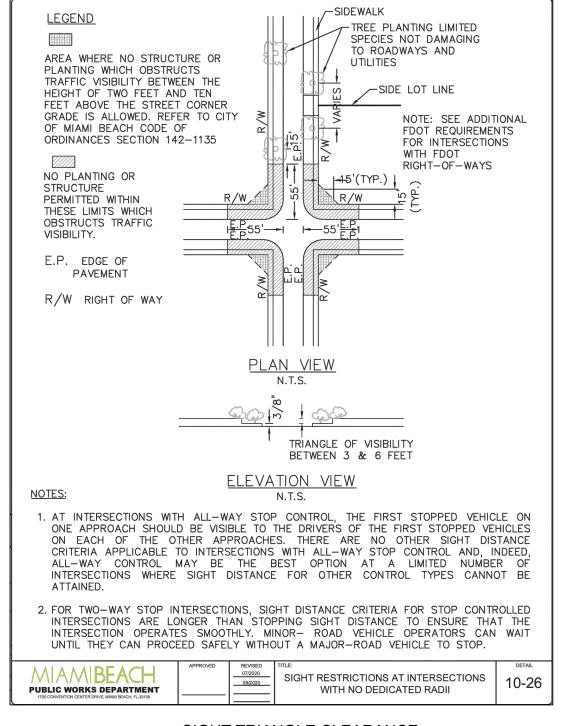

SIGHT TRIANGLE CLEARANCE



Call 811 or visit sunshine811.com two full business days before digging to have buried facilities located and marked.

Check positive response codes before you dig!

STATE OF SONAL EN

C1-01

12TH ST

PUBLIC WORKS DEPARTMENT 1700 CONVENTION CENTER DRIVE, MIAMI BEACH, FL.33139

TY MANAGER: ALINA T. HUDAK JOE GOMEZ, P.E. CITY ENGINEER: CRISTINA ORTEGA CASTINEIRAS, P.E.

12TH ST

11TH ST

DESIGN ENGINEER: VM DRAWN BY: KM HECKER: WP

SCALE:


VANESSA A. MELA,


P.F. NO. 77676

MIB-001: OCEAN DRIVE & 10TH STREET

CIVIL SITE PLAN

File Name: MIB-CIVIL PLANS REV1.dwg

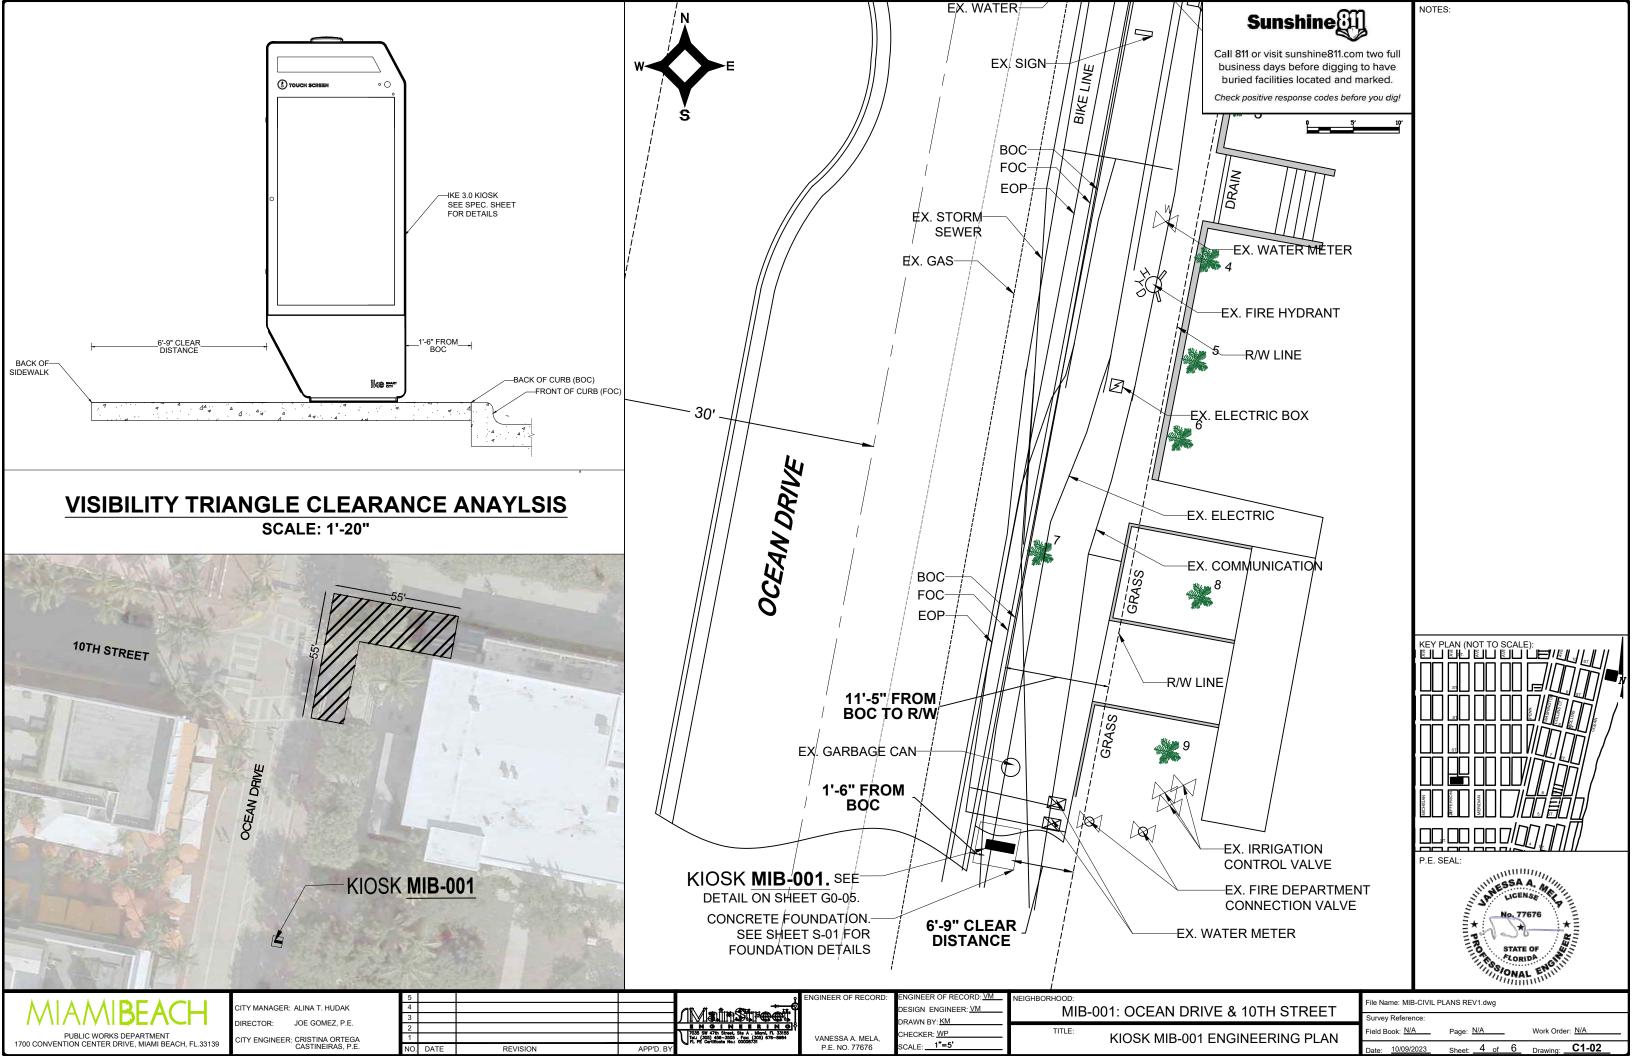

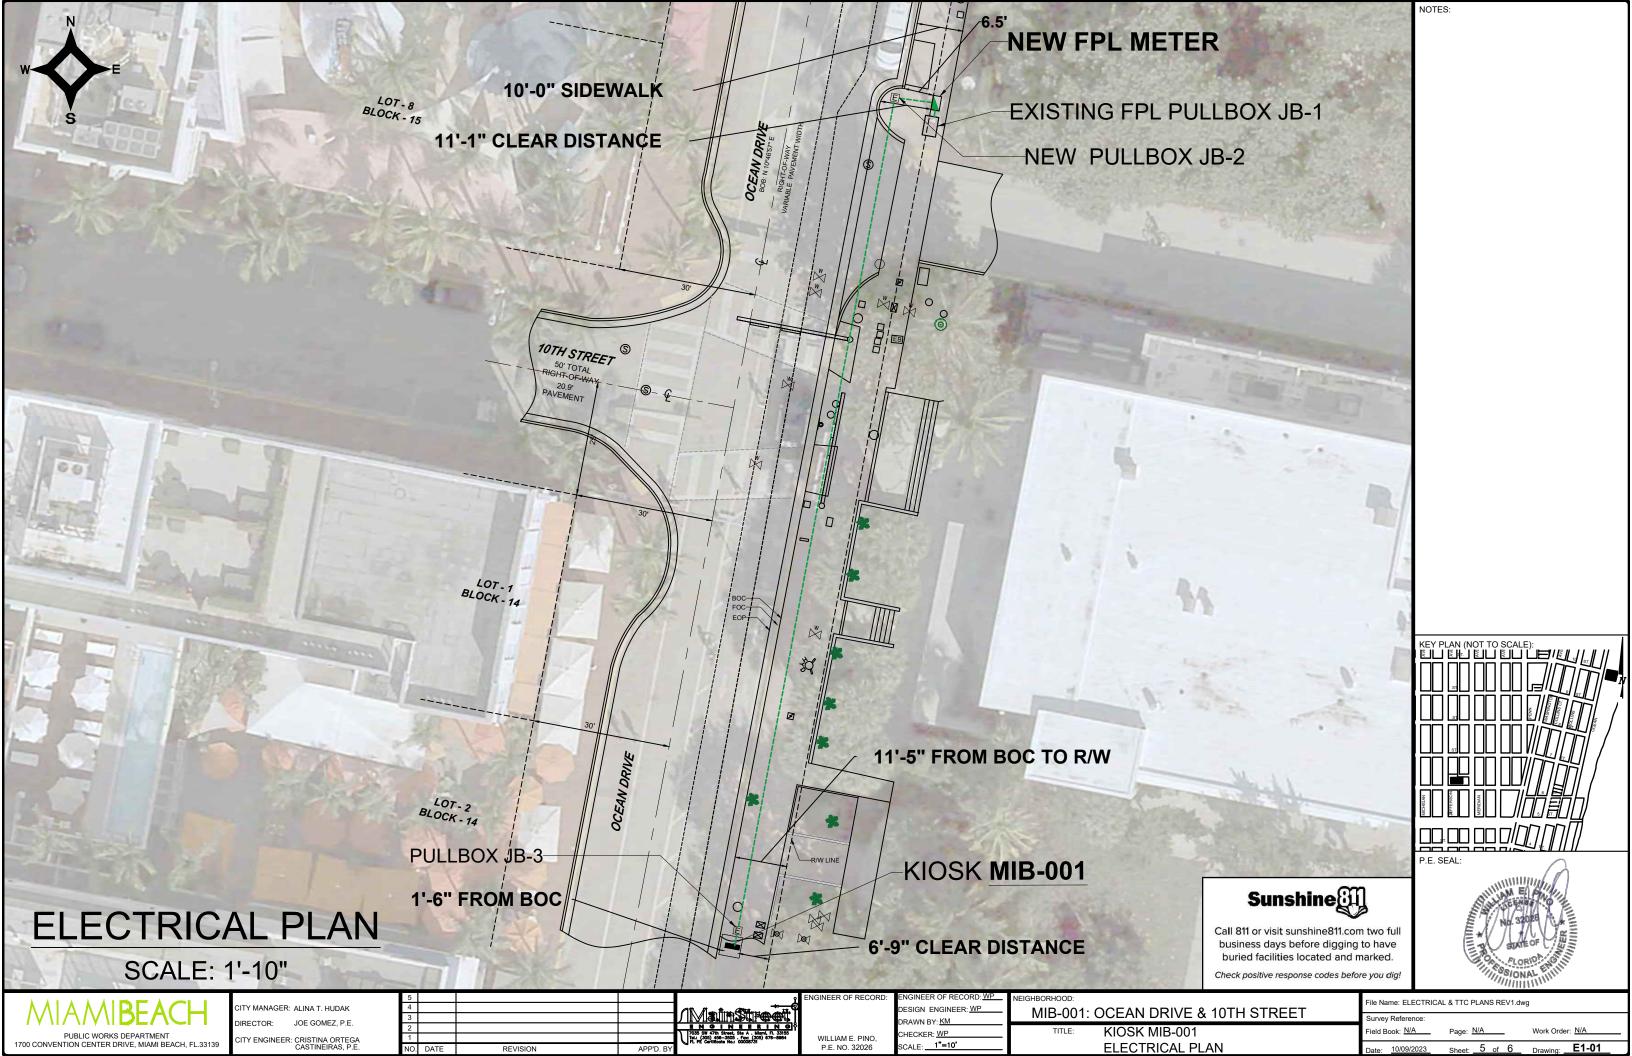

LEGEND

ABBREVIATIONS:

A = ARC DISTANCE
AC = AIR CONDITIONER PAD
BCR = BROWARD COUNTY RECORDS
BLDG = BUILDING
BM = BENCH MARK
BOB = BASIS OF BEARINGS
CBS = CONCRETE BLOCK & STUCCO CBS = CONCRETE BLOCK & STUCCO
(C) = CALCULATED

C&G = CURB & GUTTER

CLF = CHAIN LINK FENCE

COL = COLUMN

D.E. = DRAINAGE EASEMENT

D.M.E. = DRAINAGE & MAINTENANCE EASEMENT EASEMENT

D/W = DRIVEWAY

EB = ELECTRIC BOX

ENC. = ENCROACHMENT

EP = EDGE OF PAVEMENT

EW = EDGE OF WATER EW = EDGE OF WATER
FDH = FOUND DRILL HOLE
FFE = FINISHED FLOOR ELEVATION
FIP = FOUND IRON PIPE (NO ID) FIR = FOUND IRON ROD (NO ID)
FN = FOUND NAIL (NO ID)
FN&D= FOUND NAIL & DISCK FN&D= FOUND NAIL & DISCK FPL = FLORIDA POWER & LIGHT TRANSFORMER PAD L.E. = LANDSCAPE EASEMENT L.M.E. = LAKE MAINTENANCE EASEMENT

(M) = MEASURED

MDCR = MIAMI-DADE COUNTY RECORDS

(P) = PLAT PB = PLAT BOOK PC = POINT OF CURVATURE PCP = PERMANENT CONTROL POINT

PL = PLANTER
POB = POINT OF BEGINNING
POC = POINT OF COMMENCEMENT
PRC = POINT OF REVERSE CURVATURE
PRM = PERMANENT REFERENCE

PE = POOL EQUIPMENT PAD PG = PAGE PI = POINT OF INTERSECTION PL = PLANTER

MONUMENT
PT = POINT OF TANGENCY
R = RADIUS DISTANCE

(R) = RECORD R/W = RIGHT-OF-WAY

MH = MAN HOLE ML = MONUMENT LINE

R/W = RIGHT-OF-WAY
RES = RESIDENCE
SIP = SIP LB#8023
SND = SET NAIL & DISK LB#8023
STL = SURVEY TIE LINE
SWK = SIDEWALK
(TYP) = TYPICAL
UB = UTILITY BOX
U.E. = UTILITY EASEMENT
W/F = WOOD FENCE

SYMBOLS:

X 0.00 = ELEVATION(00') = ORIGINAL LOT DISTANCE Δ = CENTRAL ANGLE C = CENTER LINE

T = TELEPHONE RISER
□ = CABLE TV RISER

= WATER VALVE = CURB INLET

= FIRE HYDRANT

= LIGHT POLE = CATCH BASIN

= UTILITY POLE (D) = DRAINAGE MANHOLE S = SEWER MANHOLE

= ELECTRIC BOX

_____= SIGN → · · · · · = METAL FENCE * * * * = WOOD FENCE

*** * * = CHAIN LINK FENCE
----= EASEMENT BOUNDARY LINE - = OVERHEAD UTILITY LINE -- = ORIGINAL LOT LINE



GRAPHIC SCALE

1"=30

MAP OF SPECIFIC PURPOSE, TOPOGRAPHIC & TREE SURVEY

BLOCK . 15

OF A PORTION OF "OCEAN DRIVE" CITY OF MIAMI BEACH, FL. PLAT OF "OCEAN BEACH ADDITION NO. 2" PLAT BOOK 2, PAGE 56, MDCR

TREE TABLE:

NO	COMMON NAME	DBH(Ø)	HEIGHT	CANC
1	TREE	27"	28'	19'
2	PALMETTO	11"	18'	8'
3	PALMETTO	11"	18'	8'
4	PALMETTO	11"	18'	8'
5	PALMETTO	11"	18'	8'
6	PALMETTO	11"	18'	8'
7	PALMETTO (3)	3"	5'	6'
8	PALMETTO (3)	3"	5'	6'
9	PALMETTO (3)	3"	5'	6'

IN CASE OF A DISPUTE AN ARBORIST REPORT WILL GOVERN

-= COMMUNICATION LINE -= ELECTRIC LINE --- UNKNOWN -= STORM LINE ---- WATER LINE -= SANITARY LINE



NICOLAS DEL VENTO PROFESSIONAL SURVEYOR & MAPPER STATE OF FLORIDA LIC. # 6945

CERTIFICATE OF AUTHORIZATION # LB-8023

Survey Pros, Inc.

PH: (305) 767-6802 (main) MIAMI-DADE | BROWARD | PALM BEACH | MONROE | HILLSBOROUGH | PINELLAS www.survey-pros.com

LOCATION SKETCH:



FLOOD ZONE INFORMATION:

THE GRAPHICALLY DEPICTED BUILDING(S) SHOWN ON THIS MAP OF SURVEY IS WITHIN ZONE AE BASE FLOOD ELEVATION 8

COMMUNITY NAME & NUMBER CITY OF MIAMI BEACH 120651

MAP & PANEL NUMBER 12086C0319 SUFFIX L

SURVEYOR'S NOTES:

1. ELEVATIONS WHEN SHOWN REFER TO 1929 NATIONAL GEODETIC VERTICAL DATUM

(NGVD 1929).

2. NO ATTEMPT WAS MADE TO LOCATE FOOTINGS/FOUNDATIONS, OR UNDERGROUND UTILITIES UNLESS OTHERWISE NOTED.

3. THE LANDS SHOWN HEREON HAVE NOT BEEN ABSTRACTED IN REGARDS TO MATTERS OF INTEREST BY OTHER PARTIES, SUCH AS EASEMENTS, RIGHTS OF WAYS, RESERVATIONS, ETC. ONLY PLATTED EASEMENTS ARE SHOWN.

4. THIS SURVEY WAS PREPARED FOR AND CERTIFIED TO THE PARTY(IES) INDICATED HEREON, AND IS NOT TRANSFERABLE OR ASSIGNABLE WITHOUT WRITTEN CONSENT OF

THIS FIRM.

5. ALL BOUNDARY LIMIT INDICATORS SET ARE STAMPED LB#8023.

6. THE BOUNDARY LIMITS ESTABLISHED ON THIS SURVEY ARE BASED ON THE LEGAL DESCRIPTION PROVIDED BY THE CLIENT OR ITS REPRESENTATIVE.

7. FENCE OWNERSHIP IS NOT DETERMINED. DIMENSIONS ARE TO THE INTERIOR PORTION OF THE FENCE.

B. ADDITIONS OR DELETIONS TO THIS SURVEY MAP AND/OR REPORT BY SOMEONE OTHER THAN THE SIGNING PARTY(IES) IS PROHIBITED WITHOUT WRITTEN CONSENT OF

OTHER IHAN THE SIGNING PARTITIES) IS PROHIBITED WITHOUT WITHEN CONSERT OF THE SIGNING PARTY (IES).

9. THIS SURVEY IS NOT VALID WITHOUT THE ORIGINAL SIGNATURE AND RAISED SEAL OF A FLORIDA LICENSED SURVEYOR AND MAPPER. OTHERWISE THIS MAP IS FOR INFORMATIONAL PURPOSES ONLY.

10. BEARINGS WHEN SHOWN ARE TO AN ASSUMED MERIDIAN AND BASED ON PLAT.

THE CENTERLINE OF OCEAN DRIVE BEARS N10°46'57"E.

SURVEYOR'S CERTIFICATION:

HERBEY CERTIFY THAT THIS SURVEY IS TRUE AND CORRECT TO THE BEST OF MY KNOWLEDGE AND BELIEF AS RECENTLY SURVEYED AND DRAWN UNDER MY DIRECTION AND MEETS THE MINIMUM TECHNICAL STANDARDS SET FORTH BY THE FLORIDA STATE BOARD OF SURVEYORS AND MAPPERS IN CHAPTER 5J-17 FLORIDA ADMINISTRATIVE CODE PURSUANT TO SECTION 472.027 FLORIDA STATUE.

CERTIFIED TO:

MAIN STREET ENGINEERING

07/26/2023 - UPDATE SURVEY, JOB#23039119

DATE OF ORIGINAL FIELD WORK: JOB NUMBER: 23039119 DRAWN BY: ADRIEL SEAL CAD FILE: MAIN STREET ENG SHEET 1 OF 1 REVISION(S):




LOCATION1: MACARTHUR CSWY --- 6.5' SW OF SW EDGE OF PAVEMENT

LOCATION2: BRIDGE ROAD --- 50' NW OF

PROJECTED C/L DESCRIPTION: BRASS DISK IN CONC SIDEWALK.

(STAMPED 87 93 E-03)

11. Ocean Drive & 10th Street

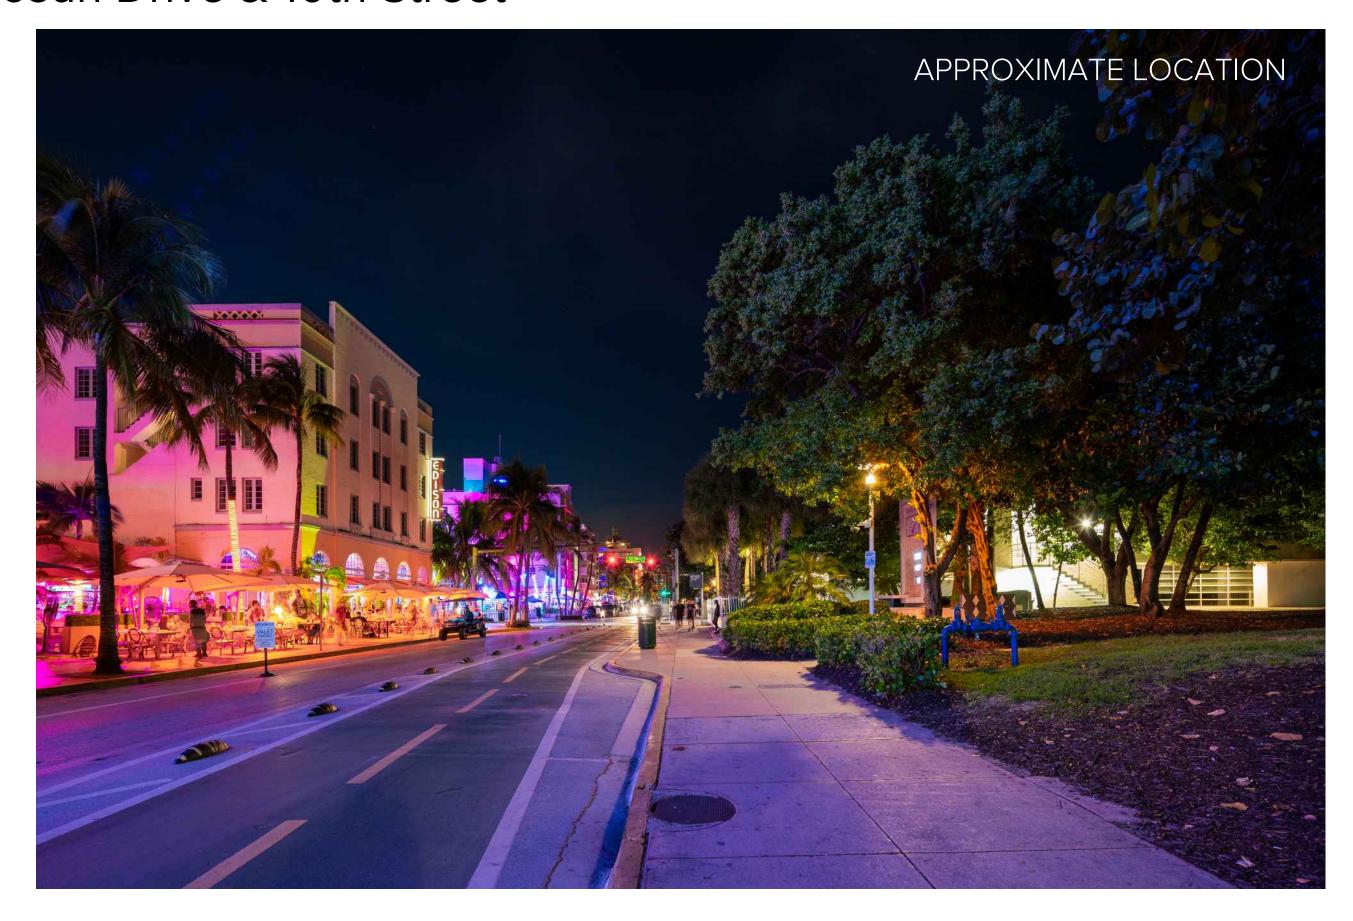



PUBLIC WORKS DEPARTMENT

WASHINGTON AVENUE & 10TH STREET
INTERACTIVE DIGITAL KIOSK DEPLOYMENT PROJECT
OCTOBER 2023
IKE SMART CITY
MIB-005

CITY OF MIAMI BEACH

MAYOR: DAN GELBER

COMMISSIONERS: MICKY STEINBERG

MARK SAMUELIAN MICHAEL GONGORA STEVEN MEINER RICKEY ARRIOLA DAVID RICHARDSON


CITY MANAGER: ALINA T. HUDAK

CITY ATTORNEY: RAFAEL A. PAZ

PUBLIC WORKS DIRECTOR: JOE GOMEZ, P.E., F.FES

CITY ENGINEER: NELSON PEREZ-JACOME, PE



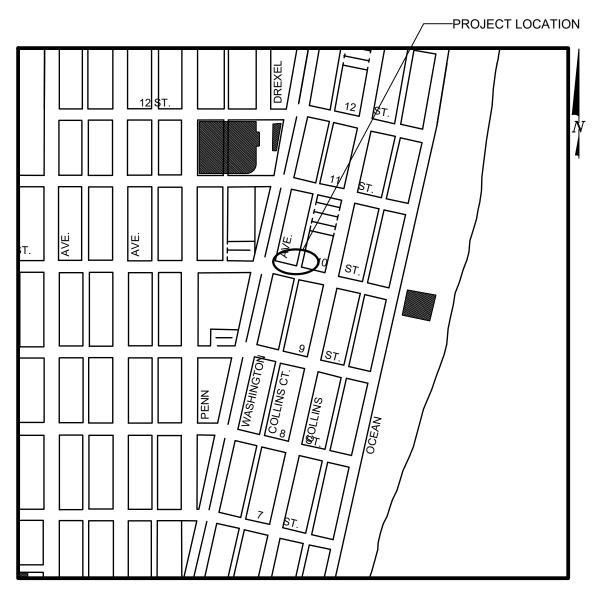



INDEX OF PLANS					
NUMBER	DISCIPLINE	SHEET NO.	DESCRIPTION	NOTES	
1	GENERAL	G0-03	INDEX OF SHEETS		
2	GENERAL	G0-04	ADA NOTES, SCOPE OF WORK & KIOSK SPECIFICATIONS		
3	CIVIL	C1-01	CIVIL SITE PLAN		
4	CIVIL	C1-02	MIB-005 ENGINEERING PLAN		
5	ELECTRICAL	E1-01	KIOSK MIB-005 ELECTRICAL PLAN		
6	SURVEY		MIB-005 SITE SURVEY		

SCOPE OF WORK: THE PROJECT CONSISTS OF THE INSTALLATION OF ONE (1) DIGITAL INTERACTIVE KIOSK AND APPLICABLE INFRASTRUCTURE; STRUCTURAL FOUNDATION AND ELECTRICAL SERVICE AT THE LOCATION INDICATED ON THESE DESIGN PLANS.

FINAL SUBMITTAL 10/09/2023

LOCATION MAP

INDEX OF PLANS

NUMBER	DISCIPLINE	SHEET NO.	DESCRIPTION	NOTES
1	GENERAL	G0-03	INDEX OF SHEETS	
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5	ELECTRICAL	E1-01	KIOSK MIB-005 ELECTRICAL PLAN	
6	SURVEY		MIB-005 SITE SURVEY	

PROJECT LOCATION FLAMINGO PARK HISTORIC DISTRICT

LOCAL HISTORIC DISTRICTS Espanola Way Historic District Palm View Historic District Altos del Mar Historic District Flamingo Park Historic District Ocean Drive/Collins Avenue Historic Dis

Collins Waterfront Historic District Morris Lapidus/Mid 20th Century Historic District

North Shore Historic District

NATIONAL REGISTER HISTORIC DISTRICTS

Miami Beach Architectural District Normandy Isles Historic District

North Shore Historic District

Collins Waterfront Architectural District

2 21st St Recreation Center Historic Site Congregation Beth Jacob Historic Site

LOCAL HISTORIC SITES

1 Old City Hall Historic Site

Venetian Causeway Historic Site

6 Sunset Island Bridges Historic Structures

The Bath Club Historic Site

8 Dade Blvd Fire Station Historic Site 9 PineTree Dr Historic Roadway

13 1600 Lenox Ave Historic Site 14 36 Ocean Dr Historic Site

1700 Alton Rd Historic Site

CABLE: COMCAST, XFINITY, ATT-UVERSE

GAS: FLORIDA GAS

PROJECT DIRECTORY:

PROJECT NAME:

INTERACTIVE DIGITAL INFORMATION KIOSKS DEPLOYMENT PROJECT

JURISDICTION:

Ocean Beach Historic District

Harding Townsite Historic District

CITY OF MIAMI DEPARTMENT OF RESILIENCE AND **PUBLIC WORKS** MIAMI RIVERSIDE CENTER 444 S.W. 2nd AVENUE, 8th FLOOR MIAMI, FLORIDA 33130 TEL: 305-416-1200

OWNER:

IKE SMART CITY 250 N HARTOFORD AVE COLUMBUS, OH 43222 (614) 589-0087

ENGINEER OF RECORD:

MAINSTREET ENGINEERING 7035 SW 47 STREET, SUITE A MIAMI, FL 33155 (305) 456-3505 PROJ. MGR: VANESSA MELA, P.E. VMELA@MAINSTREETENG.COM

KIOSK MANUFACTURER:

DISPLAY DEVICE INC. 21075 WESTGATE RD. **GOLDEN, CO 80403 CONTACT: ERIC PERKINS** PHONE: (303) 929-4071

UTILITIES:

ELECTRICAL POWER: FLORIDA POWER & LIGHT COMPANY (FPL)

WATER & SEWER: MIAMI-DADE WATER & SEWAGE DEPARTMENT

TELEPHONE: AT&T

SIDEWALK & STREET SYMBOLS **ASPHALT** BRICK **PAVER** CONCRETE UNIMPROVED TILE STAMPED **GRAVEL** CONCRETE

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LEGEND AND ABBREVIATIONS

NOTES:

PUBLIC WORKS DEPARTMENT

1700 CONVENTION CENTER DRIVE, MIAMI BEACH, FL.33139

ITY MANAGER: ALINA T. HUDAK JOE GOMEZ, P.E.

VANESSA A. MELA P F NO 77676

ESIGN ENGINEER: VM DRAWN BY: KM HECKER: WP SCALE:

HISTORIC DISTRICTS

AND SITES

CITY OF

MIAMI BEACH

FLORIDA .

INCORPORATED 1915

Biscayne Bay

MIB-005: WASHINGTON AVE & 10TH STREET

Atlantic

INDEX OF SHEETS

ile Name: MIB-005-GENERAL AND FOUNDATION.dwg

SSA A. W

STATE OF

FLORIDA

SONAL EN

ADA NOTES

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- 6.1.2. PARALLEL APPROACH: THE CLEAR SPACE AND ADDITIONAL MANEUVERING SPACE SHALL BE 60" WIDE MINIMUM WHERE THE DEPTH OF THE CONFINING ELEMENT EXCEEDS 15".
- 7. THE MINIMUM WHEELCHAIR PASSAGE WIDTH OR CLEAR SPACE WIDTH FOR A SINGLE WHEELCHAIR PASSAGE SHALL BE 48" PER PROWAG SECTION R302.3.
- 8. INITIAL OPERATION FOR THE KIOSK WILL HAVE 4G LTE CONNECTION SECTION R404. TO THE INTERNET.

SIDES, ADDITIONAL MANEUVERING SPACE SHALL BE PROVIDED AS FOLLOWS:

- 9. THE KIOSKS HAVE BEEN DESIGN TO COMPLY WITH ALL ADA GUIDELINES INCLUDING VIEWING, OPERATION, AND ACCESSIBILITY.
- 10. THE MOBILE IKE EXPERIENCE WILL FOLLOW WEB CONTENT ACCESSIBILITY GUIDELINES (WCAG) TO WORK IN TANDEM WITH THE NATIVE ACCESSIBILITY FEATURES ON THE USER'S MOBILE DEVICE. INCLUDING TALKBACK AND VOICEOVER TOOLS.

SCOPE OF WORK

THE PROJECT CONSIST OF THE INSTALLATION OF ONE (1) DIGITAL INTERACTIVE KIOSKS AT THE LOCATION(S) INDICATED ON THIS PLANS SET. INSTALLER SHALL PROVIDE AND INCLUDE ALL WORKMANSHIP AND MATERIALS NECESSARY TO COMPLETE THE INSTALLATION INCLUDING BUT NOT LIMITED TO:

- 1. INSTALLATION OF THE KIOSKS TO THE FOUNDATION AS INDICATED ON PLANS TO NEW RECTANGULAR CONCRETE FOUNDATION
- 2. ELECTRICAL SERVICE POINTS ARE EXISTING. CONNECT THE EXISTING ELECTRIC SERVICE TO THE NEW KIOSK AS INDICATED ON PLANS.
- TESTING OF THE ELECTRICAL SERVICE INFRASTRUCTURE SHALL BE PERFORMED IN CONJUNCTION WITH A REPRESENTATIVE OF THE ENGINEER OF RECORD.
- THE CONTRACTOR SHALL INSTALL THE KIOSK IN SUCH A WAY THAT THE KIOSK IS WITHIN THE PUBLIC R.O.W. AND IN COMPLIANCE WITH ALL APPLICABLE A.D.A. REQUIREMENTS
- THE LOCATION OF KIOSKS HAS BEEN COORDINATE TO ENSURE THERE IS NO OBSTRUCTION OF THE SIGHT OF VEHICULAR SIGNS.
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MONUMENT SIGN SPECIFICATIONS AND FUNCTIONS

THE UNIT CONSISTS OF A UL/NRTL LISTED WEATHER AND VANDAL RESISTANT FREE STANDING ENCLOSURE DESIGNED TO COMPLY WITH THE FLORIDA BUILDING CODE AND OTHER APPLICABLE CODES INCLUDING THE NATIONAL ELECTRICAL CODE. THE UNIT HAS BEEN DESIGNED TO WITHSTAND WINDS OF 165 MPH. THE UNIT'S MAIN COMPONENTS ARE:

- 1. TWO (2) INTERACTIVE 65" VIDEO TOUCH SCREENS.
- 2. TWO (2) CAMERAS
- ONE (1) CPU
- ONE (1) WI-FI TRANSMITTER


MANUFACTURER: DYNASCAN MODEL NUMBER: CIO651DR5

NATIVE RESOLUTION: 1920 X 1080 **ELECTRICAL POWER REQUIREMENT:**


- ONE-2-POLE. 20 AMP. 240 VOLTS CIRCUIT.
- 2. TOTAL LOAD: 1400/2200 WATTS (OPERATIONAL/PEAK)
- 3. VOLTAGE: 100-240 VOLTS AC, 50-60 HZ

WEIGHT: 832 LBS

CERTIFICATION CE / FCC / RoHS

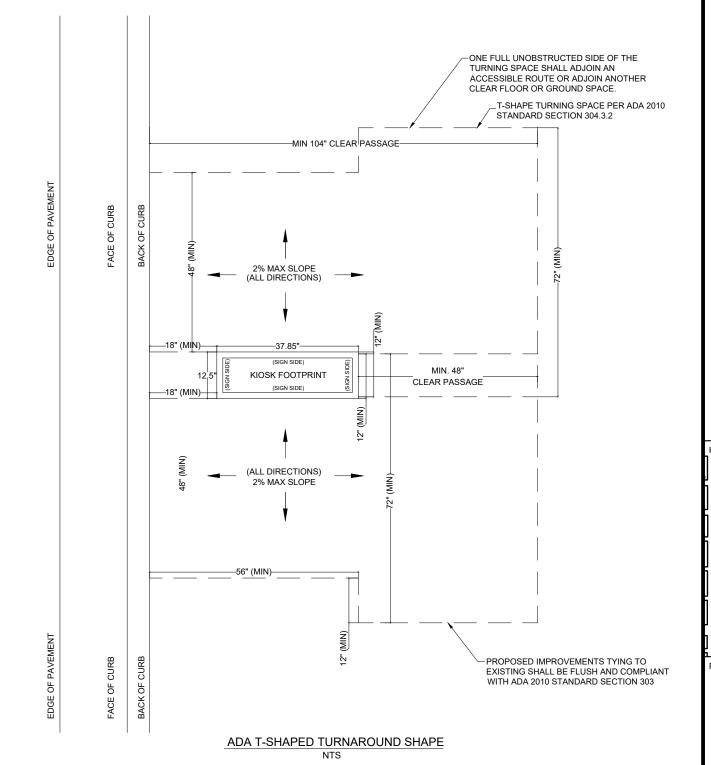

NOTES:

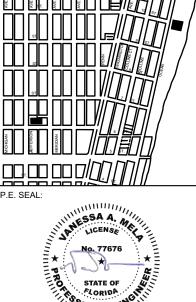

G0-04

PUBLIC WORKS DEPARTMENT 1700 CONVENTION CENTER DRIVE, MIAMI BEACH, FL.33139

CITY MANAGER: ALINA T. HUDAK JOE GOMEZ, P.E. CITY ENGINEER: CRISTINA ORTEGA CASTINEIRAS, P.E. NO. DATE

ESIGN ENGINEER VM RAWN BY: KM HECKER: WP VANESSA A. MELA

P F NO 77676

SCALE:

MIB-005: WASHINGTON AVE & 10TH STREET


& KIOSK SPECIFICATIONS

ADA NOTES, SCOPE OF WORK

ile Name: MIB-005-GENERAL AND FOUNDATION.dwo

Sheet: 2 of 6



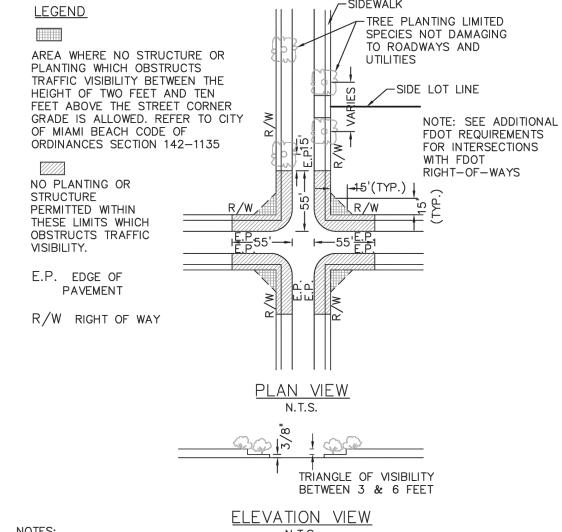

NOTES:

- 1. AT INTERSECTIONS WITH ALL-WAY STOP CONTROL, THE FIRST STOPPED VEHICLE ON ONE APPROACH SHOULD BE VISIBLE TO THE DRIVER'S OF THE FIRST STOPPED VEHICLES ON EACH OF THE OTHER APPROACHES. THERE ARE NO OTHER SIGHT DISTANCE CRITERIA APPLICABLE TO INTERSECTIONS WITH ALL-WAY STOP CONTROL AND, INDEED, ALL-WAY CONTROL MAY BE THE BEST OPTION AT A LIMITED NUMBER OF INTERSECTIONS WHERE SIGHT DISTANCE FOR OTHER CONTROL TYPES CANNOT BE ATTAINED.
- 2. FOR TWO-WAY STOP INTERSECTIONS, SIGHT DISTANCE CRITERIA FOR STOP CONTROLLED INTERSECTIONS ARE LONGER THAN STOPPING SIGHT DISTANCE TO ENSURE THAT THE INTERSECTION OPERATES SMOOTHLY. MINOR— ROAD VEHICLE OPERATORS CAN WAIT UNTIL THEY CAN PROCEED SAFELY WITHOUT A MAJOR-ROAD VEHICLE TO STOP.

PUBLIC WORKS DEPARTMENT

07/2020

SIGHT RESTRICTIONS AT INTERSECTIONS WITH NO DEDICATED RADII

10-26

SIGHT TRIANGLE CLEARANCE



Call 811 or visit sunshine811.com two full business days before digging to have buried facilities located and marked.

Check positive response codes before you dig!

STATE OF SONAL EN

PUBLIC WORKS DEPARTMENT

1700 CONVENTION CENTER DRIVE, MIAMI BEACH, FL.33139

TY MANAGER: ALINA T. HUDAK CITY ENGINEER: CRISTINA ORTEGA CASTINEIRAS, P.E.

JOE GOMEZ, P.E.

12TH ST

11TH ST

DESIGN ENGINEER: VM RAWN BY: KM HECKER: WP

SCALE:


VANESSA A. MELA,


P.F. NO. 77676

MIB-005: WASHINGTON AVE & 10TH STREET

File Name: MIB-005-CIVIL PLANS.dwg


CIVIL SITE PLAN

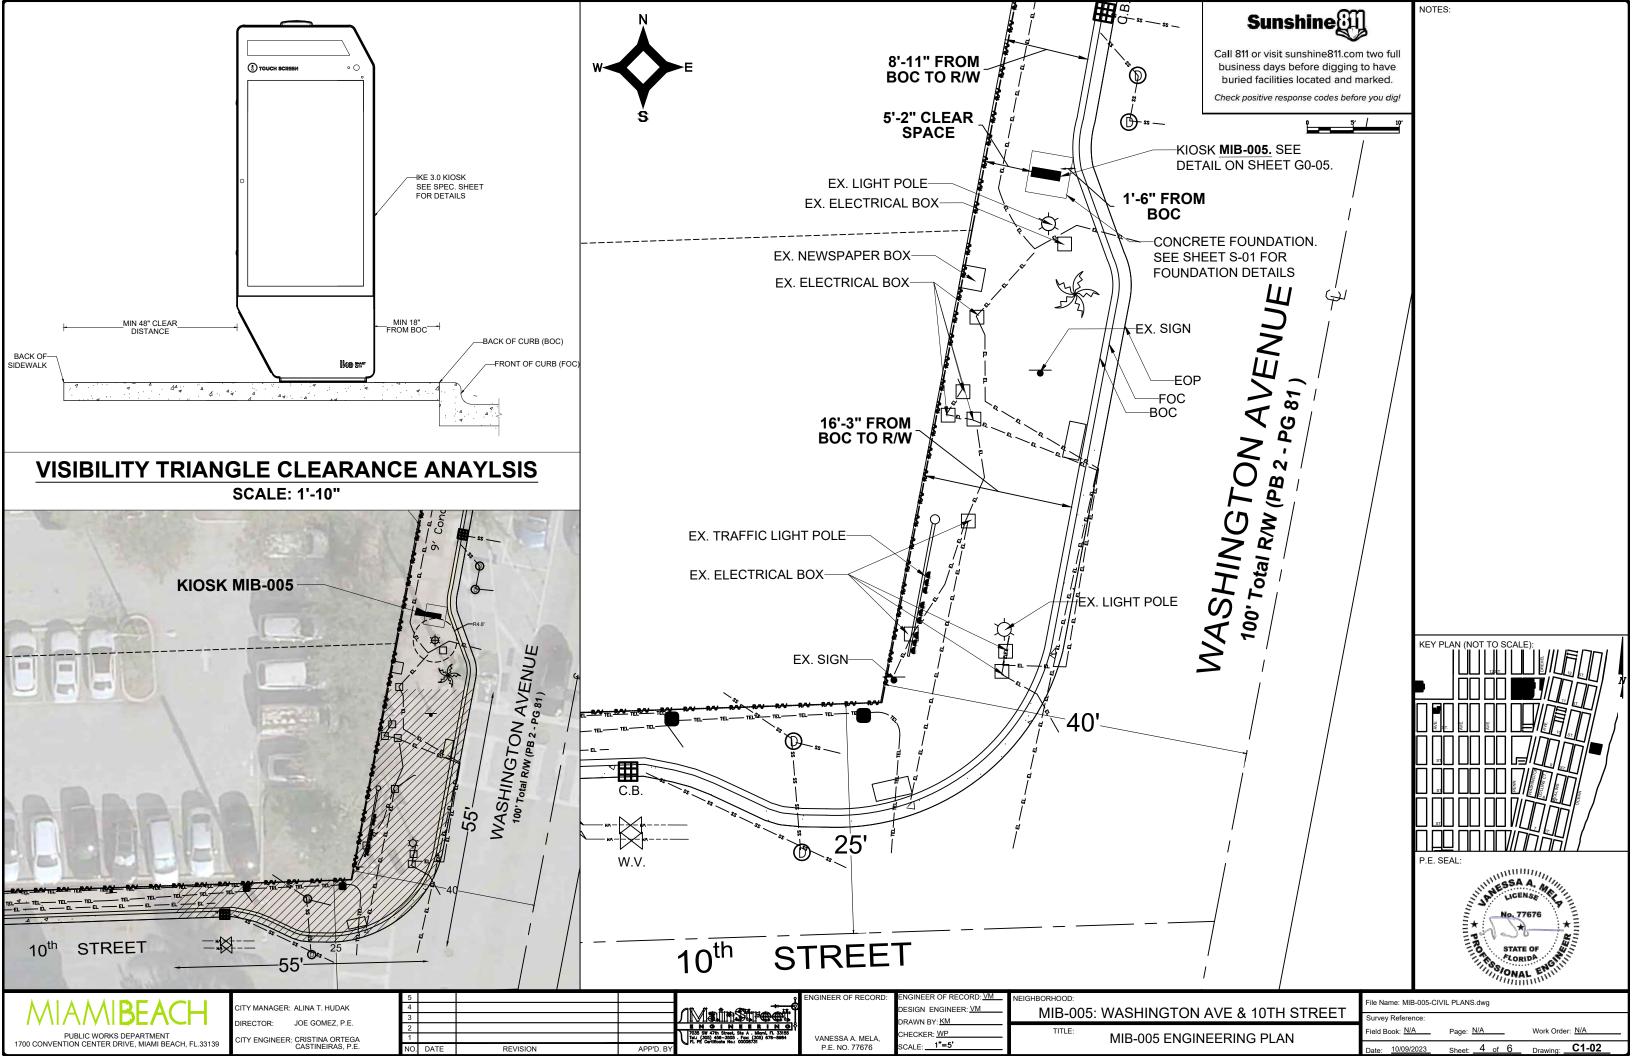

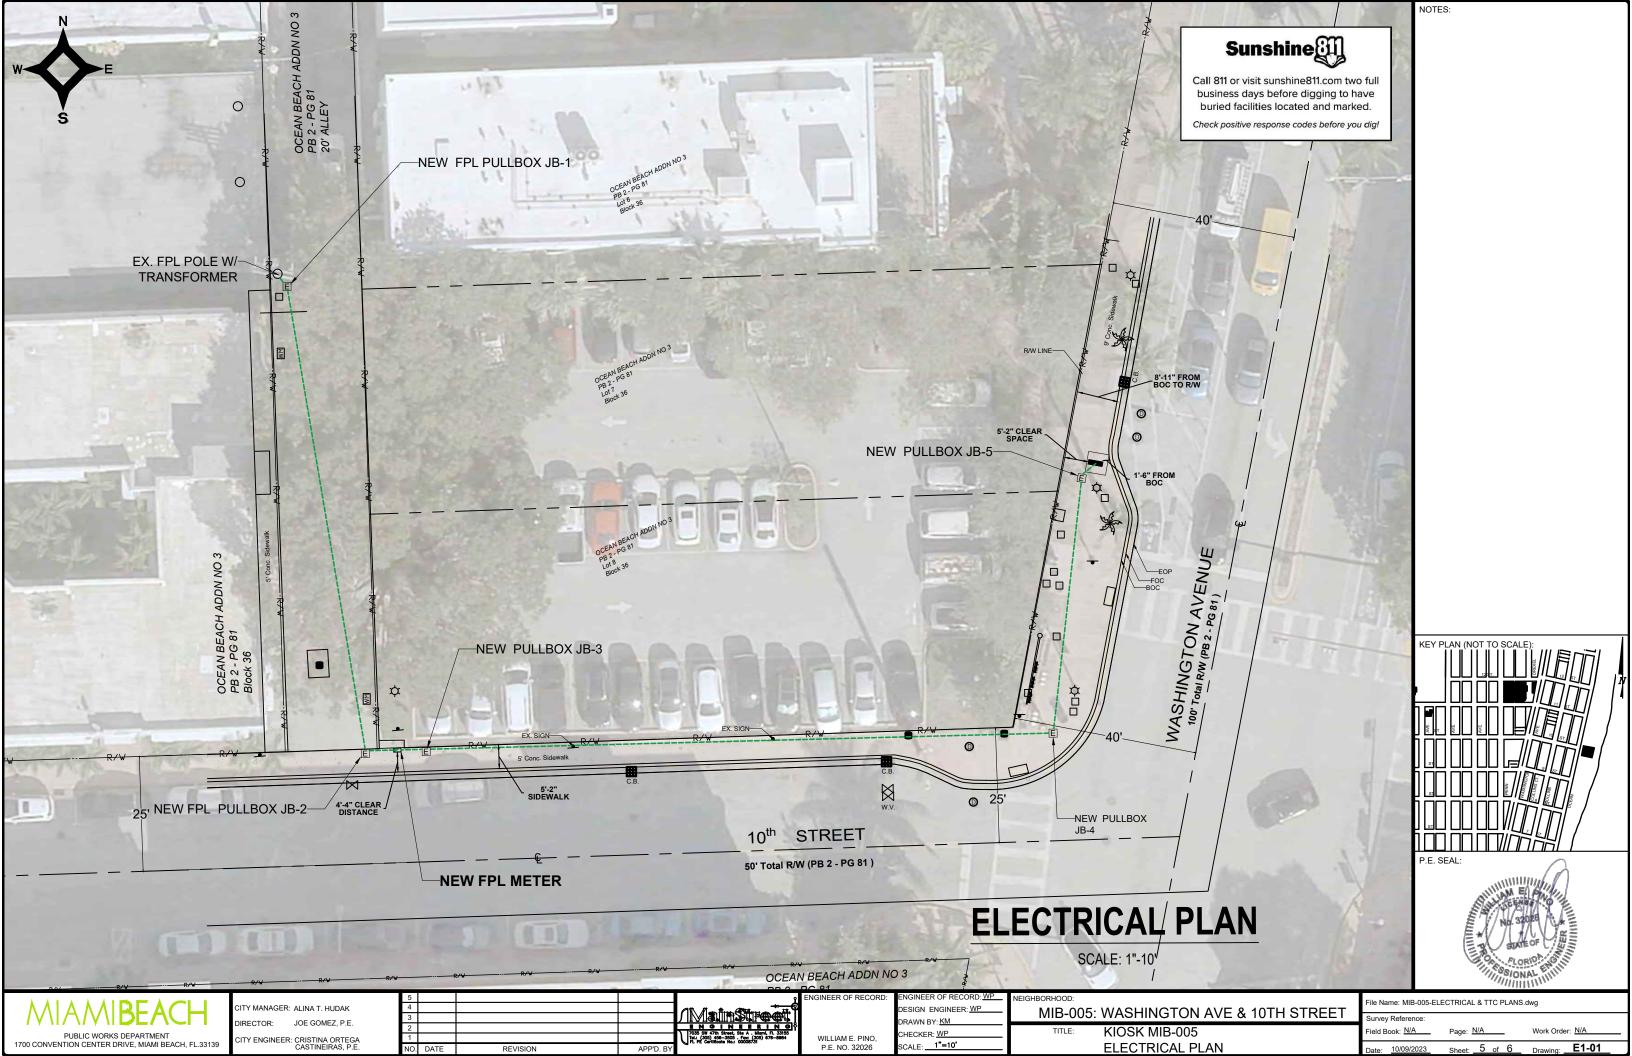

MAP OF TOPOGRAPHIC SURVEY

PORTION OF LANDS LYING IN SECTIONS 3. TOWNSHIP 54 SOUTH. RANGE 42 EAST, CITY OF MIAMI, MIAMI-DADE COUNTY, FLORIDA.

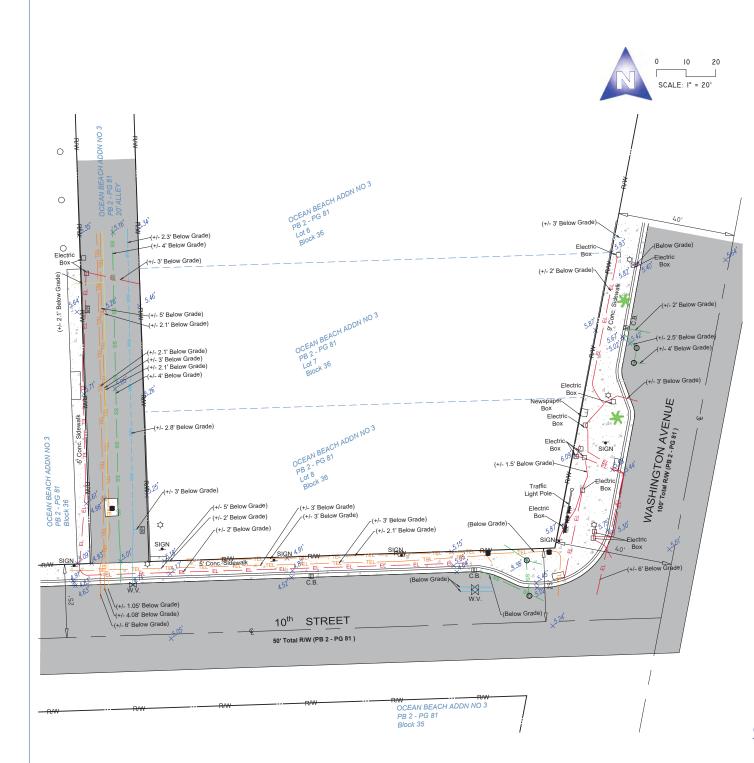


- FI - FI - RED PAINT LINE APPARENT FLECTRIC CONDUIT

= RIGHT OF WAY LINE

TEL TEL TEL - ORANGE PAINT LINE APPARENT TELECOMMUNICATION CABLES

= YELLOW PAINT LINE APPARENT GASS LINE

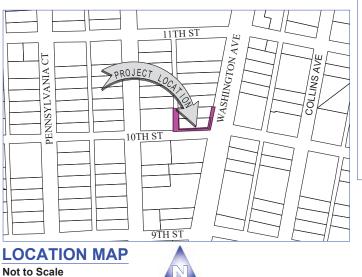

SURVEYOR'S REPORT AND GENERAL NOTES

(Not valid without the attached Survey Map)

the surveyor.

- 1. This is not a Boundary Survey. This is a Topographic survey of a portion of public right of ways. The underlying subdivisions as depicted on the survey is the following: Plat of OCEAN BEACH ADDITION No. 3, according to the plat thereof, as recorded in Plat Book 2, Page 81 of the Public Records of Miami-Dade County, Florida. These lands are subject to restrictions of record that were not furnished to the undersigning registered surveyor. A title search has not been performed by
- 2. North arrow direction is based on an assumed Meridian. Bearings are based on an assumed meridian on a well-established line, said line is being noted as BR on the Survey Map.
- 3. Foundations and/or any other underground structures have not been located.
- 4. Survey markers found in the field have no identification unless otherwise shown. Any survey marker set by our company is labeled LB 7262 or PSM 6169.
- 5. This Survey Map is intended to be displayed at the scale shown hereon. Data is expressed in U.S.
- 6. This Survey Map is being prepared for the use of the party/parties that it is certified to and does not extend to any unnamed individual, entity or assignee
- 7. FLOODPLAIN INFORMATION: As scaled from Federal Insurance Rate Map (FIRM) of Community No. 120651 (City of Miami Beach), Panel 0314, Suffix L, revised on Sept 11th, 2009, this real property falls in Zone "AE" with Base Flood Elevation 8 feet (NGVD 1929)
- 8. SUBSURFACE UTILITY ENGINEERING (SUE) QUALITY LEVEL B for investigation of underground utilities was performed as part of this survey using GPR (Ground Penetrating Radar) and RD (Radiodetection Technology) for designation and location of underground facilities. This Survey depicts apparent location of underground piping and conduits found during this investigation, and located as accurately as possible, based on best interpretation of signals received and combining it with utility evidences. Horizontal location of utilities is subject to a horizontal clearance of 3 (three) feet, plus or minus. Softdigs/excavation was not performed as part of this locating effort. There might be additional underground facilities not discovered at the time of this survey. AS-Builts of underground utilities were not furnished to this surveyor. This surveyor can't certify if the lines located are actively in service or not. This firm recommends that underground utilities be verified by electromagnetic technology and/or excavation prior to any construction work.
- 9. HORIZONTAL ACCURACY: Accuracy obtained thru measurements and calculations meets and exceeds the minimum horizontal feature accuracy for a Suburban area being equal to 1 foot in 7, 500 feet.
- 10.VERTICAL CONTROL AND ACCURACY: The elevations as shown are referred to the National Geodetic Vertical Datum of 1929 (NGVD 1929). The closure in feet, as computed, meets the standard of plus or minus 0.05 feet times the squared root of the loop distance in miles. Elevation are based on a level loop from and to the following official Bench Marks:

I hereby certify to Main Street Engineering that this Survey conforms to the Standards of Practice as set forth

Bench Mark # 1: Miami-Dade County Public Works Department Bench Mark X-310-R,

Elevation = 8.12 feet (NGVD29), Elevation = 6.57 feet (NAVD88)

Bench Mark # 2: Miami-Dade County Public Works Department Bench Mark W-310, Elevation = 5.47 feet (NGVD29), Elevation = 3.91t (NAVD88)

by the Florida Board of Professional Surveyors and Mappers in applicable provisions of Chapter 5J-17, Florida Administrative Code pursuant to Section 472.027 Florida Statutes. This Survey is accurate and correct to the best of my knowledge and belief.

c=US, o=Bello and Bello Land

Surveying Corp., dnOualifier-A01410D0000018 BDD60853000C0823, cn=Odalys C Bello 2023.05.12 09:51:58 -04'00'

Odalys C. Bello-Iznaga Professional Surveyor and Mapper LS6169 · State of Florida Field Work Date: 05/05/2023

10 20 SCALE: I" = 20'

LEGEND & ABBREVIATIONS

= CONCRETE BLOCK WALL = COVERED AREA

= PAVERS = STONE

X = CHAIN LINK FENCE (CLF)

-O-O-= IRON METAL BARS FENCE (IE

= WATER VALVE (WV) = POWER POLE (PP) = GUY ANCHOR

WM = WATER METER (WM)

CONC. = CONC. LIGHT POLE (LP)

= STREET SIGN

S = SANITARY MANHOLE = DRAINAGE MANHOLE (D)

= MANHOLE

= FIRE HYDRANT = CABLE BOX (CATV)

= FPL TRANSFORMER

= CATCH BASIN OR INLET

= EXISTING ELEVATION = PERMANENT REFERENCE MONUMENT (PRM)

= PROPERTY CORNER

= PERMANENT CONTROL POINT (PCP)

PT = POINT OF TANGENCY

PC = POINT OF CURVATURE PCC = POINT OF COMPOUND CURVE PRC = POINT OF REVERSE CURVE

BM = BENCH MARK = BEARING REFERENCE

TBM = TEMPORARY BENCH MARK = PROPERTY LINE = CENTER LINE

= MONUMENT LINE = BASE LINE

MEAS = FIELD MEASURED = PER PLAT PSM = PROFESSIONAL SURVEYOR AND

MAPPER A/C = AIR CONDITIONER PAD

ENCR = ENCROACHEMENT FF ELEV= FINISHED FLOOR ELEVATION

(XX-XX) = DENOTES PLAT BOOK XX - PAGE XX ORB = OFFICIAL RECORD BOOK

CBS = CONCRETE BLOCK STRUCTURE R/W = RIGHT OF WAY

ELEV = ELEVATION SEC = SECTION

T = TOWNSHIP R = RANGE

CALC = CALCULATED (R) = RECORD

(CMA X-X) = CITY OF MIAMI MUNICIPAL ATLAS X-X

Additions and deletions to this Survey Map are prohibited. This Survey Map and Report are not valid without the signature and original raised seal or without the authenticated electronic signature and seal of the undersigning Florida licensed Surveyor and Mapper

Property Address: (Reference)

Project No. 22986

1001 Pennsylvania Avenue, Miami Beach, Florida 33139 D.B.: UR

BELLO & BELLO LAND SURVEYING 12230 SW 131 AVENUE SUITE 201 MIAMI FL 33186 Phone: 305.251.9606 Fax: 305.251.6057 LB#7262

e-mail: info@belloland.com • www.bellolandsurveving.com



12. Washington Ave & 10th Street



MIAMIBEACH

PUBLIC WORKS DEPARTMENT

5th STREET & OCEAN DR
INTERACTIVE DIGITAL KIOSK DEPLOYMENT PROJECT
OCTOBER 2023
IKE SMART CITY
MIB-006

CITY OF MIAMI BEACH

MAYOR: DAN GELBER

COMMISSIONERS: MICKY STEINBERG

MARK SAMUELIAN MICHAEL GONGORA STEVEN MEINER RICKEY ARRIOLA DAVID RICHARDSON


CITY MANAGER: ALINA T. HUDAK


CITY ATTORNEY: RAFAEL A. PAZ

PUBLIC WORKS DIRECTOR: JOE GOMEZ, P.E., F.FES

CITY ENGINEER: NELSON PEREZ-JACOME, PE



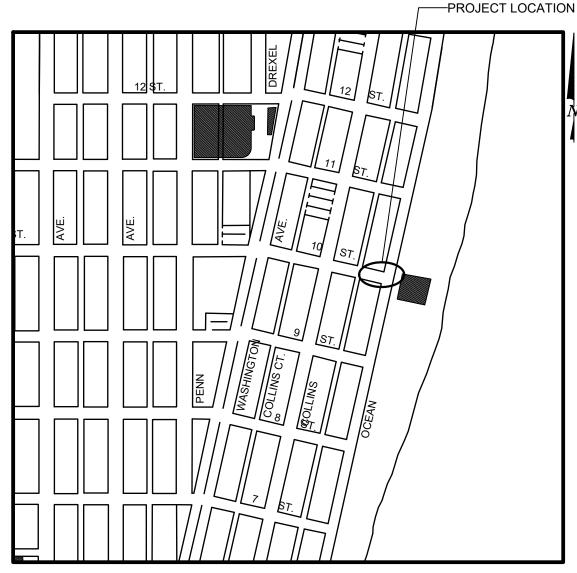

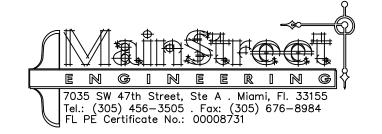

INDEX OF PLANS					
NUMBER	DISCIPLINE	SHEET NO.	DESCRIPTION	NOTES	
1	GENERAL	G0-03	INDEX OF SHEETS		
2	GENERAL	G0-04	ADA NOTES, SCOPE OF WORK & KIOSK SPECIFICATIONS		
3	CIVIL	C1-01	CIVIL SITE PLAN		
4	CIVIL	C1-02	KIOSK MIB-006 ENGINEERING PLAN		
5	ELECTRICAL	E1-01	KIOSK MIB-006 ELECTRICAL PLAN		
6	SURVEY		KIOSK MIB-006 SITE SURVEY		

SCOPE OF WORK: THE PROJECT CONSISTS OF THE INSTALLATION OF ONE (1) DIGITAL INTERACTIVE KIOSK AND APPLICABLE INFRASTRUCTURE; STRUCTURAL FOUNDATION AND ELECTRICAL SERVICE AT THE LOCATION INDICATED ON THESE DESIGN PLANS.

FINAL SUBMITTAL 10/09/2023

LOCATION MAP

INDEX OF PLANS

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6	SURVEY		KIOSK MIB-006 SITE SURVEY	

CITY OF **MIAMI BEACH** FLORIDA . INCORPORATED 1915 Biscayne Bay

HISTORIC DISTRICTS

AND SITES

PROJECT LOCATION

OCEAN DRIVE/COLLINS AVENUE HISTORIC DISTRICT

LOCAL HISTORIC DISTRICTS Espanola Way Historic District

Altos del Mar Historic District

Flamingo Park Historic District

Ocean Beach Historic District Harding Townsite Historic District Palm View Historic District Collins Waterfront Historic District

Morris Lapidus/Mid 20th Century Historic District North Shore Historic District

NATIONAL REGISTER HISTORIC DISTRICTS

Miami Beach Architectural District Normandy Isles Historic District

North Shore Historic District

Collins Waterfront Architectural District

6 Sunset Island Bridges Historic Structures

KIOSK MANUFACTURER:

Old City Hall Historic Site

The Bath Club Historic Site

LOCAL HISTORIC SITES

2 21st St Recreation Center Historic Site

Congregation Beth Jacob Historic Site

DISPLAY DEVICE INC. 21075 WESTGATE RD. **GOLDEN, CO 80403**

CONTACT: ERIC PERKINS PHONE: (303) 929-4071

UTILITIES:

ELECTRICAL POWER: FLORIDA POWER & LIGHT COMPANY (FPL)

WATER & SEWER: MIAMI-DADE WATER & SEWAGE DEPARTMENT

ATT-UVERSE

TELEPHONE: AT&T

36 Ocean Dr Historic Site

1700 Alton Rd Historic Site

8 Dade Blvd Fire Station Historic Site

CABLE: COMCAST, XFINITY,

GAS: FLORIDA GAS

SIDEWALK & STREET SYMBOLS **ASPHALT** BRICK **PAVER** CONCRETE UNIMPROVED TILE STAMPED **GRAVEL** CONCRETE

P.E. SEAL: = FIBER OPTIC MARKER SIGN 55A 4. = UNKNOWN UTILITY METER = UNKNOWN UTILITY MANHOLE = UNKNOWN UTILITY VALVE = UNKNOWN UTILITY MARKER FLAG

PROJECT DIRECTORY:

PROJECT NAME:

INTERACTIVE DIGITAL INFORMATION KIOSKS DEPLOYMENT PROJECT

JURISDICTION:

CITY OF MIAMI DEPARTMENT OF RESILIENCE AND **PUBLIC WORKS** MIAMI RIVERSIDE CENTER 444 S.W. 2nd AVENUE, 8th FLOOR MIAMI, FLORIDA 33130 TEL: 305-416-1200

OWNER:

IKE SMART CITY 250 N HARTOFORD AVE COLUMBUS, OH 43222 (614) 589-0087

ENGINEER OF RECORD: MAINSTREET ENGINEERING

7035 SW 47 STREET, SUITE A MIAMI, FL 33155 (305) 456-3505 PROJ. MGR: VANESSA MELA, P.E. VMELA@MAINSTREETENG.COM

ESIGN ENGINEER: VM

MIB-006: 5TH STREET & OCEAN DRIVE

LEGEND AND ABBREVIATIONS

= ORNAMENTAL TREE

= OFFICIAL RECORDS BOOK

= OVERHEAD ELECTRIC LINE = SPOT ELEVATION

= CONCRETE = CONCRETE BLOCK STUCCO = CHAIN LINK FENCE

= METAL FENCE = REINFORCED CONCRETE PIPE

= POINT OF TANGENCY = POINT OF CURVATURE = STATION = POINT OF INTERSECTION = IDENTIFICATION = METAL LIGHT POLE

= PALM TREE

= ELEVATION

= WOOD FENCE

= FINISH FLOOR = RECORD = CALCULATED = MEASURE = LICENSE BUSINESS = LENGTH = CENTRAL ANGLE = RADIUS = TANGENT

= SECTION LINE = CENTERLINE

= ELECTRIC BOX

= UTILITY POLE

= ELECTRIC TRANSFORMER = GUY ANCHOR = ELECTRIC METER = GAS VALVE = GAS UTILITY BOX = GAS MANHOLE = GAS TANK

= GAS METER = COMMUNICATION BOX = COMMUNICATION MANHOLE = GARBAGE RECEPTACLE = HANDICAP PARKING SPACE

= WATER METER = IRRIGATION VALVE

= WATER VALVE

= WATER CONNECTION

= WATER WELL = WATER MARKING FLAG

= WATER MARKING SIGN

= NEWSPAPER DISPENSER = MAILBOX = SANITARY MANHOLE

= SANITARY LIFT STATION

= GREASE TRAP MANHOLE

= WATER MANHOLE = WATER TANK

= STORM MANHOLE

= STORM METER = CATCH BASIN = TELEPHONE MANHOLE = TELEPHONE BOX

= SANITARY BOX = SANITARY TANK

= CLEANOUT

= PARKING METER

= FIBER OPTIC BOX

= SANITARY VALVE = RAILROAD SIGN

= PROPERTY LINE = ELECTRICAL OUTLET

= FLAGPOLE

= MONITORING WELL

= WATER BOX

= MONUMENT LINE = TRAFFIC SIGNAL BOX = TRAFFIC SIGNAL CABINET = PEDESTRIAN SIGNAL = TRAFFIC SIGNAL MAST ARM = SIGN = CABLE TELEVISION BOX = LIGHT POLE

= TYPICAL = CABLE TELEVISION

O.R.B.

ELEV.

NOTES:

File Name: MIB-006-GENERAL AND FOUNDATION.dwg

STATE OF

FLORIDA

SONAL EN

PUBLIC WORKS DEPARTMENT 1700 CONVENTION CENTER DRIVE, MIAMI BEACH, FL.33139 ITY MANAGER: ALINA T. HUDAK JOE GOMEZ, P.E.

SCALE: P F NO 77676

DRAWN BY: KM HECKER: WP

INDEX OF SHEETS

Atlantic

ADA NOTES

- 1. ALL CONSTRUCTION ACTIVITIES SHALL BE COMPLETED IN FULL COMPLIANCE WITH THE AMERICANS WITH DISABILITIES ACT (ADA). CLEAR SPACES IN FRONT OF KIOSK SHALL HAVE THE FOLLOWING CHARACTERISTICS:
- 2. SURFACES SHALL BE FIRM, STABLE, AND SLIP RESISTANT AND OTHERWISE COMPLY WITH PROWAG SECTION R302.7 AND SHALL HAVE A RUNNING SLOPE CONSISTENT WITH GRADE OF THE ADJACENT PEDESTRIANT ACCESS ROUTE AND CROSS SLOPE OF 1.50% +/-0.50%)
- 3. SIZE: CLEAR SPACES SHALL BE 48" MINIMUM BY 48" MINIMUM.
- 4. POSITION: UNLESS OTHERWISE SPECIFIED, CLEAR SPACES SHALL BE POSITIONED FOR EITHER FORWARD OR PARALLEL APPROACH TO THE KIOSK.
- 5. APPROACH: ONE FULL UNOBSTRUCTED SIDE OF A CLEAR SPACE SHALL ADJOIN A PEDESTRIAN ACCESS ROUTE OR ADJOIN ANOTHER CLEAR SPACE.
- 6. MANEUVERING SPACE: WHERE A CLEAR SPACE IS CONFINED ON ALL OR PART OF THREE SIDES. ADDITIONAL MANEUVERING SPACE SHALL BE PROVIDED AS FOLLOWS:
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- 6.1.2. PARALLEL APPROACH: THE CLEAR SPACE AND ADDITIONAL MANEUVERING SPACE SHALL BE 60" WIDE MINIMUM WHERE THE DEPTH OF THE CONFINING ELEMENT EXCEEDS 15".
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- 2. TWO (2) CAMERAS
- 3. ONE (1) CPU
- 4. ONE (1) WI-FI TRANSMITTER


MANUFACTURER: DYNASCAN MODEL NUMBER: CIO651DR5

NATIVE RESOLUTION: 1920 X 1080 ELECTRICAL POWER REQUIREMENT:

- 1. ONE-2-POLE, 20 AMP, 240 VOLTS CIRCUIT.
- 2. TOTAL LOAD: 1400/2200 WATTS (OPERATIONAL/PEAK)
- 3. VOLTAGE: 100-240 VOLTS AC, 50-60 HZ

WEIGHT: 832 LBS

CERTIFICATION CE / FCC / RoHS

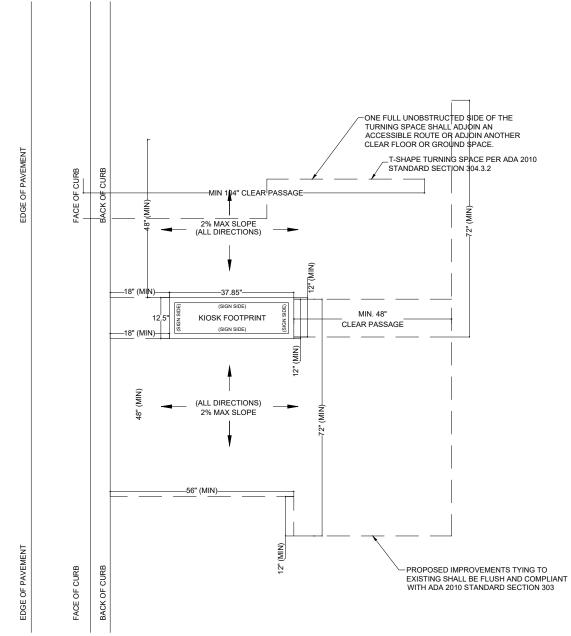

ADA T-SHAPED TURNAROUND SHAPE

1110

MIAMIBEACH

PUBLIC WORKS DEPARTMENT
1700 CONVENTION CENTER DRIVE, MIAMI BEACH, FL.33139

CITY MANAGER: ALINA T. HUDAK

DIRECTOR: JOE GOMEZ, P.E.

CITY ENGINEER: CRISTINA ORTEGA
CASTINEIRAS, P.E.

4 3 3 2 2 2 1 1 NO. DATE REVISION APP'D. BY

VANESSA A. MELA,

P F NO 77676

Engineer of Record: <u>VM</u>

DESIGN ENGINEER: <u>VM</u>

DRAWN BY: <u>KM</u>

CHECKER: <u>WP</u>

SCALE:


HBORHOOD: MIB-006: 5TH STREET & OCEAN DRIVE

ADA NOTES, SCOPE OF WORK & KIOSK SPECIFICATIONS File Name: MIB-006-GENERAL AND FOUNDATION.dwg
Survey Reference:

NOTES:

FLORID



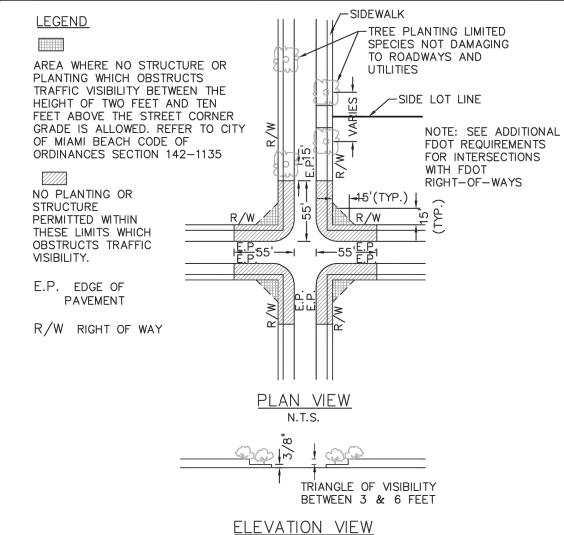

NOTES:

- 1. AT INTERSECTIONS WITH ALL-WAY STOP CONTROL, THE FIRST STOPPED VEHICLE ON ONE APPROACH SHOULD BE VISIBLE TO THE DRIVERS OF THE FIRST STOPPED VEHICLES ON EACH OF THE OTHER APPROACHES. THERE ARE NO OTHER SIGHT DISTANCE CRITERIA APPLICABLE TO INTERSECTIONS WITH ALL-WAY STOP CONTROL AND, INDEED, ALL-WAY CONTROL MAY BE THE BEST OPTION AT A LIMITED NUMBER OF INTERSECTIONS WHERE SIGHT DISTANCE FOR OTHER CONTROL TYPES CANNOT BE ATTAINED.
- 2. FOR TWO-WAY STOP INTERSECTIONS, SIGHT DISTANCE CRITERIA FOR STOP CONTROLLED INTERSECTIONS ARE LONGER THAN STOPPING SIGHT DISTANCE TO ENSURE THAT THE INTERSECTION OPERATES SMOOTHLY. MINOR— ROAD VEHICLE OPERATORS CAN WAIT UNTIL THEY CAN PROCEED SAFELY WITHOUT A MAJOR-ROAD VEHICLE TO STOP.

PUBLIC WORKS DEPARTMENT

07/2020

SIGHT RESTRICTIONS AT INTERSECTIONS WITH NO DEDICATED RADII


10-26

SIGHT TRIANGLE CLEARANCE



Call 811 or visit sunshine811.com two full business days before digging to have buried facilities located and marked.

Check positive response codes before you dig!

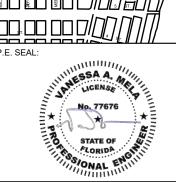

KEY PLAN (NOT TO SCALE): | BLJ BIT BLJ BLJ LEILE

PUBLIC WORKS DEPARTMENT 1700 CONVENTION CENTER DRIVE, MIAMI BEACH, FL.33139

JOE GOMEZ, P.E. CITY ENGINEER: CRISTINA ORTEGA CASTINEIRAS. P.E.


DESIGN ENGINEER: VM RAWN BY: KM HECKER: WP VANESSA A. MELA, P.E. NO. 77676


SCALE:

MIB-006: 5TH STREET & OCEAN DRIVE

CIVIL SITE PLAN

File Name: MIB-006-CIVIL PLANS.dwg

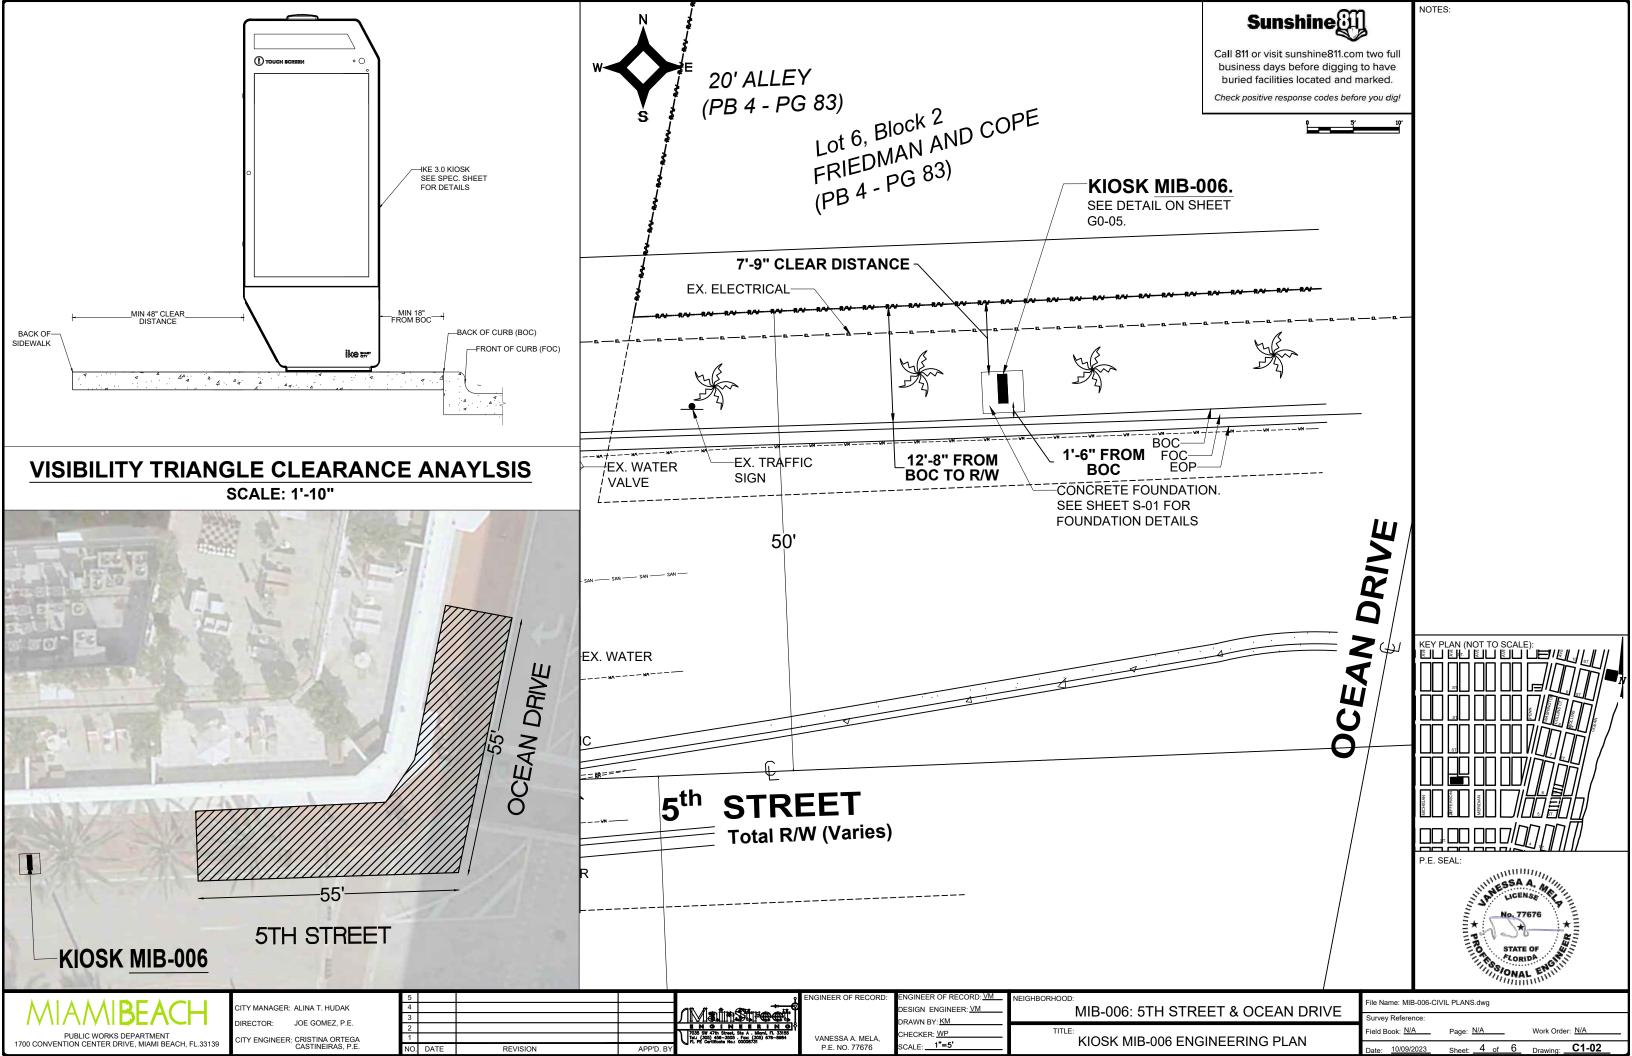


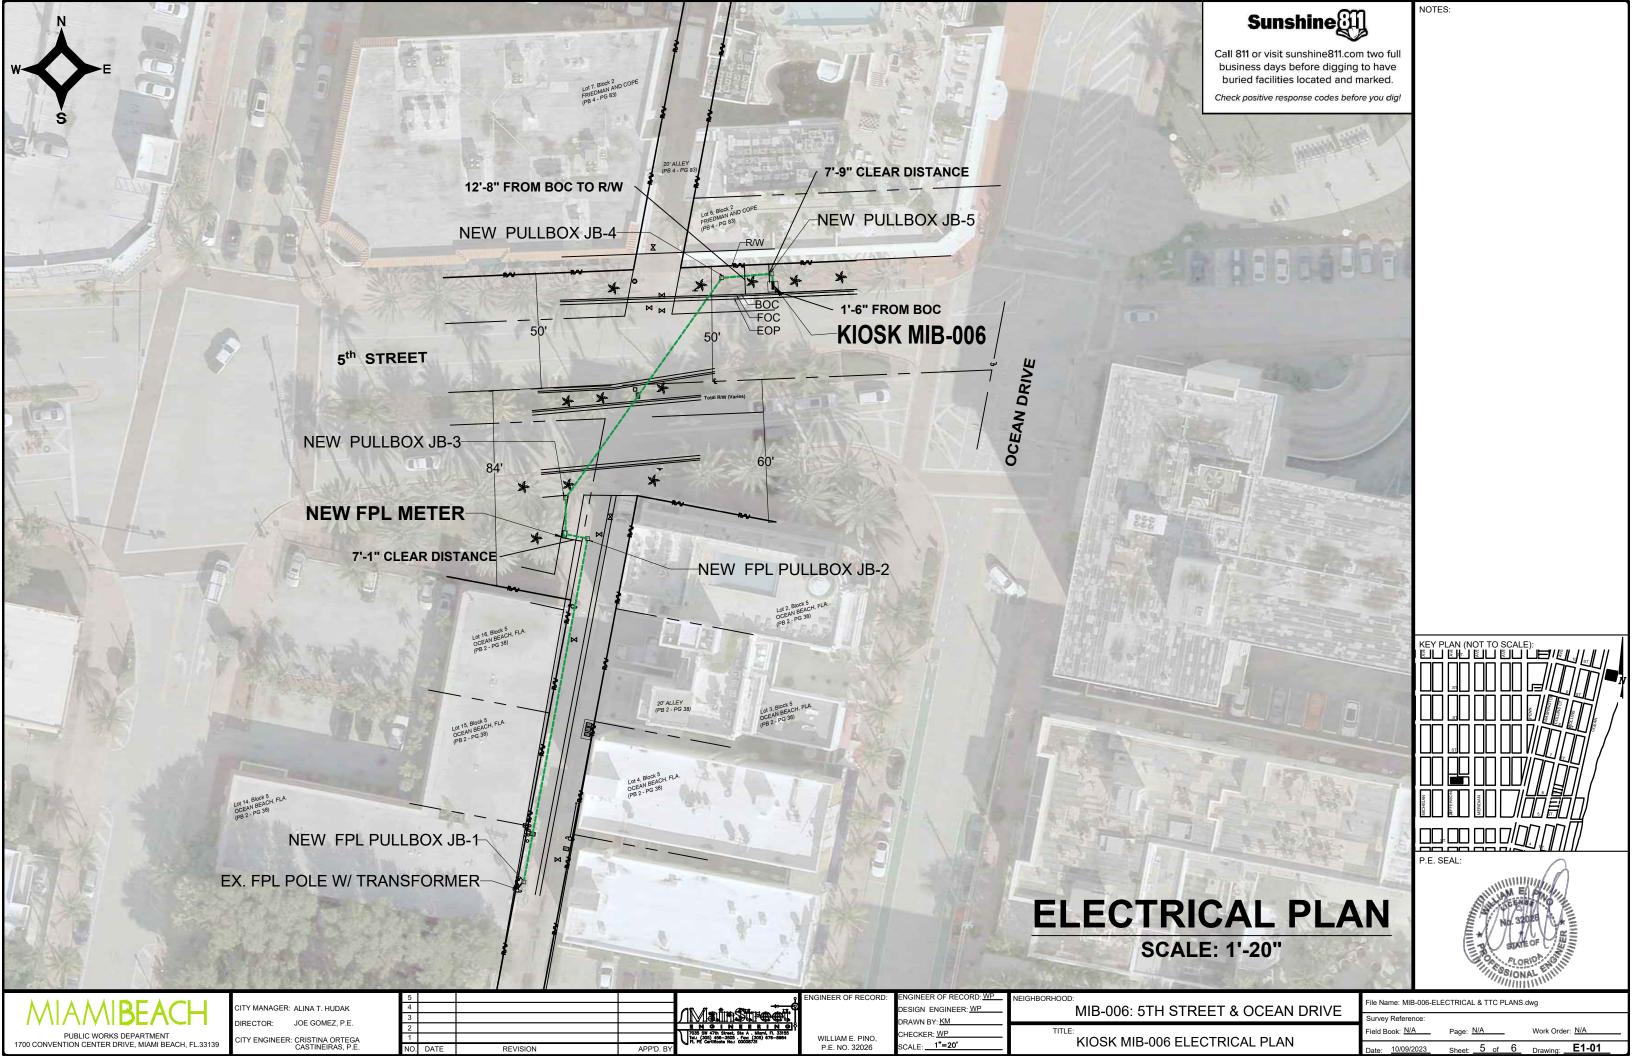

SCALE: I" = 20" DRIVE V+/- 5' Relow Grade) 5th STREET Not to Scale (+/- 2' Below Grade (+/- 3' Below Grade)-+/- 4' Below Grade +/- 2' Below Grade (+/- 3' Below Grade) (+/- 3' Below Grade (+/- 3' Below Grade) (PB 2 - PG 38) (+/- 4' Below Grade (+/- 5' Below Grade) (+/- 2' Below Grade (+/- 2' Below Grade - EL - EL - RED PAINT LINE APPARENT ELECTRIC CONDUIT - TEL = ORANGE PAINT LINE APPARENT TELECOMMUNICATION CABLES - WM == BLUE PAINT LINE APPARENT WATER LINE RW = RIGHT OF WAY LINE - SAN - SAN - = GREEN PAINT LINE APPARENT DRAINAGE LINE

MAP OF TOPOGRAPHIC SURVEY

PORTION OF LANDS LYING IN SECTIONS 3, TOWNSHIP 54 SOUTH, RANGE 42 EAST CITY OF MIAMI, MIAMI-DADE COUNTY, FLORIDA.

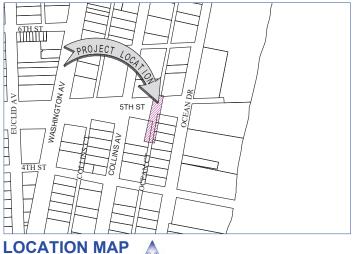

SURVEYOR'S REPORT AND GENERAL NOTES

(Not valid without the attached Survey Map)

- 1. This is not a Boundary Survey. This is a Topographic survey of a portion of public right of ways. The underlying subdivisions as depicted on the survey is the following:
- That Plat of OCEAN BEACH, FLA. & FRIEDMAN AND COPE, according to the plat thereof, as recorded in Plat Book 2, Page 38, Plat Book 4, Page 83 of the Public Records of Miami-Dade County, Florida. These lands are subject to restrictions of record that were not furnished to the undersigning registered surveyor. A title search has not been performed by the survevor.
- 2. North arrow direction is based on an assumed Meridian. Bearings are based on an assumed meridian on a well-established line, said line is being noted as BR on the Survey Map.
- 3. Foundations and/or any other underground structures have not been located.
- 4. Survey markers found in the field have no identification unless otherwise shown. Any survey marker set by our company is labeled LB 7262 or PSM 6169.
- 5. This Survey Map is intended to be displayed at the scale shown hereon. Data is expressed in U.S. Survey Foot.
- 6. This Survey Map is being prepared for the use of the party/parties that it is certified to and does not extend to any unnamed individual, entity or assignee.

 7. FLOODPLAIN INFORMATION: As scaled from Federal Insurance Rate Map (FIRM) of Community No. 120651 (City of
- Miami), Panel 0319, Suffix L, revised on Sept 11th, 2009, this real property falls in Zone "AE" with Base Flood Elevation 8 feet (NGVD 1929)
- 8. SUBSURFACE UTILITY ENGINEERING (SUE) QUALITY LEVEL B for investigation of underground utilities was performed as part of this survey using GPR (Ground Penetrating Radar) and RD (Radiodetection Technology) for designation and location of underground facilities. This Survey depicts apparent location of underground piping and conduits found during this investigation, and located as accurately as possible, based on best interpretation of signals received and combining it with utility evidences. Horizontal location of utilities is subject to a horizontal clearance of 3 (three) feet, plus or minus. Softdigs/excavation was not performed as part of this locating effort. There might be additional underground facilities not discovered at the time of this survey. AS-Builts of underground utilities were not furnished to this surveyor. This surveyor can't certify if the lines located are actively in service or not. This firm recommends that underground utilities be verified by electromagnetic technology and/or excavation prior to any construction work.
- 9. HORIZONTAL ACCURACY: Accuracy obtained thru measurements and calculations meets and exceeds the minimum horizontal feature accuracy for a Suburban area being equal to 1 foot in 7, 500 feet.
- 10. VERTICAL CONTROL AND ACCURACY: The elevations as shown are referred to the National Geodetic Vertical Datum of 1929 (NGVD 1929). The closure in feet, as computed, meets the standard of plus or minus 0.05 feet times the squared root of the loop distance in miles. Elevation are based on a level loop from and to the following official Bench Marks: Bench Mark # 1: Miami-Dade County Public Works Department Bench Mark D-146,

Elevation = 8.80 feet (NGVD29), Elevation = 7.25 feet (NAVD88)

Bench Mark # 2: Miami-Dade County Public Works Department Bench Mark D-116,

Elevation = 5.03 feet (NGVD29), Elevation = 3.48 feet (NAVD88)

I hereby certify to Main Street Engineering that this Survey conforms to the Standards of Practice as set forth by the Florida Board of Professional Surveyors and Mappers in applicable provisions of Chapter 5J-17, Florida Administrative Code pursuant to Section 472.027 Florida Statutes. This Survey is accurate and correct to the best of my knowledge and belief.

Odalys C. Bello-Iznaga Professional Surveyor and Mapper LS6169 State of Florida Field Work Date: 05/10/2023

LEGEND & ABBREVIATIONS

= CONCRETE (CONC.)
= CONCRETE BLOCK WALL
= WOOD DECK = COVERED AREA

= ASPHALT

= PAVERS = STONE

X = CHAIN LINK FENCE (CLF) -0-0- IRON METAL BARS FENCE (IF

= OVERHEAD WIRES = WATER VALVE (WV)

= POWER POLE (PP) WM = WATER METER (WM)

= CONC. LIGHT POLE (LP) ф (M) = WELL

= STREET SIGN

S = SANITARY MANHOLE = DRAINAGE MANHOLE (D)

9 = MANHOLE = FIRE HYDRANT

= CABLE BOX (CATV)

= FPL TRANSFORMER = CATCH BASIN OR INLET

= EXISTING ELEVATION

= PERMANENT REFERENCE MONUMENT (PRM)

= PROPERTY CORNER

= PERMANENT CONTROL POINT (PCP)

PT = POINT OF TANGENCY PC = POINT OF CURVATURE

PCC = POINT OF COMPOUND CURVE PRC = POINT OF REVERSE CURVE

BM = BENCH MARK = BEARING REFERENCE

TBM = TEMPORARY BENCH MARK = PROPERTY LINE

= CENTER LINE = MONUMENT LINE

= BASE LINE

MEAS = FIELD MEASURED = PER PLAT

PSM = PROFESSIONAL SURVEYOR AND MAPPER

A/C = AIR CONDITIONER PAD ENCR = ENCROACHEMENT

FF ELEV= FINISHED FLOOR ELEVATION (XX-XX) = DENOTES PLAT BOOK XX - PAGE X

ORB = OFFICIAL RECORD BOOK CBS = CONCRETE BLOCK STRUCTURE

R/W = RIGHT OF WAY ELEV = ELEVATION

SEC = SECTION T = TOWNSHIP

R = RANGE

CALC = CALCULATED (R) = RECORD

(CMA X-X) = CITY OF MIAMI MUNICIPAL

ATLAS X-X

Additions and deletions to this Survey Map are prohibited. This Survey Map and Repor are not valid without the signature and original raised seal or without the authenticated electronic signature and seal of the undersigning Florida licensed Survevor and Manna

Property Address:

436 Ocean Drive, Miami Beach, Florida 33139 (Reference Project No. 22985 D.B.: UR

BELLO & BELLO LAND SURVEYING

12230 SW 131 AVENUE SUITE 201 MIAMI FL 33186 Phone: 305.251.9606 Fax: 305.251.6057 LB#7262 e-mail: info@belloland.com • www.bellolandsurveying.com



13. Ocean Drive & 5th Street

