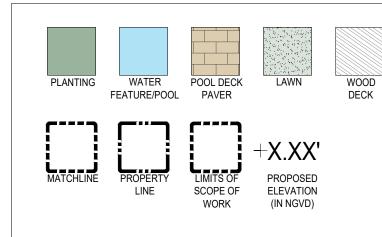
## SHEET INDEX

SHEET #	SHEET TITLE							
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L-0.00A	SITE TABULATIONS	F	٠	E	٠	ヒ	٠	
L-0.00B	ILLUSTRATIVE SITE PLAN	M	٠	3MI	•	M	•	
L-0.01	SITE SURVEY	SUBMI	٠	SUBM	•	SUBMI	•	
L-0.02	SITE SURVEY TREE LIST	C	•		٠			
L-1.10	OVERALL HARDSCAPE PLAN	Ř	٠	FIRST	٠	FINAL	٠	
L-1.11	REAR YARD HARDSCAPE AREA DIAGRAM	5	•	ш	•		٠	
L-3.00	OVERALL TREE DISPOSITION PLAN	8	•	НРВ	•	HPB	٠	
L-3.00A	EXISTING PLANTING AREAS DIAGRAM	2023.	•		٠	8	۲	
L-3.01	TREE DISPOSITION LIST	ຊ	٠	2023.04.17	٠	80.	٠	
L-3.02	TREE DISPOSITION LIST		•	33.	•	2023	٠	
L-3.03	TREE DISPOSITION LIST		•	20	•	20	٠	
L-3.04	TREE DISPOSITION LIST		•		٠		۲	
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L-3.11	ENLARGED LANDSCAPE PLAN 'A'		•		•		٠	
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L-3.14	ENLARGED LANDSCAPE PLAN 'D'		٠		٠		٠	
L-3.15	LANDSCAPE PLANT LIST		٠		٠		•	
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L-3.30	GENERAL PLANTING DETAILS		٠		٠		٠	
L-4.10	OVERALL LIGHTING PLAN		٠		٠		•	
L-5.10	OVERALL IRRIGATION PLAN		•		٠		•	

# **GRAPHIC LEGEND**



# **GENERAL ABBREVIATIONS**

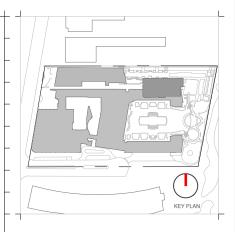
TW	TOP OF WALL	OA	OVERALL PLAN
TPW	TOP OF PLANTER WALL	CONC	CONCRETE
TB	TOP OF BENCH	LA	LANDSCAPE ARCHIT
TC	TOP OF CURB	ARCH	ARCHITECT
FFE	FINISH FLOOR ELEVATION	STRUCT	STRUCTURE / STRUC
AFF	ABOVE FINISH FLOOR	ENG	ENGINEER
P.L.	PROPERTY LINE	DWGS	DRAWINGS
TG	TOP OF GRADE	ТҮР	TYPICAL
M	MONUMENT LINE	EXST	EXISTING
Ę	CENTER LINE	HSCP	HARDSCAPE
ML	MATCH LINE	LSCP	LANDSCAPE
EL	ENLARGED PLAN	PLNT	PLANTING

# SCOPE OF WORK

HARDSCAPE, LANDSCAPE, LANDSCAPE LIGHTING, AND IRRIGATION WITHIN THE LIMITS DEFINED BY THE LIMITS OF SCOPE OF WORK.

EXISTING BEACH WALK
TECT
CTURAL





Date	Rev.	Date
		Date Rev.

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# Ritz-Sagamore

1 Lincoln Road Miami Beach, FL 33139

# Owner: Name Address Address Tel: Email

Di Lido Beach Resort LLC. EBJ Sagamore LLC. Sobe Sky Development LLC.

Consultant: Name Address Address Tel: Email STUDIO MUNGE. 25 Wingold Avenue, Toronto, ON Canada M6B 1P8 416.588.1668

Consultant: Name Address Address Tel: Email LANDSCAPE ARCHITECT Naturalficial. 6915 Red Road, Suite 224 Coral Gables, FL 33143 786.717.6564

Consultant: MEP Name MG Engineering. Address 6015 Red Road, Suite 224 Address 2800 Biscayne Blvd Tel: Miami, FL 33137 Email 305,755,3833

Consultant: Name Address Address Tel: Email

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Architect of Record: Kobi Karp Architecture and Interior Design, Inc. 571 NW 28TH ST Miami, Florida 33137 USA Tel:: +1(305) 573 1818 Fax: +1(305) 573 3766

Peter Anselmo R.L.A. FL #6667221

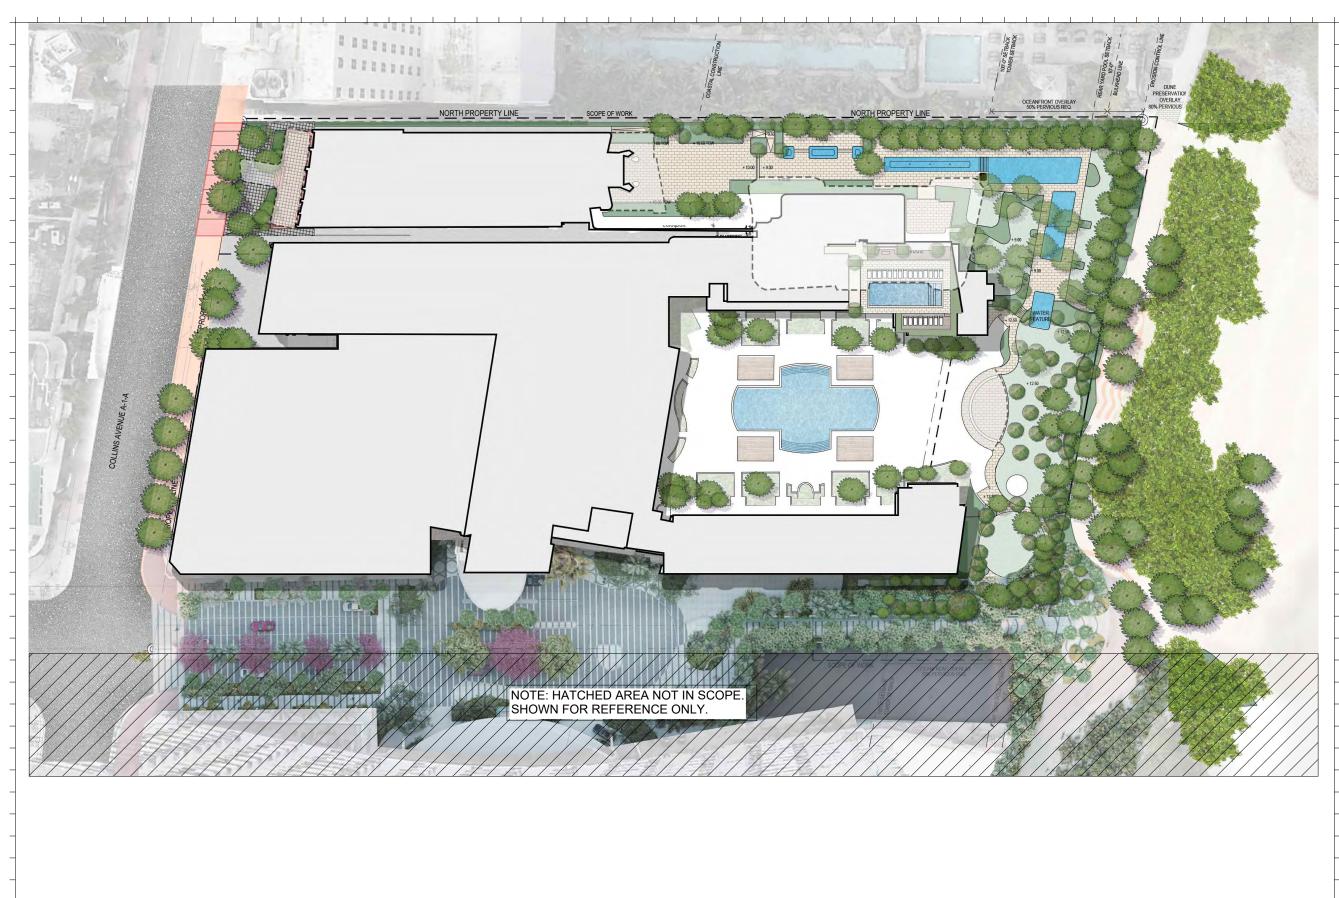
### COVER SHEET

05-08-2023 Sheet No. Date Scale NTS L-0.00 Project Ritz Sagamore

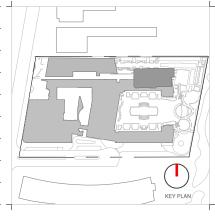
Sagamore Ritz				
1 Lincoln Road Miami Beach, FL 33	139			
CITY OF MIAMI BEACH				
LANDSCAPE LEGEND				
INFORMATION REQUIRED TO BE PERMANENTLY AFFIXED TO PLANS Zoning District <u>RM-3</u> Lot Area <u>207,612 SF</u> Acres <u>4.76</u>				
OPEN SPACE	REQUIRED/ ALLOWED	PROVIDED		Rev. Date Rev. Date
A. Square feet of required Open Space as indicated on site plan:	ALLOWED	THOUDED		-
207,612 sq. ft. x 30%	62,284 SF Required	44,124 SF		
B. Square feet of parking lot open space required as indicated on site plan:	,	,		-
Number of parking spaces <u>n/a</u> x 10 s.f. parking space = C. Total square feet of landscaped open space required: A+B=	n/a 62,284 SF Required	n/a 44,124 SF		
C. Total square reet of landscaped open space required. A+b-	02,284 SF Required	<u>44,124 JI</u>		ALL DRAWINGS AND WRITTEN MATERIAL APPEARING HEREIN CONSTITUTE THE ORIGINAL AND UNPUBLISHED WORK OF KODI KARP AIA, AND MAY NOT BE CURJUCATED, USED, OR DISCLOSED WITHOUT THE EXPRESS WRITTEN CONSINT OF
LAWN AREA CALCULATION				KOBI KARP ARCHITECTURE & INTERIOR DESIGN, INC. AIA. (q) 2020
A. Square feet of landscaped open space required	62,284 SF Required	20,217 SF		_
B. Maximum lawn area (sod) permitted= <u>30% x</u> 62,284 SF	18,685 SF Allowed	10,624 SF		
A. Number of trees required per lot or net lot acre, less existing number of				– Ritz-Sagamore
trees meeting minimum requirements:		100 7 12		1 Lincoln Road — Miami Beach, FL 33139
(28) trees required per acre - (0) existing trees =		160 Trees / 3 Palms (		_
	134	Additionally 112 Ex. Palms		
B. % Natives required:				Owner: — Name Di Lido Beach Resort LLC. Address EBJ Sagamore LLC.
(134) Number of trees provided x 30% =				Address ED Sagainore LLC. Tel: Sobe Sky Development LLC. Email
	41	100		Consultant: Name STUDIO MUNGE. Address 25 Wingold Avenue,
C. % Low maintenance / drought and salt tolerant required:	41	160		Address Toronto, ON Canada M6B 1P8 — Tel: 416.588.1668 Email
(134) Number of trees provided x 50%=	67	160		Consultant: Name LANDSCAPE ARCHITECT Address Naturalficial.
D. Street Trees (maximum average spacing of 20' o.c.)		16 *See		Address 6915 Red Road, Suite 224 Address Coral Gables, FL 33143 Tel: 786.717.6564
<u>658'</u> linear feet along street divided by 20'=	33	Additional ROW Plan		Consultant: MEP Name MG Engineering. Address 6915 Red Road, Suite 224
E. Street tree species allowed directly beneath power lines:				Address 6915 Red Road, Suite 224     Address 2800 Biscayne Bivd     Tel: Miami, FL, 33137     Email 305.755.3833
(maximum average spacing of 20' o.c.):				Consultant:
<u>n/a</u> linear feet along street divided by 20'=	n/a	n/a		Address Desimore Consulting Engineering Address 800 Brickell Avenue, 6th Floor Tel: Miami, FL 33131 Email 305.441.0755
				Architect of Record:
SHRUBS				Kobi Karp Architecture and Interior Design, Inc. 571 NW 28TH ST Miami, Florida 33137 USA Tel: +1(305) 573 1818 Even: +1(305) 573 2766
A. Number of shrubs required:				Fax: +1(305) 573 3766 
(134) Sum of lot trees required $x$ 12=	1,608	1,616		_
B. % Native shrubs required:				-
(1,608) Number of shrubs provided x 50%=	804	804	-	– Peter Anselmo
LARGE SHRUBS OR SMALL TREES			TAL	- R.L.A. FL #6667221
A. Number of large shrubs or small trees required:			SUBMITTAL	- SITE TABULATIONS
(1,608) Number of required shrubs x 10%=	161	201	UBI	
B. % Native large shrubs or small trees required:				Date 05-08-2023     Sheet No.     Scale NTS     I ∩ ∩∩∧
(161) Number of large shrubs or small trees provided x 50%=	81	201	НРВ	- Scale NTS L-0.00A

NOTE: ALL CALCULATIONS TO BE FINALIZED ON 2ND/FINAL HPB SUBMITTAL.

1







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LANDSCAPE ARCHITECT Naturalficial. 6915 Red Road, Suite 224 Coral Gables, FL 33143 786.717.6564

 Consultant:
 MEP

 Name
 MG Engineering, 6915 Red Road, Suite 224

 Address
 2800 Biscayne Blvd

 Tel:
 Miami, FL, 33137

 Email
 305.755.3833


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Peter Anselmo R.L.A. FL #6667221

### ILLUSTRATIVE SITE PLAN

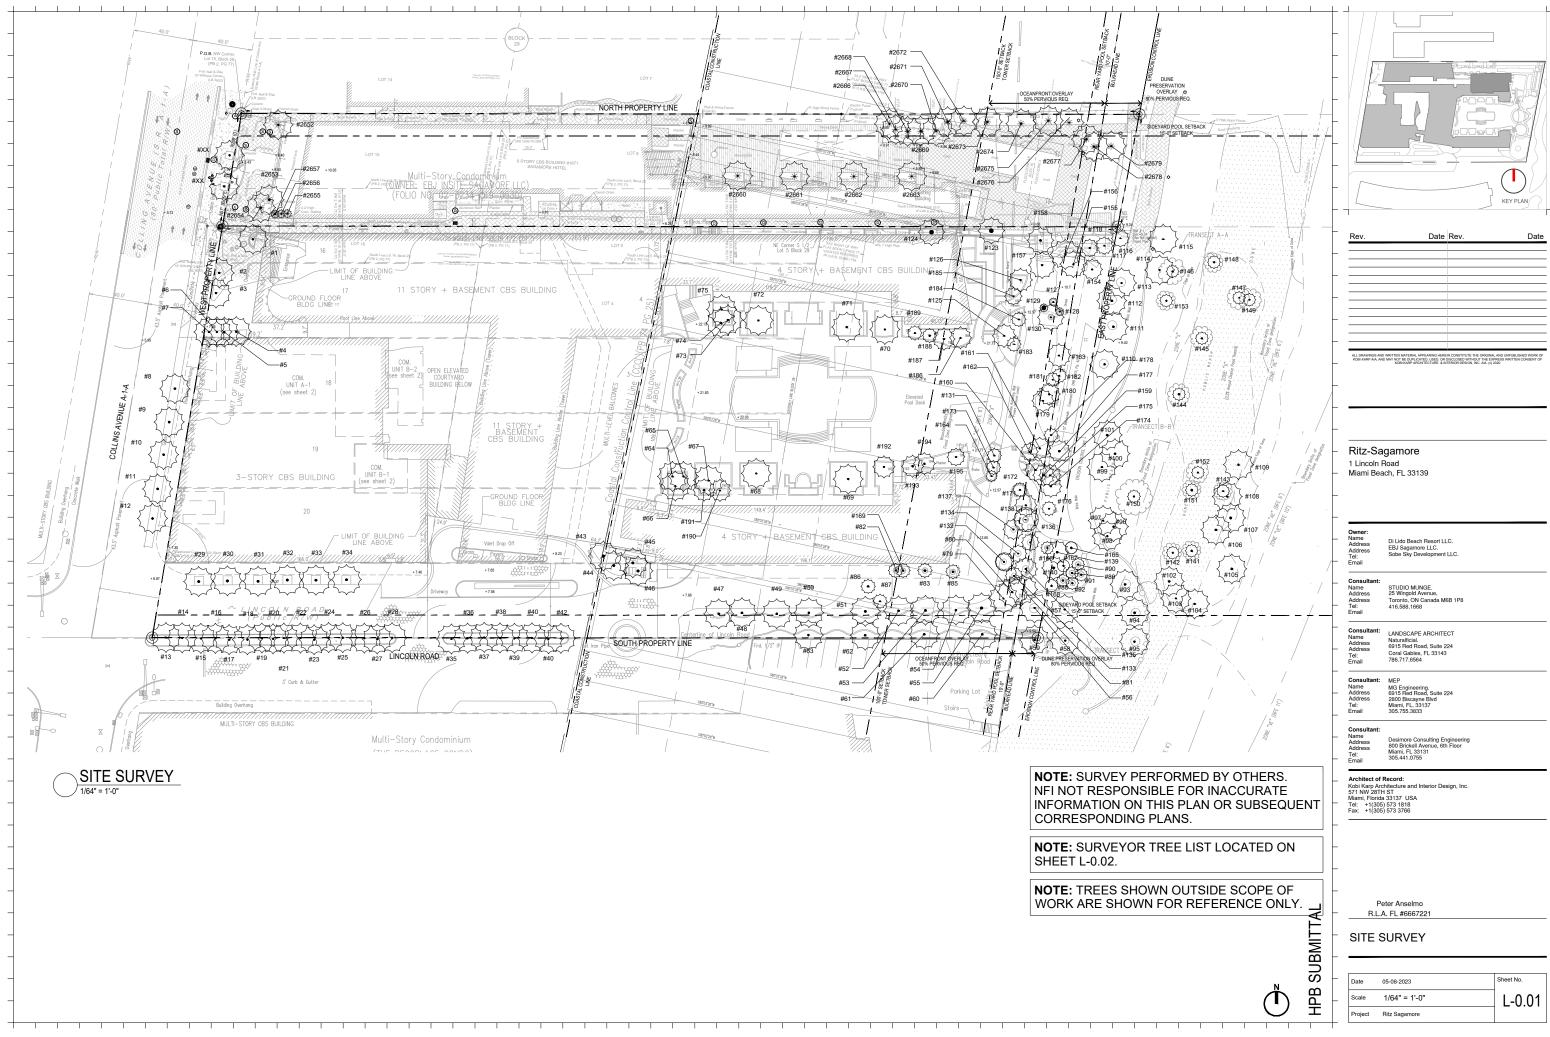Sheet No. Date 05-08-2023 NTS L-0.00B Scale Project Ritz Sagamore



Rev.	Date	Rev.	Date


Tree	Botanical Name	Common Name	Diameter	Height	Canopy
No.	Botanical Name		(Inches)	(Feet)	(Feet)
1	Cocos nucifera	Coconut Palm	0.6	15	20
2	Phoenix Canariensis	Canary Island Palm	1.2	20	22
3	Phoenix Canariensis	Canary Island Palm	1.3	22	22
4 - 7	Cocos nucifera	Coconut Palm	0.5	12	20
8 - 11	Cocos nucifera	Coconut Palm	0.7	30	20
12	Cocos nucifera	Coconut Palm	0.7	25	20
13	Cocos nucifera	Coconut Palm	0.7	20	20
14 - 16	Cocos nucifera	Coconut Palm	0.7	22	20
17	Cocos nucifera	Coconut Palm	0.6	18	20
18 - 20	Cocos nucifera	Coconut Palm	0.6	20	20
21	Cocos nucifera	Coconut Palm	0.6	18	20
22	Cocos nucifera	Coconut Palm	0.6	20	20
23	Cocos nucifera	Coconut Palm	0.7	22	20
24 - 28	Cocos nucifera	Coconut Palm	0.7	22	20
29 - 34	Phoenix Canariensis	Canary Island Palm	1.3	22	20
35	Cocos nucifera	Coconut Palm	0.6	30	20
36 - 37	Cocos nucifera	Coconut Palm	0.6	25	20
38 - 39	Cocos nucifera	Coconut Palm	0.6	20	20
40	Cocos nucifera	Coconut Palm	0.6	22	20
41	Cocos nucifera	Coconut Palm	0.6	18	20
42	Cocos nucifera	Coconut Palm	0.7	20	20
43, 44, 46	Cocos nucifera	Coconut Palm	0.6	25	20
45	Cocos nucifera	Coconut Palm	0.6	18	20
47 - 49	Phoenix Canariensis	Canary Island Palm	23	22	20
50 - 63	Phoenix Canariensis	Canary Island Palm	14	25	20
64, 65	Cocos nucifera	Coconut Palm	0.7	25	20
66	Cocos nucifera	Coconut Palm	0.7	20	20
67	Cocos nucifera	Coconut Palm	0.7	20	20
68, 69	Phoenix Canariensis	Canary Island Palm	1.3	25	20
70	Cocos nucifera	Coconut Palm	0.7	22	20
71, 72	Phoenix Canariensis	Canary Island Palm	1.3	25	20
73, 75	Cocos nucifera	Coconut Palm	0.7	30	20
74	Cocos nucifera	Coconut Palm	0.7	22	20
79 - 82	Cocos nucifera	Coconut Palm	0.7	20	20
83 - 87	Unknown to Surveyor	Unknown to Surveyor	0.5	15	15
145	Cocos nucifera	Coconut Palm	0.8	25	25
139	Cocos nucifera	Coconut Palm	0.7	38	30
140	Cocos nucifera	Coconut Palm	0.7	42	30
141	Cocos nucifera	Coconut Palm	0.6	45	30
142	Cocos nucifera	Coconut Palm	0.7	50	30
143	Cocos nucifera	Coconut Palm	0.7	48	25
144	Cocos nucifera	Coconut Palm	0.6	20	25
146	Cocos nucifera	Coconut Palm	0.7	35	30
147	Cocos nucifera	Coconut Palm	0.8	45	30
148	Cocos nucifera	Coconut Palm	0.8	25	25
149	Cocos nucifera	Coconut Palm	0.8	30	30

Tree	Botanical Name	Common Name	Diameter	Height	Canop
No.	Dotanical Name	Common Name	(Inches)	(Feet)	(Feet
52	Roystonea regia	Royal Palm	16	25	14
53	Roystonea regia	Royal Palm	16	20	14
54	Roystonea regia	Royal Palm	16	22	14
55	Roystonea regia	Royal Palm	16	22	14
79	Thrinax radiata	Florida Thatch Palm	4	12	5
80	Thrinax radiata	Florida Thatch Palm	4	12	5
81	Thrinax radiata	Florida Thatch Palm	4	12	5
82	Washingtonia robusta	Washington Palm	10	35	10
83	Washingtonia robusta	Washington Palm	10	35	10
85	Washingtonia robusta	Washington Palm	10	35	10
88	Cabbage	Cabbage	10	12	14
89	Cabbage	Cabbage	12	12	10
90	Cabbage	Cabbage	12	14	12
91	Cabbage	Cabbage	12	14	12
92	Cabbage	Cabbage	12	14	12
116	Cocos nucifera	Coconut Palm	10	25	12
117	Cocos nucifera	Coconut Palm	8	25	12
118	Cocos nucifera	Coconut Palm	8	25	12
125	Cocos nucifera	Coconut Palm	10	25	16
126	Cocos nucifera	Coconut Palm	10	22	16
127	Cabbage	Cabbage	4	15	6
128	Cabbage	Cabbage	4	12	5
129	Cabbage	Cabbage	4	15	6
130	Cabbage	Cabbage	10	25	18
131	Cocos nucifera	Coconut Palm	10	25	10
132	Cocos nucifera	Coconut Palm	8	25	12
133	Cocos nucifera	Coconut Palm	8	25	12
134	Cocos nucifera	Coconut Palm	8	25	12
135	Cocos nucifera	Coconut Palm	10	30	16
136	Cocos nucifera	Coconut Palm	8	25	12
137	Cocos nucifera	Coconut Palm	10	25	14
138	Cabbage	Cabbage	10	30	16
154	Cocos nucifera	Coconut Palm	7	15	14
155	Cocos nucifera	Coconut Palm	10	20	18
156	Cocos nucifera	Coconut Palm	10	40	20
157	Cocos nucifera	Coconut Palm	9	20	18
158	Cocos nucifera	Coconut Palm	8	30	18
159	Cocos nucifera	Coconut Palm	10	25	16
160	Cocos nucifera	Coconut Palm	10	30	16
161	Cocos nucifera	Coconut Palm	10	30	16
162	Cocos nucifera	Coconut Palm	10	35	12
163	Cocos nucifera	Coconut Palm	10	30	16
164	Cocos nucifera	Coconut Palm Coconut Palm	10	20	8
165	Conocarpus erectus	Silver Button	8	14	4
165	Conocarpus erectus		0 4	14	8
165	Cabbage Conocarpus erectus	Cabbage Silver Button	4 8	16	4
167	Conocarpus erectus	Silver Button	8	14	4
168	Washingtonia robusta	Washington Palm	8 10	35	4

Tree			Diameter	Height	Canopy
No.	Botanical Name	Common Name	(Inches)	(Feet)	(Feet)
171	Cocos nucifera	Coconut Palm	12	15	15
172	Cocos nucifera	Coconut Palm	8	15	10
173	Cocos nucifera	Coconut Palm	8	15	10
174	Cocos nucifera	Coconut Palm	12	15	15
175	Cocos nucifera	Coconut Palm	12	15	15
176	Cocos nucifera	Coconut Palm	8	15	10
177	Cocos nucifera	Coconut Palm	10	15	15
178	Cocos nucifera	Coconut Palm	7	15	10
179	Cocos nucifera	Coconut Palm	8	20	15
180	Cocos nucifera	Coconut Palm	12	15	15
181	Cocos nucifera	Coconut Palm	7	10	10
182	Cocos nucifera	Coconut Palm	7	10	10
183	Cocos nucifera	Coconut Palm	7	10	10
184	Cocos nucifera	Coconut Palm	7	10	10
185	Cocos nucifera	Coconut Palm	8	8	12
186	Cocos nucifera	Coconut Palm	7	20	15
187	Cocos nucifera	Coconut Palm	12	20	15
188	Cocos nucifera	Coconut Palm	12	25	10
189	Cocos nucifera	Coconut Palm	8	20	10
190	Cocos nucifera	Coconut Palm	8	30	15
191	Cocos nucifera	Coconut Palm	8	30	15
192	Cocos nucifera	Coconut Palm	8	15	15
193	Cocos nucifera	Coconut Palm	8	20	15
194	Cocos nucifera	Coconut Palm	12	15	15
195	Cocos nucifera	Coconut Palm	8	15	12

TREE	COMMON	D.B.HHE	IGHT SPRI	AD
NUMBER	NAME	(INCHES)	(FEET) (F	FEET)
2652	Coconut Palm	12	25	20
2653	Coconut Palm	12	35	20
2654	Coconut Palm	12	25	20
2655	Fan Palm	12	4	6
2656	Fan Palm	12	10	6
2657	Fan Palm	12	4	10
2660	Coconut Palm	12	30	20
2661	Coconut Palm	12	35	20
2662	Coconut Palm	12	32	22
2663	Coconut Palm	12	35	20
2666	Coconut Palm	9	38	24
2667	Coconut Palm	10	35	24
2668	Coconut Palm	9	35	24
2669	Coconut Palm	8	28	24
2670	Coconut Palm	8	30	24
2671	Coconut Palm	9	30	20
2672	Coconut Palm	11	25	24
2673	Coconut Palm	12	30	18
2674	Coconut Palm	10	28	20
2675	Coconut Palm	7	25	16
2676	Coconut Palm	8	24	14
2677	Coconut Palm	7	20	18
2678	Coconut Palm	7	20	16
2679	Coconut Palm	8	18	16

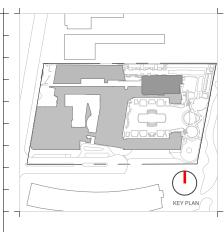1



Rev.	Date	Rev.	Date

Ritz-Sagamore 1 Lincoln Road Miami Beach, FL 33139

# Owner: Name Address Address Tel: Email

Di Lido Beach Resort LLC. EBJ Sagamore LLC. Sobe Sky Development LLC.

Consultant: Name Address Address Tel: Email STUDIO MUNGE. 25 Wingold Avenue, Toronto, ON Canada M6B 1P8 416.588.1668

Consultant: Name LANDSCAPE ARCHITECT Address Address 6915 Red Road, Suite 224 Coral Gables, FL 33143 Email 786.717.6564

Consultant: MEP Name MG Engineering. Address 6915 Red Road, Suite 224 Address 2800 Biscayne Blvd Tel: Miami, FL, 33137 Email 305.755.3833

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Desimore Consulting Engineering 800 Brickell Avenue, 6th Floor Miami, FL 33131 305.441.0755

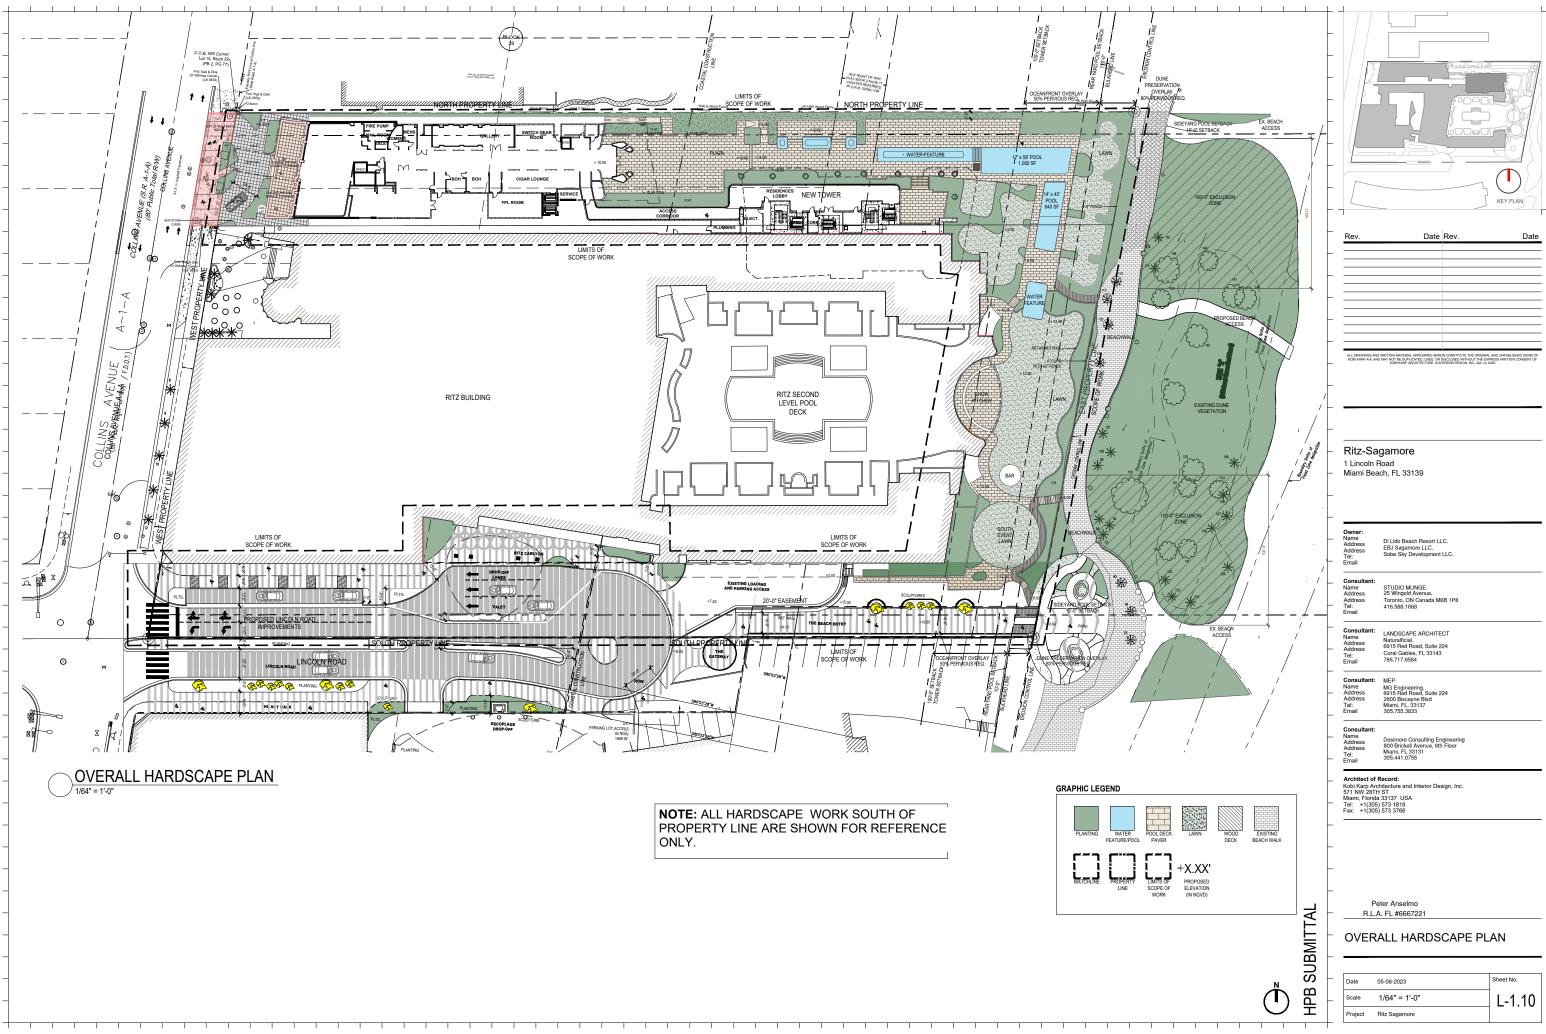
Architect of Record: Kobi Karp Architecture and Interior Design, Inc. 571 NW 28TH ST Miami, Florida 33137 USA Teit: +1(305) 573 1818 Fax: +1(305) 573 3766

Peter Anselmo R.L.A. FL #6667221

### SITE SURVEY TREE LIST


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Scale	NTS	L-0.02
Project	Ritz Sagamore	


# NOTE: TREES SHOWN OUTSIDE SCOPE OF WORK ARE SHOWN FOR REFERENCE ONLY.



Rev.	Date	Rev.	Date

Date	05-08-2023	Sheet No.
Scale	1/64" = 1'-0"	L-1.10
Project	Ritz Sagamore	

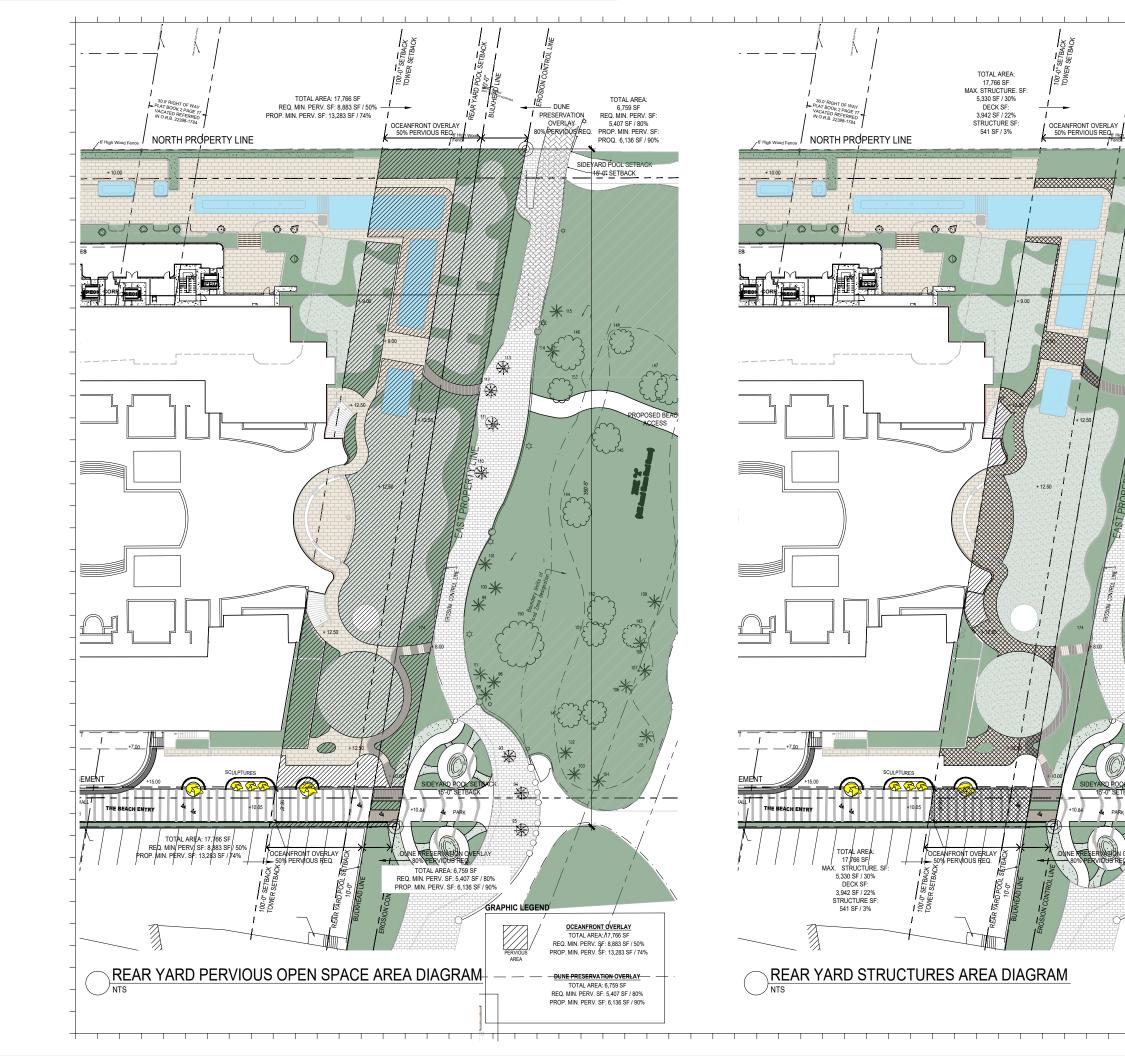

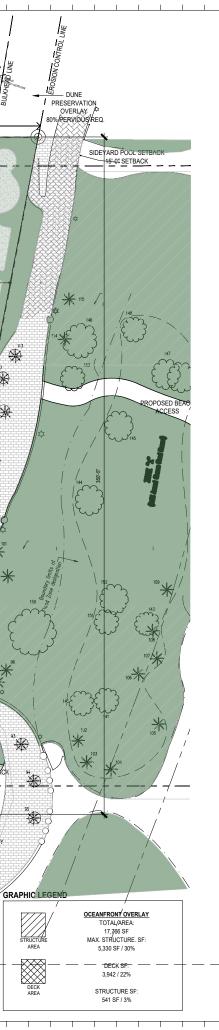

ETBA

18 REAR VARD PC

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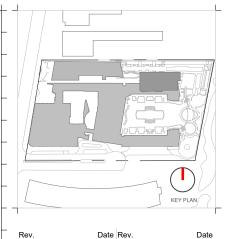
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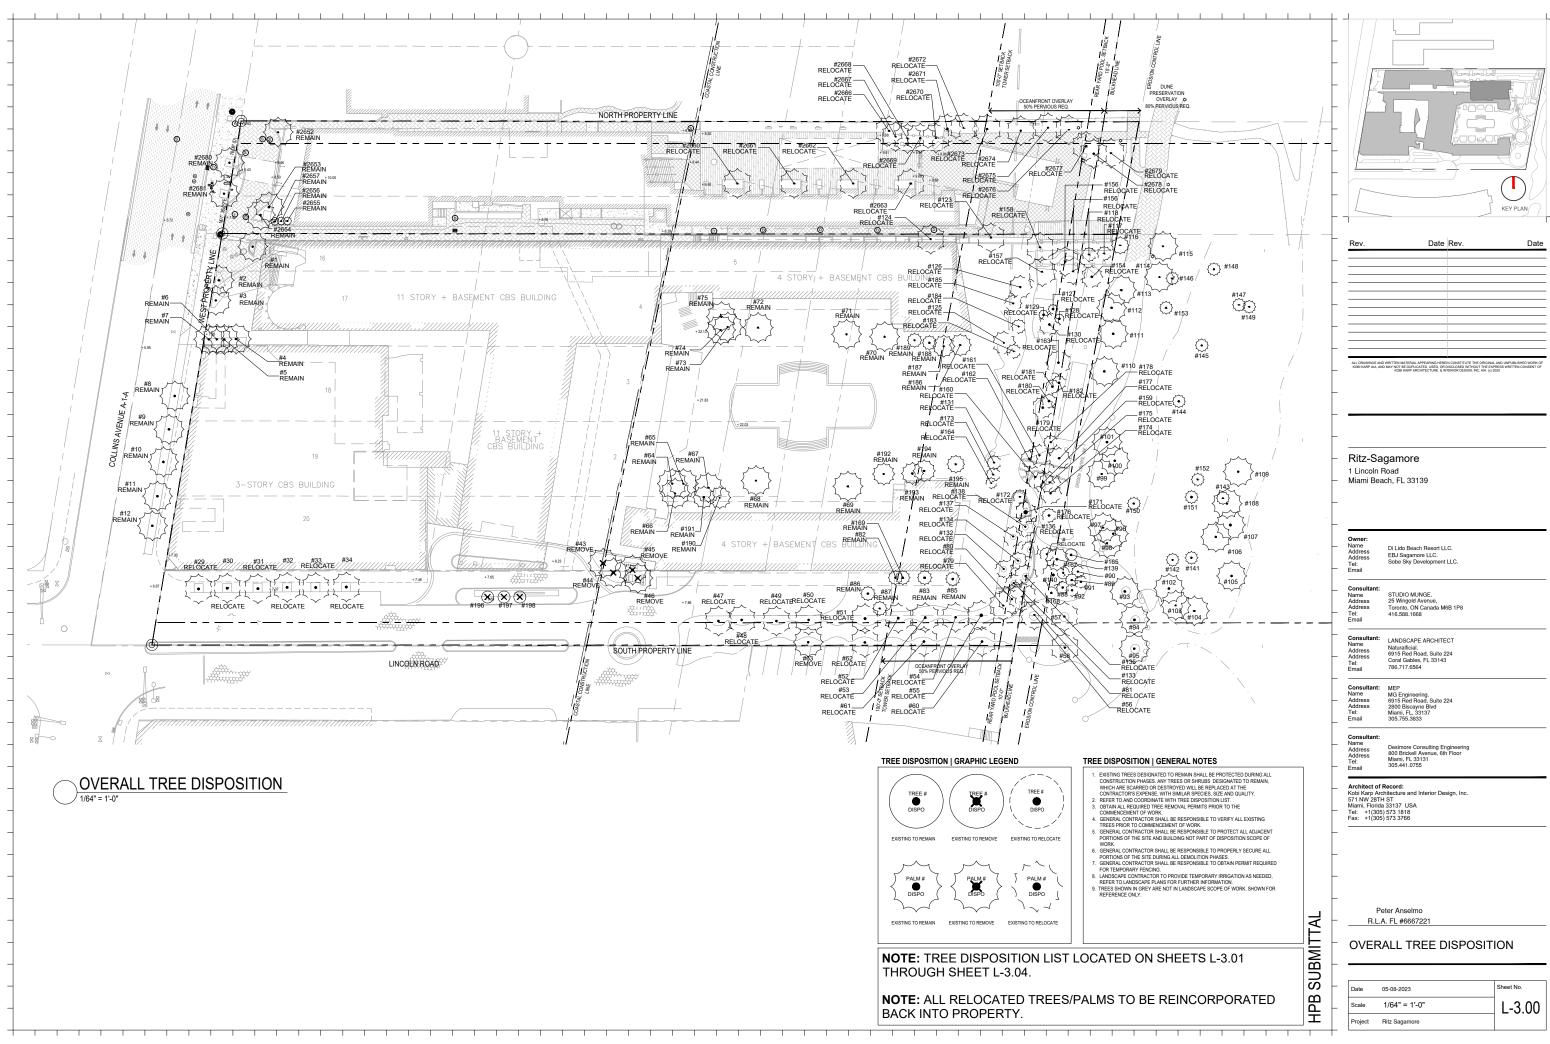
### Peter Anselmo

R.L.A. FL #6667221


### REAR YARD HARDSCAPE AREA DIAGRAM

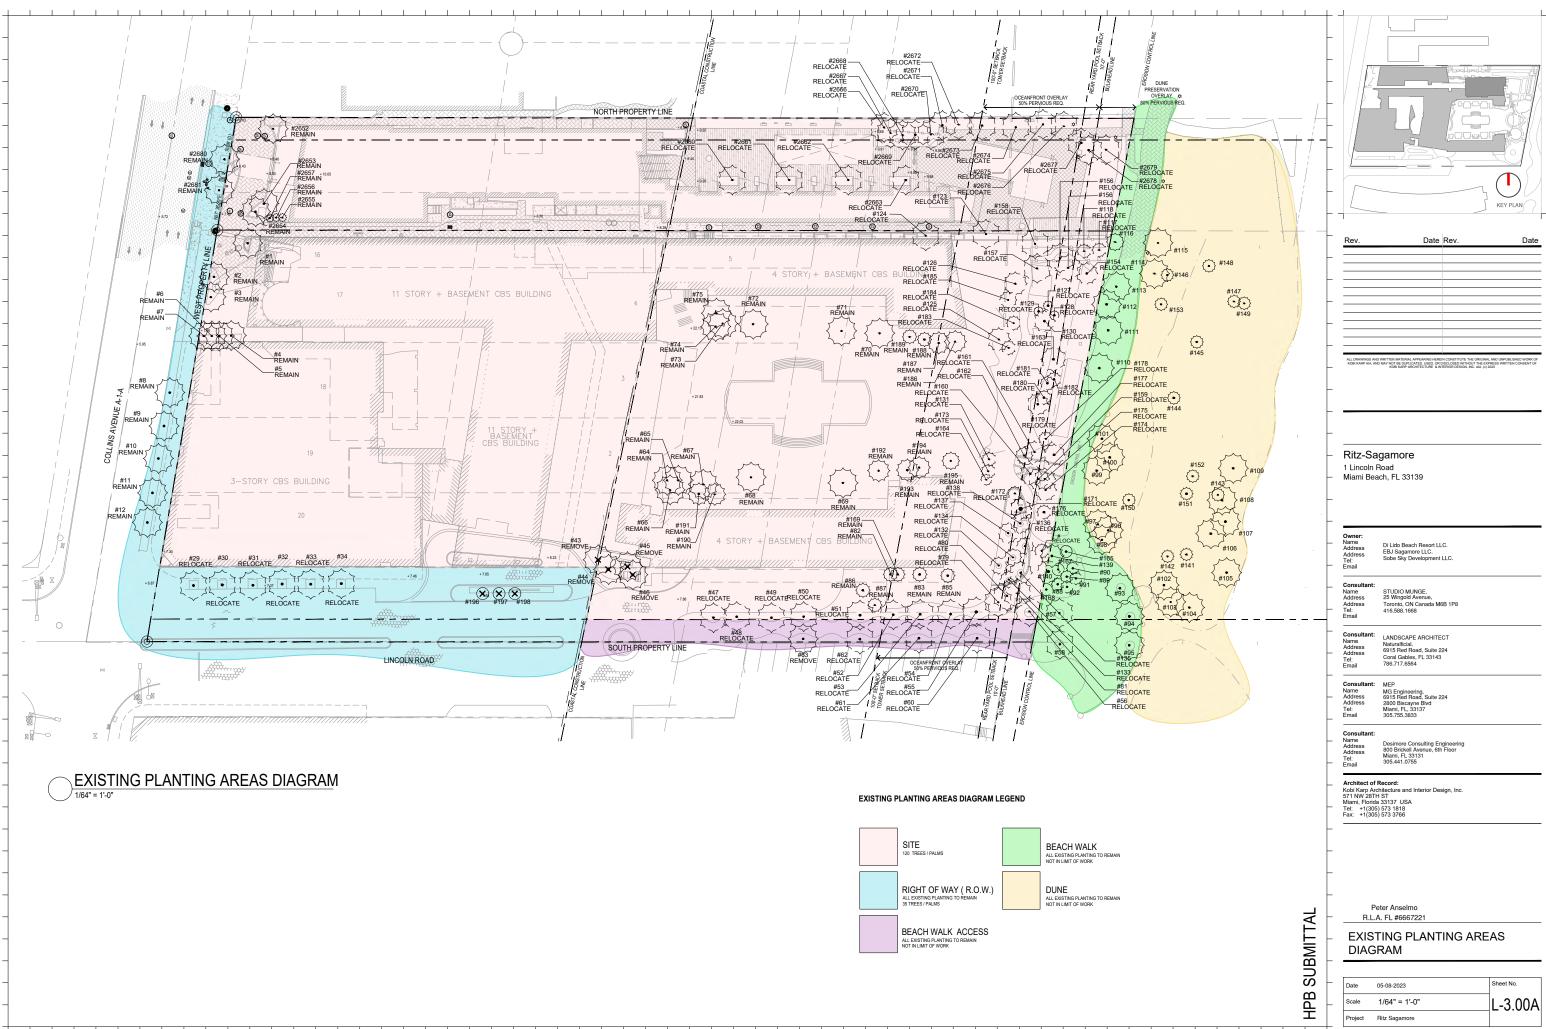Date	05-08-2023	Sheet No.
Scale	NTS	L-1.11
Project	Ritz Sagamore	

**SUBMITTAI** НРВ



Rev.	Date	Rev.	Date



Rev.	Date	Rev.	Date


Date	05-08-2023	Sheet No.
Scale	1/64" = 1'-0"	L-3.00A
Project	Ritz Sagamore	

					0.75			Dispess		MITIGATION
<u>(EY #</u>	<u>ABRV.</u>	BOTANICAL NAME	COMMON NAME		<u>SIZE</u>		LOCATION	DISPOSI	TION RELOCATE	REQ'D
				DBH. (IN.)	HT. (FT.)	SPD. (FT.)		REMAIN REMOV		
1	CNU	Cocos nucifera	Coconut Palm	0.6	15	20	Site	x		No
2	PCA	Phoenix canariensis	Canary Island Date Palm	1.2	20	22	Site	x		No
3	PCA	Phoenix canariensis	Canary Island Date Palm	1.3	22	22	Site	X		No
4	CNU	Cocos nucifera	Coconut Palm	0.5	12	22	Site	X		No
5	CNU	Cocos nucifera	Coconut Palm	0.5	12	22	Site	X		No
6	CNU	Cocos nucifera	Coconut Palm	0.5	12	22	Site	x		No
7	CNU	Cocos nucifera	Coconut Palm	0.5	12	22	Site	X		No
8	CNU	Cocos nucifera	Coconut Palm	0.7	30	20	ROW	X		No
9	CNU	Cocos nucifera	Coconut Palm	0.7	30	20	ROW	X		No
10	CNU	Cocos nucifera	Coconut Palm	0.7	30	20	ROW	X		No
11	CNU	Cocos nucifera	Coconut Palm	0.7	30	20	ROW	X		No
12	CNU	Cocos nucifera	Coconut Palm	0.7	25	20	ROW	X		No
17	CNU	Cocos nucifera	Coconut Palm	7.2	18	20	ROW		X	No
19	CNU	Cocos nucifera	Coconut Palm	7.2	20	20	ROW		X	No
21	CNU	Cocos nucifera	Coconut Palm	7.2	18	20	ROW		X	No
23	CNU	Cocos nucifera	Coconut Palm	8.4	22	20	ROW		X	No
25	CNU	Cocos nucifera	Coconut Palm	8.4	22	20	ROW		X	No
27	CNU	Cocos nucifera	Coconut Palm	8.4	22	20	ROW		X	No
29	PCA	Phoenix canariensis	Canary Island Date Palm	15.6	22	20	ROW		X	No
30	PCA	Phoenix canariensis	Canary Island Date Palm	15.6	22	20	ROW		X	No
31	PCA	Phoenix canariensis	Canary Island Date Palm	15.6	22	20	ROW		X	No
32	PCA	Phoenix canariensis	Canary Island Date Palm	15.6	22	20	ROW		X	No
33	PCA	Phoenix canariensis	Canary Island Date Palm	15.6	22	20	ROW		X	No
34	PCA	Phoenix canariensis	Canary Island Date Palm	15.6	22	20	ROW		X	No
43	CNU	Cocos nucifera	Coconut Palm	8.4	25	20	Site	X		Yes
44	CNU	Cocos nucifera	Coconut Palm	8.4	25	20	Site	X		Yes
45	CNU	Cocos nucifera	Coconut Palm	8.4	18	20	Site	X		Yes
46	CNU	Cocos nucifera	Coconut Palm	8.4	25	20	Site	X		Yes
47	PCA	Phoenix canariensis	Canary Island Date Palm	23	22	20	Site		X	No
48	PCA	Phoenix canariensis	Canary Island Date Palm	23	22	20	Site		X	No
49	PCA	Phoenix canariensis	Canary Island Date Palm	23	22	20	Site		X	No
50	PCA	Phoenix canariensis	Canary Island Date Palm	14	25	20	Site		X	No
51	PCA	Phoenix canariensis	Canary Island Date Palm	14	25	20	Site		X	No
52	PCA	Phoenix canariensis	Canary Island Date Palm	14	25	20	Site		X	No
53	PCA	Phoenix canariensis	Canary Island Date Palm	14	25	20	Site		X	No
54	PCA	Phoenix canariensis	Canary Island Date Palm	14	25	20	Site		X	No
55	PCA	Phoenix canariensis	Canary Island Date Palm	14	25	20	Site		X	No
56	PCA	Phoenix canariensis	Canary Island Date Palm	14	25	20	Site		X	No

Rev.	Date Rev. D
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Owner: Name Address Address Tel: Email	Di Lido Beach Resort LLC. EBJ Sagamore LLC. Sobe Sky Development LLC.
Name Address Address Tel:	EBJ Sagamore LLC.
Name Address Address Tel: Email Consultant: Name Address Address Tel: Email Consultant: Name	EBJ Sagamore LLC. Sobe Sky Development LLC. STUDIO MUNGE. 25 Wingold Avenue, Toronto, ON Canada M6B 1P8 416.588.1668
Name Address Address Tel: Email Consultant: Name Address Address Tel: Email Consultant:	EBJ Sagamore LLC. Sobe Sky Development LLC. STUDIO MUNGE: 25 Wingold Avenue, Toronto, ON Canada M6B 1P8 416.588,1668
Name Address Address Tel: Email Consultant: Name Address Address Address Address Address Address Address Address Consultant: Name Consultant:	EBJ sagamore LLC. Sobe Sky Development LLC. STUDIO MUNGE: 25 Wingold Avenue, Toronic, ON Canada M6B 1P8 416.588,1668 LANDSCAPE ARCHITECT Naturalicial. 6915 Rod Road, Suite 224 Coral Gables, FL33143 786.717.6564
Name Address Address Tel: Email Consultant: Name Address Address Tel: Email Consultant: Name Address Tel: Email Consultant:	EBJ Sagamore LLC. Sobe Sky Development LLC. STUDIO MUNGE. 25 Wingold Avenue, Toronto, ON Canada M6B 1P8 416.588.1688 LANDSCAPE ARCHITECT Naturalicial. 6915 Facl Road, Suite 224 Coral Gables, FL 33143 786.717.6564
Name Address Address Address Address Consultant: Name Address	EBJ Sagamore LLC. Sobe Sky Development LLC. 25 Wingold Avenue, Toronic, ON Canada M6B 1P8 416.588,1666 LANDSCAPE ARCHITECT Naturallical. Coral Gables, FL 33143 766.717.6564 MEP MG Engineering, 9015 Fied Food. Suite 224 2000 Biscayne Blvd Mami, FL, 33192
Name Address Address Address Address Address Address Tel: Email Consultant: Name Address Address Address Address Address Tel: Email Consultant: Name Address Addres Addres Add	EBJ sagamore LLC. Sobe Sky Development LLC. 25 Wingold Avenue, Toronic, ON Canada M6B 1P8 416.588,1666 LANDSCAPE ARCHITECT Naturalical. Coral Gables, FL 33143 766.717.6564 MEP MG Engineering. 9015 Rod Rod. Suite 224 2000 Bicayne Blvd Mami, FL 33137 305.755.3833
Name Address Address Address Address Address Tel: Email Consultant: Name Address Address Address Address Address Tel: Email Consultant: Name Address Addres Address Address Ad	EBJ sagamore LLC. Sobe Sky Development LLC. STUDIO MUNGE. 25 Wingold Avenue, Toronte, ON Canada M6B 1P8 416.588.1668 LANDSCAPE ARCHITECT Naturalicial. 915 Fred Foad, Suite 224 Coral Gables, FL 33143 786.717.6564 MEP MG Englinearing. MGE Englinearing. MGE Englinearing. 930 Brickle Avenue, 6th Floor Miami, FL 33197 305.755.3833 Desimore Consulting Englineering 800 Brickle Avenue, 6th Floor Miami, FL 33131 305.441.0755 Record: hitecture and Interior Design, Inc. 1 ST 33137 USA ) 573 1818 ) 573 3766
Name Address Address Address Address Address Tel: Email Consultant: Name Address Address Address Address Address Address Address Address Address Address Address Address Address Address Address Tel: Email Consultant: Name Address Addres Addre	EBJ Sagamore LLC. Sobe Sky Development LLC. STUDIO MUNGE. 25 Wingold Avenue, Toronic, ON Canada M6B 1P8 416.588, 1666 LANDSCAPE ARCHITECT Naturalical. Naturalical. 8015 Red Read, Suite 224 Coral Gables, FL 33143 786.717.6564 MEP MG Engineering, 9015 Red Read, Suite 224 2800 Bickeyne Blvd Mami, FL, 33137 305.755.3833 Desimore Consulting Engineering 305.441.0755 Record: hitecture and Interior Design, Inc. 4 ST 33157 USA (577 1816) (577 3766
Name Address Address Address Address Address Tel: Email Consultant: Name Address Address Address Address Address Address Address Address Address Address Address Address Address Address Address Tel: Email Consultant: Name Address Addres Addre	EBJ Sagamore LLC. Sobe Sky Development LLC. STUDIO MUNGE: 25 Wingold Avenue, Toronic, ON Canada M6B 1P8 416.588.1688 LANDSCAPE ARCHITECT Naturalicial. 6915 FRed Road, Suite 224 Coral Gables, FL 33143 786.717.6564 MEP MCE Engineering. 6915 FRed Road, Suite 224 2800 Biscayne Bivd Mamir, FL 331/37 305.745.3833 Desimon Consulting Engineering 690 Dirixell Avenue, 6th Floor Mamir, FL 331/37 305.441.0755 Record: 157 3 3786 eter Anselmo A. FL #6667221 DISPOSITION LIST
Name Address Address Address Address Address Address Email Consultant: Name Address Address Address Address Address Address Address Tel: Email Consultant: Name Address Address Tel: Email Consultant: Name Address Tel: Email Consultant: Name Email Consultant: Name Address Tel: Email Consultant: Name Address Tel: Email Consultant: Name Address Tel: Email Consultant: Name Address Tel: Email Consultant: Name Address Tel: Email Consultant: Name Address Tel: Email Consultant: Name Address Tel: Email Consultant: Name Address Tel: Email Consultant: Name Email Consultant: Name Address Tel: Email Consultant: Name Address Tel: Email Consultant: Name Email Consultant: Tel: Email Consultant: Tel: Email Consultant: Name Address Tel: Email Consultant: Name Address Tel: Email Consultant: Name Address Tel: Email Consultant: Name Consultant: Name Consultant:	EBJ sagamore LLC. Sobe Sky Development LLC. STUDIO MUNGE: 25 Wingold Averue, Toronic, ON Canada M6B 1P8 416.588.1688 LANDSCAPE ARCHITECT Naturalicial 6915 FR dR hoad, Suite 224 Coral Gables, FL 3143 786.717.6564 MEP MGE Engineering, 6915 FR dR hoad, Suite 224 2800 Biscayne Blvd Mami, FL, 33137 305.755.3833 Desimore Consulting Engineering 800 Bickoll Avenue, 6th Floor Mami, FL 33137 305.451.0755 Record: hitecture and Interior Design, Inc. 157 31337 USA 1573 3766

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	ם ר ד

60	PCA	Phoenix canariensis	Canary Island Date Palm	14	25	20	Beach Walk Access			x	No
51	PCA	Phoenix canariensis	Canary Island Date Palm	14	25	20	Beach Walk Access			x	No
62	PCA	Phoenix canariensis	Canary Island Date Palm	14	25	20	Beach Walk Access			x	No
63	PCA	Phoenix canariensis	Canary Island Date Palm	14	25	20	Beach Walk Access		x		Yes
64	CNU	Cocos nucifera	Coconut Palm	8.4	25	20	Site	x			No
65	CNU	Cocos nucifera	Coconut Palm	8.4	25	20	Site	x	·		No
66	CNU	Cocos nucifera	Coconut Palm	8.4	20	20	Site	х			No
67	CNU	Cocos nucifera	Coconut Palm	8.4	20	20	Site	х			No
68	PCA	Phoenix canariensis	Canary Island Date Palm	15.5	25	20	Site	х	1		No
69	PCA	Phoenix canariensis	Canary Island Date Palm	15.5	25	20	Site	х			No
70	CNU	Cocos nucifera	Coconut Palm	8.4	22	20	Site	х	1	1	No
71	PCA	Phoenix canariensis	Canary Island Date Palm	1.3	25	20	Site	x			No
72	PCA	Phoenix canariensis	Canary Island Date Palm	1.3	25	20	Site	x			No
73	CNU	Cocos nucifera	Coconut Palm	0.7	30	20	Site	x			No
74	CNU	Cocos nucifera	Coconut Palm	0.7	22	20	Site	X			No
75	CNU	Cocos nucifera	Coconut Palm	0.7	30	20	Site	X			No
76	-		Not Locat	ed on Survey		-	<u></u>			x	No
77			Not Locat	ed on Survey						x	No
78			Not Locat	ed on Survey	-		1			x	No
79	CNU	Cocos nucifera	Coconut Palm	0.7	20	20	Site			x	No
80	CNU	Cocos nucifera	Coconut Palm	0.7	20	20	Site			x	No
81	CNU	Cocos nucifera	Coconut Palm	0.7	20	20	Site		L	x	No
82	CNU	Cocos nucifera	Coconut Palm	0.7	20	20	Site	x			No
83	CNU	Cocos nucifera	Coconut Palm				Site	x			No
84			Not Locat	ed on Survey						x	No
85	CNU	Cocos nucifera	Coconut Palm				Site	x			No
86	CNU	Cocos nucifera	Coconut Palm				Site	х			No
87	CNU	Cocos nucifera	Coconut Palm	1			Site	x	1	6 · · · · · ·	No
88	SPA	Sabal palmetto	Cabbage Palm	10	12	14	Beach Walk			x	No
89	SPA	Sabal palmetto	Cabbage Palm	12	12	10	Beach Walk			x	No
90	SPA	Sabal palmetto	Cabbage Palm	12	14	12	Beach Walk			x	No
91	SPA	Sabal palmetto	Cabbage Palm	12	14	12	Beach walk			x	No
92	SPA	Sabal palmetto	Cabbage Palm	12	14	12	Beach Walk			x	No
93	-		Unknown to Surveyor				Dune	х			No
94			Unknown to Surveyor				Dune	x			No
95			Unknown to Surveyor				Dune	х	1		No
96			Unknown to Surveyor				Dune	х			No
97			Unknown to Surveyor				Dune	х			No
98			Unknown to Surveyor				Dune	x			No
99	-		Unknown to Surveyor				Dune	х	1		No
100			Unknown to Surveyor				Dune	x			No
101			Unknown to Surveyor				Dune	х			No
102			Unknown to Surveyor				Dune	х			No
103			Unknown to Surveyor				Dune	x			No
104			Unknown to Surveyor				Dune	x			No
105			Unknown to Surveyor				Dune	x			No
106			Unknown to Surveyor				Dune	x	in the second	and produced in	No
107	1		Unknown to Surveyor		1111111		Dune	x			No
108			Unknown to Surveyor				Dune	x			No
109			Unknown to Surveyor				Dune	x			No
110			Unknown to Surveyor				Beach Walk	x			No
111			Unknown to Surveyor				Beach Walk	x			No
112			Unknown to Surveyor				Beach Walk	x	1		No
113			Unknown to Surveyor				Beach Walk	x	1		No
114			Unknown to Surveyor				Dune	x	1		No
115			Unknown to Surveyor	S. A. Ph. 1			Dune	x			No
116	CNU	Cocos nucifera	Coconut Palm	10	25	12	Beach Walk	x			No
117	CNU	Cocos nucifera	Coconut Palm	8	25	12	Site		1	x	No
118	CNU	Cocos nucifera	Coconut Palm	8	25	12	Site			x	No
	0110	0000011001010	The second se		20	14	One			^	140

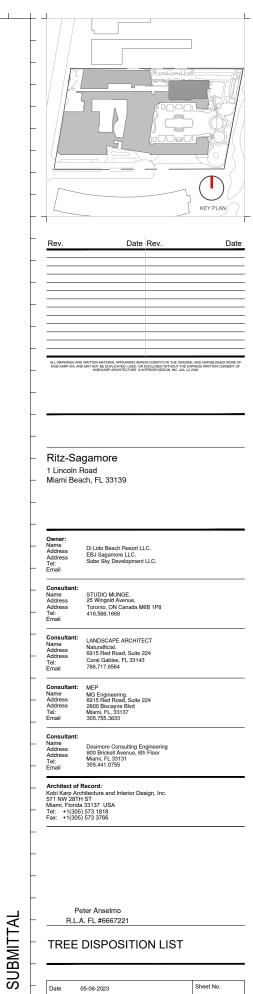


НРВ

Scale NTS

Project Ritz Sagamore

L-3.02

117	CNU	Cocos nucifera	Coconut Palm	8	25	12	Site		x	No
118		Cocos nucifera	Coconut Palm	8	25	12	Site		X	No
119			Not Located on Survey	0		12	Oile		x	No
120			Not Located on Survey						x	No
121			Not Located on Survey						x	No
122			Not Located on Survey						x x	No
122	CNU	Cocos nucifera	Coconut Palm				Site		x	No
123		Cocos nucifera	Coconut Palm				Site		x	No
			Coconut Palm	10	25	10	Site			
125 126		Cocos nucifera Cocos nucifera	Coconut Palm	10	25 22	16 16	Site		x	No No
			Cabbage Palm							
127	SPA	Sabal palmetto		4	15	6	Site		X X	No
128	SPA	Sabal palmetto	Cabbage Palm	4	12	5	Site		X X	No
129	SPA	Sabal palmetto	Cabbage Palm	4	15	6	Site		X	No
130	SPA	Sabal palmetto	Cabbage Palm	10	25	18	Site		X	No
131		Cocos nucifera	Coconut Palm	10	25	10	Site		X	No
132		Cocos nucifera	Coconut Palm	8	25	12	Site		X	No
133	CNU	Cocos nucifera	Coconut Palm	8	25	12	Site		X	No
134	CNU	Cocos nucifera	Coconut Palm	8	25	12	Site		X	No
135	CNU	Cocos nucifera	Coconut Palm	10	30	16	Site		X	No
136	CNU	Cocos nucifera	Coconut Palm	8	25	12	Site		X	No
137	CNU	Cocos nucifera	Coconut Palm	10	25	14	Site		X	No
138	SPA	Sabal palmetto	Cabbage Palm	10	30	16	Site		X	No
139			Unknown to Surveyor				Beach Walk	X		No
140			Unknown to Surveyor				Beach Walk		x	No
141			Unknown to Surveyor				DUNE	x		No
142			Unknown to Surveyor				DUNE	x		No
143			Unknown to Surveyor				DUNE	X		No
144			Unknown to Surveyor				DUNE	X		No
145			Unknown to Surveyor				DUNE	х		No
146	Unknown to Surveyor					DUNE	x		No	
147			Unknown to Surveyor				DUNE	X		No
148			Unknown to Surveyor				DUNE	X		No
149			Unknown to Surveyor				DUNE	X		No
150			Unknown to Surveyor				DUNE	X		No
151			Unknown to Surveyor				DUNE	х		No
152			Unknown to Surveyor				DUNE	х		No
153			Unknown to Surveyor				DUNE	х		No
154	CNU	Cocos nucifera	Coconut Palm	7	15	14	Site		x	No
155	CNU	Cocos nucifera	Coconut Palm	10	20	18	Site		x	No
156	CNU	Cocos nucifera	Coconut Palm	10	40	20	Site		x	No
157	CNU	Cocos nucifera	Coconut Palm	9	20	18	Site		x	No
158	CNU	Cocos nucifera	Coconut Palm	8	30	18	Site		x	No
159	CNU	Cocos nucifera	Coconut Palm	10	25	16	Site		x	No
160		Cocos nucifera	Coconut Palm	10	30	16	Site		x	No
161		Cocos nucifera	Coconut Palm	10	30	16	Site		x	No
162		Cocos nucifera	Coconut Palm	10	35	10	Site		x	No
163		Cocos nucifera	Coconut Palm	10	30	12	Site		x	No
164		Cocos nucifera	Coconut Palm	10	20	8	Site		x x	No
165	CER	Conocarpus erectus	Silver Buttonwood	8	14	4	Beach Walk	x		No
165	SPA	Sabal palmetto	Cabbage Palm	4	14	4 8	Site	<u>^</u>	x	No
167	CER	Conocarpus erectus	Silver Buttonwood	8	14	4	Beach Walk	~	X	No
168	CER	Conocarpus erectus	Silver Buttonwood	8	14	4	Beach Walk	X		No
169	WRO	Washingtonia robusta	Washingtonia Palm	10	35	10	Site	X		No
170		a "	Not Located on Survey						X	No
171	CNU	Cocos nucifera	Coconut Palm	12	15	15	Site		X	No
172	CNU	Cocos nucifera	Coconut Palm	8	15	10	Site		X	No
173	CNU	Cocos nucifera	Coconut Palm	8	15	10	Site		X	No
174	CNU	Cocos nucifera	Coconut Palm	12	15	15	Site		X	No
475	CNU	Cocos nucifera	Coconut Palm	12	15	15	Site		X	No
175			Coconut Palm				Site			

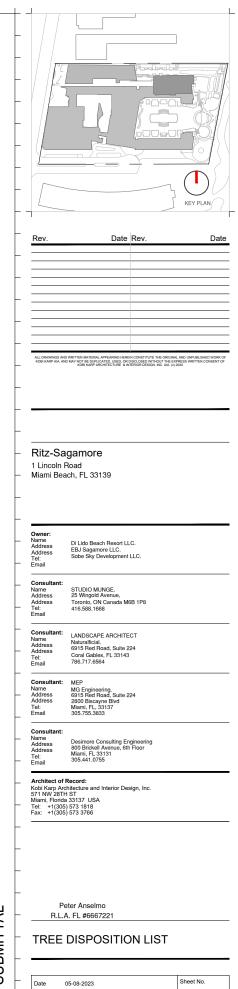

# HPB SUBMITTAL

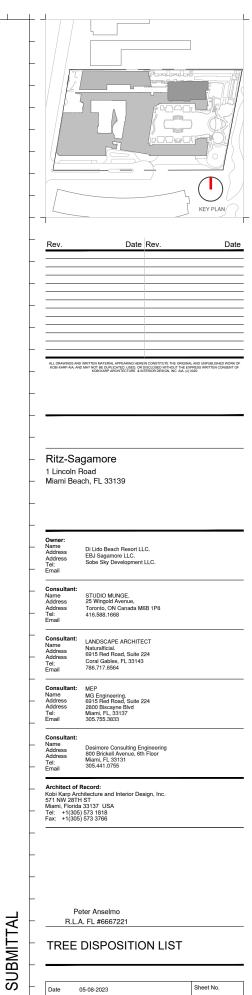
NTS

Project Ritz Sagamore

Scale

L-3.03

		59.6		,			10			\$2	0,000
Total diar		ee(s) to be removed (sum of hes at DBH)	Total number of replacement tre each Replacement Tree is a mini spread in Canopy x 12	imum of 2"	DBH x 6'	(where ea	ch Replacement Tre	cement trees required : Tree is a minimum of 4" (nopy x 16' in height)			ition to Tree st Fund
		ACH - TREE REPLACEMEN			0.00						
		ing R.O.W Trees / Palms to be as to removed (sum of inches a			1 59.6						
		ing R.O.W Trees / Palms to be			3						
Total Numb	er of Exist	ing R.O.W Trees / Palms to Re			7						
		ing R.O.W Trees / Palms:			17						
		Site Trees / Palms to be Reloca Site Trees / Palms to be Remov			109 7						
		Site Trees / Palms to Remain:			88						
Total Numb	er of Exist	ing On-Site Trees / Palms:			205						
SUMMAR			• 	-							
2681	CNU	Cocos nucifera	Coconut Palm	8	18	16	RIGHT OF WAY	X			No
2680	CNU	Cocos nucifera	Coconut Palm	8	18	16	RIGHT OF WAY	x			No
2679	CNU	Cocos nucifera	Coconut Palm	8	18	16	Site			X	No
2678	CNU	Cocos nucifera	Coconut Palm	7	20	16	Site			х	No
2677	CNU	Cocos nucifera	Coconut Palm	7	20	18	Site			х	No
2676	CNU	Cocos nucifera	Coconut Palm	8	24	14	Site			Х	No
2675	CNU	Cocos nucifera	Coconut Palm	7	25	16	Site			Х	No
2674	CNU	Cocos nucifera	Coconut Palm	10	28	20	Site			Х	No
2673	CNU	Cocos nucifera	Coconut Palm	12	30	18	Site			Х	No
2672	CNU	Cocos nucifera	Coconut Palm	11	25	24	Site			X	No
2671	CNU	Cocos nucifera	Coconut Palm	9	30	20	Site			X	No
2670	CNU	Cocos nucifera	Coconut Palm		30	24	Site			X	No
2669	CNU	Cocos nucifera	Coconut Palm	8	28	24	Site			X	No
2668	CNU	Cocos nucifera	Coconut Palm	9	35	24	Site			X	No
2667	CNU	Cocos nucifera	Coconut Palm	10	35	24	Site			X	No
2665	CNU	Cocos nucifera	Coconut Palm	9	38	20	Site			X	No
2663	CNU	Cocos nucifera	Coconut Palm	12	35	22	Site			<u>х</u>	No
2662	CNU	Cocos nucifera	Coconut Palm	12	33	20	Site			X	No
2660	CNU	Cocos nucifera	Coconut Palm	12	35	20	Site			X	No
2660	CNU	Cocos nucifera	Coconut Palm	12	30	20	Site	~		х	No
2657	RMA	Ravenala madagascariensis	Travellers Palm	12	4	10	Site	x			No
2656	RMA	Ravenala madagascariensis	Travellers Palm	12	10	6	Site	x			No
2655	RMA	Ravenala madagascariensis		12	4	6	Site	x			No
2654	CNU	Cocos nucifera	Coconut Palm	12	25	20	Site	X			No
2653	CNU	Cocos nucifera	Coconut Palm	12	35	20	Site	х			No
2652	CNU	Cocos nucifera	Coconut Palm	12	25	20	Site	х			No
SAGAMO	RE										
198	CER	Conocarpus erectus	Green Buttonwood	4	12	6	Site	_	X		Yes
197	CER	Conocarpus erectus	Green Buttonwood	4	12	6	Site		X		Yes
196	CER	Conocarpus erectus	Green Buttonwood	4	12	6	Site		X		Yes
195	CNU	Cocos nucifera	Coconut Palm	8	15	12	Site	X	v		No
194		Cocos nucifera		12	15	15					No
193		Cocos nucifera	Coconut Palm		20	15	Site	<u> </u>			
			Coconut Palm	8			Site				No
191 192	CNU	Cocos nucifera Cocos nucifera	Coconut Palm	8	30 15	15	Site	<u> </u>			No
190	CNU CNU	Cocos nucifera	Coconut Palm Coconut Palm	8	30	15 15	Site Site	X V			No No
189	CNU	Cocos nucifera	Coconut Palm	8	20	10	Site	<u>X</u>			No
188	CNU	Cocos nucifera	Coconut Palm	12	25	10	Site	<u>x</u>			No
187	CNU	Cocos nucifera	Coconut Palm	12	20	15	Site	<u>X</u>			No
186	CNU	Cocos nucifera	Coconut Palm	7	20	15	Site	X			No
185	CNU	Cocos nucifera	Coconut Palm	8	8	12	Site			Х	No
184	CNU	Cocos nucifera	Coconut Palm	7	10	10	Site			Х	No
183	CNU	Cocos nucifera	Coconut Palm	7	10	10	Site			Х	No
182	CNU	Cocos nucifera	Coconut Palm	7	10	10	Site			Х	No
181	CNU	Cocos nucifera	Coconut Palm	7	10	10	Site			Х	No
180	CNU	Cocos nucifera	Coconut Palm	12	15	15	Site			Х	No
	CNU	Cocos nucifera	Coconut Palm	8	20	15	Site			Х	No
179	~						e no			~	110
178 179	CNU	Cocos nucifera	Coconut Palm	7	15	10	Site			х	No




НРВ

Scale NTS


Project Ritz Sagamore

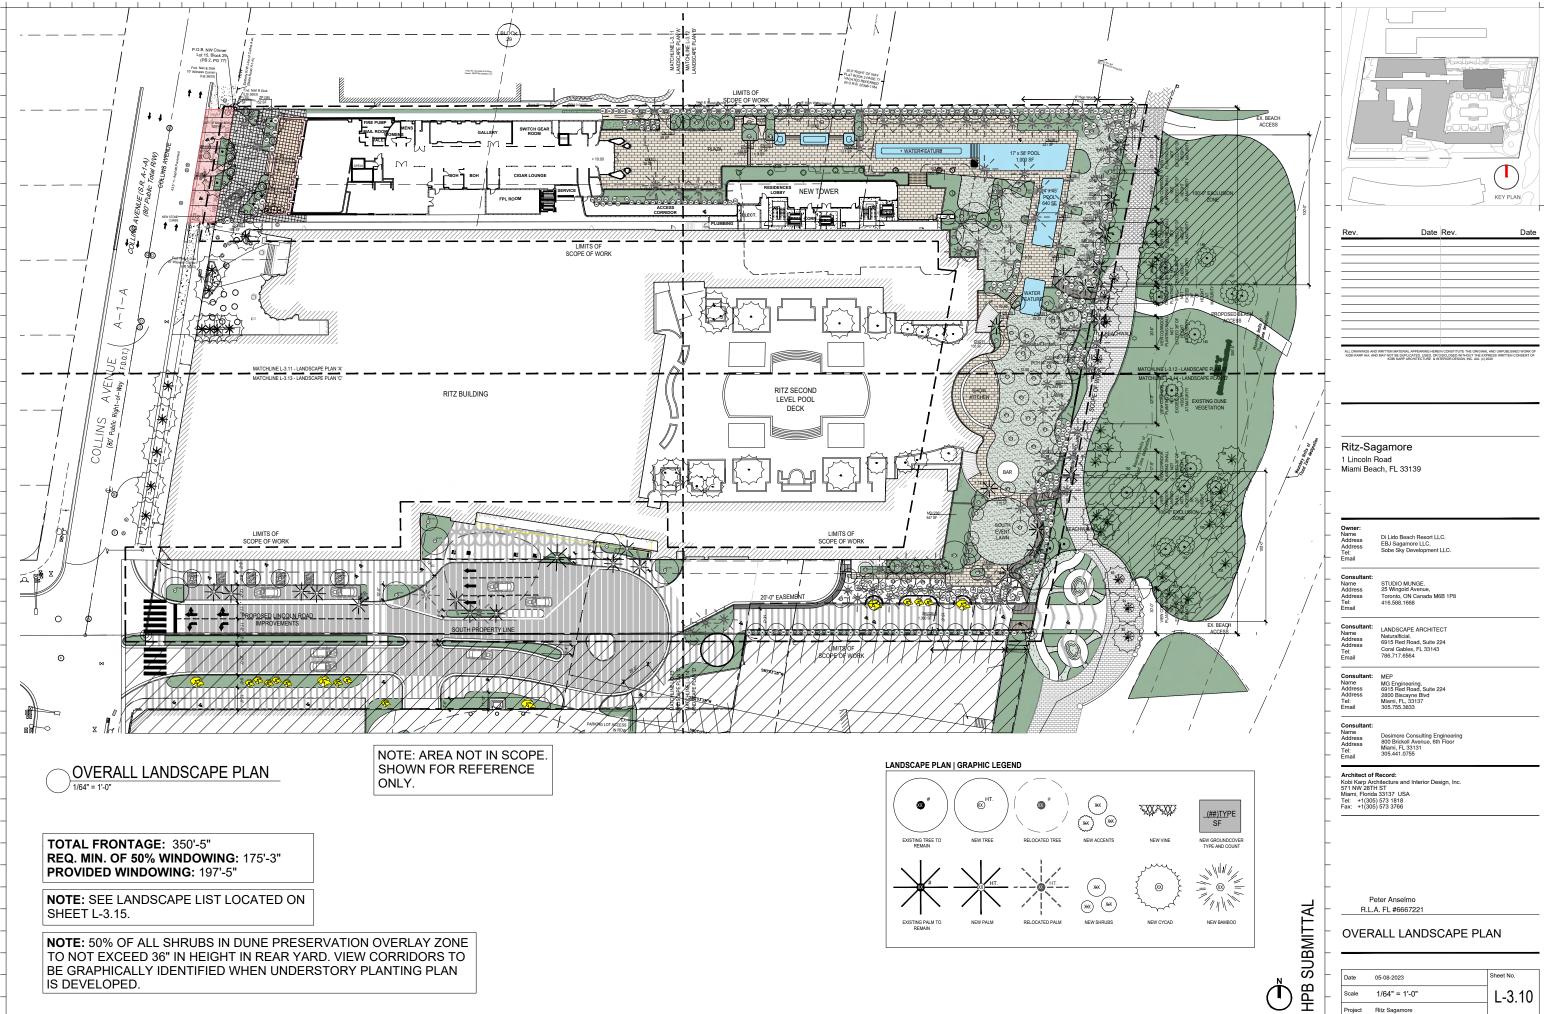L-3.04





Rev.	Date	Rev.	Date

Date	05-08-2023	Sheet No.
Scale	1/64" = 1'-0"	L-3.10
Project	Ritz Sagamore	

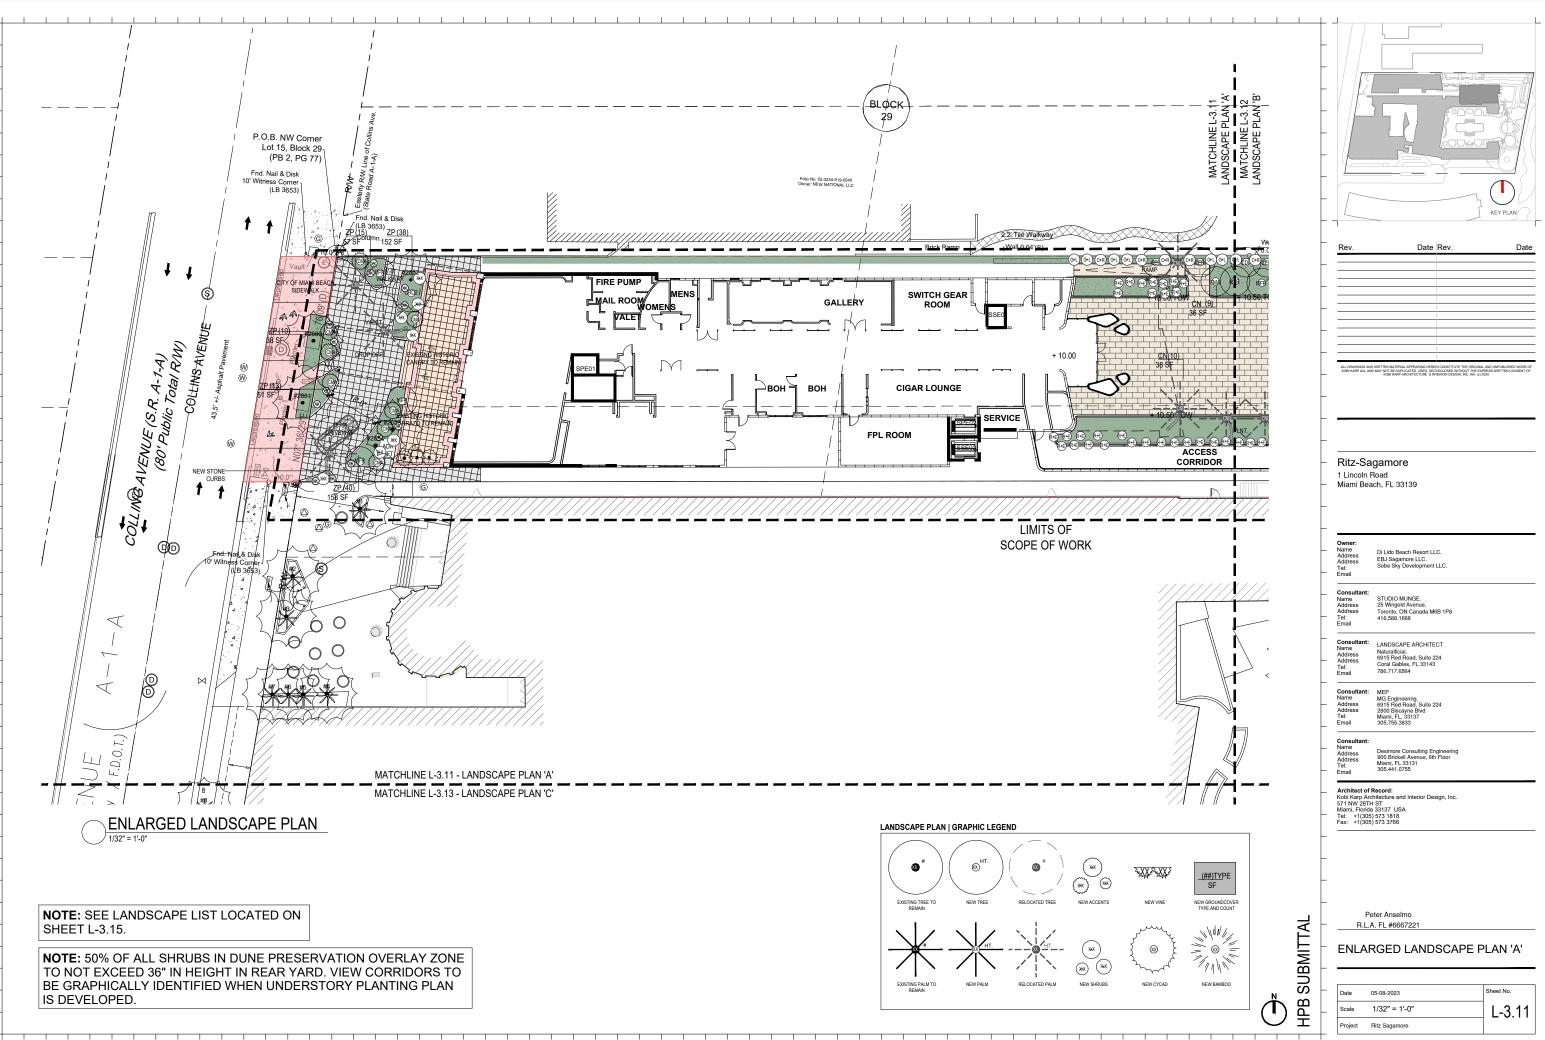

Date	05-08-2023	Sheet No.
Scale	1/32" = 1'-0"	L-3.11
Project	Ritz Sagamore	

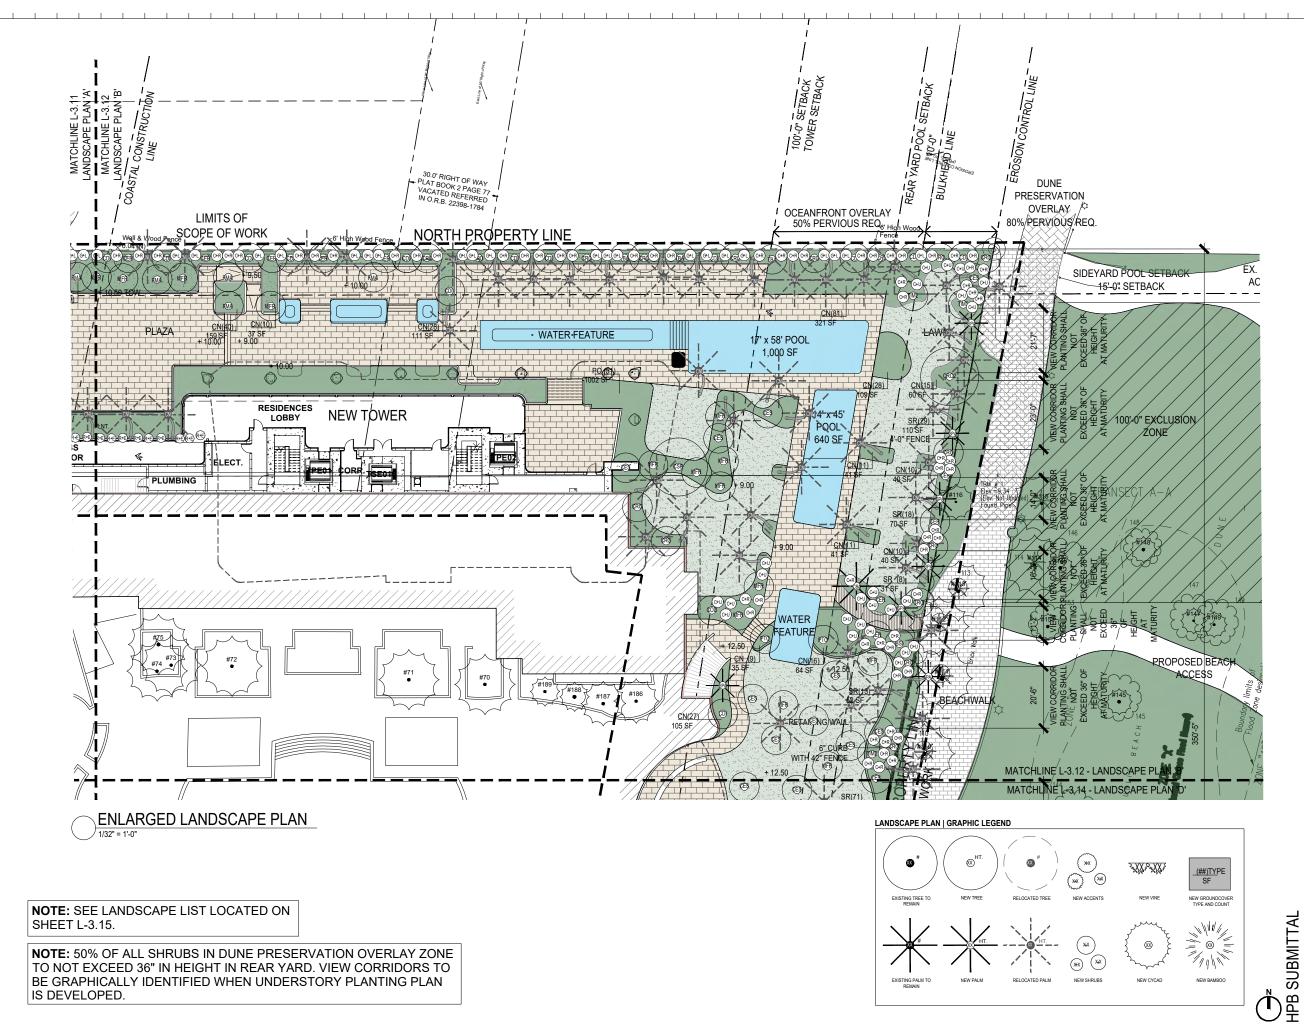

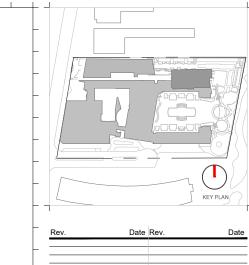

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Ritz-Sagamore 1 Lincoln Road Miami Beach, FL 33139

Owner: Name Address Address Tel: Email

Consult Name Address Address Tel: Email

Di Lido Beach Resort LLC. EBJ Sagamore LLC. Sobe Sky Development LLC.

STUDIO MUNGE. 25 Wingold Avenue Toronto, ON Canada M6B 1P8 416.588.1668

Consultant Name Address Address Tel: Email LANDSCAPE ARCHITECT Naturalficial. 6915 Red Road, Suite 224 Coral Gables, FL 33143 786.717.6564

Consult Name Address Address Tel: Email MEP

MG Engineering. 6915 Red Road, Suite 224 2800 Biscayne Blvd Miami, FL, 33137 305.755.3833


Consultant Name Address Address Tel: Email Desimore Consulting Engineering 800 Brickell Avenue, 6th Floor Miami, FL 33131 305.441.0755


Architect of Record: Kobi Karp Architecture and Interior Design, Inc. 571 NW 281H ST Miami, Florida 33137 USA Tel: + 1(305) 573 3188 Fax: +1(305) 573 3766

Peter Anselmo R.L.A. FL #6667221

ENLARGED LANDSCAPE PLAN 'B'

Date	05-08-2023	Sheet No.
Scale	1/32" = 1'-0"	L-3.12
Project	Ritz Sagamore	

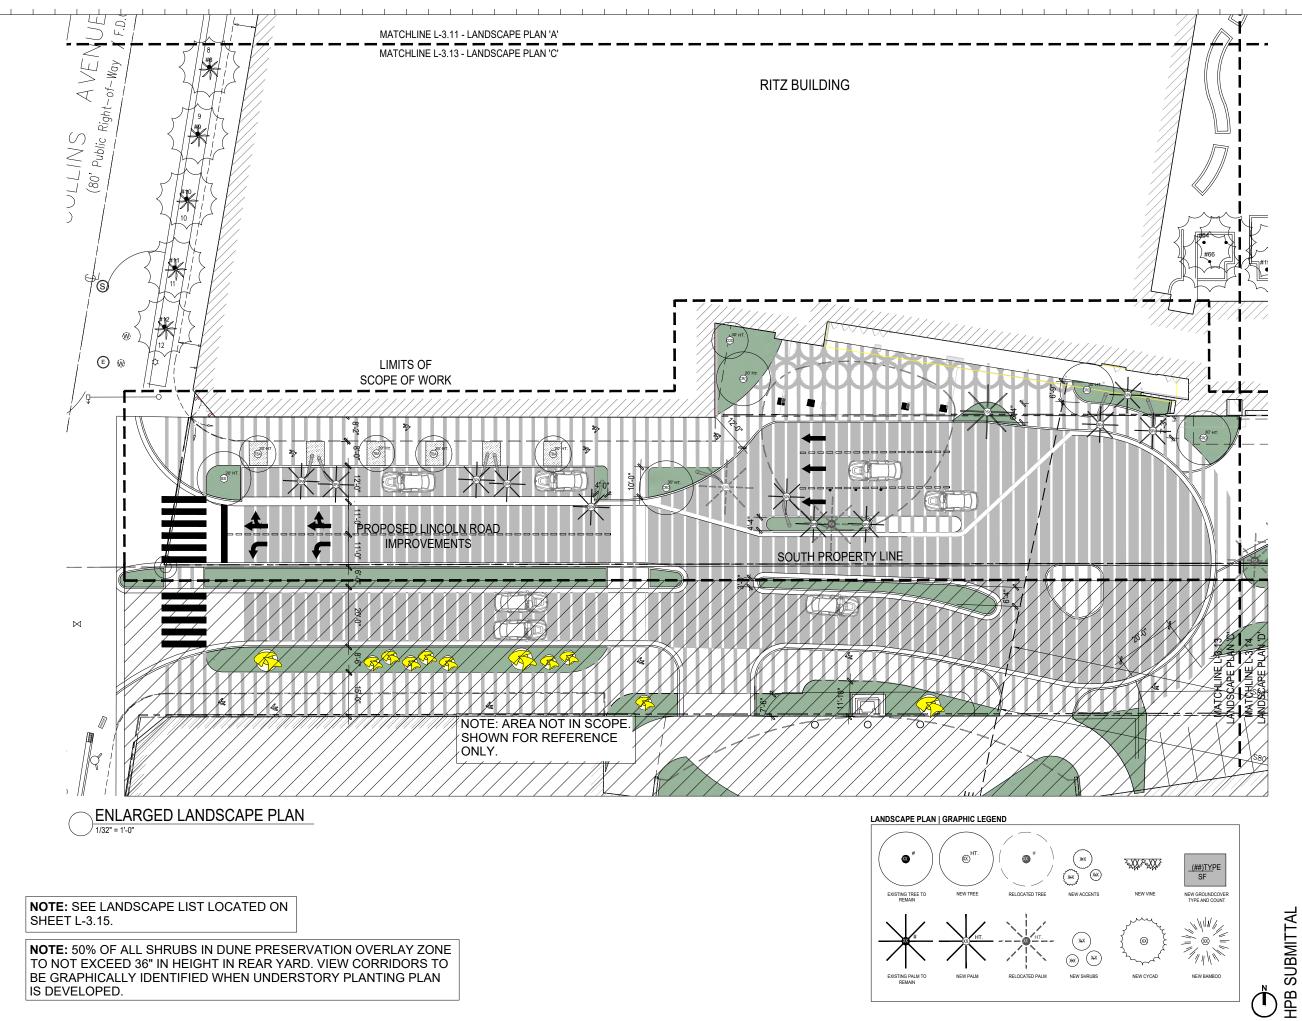

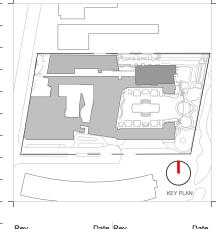

Rev.	Date	Rev.	Date

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### Ritz-Sagamore 1 Lincoln Road Miami Beach, FL 33139

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Di Lido Beach Resort LLC. EBJ Sagamore LLC. Sobe Sky Development LLC.

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Consultant: Name Address Address Tel: Email MG Engineering. 6915 Red Road, Suite 224 2800 Biscayne Blvd Miami, FL, 33137 305.755.3833

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# Consultant Name Address Address Tel: Email

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Architect of Record: Kobi Karp Architecture and Interior Design, Inc. 571 NW 281H ST Miami, Florida 33137 USA Tei: +1(305) 573 1818 Fax: +1(305) 573 3766

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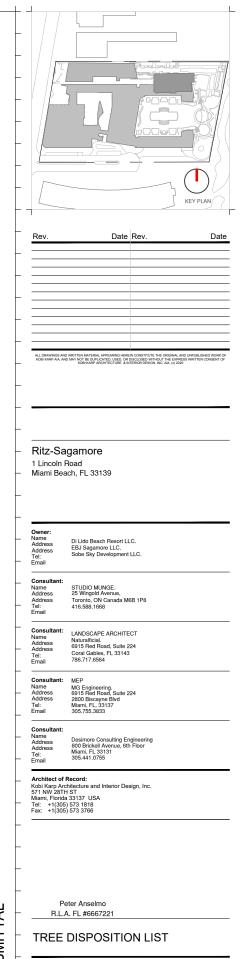
### ENLARGED LANDSCAPE PLAN 'C'

Date	05-08-2023	Sheet No.
Scale	1/32" = 1'-0"	L-3.13
Project	Ritz Sagamore	
		•

:NU       :R       :ER       :ER       :ER       :ER       :ER	Cocos nucifera	Coconut Palm Coconut Palm	7 8 12 7 7 7 7 7 7 8 8 7 12 12 12 12 8 8 8 8 8	15 20 15 10 10 10 10 10 10 20 20 20 25 20 30	10 15 15 10 10 10 10 10 12 15 15 15 10	Site Site Site Site Site Site Site Site			X X X X X X X X X X X	No No No No No No No No
:NU       :R       :ER       :ER       :ER       :NU	Cocos nucifera Cocos nucifera	Coconut Palm Coconut Palm	12 7 7 7 7 8 8 7 12 12 12 8 8 8 8 8	15           10           10           10           10           20           20           20           20           20           20           20           20           20	15 10 10 10 10 12 15 15 10	Site Site Site Site Site Site Site Site			X X X X X X	No No No No No No
:NU       :R       :ER       :ER       :ER       :ER       :ER	Cocos nucifera Cocos nucifera	Coconut Palm Coconut Palm	7 7 7 8 8 7 12 12 12 8 8 8 8 8	10 10 10 10 20 25 20	10 10 10 10 12 15 15 15 10	Site Site Site Site Site Site Site			X X X X X	No No No No No
:NU       :R       :ER       :ER       :ER       :ER       :ER	Cocos nucifera Cocos nucifera	Coconut Palm Coconut Palm	7 7 7 8 7 12 12 12 8 8 8 8 8 8	10 10 10 8 20 20 25 20	10 10 10 12 15 15 15 10	Site Site Site Site Site Site			X X X	No No No No
:NU       :R       :ER       :ER       :ER       :ER	Cocos nucifera Cocos nucifera	Coconut Palm Coconut Palm	7 7 8 7 12 12 12 8 8 8 8 8	10 10 8 20 20 20 25 20	10 10 12 15 15 10	Site Site Site Site Site			X X	No No No No
:NU :NU :NU :NU :NU :NU :NU :NU :NU :NU	Cocos nucifera Cocos nucifera	Coconut Palm Coconut Palm Coconut Palm Coconut Palm Coconut Palm Coconut Palm Coconut Palm Coconut Palm Coconut Palm Coconut Palm	7 8 7 12 12 8 8 8 8 8	10 8 20 20 25 20	10 12 15 15 10	Site Site Site Site			х	No No No
:NU :NU :NU :NU :NU :NU :NU :NU :NU :NU	Cocos nucifera Cocos nucifera	Coconut Palm Coconut Palm Coconut Palm Coconut Palm Coconut Palm Coconut Palm Coconut Palm Coconut Palm Coconut Palm Coconut Palm	8 7 12 12 8 8 8 8	8 20 20 25 20	12 15 15 10	Site Site Site				No No
:NU :NU :NU :NU :NU :NU :NU :NU :NU :RU :RU :RU :RU :RU :RU :RU	Cocos nucifera Cocos nucifera	Coconut Palm Coconut Palm Coconut Palm Coconut Palm Coconut Palm Coconut Palm Coconut Palm Coconut Palm	7 12 12 8 8 8 8 8	20 20 25 20	15 15 10	Site Site				No
:NU :NU :NU :NU :NU :NU :NU :NU :NU :RU :ER :ER :ER :ER	Cocos nucifera Cocos nucifera	Coconut Palm Coconut Palm Coconut Palm Coconut Palm Coconut Palm Coconut Palm Coconut Palm	12 12 8 8 8 8	20 25 20	15 10	Site		<u>├</u> ───┤		
:NU :NU :NU :NU :NU :NU :NU :ER :ER :ER :ER	Cocos nucifera Cocos nucifera Cocos nucifera Cocos nucifera Cocos nucifera Cocos nucifera Cocos nucifera Cocos nucifera Cocos nucifera Cocos nucifera	Coconut Palm Coconut Palm Coconut Palm Coconut Palm Coconut Palm Coconut Palm	12 8 8 8 8	25 20	10		<u> </u>			No
NU NU NU NU NU NU NU ER ER ER	Cocos nucifera Cocos nucifera Cocos nucifera Cocos nucifera Cocos nucifera Cocos nucifera Cocos nucifera Cocos nucifera Conocarpus erectus	Coconut Palm Coconut Palm Coconut Palm Coconut Palm Coconut Palm	8 8 8	20						
NU NU NU NU NU NU ER ER ER	Cocos nucifera Cocos nucifera Cocos nucifera Cocos nucifera Cocos nucifera Cocos nucifera Cocos nucifera Conocarpus erectus	Coconut Palm Coconut Palm Coconut Palm Coconut Palm	8 8			Site	X			No
NU NU NU NU NU ER ER ER	Cocos nucifera Cocos nucifera Cocos nucifera Cocos nucifera Cocos nucifera Cocos nucifera Conocarpus erectus	Coconut Palm Coconut Palm Coconut Palm	8	30	10	Site	X			No
NU NU NU ER ER ER ER	Cocos nucifera Cocos nucifera Cocos nucifera Cocos nucifera Conocarpus erectus	Coconut Palm Coconut Palm			15	Site	X			No
NU NU ER ER ER ER	Cocos nucifera Cocos nucifera Cocos nucifera Conocarpus erectus	Coconut Palm		30	15	Site	X			No
NU NU ER ER ER ER	Cocos nucifera Cocos nucifera Conocarpus erectus		8	15	15	Site	X			No
NU ER ER ER ER	Cocos nucifera Conocarpus erectus		8	20	15	Site	X			No
ær ær ær	Conocarpus erectus	Casanut Dalm	12	15	15	Site	X	<u> </u>		No
ER ER NU	· · · · · · · · · · · · · · · · · · ·	Coconut Palm	8	15 12	12 6	Site	X			No
ER NU	L'anagarnue gradue	Green Buttonwood Green Buttonwood	4			Site		X		Yes
NU	Conocarpus erectus Conocarpus erectus	Green Buttonwood	4	12 12	6 6	Site Site		X X		Yes Yes
				12						163
	Cocos nucifera	Coconut Palm	12	25	20	Site	х			No
NU	Cocos nucifera	Coconut Palm	12	35	20	Site	x	++		No
	Cocos nucifera	Coconut Palm	12	25	20	Site	x			No
MA	Ravenala madagascariensis	Travellers Palm	12	4	6	Site	x			No
	Ravenala madagascariensis	Travellers Palm	12	10	6	Site	x			No
	Ravenala madagascariensis	Travellers Palm	12	4	10	Site	x			No
	Cocos nucifera	Coconut Palm	12	30	20	Site			x	No
	Cocos nucifera	Coconut Palm	12	35	20	Site			X	No
	Cocos nucifera	Coconut Palm	12	32	22	Site			X	No
	Cocos nucifera	Coconut Palm	12	35	20	Site			x	No
	Cocos nucifera	Coconut Palm	9	38	24	Site			X	No
	Cocos nucifera	Coconut Palm	10	35	24	Site			X	No
		Coconut Palm								No
		Coconut Palm								No
		Coconut Palm	8	30	24	Site				No
NU	Cocos nucifera	Coconut Palm	9	30	20	Site			х	No
		Coconut Palm	11							No
		Coconut Palm	12	30	18	Site			X	No
		Coconut Palm	10	28	20	Site			x	No
		Coconut Palm	7	25	16	Site			x	No
		Coconut Palm	8	24	14	Site			х	No
		Coconut Palm	7	20	18	Site			X	No
		Coconut Palm	7	20	16	Site			х	No
NU	Cocos nucifera	Coconut Palm	8	18	16	Site			х	No
NU	Cocos nucifera	Coconut Palm	8	18	16	RIGHT OF WAY	х			No
NU	Cocos nucifera	Coconut Palm	8	18	16	RIGHT OF WAY	х			No
Evicti	ng On Site Trace / Deliver			205						
				205 88						
On- Si	ite Trees / Palms to be Reloca			109						
		red:								
		emain:		7						
Existin	ng R.O.W Trees / Palms to be	Relocated :		3						
				1						
	•	•		59.6						
			ees require	d (where	Total	number of replaceme	nt trees re	equired		
inches at DBH) each Replacement Tree is a minimum of			imum of 2"	DBH x 6'	DBH x 6' (where each Replacement Tree is a minimum of 4			imum of 4"		tion to Tree st Fund
inch								I SIMILI		
	JU           JU	IU       Coccos nucifera         IU       Cocos nucifera     <	IU       Cocos nucifera       Coconut Palm         IU       Co	U       Cocos nucifera       Coconut Palm       9         U       Cocos nucifera       Coconut Palm       8         U       Cocos nucifera       Coconut Palm       8         U       Cocos nucifera       Coconut Palm       9         U       Cocos nucifera       Coconut Palm       9         U       Cocos nucifera       Coconut Palm       11         U       Cocos nucifera       Coconut Palm       12         U       Cocos nucifera       Coconut Palm       10         U       Cocos nucifera       Coconut Palm       10         U       Cocos nucifera       Coconut Palm       7         U       Cocos nucifera       Coconut Palm       8         U	NU       Cocos nucifera       Coconut Palm       9       35         NU       Cocos nucifera       Coconut Palm       8       28         NU       Cocos nucifera       Coconut Palm       8       30         NU       Cocos nucifera       Coconut Palm       9       30         NU       Cocos nucifera       Coconut Palm       9       30         NU       Cocos nucifera       Coconut Palm       11       25         NU       Cocos nucifera       Coconut Palm       12       30         NU       Cocos nucifera       Coconut Palm       12       30         NU       Cocos nucifera       Coconut Palm       10       28         NU       Cocos nucifera       Coconut Palm       7       25         NU       Cocos nucifera       Coconut Palm       7       20         NU       Cocos nucifera       Coconut Palm       7       20         NU       Cocos nucifera       Coconut Palm       7       20         NU       Cocos nucifera       Coconut Palm       8       18         NU       Cocos nucifera       Coconut Palm       8       18         NU       Cocos nucifera       Coconut Palm<	AU       Coccos nucliera       Coconut Palm       9       35       24         AU       Coccos nucliera       Coconut Palm       8       28       24         AU       Coccos nucliera       Coconut Palm       8       30       24         AU       Coccos nucliera       Coconut Palm       9       30       20         AU       Coccos nucliera       Coconut Palm       9       30       20         AU       Coccos nucliera       Coconut Palm       11       25       24         AU       Cocos nucliera       Coconut Palm       10       28       20         AU       Cocos nucliera       Coconut Palm       7       25       16         AU       Cocos nucliera       Coconut Palm       7       20       18         AU       Cocos nucliera       Coconut Palm       7       20       18         AU       Cocos nucliera       Coconut Palm       7       20       16         AU       Cocos nucliera       Coconut Palm       8       18       16         AU       Cocos nucliera       Coconut Palm       8       18       16         AU       Cocos nucliera       Coconut Palm       8	U       Cocos nucifera       Coconut Palm       9       35       24       Site         UU       Cocos nucifera       Coconut Palm       8       28       24       Site         UU       Cocos nucifera       Coconut Palm       8       30       24       Site         UU       Cocos nucifera       Coconut Palm       9       30       20       Site         UU       Cocos nucifera       Coconut Palm       11       25       24       Site         UU       Cocos nucifera       Coconut Palm       11       25       24       Site         UU       Cocos nucifera       Coconut Palm       10       28       20       Site         UU       Cocos nucifera       Coconut Palm       7       25       16       Site         UU       Cocos nucifera       Coconut Palm       7       20       18       Site         UU       Cocos nucifera       Coconut Palm       7       20       16       Site         UU       Cocos nucifera       Coconut Palm       8       18       16       RIGHT OF WAY         UU       Cocos nucifera       Coconut Palm       8       18       16       RIGHT OF WAY	U       Cocons nuclifera       Coconut Palm       9       35       24       Site         UU       Cocos nuclifera       Coconut Palm       8       28       24       Site         UU       Cocos nuclifera       Coconut Palm       8       30       24       Site         UU       Cocos nuclifera       Coconut Palm       9       30       20       Site         UU       Cocos nuclifera       Coconut Palm       11       25       24       Site         UU       Cocos nuclifera       Coconut Palm       11       25       24       Site         UU       Cocos nuclifera       Coconut Palm       10       28       20       Site         UU       Cocos nuclifera       Coconut Palm       10       28       20       Site         UU       Cocos nuclifera       Coconut Palm       7       25       16       Site         UU       Cocos nuclifera       Coconut Palm       7       20       18       Site         UU       Cocos nuclifera       Coconut Palm       7       20       16       Site         UU       Cocos nuclifera       Coconut Palm       8       18       16       RIGHT OF WAY	U         Cocos nucifera         Coconut Paim         9         35         24         Site           UU         Cocos nucifera         Coconut Paim         8         28         24         Site         Image: Coconut Paim         9         30         20         Site         Image: Coconut Paim         9         30         20         Site         Image: Coconut Paim         9         30         20         Site         Image: Coconucitera         Coconut Paim         9         30         20         Site         Image: Coconucitera         Coconut Paim         11         25         24         Site         Image: Coconucitera         Coconut Paim         11         25         24         Site         Image: Coconucitera         Coconut Paim         11         25         24         Site         Image: Coconucitera         Coconut Paim         10         28         20         Site         Image: Coconucitera         Coconut Paim         10         28         20         Site         Image: Coconucitera         Coconut Paim         8         24         14         Site         Image: Coconucitera         Coconut Paim         8         18         16         Site         Image: Coconucitera         Coconucitera         Coconut Paim         8         18	U         Cocos nuclfera         Cocont Palm         9         35         24         Site         X           U         Cocos nuclfera         Cocontt Palm         8         28         24         Site         X           U         Cocos nuclfera         Cocontt Palm         8         30         24         Site         X           U         Cocos nuclfera         Cocontt Palm         9         30         20         Site         X           U         Cocos nuclfera         Cocontt Palm         9         30         24         Site         X           U         Cocos nuclfera         Cocontt Palm         9         30         24         Site         X           U         Cocos nuclfera         Cocont Palm         12         30         18         Site         X           U         Cocos nuclfera         Cocont Palm         7         25         16         Site         X           U         Cocos nuclfera         Cocont Palm         7         20         18         Site         X           U         Cocos nuclfera         Cocont Palm         8         18         16         RIGHT OF WAY         X           U <td< td=""></td<>

NOTE: PLEASE SEE SHEET L-3.15 FOR TREES TO BE CREDITED.

LANDSCAPE SUMMARY DEPICTING NEW



# HPB SUBMITTAL

Date 05-08-2023 Scale NTS Sheet No. L-3.04 Project Ritz Sagamore

TY ABRV.		BOTANICAL NAME	COMMON NAME SPECIFICATIONS		FL. NAT	<u>IVE</u>	DROUGHT TOLERANT		
REES (O	VER STOP	RY PLANTING)			YES	NO	YES	NO	
2	BSI	Bursera simaruba	Gumbo Limbo	25' Ht. x 15' Spr.	х		х		
1	COD	Cananga odorata	Ylang Ylang	25' Ht.		х	х		
1	CSP	Ceiba speciosa	Silk Floss Tree (Pink)	30' Ht., Specimen		х	х		
18	CDI	Coccoloba diversifolia	Pigeon plum	12'-14' Ht. x 6' Spr. Min. 6' CT.	х		X		
25	CER	Conocarpus erectus	Green Buttonwood	12'-14' Ht x 10' Spr. Mtl-trk, 2"-8" Cal. Min.,6' CT.	X		X		
21	CES	Conocarpus erectus var. sericeus	Silver Buttonwood (mlt. trk.)	16'-18 Ht., Mitl-trk, Field Grown, Specimen	x		x		
17	CRO	Clusia rosea	Autograph Tree	12'-14' Ht. x 10' Spr, MltI-trk, Field Grown, Specimen	x		x		
4	CRO2	Clusia rosea	Autograph Tree	25' Ht. x 15' Spr.	X		x		
5	FMA	Ficus maclellandii	Ficus Alii	200 Gal.		х		x	
3	GLU	Gymnanthes lucida	Crabwood		x	~	x		
	MFR	-		16, 19, Lt. Mill triz Field Crown Specimen	x		x		
24		Myrcianthes fragrans	Simpson Stopper	16'-18 Ht., Miti-trk, Field Grown, Specimen	^	v			
3	PTO	Pithecellobium tortum	Brazilian Rain Tree	8'-10' Ht x 8' Spr. Min.		X	X		
3	TBA	Tabebuia bahamensis	Bahama Tabebuia (white flower)		X		X		
4	TIM2	Tabebuia impetiginosa	Pink Trumpet Tree	25' Ht., 200 Gal.	X		X		
		RY PLANTING)							
1	CBA	Copernicia baileyana	Bailey Palm			X	X		
8	CMA	Coccothrinax mariguama	Miraguama Palm			X	X		
70	CNU	Cocos nucifera	Relocated Coconut Palm	Relocated from On Site		X	X		
13	PSA	Phoenix sylvestris	Wild Date Palm	Relocated from On Site		X	Х		
6	SPA	Sabal palmetto	Sabal Palm (booted trunk)	14' Ht., 18" DBH	X		X		
17	SPA2	Sabal palmetto	Sabal Palm (character trunk)		Х		Х		
HRUBS	UNDER ST	ORY PLANTING)							
488	CN	Clusia guttifera 'Nana'	Small Leaf Clusia	7 Gal.		Х	Х		
107	CR	Clusia rosea	Autograph Tree	8' Ht.	X		Х		
66	CU	Coccoloba uvifera	Sea Grape	8' Ht.	Х		Х		
28	GL	Gymnanthes lucida	Crabwood	8' Ht.	Х		х		
236	MD	Monstera deliciosa	Mexican Breadfruit	7 Gal.		Х	Х		
51	PO	Plumeria obtusa	Evergreen Plumeria	15 Gal.		Х	Х		
37	RE	Rhapis excelsa	Lady Palm	15 Gal.		Х	Х		
487	SR	Serenoa repens 'Silver Form'	Silver Saw Palmetto	15 Gal.	х		Х		
116	ZP	Zamia pumila	Coontie	7 Gal.	х		х		
CCENTS	UNDER	STORY PLANTING)							
8	AP	Alpinia purpurata	Red Ginger	7G		х		x	
10	AT	Agave attenuata	Spineless Agave	3G (see note 1)		х	х		
10	AI	Alcantarea Imperialis	(Bromeliad)	7G (see note 1)		х	х		
36	AR	Alcantarea Reginae	Silver Form Bromeliad	7G		х	х		
14	PW	Philodendron Weeks Hybrid	Same	7G		х		x	
83	NR	Neomarica caerulea 'Regina'	Giant Apostle's Iris	3G		х		x	
10	ZP	Zamia pumila	Coontie	7G (see note 1)	х		х		
ROUND	COVERS (	UNDER STORY PLANTING)							
TBD	BA	Borrichia arborescens	Silver Sea-Oxeye Daisy (wildflow	43G	Х		х		
TBD	EL	Ernodea littoralis	Golden Creeper	3G	Х		х		
TBD	HD	Helianthus debilis	Beach Sunflower / Dune Sunflowe	=3G	х		х		
215	RN	Clusia rosea 'Nana'	Miniature Pitch Apple	3G @18" O.C.	x		x		
120	HL	Hymenocallis latifolia	Spider Lily	3G @18 O.C.	х		х		
294	MS	Microsorum scolopendrium	Wart Fern	3G @18" O.C.	х		х		
100	МС	Muhlenbegia capillaris	Muhly Grass	7G, 3' ht. x 3' sp.	х		х		
123	ОВ	Nephrolepis biserrata	Macho Fern	3G @24" O.C.	x		х		
85	OE	Nephrolepis exaltata"Bostoniesis"	Boston Fern	3G @18" O.C.	х		х		
TBD	OJ	Ophiopogon Japonicus	Mondo Grass	3G		х		х	
121	BM	Philodendron Burle Marx	Same	3G @24" O.C.		х		x	

# LANDSCAPE SUMMARY:

1

EXISTING PALMS TO REMAIN: (83) NOT CR PROPOSED TREES: (160) TREES TO BE CR PROPOSED PALMS: (45) PALMS NOT CREE

NOTE: 50% OF ALL SHRUBS IN DUNE PRES TO NOT EXCEED 36" IN HEIGHT IN REAR YA BE GRAPHICALLY IDENTIFIED WHEN UNDE IS DEVELOPED.

	Rev. Date Rev. Date
	- Ritz-Sagamore 1 Lincoln Road Miami Beach, FL 33139
	Owner:           Name         Di Lido Beach Resort LLC.           Address         EBJ Sagamore LLC.           Address         Sobe Sky Development LLC.           Tel:         Sobe Sky Development LLC.           Email
	Name Nativatificial. Address 6915 FR4 Fload. Suite 224 Address 6915 FR4 Fload. Suite 224 Tel: Coral Gables, FL 33143 Email 786.717.8584 
	Name     Desimore Consulting Engineering Address       Address     900 Brickell Avenue, 6th Floor Tel:       Miami, FL 33131       Email     305.441.0755       Architect of Record:       Kobi Karp Architecture and Interior Design, Inc. 571 NW 2811 ST       Miami, Florida 33137 USA       Tel:     +1(305) 573 3766
REDITED (CNU + PCA)) REDITED DITED	Peter Anselmo R.L.A. FL #6667221 LANDSCAPE PLANT LIST
DITED SERVATION OVERLAY ZONE	

五 Project Ritz Sagamore L-3.13



Bursera simaruba Gumbo Limbo



Clusia rosea Autograph Tree



Myrcianthes fragrans Simpson's Stopper



Copernicia baileyana Bailey Palm



Cananga odorata Ylang Ylang



Conocarpus erectus Green Buttonwood



Pithecellobium tortum Brazilian Rain Tree



Coccothrinax mariguama Mariguama Palm



Ceiba speciosa Silk Floss Tree



Conocarpus erectus var. sericeus Silver Buttonwood



Tabebuia bahamensis Bahama Tabebuia



Coccoloba diversifolia Pigeon Plum



Ficus maclellandii Ficus Alii



Tabebuia impetiginosa Pink Trumpet Tree

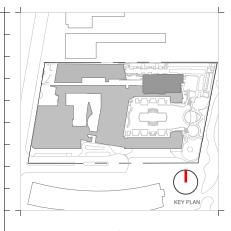


Gymnanthes lucida Crabwood



Coccoloba uvifera Seagrape





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# Ritz-Sagamore 1 Lincoln Road Miami Beach, FL 33139

# Owner: Name Address Address Tel: Email

Di Lido Beach Resort LLC. EBJ Sagamore LLC. Sobe Sky Development LLC.

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STUDIO MUNGE. 25 Wingold Avenu Toronto, ON Canada M6B 1P8 416.588.1668

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LANDSCAPE ARCHITECT Naturalficial. 6915 Red Road, Suite 224 Coral Gables, FL 33143 786.717.6564

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ulting Engineering

Architect of Record: Kobi Karp Architecture and Interior Design, Inc. 571 WV 28TH ST Miami, Florida 33137 USA Tei: +1(305) 573 1818 Fax: +1(305) 573 766

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### PLANTING REFERENCE IMAGES

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Dypsis cabadae Cabadae Palm



Sabal palmetto Sabal Palm



Euterpe edulis Assai Palm



Thrinax morrisii Keys Thatch Palm



*Pseudophoenix sargentii* Buccaneer Palm



Thrinax radiata Florida Thatch Palm



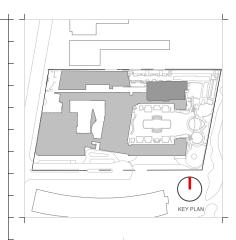
Ptychosperma elegans Solitaire Palm



Veitchia montgomeryana Montgomery Palm



Ravenala madagascariensis Traveler's Tree



Rev.	Date	Rev.	Date

ALL DRAWINGS AND WRITTEN MATERIAL APPEARING HEREIN CONSTITUTE IN KOBI KARP AIA, AND MAY NOT BE DUPLICATED, USED, OR DISCLOSED WITHO KOBI KARP ARCHITECTURE & INTERIOR DESIGN, IN

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Architect of Record: Kobi Karp Architecture and Interior Design, Inc. 571 NW 28TH ST Miami, Fiorida 33137 USA Teit: +1(305) 573 31818 Fax: +1(305) 573 3766

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### PLANTING REFERENCE IMAGES

Consulting Engineering Il Avenue, 6th Floor

Date	05-08-2023	Sheet No.
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### GENERAL PLANTING NOTES AND SPECIFICATIONS:

### GENERAL

ISTING TREES DESIGNATED TO REMAIN SHALL BE PROTECTED DURING ALL STRUCTION PHASES. ANY TREES OR SHRUBS SCARRED OR DESTROYED GNATED TO PRANN WILL BE REPLACED AT THE CONTRACTORS EXPENSE, I SIMILAR SPECIES, SIZE AND QUALITY. XISTING TREES DES

EXISTING TREES DESIGNATED TO BE STORED OFF-SITE, SHALL BE PROTECTED ID CARED FOR ACCORDINGLY TO INDUSTRY STANDARD. ANY TREES OR IRUBS SCARRED OR DESTROYED WILL BE REPLACED AT THE CONTRACTOR'S PENSE, WITH SIMILAR SPECIES, SIZE AND QUALITY.

ANDSCAPE CONTRACTOR SHALL BECOME FAMILIAR WITH ALL IDERGROUND UTILITIES OR STRUCTURES PRIOR TO DIGGING. LANDSCAPE INTRACTOR SHALL REPAIR ALL DAMAGE TO UNDERGROUND UTILITIES, ID/OR CONSTRUCTION CAUSED BY UTILITY DAMAGE, AT NO COST TO THE

ALL PLANT MATERIALS SHALL BE GUARANTEED FOR A PERIOD OF 12 MONTHS FTER DATE OF SUBSTANTIAL COMPLETION.

ANDSCAPE CONTRACTOR SHALL VERIFY ALL ESTIMATED QUANTITIES OF ATERIAL SHOWN ON THE DRAWINGS PRIOR TO SUBMITTING HIS BID. PLANTING AN TO TAKE PRECEDENCE OVER PLANT LIST.

A TO TAKE PRECEDENCE OFEN POWN DST. XISTING PLANT MATERIAL NOT SHOWN ON THE PLAN AND IN CONFLICT WITH Y PLANTING SHALL BE EVALUATED AT THE TIME OF NEW PLANTING TALLATION BY THE LANDSCAPE ARCHITECT.

NSI ALLENIONS IT THE UNIDAVE AND THE A

Alza PLANT MIX, OR AS PER SPECIFICATIONS. A LI PLANT MIXERIAL SYMBOLS SHOWN ON LANDSCAPE PLAN SHALL BE CONSIDERED DIAGRAMMATIC AND SHOLLD BE AUJUSTED IN THE FIELD BY CONSULTION ON ALL LITLIERS AND ALL OTHER OBSTRUCTIONS AFTER CONSULTION FILE LANDSCAPE ARCHITECT: A LL SZES SHOWN FOR PLANT MATERIAL ON THE PLAN IAPE TO BE CONSIDERED MINIMUM. ALL PLANT MATERIAL ON THE PLAN IAPE TO BE CONSIDERED MINIMUM. ALL PLANT MATERIAL ON THE PLAN IAPE TO THE CONSIDERED MINIMUM. ALL PLANT MATERIAL ON THE PLAN IAPE TO THE CONSIDERED MINIMUM. ALL PLANT MATERIAL ON THE PLAN IAPE TO THE CONSIDERED MINIMUM. ALL PLANT MATERIAL ON THE PLAN IAPE TO THE REQUIREMENTS FOR SOFTING CALL THESE TO ROCED THESE MINIMUM RECILIENCERT FOR CORPORTING ALL THESE TO HAVE SMILE BULL ASSO BE RECILIENT FOR ACOPTION CALL THESE TO HAVE SMILE TRUNK, LULESS OTHERWISS NOTED ON THE PLANS OR PLANT LIST. MICH RECILIENCEMENT AND THE PLANS OR PLANT LIST.

SITE PREPARATION SHALL INCLUDE THE ERADICATION AND REMOVAL OF I WEEDS, GRASS, AS WELLAS CLEAN-UP OF ANY DEAD MATERIAL AND FINISH VADING AS PER THE SPECS.

THE LANDSCAPE CONTRACTOR SHALL AT ALL TIMES KEEP THE JOB SITE EAN AND FREE FROM ACCUMULATION OF WASTE MATERIAL, DEBRIS, AND

 THE LANDSCAPE CONTRACTOR SHALL EXERCISE CAUTION TO PROTECT ANY EW HARDSCAPE CONSTRUCTION OR IRRIGATION ANY DAMAGE SHALL BE EVACED OR REPARED TO THE ORIGINAL STATE BY THE LANDSCAPE ONTRACTOR AT NO ADDITIONAL COST TO THE OWNER.
 THE LANDSCAPE AND ADDITIONAL COST TO THE OWNER.
 MINIMUM ROOT BALL DIAMETER 11/1 1/2/1 3/4"
 MINIMUM ROOT BALL DIAMETER

3. ALL PLANT MATERIAL TO BE FLORIDA #1 OR BETTER, AS DEFINED BY THE ORIDA DEPARTMENT OF AGRICULTURES 'CODES AND STANDARDS FOR URSERY PLANTS PART I AND II'.

. MULCH ALL PLANTING AREAS WITH SHREDDED ORGANIC MULCH TO A NIMUM DEPTH OF 2'. WITH THE EXCEPTION OF BEACH PLANTING.

I. ALL PLANTING AREAS WITHIN LIMIT OF WORK SHALL BE 100% FULLY RIGATED. THE IRRIGATION CONTRACTOR AWARDED THE BID SHALL COMPLY TH THE PROPOSED IRRIGATION DESIGN

ON-SITE LAYOUT OF PLANT MATERIAL MUST BE COORDINATED WITH THE NDSCAPE ARCHITECT PRIOR TO INSTALLATION

NUCLER PARLIELL PRIVIL ID INSTALLATION LANSCAPE CONTRACTOR TO INCLUDE REMOVAL CORRECTIVE PRUNING ID OR REPLACEMENT. ANY CORRECTIVE ACTIONS REQUIRED SHALL BE RFORMED IN ACCORDANCE WITH THE STANDARDS OF THE GOVERNING UNITY AND/OR AN SSUED EINTHEE OR ENVIRONMENTAL FEMIT.

UNITI ANUORI AN ISSUED EMINITEE UNEVNEUVNEUTAL PERMIT. TREE PROTECTION BARRIERS MUED DE INSTALLED AT THE DRIP UNES OF ALL EES AND PALMS TO REMAIN OR BE RELOCATED PRIOR TO THE START OF INSTRUCTION ACTIVITIES ONSITE AND SHALL REMAIN IN PLACE UNTIL INSTRUCTION HAS COMPLETED

NULCH SHALL NOT BE APPLED WITHIN 6' OF ANY TREE OR PALM TRUNKS HAT ARE INSTALLED OR INCORPORATED INTO THE PROJECT. FOR ROW VESTPAUNS PLASE UTILIZE AMERGROW, (PREMIUM PINEBAPK BROWN) IREDDED MULCH OR A CITY APPROVED ALTERNATIVE.

HEUDED MULCH ORA CITI APHYODID AL LENAMINE. S. SHOLD AN' CORECTIVE STRUCTURA, PRUNING BE NECESSARY FOR REES RPOPOSED TO REMAIN ON STE, DUE TO CLEARANCE, SAFETY OR FOR ONSTRUCTION RELITED REASONS THE PRUNING SHALL BE DIFECTED OF ERFORMED BY AN ISA OR ASCA CERTIFIED ARBORST IN ACCORDANCE WITH HE LITEST VERSION OF THE ANSI ASOP PRUNING STANDARDS AND COOD ORTICULTURAL PRACTICES. THE CITY UBBAN FORESTER SHALL BE PROVIDED ORTICULTURAL PRACTICES. THE CITY UBBAN FORESTER SHALL BE PROVIDED MIL A WINTER DURY OF THE ARPORTED PRUNING PANIL DURING IN EASONS WHY PRUNING IS NECESSARY, PRIOR TO THE PRUNING ACTIVITIES ANAURO DUCT

HEADONS WHY PRUNNING IS NECESSARY, PRIOR TO THE PPUNNING ACTIVITIES PRAVIDE PLACE. 17: CARE SHALL BE TAKEN TO AVOID UTILITY OR CONSTRUCTION TRENCHING HENOLEN DUSTING THEE OF PAUL MERILINES OF TREES SULTED TO REMAIN IN VACE OR BE RELOCATED, IF CONSTRUCTION REQUIRES THE CUTTING OF ANY MODIS WITH A DIAMETER OF 2° CM ORDERER, PAOLS SHALL BE CLEANLY CON WITH A SHAPE TOOL, AS DRECTED BY AN ISA CERTIFIED AREARS, AND IN ACCORDANCE WITH HE AND AND TO PREVENT DWING, ROOTS SHOULD NOT MEDIATELY CONFERENT WITH AND TA DRECTED WITH A DRECHEN YOUT MEDIATELY CONFERENT WITH AND THE AND TO PREVENT DWING, ROOTS SHOULD NOT MEDIATELY CONFERENT WITH AND AND TO PREVENT DWING, ROOTS SHOULD NOT DRECKENT POOTS TO BUS SHOULD BE NOTTO AND REVENT DWING. ROOTS SHOULD NOT DRECKENT POOTS TO BUS SHOULD BE NOTTO AND REVENDENT THE ANDSCAPE ARCHITECT PRIOR TO AVY ROOT PRUNING TAKING PLACE.

### HANDLING AND TRANSPORTATION

A DELICE OF AND THEFT OF INTERIMINE DO URING EXCAVATION, MOVING, GRAGE, RELOCATION, AND REPLAYTING. DO NOT SCAP OR OTHERWISE MAKEE TRUINS AND BRANCHES, AND AVOID BREAKING MURS, BRANCHES, NO FRONDS, DAWAGE TO THEEPALM MAY BE CAUSE FOR ITS RELECTION. AND YR REQUIRE UNTERIM REPLACEMENT BY THE CONTRACTOR. CONTRACTOR SHALL BE RESPONSIBLE FOR THE MANUAL WATERING OF ALL LIGCATED TREESPANIS DURING MAINTENANCE PROOL UNTLE FINAL CONTRACTOR SHALL BE MERPONSIBLE FOR THE MANUAL WATERING OF ALL LIGCATED TREESPANIS DURING MAINTENANCE OF PROOL UNTLE FINAL CONTRACTOR SHALL BE MERPONSIBLE FOR THE MANUAL WATERING OF ALL LIGCATED TREESPANIS DURING MAINTENANCE OF MOULUNE CONTRACTOR SHALL BE MERPONSIBLE FOR THE MANUAL WATERING OF ALL LIGCATED TREESPANIS DURING MAINTENANCE PROOL UNTLE FINAL

LANDSOFE CONTRACTOR SHALL BE RESPONSIBLE OF MINUTATION AND A LANDSOFE CONTRACTOR SHALL BE RESPONSIBLE OF MISTALLINA AND INITIANING TREEPAIM PROTECTION. INSTALL BARRICADE OF GALVANZED INITIANING TREEPAIM PROTECTION. INSTALL BARRICADE OF GALVANZED LEIDED WIRE FABRIC OR PLASTIC MESH TO ENCOMPASS THE DIPPLINE OF THE REFERAML BARRICADE SHALL BE PLANT. AND STORY, BARRICADE OF LEIFT LIP AND MAINTAINED UNTIL DIRECTED TO REMOVE BY LANDSOFE POINTERCT.

### TREE PROTECTION MATERIALS

POSTS: 2'X2' WOOD.

ACCESS: PROVIDE HINGED, LATCHING GATE. AERATION PIPE: RIGID PVC PERFORATED DRAINPIPE, 3 INCH DIAMETER X 4 EET LONG, WITH PERFORATED CAP. FILL WITH WASHED PEA GRAVEL.

### WARRANTY

I. LANDSCAPE CONTRACTOR SHALL PROVIDE A MINIMUM OF ONE (1) YEA GUARANTEE FOR ALL RELOCATED TREES, PALMS AFTER FINAL ACCEPTANCE B' LANDSCAPE ARCHITECT AND/OR CLIENT.

LANGEAPE PROFILED INJUDICED. 2. LANGESPECTURATOR SHALL REMOVE COMPLETELY AND DISPOSE OF OFF STIE. ANY RELOCATED TREEPAUL THAT FAILS TO THRIVE AS DETERMINED BY THE LANGEAPE ADMITTECT 3. FOR MY RELOCATED TREEPAUL REMOVED DUE TO ITS FALLIRE TO THRIVE LANDEGAPE CONTRACTOR SHALL BE RESPONSIBLE FOR REFLACING AND INSTALLING WITH A SPECIMEN OF EQUAL OR GREATER SPECIFICATION OF ORIGINAL REFLACEMENT MATERIAL SHALL BE APPRIVED BY LANGEAPE ACHITECT PROFIL OPPOCUENEENT, TREPARATION OR NEXTLALIATION.

### TREE / PALM RELOCATION NOTES

I. VERIFY AND INSURE ALL TREES/PALMS IDENTIFIED ON THE CONSTRUCTION DRAWINGS AND THOSE TAGGED IN THE FIELD CORRESPOND AS TO NUMBER AND DESCRIPTION. ANY DISCREPANCIES SHALL BE BROUGHT TO THI ATTENTION. OF THE LANDSCAPE ARCHITECT IMMEDIATELY, PRIOR TO DETERMINED AND THE CANDESCAPE ARCHITECT IMMEDIATELY. PRIOR TO DETERMINED. PREPAREMENT OF THE AND A CONTRACTOR SHALL BE RESPONSIBLE FOR THEE/PAU PROTECTION OF ALL VERIFIED MATERIAL. INSTALL BARRICADE OF GALVANIZE WELDED WIRE SPARIC OR PLASTIC USENT OF BUDGMASS THE DIRPLAY OF TH TREE/PAUM. BARRICADE TO BE REMOVED UPON COMPLETION OF BACKFILLING. 3. TREE ROOT BALL SHALL BE ROOT PRUNED 50% (EQUALLY AROUND TREE) 6 DAYS PRIOR TO TRANSPLANT. THE REMAINING 50% TO BE PRUNED 30 DAY PRIOR TO TRANSPLANTING.

4. PALMS TO BE RELOCATED MAY BE IMMEDIATELY RELOCATED AFTER DIGGIN A NOME TO BE RELEGATED WITH CLEAN, SHARP TOOLS, ROOTS ONE (1) INCH AN LARGER IN DIAMETER SHALL BE NEATLY AND CLEANLY CUT WITH A HAND SA OR OTHER APPROVED CUTTING IMPLEMENT.

I LANDSCAPE CONTRACTOR TO APPLY INFORMULZA APPLICATION TO ROOT DURING ROOT PRUNING AND DIGGING OPERATIONS. ALL PRUNING TO BI REVIEWED AND APPROVED BY LANDSCAPE ARCHITECT PRIOR TO PRUNING. 7. DEAD WOOD, CROSSING BRANCHES, AND GENERAL CANOPY PRUNING SI 7. DEAL WOOD, CHOSSING BHAVACHES, AND GENERAL CAROPP HAUMING SHA BE PERFORMED OF DIRECTED BY AN SA OR ASCA CHIEFIED ARBORIST ACCORDANCE. WITH THE LATEST VERSION IF THE ANSI A-300 PRUNIN STANDARDS AND GOOD HORTCUTURAL PRACTICES MINEMATELY ATT COMPLETION OF ROOT PRUNING OF EACH SPECIMEN TO BE RELOCATED A PRUNING TO BE REVIEWED AND APPROVED BY LANDSCAPE ARCHTECT PRIC TO PRUNING.

8. ROOT BALL SIZE TABLE

(NOTE: ROOT BALL SIZES SHALL EXCEED MINIMUM STANDARDS SET FORTH IN GRADES AND STANDARDS FOR NURSERY PLANTS, PART IL, PALMS AND TREES, FLORIDA DEPARTMENT OF AGRICULTURE)

10. ALL TREES TO BE FLOODED FOR FIVE (5) DAYS PRIOR TO TR 11. ALL PITS TO BE FILLED THE SAME DAY AND WITH CLEAN FILL IN 18 INCI LIFTS/LAYERS, EACH THEN COMPACTED BEFORE A SUBSEQUENT 18' LIFT/LAYEF IS PLACED. REPEAT UNTIL BACKFILL IS FLUSH WITH SURROUNDING GRADE.

CORRECT ALL PROBLEMS RELATED TO SETTLEMENT, EROSION, OR OTHER DISTRESS OF EXCAVATEDIDACKFILLED PT FROM WHICH TREEPALM HAS BEER REMOVED, INCLUDING THE COMPLETE AND THROUGH REMOVAL OF ALL RESIDUAL ROOTS, STUMPS AND PORTIONS AND PARTS THEREOF.

IS RESTORE THE SURFACE WITH MATERIAL TO MATCH ADJACENT AREAS MATERIAL TO BE APPROVED BY LANDSCAPE ARCHITECT. CONTRACTOR TO PROVIDE A MINIMUM ONE YEAR WARRANTY ON SETTLING AND PLANT MATERIAL

14. LANDSCAPE CONTRACTOR IS RESPONSIBLE FOR ALL MATERIAL INCLUE BUT NOT LIMITED TO BACKFILL MATERIAL, PROTECTION FENCING, FLAGG ROOT BALL BURLAP OR SHRINK WRAP.

VERIFY ALL UNDERGROUND CONSTRUCTIONS OR OBSTRUCTION UTILITIES. SEPTIC SYSTEMS, ETC.) ARE IDENTIFIED, LOCATED AND CASEAN WARKED AS PAPPORPARE PRIOR TO EXCANATION OF PLANTING PLATS OR FLECATED TREES AND PAULS. ANY UNKNOWN OBJECTS SHULL BE BROUGHT TO HEATTENTION OF THE LANGEDER ARCHITECT MILEMENTELY. REPORT ON INSTALLING AND OF THE LANGEDER ARCHITECT DIRECTORY.

2. LANDSCAPE CONTRACTOR TO FLAG ALL PROPOSED PLANT LOCATIONS FOR LANDSCAPE ARCHITECTS APPROVAL PRIOR TO INSTALLATION. 3. PLANTING PITS SHALL BE A MINIMUM OF TWO (2) TIMES LARGER IN DIAMETE AND ONE AND A HALF (1-1/2) TIMES LARGER IN DEPTH THAN THE ROOT BAL ROUGHEN SIDES AND BOTTOM OF PIT.

HOUGHEN SILES AND BOTTOM OF HT. A AFTER BCH ANTINE PTT IS DEVIANTED, PTACE SUFFICIENT PLATTING MX IN BOTTOM OF EXCAVATION, AND SEAT PLANT, INSURING TOP OF ROOT BALL IS FULSH MITH IMMEDIATELY ADJACENT FINAL OR PROFOSED GRADE. S LANDSCAPE CONTINUENT AND AND ADJACENT FINAL OR PARONSED GRADE. IS LANDSCAPE CONTINUENT AND ADJACENT FINAL OR PARONSED GRADE. THE CORRECT ELEVATION. REFER TO HARDSCAPE FLANS AND CALL ENGINEERS OPUDIALE DAVE FOR PROFORD DE LEVATOR.

GRADING PLANS FOR PROPOSED SITE ELEVATIONS 6. LANDSCAPE CONTRACTOR TO INSURE ALL ROOT FLARES ARE EXPOSED. 7. CENTER EACH RELOCATED TREE/PALM IN ITS PLANTING PIT AND BACKFI

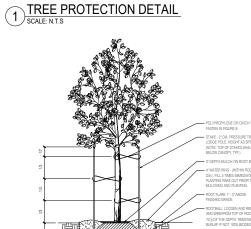
8. PLACE PLANTING MIX IN 12 INCH LIFTS/LAYERS AROUND ROOT BALL ANI COMPACT UNTIL ALL VOIDS ARE FILLED WITH COMPACTED PLANTING MIX.

9. BUILD SOIL SAUCER OF MOUNDED EXCAVATED SOIL AROUND PERIMETER O EACH PLANTING PIT TO FORM WATERING BASIN, MULCH TO A DEPTH OF 3'.

INSTALLATION

BACKFILLING.

WITH SPECIFIED PLANTING MIX



527

THE TREE PROTECTION BARRICADE SHALL BE AT LEAST FOUR (II) FEET HIGH. THE BARRIER SHALL CONSIST O EITHER A WOOD FORCE WITH 2X POSTS PLACED A MAXMMUM OF BIAHT (B) FEET APART, WITH A 2X MINIMUM TOP PAIN OR A TEMPORAPY THE WESH FENCE, OF OTHER SMILLING REPRETIVENCY WILL LUMIX TACCESS TO THE PROTECTED AREA THE BARRICADE SHALL BE AT LEAST ONE FOOT IN DURATEINF FOR BACIT HANC'S MOTION FEROTEER FOR A 2) TREES LESS THAT I'S DIEN, HE MINIMUM ARARIDOLS SHALL BE PLACIDAT LESST (B) FEET AWAY

THE BOOL OF THE ADDRESS OF THE ADDRESS

IAX. BETWEEN POST

NOTES


IOM THE BASE OF THE TREE.

TIONS OR ANY SITE DEVELOPMENT




# 4 SMALL TREE PLANTING AND STAKING DETAIL

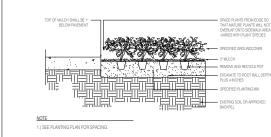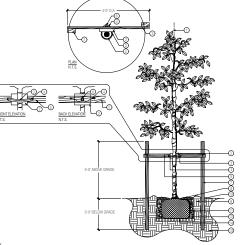. ID STARII ITV







### 7.) 2.2" X.4" X 8 P.T. LANDSCAPE TIMBER AS SPECIFIED. 14.) COMPACT SOIL IMMEDIATELY BENEATH THE R1.2" MI II CH DEPTH LAYER ON ROOT BALL. ROOT BALL TO PREVENT SETTLING. ) SET TREE PLUMB IN PLANTING PIT. ) PROTECT TREE TRUNK WITH 1 NOMACO ® 8. 2" MULCH DEPTH LAYER ON ROOT BALL () HOLELT THEE THONK WITH T NUMAEU ® TYROFOAM PADDING GUAPDS, #60048048, S SPECIFIED, OR APPROVED EQUAL. ) AMAZON HOUSE AND RUBBER ®. 1 ½ AIR OSE #K1146 OR APPROVED EQUAL, TO 6.12 INDUCH DE'T I AUTEN OWNOOT BALL. 9.4 WATER RING, (WITHIN ROTBALL DIA), FILL3 TIMES IMMEDIATLEY AFTER PLANTING, RAKE OUT PRIOR RO MULCHING AND PLATING. DI) ROOT FLARE 1":2" ABOVE FINSHED GRADE. 11.) B&B OR CONTAINERIZED ROOTBALL REMOVE 10 GAUGE GALVANIZED WIRE. WIRE ALL BURLAP IF NOT 100% BIODEGRADABLE REMOVE CONTAINER FROM ROOTBALL PRIOR REMOVE CONTAINER FROM ROOTBALL PRIOR TO PLANTING. 12) BACKFILL TOP SOIL TYP. OR AREA. BACKFILL DUCT (8, OR APPROVED EQUAL. 2" X 4" X 4" NON TREATED LANDSCAPE DECK SCREWS TO 2" X 4" X 8' P.T. LANDSCAPE SHALL BE AMENDED THROUGHOUT ENTIRE SIT WITH FERTILIZER AND COMPOST AS REQUIRED

13.) UNDISTURBED SUBGRADE.

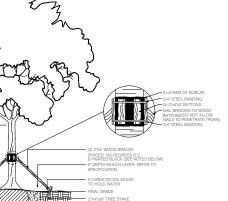
GAUGE WIRE

2 MEDIUN SCALE: N.T.S

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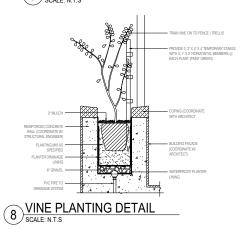
NOTES: 1) CONTRACTOR TO ASSURE PERCOLATION 2.) NO MULCH WITHIN 4" OF TRUNK.


MEDIUM TREE PLANTING & STAKING DETAIL



# 5 LARGE TREE PLANTING AND STAKING DETAIL

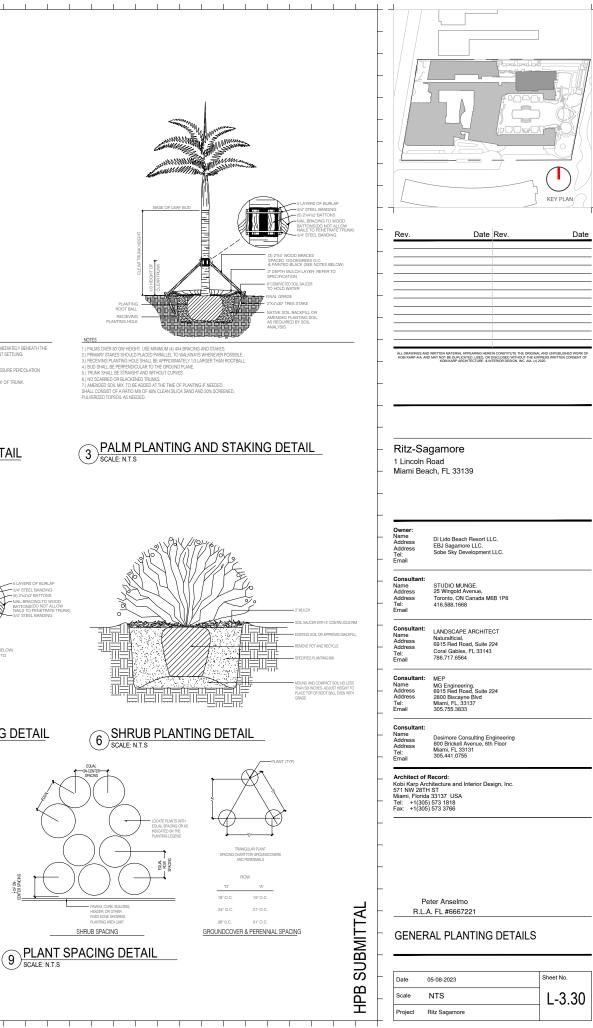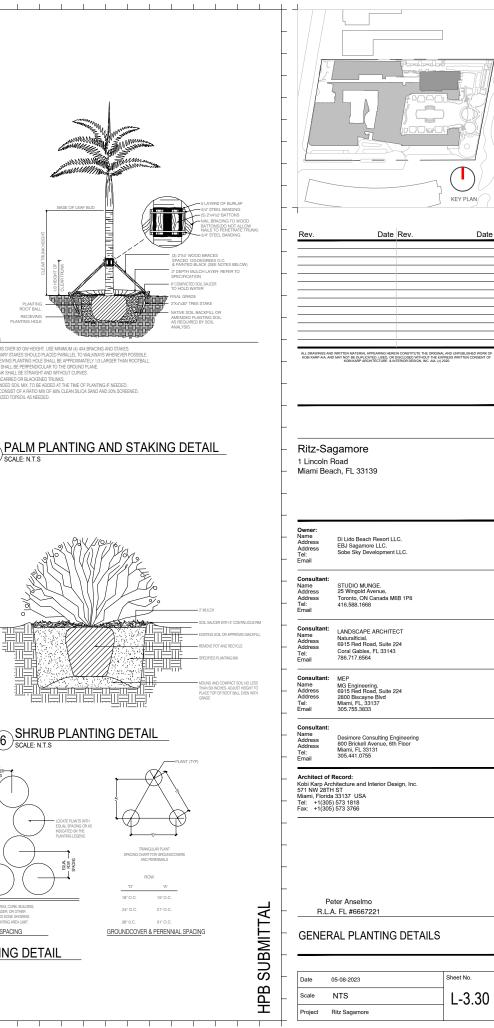
NATIVE SOIL BACKFILL OF AMENDED PLANTING SOF AS REQUIRED BY SOIL

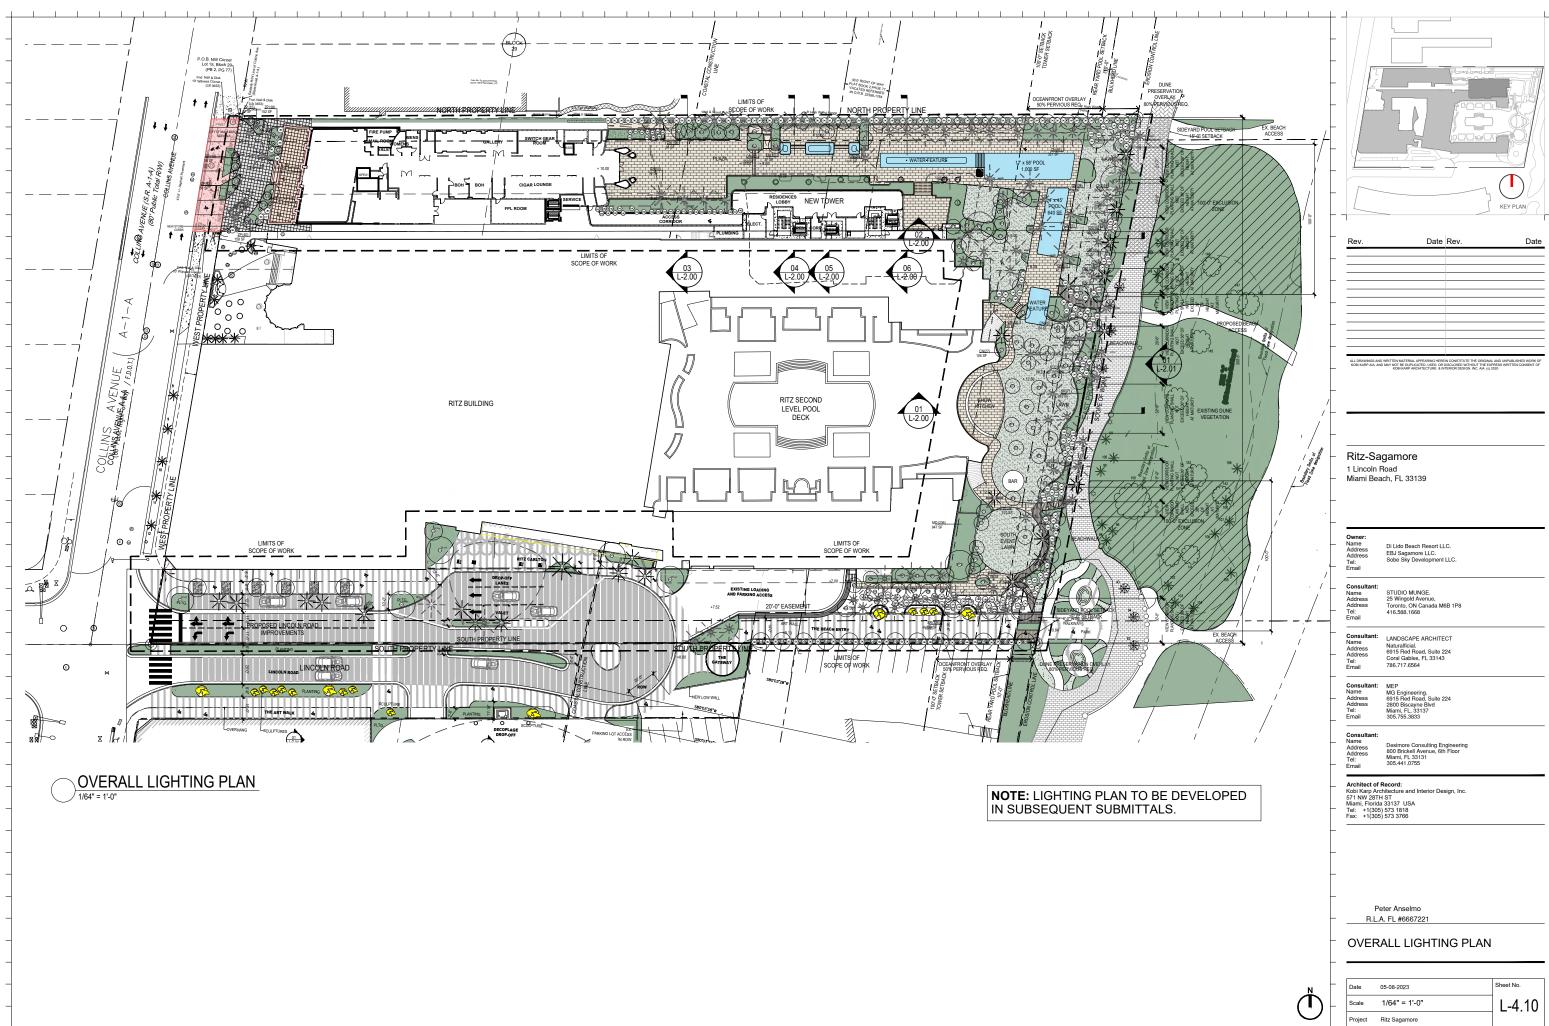






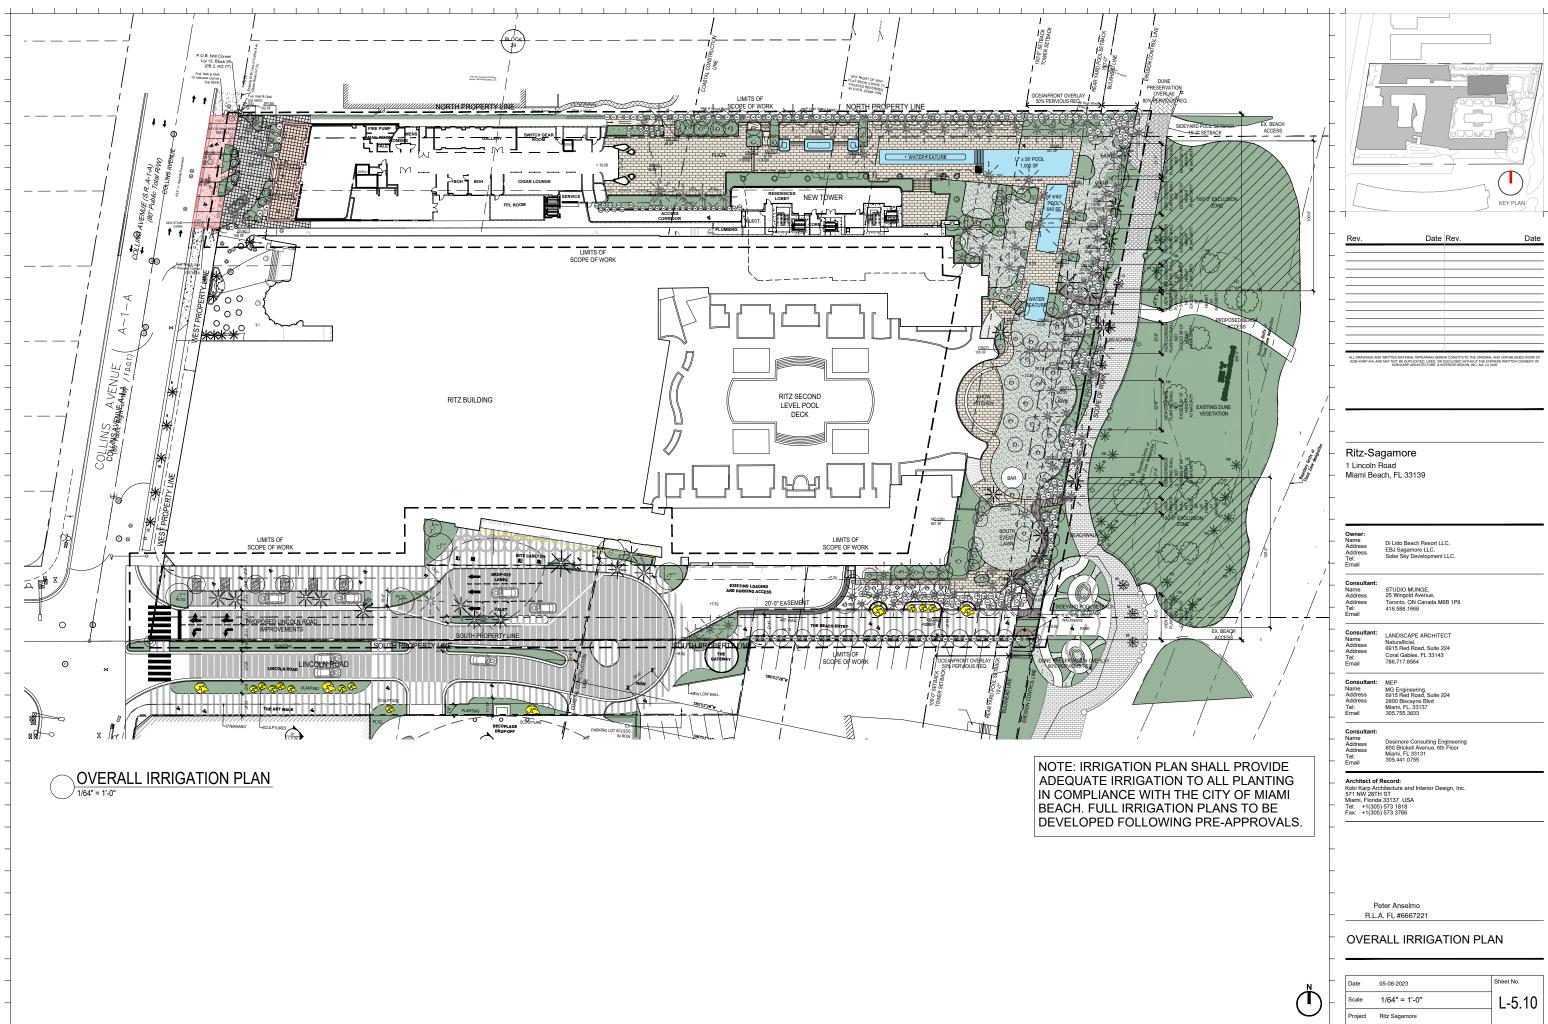






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Date	05-08-2023	Sheet No.
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