
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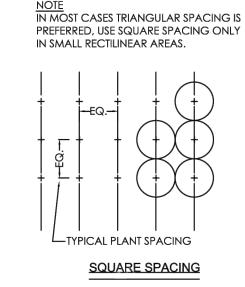
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MIN.2x4x6WD. BATTENS SECURED W/METAL OR ω PLASTIC BANDING STRAPS DO NOT NAIL TO TREE. USE ADD'L BATTENS IF NECESSARY SAUCER-LIKE TREE -WELL, MIN. 3" DEEP REMOVE BURLAP FROM TOP OF **EUCALYPTUS MULCH** 2x4x30" P.T. WOOD STAKES TO ANCHOR PROP.DRIVE FIRMLY INTO GROUND


SPECIMEN TREE AND TALL PALMS SUPPORT DETAIL

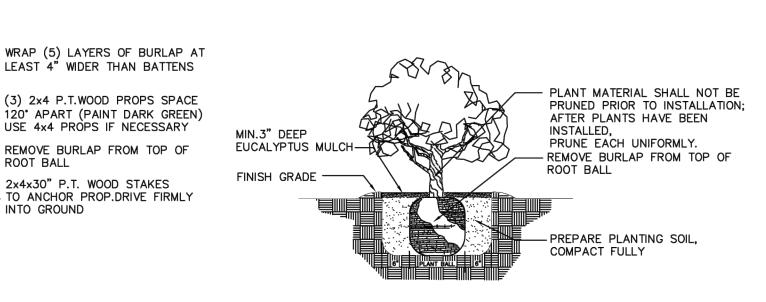




TYPICAL SHRUB PLANTING DETAIL


PLANT LOCATIONS-TYPICAL PLANT SPACING RIANGULAR SPACING

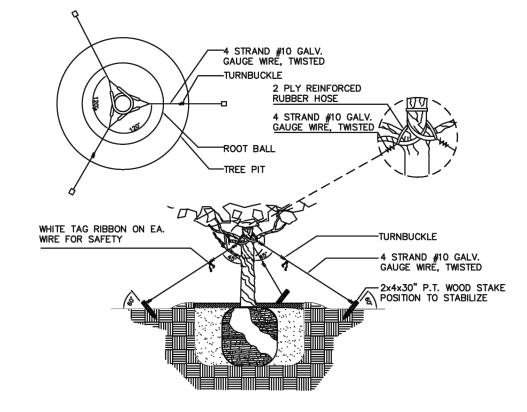

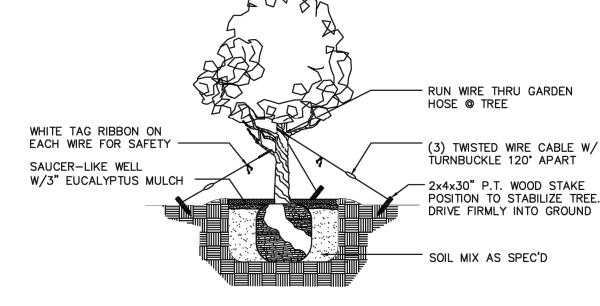

SMALL TREE SUPPORT DETAIL

Native

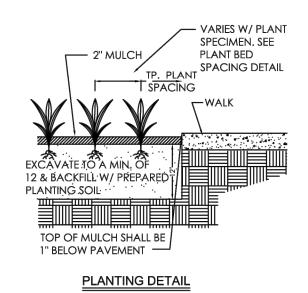

TREE PLANTING AND GUYING DETAIL

Specifications

07/26/2019 PARK AVE

PLANT LIST

Oty Botanical/Common Name

(12 each from Levels 2 to 5)

(14 on Level 1)

Botanical/Common Name	Specifications	Native
TREES & PALMS		
Alphonse karr bamboo Alphonse karr bamboo	25 gal.	N
Coccoloba diversifolia Pigeon Plum	8'-10' ht. x 6'-8' sp.	Y
Cocos nucifera 'Green Malayan' Coconut Palm	8' wd., 2 Street Trees	N
Dypsis cabadae Cabada Palm	3 trunks each cluster 6'-8' wd.	N
Myrcianthes fragrans	10'-12' ht. x 8'-10' sp., field grown, 2 Street Trees	Y
Native tree Native Tree	12'-14' ht. x 10'-12' sp., field grown	Y
Ptychosperma macarthurii Macarthur Palm	8'-12' wd., mixed heights, field grown	N
Sabal Palmetto Sabal Palm	crooked, curved trunks, planted as per plan 8'-22' wd., regenerated heads, 3 Street Trees	Y
Thrinax radiata Florida Thatch Palm	8'-12' ht. x 6'-8 sp.	Y
Cocothrinax miraguama Miraguama Palm	5'-7' clear wood x 6' sp.	Y
Botanical/Common Name	Specifications	
SHRUBS AND GROUND COVERS		
Alcantarea vinicolor Alcantarea vinicolor	7 gal.	N
Ernodea littoralis Golden Creeper	1 Gal., o.c. – 8"	Y
Pennisetum setaceum White Fountain Grass	36" o.c.	N
Philodendron 'Weeks Red' Weeks Red Philodendron	10 gal. 36" o.c.	N
Tripsacum dactyloides (dwarf) Dwarf Fakahatchee Grass	7 gal. 36" o.c.	Y
Spartina alterniflora Cordgrass	3 gal. 36" o.c.	Y
Mauna loa spathyphyllum	7 gal. 48" o.c.	Y
Stephanotis floribunda Madagascar Jasmine	7 gal. 36" o.c.	Y
	TREES & PALMS Alphonse karr bamboo Alphonse karr bamboo Coccoloba diversifolia Pigeon Plum Cocos nucifera 'Green Malayan' Coconut Palm Dypsis cabadae Cabada Palm Myrcianthes fragrans Simpson Stopper Native tree Native Tree Ptychosperma macarthurii Macarthur Palm Sabal Palmetto Sabal Palm Thrinax radiata Florida Thatch Palm Cocothrinax miraguama Miraguama Palm Botanical/Common Name SHRUBS AND GROUND COVERS Alcantarea vinicolor Alcantarea vinicolor Ernodea littoralis Golden Creeper Pennisetum setaceum White Fountain Grass Philodendron 'Weeks Red' Weeks Red Philodendron Tripsacum dactyloides (dwarf) Dwarf Fakahatchee Grass Spartina alterniflora Cordgrass Mauna loa spathyphyllum Peace Lily Stephanotis floribunda	TREES & PALMS Alphonse karr bamboo Alphonse karr bamboo Coccoloba diversifolia Pigeon Plum Cocos nucifera 'Green Malayan' Coconut Palm Dypsis cabadae Cabada Palm Myrcianthes fragrans Simpson Stopper Native tree Native Tree Ptychosperma macarthurii Macarthur Palm Sabal Palmetto Sabal Palmett

RELOCATED MATERIAL

Cocos Nucifera 'Green Mayalan'

Coconut Palm Conocarpus erectus

Green Buttonwood

	Green Buttonwood			
	CITY OF MIAMI BEACH			
	LANDSCAPE LEGEND			
	INFORMATION REQUIRED TO BE PERMANENTLY AFFIXED TO PLANS			
	•	cres 0.51 acres	_	
		REQUIRED/		
	OPEN SPACE	ALLOWED	PROVIDED	
A.	Square feet of required Open Space as indicated on site plan:			
	Lot Area = $22,236$ s.f.x 30 % = $6,670$ s.f.	6,670 s.f.	7,192 s.f.	
В.	Square feet of parking lot open space required as indicated on site plan:			
	Number of parking spaces N/A x 10 s.f. parking space =	N/A	N/A	
C.	Total square feet of landscaped open space required: A+B=	6,670 s.f.	7,192 s.f.	
	LAWN AREA CALCULATION	0.070 - 1	7 102 o f	
A.	Square feet of landscaped open space required Maximum lawn area (sod) permitted= $30 \% \times 6,670 \text{ s.f.}$	6,670 s.f.	7,192 s.f.	
В.	Maximum lawn area (sod) permitted=	2001 s.f.	<u>0 s.f.</u>	
	TREES			
A.	TREES Number of trees required per lot or net lot acre, less existing number of			
Λ.	trees meeting minimum requirements=			
		12	19	
В.	% Natives required: Number of trees provided x 30% =	6	19	
C.	% Low maintenance / drought and salt tolerant required:	40	10	
_	Number of trees provided x 50%=	10	19	
D.	Street Trees (maximum average spacing of 20' o.c.) 237 linear feet along street divided by 20'=	12		REES)
E.	Street tree species allowed directly beneath power lines:		13 (101)	ALIVIO ,
	(maximum average spacing of 20' o.c.):			
	N/A linear feet along street divided by 20'=	N/A	N/A	
	CUDUDE			
	SHRUBS	222		
Α.	Number of shrubs required: Sum of lot and street trees required x 12=	228	228	
В.	% Native shrubs required: Number of shrubs provided x 50%=	114	114	
	LARGE SHRUBS OR SMALL TREES			
A.	Number of large shrubs or small trees required: Number of required shrub)S		
,	v. 100/_	23	23	

3

B. % Native large shrubs or small trees required: Number of large shrubs or

small trees provided x 50%=

GENERAL LANDSCAPE NOTES:

1. ALL PLANT MATERIAL IS TO BE FLORIDA NO. 1 OR BETTER. FLORIDA DEPARTMENT OF AGRICULTURE GRADES AND STANDARDS, PARTS I & II 1973, 1975 RESPECTIVELY.

- 2. ALL PLANTING BEDS TO BE TOPPED WITH 2"MIN. "GRADE A" CYPRESS OR **EUCALYPTUS MULCH, UNLESS OTHERWISE NOTED.**
- 3. ALL TREES TO BE STAKED IN A GOOD WORKMANLIKE MANNER. NO NAIL STAKING PERMITTED. (REFER TO PLANTING DETAILS.)
- 4. LANDSCAPE PLAN SHALL BE INSTALLED IN COMPLIANCE WITH ALL LOCAL
- 5. ALL TREE HOLDS TO BE BACK FILLED AROUND AND UNDER ROOT BALL WITH PLANTING SOIL. ALL SHRUB BEDS TO BE INSTALLED WITH PLANTING SOIL. (SEE SPECS)
- 6. SOD SHALL BE "FLORATAM" ST. AUGUSTINE (UNLESS OTHERWISE NOTED) SOLID SOD LAID WITH ALTERNATIVE AND ABUTTING JOINTS, WITH 2" TOP SOIL MINIMUM IF REQUIRED. (SEE SPECS)
- 7. ALL TREES, SHRUBS AND GROUND COVERS SHALL BE GUARANTEED FOR TWELVE MONTHS FROM DATE OF FINAL ACCEPTANCE. ALL PALMS ARE TO BE **GUARANTEED FOR ONE YEAR.**
- 8. ALL PLANTING BEDS SHALL BE WEED AND GRASS FREE.
- 9. ALL TREES, PALMS, SHRUBS AND GROUNDCOVER PLANTS SHALL BE FERTILIZED AT INSTALLATION WITH LONG LASTING FERTILIZER, ACCORDING TO MANUFACTURES RECOMMENDATIONS. (SUBMIT SAMPLE FOR APPROVAL.) (SEE
- 10. PLANTING PLAN SHALL TAKE PRECEDENCE OVER PLANT LIST IN CASE OF DISCREPANCIES. (NOTIFY LANDSCAPE ARCHITECT FOR DIRECTION.)
- 11. LANDSCAPE CONTRACTOR SHALL LOCATE AND VERIFY ALL UNDERGROUND UTILITIES PRIOR TO DIGGING.
- 12. NO CHANGE SHALL BE MADE WITHOUT THE PRIOR CONSENT OF THE LANDSCAPE ARCHITECT.
- 13. ALL MATERIAL IS SUBJECT TO AVAILABILITY AT TIME OF INSTALLATION. SUBSTITUTIONS MAY BE MADE AFTER CONSULTATION WITH LANDSCAPE ARCHITECT.
- 14. ALL NEWLY PLANTED AREAS TO RECEIVE 100% COVERAGE BY AUTOMATIC **IRRIGATION SYSTEM. (REFER TO IRRIGATION PLAN.)**
- 15. ALL PLANTING BEDS TO RECEIVE NEW PLANTING SOIL (1/3 EVERGLADES PEAT, 1/3 SAND, 1/3 CYPRESS SAWDUST & CHOPS) MINIMUM 6" DEEP. (REFER TO PLANTING **DETAILS.)**
- 16. CONTRACTOR WILL VISIT SITE TO FAMILIARIZED HIMSELF WITH THE SCOPE OF **WORK PRIOR TO SUBMITTING A BID.**
- 17. LANDSCAPE CONTRACTOR TO COORDINATE HIS WORK WITH THE GENERAL CONTRACTOR, THE IRRIGATION CONTRACTOR, AND THE ELECTRICAL CONTRACTOR.
- 18. ALL EXISTING PLANT MATERIAL TO REMAIN SHALL BE PROTECTED. (REFER TO **DEMOLITION PLAN.)**
- 19. ALL TREES TO BE RELOCATED WILL GET ROOT PRUNED 30 DAYS MIN. (OR MORE IF REQUIRED BY THE SPECIES). UPON RELOCATION, THIN OUT (UNDER LANDSCAPE ARCHITECT'S DIRECTION) 30% OF THE TREE CANOPY TO BE RELOCATED.
- 20.AFTER REMOVAL OR RELOCATION OF EXISTING TREES AND PALMS, BACKFILL TREE PIT WITH PLANTING SOIL AND SOD DISTURBED AREA, AS REQUIRED.
- 21.ALL TREES ON SOD AREAS SHALL RECEIVE A MULCH RING 2' IN DIAMETER TYPICAL
- 22.ALL TREES SHALL HAVE A 2" CALIPER AT D.B.H. MINIMUM FOR A 10' HEIGHT TREE.
- 23.ALL 1 GALLON MATERIAL TO HAVE A 12" SPREAD MINIMUM, ALL 3 GALLON MATERIAL TO HAVE A 20-24" SPREAD MINIMUM.

TREE BRACING NOTES:

- 2" AND LARGER CALIPER TREES BRACED BY GUYING -
- 1. CHOOSE THE CORRECT SIZE AND NUMBER OF STAKES AND SIZE OF HOSE AND WIRE. GUYING SHALL BE COMPLETED WITHIN 48 HOURS OF PLANTING THE TREE.
- 2. CUT LENGTHS OF STAKING HOSE TO EXTEND 2 INCHES PAST TREE TRUNK WHEN WRAPPING AROUND.
- 3. SPACE STAKES EVENLY ON OUTSIDE OF WATER RING AND DRIVE EACH FIRMLY INTO THE GROUND. STAKES SHOULD BE DRIVING AT A 30 DEGREE ANGLE WITH THE POINT OF THE STAKE TOWARD THE TREE UNTIL 4 TO 5 INCHES ARE LEFT SHOWING.
- 4. PLACE THE HOSE AROUND THE TREE TRUCK JUST ABOVE THE LOWEST BRANCH.
- 5. THREAD THE WIRE THROUGH THE HOSE AND PAST THE STAKE, ALLOWING APPROXIMATELY 2 FEET OF EACH OF THE TWO ENDS BEYOND THE STAKE BEFORE CUTTING THE WIRE.
- 6. TWIST WIRE AT RUBBER HOSE TO KEEP IT IN PLACE.

2

- 7. PULL WIRE DOWN AND WIND BOTH ENDS AROUND STAKE TWICE. TWIST WIRE BACK ONTO ITSELF TO SECURE IT BEFORE CUTTING OFF THE EXCESS.
- 8. THE ABOVE PROCEDURES ARE TO BE FOLLOWED FOR EACH STAKE, KEEPING THE TREE STRAIGHT AT ALL TIMES. THERE SHOULD BE A 1 TO 3 INCH SWAY IN THE TREE (THE WIRES SHOULD NOT BE PULLED TIGHT) FOR BEST ESTABLISHMENT.
- 9. FLAG THE GUY WIRES WITH SURVEYOR'S FLAGGING OR APPROVED EQUAL FOR SAFETY.
- 10. GUYS ARE NOT TO BE REMOVED UNTIL APPROVED BY LANDSCAPE CONTRACTOR.

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AS APPROVED ON HPB MEETING OF SEPTEMBER 9, 2019 - FILE No. HPB18-0252

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Consultant

David J. Odishoo

RLA-6666969 **HPB SUBMITTAL**

05/08/2023 Scale

AS SHOWN Project No.

Sheet Name PLANTING DETAILS AND NOTES

> Sheet No. **L-3**



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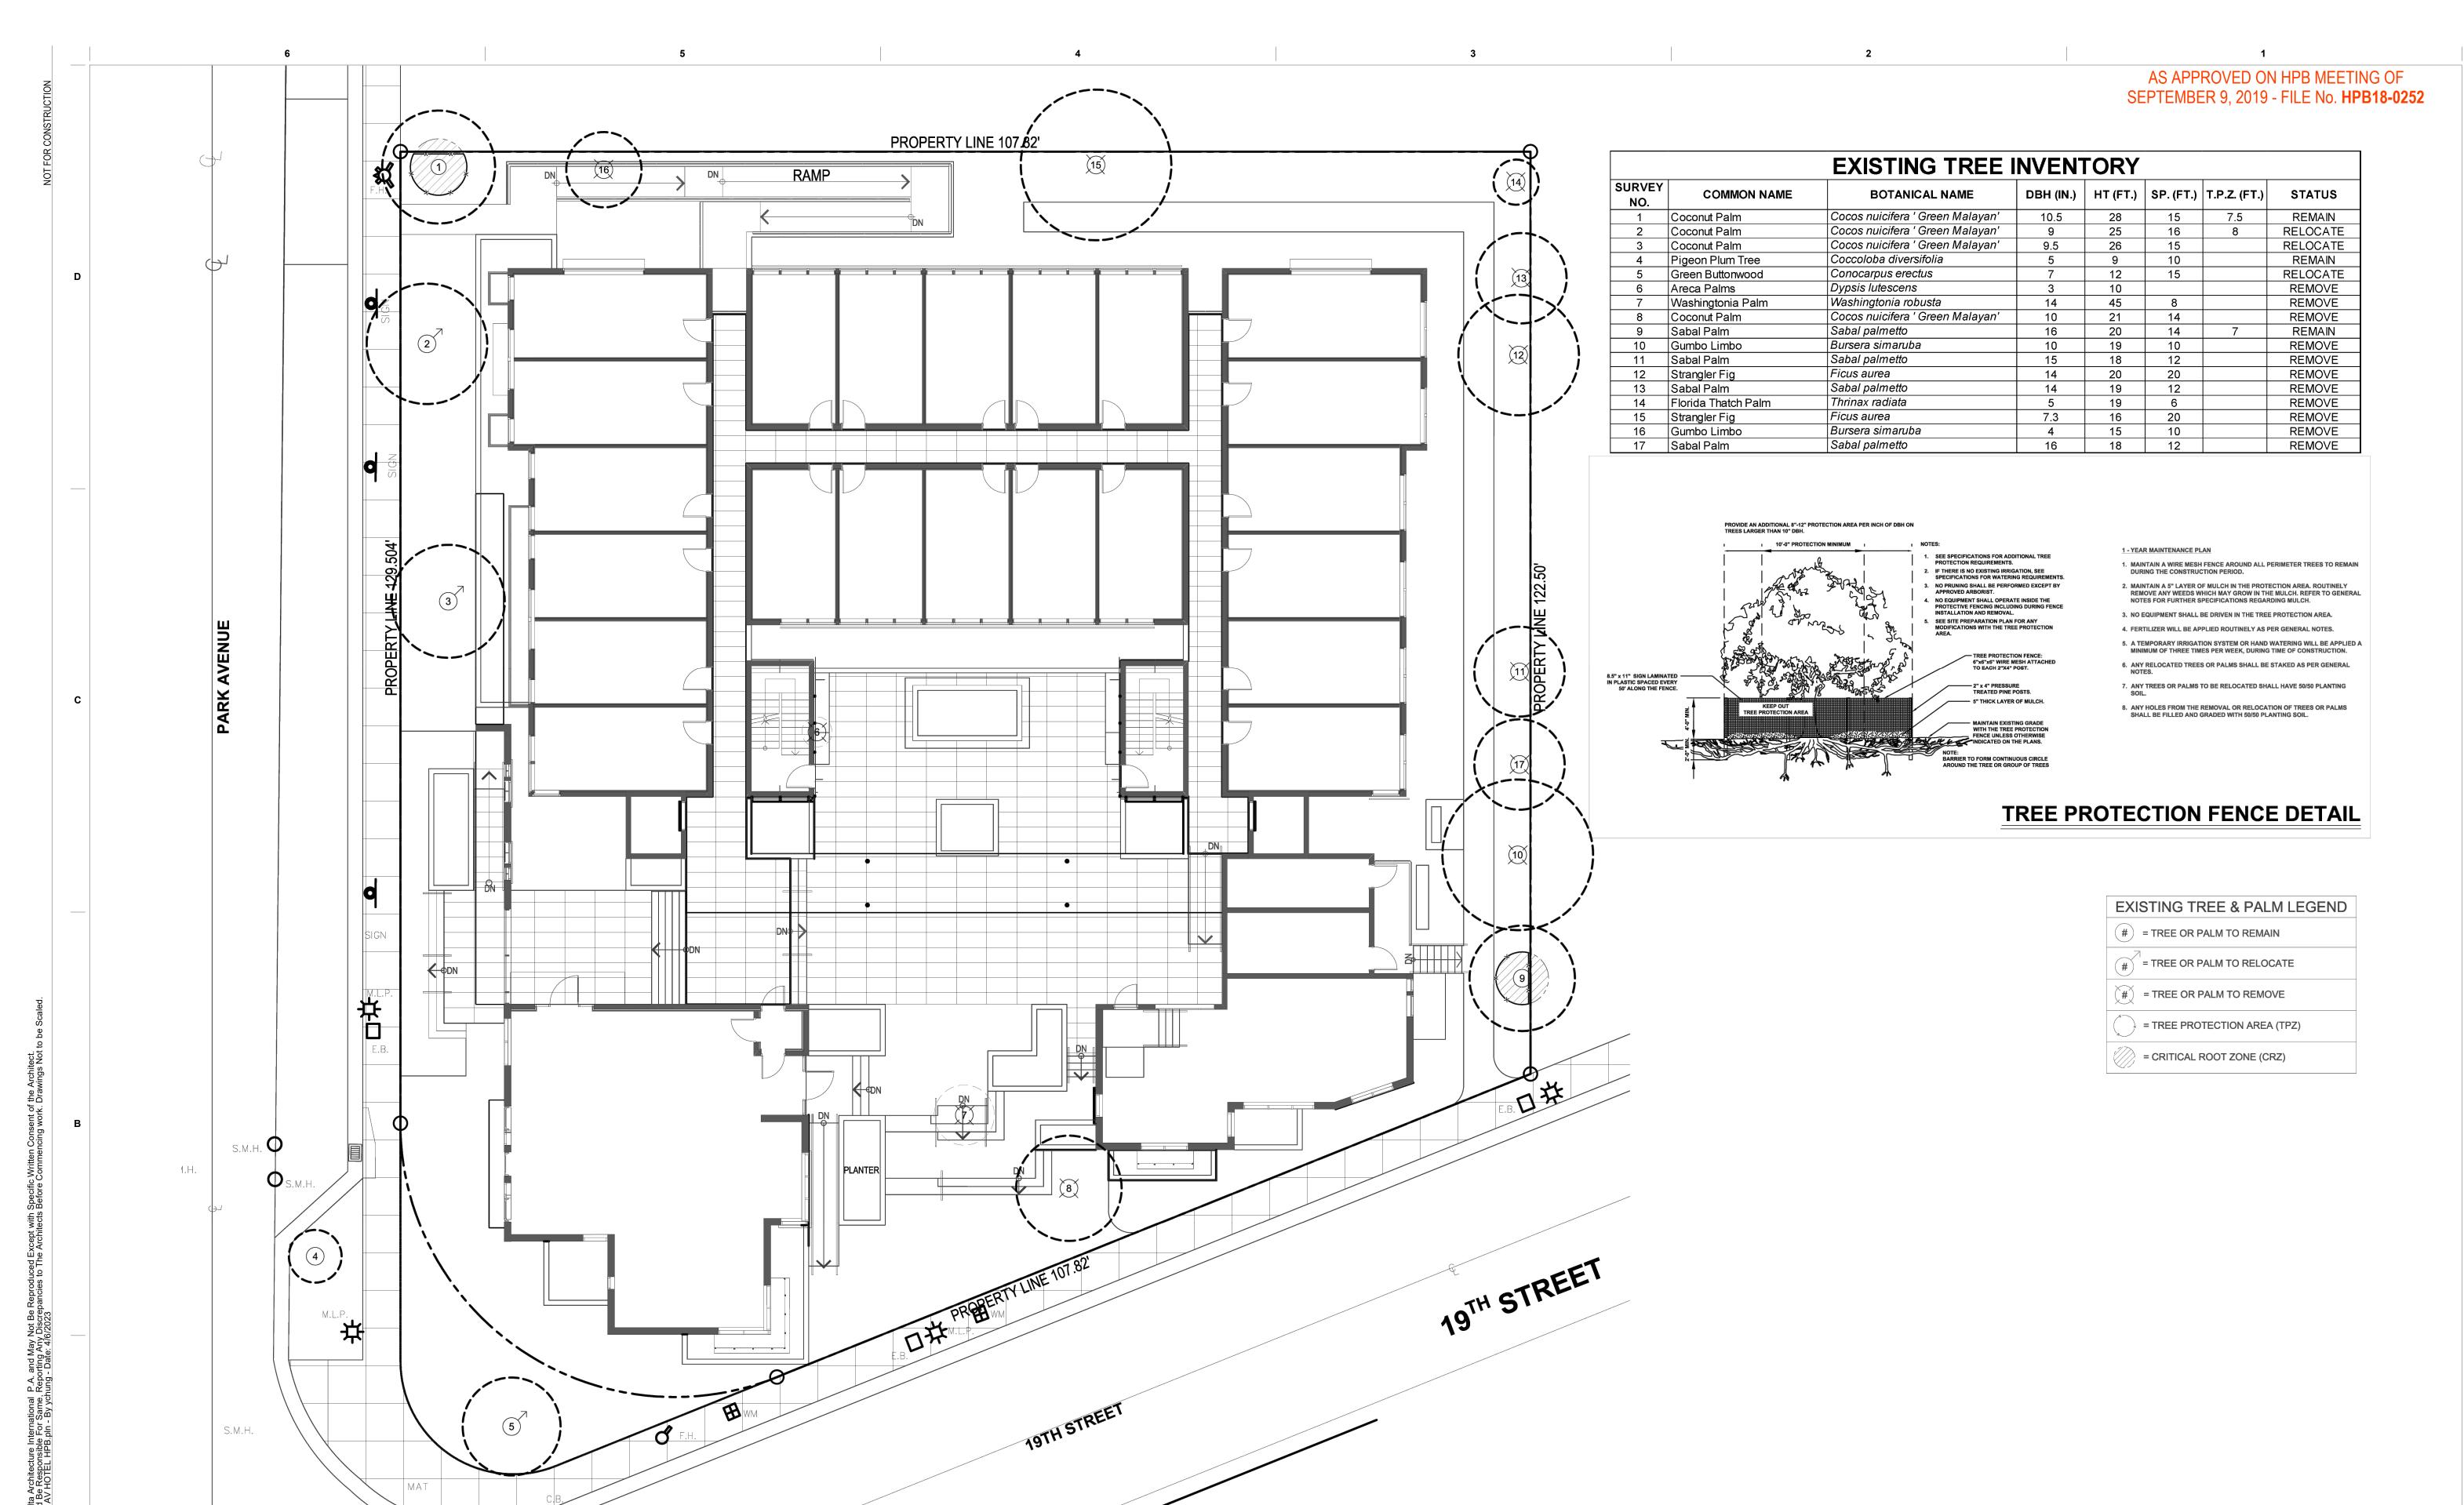
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TREE DISPOSITION PLAN

SCALE: 1/10" = 1'-0"



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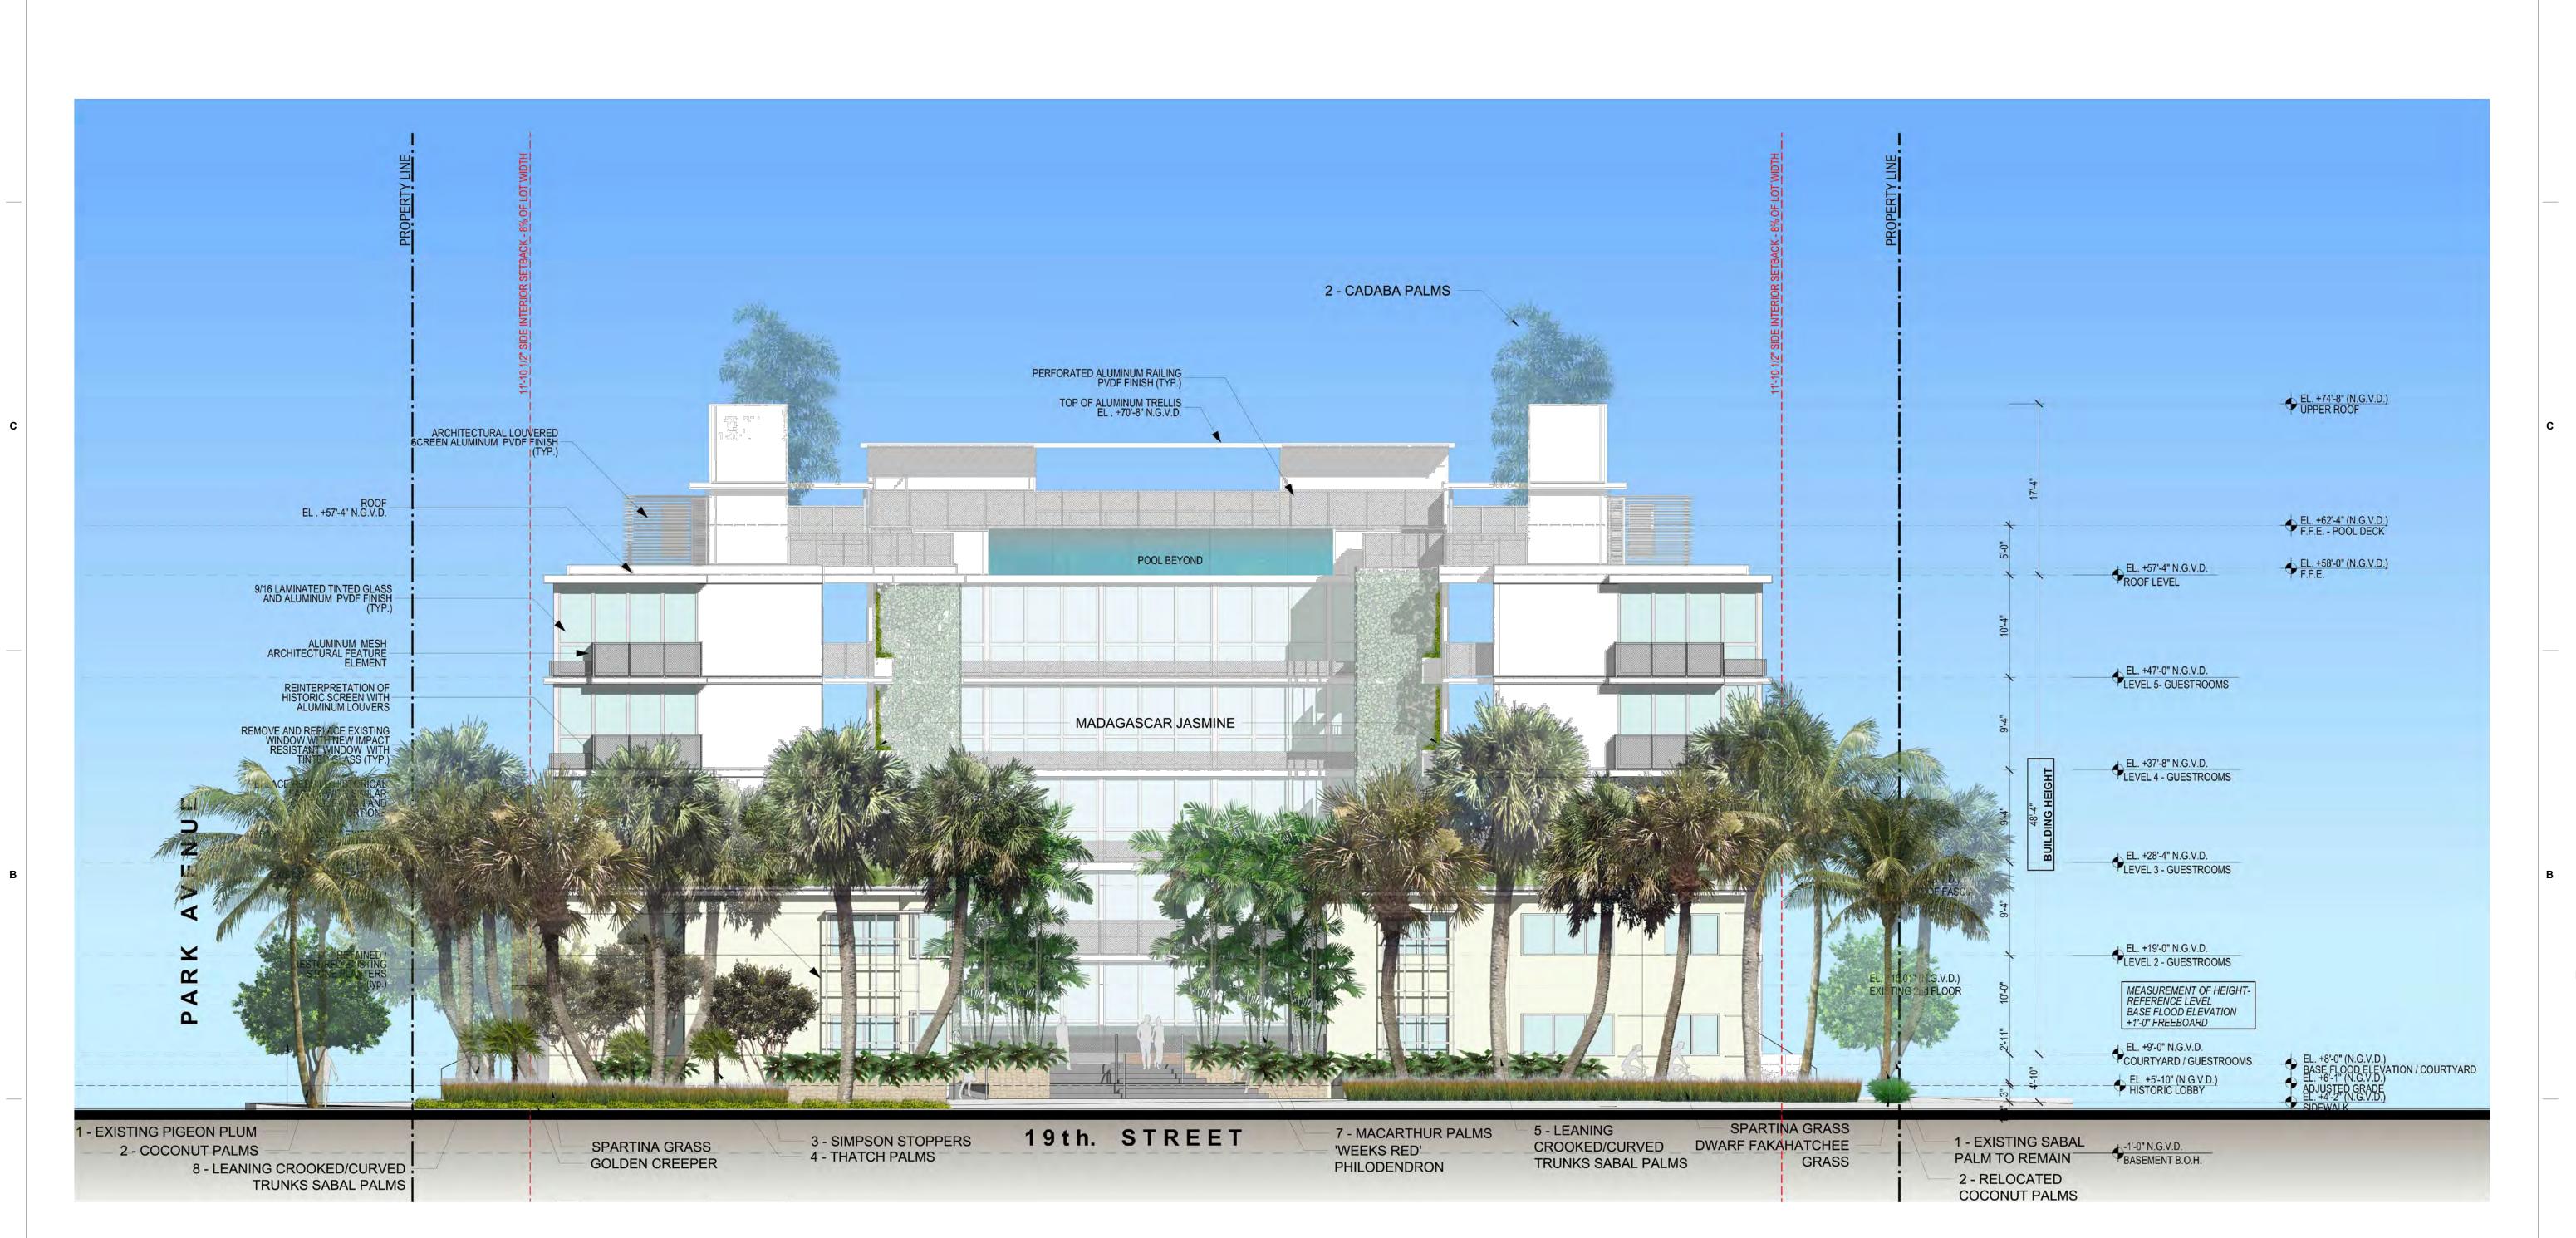
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Sheet Name SOUTH ELEVATION

Sheet No. **L-5**



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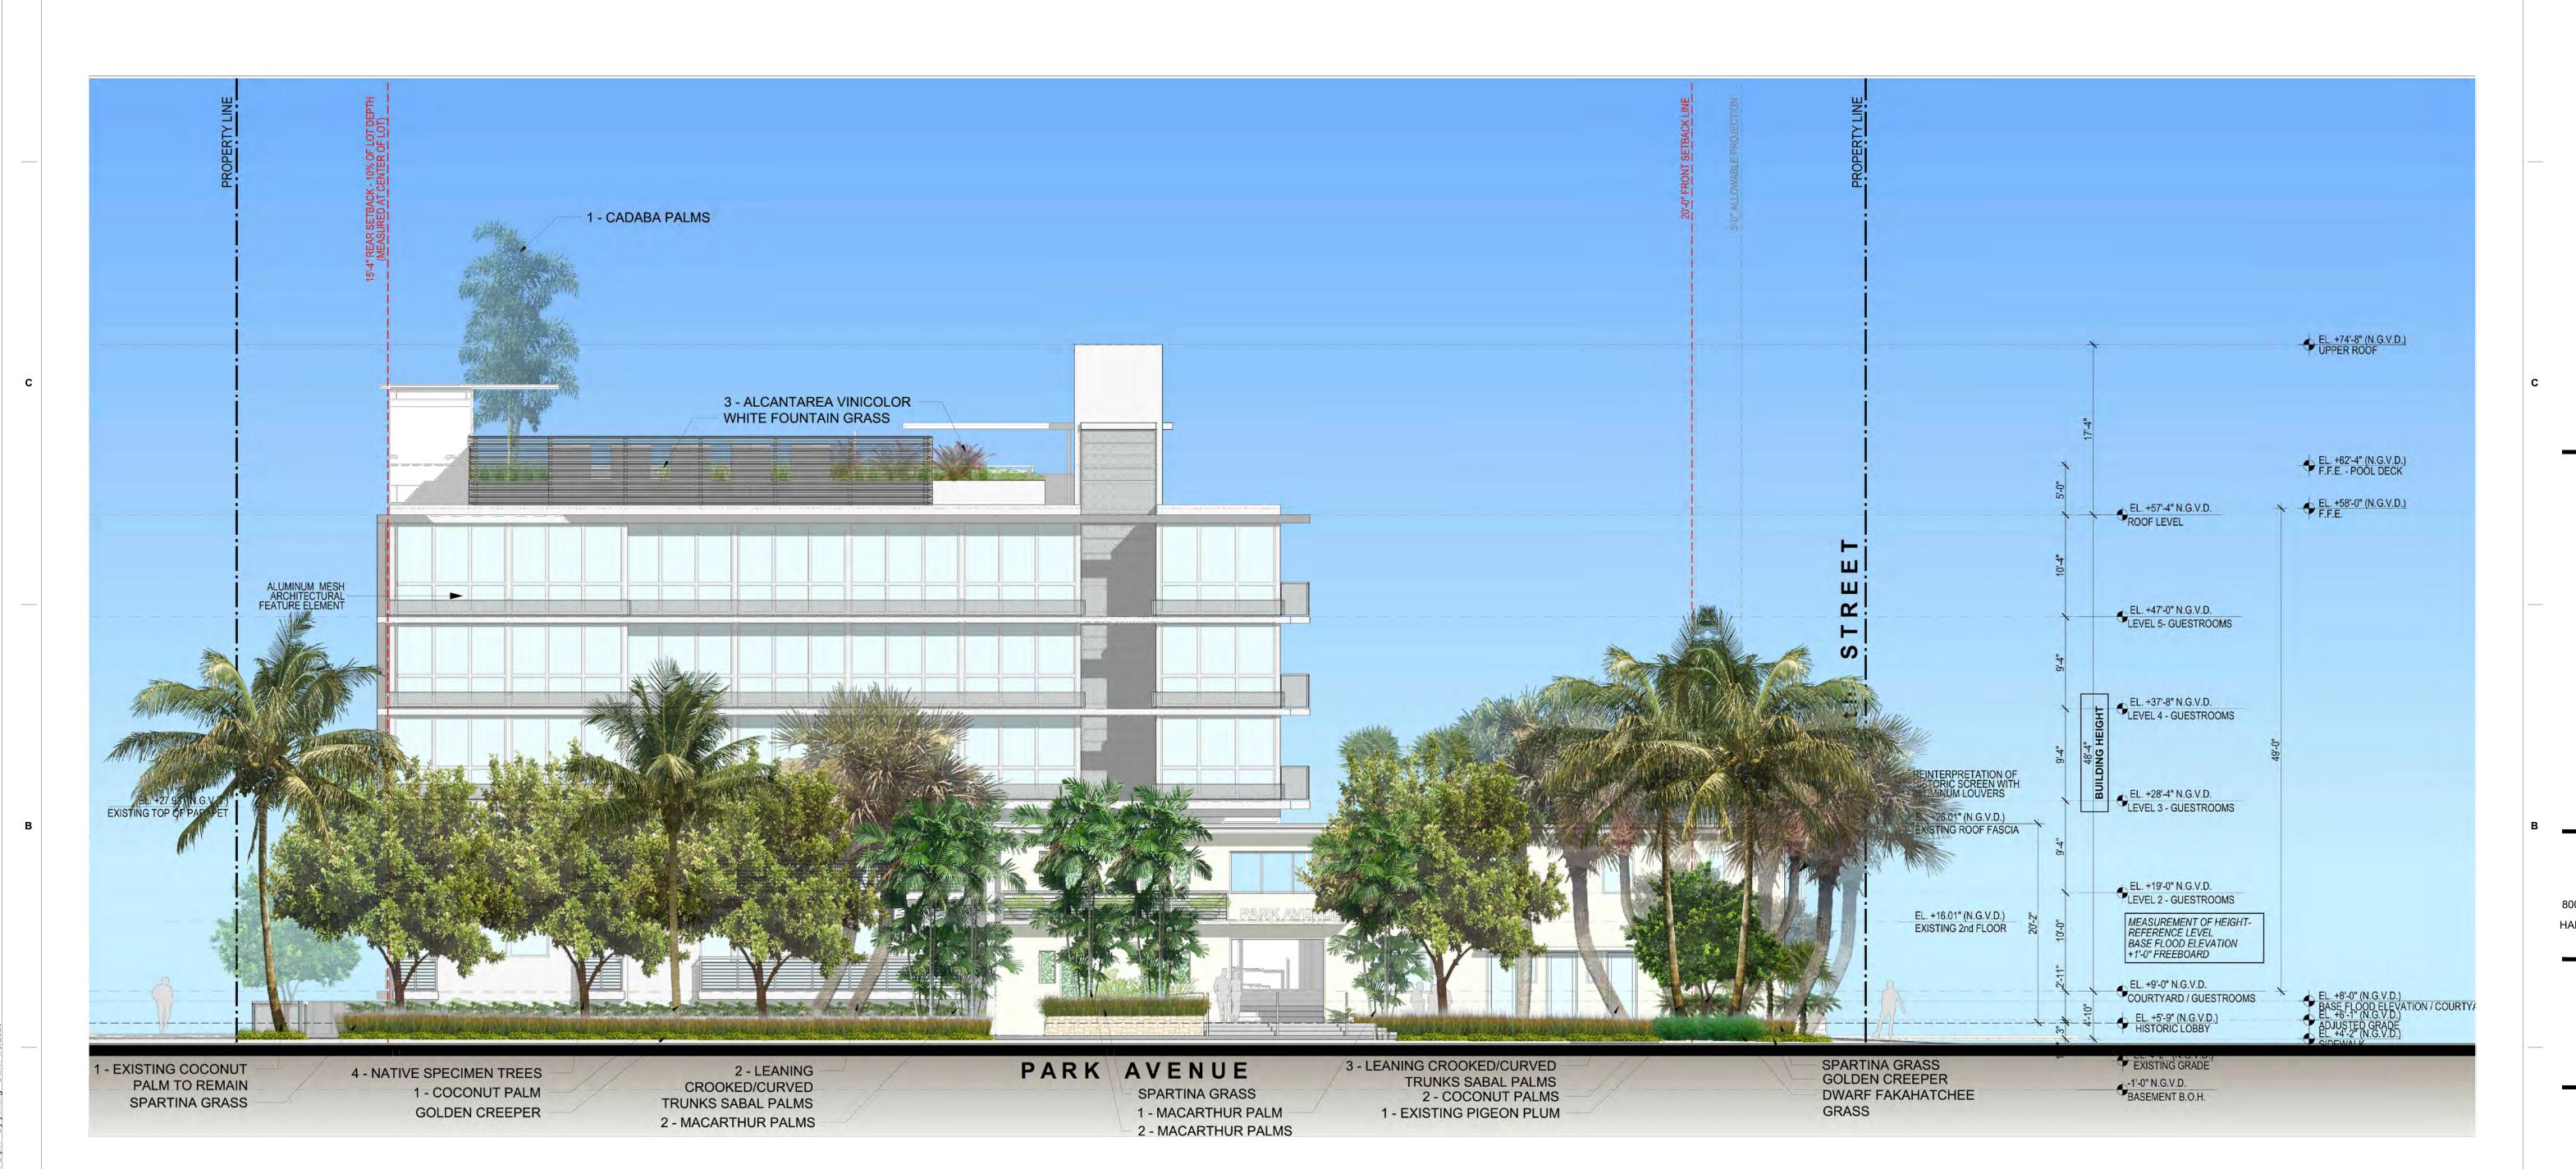
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Sheet Name WEST ELEVATION

Sheet No.



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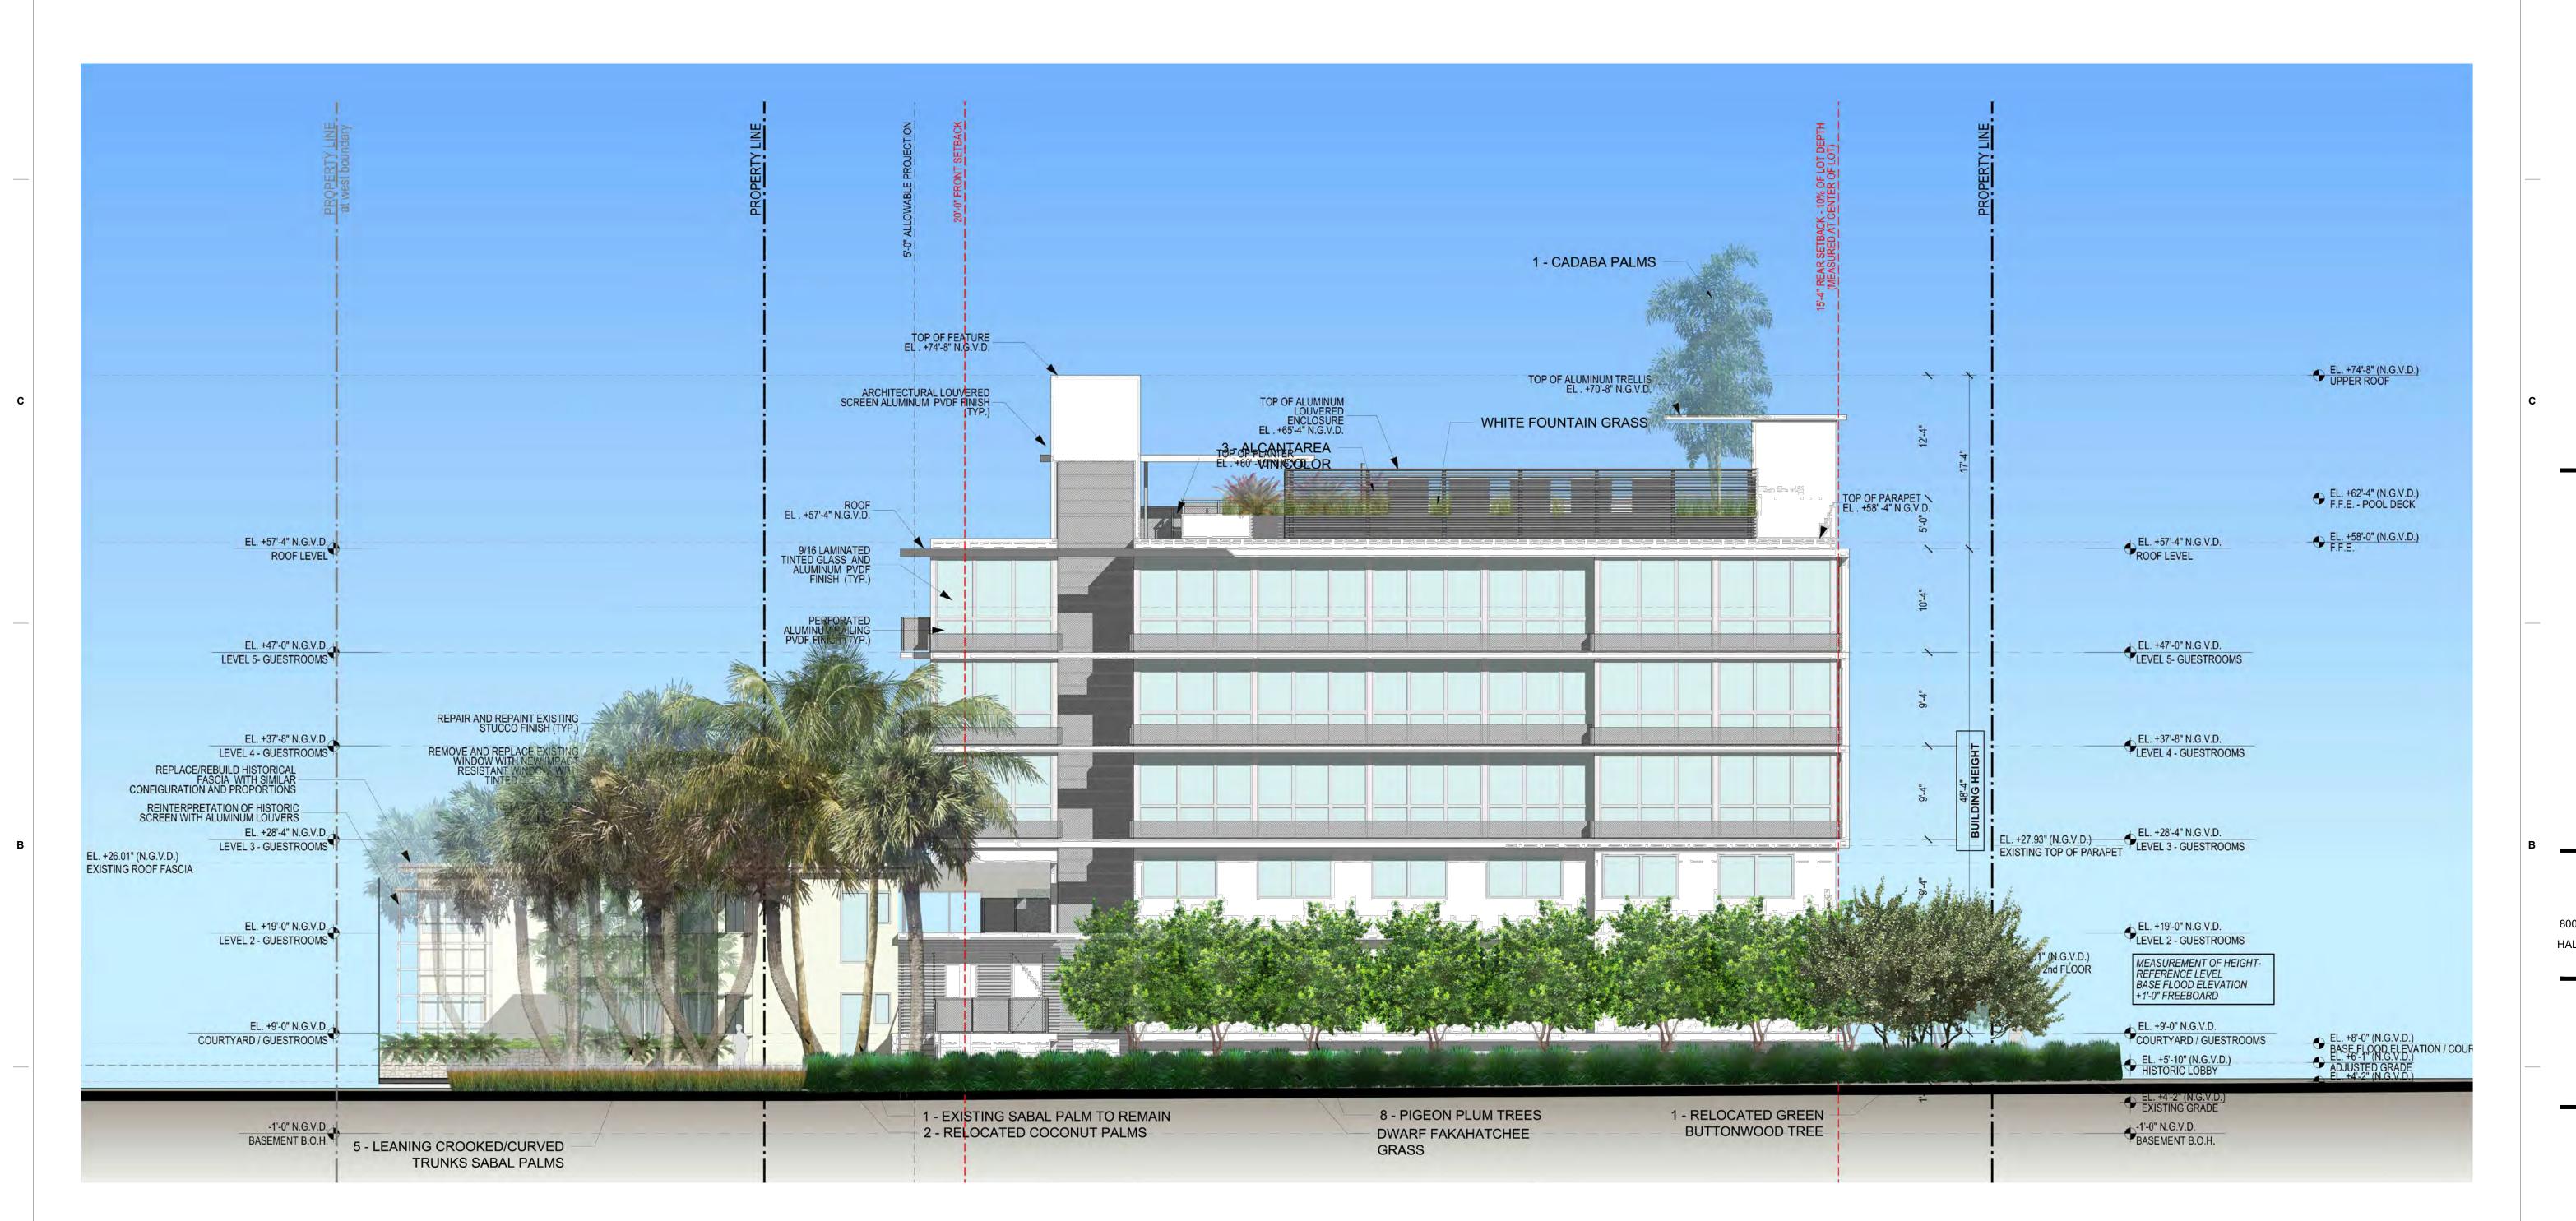
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Date 05/08/2023 Scale 1/8" = 1'-0" Project No. 1822

Sheet Name EAST ELEVATION

Sheet No.

Sheet No.



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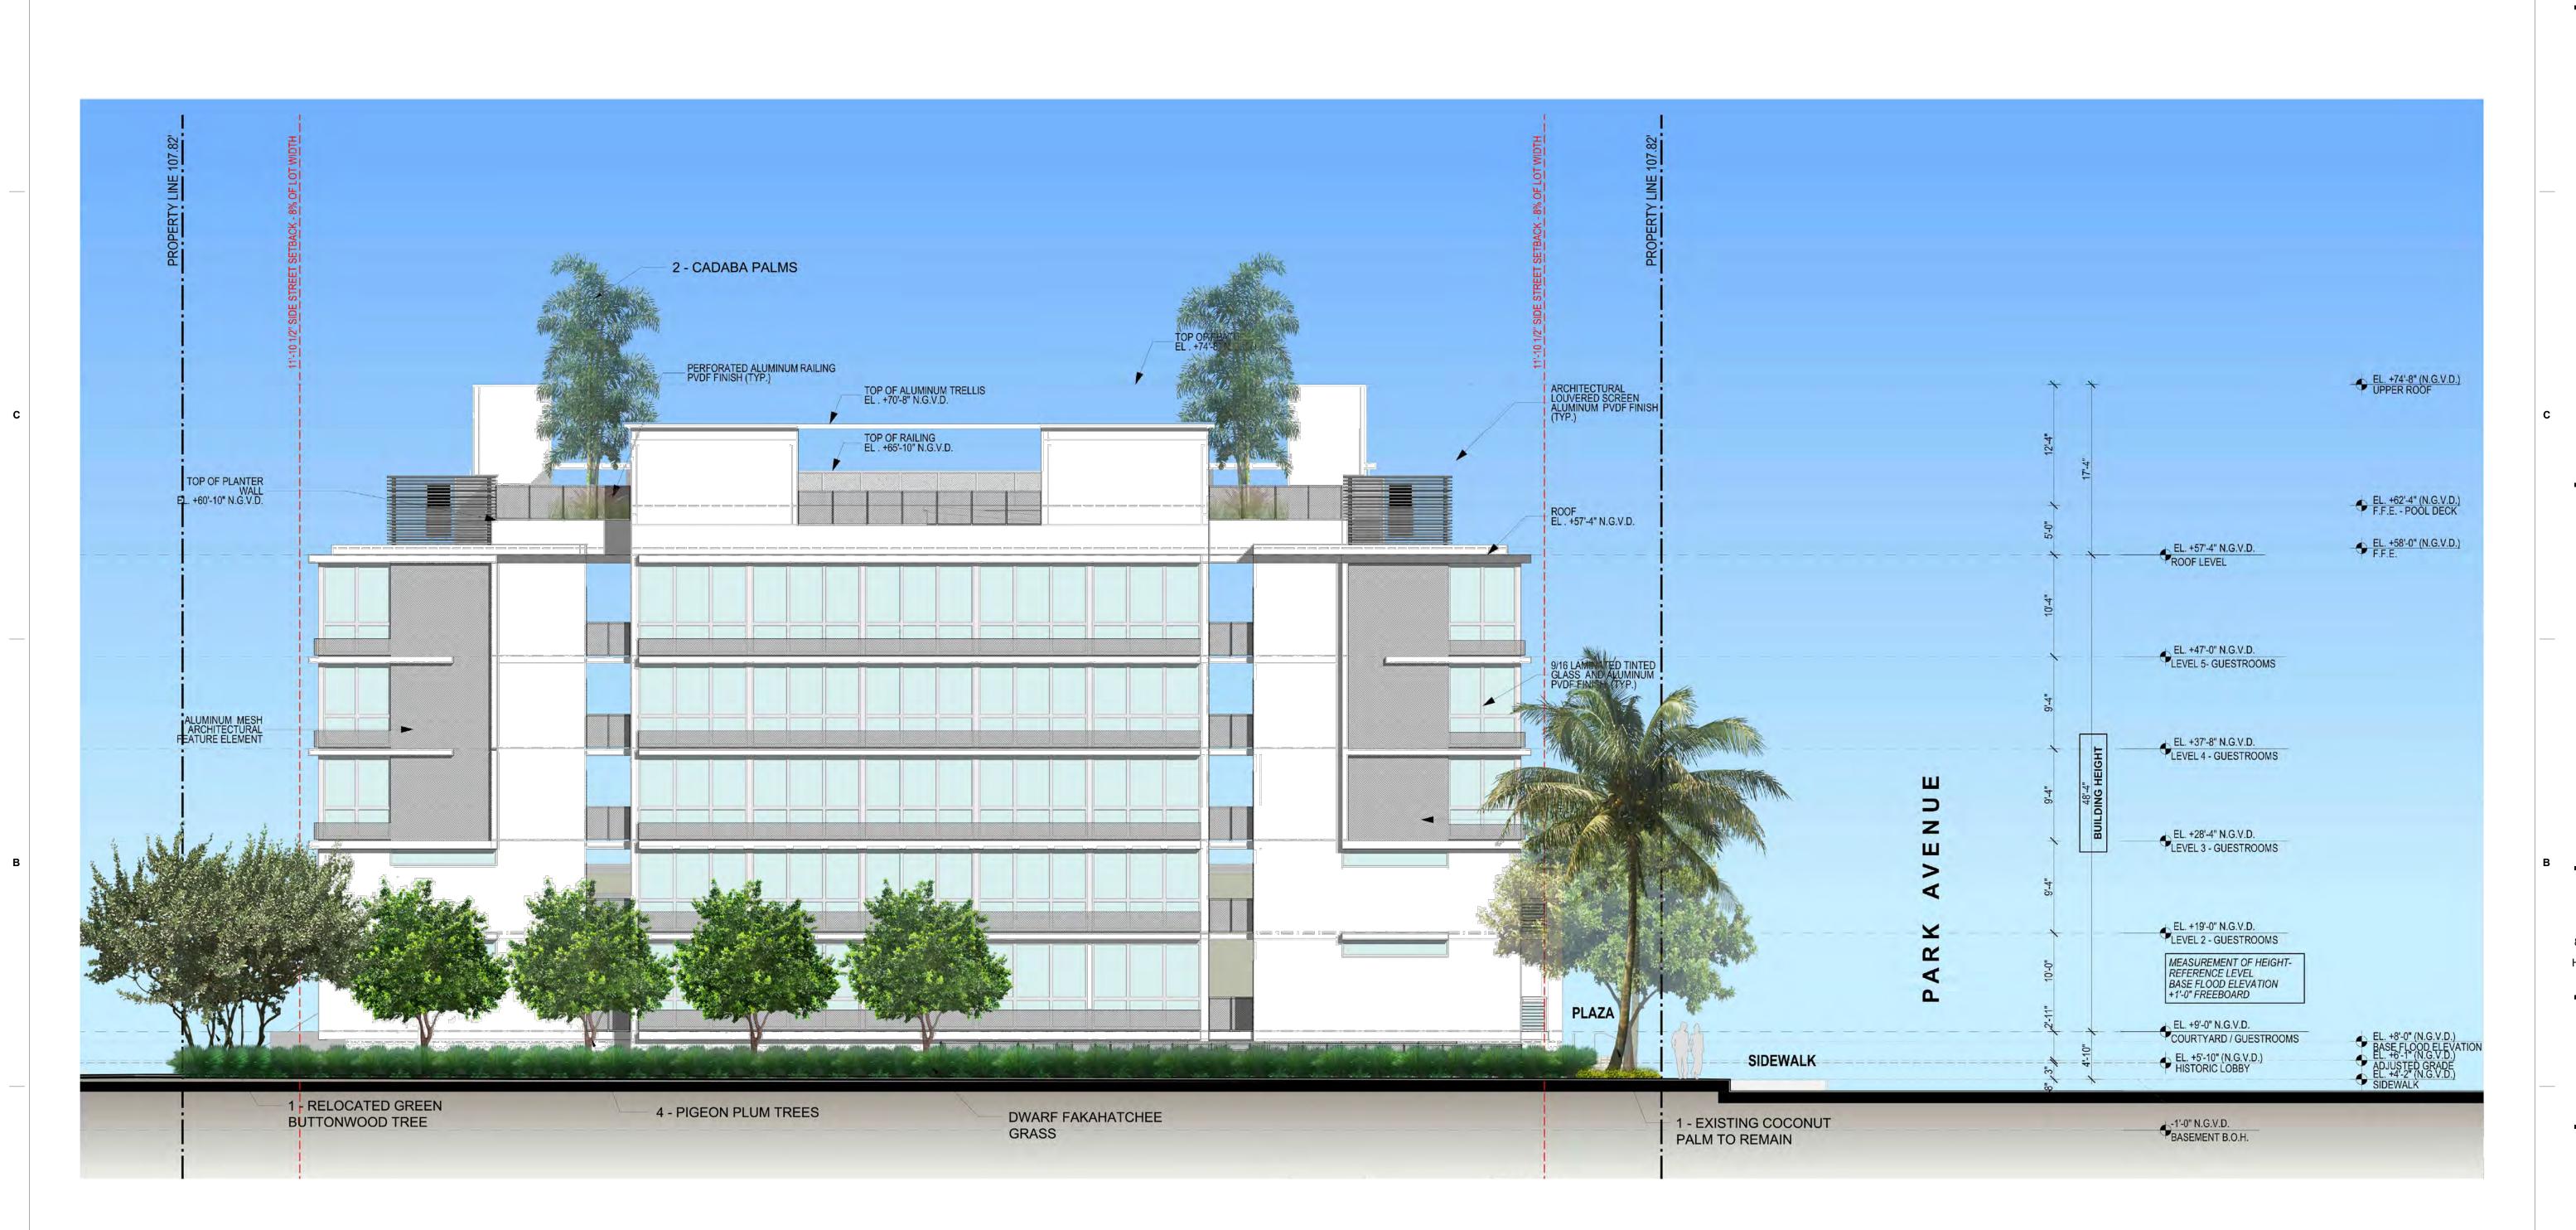
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Sheet Name NORTH ELEVATION

Sheet No.




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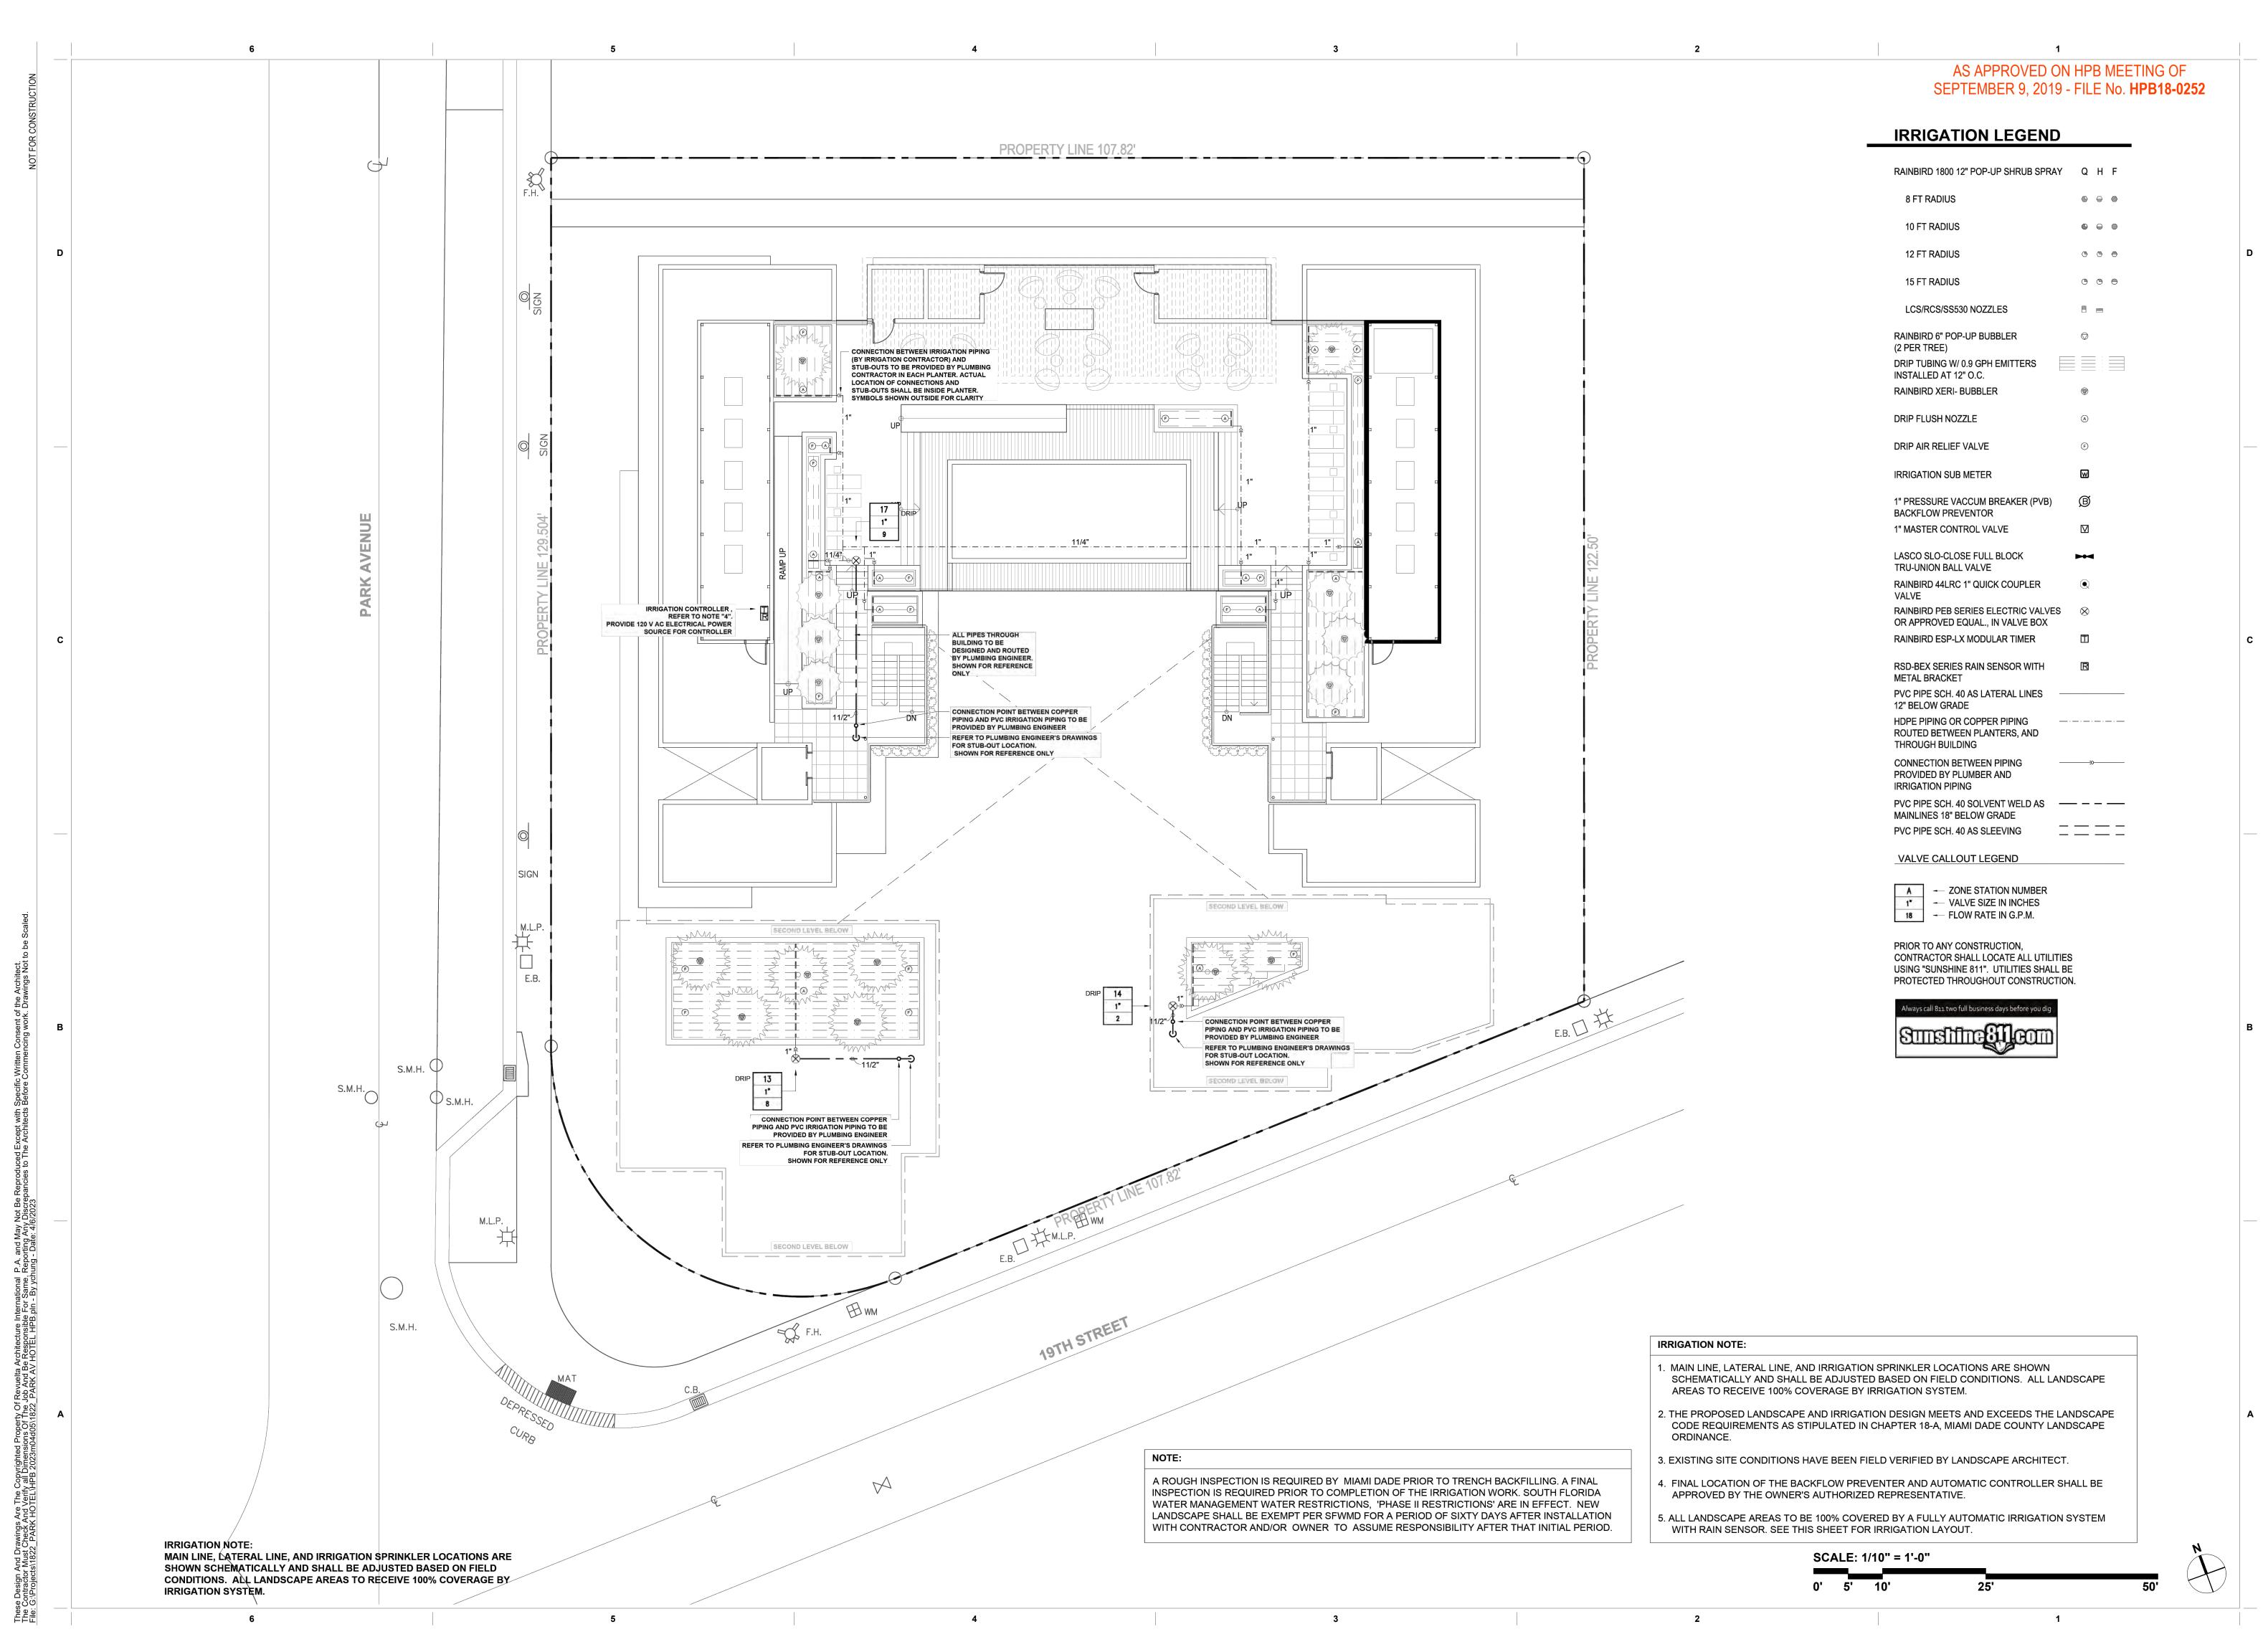
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Sheet Name **IRRIGATION PLAN - GROUND LEVEL**



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Sheet Name **IRRIGATION PLAN - ROOF LEVEL**

AS APPROVED ON HPB MEETING OF SEPTEMBER 9, 2019 - FILE No. HPB18-0252

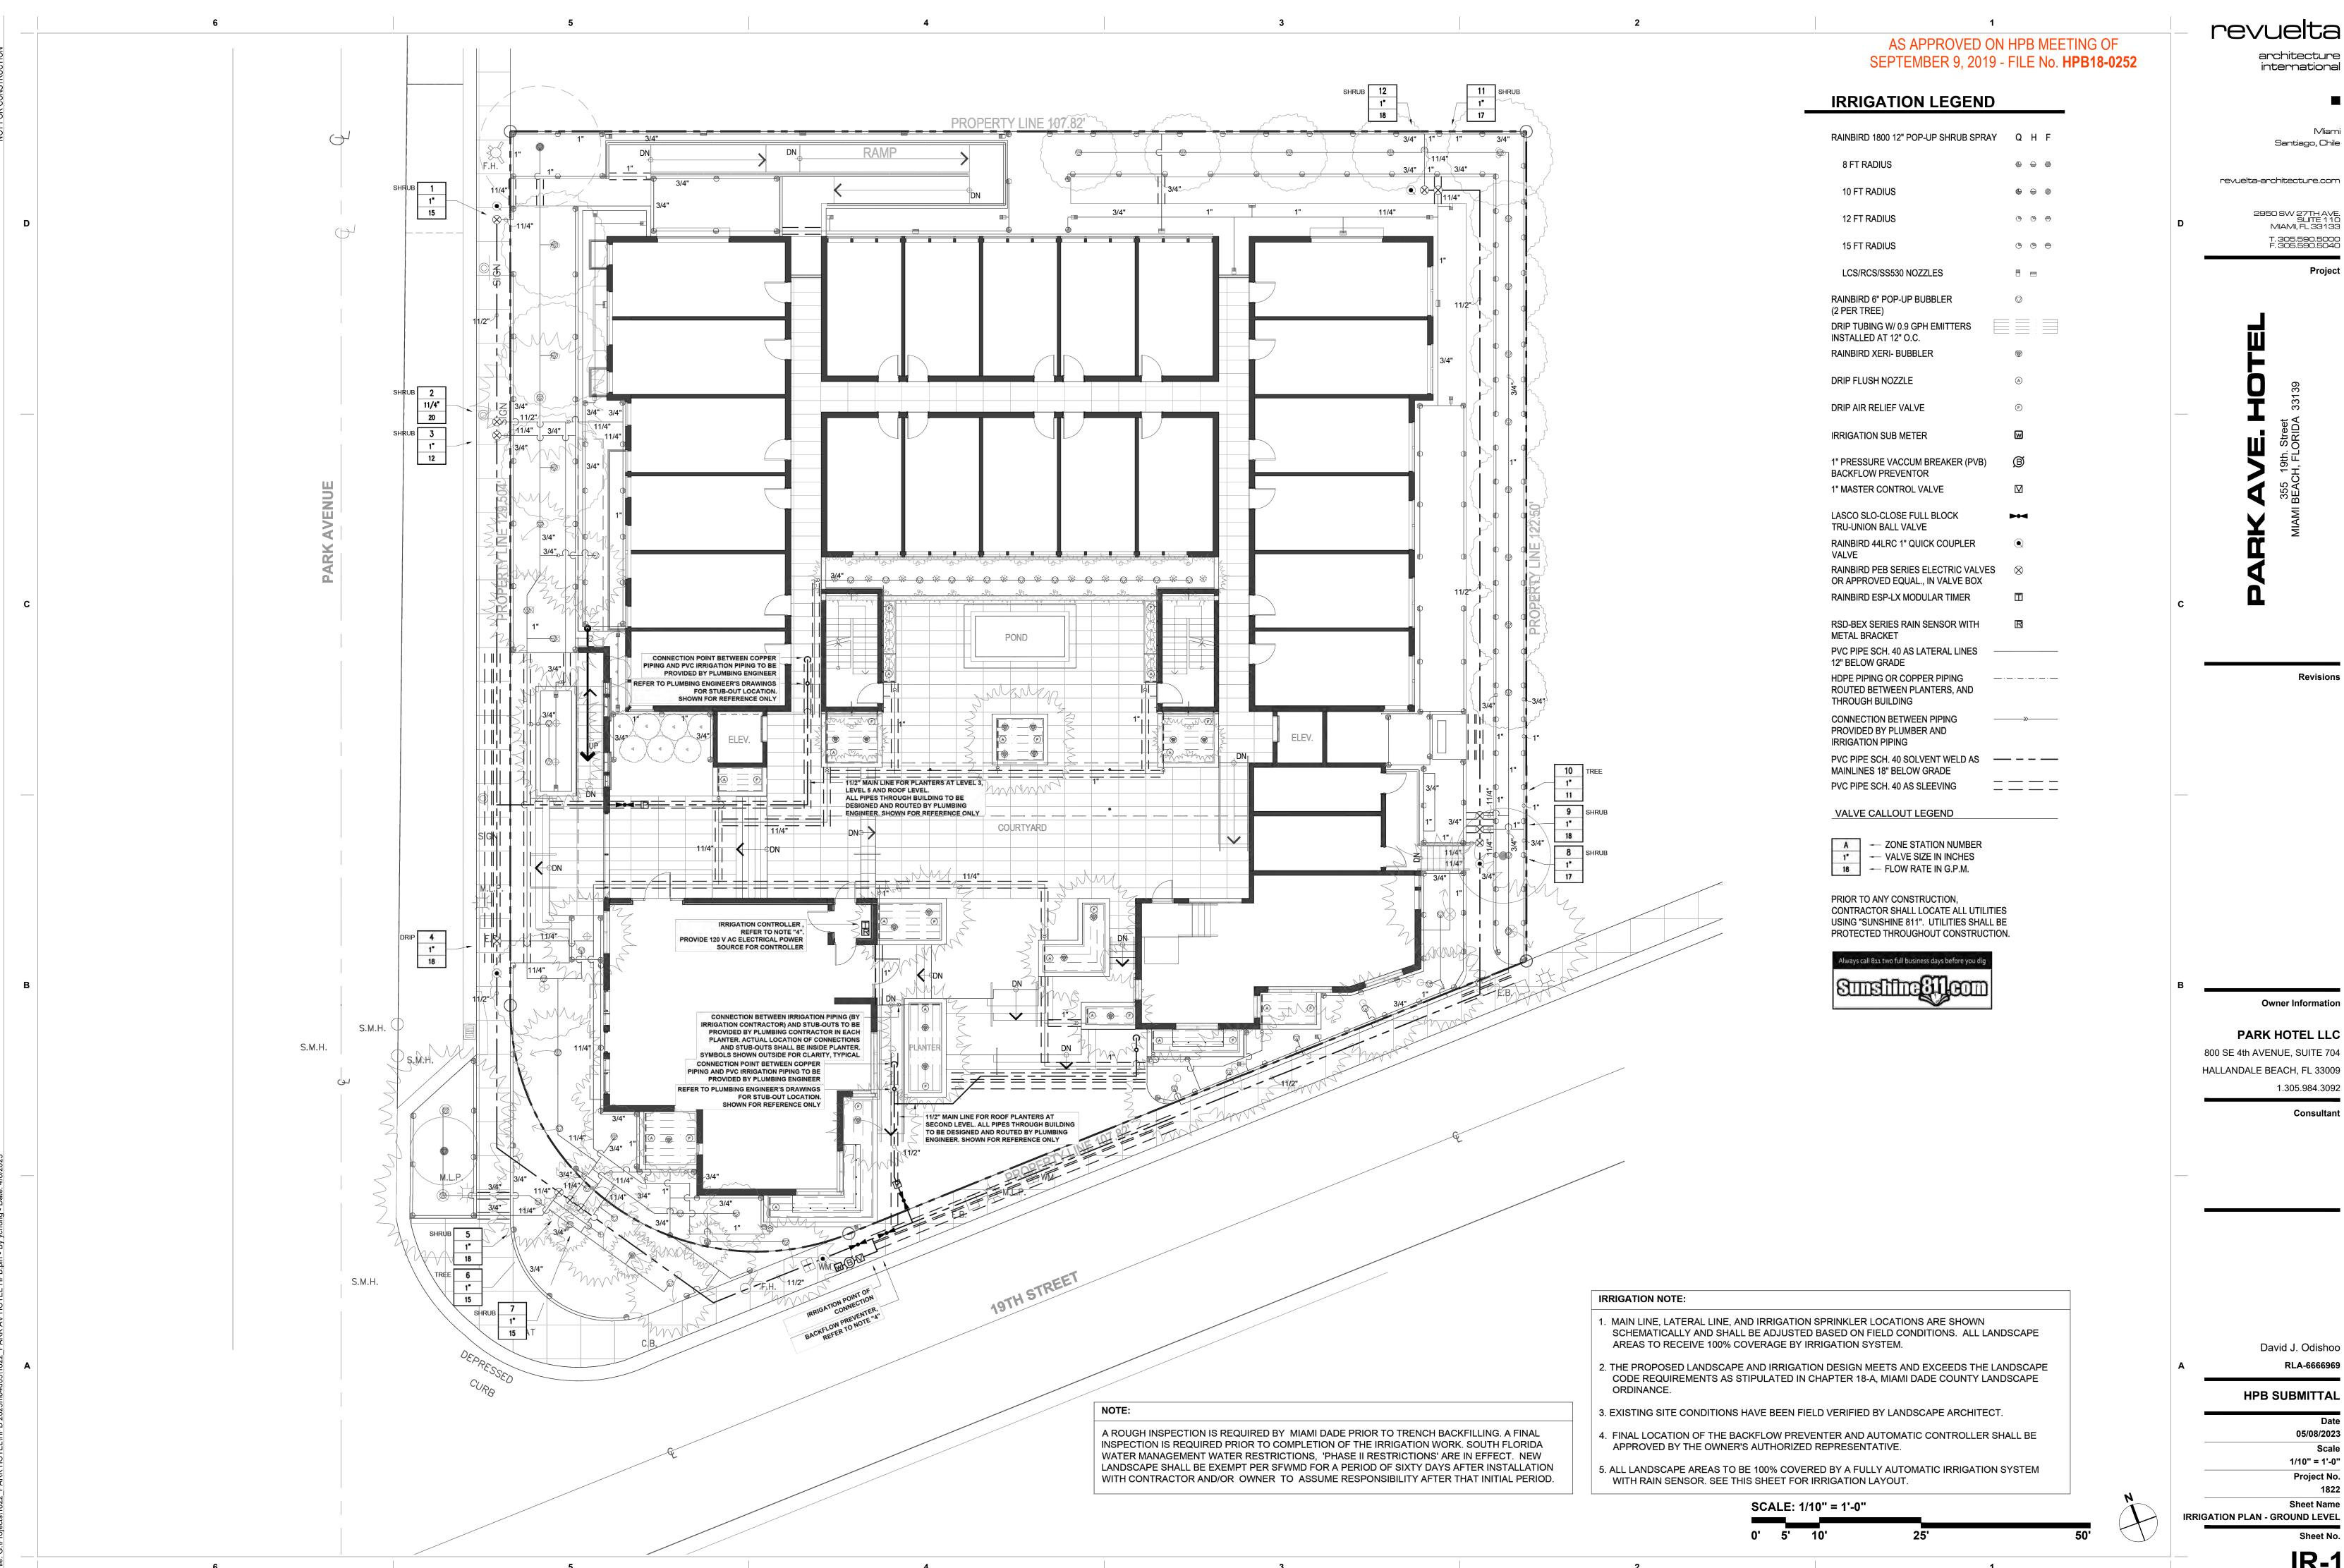RAIN SENSOR -

INSTALL

RAIN BIRD

60 436 309 637 529

2

TYPICAL CONTROLER

STATIONS

IN AN OPEN

AREA WHERE

EXPOSED TO

AND IS CLEAR

OF IRRIGATION

COMMON WIRE

TO CONTROL

RAINFALL

SPRAY

VALVES

RAIN SENSOR IS

UNOBSTRUCTED

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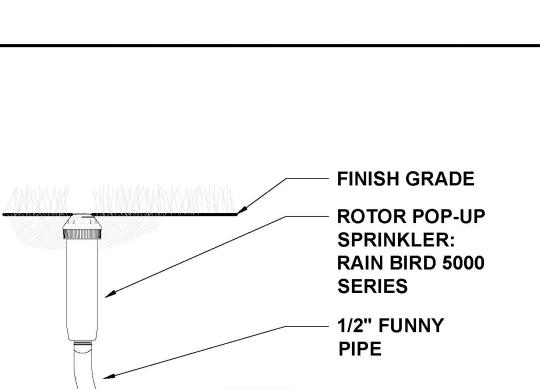
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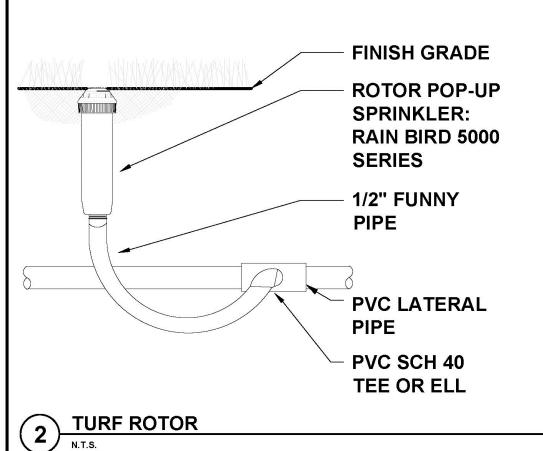
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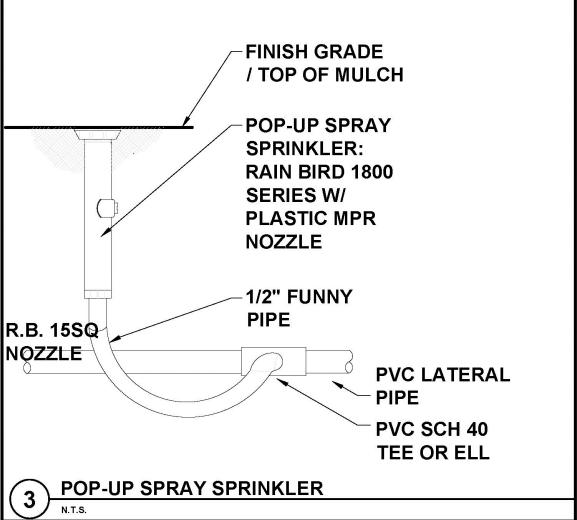
05/08/2023 Scale **AS NOTED** Project No.


IRRIGATION DETAILS AND NOTES


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	DING CODE- APPENDIX F TION-DEPTH OF COVER
VEHICLE	TRAFFIC AREAS
PIPE SIZE (INCHES)	DEPTH OF COVER (INCHES)
1/2" TO 2 1/2"	18" TO 24"
3" TO 5"	24" TO 30"
6" OR GREATER	30 TO 36"
NON-TRAFFIC A	ND NON-CULTIVATED AREAS
PIPE SIZE (INCHES)	DEPTH OF COVER (INCHES)
1/2" TO 1 1/4"	6" TO 12"
1 1/2" TO 2"	12" TO 18"
2 1/2" TO 3"	18" TO 24"
4" OR LARGER	24" TO 36"

WATER PROOF CONNECTION **VALVE BOX WITH COVER:** 12-INCH SIZE FINISH GRADE/TOP OF MULCH REMOTE CONTROL VALVE **PVC SCH 80 NIPPLE PVC SCH 40 ELL** PVC SCH 80 NIPPLE (LENGTH AS REQUIRED) **SCH 40 TEE OR DUCTILE IRON SERVICE TEE SEE** SPEC. SHEET FOR DETAIL PVC MAINLINE PIPE **PVC SCH 80 NIPPLE** - PVC LATERAL PIPE - PVC WIRELINE PIPE REMOTE CONTROL VALVE N.T.S.

12" SPRAY HEAD ON RISER

TOP OF PLANT

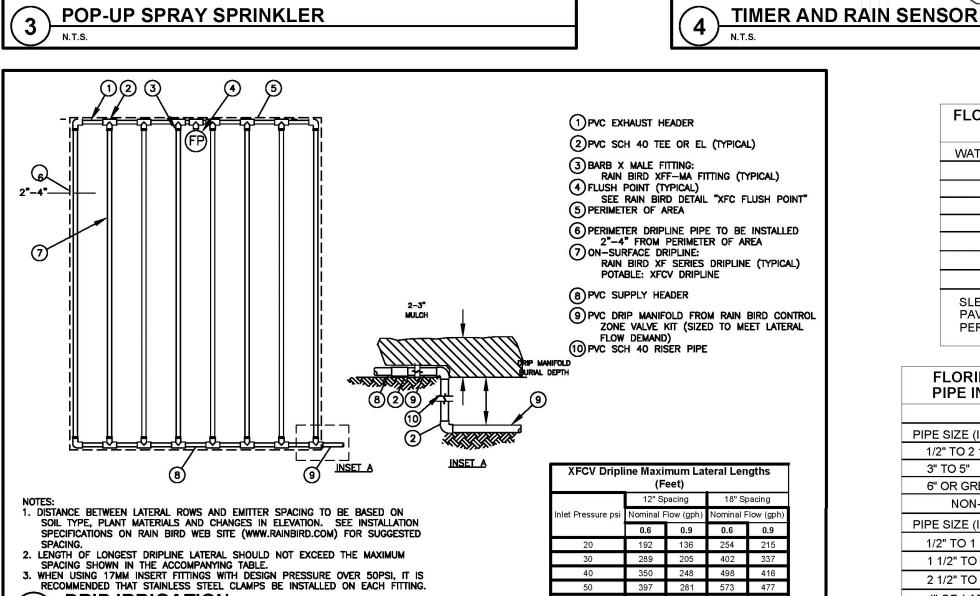POP-UP SPRAY

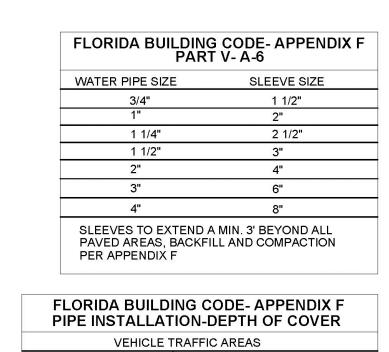RAIN BIRD 1812

PLASTIC MPR

SPRINKLER:

SERIES W/

3/4" SCH.40

1/2" FUNNY

PVC LATERAL

NOZZLE

RISER

PVC SCH 40 TEE OR ELL

MATERIAL

IRRIGATION NOTES

- 1. PIPE SIZES SHALL CONFORM TO THOSE SHOWN ON THE DRAWINGS. NO SUBSTITUTIONS OF SMALLER PIPE SIZES SHALL BE PERMITTED, BUT SUBSTITUTIONS OF LARGER SIZES MAY BE APPROVED. ALL DAMAGED AND REJECTED PIPE SHALL BE REMOVED FROM THE SITE AT THE TIME OF SAID REJECTION.
- 2. ALL MAINLINE, LATERAL LINE AND CONTROL WIRE CONDUIT UNDER PAVING SHALL BE INSTALLED IN SEPARATE SLEEVES. SLEEVES SHALL BE A MINIMUM OF TWICE (2X) THE DIAMETER OF THE PIPE TO BE SLEEVED.
- 3. INSTALL ALL BACKFLOW PREVENTION DEVICES AND ALL PIPING BETWEEN THE POINT OF CONNECTION AND THE BACKFLOW PREVENTER AS PER LOCAL CODES.
- 4. FINAL LOCATION OF THE BACKFLOW PREVENTER AND AUTOMATIC CONTROLLER SHALL BE APPROVED BY THE OWNER'S AUTHORIZED REPRESENTATIVE.
- 5. 120 VAC ELECTRICAL POWER SOURCE AT CONTROLLER LOCATION SHALL BE PROVIDED BY OTHERS. THE ELECTRICAL CONTRACTOR SHALL MAKE THE FINAL CONNECTION FROM THE ELECTRICAL SOURCE TO THE CONTROLLER.
- 6. ALL SPRINKLER HEADS SHALL BE SET PERPENDICULAR TO FINISH GRADE UNLESS OTHERWISE SPECIFIED.
- 7. THE IRRIGATION CONTRACTOR SHALL FLUSH AND ADJUST ALL SPRINKLER HEADS AND VALVES FOR OPTIMUM SPRAY WITH MINIMAL OVERSPRAY ONTO WALKS, STREETS, WALLS, ETC.

8. THIS DESIGN IS DIAGRAMATIC. ALL PIPING, VALVES, ETC., SHOWN WITHIN PAVED AREAS IS FOR DESIGN CLARIFICATION ONLY AND SHALL BE INSTALLED IN PLANTING AREAS WHEREVER POSSIBLE. THE CONTRACTOR SHALL LOCATE ALL VALVES IN SHRUB AREAS WHERE POSSIBLE.

6 PRESSURE VACUUM BREAKER N.T.S.

IN FROM WATER METER OUT TO SPRINKLER SYSTEM

- 9. IT IS THE RESPONSIBILITY OF THE IRRIGATION CONTRACTOR TO FAMILIARIZE HIMSELF WITH ALL GRADE DIFFERENCES, LOCATION OF WALLS, RETAINING WALLS, STRUCTURES AND UTILITIES. THE IRRIGATION CONTRACTOR SHALL REPAIR OR REPLACE ALL ITEMS DAMAGED BY HIS WORK. HE SHALL COORDINATE HIS WORK WITH OTHER CONTRACTORS FOR THE LOCATION AND INSTALLATION OF PIPE SLEEVES THROUGH WALLS, UNDER ROADWAYS AND PAVING, ETC.
- 10. DO NOT WILLINGLY INSTALL THE SPRINKLER SYSTEM AS SHOWN ON THE DRAWINGS WHEN IT IS OBVIOUS IN THE FIELD THAT UNKNOWN OBSTRUCTIONS, GRADE DIFFERENCES OR DIFFERENCES IN THE AREA DIMENSIONS EXIST THAT MIGHT NOT HAVE BEEN CONSIDERED IN THE ENGINEERING. SUCH OBSTRUCTIONS OR DIFFERENCES SHOULD BE BROUGHT TO THE ATTENTION OF THE OWNER'S AUTHORIZED REPRESENTATIVE. IN THE EVENT THIS NOTIFICATION IS NOT PERFORMED, THE IRRIGATION CONTRACTOR SHALL ASSUME FULL RESPONSIBILITY FOR ANY REVISIONS NECESSARY.
- 11. ALL SPRINKLER EQUIPMENT NOT OTHERWISE DETAILED OR SPECIFIED SHALL BE INSTALLED AS PER MANUFACTURER'S RECOMMENDATIONS AND SPECIFICATIONS.
- 12. THE IRRIGATION CONTRACTOR SHALL INSTALL CHECK VALVES ON ALL HEADS IN AREAS WHERE FINISH GRADE EXCEEDS 4:1, WHERE POST VALVE SHUT-OFF DRAINING, OF THE IRRIGATION HEAD OCCURS OR AS DIRECTED BY THE OWNER'S AUTHORIZED REPRESENTATIVE.

13. THE CONTRACTOR SHALL PROVIDE 1800 PCS (PRESSURE COMPENSATING SCREENS) AS NECESSARY TO REDUCE OR ELIMINATE OVERSPRAY ONTO STREETS, WALKS OR OTHER AREAS AS DIRECTED BY THE OWNER'S AUTHORIZED REPRESENTATIVE.

DRIP IRRIGATION

3

- 14. ALL CONTROL WIRES SHALL BE INSTALLED IN PVC CONDUIT.
- 15. ALL REMOTE CONTROL VALVES, GATE VALVES, QUICK COUPLERS, CONTROL WIRE AND COMPUTER CABLE PULL POINTS SHALL BE INSTALLED IN APPROVED VALVES BOXES WITH COVERS.
- 12. THE IRRIGATION CONTRACTOR SHALL INSTALL CHECK VALVES ON ALL HEADS IN AREAS WHERE FINISH GRADE EXCEEDS 4:1, WHERE POST VALVE SHUT-OFF DRAINING, OF THE IRRIGATION HEAD OCCURS OR AS DIRECTED BY THE OWNER'S AUTHORIZED REPRESENTATIVE.
- 13. THE CONTRACTOR SHALL PROVIDE 1800 PCS (PRESSURE COMPENSATING SCREENS) AS NECESSARY TO REDUCE OR ELIMINATE OVERSPRAY ONTO STREETS, WALKS OR OTHER AREAS AS DIRECTED BY THE OWNER'S AUTHORIZED REPRESENTATIVE.
- 14. ALL CONTROL WIRES SHALL BE INSTALLED IN PVC CONDUIT.
- 15. ALL REMOTE CONTROL VALVES, GATE VALVES, QUICK COUPLERS, CONTROL WIRE AND COMPUTER CABLE PULL POINTS SHALL BE INSTALLED IN APPROVED VALVES BOXES WITH COVERS.

IR-3