AR0009679

NEW SINGLE FAMILY RESIDENCE

705 W DILIDO DR.


CLIENT **ARCHITECT** 705 W DILIDO, LLC CHOEFF LEVY FISCHMAN 8425 BISCAYNE BLVD #201 MIAMI, FL 33138 (305) 434-8338

LANDSCAPING

CHRISTOPHER CAWLEY 780 NE 69th STREET #1106 MIAMI, FL 33138 (305) 979-1585 LC 26000460

CONSULTANTS

AI2 DESIGN CORP 3631 TORREMOLINOS AVE MIAMI, FL 33178 (305) 520-9242

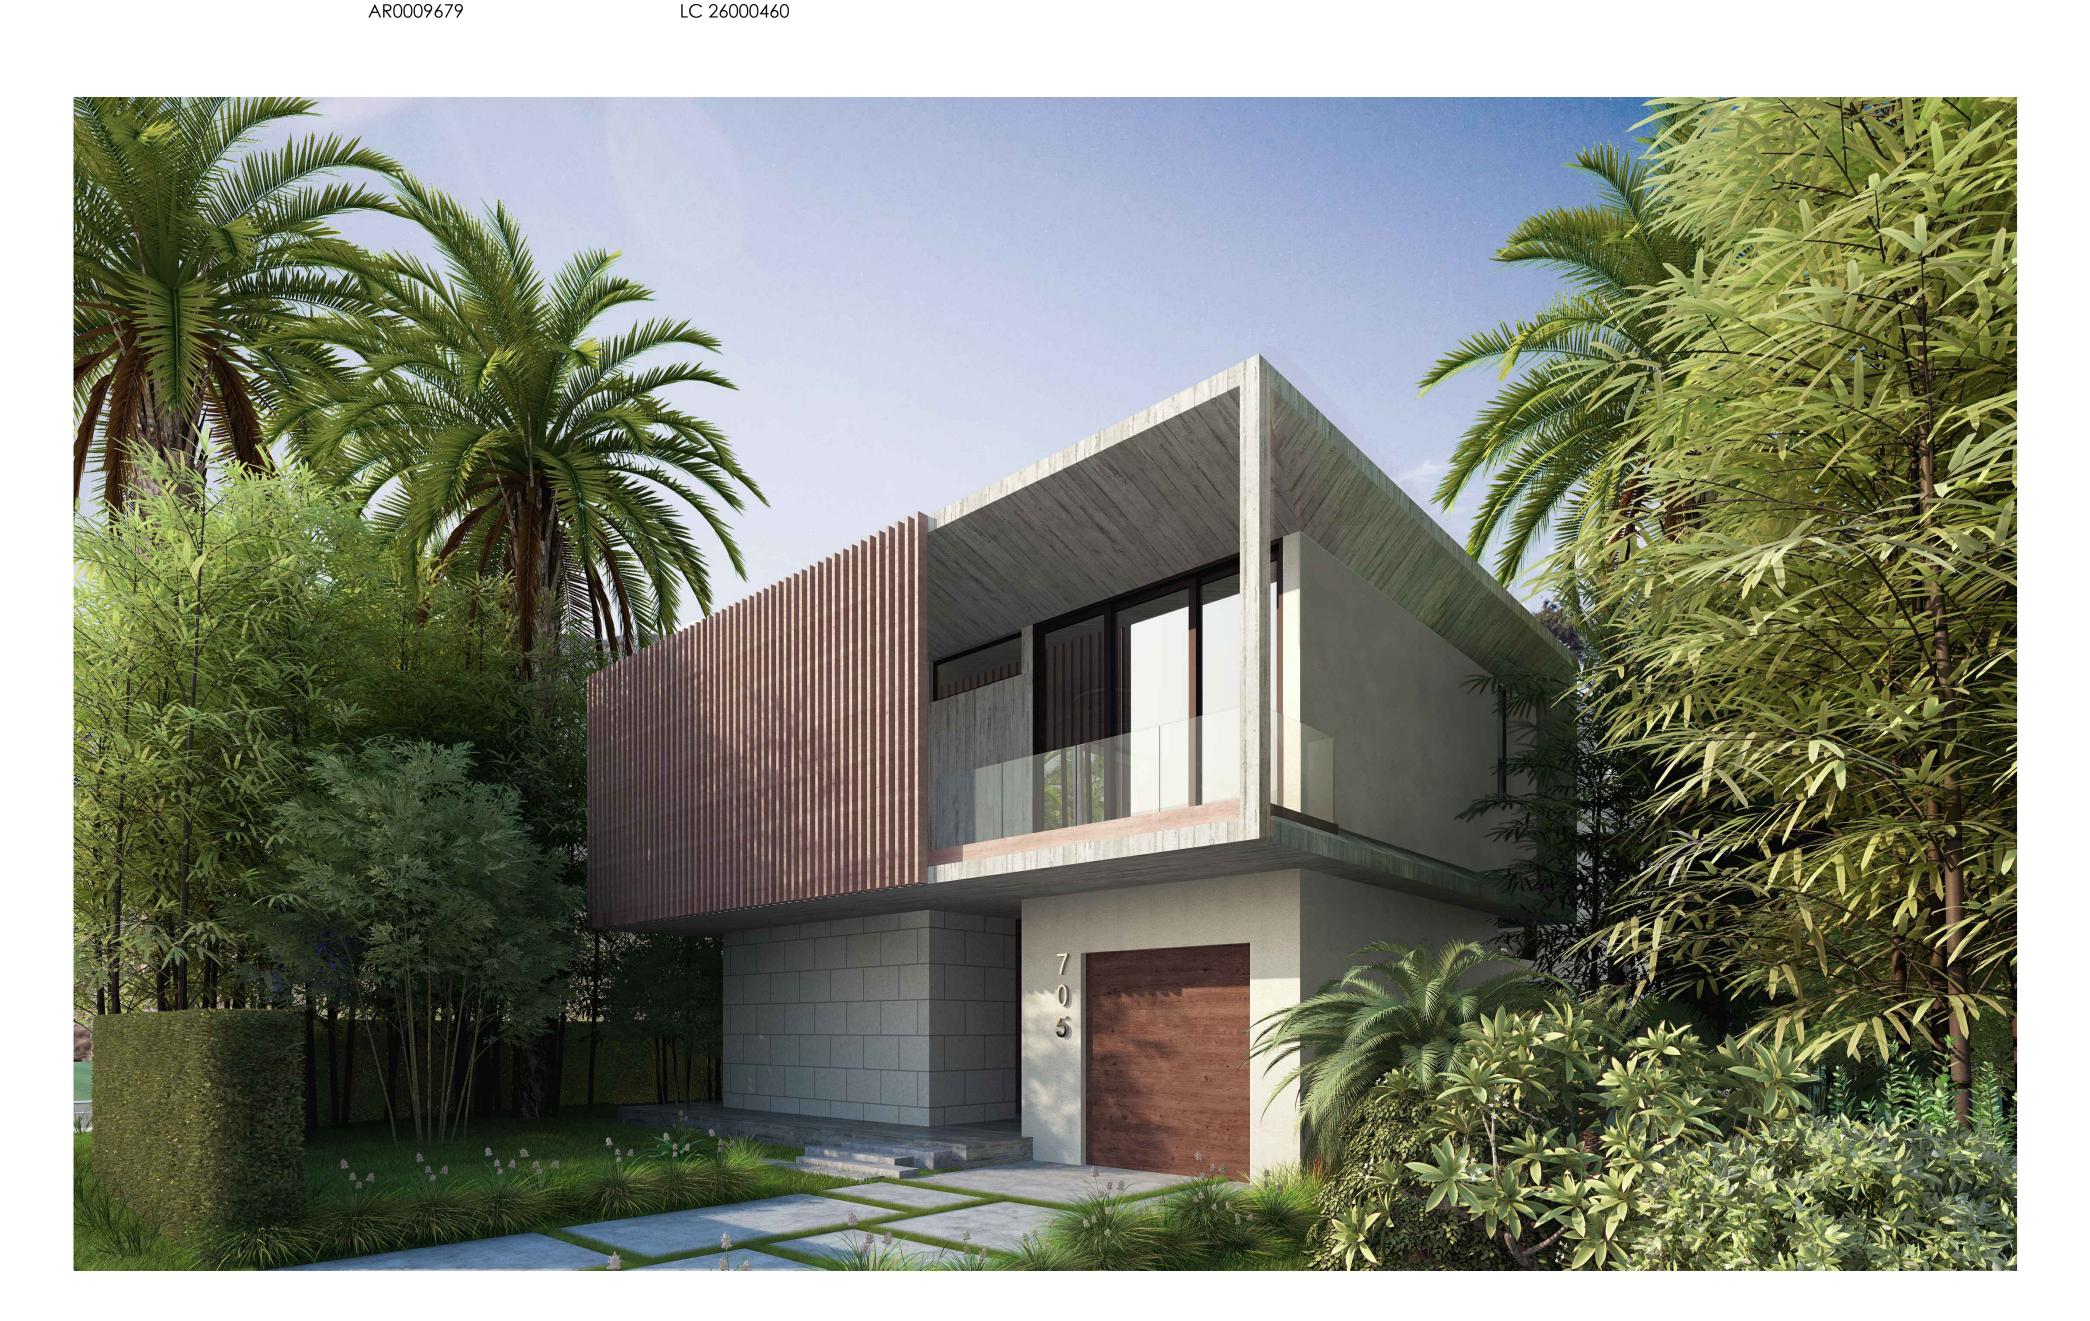

MIAMI BEACH, FLORIDA

SCOPE OF WORK

- * DEMOLITION OF A PRE-1942 SINGLE FAMILY RESIDENCE
- * NEW CONSTRUCTION OF A SINGLE FAMILY RESIDENCE

INDEX OF DRAWINGS

COVER INDEX OF DRAWINGS / CONTACT INFO. BUILDING CARD SURVEY LOCATION PLAN

NEIGHBORHOOD ANALYSIS - EXISTING RESIDENCE NEIGHBORHOOD ANALYSIS - EXISTING RESIDENCE NEIGHBORHOOD ANALYSIS - EXISTING RESIDENCE NEIGHBORHOOD ANALYSIS - CONTEXT

EX-1.6 NEIGHBORHOOD ANALYSIS - CONTEXT EX-1.7 NEIGHBORHOOD ANALYSIS - CONTEXT EX-1.8 NEIGHBORHOOD ANALYSIS - CONTEXT EX-1.9 NEIGHBORHOOD ANALYSIS - CONTEXT

EX-1.10 NEIGHBORHOOD ANALYSIS - CONTEXT EX-1.11 NEIGHBORHOOD ANALYSIS - CONTEXT EX-1.12 NEIGHBORHOOD ANALYSIS - CONTEXT EX-2.1 FLOORPLAN - EXISTING RESIDENCE

EX-2.2 ELEVATIONS - EXISTING RESIDENCE EX-2.3 LOT COVERAGE - EXISTING RESIDENCE EX-2.4 DEMOLITION PLAN - EXISTING RESIDENCE

ZONING DATE SHEET SITE PLAN / SITE DATA / NOTES area diagrams FIRST FLOOR PLAN SECOND FLOOR PLAN

ROOF PLAN MATERIAL BOARD

FRONT & REAR ELEVATIONS SIDE ELEVATIONS

SECTION "A" & "B" SECTION "1" SECTION "2" SECTION "3" SECTION "4"

AXONOMETRIC MODEL

FRONT RENDERING CONTEXTURAL STREETSCAPE RENDERING CONTEXTURAL STREETSCAPE RENDERING

LANDSCAPING COVER

EXISTING TREE INVENTORY / DISPOSITION PLAN

EXISTING TREES IMAGES LANDSCAPE PLAN LANDSCAPE NOTES / DETAILS

registered architec

revised:


sheet no.

EX-0.00

PLOT DATE: 2016-12-14

BUILDING card

SCALE: N.T.S.

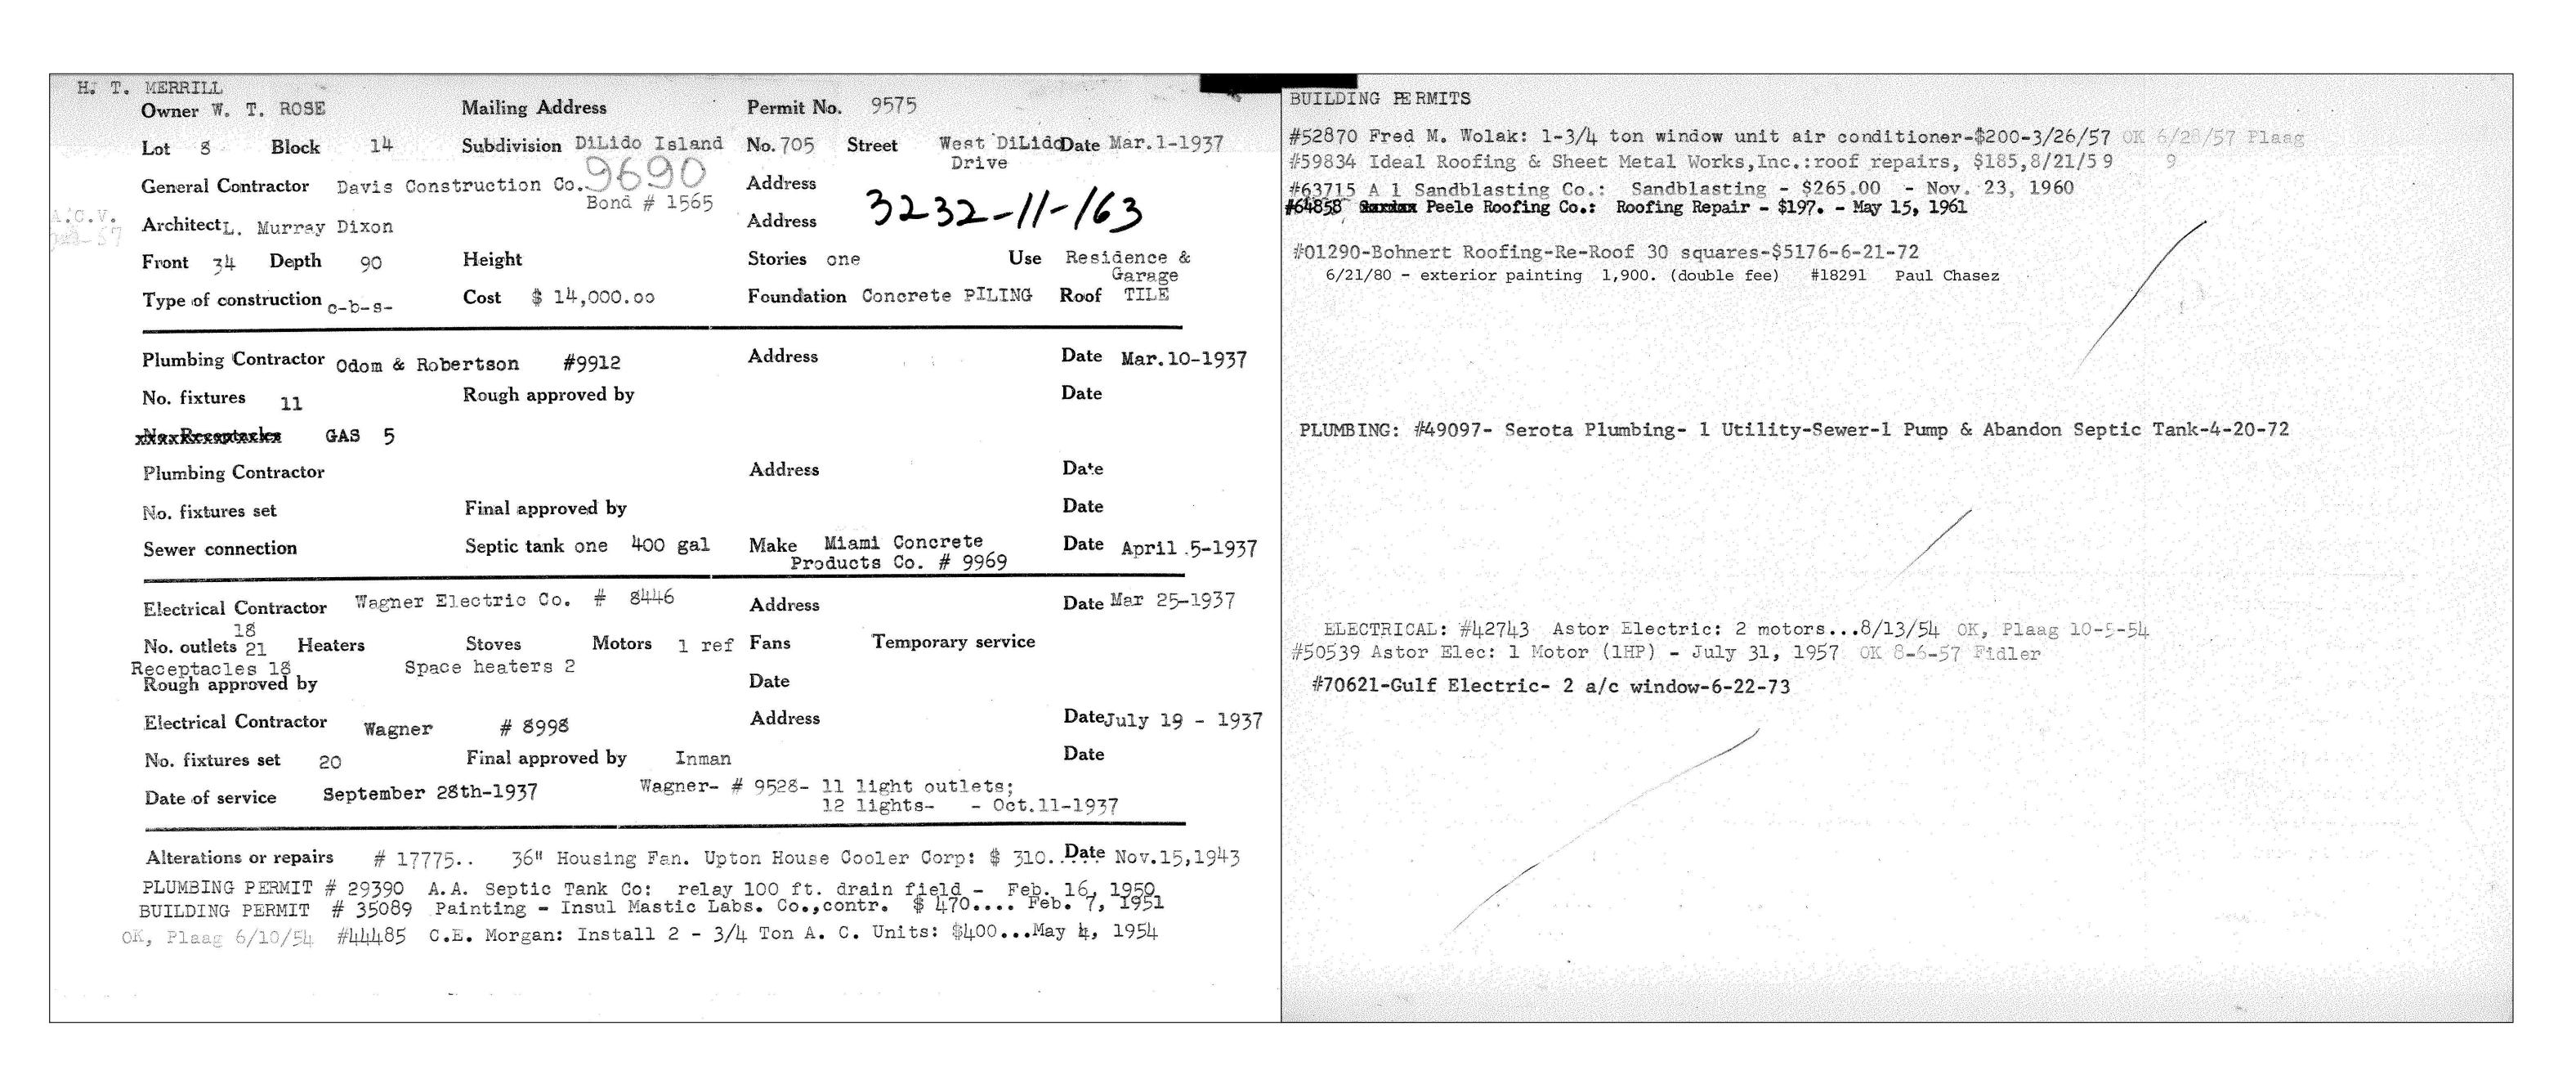

AR0009679

date: 11-22-2016

revised:

sheet no.

PLOT DATE: 2016-12-14

SCALE: N.T.S.

date: 11-22-2016

revised:

LOCATION PLAN



г . В н Б

R C H I T E C T

Biscoyne Blvd, suite 201

ii, Florida 33138

INEW RESIDEINCE 705 W Dilido, MIAMI BEACH, FL 33139

...

Ralph Choeff istered architect

comm no. 1658

date: 11-22-2016

revised


sheet no.



01. FRONT ELEVATION FROM W DILIDO



02. FRONT ELEVATION FROM 7th TERRACE

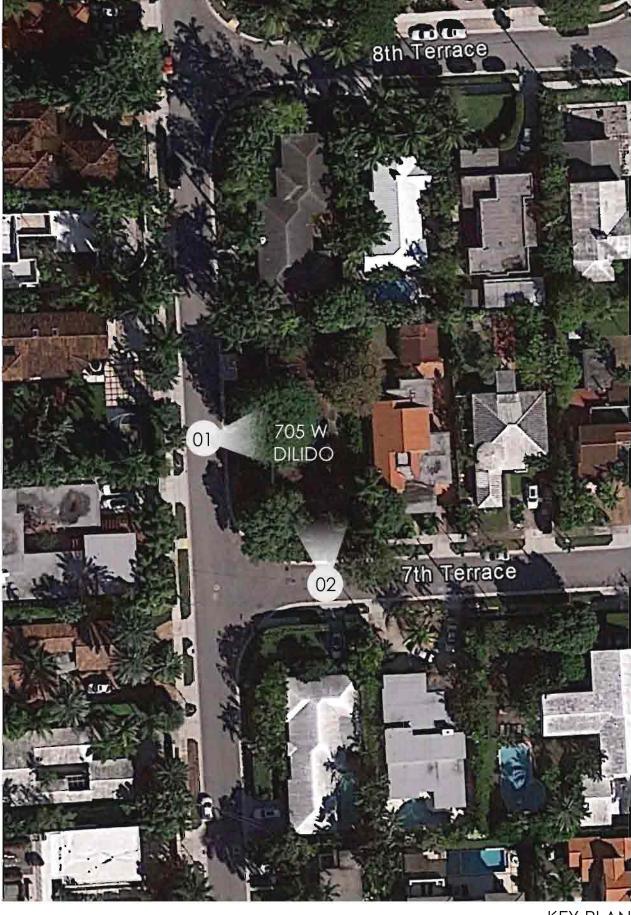

KEY PLAN

(t) 305.434.8338 (f) 305.892.5292

л В В В

CHOEFFLE ARCHITECT 8425 Biscopne Blvd, suite 201 Miami, Florida 33138

NEW RESIDENCE

sea

Ralph Choeff istered architect

comm no. 1658

date: 11-22-2016

revised:

sheet no.


PLOT DATE



03. REAR ELEVATION FROM W DILIDO



04. REAR ELEVATION FROM 7th TERRACE

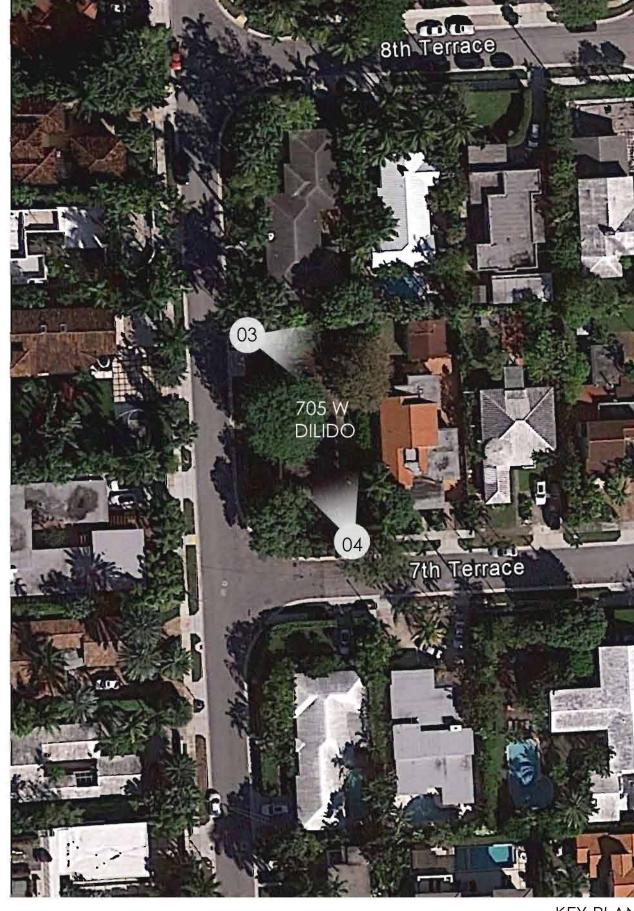

E S | G N (t) 305.434.8338 (f) 305.892.5292

R E + D E

CHOEFFLEY
ARCHITECTU

8425 Biscopne Bivd, suite 201
Miami, Florido 33138

NEW RESIDENCE 705 W Dilido,

...

Ralph Choeff stered architect

comm no. 1658

date: 11-22-2016

revised:


sheet no.



05. REAR ELEVATION 7th TERRACE



06. REAR ELEVATION 7th TERRACE

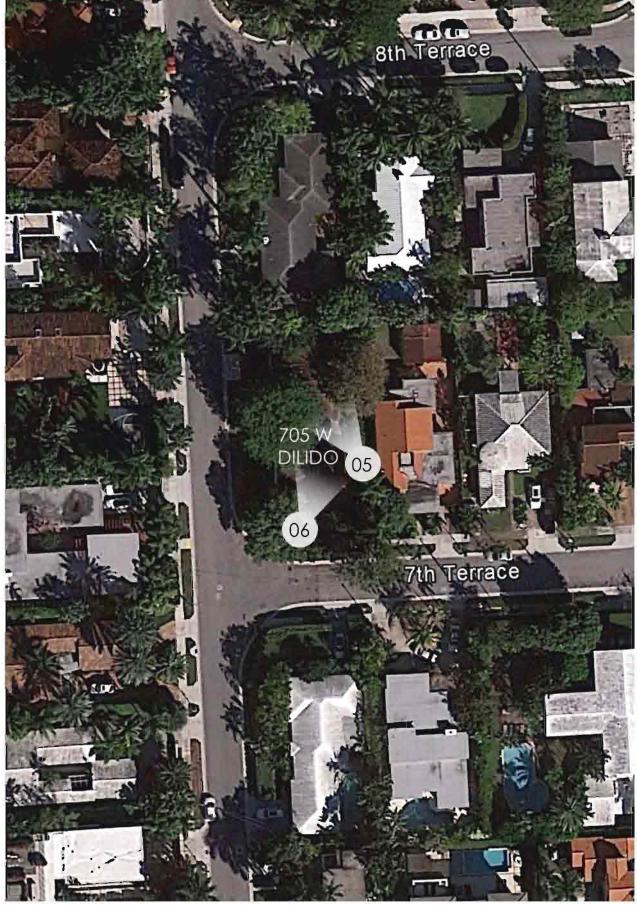

(t) 305.434 8338 (f) 305.892.5292

E + D E S

TECTURE

CHOEFF ARCHIT 8425 Biscopre Blvd, suite Miami, Florido 33138

> NEW RESIDENCE 705 W Dilido, MIAMI BEACH, FL 33139

> > sea

Ralph Choeff istered architect AR0009679

comm no. 1658

date: 11-22-2016

. .


sheet no.



01. 115 7th DI LIDO TER



02. 111 7th DI LIDO TER

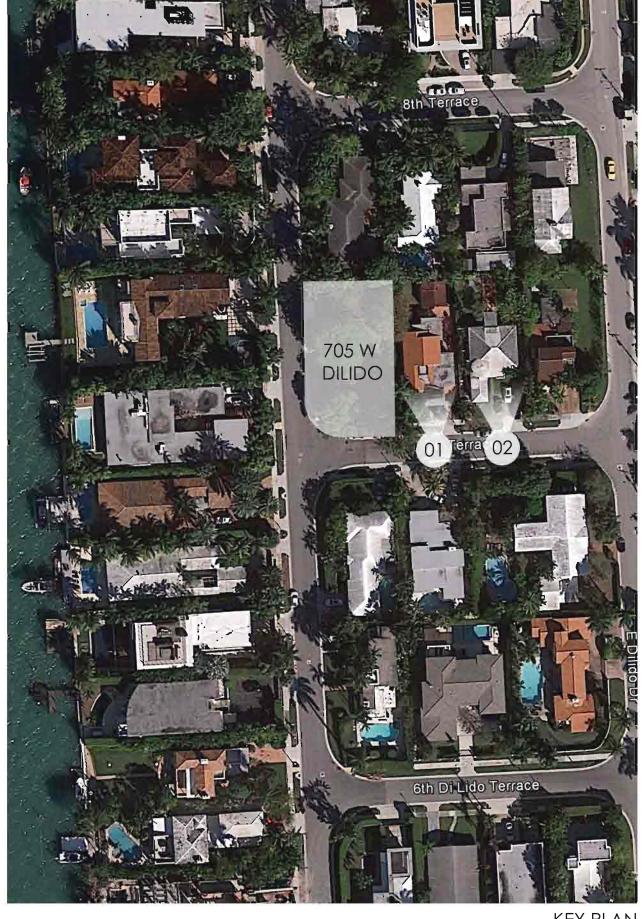

comm no. 1658

date: 11-22-2016

revised:


EX-1.5



03. 103 7th DI LIDO TER



04. 620 E DI LIDO DR

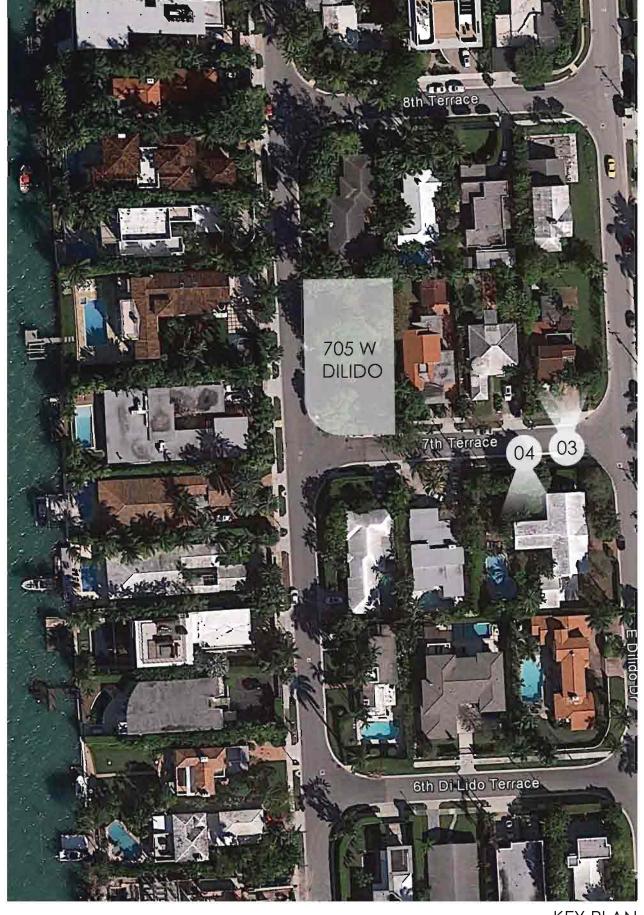

KEY PLAN

E S I G N (t) 305.434.8338 (f) 305.892.5292

E + D E S

A R C H I T E

NEW RESIDENCE 705 W Dilido, MIAMI BEACH, FL 33139

eal

Ralph Choeff istered architect AR0009679

comm no. 1658

date: 11-22-2016

evised.


EX-1.6



05. 112 7th DI LIDO TER



06. 621 W DI LIDO DR

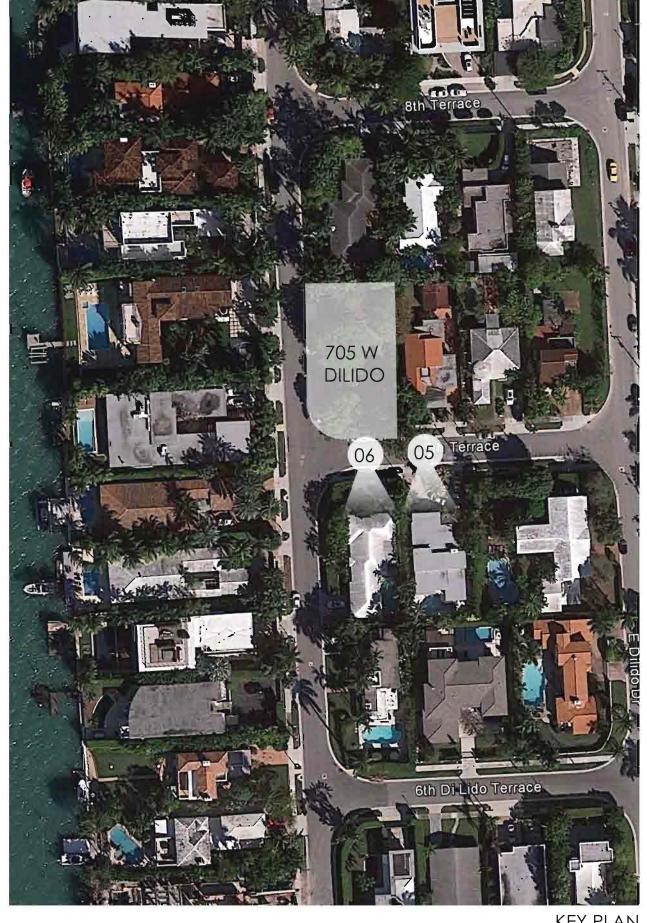

comm no. 1658

date: 11-22-2016

revised:

sheet no.




date: 11-22-2016



07. 601 W DI LIDO DR



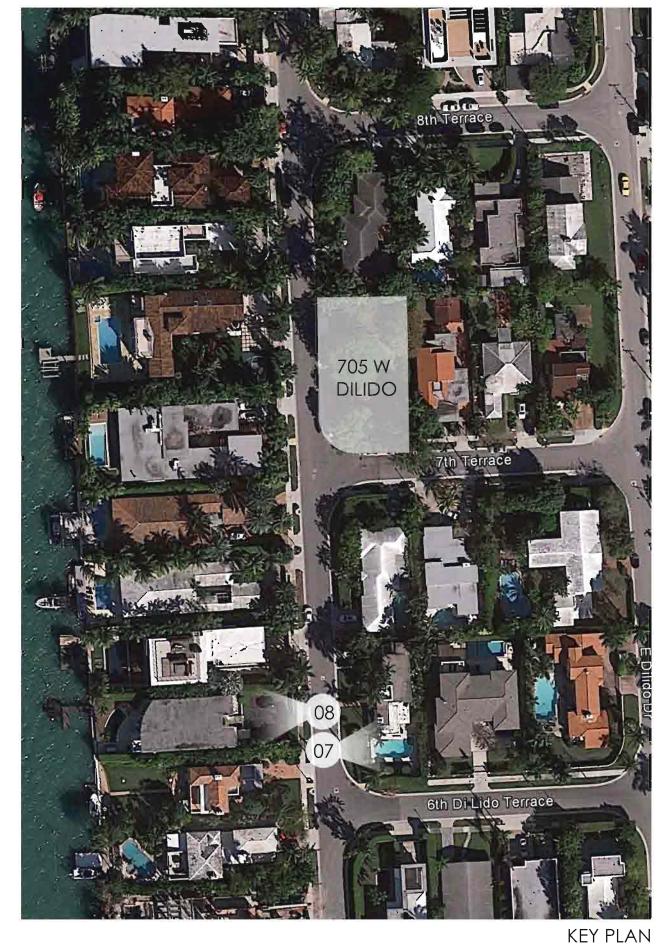


08. 608 W DI LIDO DR



09. 610 W DI LIDO DR



10. 620 W DI LIDO DR

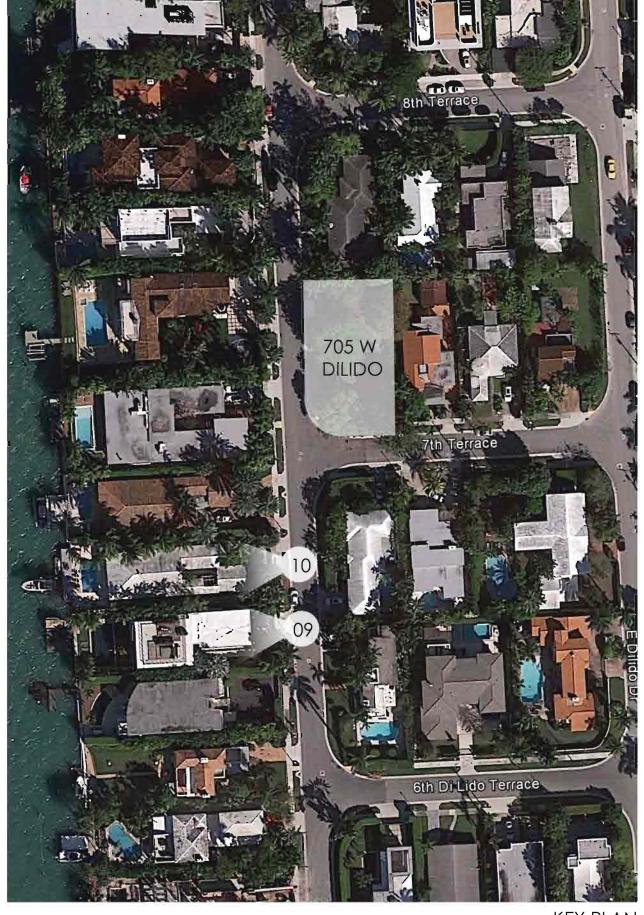

KEY PLAN

date: 11-22-2016


revised:



11. 630 W DI LIDO DR



12. 700 W DI LIDO DR

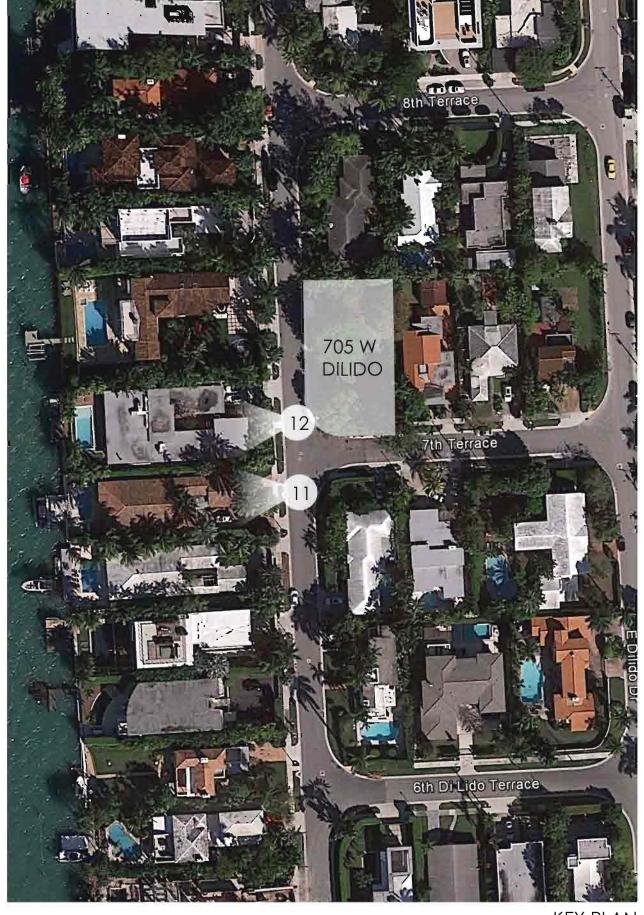

KEY PLAN

date: 11-22-2016




CHOEFF ARCHIT 8425 Biscoyne Bivd, sui Miami, Florida 33138


KEY PLAN





13. 714 W DI LIDO DR

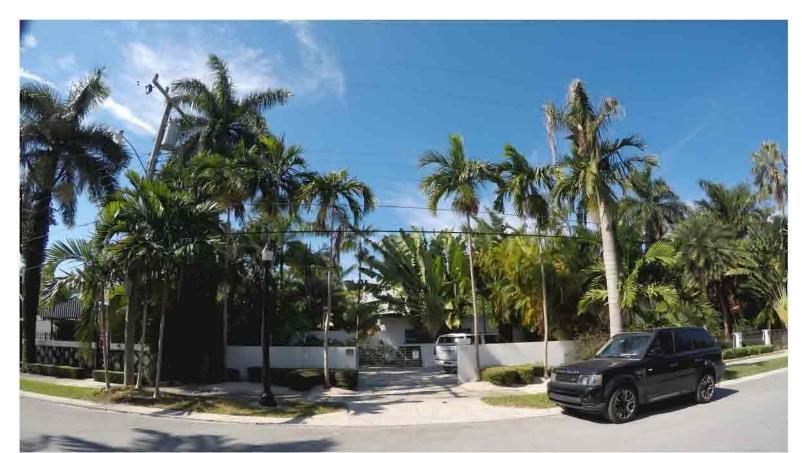

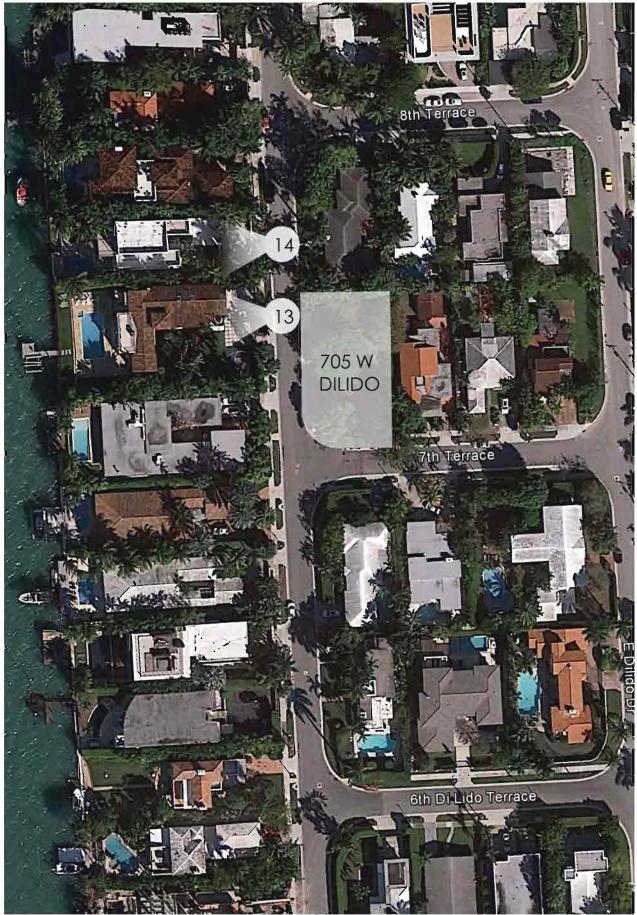




15. 726 W DI LIDO DR



16. 725 W DI LIDO DR

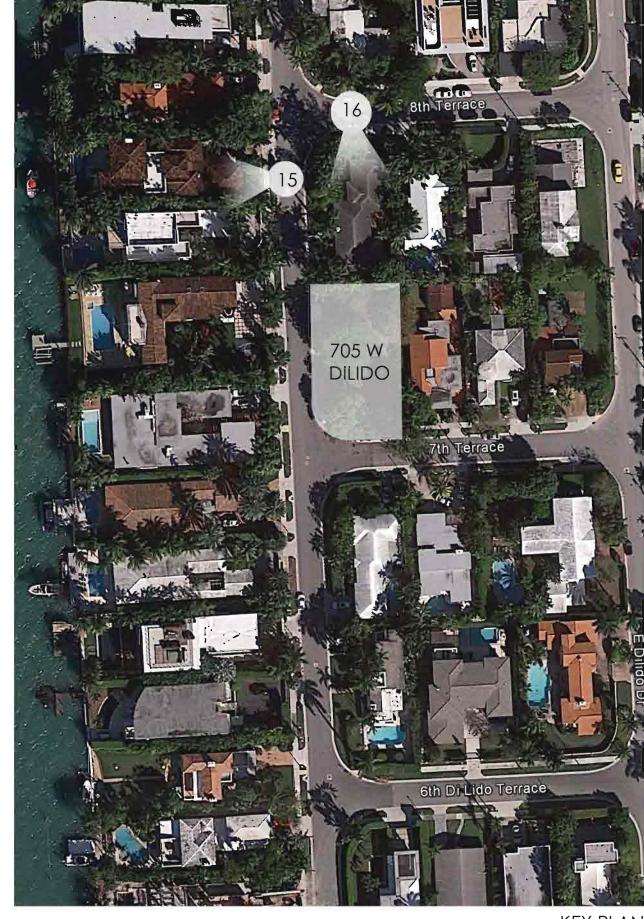

E S I G N (t) 305.434.8338

+ D E S

CTURE

R C H I T E C

S Biscoyne Blvd, suite 201

NEW RESIDENCE

sea

Ralph Choeff


comm no. 1658

date: 11-22-2016

. .

sheet no.

PLOT DAT

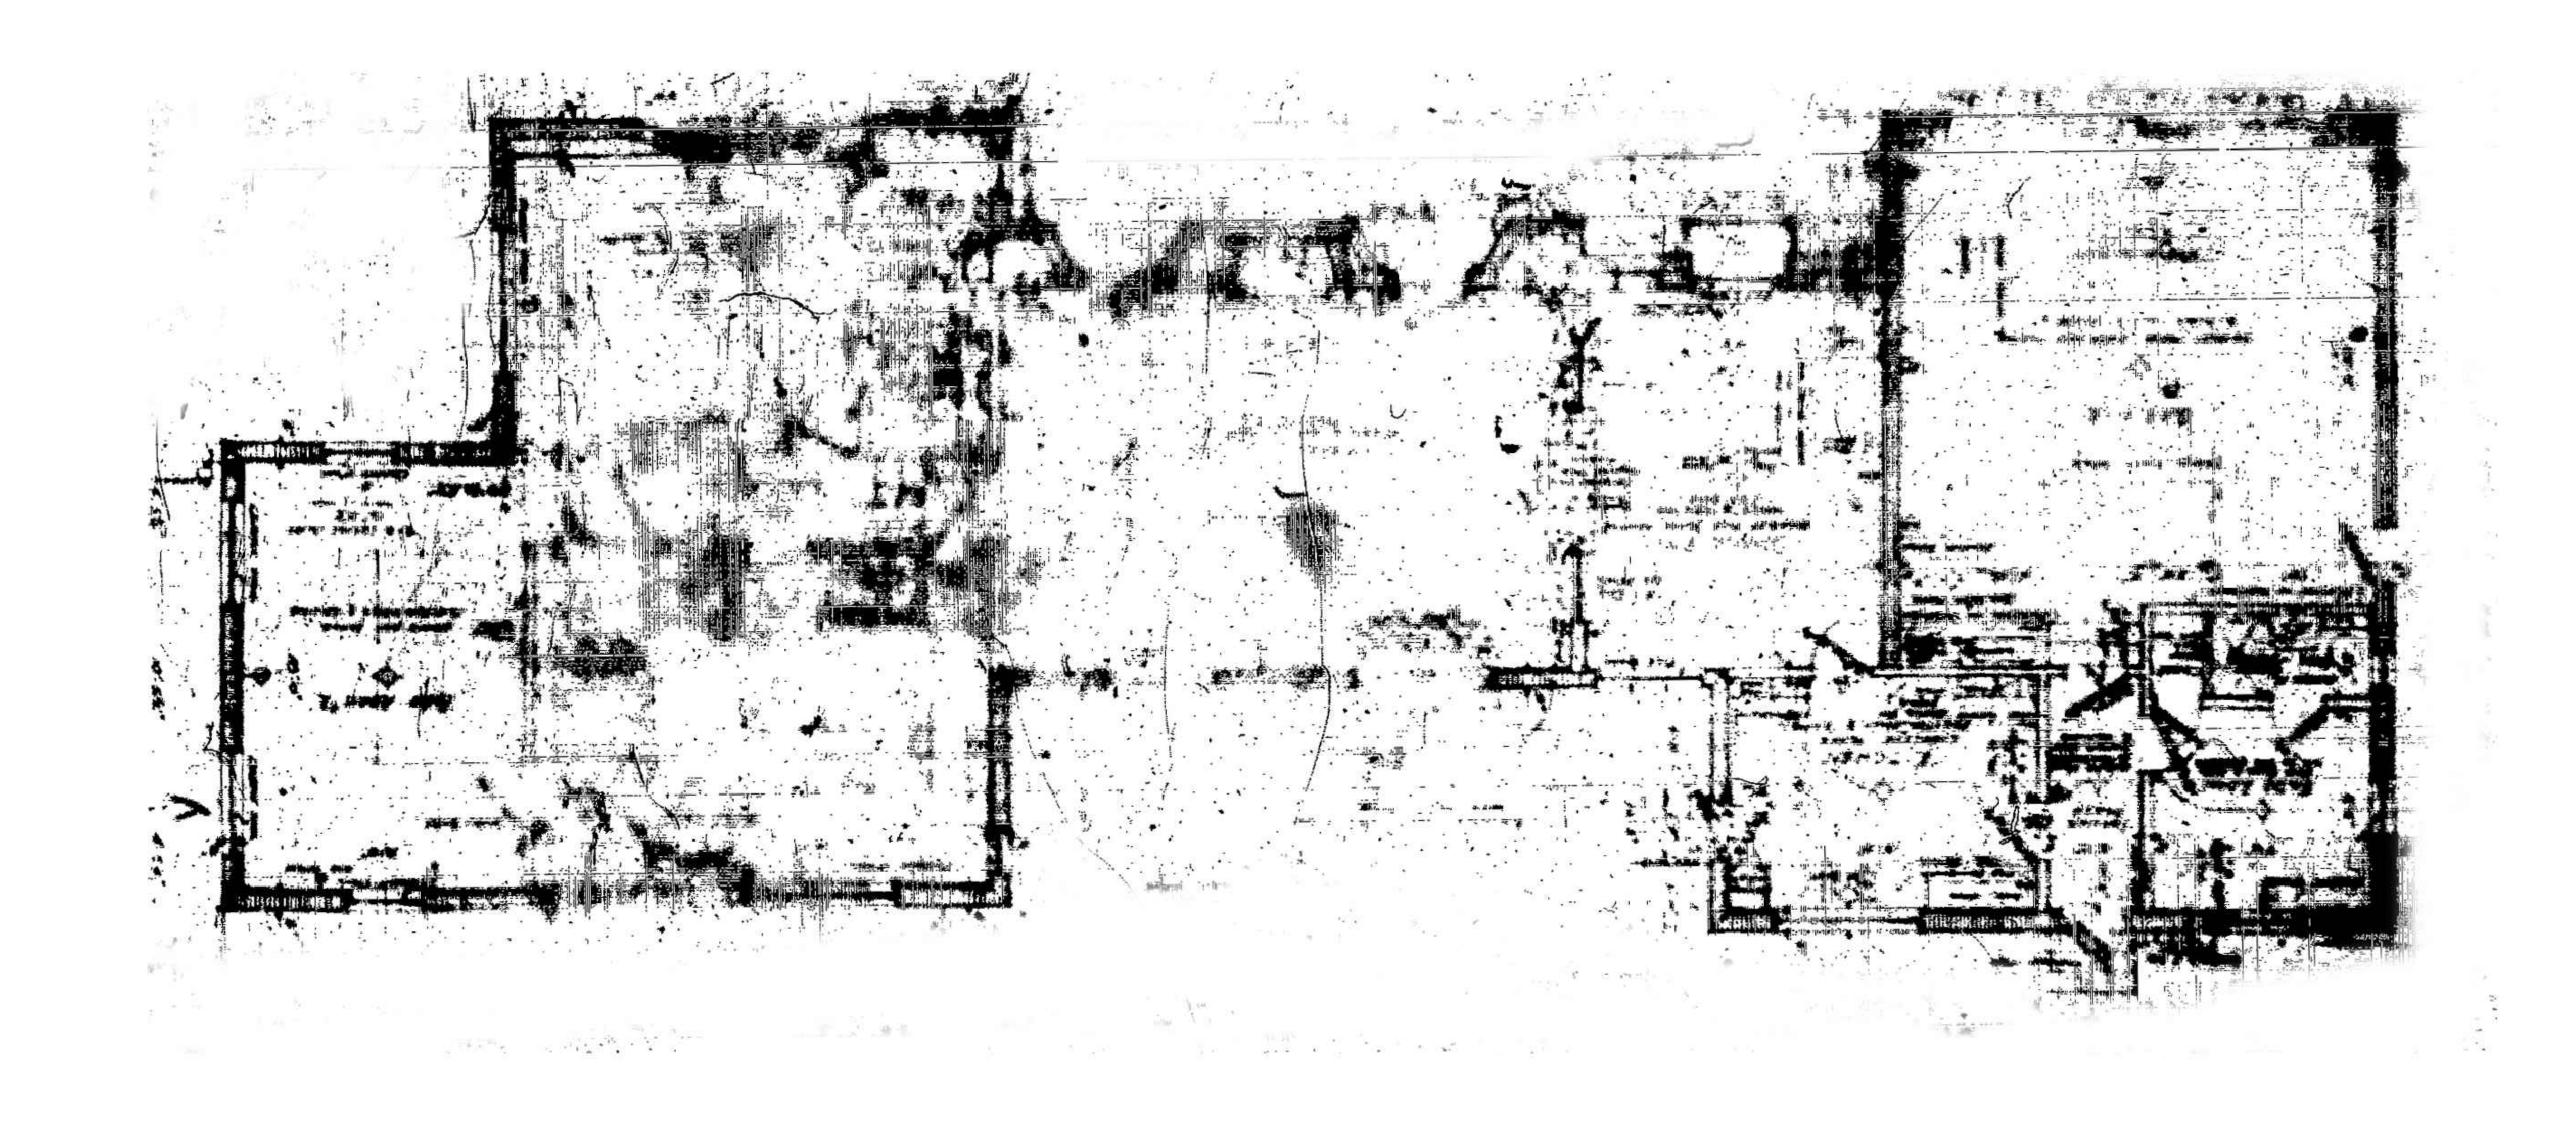


revised:

sheet no.

EX-1.2

PLOT DATE: 2016-11-18

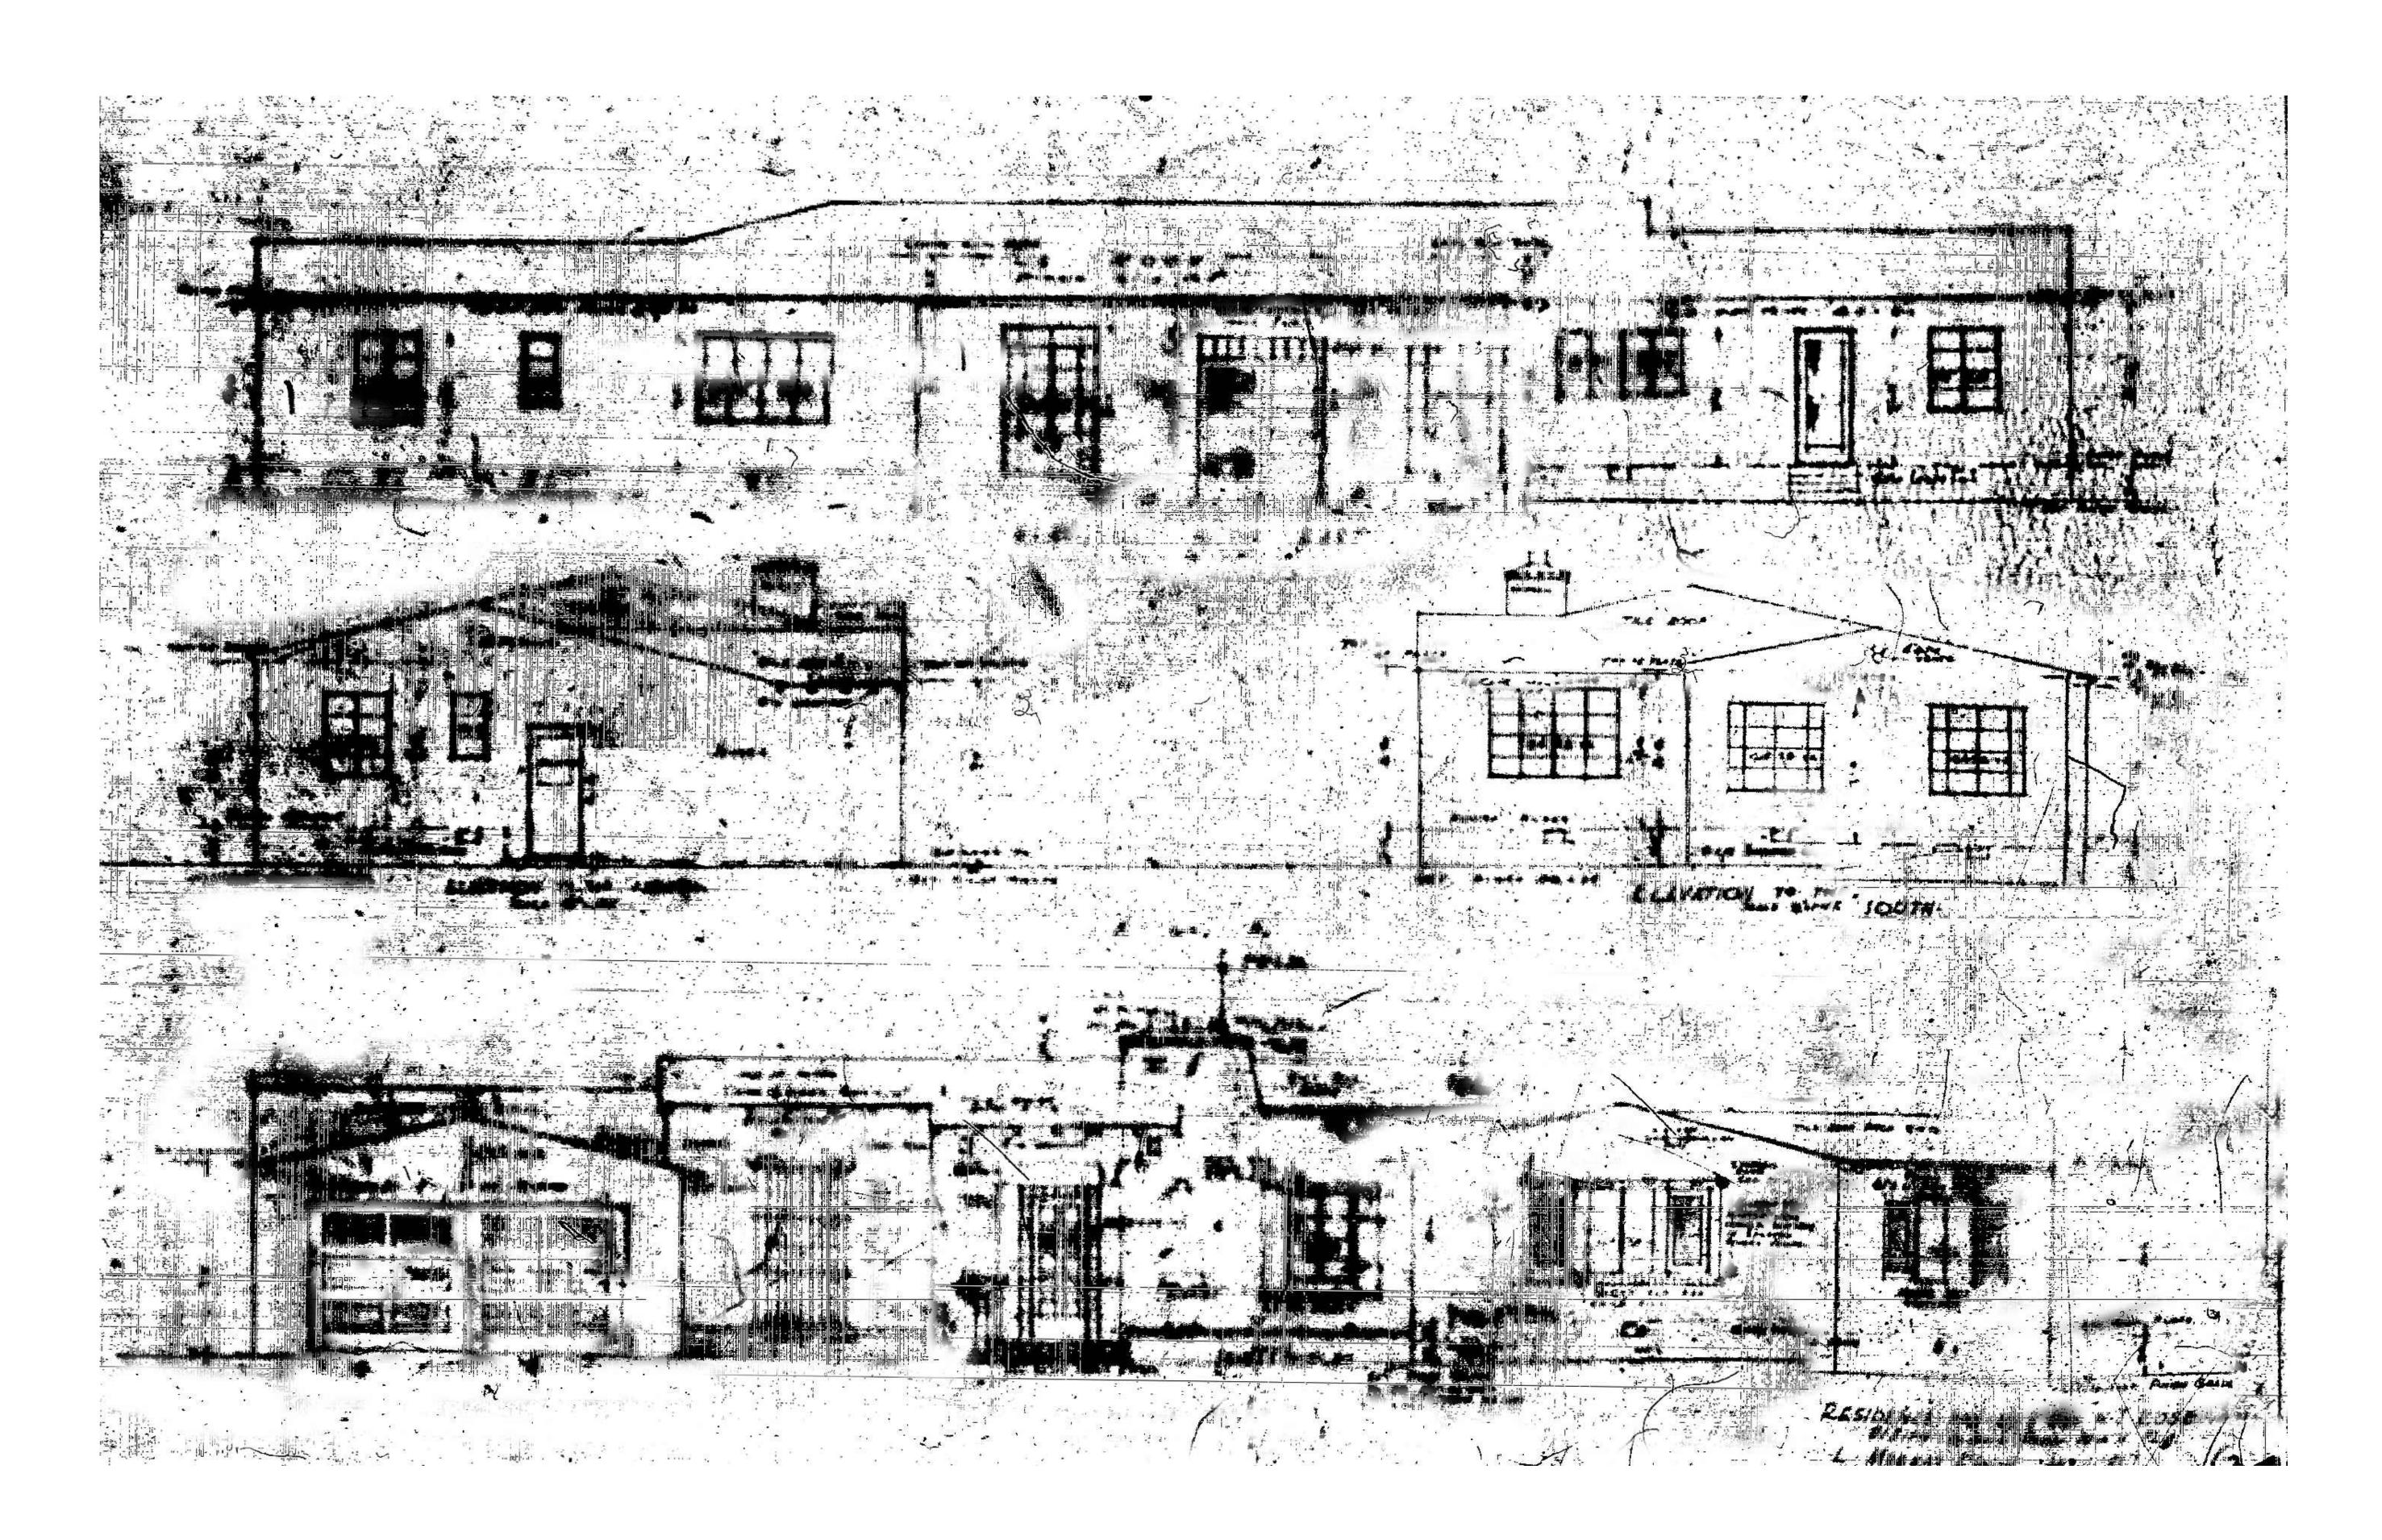

ELEVATIONS existing residence

SCALE: 1/8" = 1'-0"

CHOEFF LEVY FISCHMANNARARCHITECTURE + DESIGN

NEW RESIDENCE 705 W Dilido, MIAMI BEACH, FL 33139

seal

Ralph Choeff registered architect AR0009679

comm no. **1658**

date: 11-22-2016

revised:

sheet no. **EX-1.3**PLOT DATE: 2016-11-18

SCALE: 1/8" = 1'-0"

CHOEFF LEVY FISCHMANARRCHITECTURE + DESIGN

NEW RESIDENCE 705 W Dilido, MIAMI BEACH, FL 33139

seal

Ralph Choeff registered architect AR0009679

comm no. **1658**

date: 11-22-2016

revised:

sheet no.

EX-1.4

PLOT DATE: 2016-11-18

DEMOLITION plan

SCALE: 1/8" = 1'-0"

SINGLE FAMILY RESIDENTIAL - ZONING DATA SHEET

ITEM #	Zoning Information							
1	Address:	705 W Dilido dr. Miami Beach Florida 33139						
2	Folio number(s):	02-3232-011-1630						
3	Board and file numbers :	DRB16-0093						
4	Year built:	1937	Zoning District:	RS-4				
5	Based Flood Elevation:	9.00'	Grade value in NGVD:	7.23'				
6	Adjusted grade (Flood+Grade/2):	8.11'	Free board:	10.00'				
7	Lot Area:	7,500 sq ft						
8	Lot width:	60'	Lot Depth:	125'				
9	Max Lot Coverage SF and %:	2,250 SQ FT (30%)	Proposed Lot Coverage SF and %:	1,874 SQ FT (24.98)				
10	Existing Lot Coverage SF and %:	2,609 SQ FT (35.9%)	Lot coverage deducted (garage-storage) SF:	N/A				
11	Front Yard Open Space SF and %:	827 SQ FT (77.5%)	Rear Yard Open Space SF and %:	1,012 SQ FT (84.3%)				
12	Max Unit Size SF and %:	3,750 SQ FT (50%)	Proposed Unit Size SF and %:	3,658 SQ FT (48.77%)				
13	Existing First Floor Unit Size:	2,692 SQ FT	Proposed First Floor Unit Size:	1,778 SQ FT				
14	Existing Second Floor Unit Size		Proposed Second Floor volumetric Unit Size SF and % (Note: to exceed 70% of the first floor of the main home require DRB	N/A				
15		N/A	Proposed Second Floor Unit Size SF and %:	1,878 SQ FT				
16			Proposed Roof Deck Area SF and % (Note:					
			Maximum is 25% of the enclosed floor	N1/A				
			area immediately below):	N/A				

		Required	Existing	Proposed	Deficiencies
17	Height:	24'-0"	12'-6"	24'-0"	
18	Setbacks:				
19	Front First level:	30'-0"	20.9'	33'-8"	
20	Front Second level:	30'-0"	NA	33'-8"	
21	Side 1:	7'-6"	17.4'	7'-6"	
22	Side 2 or (facing street):	15'-0"	9.8'	17'-6"	
23	Rear:	20'-0"	12.95'	20'-0"	
	Accessory Structure Side 1:	N/A	N/A	N/A	N/A
24	Accessory Structure Side 2 or (facing street):	N/A	N/A	N/A	N/A
25	Accessory Structure Rear:	N/A		N/A	N/A
26	Sum of Side yard :	22'-6"	27.2'	25'-0"	
27	Located within a Local Historic Dist	NO			
28	Designated as an individual Histor	ric Single Family Reside		NO	
29	Determined to be Architecturally Significant?		NO		

Notes:

If not applicable write N/A

All other data information should be presented like the above format

comm no. 1658

date: 11-22-2016

revised:

ZONING data sheet

PROJECT DATA

SCOPE OF WORK:

24.98%

30%

NEW 2-STORY, CBS, SINGLE FAMILY RESIDENCE

OCCUPANCY TYPE: **CONSTRUCTION TYPE** RESIDENTIAL RS-3 TYPE V-B

CLASSIFICATION OF STRUCTURE FOR FLOOD-RESISTANT DESIGN AND CONSTRUCTION: CATEGORY II

LEGAL DESCRIPTION

LOT 8, BLOCK 14, OF DILIDO ISLAND, ACCORDING TO THE PLAT THEREOF AS RECORDED IN PLAT BOOK 8 AT PAGE 36, OF THE PUBLIC RECORDS OF MIAMI-DADE COUNTY, FLORIDA.

PUBLIC WORKS NOTES:

AREA:

AREA:

AREA:

A-REMOVE AND REPLACE SIDEWALK ALONG THE ENTIRE PROPERTY.

B- RECONSTRUCT SWALE/SOD ALONG THE ENTIRE PROPERTY.


C- MILL AND RESURFACE 2 INCHES AVERAGE USING TYPE S-III ASPHALT MIX DESIGN ON THE DRIVING LANE (10 FOOT WIDE) ALONG THE ENTIRE PROPERTY.

D- ANY WORK AND/OR IMPROVEMENTS FROM/TO THE RIGHT-OF-WAY INCLUDING LANDSCAPING AND IRRIGATION REQUIRE A SEPARATE CMB PUBLIC WORKS DEPARTMENT RIGHT-OF-WAY CONSTRUCTION PERMIT.

E- ALL CONSTRUCTION AND/OR USE OF EQUIPMENT IN THE RIGHT-OF-WAY WILL REQUIRE A SEPARATE CITY OF MIAMI BEACH PUBLIC WORKS DEPARTMENT RIGHT-OF-WAY CONSTRUCTION PERMIT PRIOR TO START OF CONSTRUCTION.

"UPON PLACEMENT OF THE LOWEST FLOOR AND PRIOR TO FURTHER VERTICAL CONSTRUCTION, AN ELEVATION CERTIFICATE SHALL BE SUBMITTED TO THE BUILDING DEPARTMENT FOR REVIEW AND APPROVAL (FBC 2010, BUILDING SECTION 110.3)".

"AS BUILT ELEVATION CERTIFICATE FOR FINISHED CONSTRUCTION SHALL BE SUBMITTED TO BUILDING DEPARTMENT FOR REVIEW AND APPROVAL PRIOR TO OBTAINING CERTIFICATE OF OCCUPANCY"

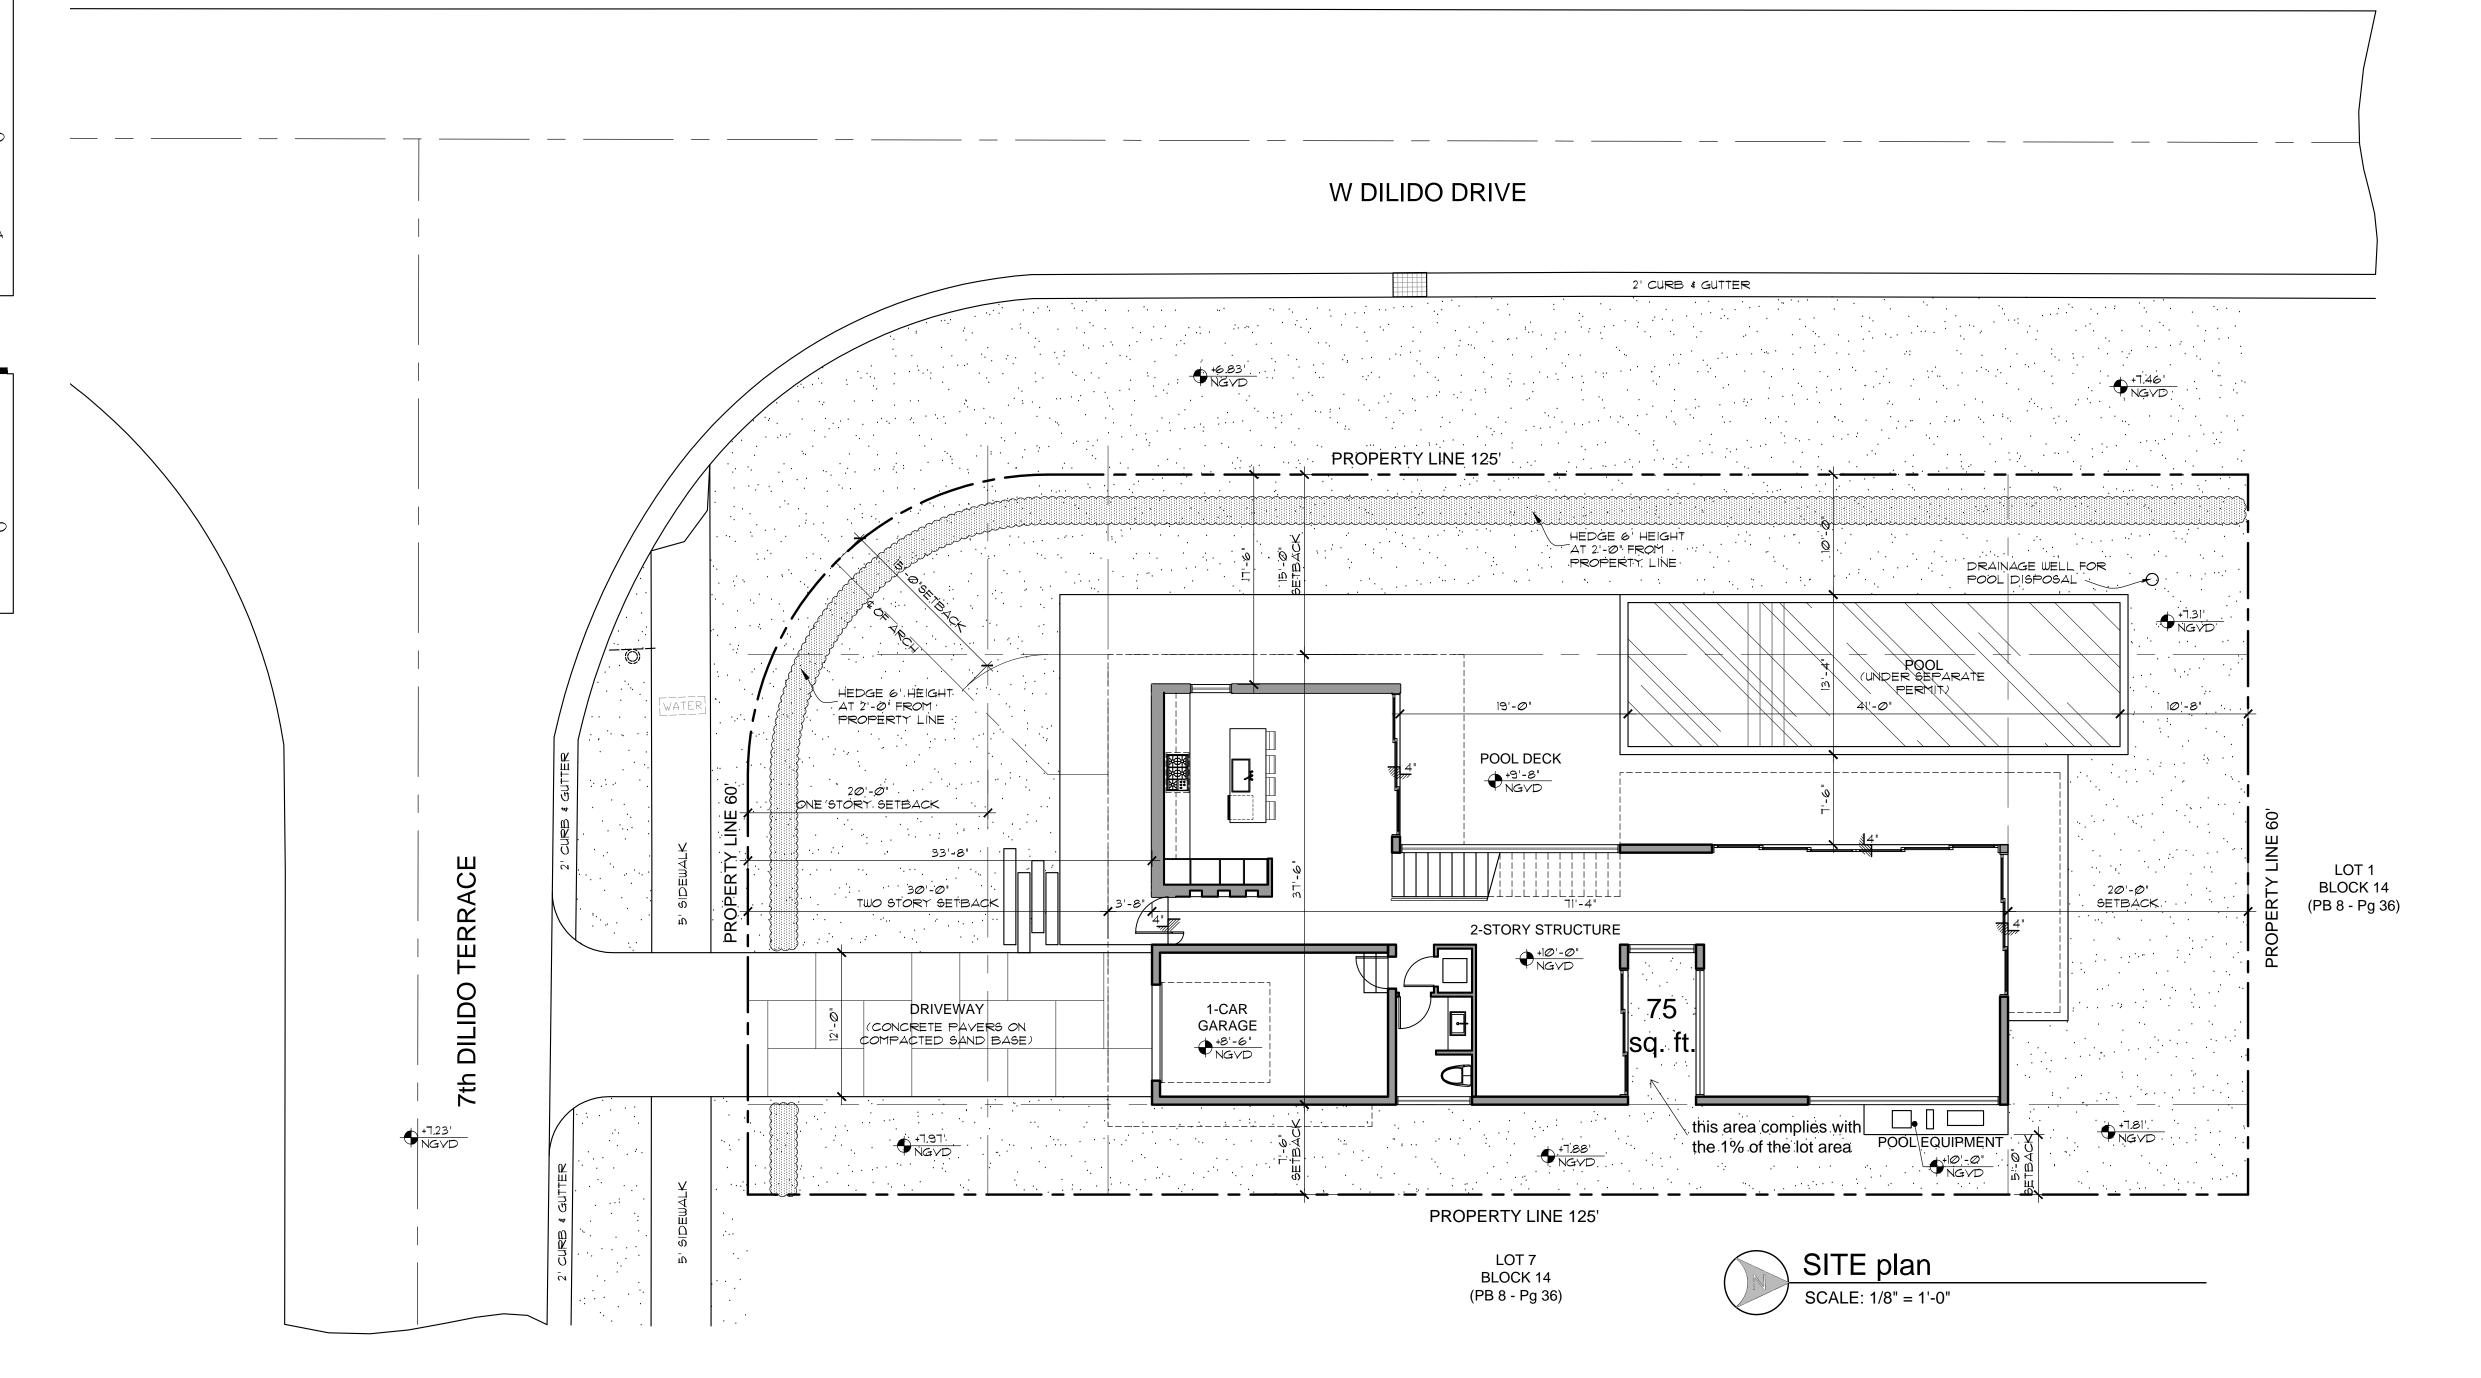

S

 $\widehat{\Xi}\widehat{\Xi}$

SIDENCE NEV

seal


Ralph Choeff registered architect AR0009679

> comm no. 1658

> date: 11-22-2016

revised:

sheet no.

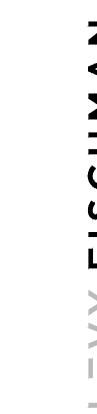

CTCILLT L=VY TA R C H I T E C T U R E +
8425 Biscavne Blvd. suite 201

NEW RESIDENCE
705 W Dilido,
MIAMI BEACH, FL 33139


seal


Ralph Choeff registered architect AR0009679


> comm no. 1658

date: 11-22-2016

revised:

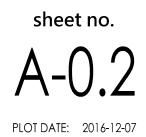


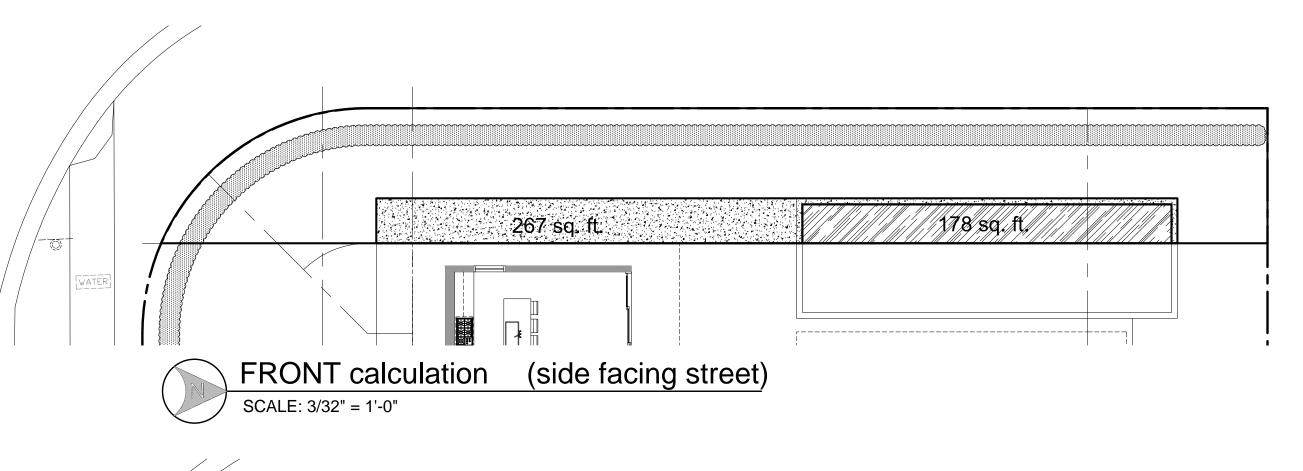


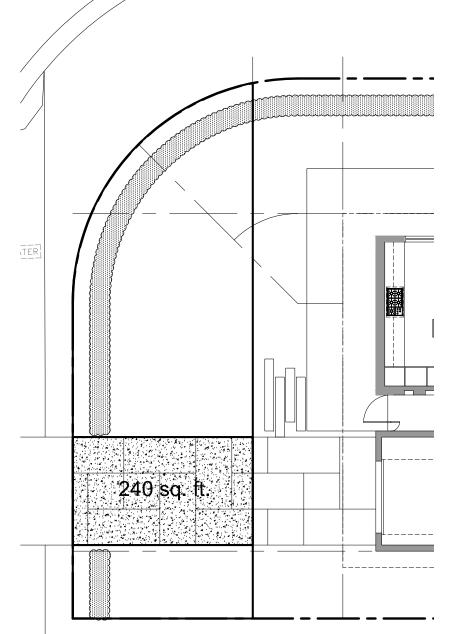



FRONT calculation


SCALE: 3/32" = 1'-0"

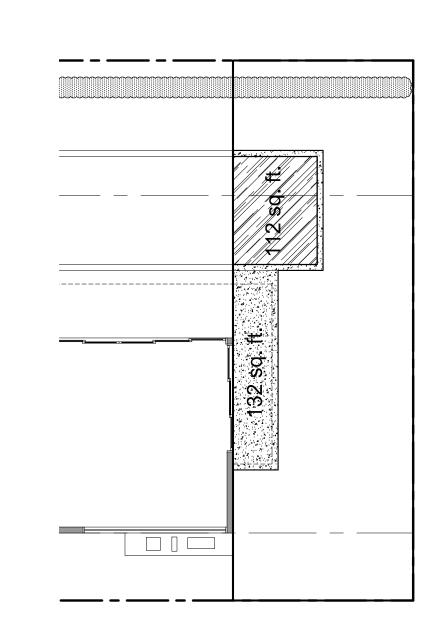


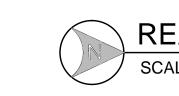

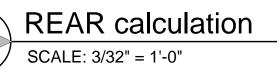

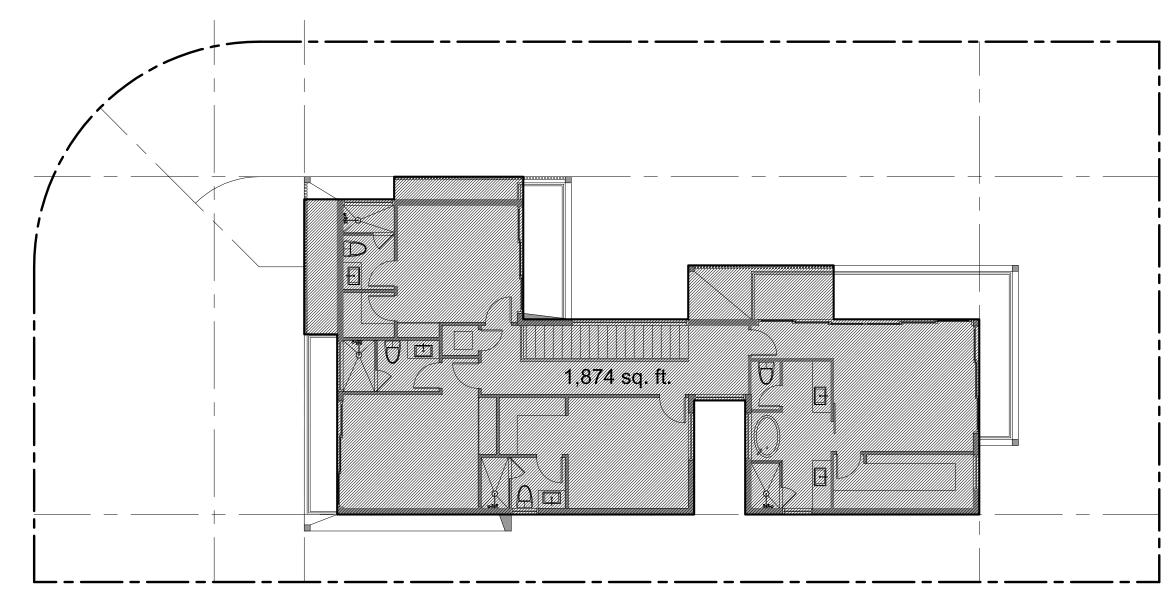

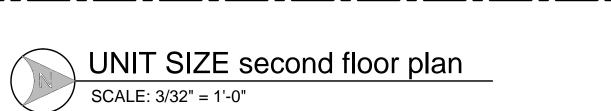

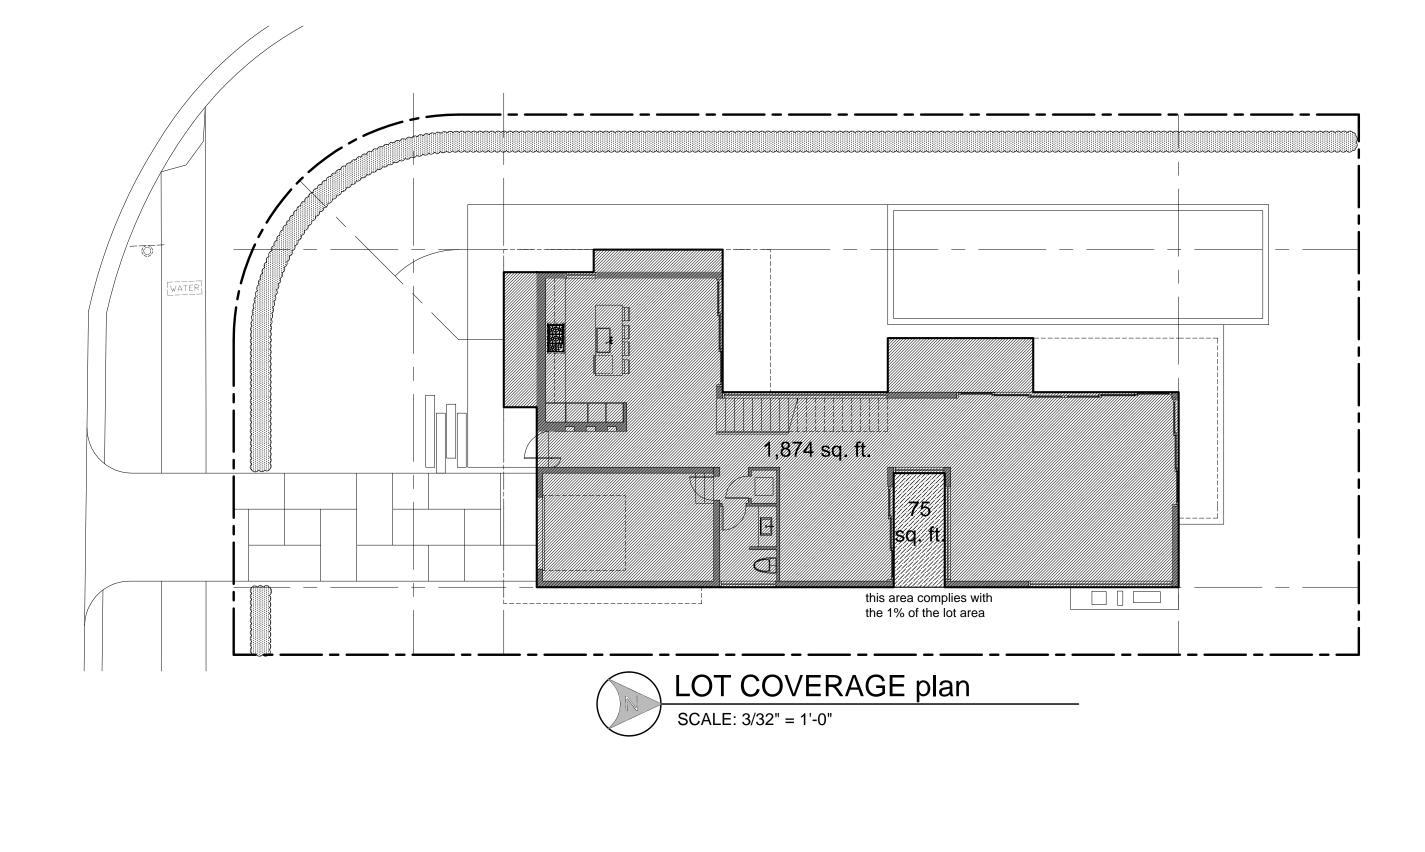


DRIVEWAY / WALKS / POOL DECK

LANDSCAPING

LOT COVERAGE legend:

RESIDENCE (BUILDING LOT COVERAGE)

COVERED TERRACES
(BUILDING LOT COVERAGE)

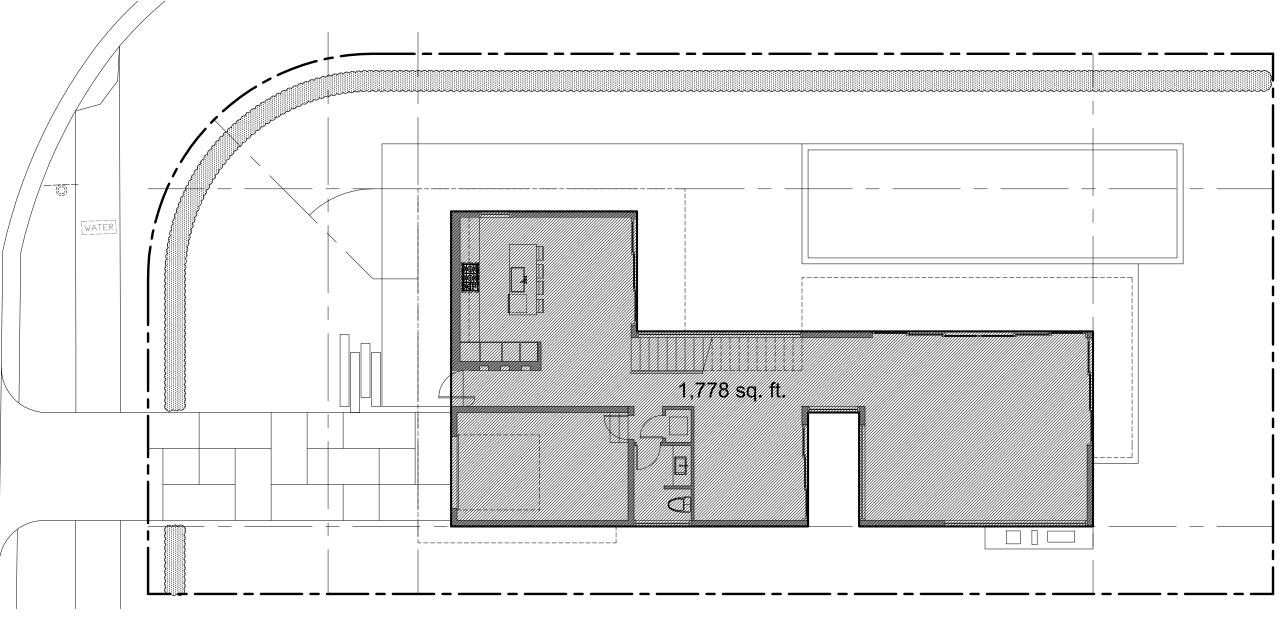




APPLICABLE CODE: F.B.C. 2014 RESIDENTIAL - ALL PLANS AND CALCULATIONS HAVE BEEN PREPARED IN COMPLIANCE WITH F.B.C. 2014 RESIDENTIAL

GENERAL NOTE:

ANY LOUVER, SCREENS AND OPENING SHALL NOT BLOCK OR IMPEDE THE AUTOMATIC FLOW OF FLOOD WATERS INTO OR OUT OF THE ENCLOSED AREA

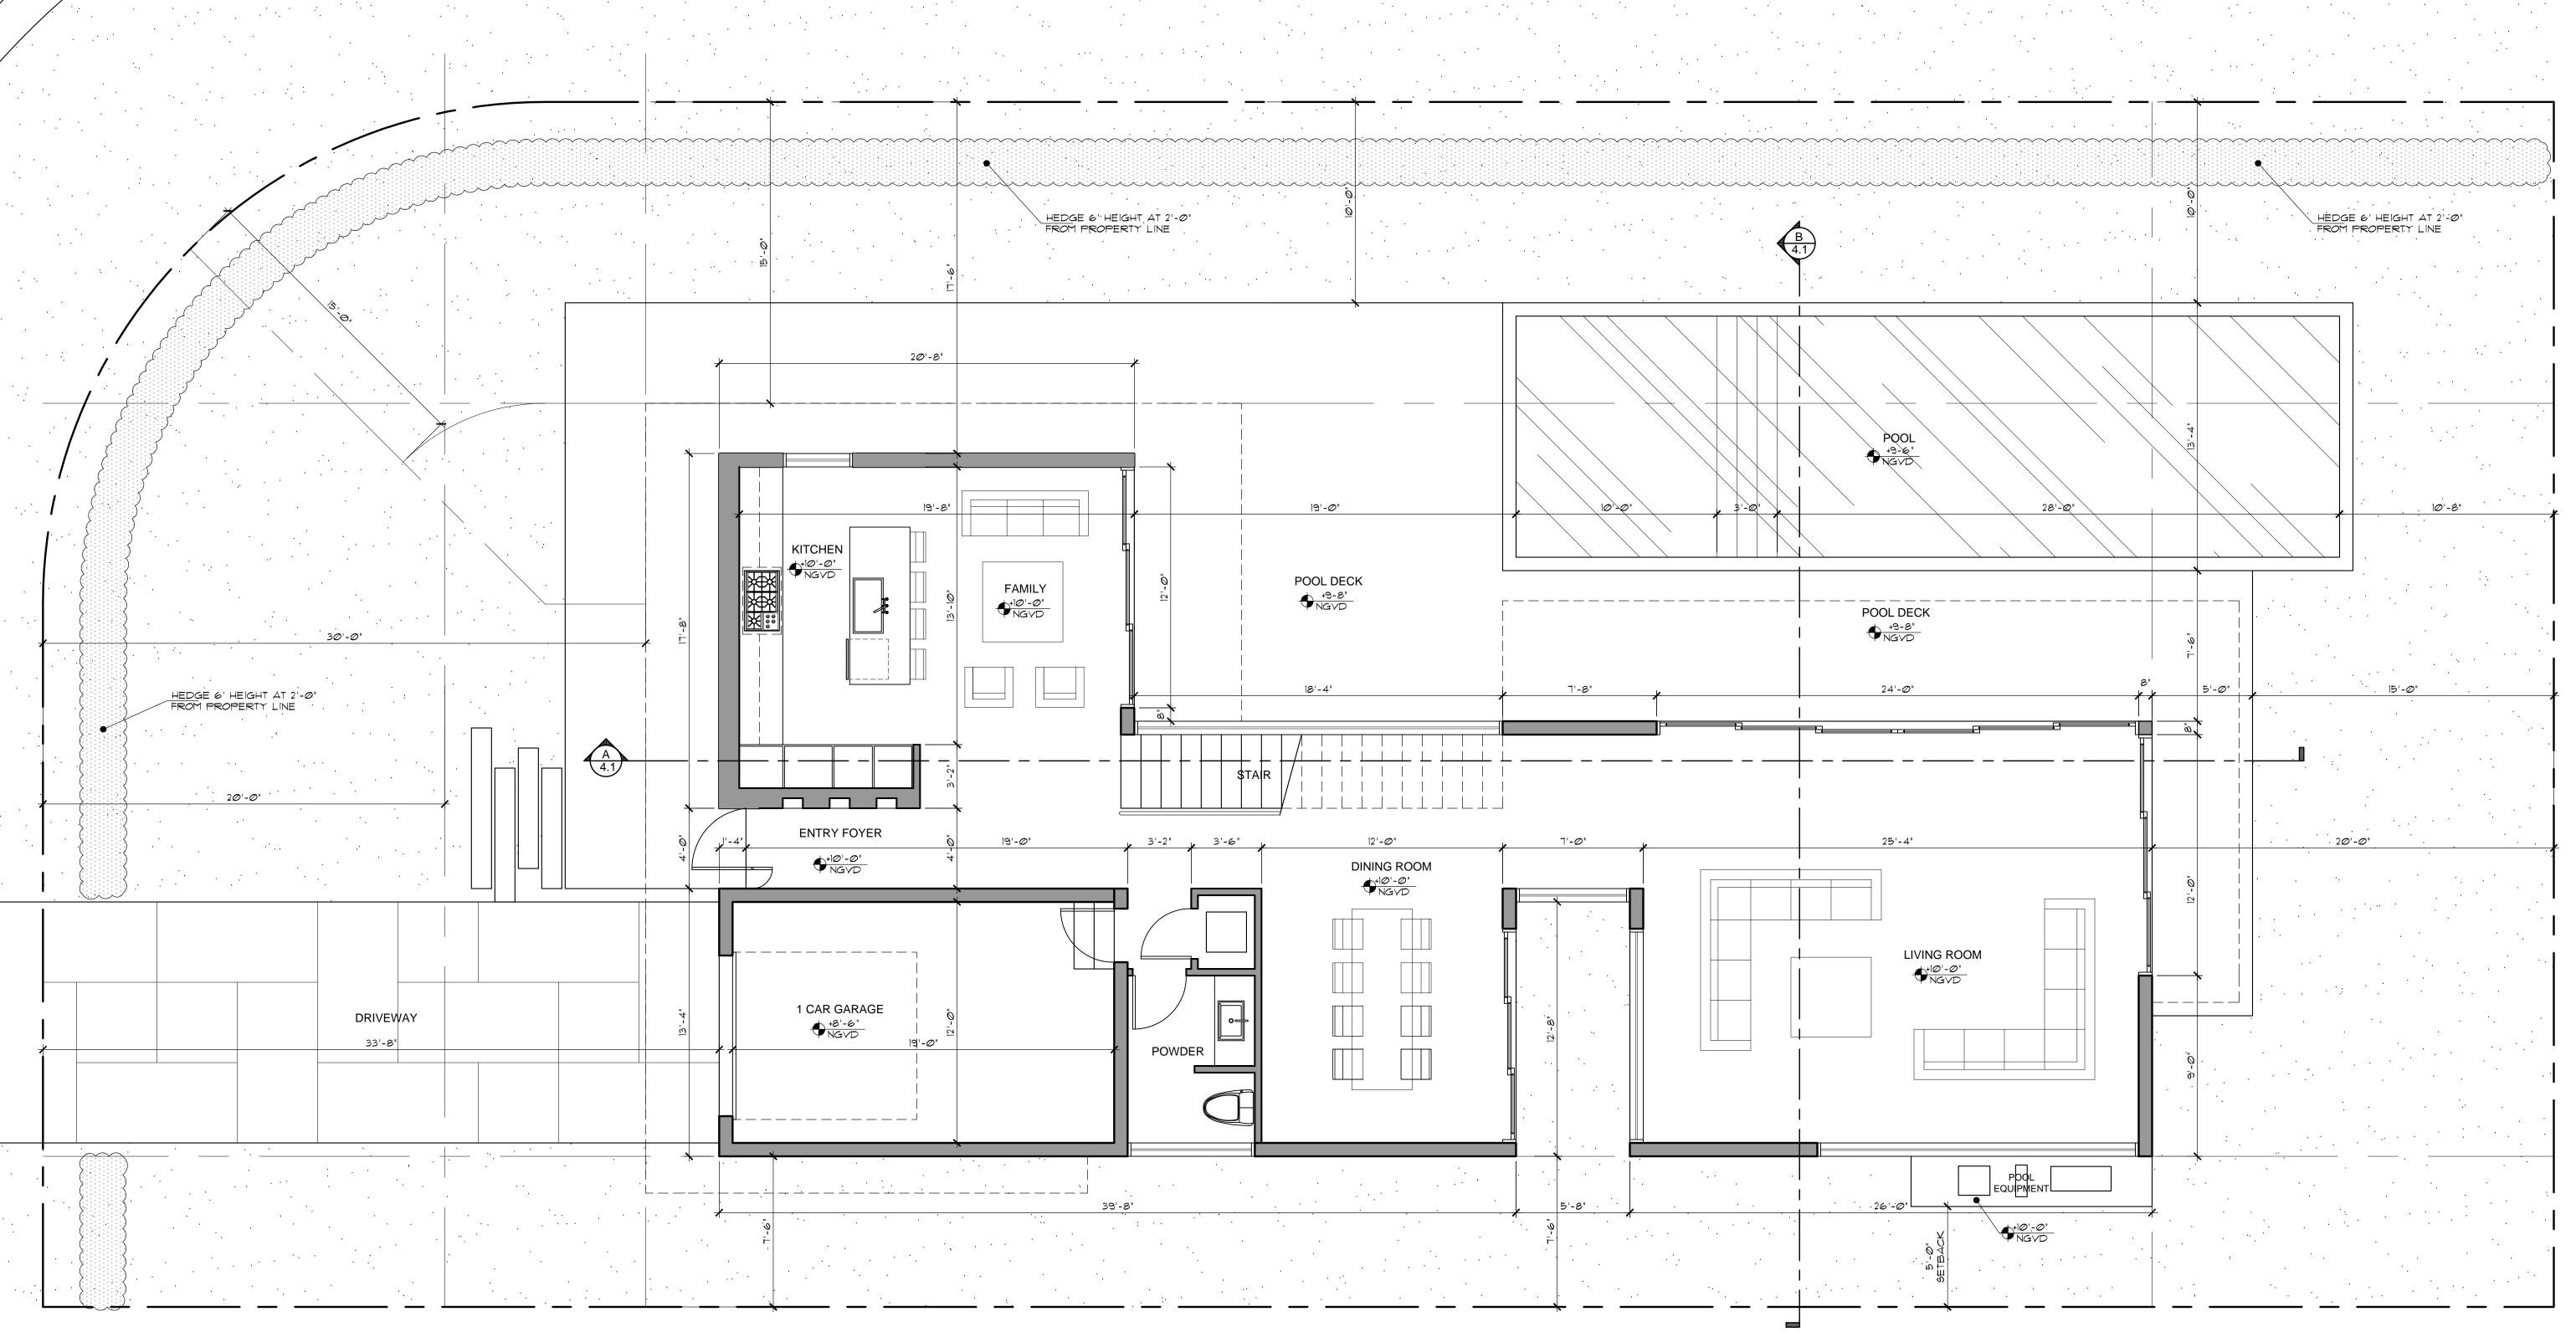

FIRST floor plan

SCALE: 1/4" = 1'-0"

plan

CHOEFF LEVY FISCHIAR + DES

NEW RESIDENCE 705 W Dilido, MIAMI BEACH, FL 33139

seal

Ralph Choeff registered architect AR0009679

comm no. **1658**

date: 11-22-2016

revised:

sheet no.


A-1.1

PLOT DATE: 2016-12-07

APPLICABLE CODE: F.B.C. 2014 RESIDENTIAL - ALL PLANS AND CALCULATIONS HAVE BEEN PREPARED IN COMPLIANCE WITH F.B.C. 2014 RESIDENTIAL

GENERAL NOTE:

ANY LOUVER, SCREENS AND OPENING SHALL NOT BLOCK OR IMPEDE THE AUTOMATIC FLOW OF FLOOD WATERS INTO OR OUT OF THE ENCLOSED AREA

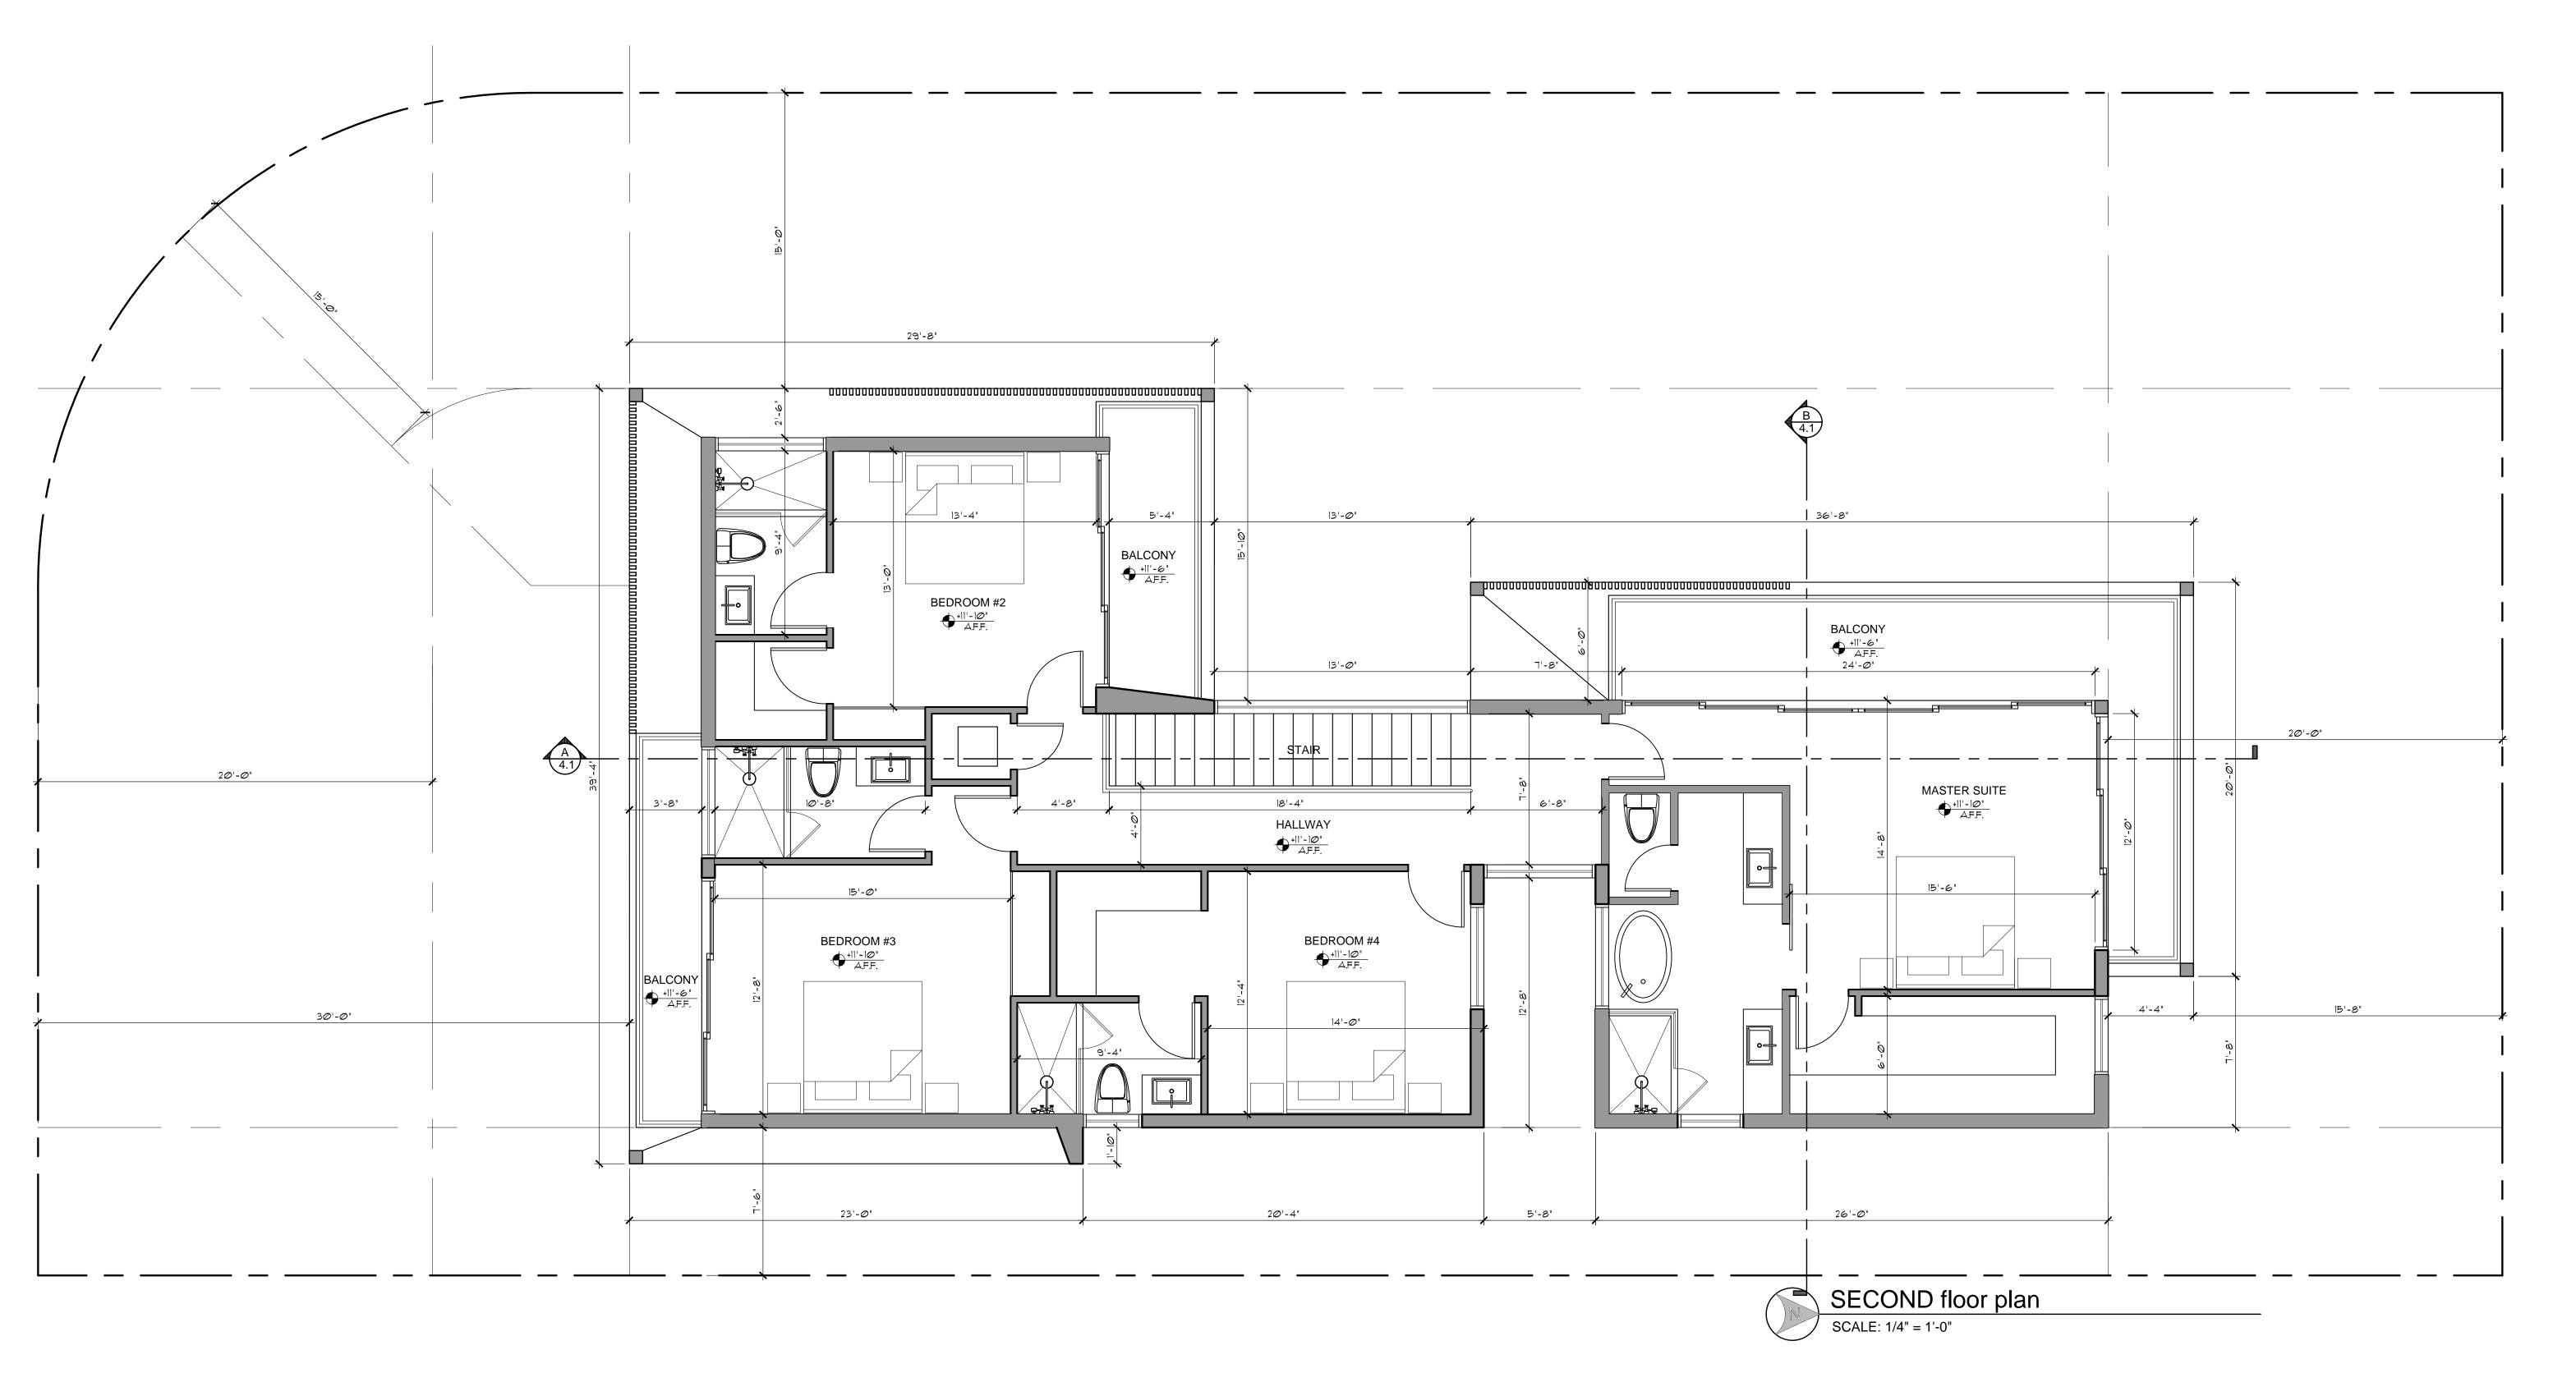

TITL CIURE + DES

NEW RESIDENCE 705 W Dilido, MIAMI BEACH, FL 33139

Ralph Choeff registered architect AR0009679

comm no. **1658**

date: 11-22-2016

revised:

sheet no.


A-1.2

PLOT DATE: 2016-12-07

APPLICABLE CODE: F.B.C. 2014 RESIDENTIAL - ALL PLANS AND CALCULATIONS HAVE BEEN PREPARED IN COMPLIANCE WITH F.B.C. 2014 RESIDENTIAL

GENERAL NOTE:

ANY LOUVER, SCREENS AND OPENING SHALL NOT BLOCK OR IMPEDE THE AUTOMATIC FLOW OF FLOOD WATERS INTO OR OUT OF THE ENCLOSED AREA

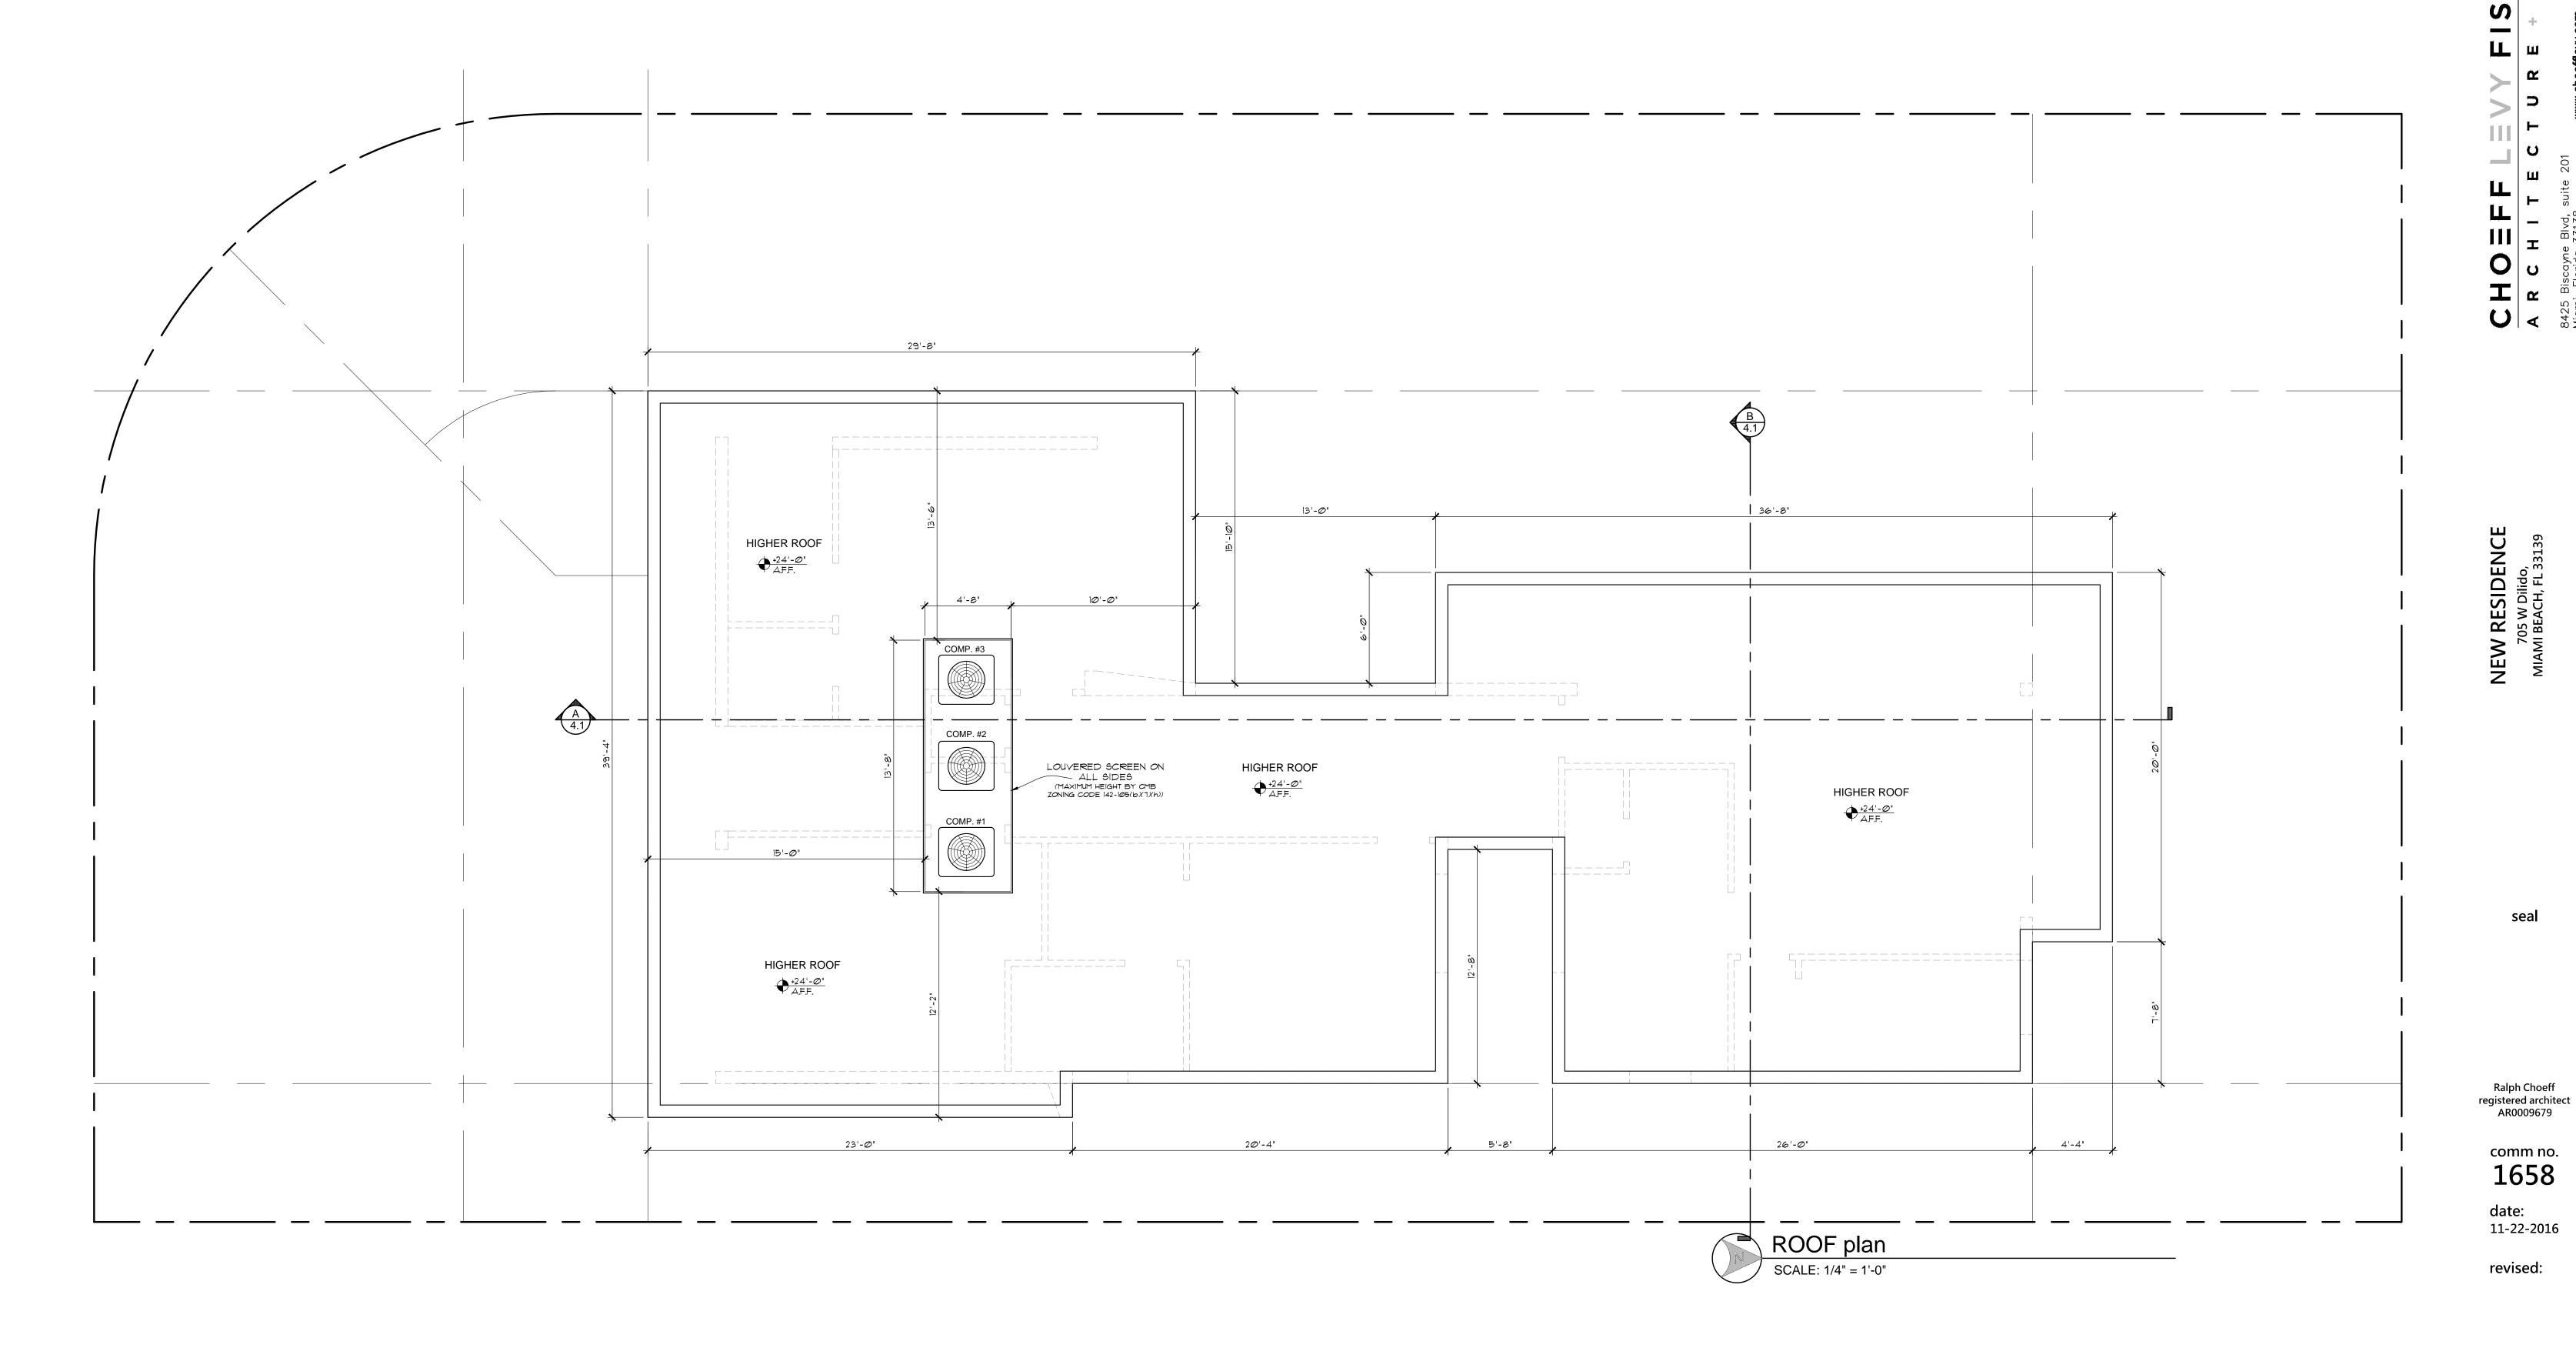


sheet no.

revised:

sheet no.

A-2.1


PLOT DATE: 2016-12-07

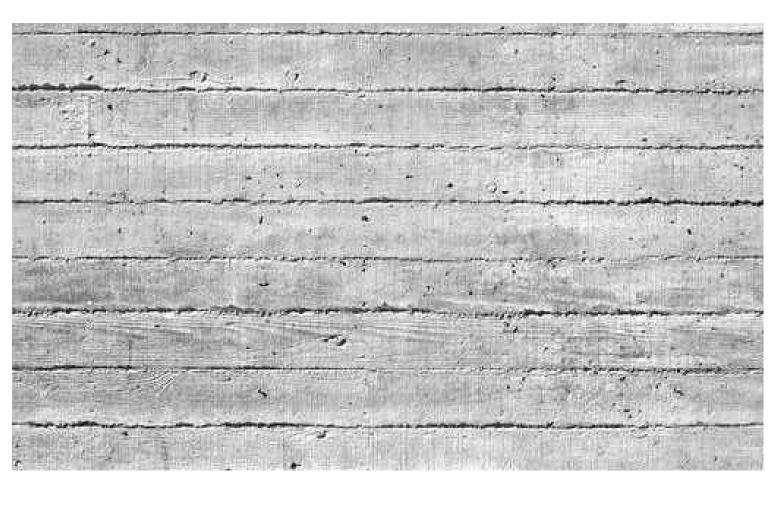

CONCRETE



STONE

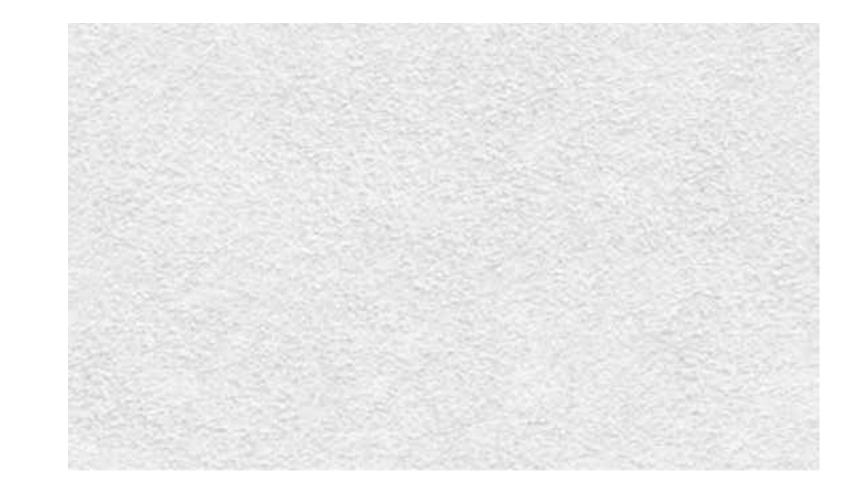

STUCCO



WOOD

SCALE: 1/4" = 1'-0"

APPLICABLE CODE NOTE:

NEW


Ralph Choeff registered architect AR0009679

comm no. 1658


date: 11-22-2016

revised:

sheet no.

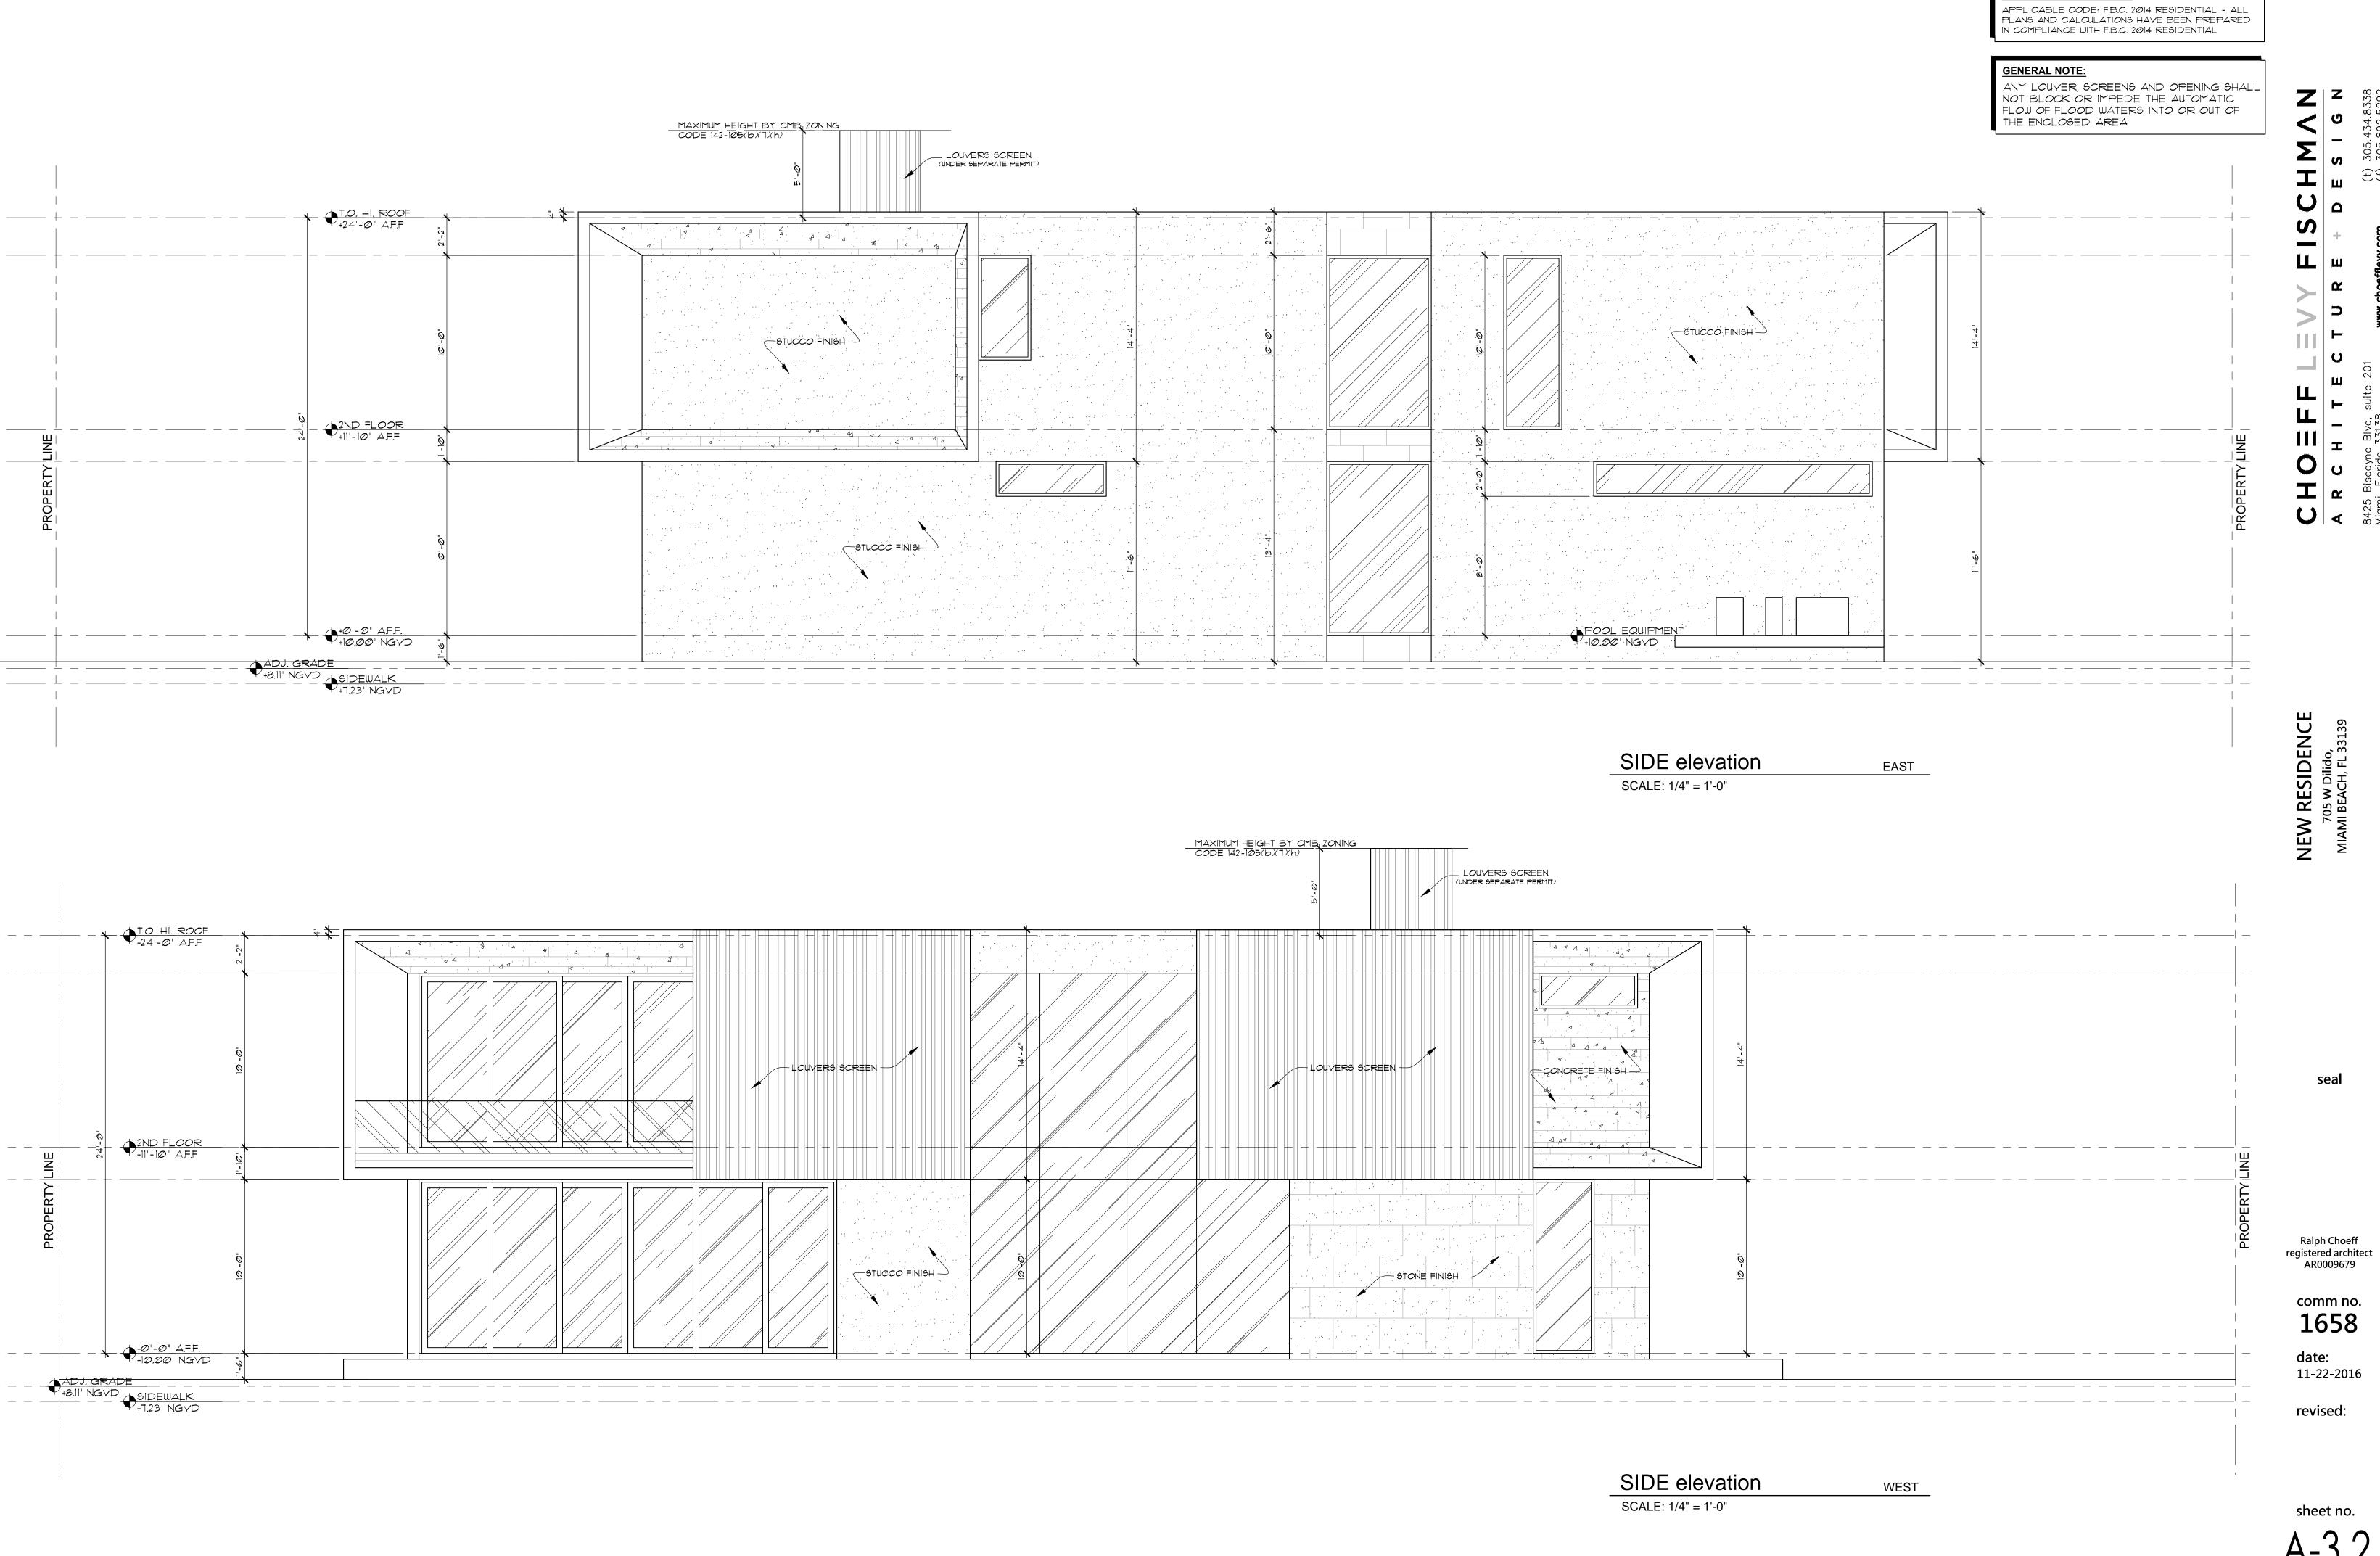

APPLICABLE CODE NOTE:

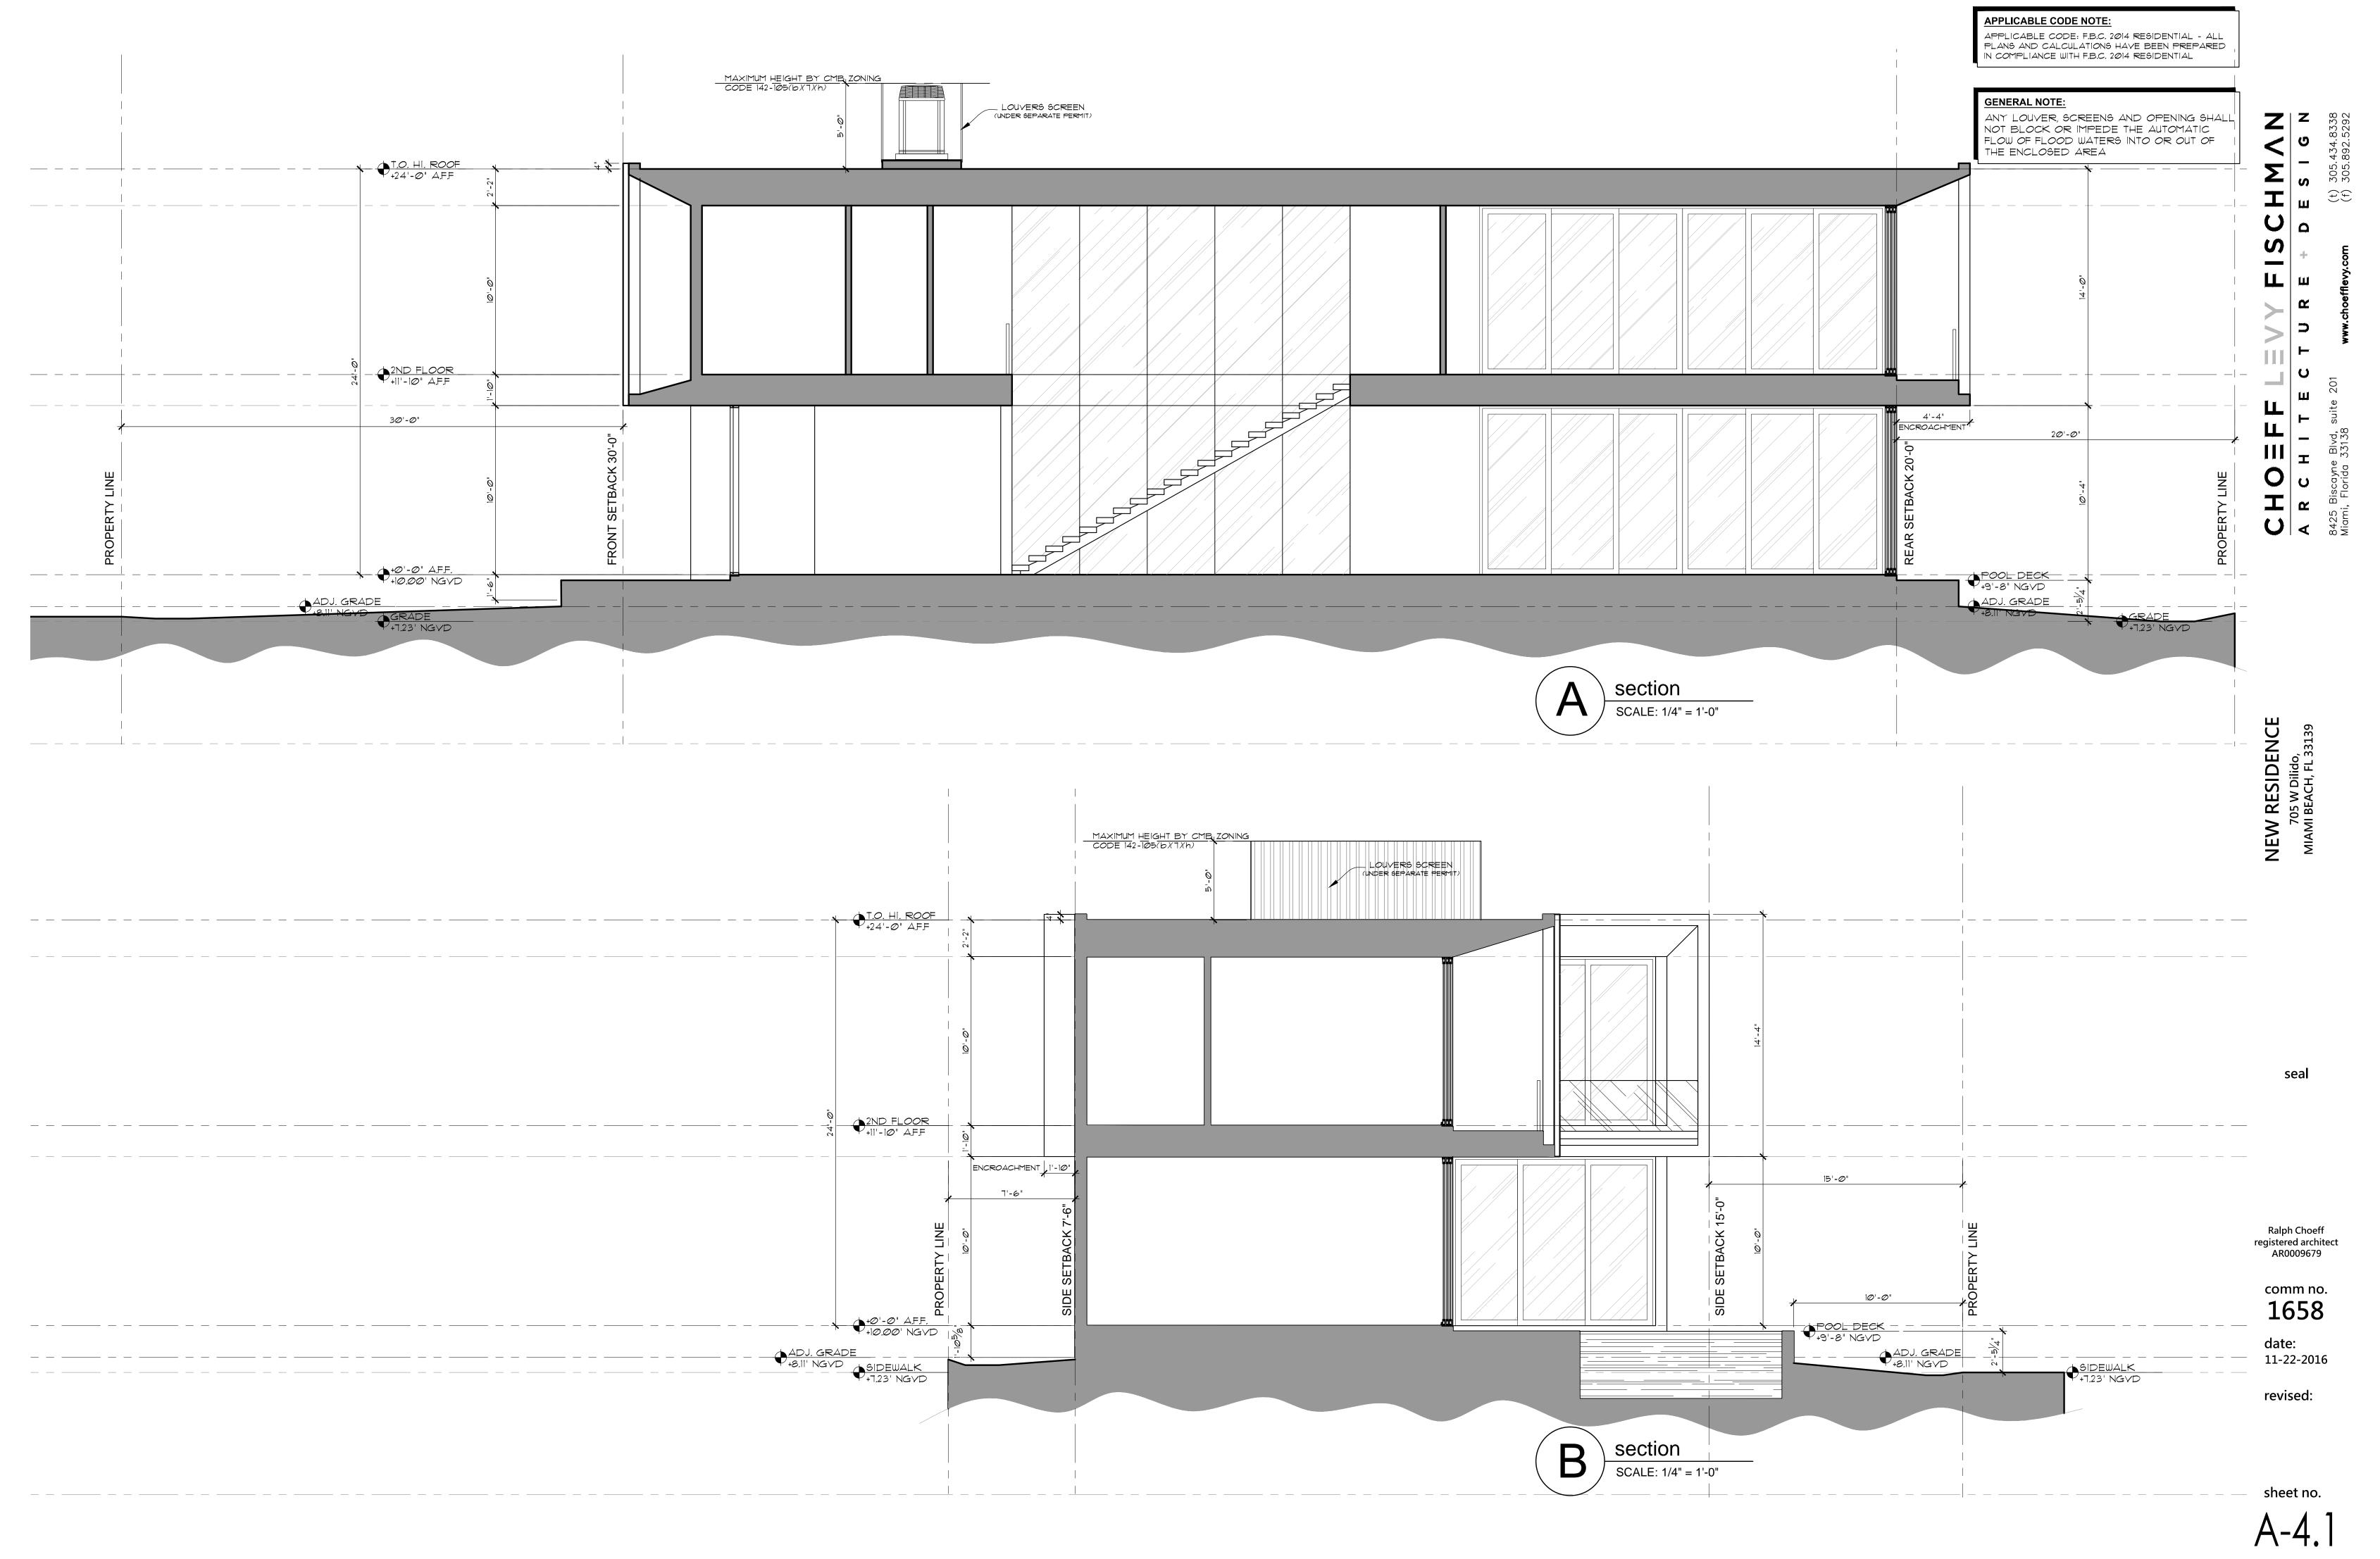

date: 11-22-2016

revised:

sheet no. A-4.2

NOTES: SEE SHEET A-0.3 FOR ADDITIONAL NOTES SEE SHEET A-0.0 FOR PROJECT DATA SEE SHEET A-5.0 FOR DOOR & WINDOW SCHEDULES SEE SHEET A-5.1 FOR ADDITIONAL DETAILS / RESIDENCE 705 W Dilido, II BEACH, FL 33139 4 - 4 " NEW ZE MIAMI ENCROACHMENT 20 -0 | 20'-0" EXISTING GRADE
+7.71' NGVD ADJ. GRADE +8.11 NG-VA SWALE GRADE +7.23' NGVD Ralph Choeff registered architect AR0009679 comm no. 1658 date: 11-22-2016 revised: REAR YARD section

SCALE: 1/2" = 1'-0"

APPLICABLE CODE NOTE:

APPLICABLE CODE: F.B.C. 2014 RESIDENTIAL - ALL PLANS AND CALCULATIONS HAVE BEEN PREPARED IN COMPLIANCE WITH F.B.C. 2014 RESIDENTIAL

APPLICABLE CODE: F.B.C. 2014 RESIDENTIAL - ALL PLANS AND CALCULATIONS HAVE BEEN PREPARED IN COMPLIANCE WITH F.B.C. 2014 RESIDENTIAL NOTES: SEE SHEET A-0.3 FOR ADDITIONAL NOTES
SEE SHEET A-0.0 FOR PROJECT DATA
SEE SHEET A-5.0 FOR DOOR & WINDOW SCHEDULES
SEE SHEET A-5.1 FOR ADDITIONAL DETAILS 4 NEW RESIDENCE 705 W Dilido, MIAMI BEACH, FL 33139 ENCROACHMENT 1'-10" 7 -6 " SIDE SETBACK 7'-6" PROPERTY LINE PROPOSED GRADE

+8.00' NGVD

+0'-0" A.F.F.

+10.00' NGVD ADJ. GRADE +8.11' NGVD +7.23' NGVD SWALE Ralph Choeff registered architect AR0009679 EXISTING GRADE +7.88' NGVD comm no. 1658 date: 11-22-2016 revised: SIDE YARD section

SCALE: 1/2" = 1'-0" sheet no.

APPLICABLE CODE NOTE:

APPLICABLE CODE: F.B.C. 2014 RESIDENTIAL - ALL PLANS AND CALCULATIONS HAVE BEEN PREPARED IN COMPLIANCE WITH F.B.C. 2014 RESIDENTIAL NOTES: SEE SHEET A-0.3 FOR ADDITIONAL NOTES SEE SHEET A-0.0 FOR PROJECT DATA SEE SHEET A-5.0 FOR DOOR & WINDOW SCHEDULES SEE SHEET A-5.1 FOR ADDITIONAL DETAILS / RESIDENCE 705 W Dilido, II BEACH, FL 33139 NEW MIAMI 15 - 0 " SIDE SETBACK 15'-0" PROPERTY LINE 10 -0 " PROPOSED GRADE +8.00' NGVD POOL DECK-+9'-8" NGVD SLOPE 9.09%-ADJ. GRADE +8.11' NGVD SWALE GRADE +7.23' NGVD Ralph Choeff registered architect AR0009679 EXISTING GRADE +7.04' NGVD comm no. 1658 date: 11-22-2016 revised: SIDE FACING STREET section

SCALE: 1/2" = 1'-0" sheet no.

APPLICABLE CODE NOTE:



DEFF LEVY FI

NEW RESIDENCE 705 W Dilido, MIAMI BEACH, FL 33139

ī

Ralph Choeff registered archited AR0009679

comm no. **1658**

date: 11-22-2016

revised:

sheet no.

A-5.1

PLOT DATE: 2016-12-07

date: 11-22-2016

revised:

sheet no.

A-6.1

PLOT DATE: 2016-12-07



revised:

sheet no.

A-6.3

PLOT DATE: 2016-12-07





MIAMI BEACH DESIGN REVIEW BOARD SUBMITTAL

NEW RESIDENCE | 705 WEST DILIDO DRIVE | MIAMI BEACH, FLORIDA

NOVEMBER 21, 2016 / DRB FIRST SUBMITTAL DECEMBER 08, 2016 / DRB FINAL SUBMITTAL

CLIENT / PROPERTY INFORMATION

Mr. Ramin

PROPERTY ADDRESS 705 WEST DILIDO DRIVE MIAMI BEACH, FL 33140

EXISTING VEGETATION SUMMARY

There are (2) large fruit trees in poor conditions being proposed for removal, (1) dead royal palm and (2) invasive tree species being proposed for removal as well. The large Ficus aurea trees and (2) royal palms are being preserve and protected. An arborist report will be provided at the time of permitting.

SCOPE OF WORK

- Preservation of existing Royal Palms and Ficus aurea tree
- New landscape design to complement new contemporary residence

INDEX OF SHEETS


L-0 Landscape Cover Page + Sheet Index L-1 Existing Tree Survey + Disposition Plan L-1A Existing Tree Images
L-2 Landscape Plan

L-3 Landscape Notes + Details


1658

11-22-2016 12-08-2016 revised:


sheet no.

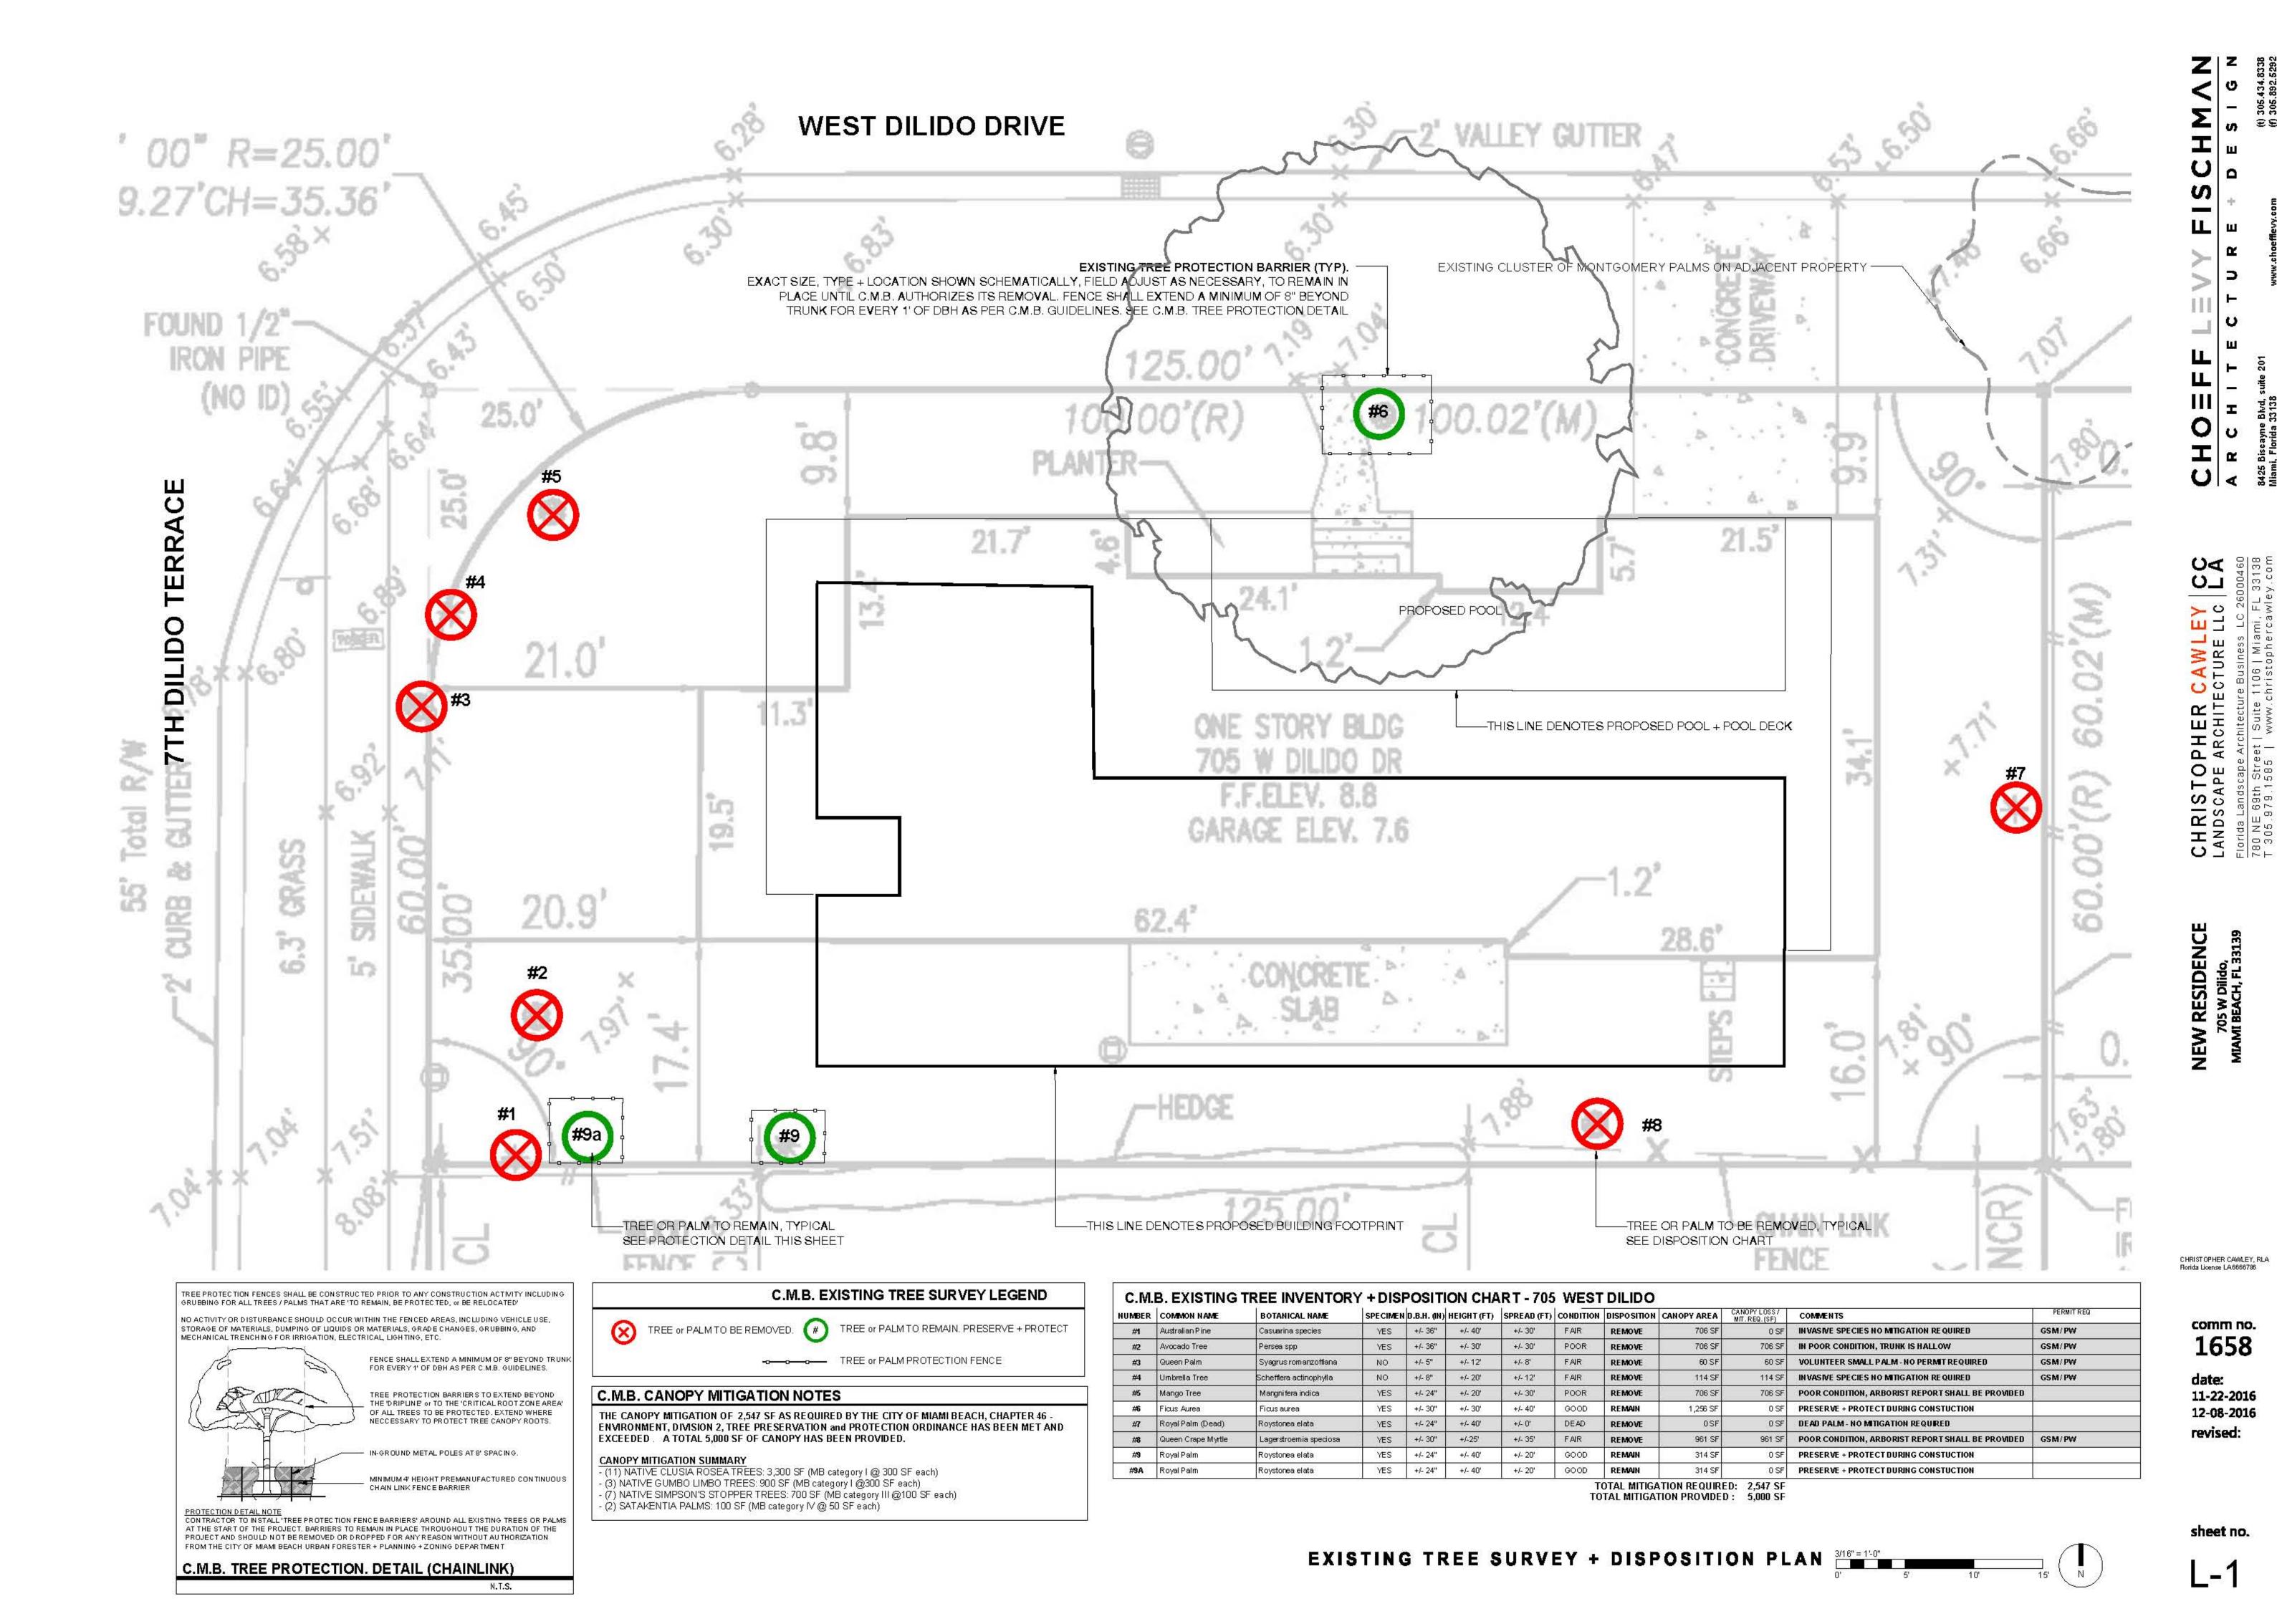


AN ARBORIST REPORT SHALL BE PROVIDED DURING PERMITTING

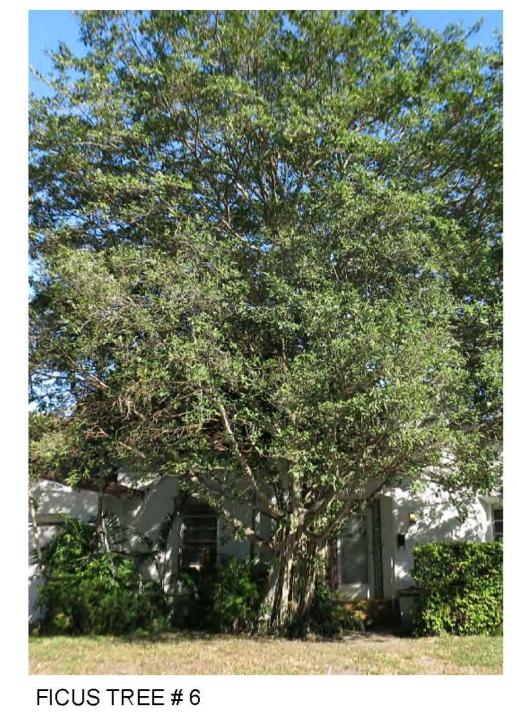



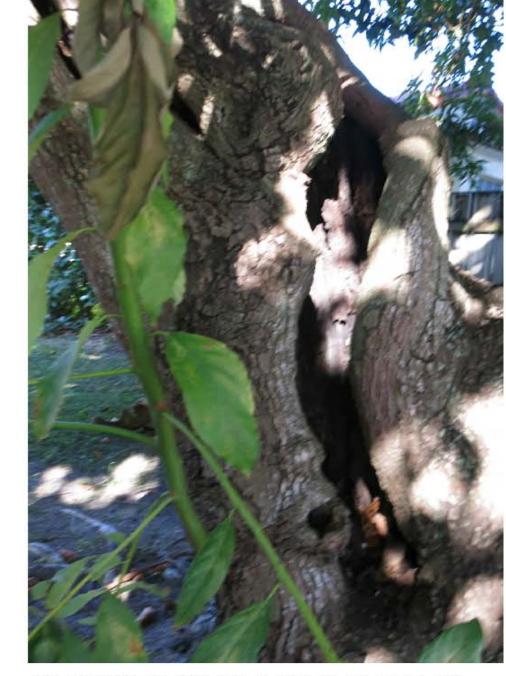

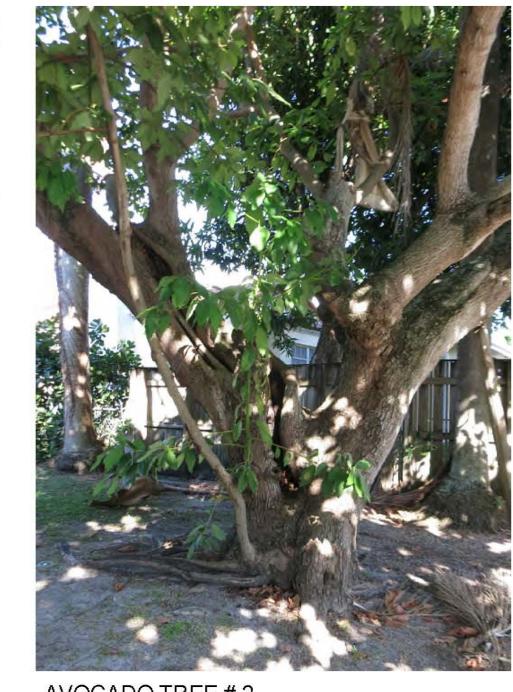



MANGO TREE #5










ROYAL PALMS #9 AND #9A

QUEEN CRAPE MYRTLE TREE # 8

QUEEN CRAPE MYRTLE TREE # 8

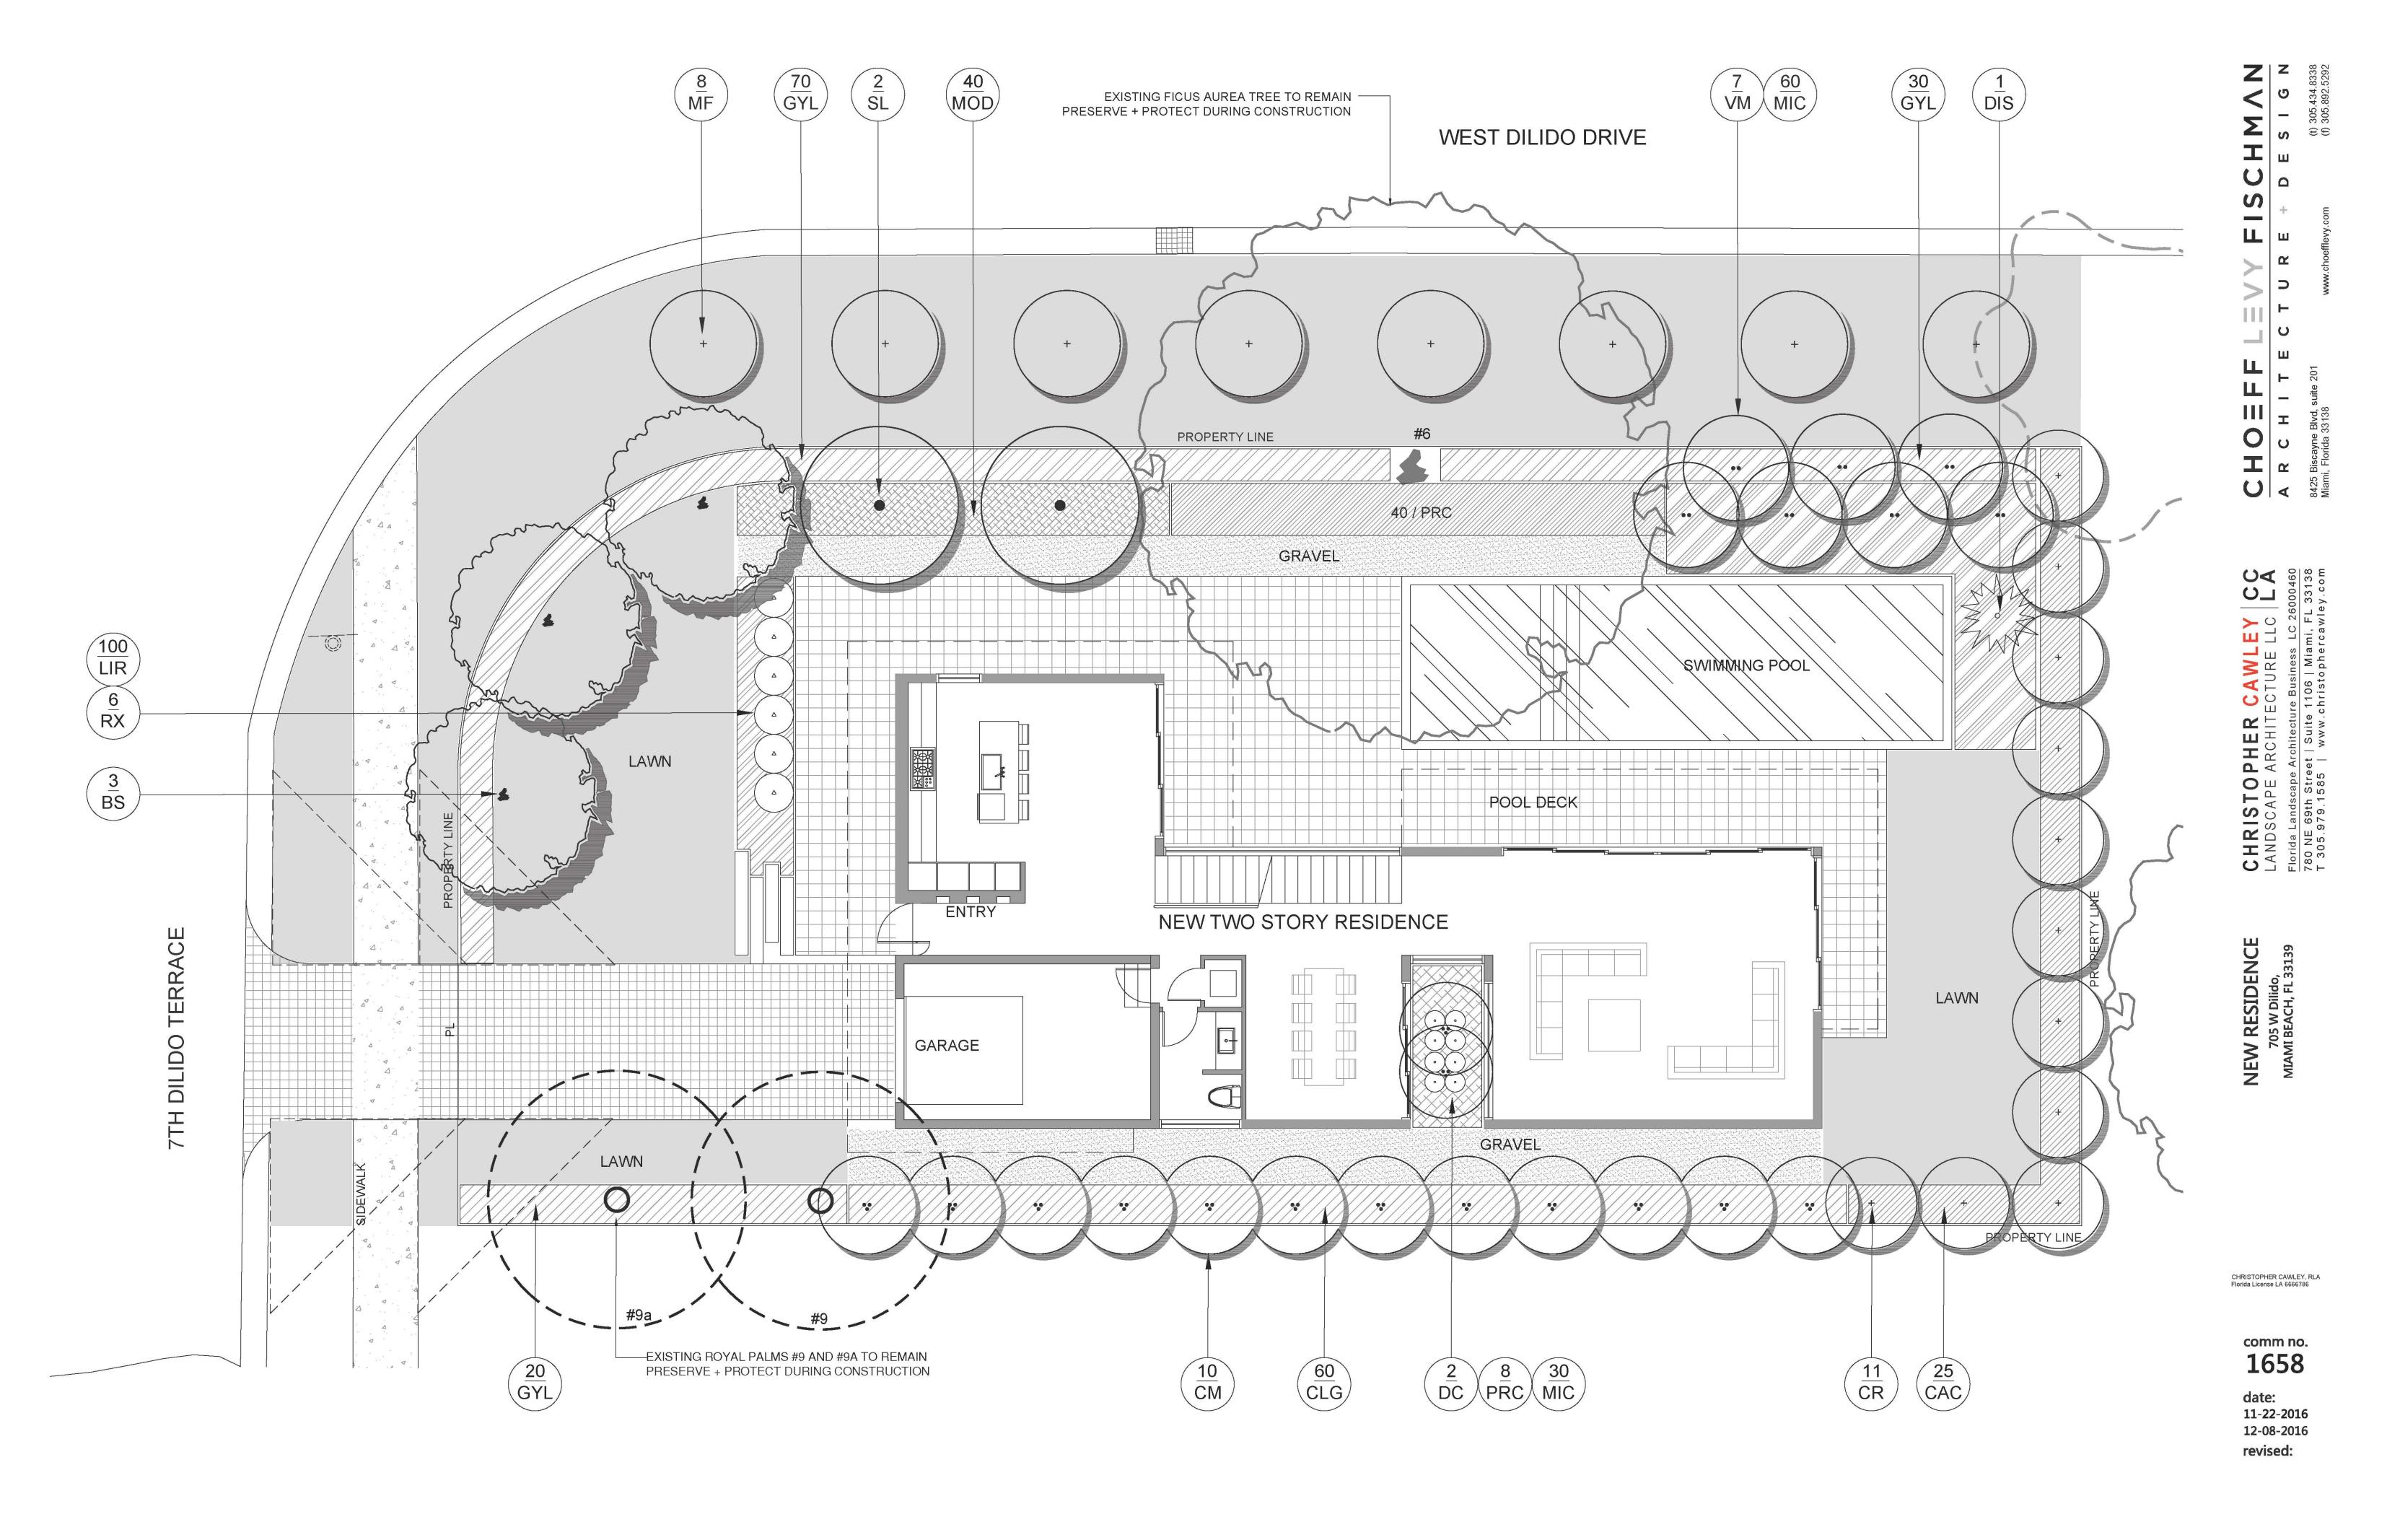

LANDSCAPE PLAN 3/16" = 1'-0"
0' 5' 10' 15' N

sheet no.

L-2

LANDSCAPE NOTES

- 1. ALL PLANT MATERIAL SHALL BE FLORIDA GRADE NO. 1 OR BETTER.
- 2. CONTRACTOR SHALL BECOME FAMILIAR WITH THE LOCATION OF, AVOID, AND PROTECT ALL UTILITY LINES, BURIED CABLES, AND OTHER UTILITIES.
- 3. TREE, PALM, ACCENT AND BED LINES ARE TO BE LOCATED IN THE FIELD AND APPROVED BY THE LANDSCAPE ARCHITECT PRIOR TO INSTALLATION.

ANY CHANGES TO R.O.W. (RIGHT OF WAY) MATERIAL IN REGARDS TO PLACEMENT OF SPECIES SHALL REQUIRE THE APPROVAL AND CONSULTATION OF THE CITY URBAN FORESTER AND OR CITY STAFF.

4. ALL PLANTING SOIL SHALL BE 50:50 TOPSOIL:SAND MIX, FREE OF CLAY, STONES, ROCKS, OR OTHER FOREIGN MATTER. THIS SPECIFICATION INCLUDES ALL BACKFILL FOR BERMS AND OTHER LANDSCAPE AREAS

CARE SHALL BE TAKEN TO AVOID PLACEMENT OF CONSTRUCTION FILL, GRAVEL, AND OR DEBRIS OVER THE ROOTBALLS OF INSTALLED OR EXISTING TREES AND OR PALMS ON SITE.

2" DEPTH PLANTING SOIL SPREAD IN PLACE- THROUGHOUT

6" DEPTH PLANTING SOIL SPREAD IN PLACE- THROUGHOUT

12" DEPTH PLANTING SOIL SPREAD IN PLACE- THROUGHOUT

TREES, PALMS, SPECIMEN PLANT MATERIAL LOCATIONS REMOVE ALL LIMEROCK PRESENT TO A DEPTH OF AT LEAST 30"BEFORE PLACING NEW **PLANTING SOIL.** APPLY NEW CLEAN PLANTING SOIL IN PLANTING AREA AS REQUIRED

- 5. THE SITE CONTRACTOR SHALL BE RESPONSIBLE TO BRING ALL GRADES TO WITHIN 2" OF FINAL GRADES. THIS SHALL INCLUDE A 2" APPLICATION OF 50:50 TOPSOIL:SAND MIX FOR ALL LANDSCAPE AND AREAS TO BE SODDED.
- 6. THE LANDSCAPE CONTRACTOR SHALL CALCULATE AND SUBMIT AN ITEMIZED PRICE FOR THE 2" APPLICATION OF 50:50 MIX FOR ALL SOD AREAS AS A REFERENCE IN THE CASE THAT THERE WOULD BE A DISCREPANCY BETWEEN SITE AND LANDSCAPE CONTRACTORS AND NOTIFY THE SITE CONTRACTOR OR PROJECT SUPERINTENDENT AS TO THIS DISCREPANCY. IT WILL THEN BE DETERMINED WHICH PARTY WILL PROVIDE THIS 2" TOPSOIL:SAND APPLICATION AND SUBSEQUENT PAYMENT.OTHER PLANTING SOIL MIXES TO BE ADDED, I.E. FOR TREES, PALMS, SPECIMEN PLANTS, SHRUBS AND GROUNDCOVERS SHALL BE THE RESPONSIBILITY OF THE LANDSCAPE CONTRACTOR AND BE INCLUSIVE WITH THE LANDSCAPE BID.
- 7. IRRIGATION SHALL PROVIDE FOR A 100% COVERAGE WITH 50% OVERLAP MINIMUM AND BE PROVIDED BY A FULLY AUTOMATIC IRRIGATION SYSTEM W/ RAIN MOISTURE SENSOR ATTACHED TO CONTROLLER. ALL FLORIDA BUILDING CODE APPENDIX "F" IRRIGATION REQUIREMENTS SHALL BE STRICTLY ADHERED TO FOR INSTALLATION AND PREVAILING WATER MANAGEMENT DISTRICT RESTRICTIONS AND REGULATIONS SHALL BE IN COMPLIANCE FOR POST-INSTALLATION WATERING SCHEDULES.CONTRACTOR SHALL COORDINATE WITH THE IRRIGATION CONTRACTOR AND LEAVE PROVISIONS FOR ALL SLEEVING AND PIPE ROUTING. ALL UNDERGROUND UTILITIES TO BE LOCATED BY DIALING 811 AS REQUIRED BY LAW.
- 8. SOD SHALL BE 'EMPIRE TURF' ZOYSIA GRASS IN ALL LAWN AREAS AS SHOWN ON THE PLANS. SOD SHALL BE STRONGLY ROOTED, FREE FROM WEED, FUNGUS, INSECTS AND

- DISEASE. CONTRACTOR SHALL SOD ALL AREAS AS INDICATED ON THE PLANS OR AS DIRECTED. PAYMENT SHALL BE DETERMINED BY THE TOTAL MEASURED SODDED AREAS X THE UNIT PRICE SUBMITTED AND FIELD VERIFIED. SOD SHALL CARRY A 5-MONTH
- 9. ALL TREES, PALMS, SHRUBS AND GROUNDCOVERS, AND SOD / LAWN SHALL CARRY A ONE-YEAR WARRANTY FROM THE DATE OF FINAL ACCEPTANCE.
- 10. ALL TREES AND PALMS SHALL BE STAKED PER ACCEPTED STANDARDS BY THE FLORIDA NURSERYMEN & GROWERS LANDSCAPE ASSOCIATION (FNGLA) AND ANSI A-300 (PART 6)-2012 TREE, SHRUB, AND OTHER WOODY PLANT MANAGEMENT STANDARD PRACTICES (PLANTING AND TRANSPLANTING). CONTRACTOR SHALL ENSURE THAT THE PLANS, DETAILS, SPECIFICATIONS AND NOTES HAVE BEEN ADHERED TO AND THAT THE LANDSCAPE AND IRRIGATION INSTALLATION IS COMPLIANT TO ALL ITEMS AS DIRECTED ON THE PLANS PRIOR TO SCHEDULING OF THE FINAL INSPECTION.

CONTRACTOR SHALL REMOVE ALL STAKES, POLES, WELLINGTON TAPE AND OR BRACING MATERIALS FROM ALL PALMS, TREES AND SHRUBS WITHIN 1 YEAR OF INSTALLATION.

- 11. THE PLANT LIST IS INTENDED ONLY AS AN AID TO BIDDING. ANY DISCREPANCIES FOUND BETWEEN THE QUANTITIES ON THE PLAN AND PLANT LIST, THE QUANTITIES ON THE PLAN SHALL BE HELD VALID.
- 12. IF NECESSARY, CONTRACTOR SHALL PROVIDE A WATER TRUCK DURING PLANTING TO ENSURE PROPER WATERING-IN DURING INSTALLATION AND CONTRACTOR WILL BE RESPONSIBLE FOR CONTINUAL WATERING UNTIL FINAL ACCEPTANCE BY THE OWNER.

A MINIMUM OF 6 MONTHS OF SUPPLEMENTAL HAND OR AUTOMATIC IRRIGATION SYSTEM WATERING SHALL BE REQUIRED TO AID IN NEW TREE OR PALM ESTABLISHMENT.

- 13. FERTILIZATION: ONE COMPLETE APPLICATION OF GRANULAR FERTILIZER SHALL BE APPLIED PRIOR TO FINAL ACCEPTANCE AND APPROVAL BY THE LANDSCAPE ARCHITECT. FERTILIZER SHALL BE OSMACOTE OR APPROVAL EQUAL
- 14. SHOULD ANY TREES OR PALMS BE DAMAGED THEY SHALL BE EVALUATED BY THE CITY URBAN FORESTER TO DETERMINE CORRECTIVE ACTIONS THAT MAY INCLUDE REMOVAL, CORRECTIVE PRUNING AND OR REPLACEMENT. ANY CORRECTIVE ACTION REQUIRED SHALL BE PERFORMED IN ACCORDANCE WITH A MIAMI DADE COUNTY CODE, ANSI-A 300 PRUNING STANDARDS AND OR AN ISSUED ERM TREE PERMIT OR ENVIRONMENTAL PERMIT. ANY CORRECTIVE PRUNIING REQUIRED SHALL BE PERFORMED BY AN ISA CERTIFIED ARBORIST OR ASCA CONSULTING ARBORIST AND THE CITY URBAN FORESTER SHALL BE CONSULTED.
- 15. ALL TREES + PALMS TO REMAIN OR BE RELOCATED ON SITE IN THE VICINITY OF CONSTRUCTION ACTIVITIES, SHALL BE PROTECTED THROUGH THE USE OF TREE PROTECTION BARRICADES INSTALLED AT THE TREE OR PALM DRIP LINE. A TREE PROTECTION FENCE SHALL BE CONSTRUCTED PRIOR TO ANY CONSTRUCTION ACTIVITY INCLUDING GRUBBING AND SHALL REMAIN IN PLACE UNTIL ON SITE CONSTRUCTION HAS BEEN COMPLETED.
- 16. CITY OF URBAN FORESTER AND OR PLANNING DEPARTMENT STAFF TO APPROVE ROW TREES BEFORE THEY ARE PLANTED.
- 20. MULCH SHALL NOT BE APPLIED WITHIN 6" OF ANY TREE OR PALM TRUNK THAT IS INSTALLED OR INCORPORATED INTO THE PROJECT. FOR ROW TREES + PALMS. ALL MULCH SHALL BE AMERIGROW 'PREMIUM PINEBARK BROWN' SHREDDED MULCH OR A CITY APPROVED ALTERNATIVE.


PLANT LIST - 705 WEST DILIDO DRIVE						
KEY	QTY.	NATIVE	COMMON NAME	BOTANICAL NAME	HEIGHT, SPECIFICATION, & NOTES	
TREES	No.			;		
BS	3	YES	GUMBO LIMBO TREE	Bursera simarubra	200 gallon, 20' o.a. height min, 16' spread, equal to Treeworld Wholesale	
CR	11	YES	PITCH APPLE TREE	Clusia rosea	45 gallon, 12' o.a. height min, 7' spread, equal to Treeworld Wholesale	
MF	7	YES	SIMPSON STOPPER TREE	Myrcianthes fragrens	100 gallon, standard form, specimen, equal to Treeworld Wholesale	
PALMS						
СМ	10	NO	FISHTAIL PALM	Carytoa mitis	12-14' height, partial shade grown w/ dark green trunks + fronds, full to base	
DC	2	NO	CABADA PALM	Dypsis cabadae	12-14' height, partial shade grown w/ dark green trunks + fronds, full to base	
RX	6	NO	LADY PALM	Rhapis excelsa	4' overall height, full to base, equal to Botanics Wholesale	
SL	2	NO	TEDDY BEAR PALM	Satakentia liukiuensis	8-10' grey wood, full heads, matched specimens	
VM	7	NO	MONTGOMERY PALMS	Vietchia montgomeriana		
SHRUBS						
CAC	25	NO	CAT PALMS	Chamaedorea cataractarum	5' overall height, full to base, space 4' o.c.	
CLG	60	NO	SMALL LEAF CLUSIA	Clusia guttifera	3' overall height, full to base, space 18" o.c.	
GYL	120	NO	CRABWOOD SHRUBS	Gymnanthes lucida	15 gallon, 6' ht, full, space 24" on center	
TROPICAI	S, GROL	INDCOVE	RS, + ACCENTS			
DIS	1	NO	MEXICAN CYCAD	Dioon spinulosum	7 gallon, 5' height x 5' spread	
LIR	100	NO	LIRIOPE	Liriope muscari	1 gallon, full 18" on center	
MIC	60	NO	WART FERN	Monstera deliciosa	3 gallon, full 18" on center	
MOD	40	NO	SWISS CHEESE PLANT	Monstera deliciosa	7 gallon, full 36" on center	
PRC	40	NO	PHILODENDRON 'ROJO CONGO'	Same	3 gallon, full 24" on center	
TRD	100	YES	FAKAHATCHEE GRASS	Tripsacum dactyloides	3 gallon, full 30" on center	


SOD, AGGREGATE & MULCH


- 3/8" DECOMPOSED GRANITE AGGREGATE OR STONE TO BE SELECTED, INSTALLED OVER FILTER FABRIC AND WEED BARRIER MATERIAL / OLIMAR, 2" MIN. DEPTH
- DARK BROWN 'FLORI MULCH' SHREDDED ORGANIC MULCH (NO CYPRESS), TO BE DETERMINED
- 'EMPIRE TURF' ZOYSIA GRASS OVER 2" TOPSOIL BED, SEE PLANTING SPECS

BE SELECTED DURING THE INSTALLATION OF THE PROJECT


CONTRACTOR TO PROVIDE IMAGES OF ALL MAJOR PLANT MATERIAL TO LANDSCAPE ARCHITECT AND OWNER FOR APPROVAL BEFORE PURCHASE + INSTALLATION. LANDSCAPE CONTRACTOR TO MEET WITH LANDSCAPE ARCHITECT AND OWNER ON SITE TO REVIEW THE PROPOSED DESIGN PRIOR TO SUBMITTING A BID FOR THE PROJECT. THE LANDSCAPE CONTRACTOR IS TO PROVIDE AN ADDITIONAL ALLOWANCE OF \$15,000 DOLLARS FOR POTTED PLANTS + MISCELLANEOUS VEGETATION TO

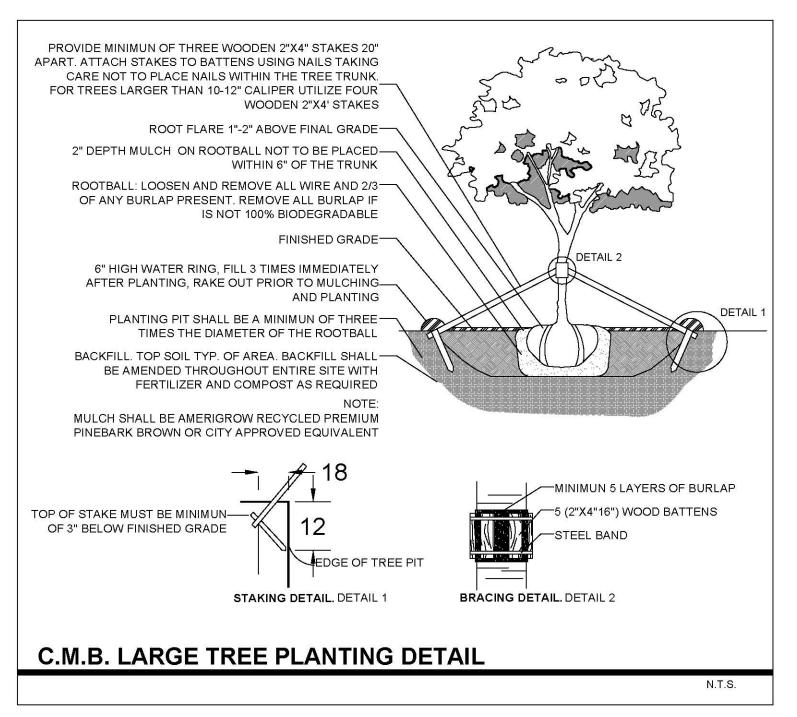

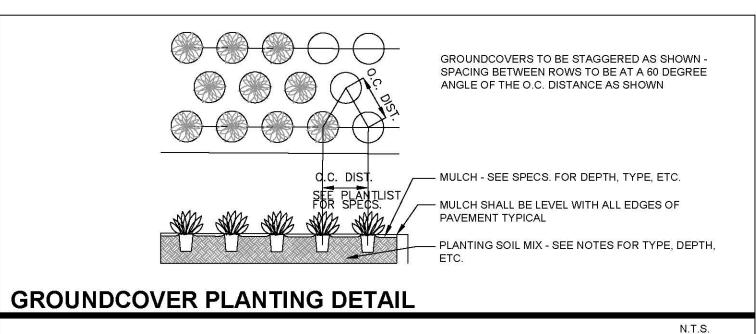

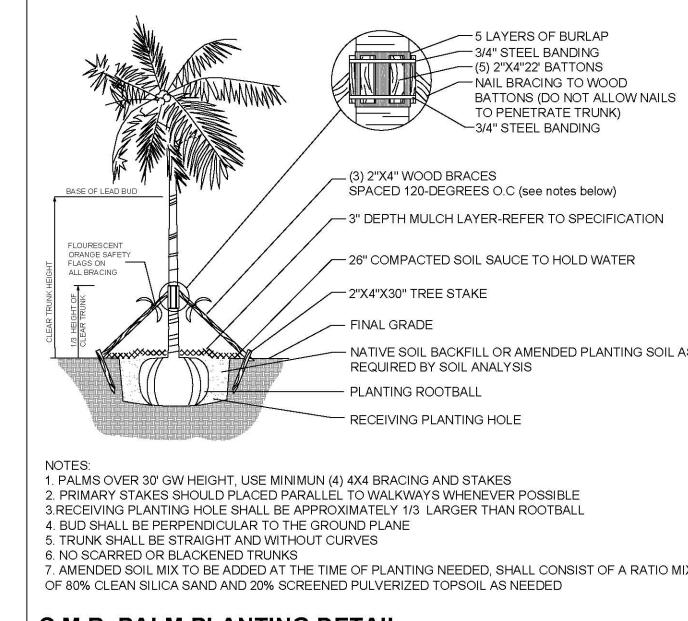

C.M.B. PALM PLANTING DETAIL

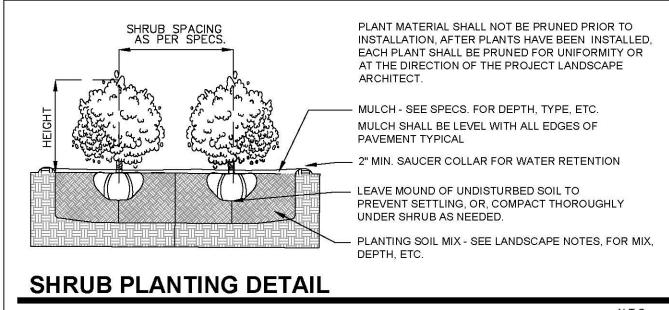

LANDSCAPE LEGEND MIAMI BEACH LANDSCAPE ORDINANCE CHAPTER 26 (RS1 - RS4 Single Family Home Residential)

ZONING: RS-3

LOT SIZE: 7,389 SF **ACRES:** 0.16

FRONT YARD - 2 TREES REQUIRED / 2 TREES PROVIDED REAR YARD -3 TREES REQUIRED / 3 TREES PROVIDED

TOTAL OF 5 TREES REQUIRED FOR LOTS UP TO 6,000 SF. 1 ADDITIONAL TREE IS REQUIRED FOR EACH ADDITIONAL 1,000 SF OF LOT AREA.

7389 SF - 6000 SF = 1,389 SF = 1 ADDITIONAL TREES + 5 REQUIRED TREES = 6 TOTAL TREES REQUIRED / 14 TREES PROVIDED. (3 NATIVE GUMBO LIMBO TREES + 1 EXISTING FICUS + 11 NATIVE CLUSIA ROSEA TREE PROVIDED)

6-10 REQUIRED TREES = 3 TREE SPECIES / 3 SPECIES PROVIDED

NATIVE TREES

30% OF REQUIRED TREES OR .30 X 6 = 1.8 NATIVE TREES REQUIRED / 13 NATIVE TREES PROVIDED (3 NATIVE GUMBO LIMBO TREES + 11 CLUSIA ROSEA TREES PROVIDED)

LOW MAINTENANCE TREES

50% OF REQUIRED TREES OR .50 X 6 = 3 NATIVE TREES REQUIRED / 7 NATIVE TREES PROVIDED (3 NATIVE GUMBO LIMBO TREES + 11 CLUSIA ROSEA TREES PROVIDED))

IRRIGATION WATER

STREET TREE REQUIREMT AVERAGE STREET TREE SPACING 20' ON CENTER

WEST DILIDO: 125 LF / 20 = 6.25 = 7 STREET TREES REQUIRED / 8 STREET TREES PROVIDED 7TH DILIDO TERRACE: 70 SF / 20 = 3.5 = 4 STREET TREES REQUIRED / 0 PROVIDED DUE TO CONFLICT WITH SITE TRIANGLES

12 SHRUBS (OR VINES) REQUIRED FOR EACH REQUIRED LOT AND STREET TREE or 12 X (17) = 204 REQUIRED / 205 SHRUBS PROVIDED,

NATIVE SHRUBS 50% OF TOTAL SHRUBS REQUIRED MUST BE NATIVE or .50 X 204 = 102 / 102 NATIVE SHRUBS PROVIDED 120 CRABWOOD SHRUBS PROVIDED

LARGE SHRUBS / SMALL TREES

10% OF TOTAL SHRUBS REQUIRED MUST BE LARGE SHRUBS OR SMALL TREES or .10 X 204 = 20 = 20 LARGE SHRUBS / SMALL TREES PROVIDED (20 CRABWOOD SHRUBS PROVIDED)

NATIVE LARGE SHRUBS / SMALL TREES

50% OF TOTAL LARGE SHRUBS REQUIRED MUST BE NATIVE or .50 X 20 = 10 NATIVE SHRUBS PROVIDED 20 CRABWOOD SHRUBS PROVIDED

LANDSCAPE LEGEND, LANDSCAPE NOTES + DETAILS

50% MAXIMUM OF LANDSCAPE AREA: NEW LAWN AREAS ARE LESS THAN 50% OF LANDSCAPE AREA

LAWN AREA

100% COVERAGE PROVIDED PURSUANT TO MIAMI DADE CODE

C.M.B. CHAPTER 46, DIVISION 2 - TREE INVENTORY + DISPOSITION PLAN NOTES

- THIS 'EXISTING TREE INVENTORY + DISPOSITION PLAN' HAS BEEN PREPARED IN ACCORDANCE WITH THE CITY OF MIAMI BEACH, CHAPTER 46 ENVIRONMENT, DIVISION 2, TREE PRESERVATION and PROTECTION ORDINANCE.
- 2. EXISTING TREE, PALM, AND VEGETATION INFORMATION AS INDICATED HAS BEEN PREPARED AS AN OVERLAY ON THE SURVEY PREPARED BY ER BROWNELL + ASS. DATED 11.01.16
- 3. THE INFORMATION AS PRESENTED HEREIN HAS BEEN FIELD VERIFIED BY THE LANDSCAPE ARCHITECT ON 11.18.16
- 4. MIAMI BEACH P+Z MUST APPROVE LANDSCAPE PLANS PRIOR TO REMOVING ANY TREES OR PALMS WITH A DBH BETWEEN 6" AND 12" INCHES. A WRITTEN TREE REMOVAL PERMIT IS REQUIRED FROM CITY OF MIAMI BEACH GREENSPACE MANAGEMENT / P.W FOR THE REMOVAL OF TREES / PALMS WITH A DBH GREATER THAN 12" INCHES OR IN THE R.O.W.
- 5. THE OWNER RESERVES THE RIGHT TO REMOVE ANY VEGETATION NOT LOCATED WITHIN THE CITY R.O.W. w/a D.B.H. OF LESS THAN 6" WITHOUT OBTAINING A TREE REMOVAL PERMIT.
- 6. THERE ARE NO TREES OF PALMS LOCATED ON THIS PROPERTY THAT WILL REQUIRE TEMPORARY IRRIGATION. ALL EXISTING TREES + PALMS ARE MATURE AND ARE CURRENTLY THRIVING WITHOUT SUPPLEMENTAL

- NATIVE SOIL BACKFILL OR AMENDED PLANTING SOIL AS 7. AMENDED SOIL MIX TO BE ADDED AT THE TIME OF PLANTING NEEDED, SHALL CONSIST OF A RATIO MIX

ОШ

RESIDENCE

CHRISTOPHER CAWLEY, RLA

comm no. 1658

> 11-22-2016 12-08-2016

revised: