


	ISSUE	DATE: 01/0	E: 01/03/2022 DRB FINAL SUBMITTA	
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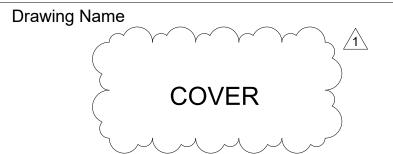
Project Team

Project Name

CASA BAHIA

253 N COCONUT LN MIAMI BEACH, FLORIDA, 33139 FOLIO # 02-4205-002-0160

Project Number 21-3600

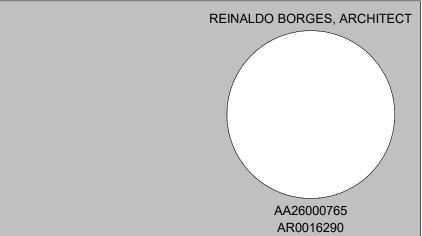

Scale:

1 1/2" = 1'-0"

A-000




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1	12/20/2021	Revision 1

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Project Number 21-3600 Drawing Name

FRONT VIEW

Scale:

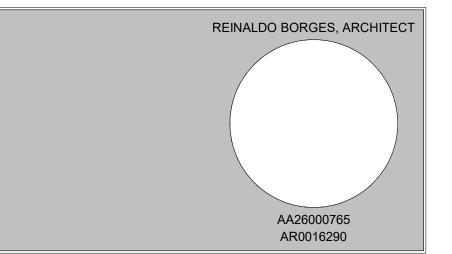A-000a



No.	Date	Description
1	12/20/2021	_


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Drawing Name



Scale:

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Drawing Number

A-000b

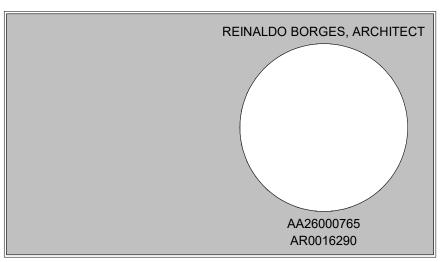

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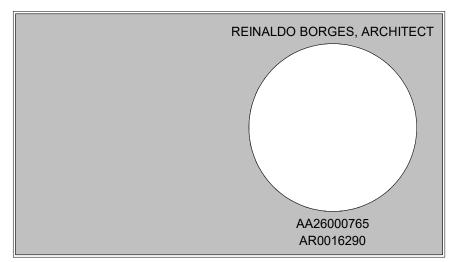
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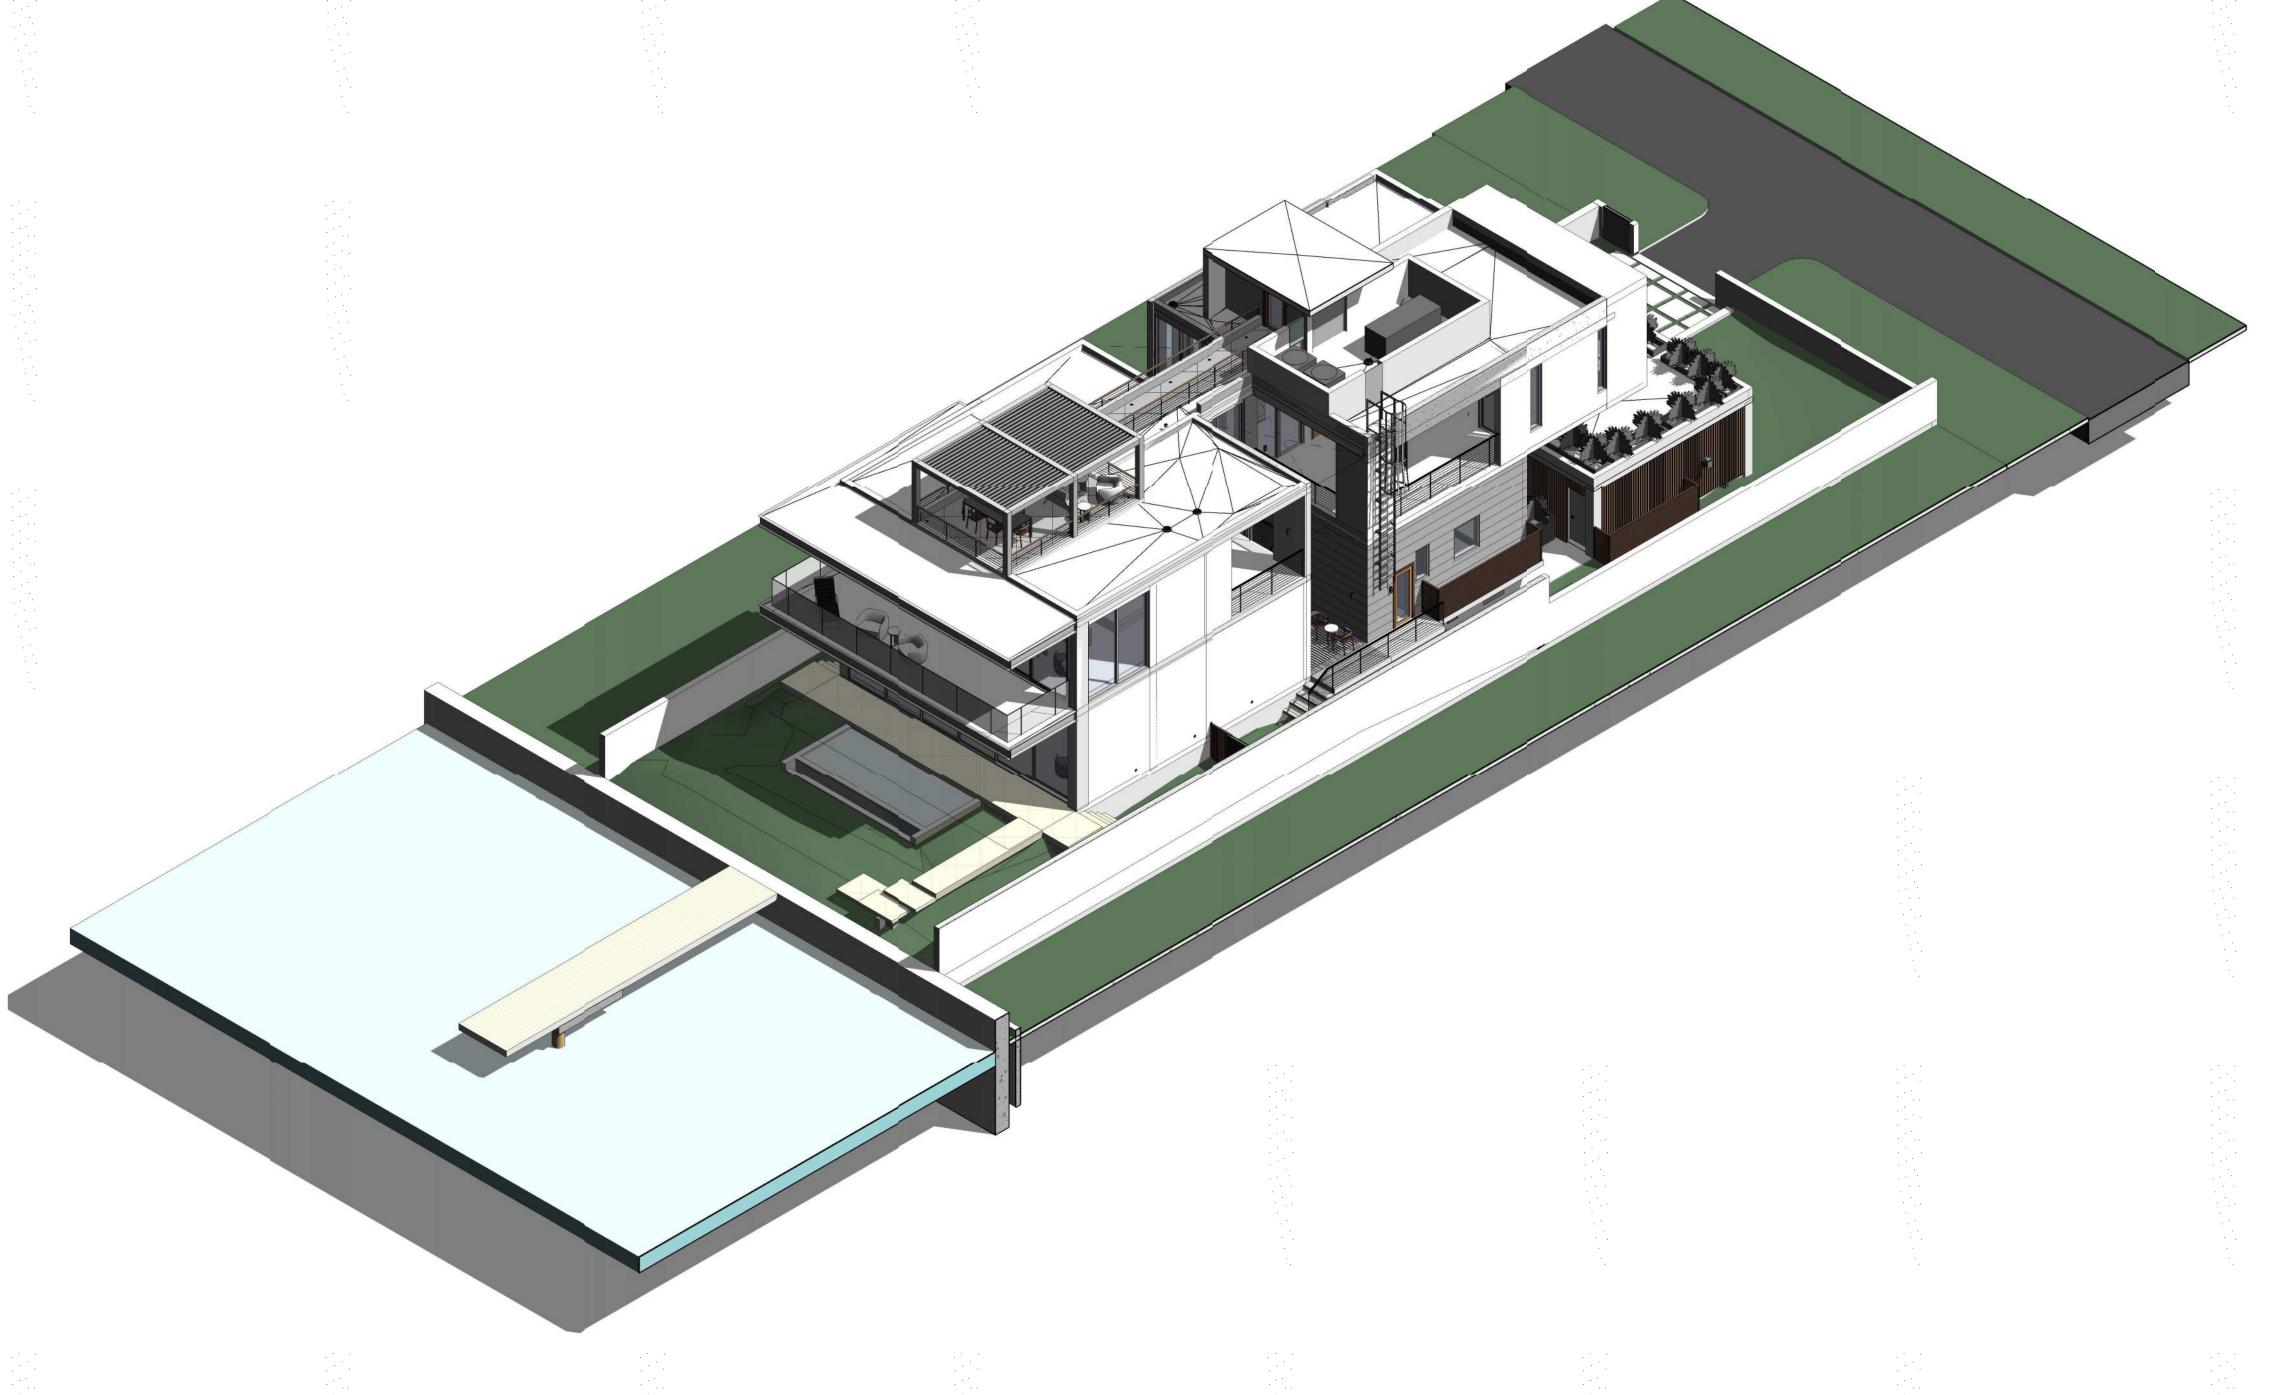
BOAT VIEW

Scale:

1 1/2" = 1'-0"

Drawing Number

A-000d



1 NW CORNER

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No. Date Description


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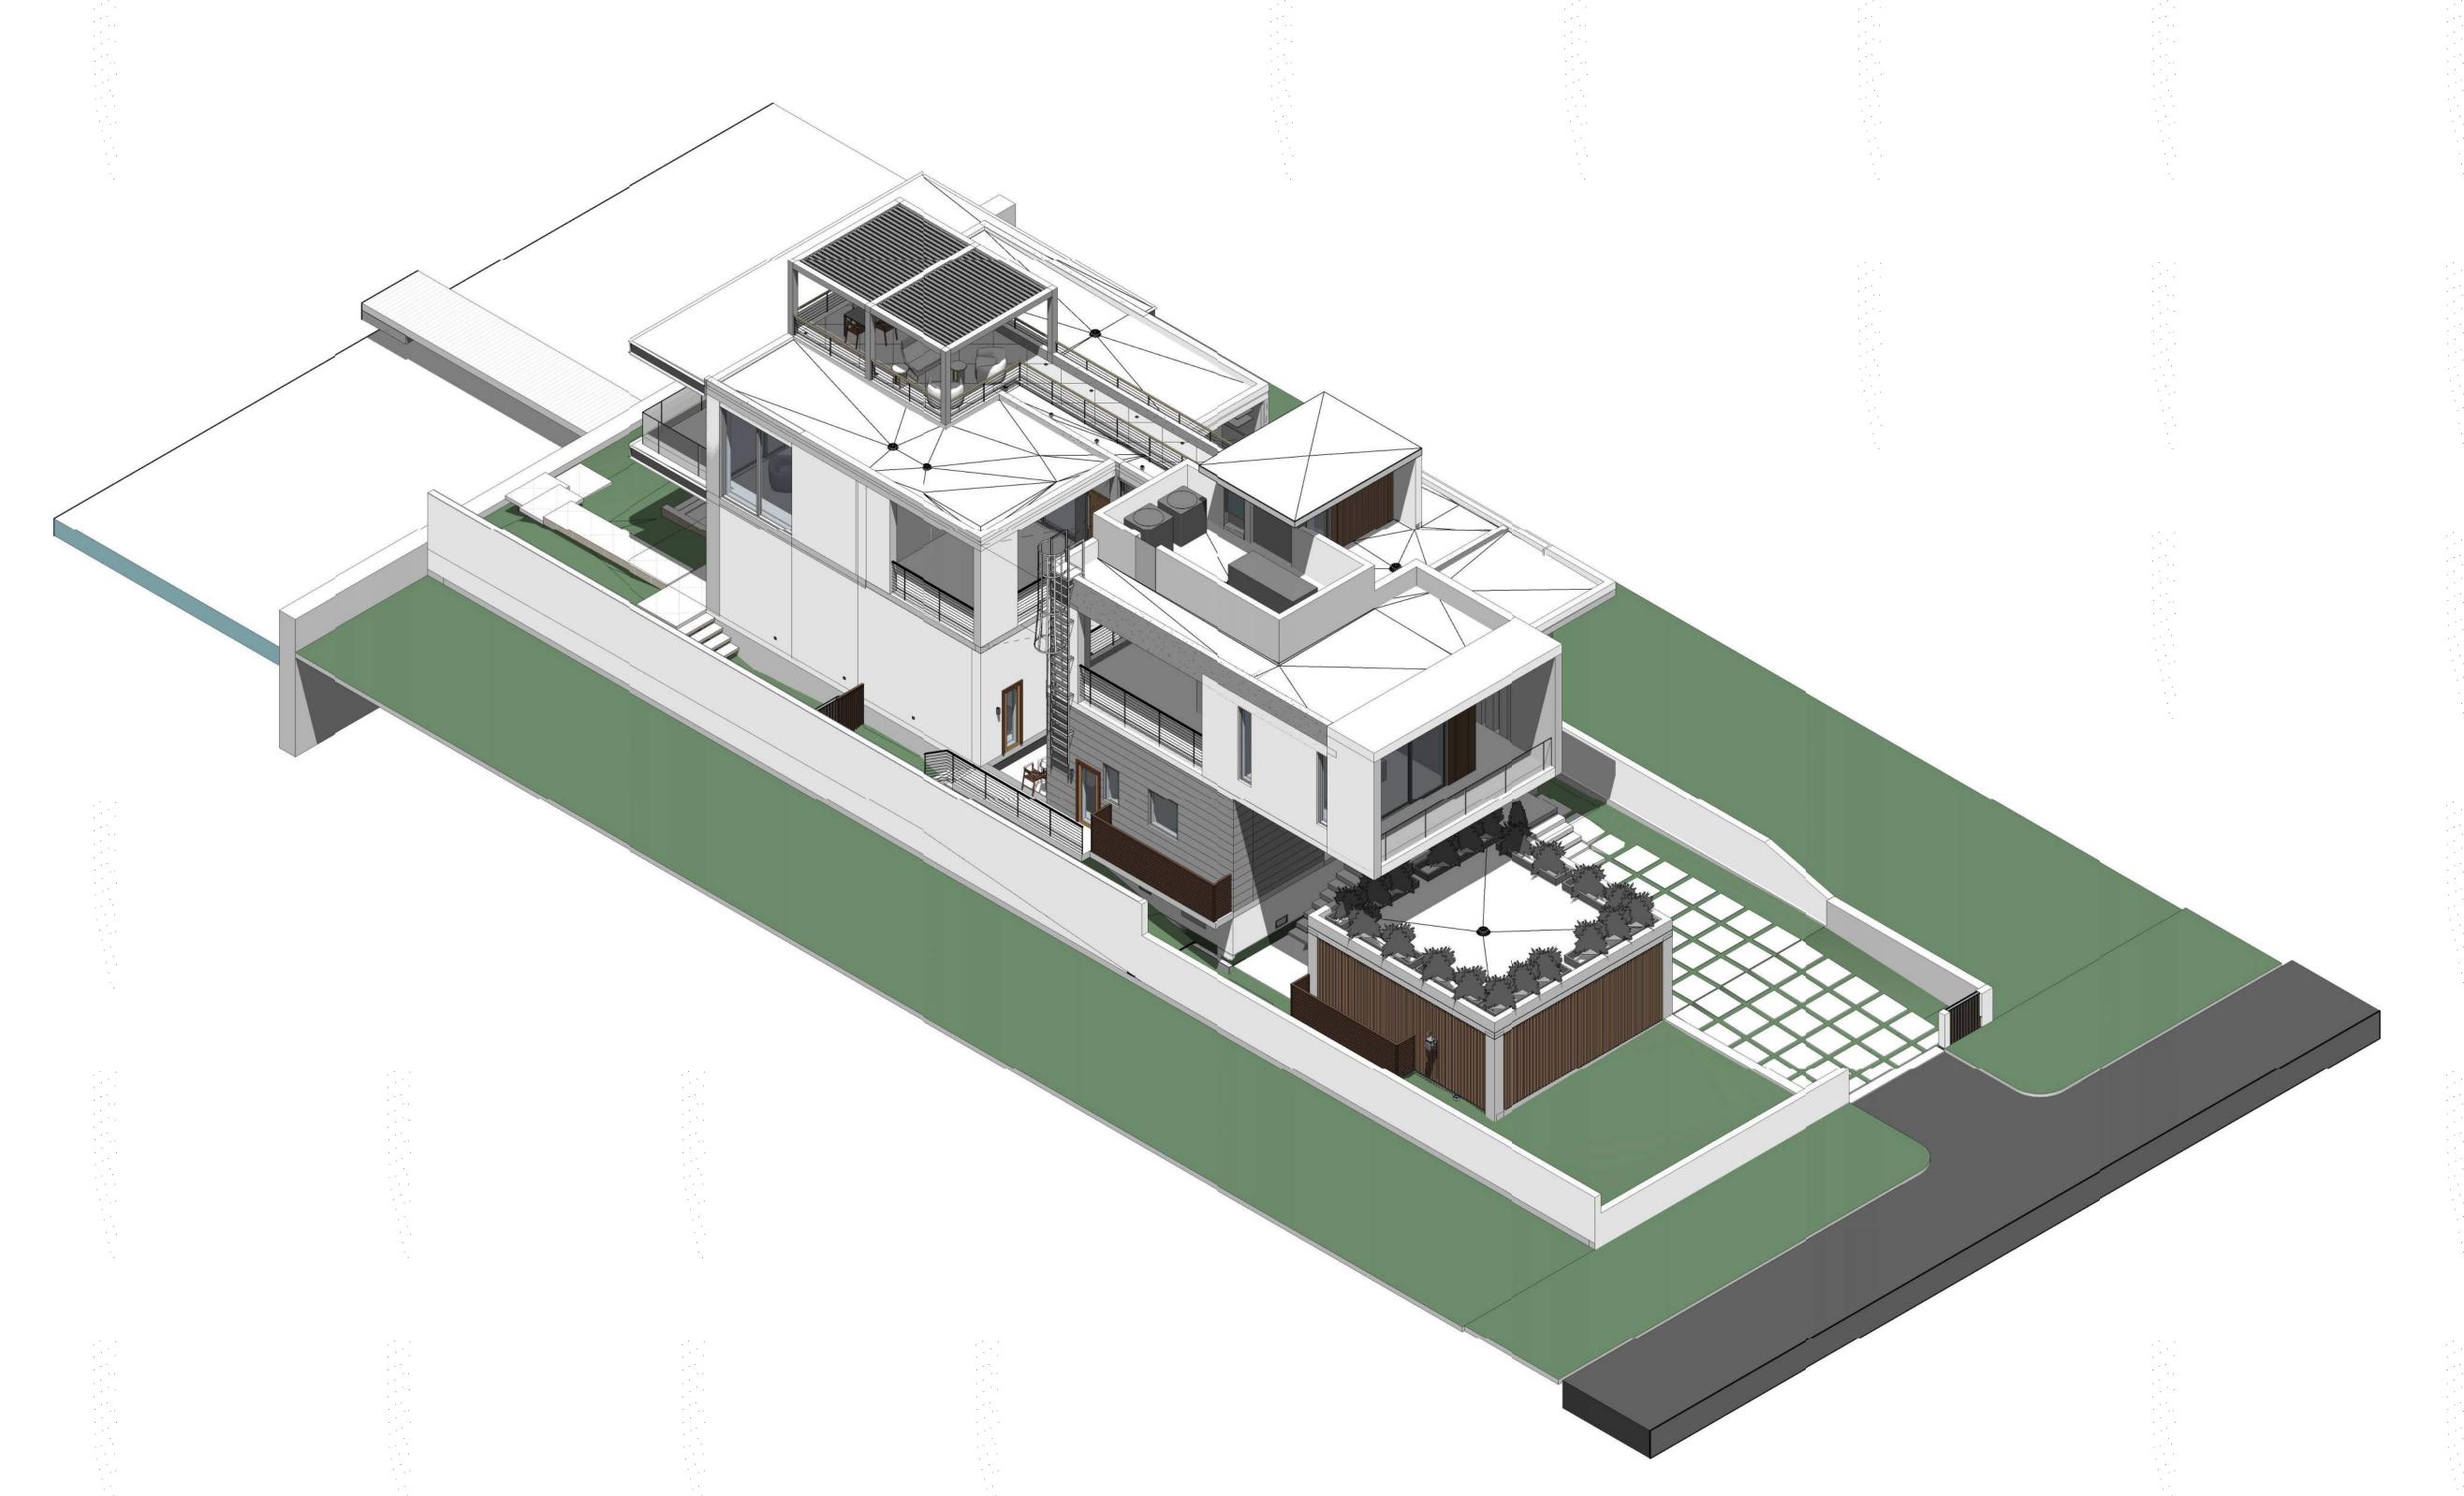
Drawing Name

NW ISOMETRIC VIEW

Scale

Drawing Number

A-000g

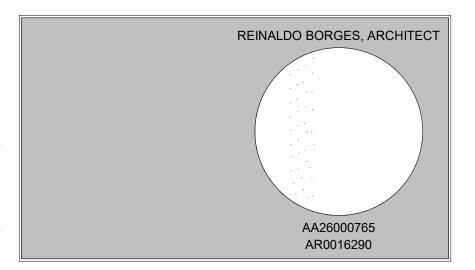

No. Date Description


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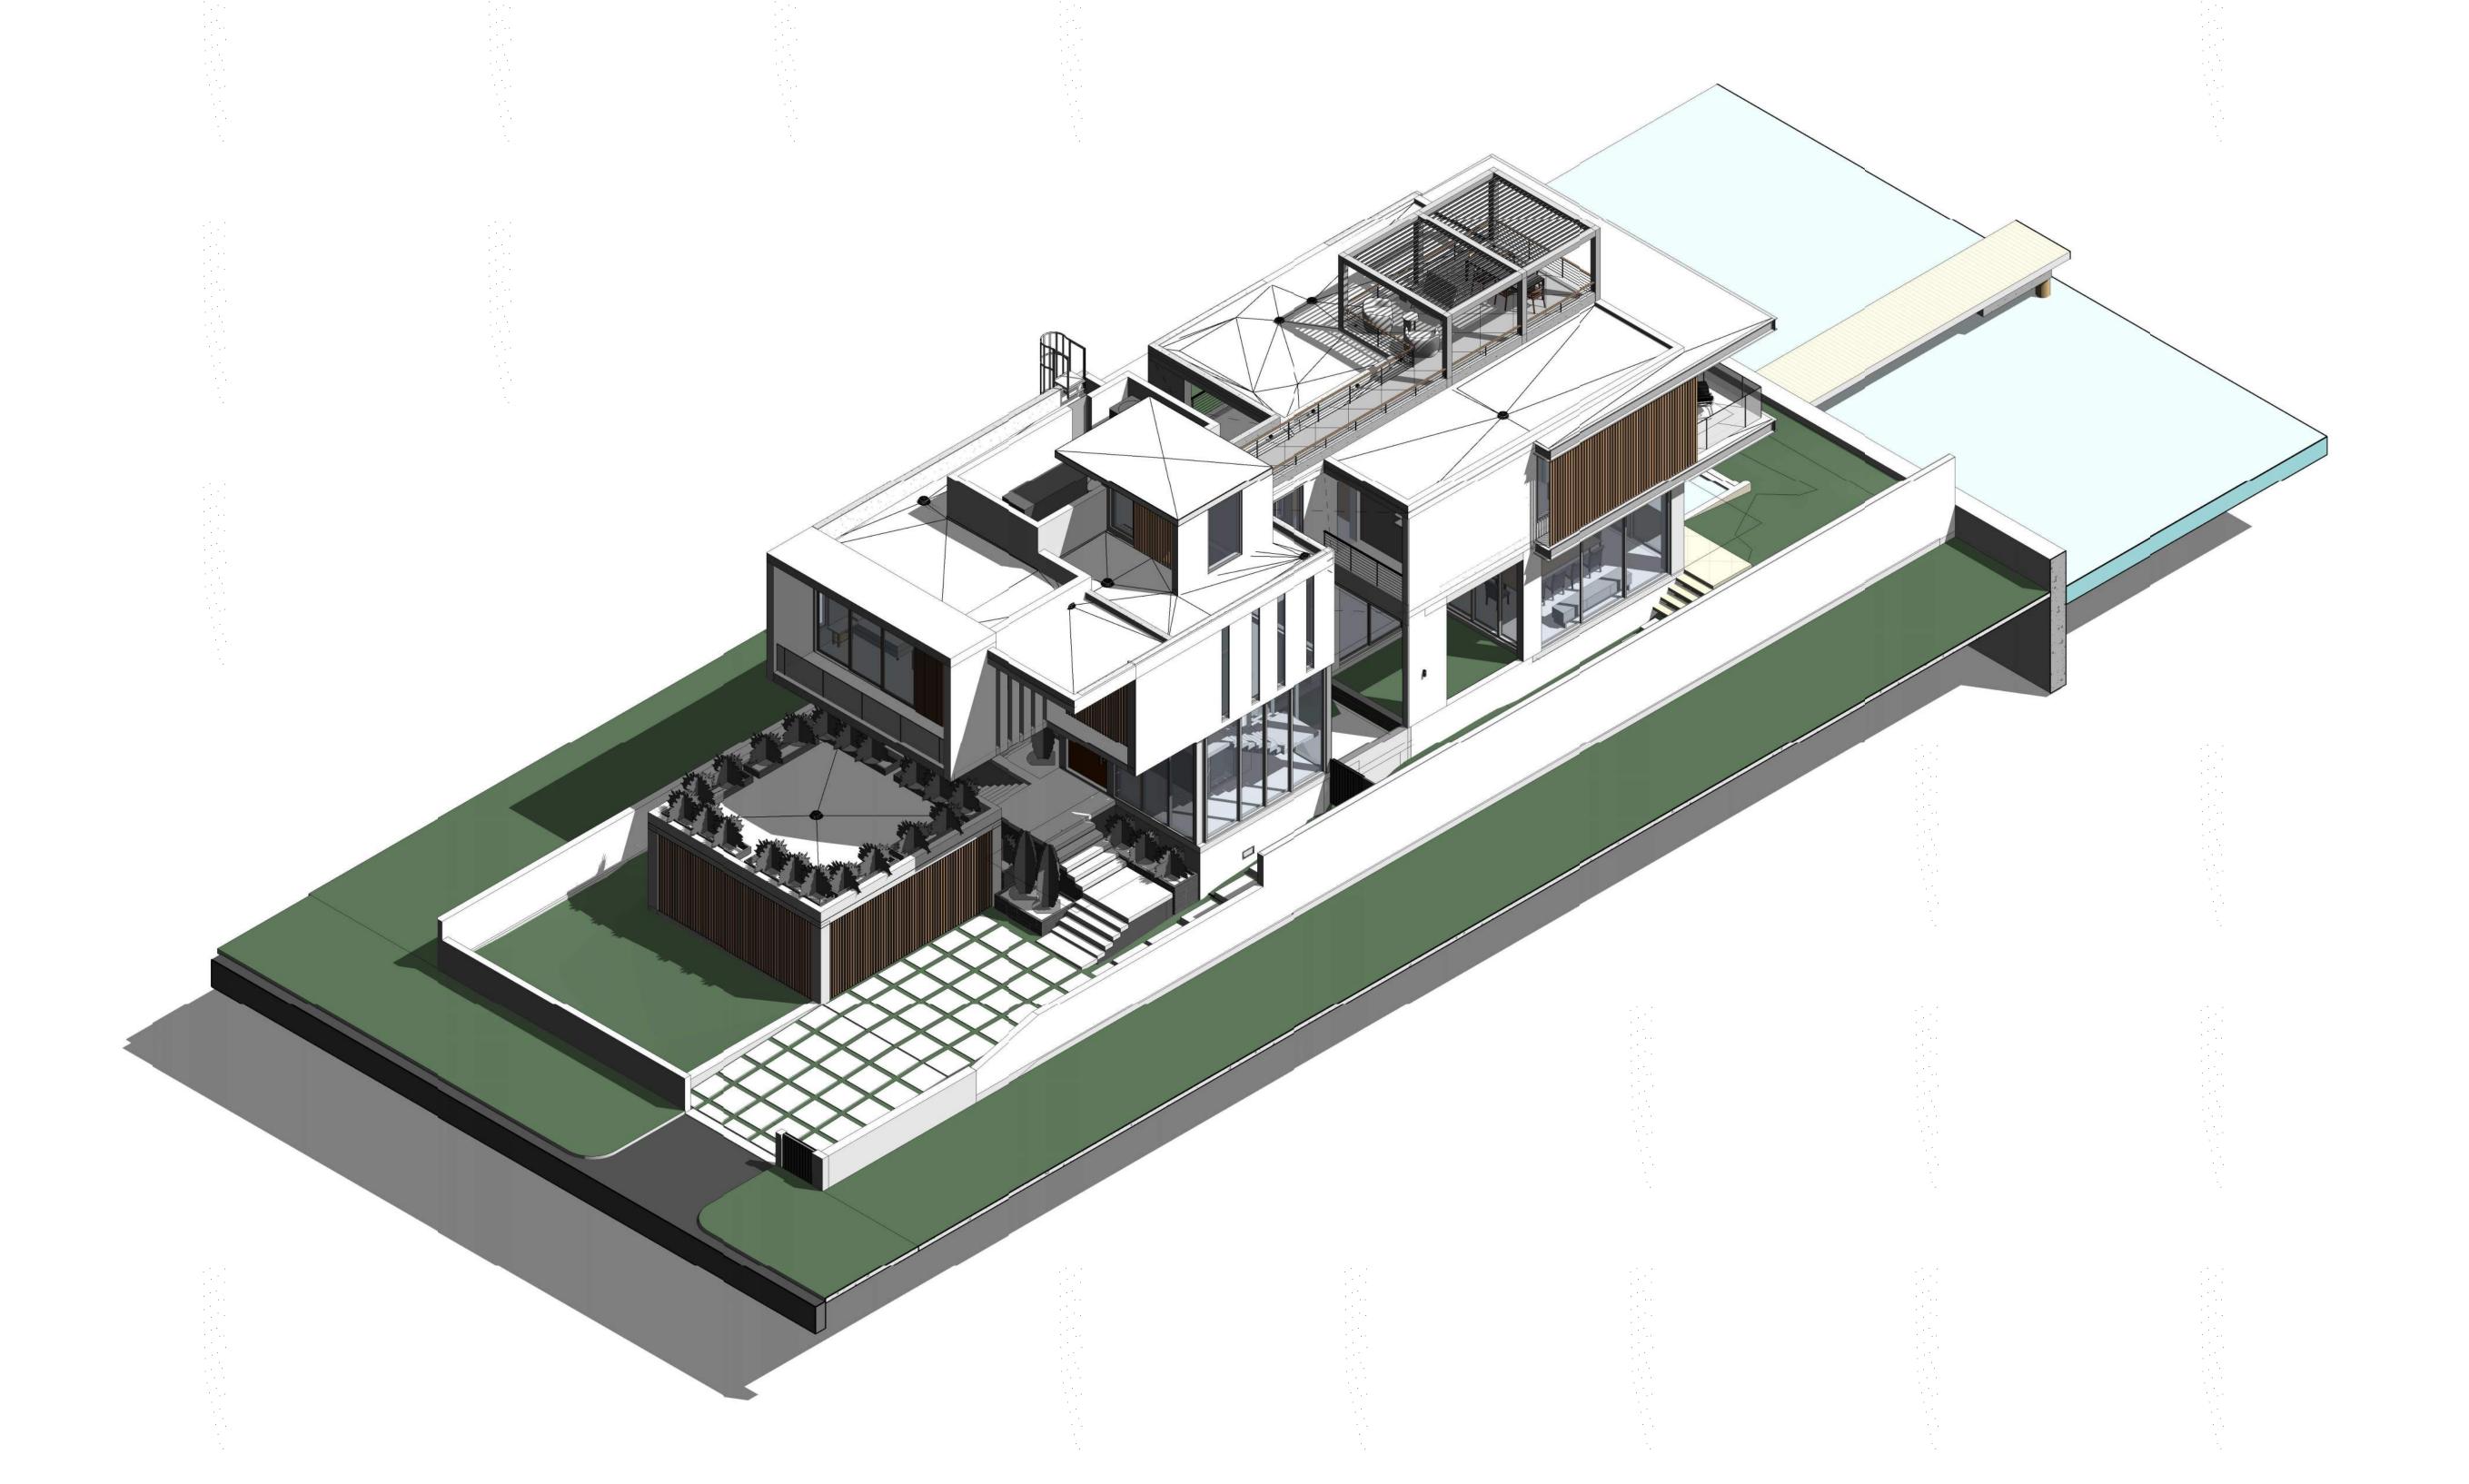
Drawing Name

SW ISOMETRIC VIEW

Scale:

Drawing Number

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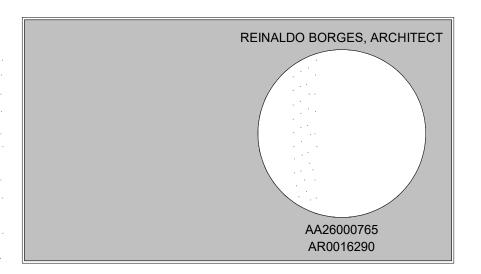
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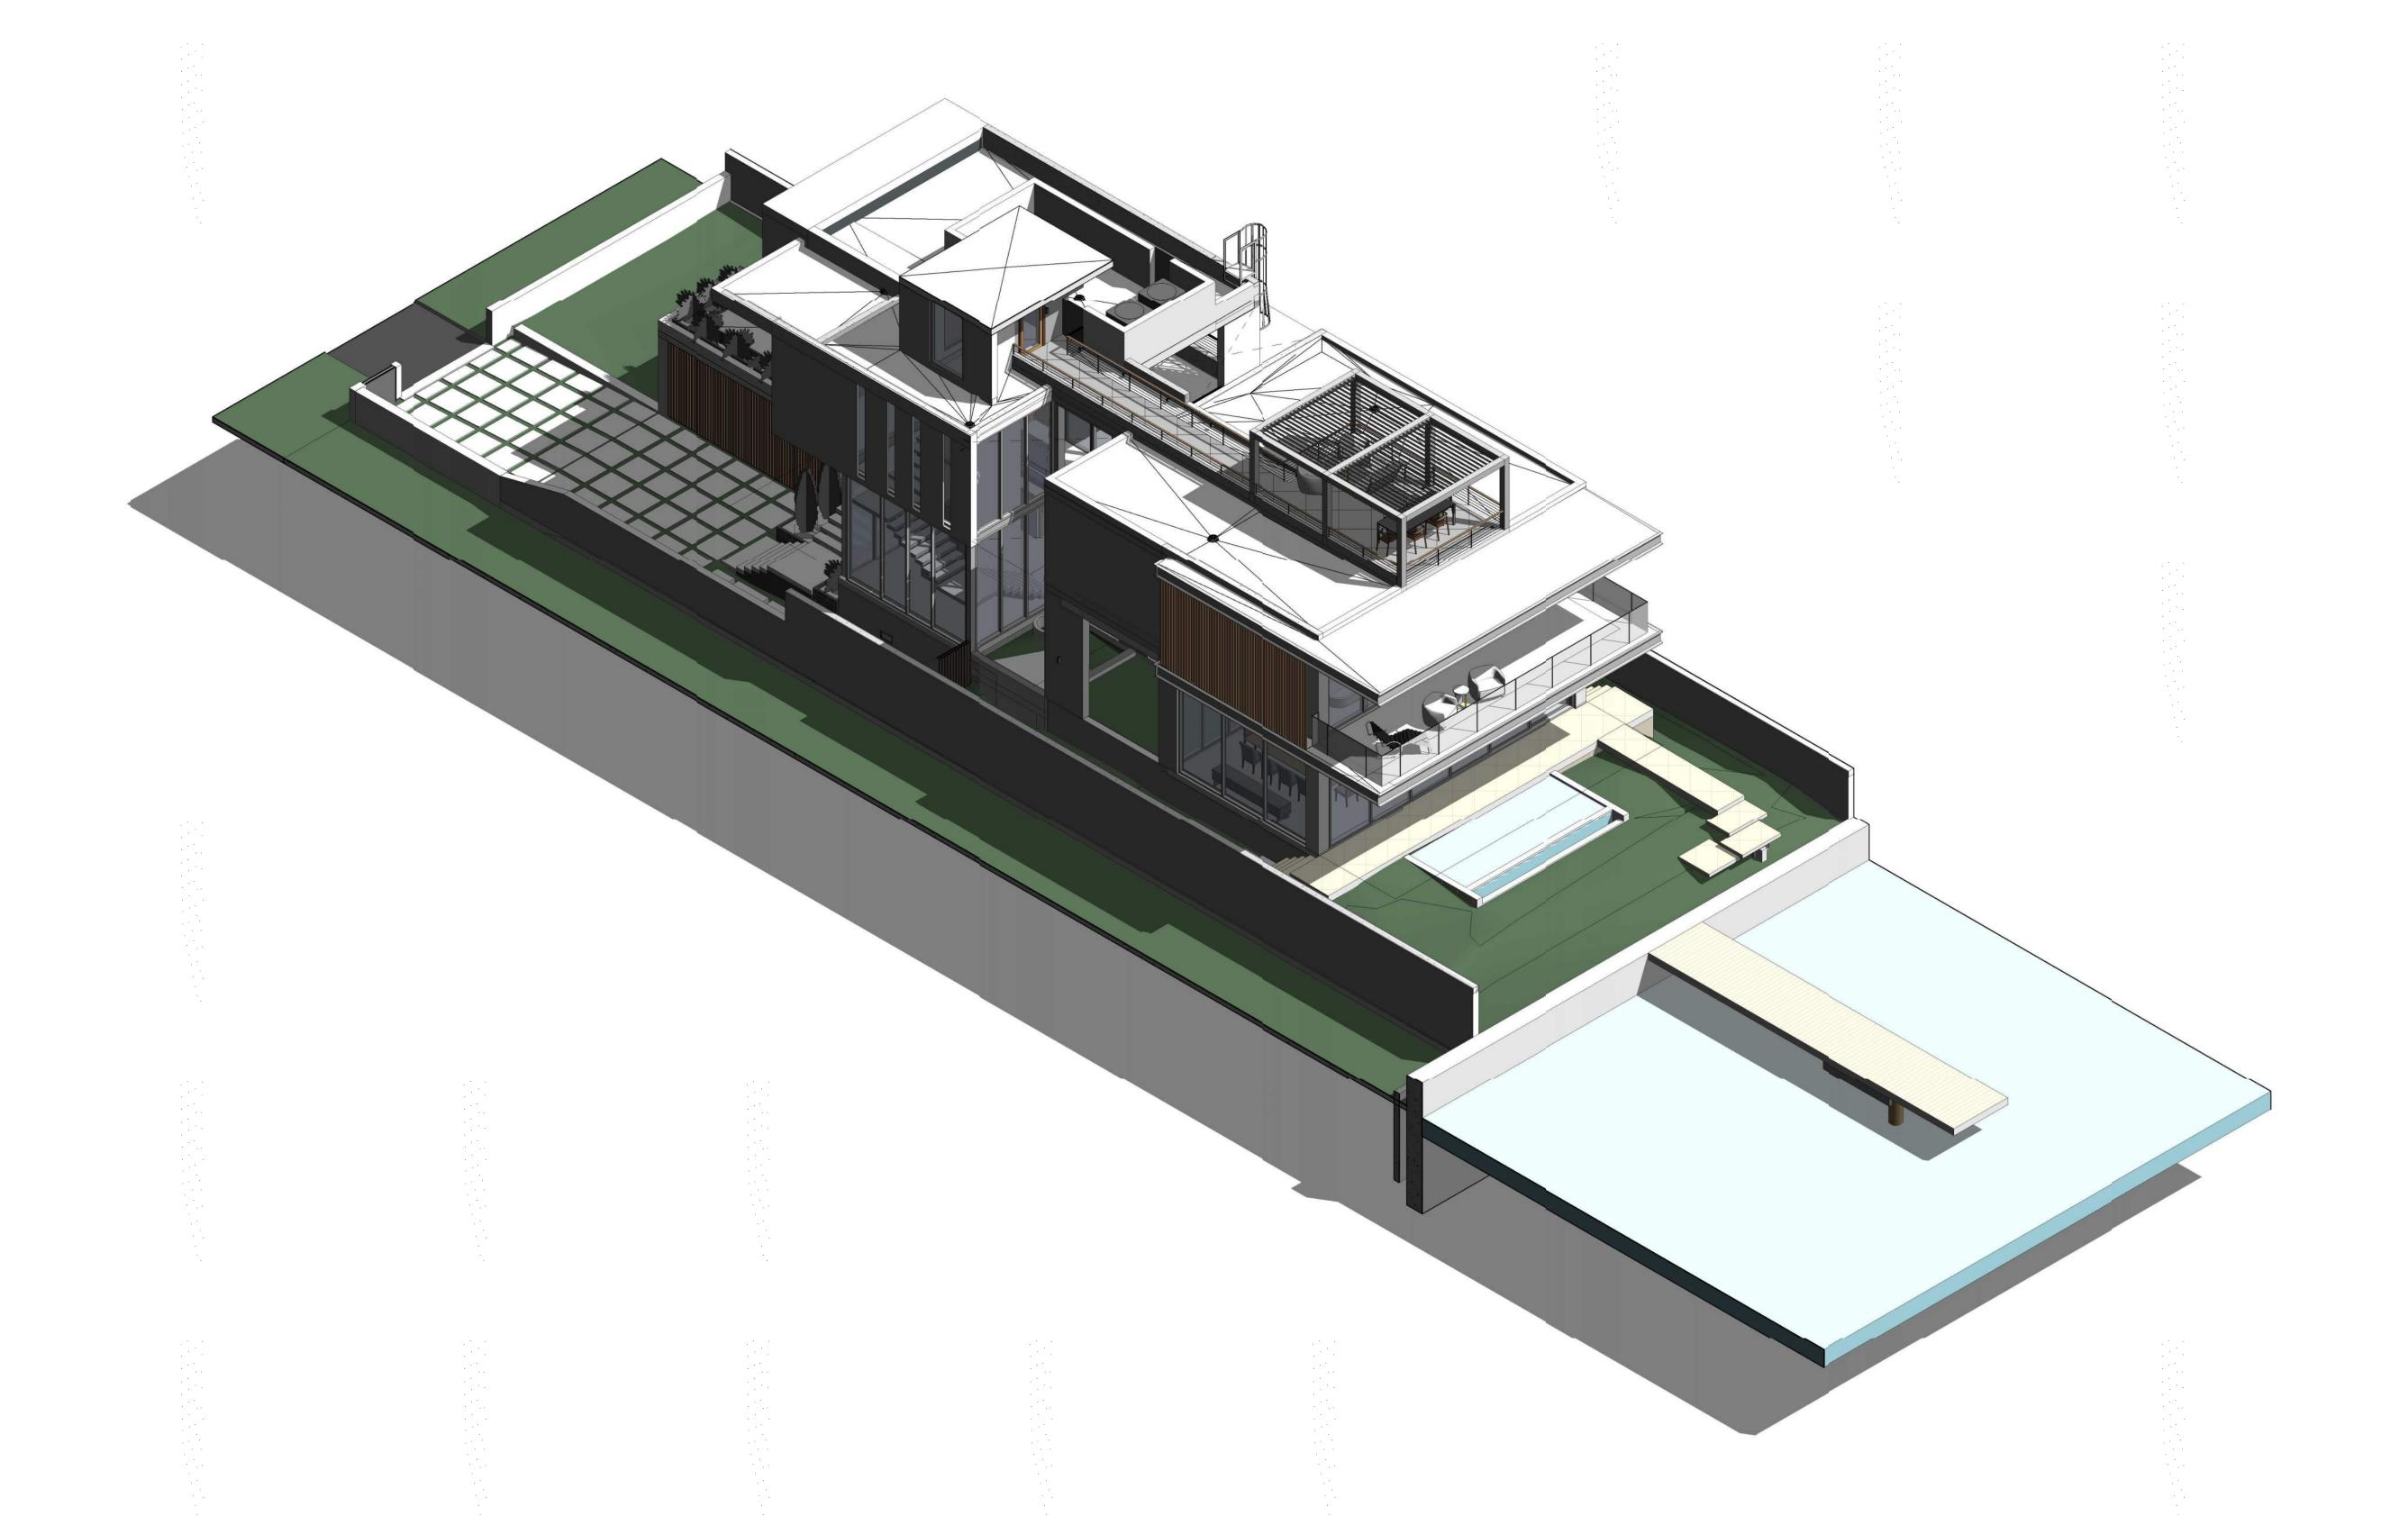
Drawing Name

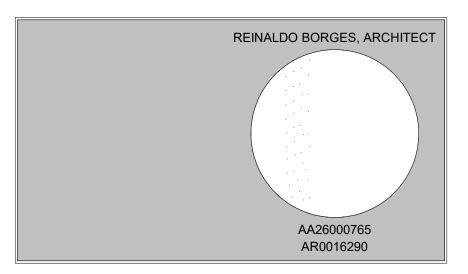SE ISOMETRIC VIEW

Scale:

Drawing Number

A-000



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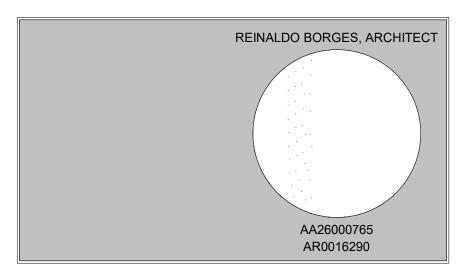
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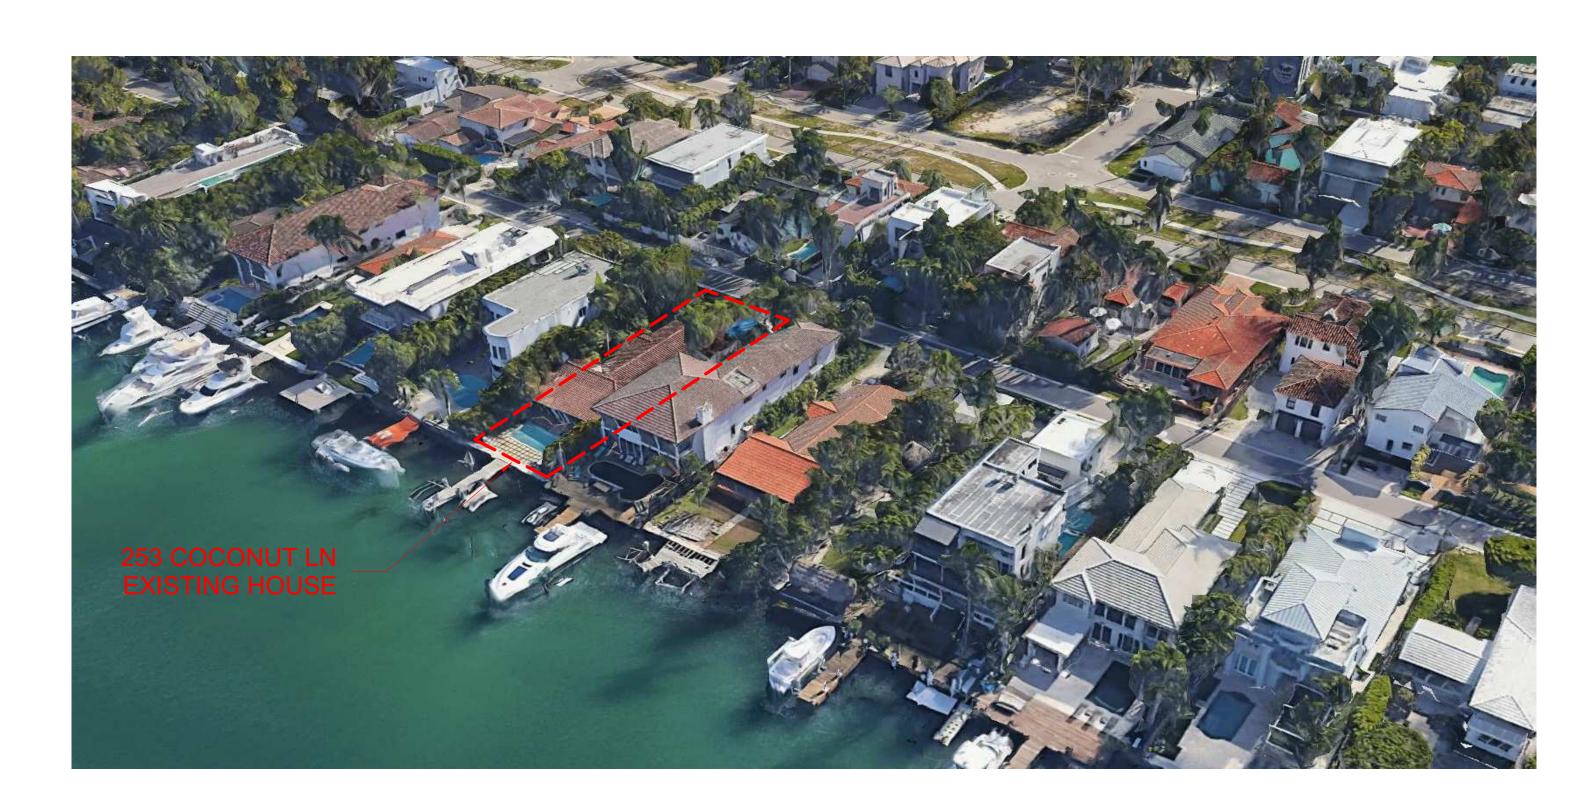
NE ISOMETRIC VIEW

Scale:







SOUTH-WEST PERSPECTIVE VIEW - N.T.S.



NORTH-EAST PERSPECTIVE VIEW. - N.T.S.

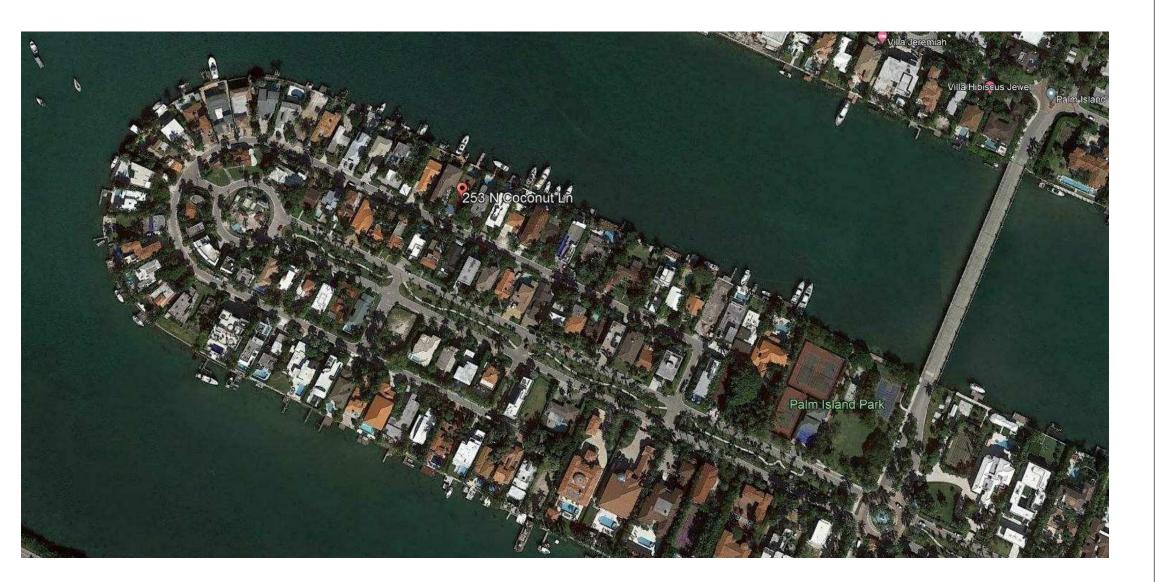

SITE AERIAL VIEW - N.T.S.

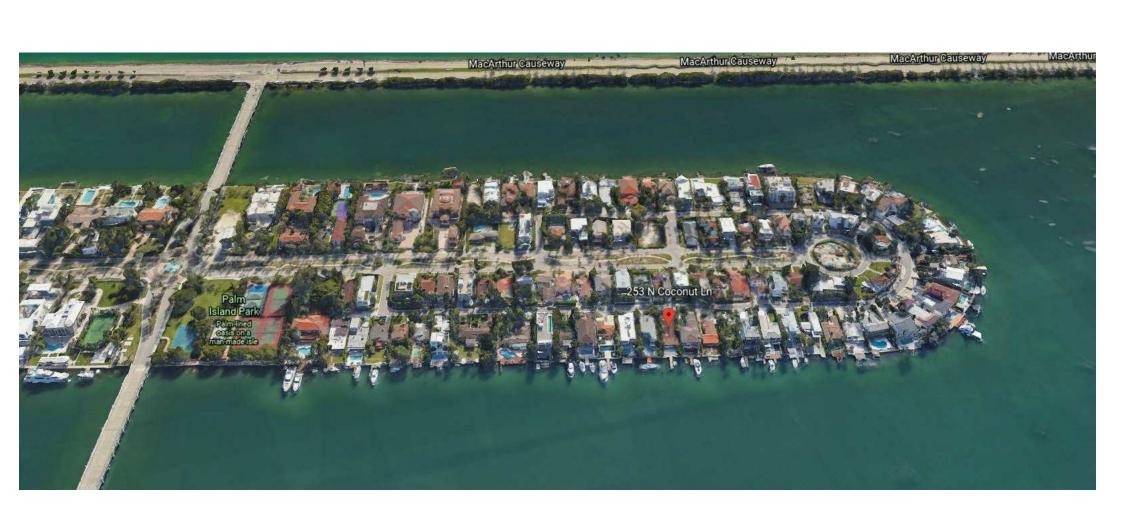


REAR AERIAL VIEW. N.T.S.

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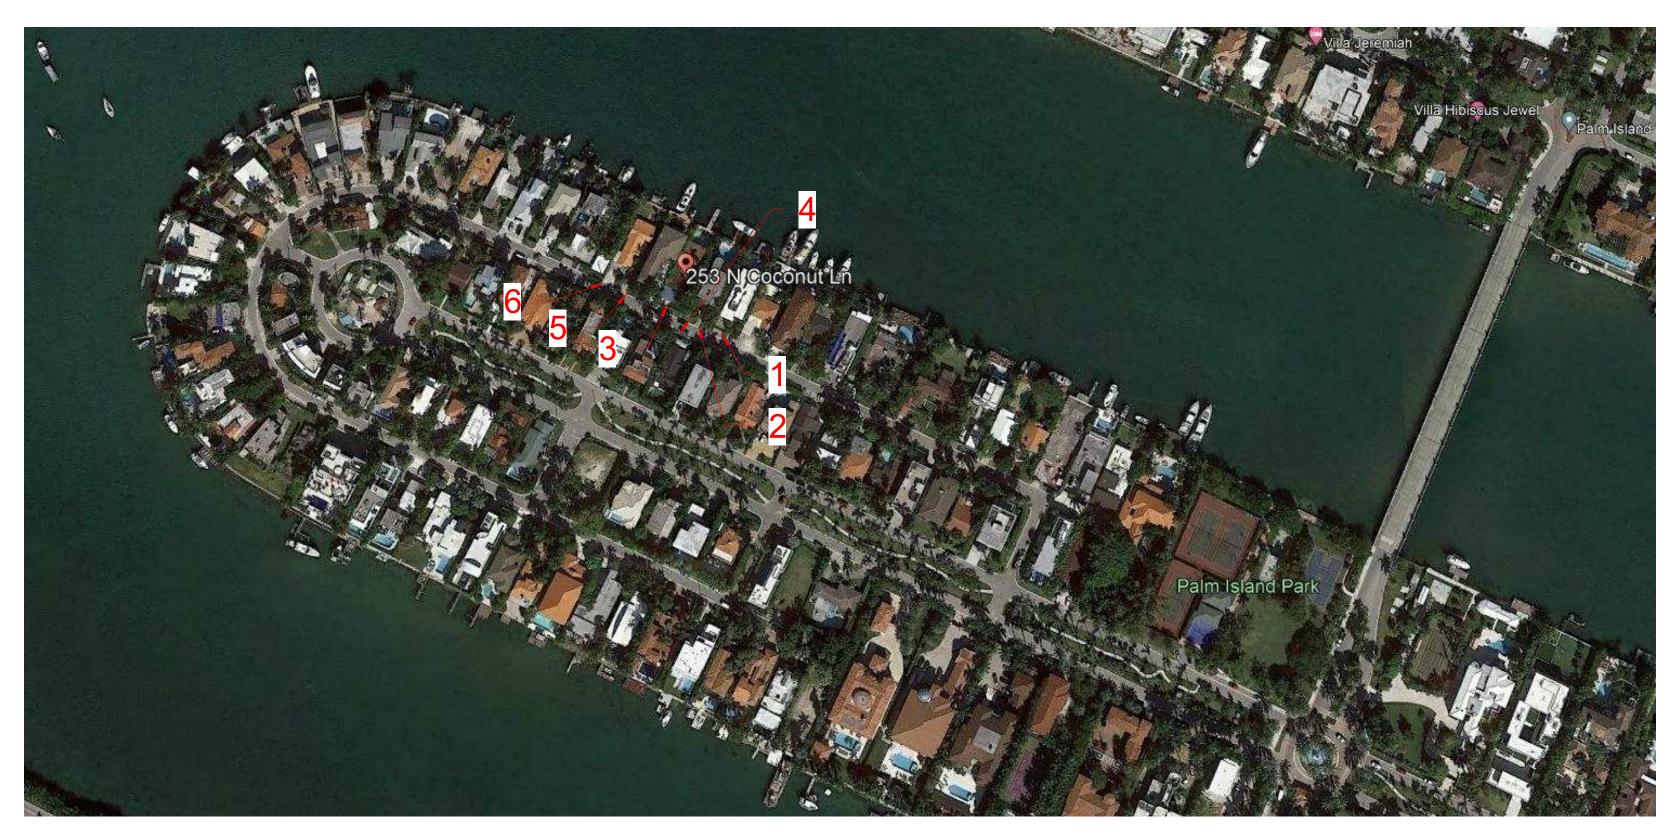
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CASA BAHIA

253 N COCONUT LN MIAMI BEACH, FLORIDA, 33139 FOLIO # 30-6936-008-0010

Project Number	
Drawing Name	
	SITE LOCATION
Scale:	Drawing Number

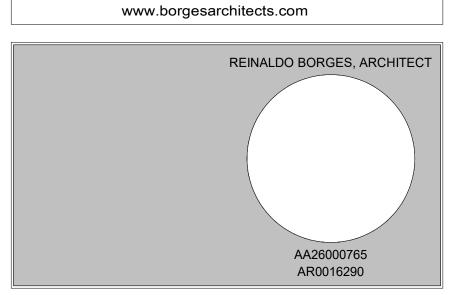A-000k



KEY MAP - N.T.S.











3. (253 COCONUT LANE - EXISTING HOUSE TO BE DEMOLISHED)



3. (253 COCONUT LANE - EXISTING HOUSE TO BE DEMOLISHED)




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Project Number 21-3600 Drawing Name

CONTEXT PICTURES

Scale: Drawing Number

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A-000d BOAT VIEW
A-000g NW ISOMETRIC VIEW
A-000h SW ISOMETRIC VIEW
A-000i SE ISOMETRIC VIEW
A-000j NE ISOMETRIC VIEW

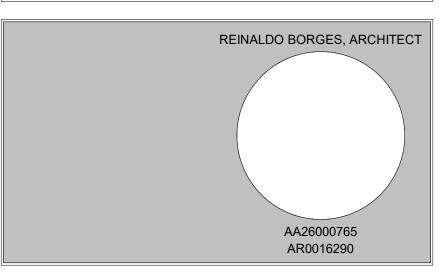LANDSCAPE

L-01 EXISTING TREE DISPOSITION
L-02 LANDSCAPE PLAN
L-03 LANDSCAPE IMAGES
L-04 LANDSCAPE DETAILS

ARCHITECTURE

A-002 INDEX OF DRAWINGS
A-005 LOT COVERAGE AND OPEN AREA DIAGRAMS
A-006 UNIT SIZE DIAGRAMS
A-100 SITE PLAN
A-100A CRAWL SPACE PLAN
A-102 GROUND FLOOR PLAN
A-106 LEVEL 2 - FLOOR PLAN
A-110 ROOF PLAN
A-300 BUILDING ELEVATIONS
A-301 BUILDING ELEVATIONS

A-401

BUILDING SECTIONS

BUILDING SECTIONS

A-000k SITE LOCATION
A-000I CONTEXT PICTURES

INDEX

PROJECT ADDRESS

253 N COCONUNT LN MIAMI BEACH, FL. 33139

PROJECT PROGRAM

THIS PROJECT CONSISTS OF A SINGLE FAMILY HOME: (2) STORY HOUSE, BASEMENT, AND PARKING GARAGE AT GROUND FLOOR AND ROOF DECK TERRACE.

CONSTRUCTION TYPE : III B

OCCUPANCY GROUP : RESIDENTIAL RS-4

ZONING DISTRICT : RS-4 DISTRICT (SINGLE-FAMILY RESIDENTIAL DISTRICTS)

CODES IN EFFECT

FLORIDA BUILDING CODE, RESIDENTIAL 2020
- BUILDING

- STRUCTURAL - PLUMBING - MECHANICAL

CITY OF MIAMI BEACH ZONING ORDINANCES

TOTAL GROSS AREA : 3,577 SF

PROJECT DATA

ELEVATION INFORMATION:

FEMA FLOOD ZONE : AE

BASE FLOOD ELEVATION: +8.00' NGVD +2.00' FREE BOARD = 10.00' NGVD

ISSUE DATE: 01/03/2022 DRB FINAL SUBMITTAL

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1 12/20/2021 Revision 1

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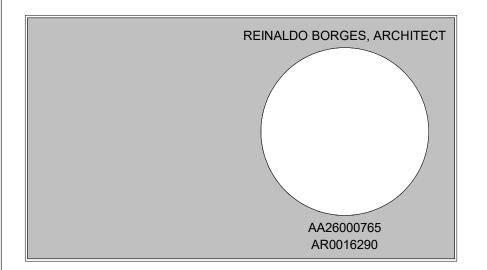
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253 N COCONUT LN MIAMI BEACH, FLORIDA, 33139 FOLIO # 02-4205-002-0160

Project Number 21-3600

Drawing Name

INDEX OF DRAWINGS

Scale:

12" = 1'-0"

Drawing Number

A-002

ABBREVIATIONS

	ANCHOR	НТ	HEIGHT
С	AIR CONDITIONING	HORIZ	HORIZONTAL
COUST	ACOUSTICAL	H.B.	HOSE BIBB
P	ACOUSTICAL CEILING PANEL	I.D.	INTERIOR DIMENSION
F.F.	ABOVE FINISH FLOOR	INSUL.	INSULATION
OR ALUM	ALUMINUM	INTERM	INTERMEDIATE
IOD.	ANODIZE	JAN.	JANITOR
)	BOARD	MANUF.	MANUFACTURER
F.F.	BELOW FINISH FLOOR	MAT	MATERIAL
K'G	BLOCKING	MAX	MAXIMUM
K	BLOCK	MIN	MINIMUM
EM	CEMENT	MTL	METAL
R	CERAMIC	NIC	NOT IN CONTRACT
F.V.	CONTRACTOR FIELD VERIFY	NEOPR	NEOPRENE
J.	CONTROL JOINT	O.D.	OUTSIDE DIMENSION
.G	CEILING	O.C.	ON CENTER
DL	COLUMN	O.S.	OVERFLOW SCUPPER
-	CLOSET	O.R.S.	OVERFLOW ROOF SCUP
ONC	CONCRETE	PTN	PARTITION
DNT	CONTINUOUS	PJ	PANEL JOINT
OVER'G	COVERING	PL	PLATE
3	CURB SCUPPER	L.P.	LIGHT POLE
-	CERAMIC TILE	PLYWD	PLYWOOD
BL	DOUBLE	PNL	PANEL
М	DIMENSION	PLAM	PLASTIC LAMINATE
L/DTLS	DETAILS	P.T.	PRESSURE TREATED
W	DISH WASHER	REINF.	REINFORCING
۹.	EACH	REQ'D	REQUIRED
ECT/ELEC	ELECTRICAL	RM	ROOM
	ELEVATION	R.D.	ROOF DRAIN
EV.	ELEVATOR	R.S.	ROOF SCUPPER
3	EMERGENCY SCUPPER	SHT	SHEET
H.	EXHAUST	SCH	SCHEDULE
IST.	EXISTING	S.S.	STAINLESS STEEL
P.	EXPANSION	STL	STEEL
Œ.	EXTERIOR	STD.	STANDARD
) .	FLOOR DRAIN	SECT	SECTION
≣.	FIRE EXTINGUISHER	SIM	SIMILAR
=.L.	FINISH FLOOR	SPEC'S	SPECIFICATIONS
RE EXT. CAB.	FIRE EXTINGUISHER CABINET	STRUCT	STRUCTURE
O.I.C.	FURNISHED BY OWNER,	SC	SOLID CORE WOOD
J.I.C.	INSTALLED BY CONTRACTOR	PH.	TELEPHONE
UOR	FLUORESCENT	TEMP	TEMPERED
١.	FINISH	VCT	VINYL COMPOSITION TIL
\	GAUGE	VERT	VERTICAL
VB	GYPSUM WALL BOARD	VEST.	VESTIBULE
P. BD.	GYPSUM BOARD	WH	WATER HEATER
ALV.	GALVANIZED		

GALVANIZED STEEL

HOLLOW METAL

GLASS

	SYMBOI	_ LEGENI)
Ę	CENTER LINE	??.??' 	SITE TERRAIN ELEV.
R	PROPERTY LINE	M	ELECTRICAL METER
(1t)	WINDOW TAG	\$\(\bar{M} \)\$	WATER METER
(1t)	DOOR TAG	<u> </u>	REVISION TAG
	SECTION MARK	Room name	ROOM TAG
	DATUM FLOOR ELEV.	SIM A101	CALLOUT HEAD TAG
?	KEYNOTE TAG		ELECTRICAL PANEL
>	BREAKLINE	- LP	LOW POINT ELEVATION
4"	CHANGE OF ELEVATION	•	SPOT ELEVATION
1i	WALL TYPE TAG	5 12	ROOF SLOPE TAG
\rightarrow	RAIN WATER SLOPE ARROW	1i	CURTINE WALL TAG
+ ?? PSF - ?? PSF	WINDOW PRESSURE		LEVEL HEAD CIRCLE
	NORTH ARROW	0	GRID BUBBLE TAG
SD	LINEAR DIFFUSER	LD	LINEAR DIFFUSER
LR	LINEAR RETURN	LT	LINEAR TRANSFER
①	JUNCTION BOX		

GENERAL NOTES

- CONTRACTOR SHALL COMPLY WITH ALL APPLICABLE LOCAL, STATE AND FEDERAL BUILDING CODES HAVING JURISDICTION OVER THIS PROJECT. PERMIT(S) SHALL BE POSTED ON A VISIBLE PLACE AT ALL TIMES.
- CONTRACTOR SHALL BE RESPONSIBLE FOR VISITING THE SITE PRIOR TO BIDDING AND FAMILIARIZING HIMSELF WITH ALL EXISTING CONDITIONS AFFECTING THE WORK, INCLUDING BUT NOT LIMITED TO PRIVATE AND PUBLIC UTILITIES, ON AND OFF SITE, ACCESS ROADS, AND OTHER SUPPORT FACILITIES. CONTRACTOR IS RESPONSIBLE FOR INCLUDING IN HIS BID, LABOR AND MATERIAL COSTS FOR ANY CHARGE OR ALTERATION OF ADJACENT AREAS TO BE DISTURBED DURING CONSTRUCTION SUCH AS, BUT NOT LIMITED TO, PAVING SIDEWALKS, STREETS, EXISTING TREES AND LANDSCAPING TO INSURE THEIR PROPER DRAINAGE AND RETURN THEM TO THE ORIGINAL FINISHED CONDITION.
- CONTRACTOR SHALL REMOVE. RELOCATE OR RE-ROUTE AS NECESSARY ELECTRICAL, WATER, GAS OR ANY OTHER UTILITY LINES ENCOUNTERED DURING CONSTRUCTION, AND AS INDICATED IN THESE DOCUMENTS.
- CONTRACTOR SHALL BE RESPONSIBLE FOR THE REPAIR AND/OR THE REPLACEMENT OF ANY EQUIPMENT DAMAGED DURING CONSTRUCTION OR CLEAN UP. CONSTRUCTION PERSONNEL SHALL BE CONFINED TO THE LIMITS OF THE CONSTRUCTION AREA. ALL OSHA REGULATIONS FOR CONSTRUCTION AREAS SHALL BE STRICTLY FOLLOWED. CONTRACTOR SHALL PREPARE AND MAINTAIN ALL CONSTRUCTION AREAS, AS WELL AS SURROUNDING AREAS FREE OF DEBRIS OR HAZARDOUS EQUIPMENT.
- BY THE CONTRACTOR IN FULL COORDINATION WITH ALL THE CONTRACT DOCUMENTS ISSUED BY BORGES + ASSOCIATES ARCHITECTS, CONTRACTOR MUST NOTIFY ARCHITECT FOR CLARIFICATION PRIOR TO BIDDING OF ANY DISCREPANCIES FOUND ON THE DRAWINGS

CIVIL ENGINEERING, INTERIOR DESIGN, LANDSCAPING AND IRRIGATION DRAWINGS ARE PART OF THIS PROJECT AND SHALL BE PROVIDED

- BETWEEN BUT NOT LIMITED TO THE CIVIL ENGINEERING, ARCHITECTURAL, STRUCTURAL, MECHANICAL, PLUMBING AND ELECTRICAL DRAWINGS. ANY DISCREPANCIES FOUND AFTER BIDDING SHALL BE INTERPRETED AS IF IT WAS BID BASED ON THE MOST EXPENSIVE METHOD OR FINISH.
- CONTRACTOR MUST NOTIFY ARCHITECT IMMEDIATELY OF ANY UNEXPECTED OR UNKNOWN CONDITIONS IN THE FIELD. DISCREPANCIES IN THE DRAWINGS, PRIOR TO PROCEEDING WITH WORK OR SHOP FABRICATION.
- CONTRACTOR TO OBTAIN WRITTEN APPROVAL FROM OWNER OR ARCHITECT PRIOR TO ANY CHANGES OR DEVIATION FROM CONTRACT DOCUMENTS. UNDER NO CIRCUMSTANCES WILL ASSUMPTIONS BY THE CONTRACTOR BE CONSIDERED THE DESIGN INTENT OR APPROVAL OF THE ARCHITECT OR ENGINEER UNLESS THERE IS WRITTEN APPROVAL BY THEM. FAILURE TO NOTIFY THE ARCHITECT AND/OR COMMENCEMENT OF THE WORK WITHOUT APPROPRIATE AUTHORIZATION TO PROCEED SHALL BE REGARDED AS ACCEPTANCE OF THE CONDITIONS AND NOT SUBJECT TO ALTERATIONS ON THE TERMS OF THE CONTRACT.
- ALL WORK, MATERIALS AND EQUIPMENT UTILIZED IN THIS PROJECT SHALL BE NEW AND INSTALLED IN STRICT ACCORDANCE WITH THE MANUFACTURER'S PRINTED INSTALLATION RECOMMENDATIONS AND SPECIFICATIONS. ALL WORK FOR THIS PROJECT SHALL CONFORM TO STANDARDS PUBLISHED BY RECOGNIZED PROFESSIONAL AND INDUSTRY ORGANIZATIONS.
- DRAWINGS ARE NOT TO BE SCALED. DIMENSIONS SHALL BE FOLLOWED. ALL DIMENSIONS ARE BASED ON NOMINAL SIZES OF MEMBERS AND ARE GIVEN TO THE OUTER FACE OF SUCH MEMBERS, NOT TO FACE OF FINISH MATERIAL UNLESS OTHERWISE NOTED ON DRAWINGS.
- CONTRACTOR TO SUBMIT A MINIMUM OF FIVE (5) SETS OF COMPLETE SHOP DRAWINGS OR AS SUBMITTALS FOR APPROVAL BEFORE COMMENCING FABRICATION AND OR INSTALLATION OF ALL APPLICABLE ITEMS OF CONSTRUCTION. ALL SHOP DRAWING AND DIMENSIONS SHALL BE FIELD VERIFIED, REVIEWED AND APPROVED BY THE CONTRACTOR <u>BEFORE</u> SUBMITTAL, AND SO NOTED. INCOMPLETE SHOP DRAWINGS OR LACKING SUFFICIENT INFORMATION WILL BE RETURNED WITHOUT REVIEW. RE-REVIEWS BY ARCHITECT OR ENGINEER REQUIRED DUE TO SUBMITTALS NOT EVALUATED AND APPROVED BY CONTRACTOR SHALL BE BILLABLE AND PAID FOR BY THE CONTRACTOR ON HOURLY RATES ESTABLISHED IN THE ARCHITECTS CONTRACT FOR SERVICES FOR THIS PROJECT.
- THE CONTRACTOR SHALL BE AWARE THAT SPECIFIC FIRE RATED SEPARATIONS AND STATED SOUND TRANSMISSION COEFFICIENTS (STC) WITHIN THE BUILDING'S CONSTRUCTION ARE REQUIRED BY CODE. THE USE OF SPECIFIC MATERIALS AND COMBINATIONS OF MATERIALS WITHIN FIRE RATED ASSEMBLIES AS CALLED FOR ON THE DRAWINGS AND SPECIFICATIONS ARE FOR THE PURPOSE OF ACHIEVING THOSE REQUIRED FIRE SEPARATIONS. IT SHALL BE THE CONTRACTORS RESPONSIBILITY TO VERIFY THAT ANY CHANGE IN MATERIAL REQUESTED AND/OR MADE BY THE CONTRACTOR AND/OR SUBCONTRACTORS, FROM THOSE MATERIALS DRAWN OR SPECIFIED HEREIN, DOES NOT IN ANY WAY AFFECT OR LESSEN THE REQUIRED FIRE RATED CONSTRUCTION OR STC ASSEMBLY. WHERE CMU IS INDICATED TO HAVE A SPECIFIC HOURLY FIRE RATING AND STC RATING, THESE SHALL BE TAKEN AS THE MINIMUM REQUIRED.
- ALL PIPING SHALL BE SLEEVED THROUGH SLAB AND STRUCTURAL ELEMENTS PENETRATED. CONTRACTOR SHALL FULLY SEAL SPACE AROUND PIPES WITH A 2-HOUR U.L. APPROVED FIRE RESISTIVE ("THERMAFIBER" GLASS FIBER SAFING INSULATION AS MANUFACTURED BY U.S. GYPSUM CO. COMPLYING WITH ASTM E-119 OR APPROVED SIMILAR). PENETRATIONS THROUGH FIRE RATED WALLS SHALL BE PROTECTED AS TO MAINTAIN THE FIRE RATING OF SAID WALL. REFER TO WALL TYPES AND PENETRATION PROTECTION U.L. DETAILS INCLUDED IN THE DRAWINGS.
- ALL SHAFTS WHERE APPLICABLE SHALL BE 2-HOUR RATED WITHOUT EXCEPTION, (UL DESIGN NO. U-505 OR APPROVED SIMILAR) AND SHALL EXTEND AS SUCH TO UNDERSIDE OF ROOF OR FLOOR STRUCTURAL DECKING. SEE WALL TYPE DETAILS FOR WALL DESIGNS. PROJECT TO COMPLY WITH APPLICABLE REQUIREMENTS OF FBC CHAPTER 39, SEE FIRE PROTECTION, MECHANICAL, ELECTRICAL AND PLUMBING DRAWINGS.
- CONTRACTOR SHALL FURNISH AND INSTALL BLOCKING (METAL AND/OR WOOD AS ALLOWED BY CODE) WITHIN VERTICAL OR HORIZONTAL FRAMING AS REQUIRED OR RECOMMENDED FOR WALL MOUNTED OR BRACED FIXTURES, MILLWORK, SHELVES, BATHROOM FIXTURES, ACCESSORIES, TILE AND STONE WORK OR BY OTHER ITEMS DESCRIBED IN INTERIOR DESIGN AND ARCHITECTURAL DRAWINGS. ALL WOOD FRAMING, INCLUDING PLYWOOD, WHICH IS CONCEALED WITHIN WALLS OR CEILINGS OR USED FOR SUPPORT OF WALLS OR CEILINGS MUST BE FIRE RETARDANT. PRESSURE TREATED WOOD MUST BE USED WHERE IN CONTRACT WITH CONCRETE OR MASONRY AS PERMISSIBLE BY THE AUTHORITIES HAVING JURISDICTION.
- THE UNDERSIDE OF ALL EXTERIOR SOFFITS, BALCONIES AND SLABS EXPOSED TO WEATHER SHALL RECEIVE A CONTINUOUS 1-INCH DRIP STRIP CAST IN SAID SLAB WITHOUT EXCEPTION.
- ALL METAL FLASHING, SCUPPERS, ETC. SHALL BE PAINTED AS RECOMMENDED BY MANUFACTURER, UNLESS OTHERWISE NOTED ON DRAWINGS OR PROJECT MANUAL. COLOR TO MATCH ADJACENT SURFACES OR AS INDICATED BY THE ARCHITECT
- IN ADDITION TO WALL TYPES SHOWN ON PLANS THE CONTRACTOR SHALL REFER TO THE ROOM FINISH SCHEDULE, INTERIOR
- ELEVATIONS AND DETAILS FOR ADDITIONAL INFORMATION REGARDING FINISHES, INCLUDING INTERIOR DESIGN DRAWINGS. CONTRACTOR SHALL PROVIDE ACCESS PANELS FOR ANY CONCEALED PLUMBING, FIRE PROTECTION AND/OR MECHANICAL VALVES, FIRE DAMPERS. FIRE ALARM AND ELECTRICAL JUNCTION BOXES AS REQUIRED BY CODE AND AUTHORITIES HAVING JURISDICTION. ACCESS PANELS AND/OR DOORS SHALL BE U.L. LISTED AND SHALL MAINTAIN THE FIRE RATING SPECIFIED FOR THE DESIGN ASSEMBLY. THE LOCATION OF ALL ACCESS DOORS/PANELS SHALL ALLOW FOR PROPER EQUIPMENT ACCESSIBILITY, MAINTENANCE AND/OR OPERATION OF THE BUILDING SYSTEMS. THE OMISSION OF SUCH IN THESE DOCUMENTS DOES NOT RELIEVE THE CONTRACTOR OF THE
- RESPONSIBILITY FROM PROVIDING AND INSTALLING SUCH PANELS OR DOORS. CONTRACTOR SHALL PAINT ALL VISIBLE SURFACES OF FACTORY PRIMED OR FACTORY PAINT FINISHED EQUIPMENT, A/C GRILLS OR REGISTERS, COVERS, ETC, UNLESS SPECIFICALLY NOTED OTHERWISE, VERIFY AND COORDINATE COLORS WITH INTERIOR DESIGNER AND
- BEFORE INSTALLATION, THE CONTRACTOR SHALL COORDINATE WITH THE ARCHITECT AND INTERIOR DESIGNER THE EXACT MOUNTING LOCATION OF ALL SWITCHES, WALL RECEPTACLES, PLUGS, THERMOSTATS AND OTHER WALL MOUNTED FIXTURES IN ACCORDANCE WITH ADOPTED ACCESSIBILITY GUIDELINES, UNLESS SPECIFICALLY NOTED ON THE DRAWINGS.
- ALL INTERIOR AND EXTERIOR CONNECTIONS BETWEEN DISSIMILAR MATERIALS AND/OR FINISHES SHALL BE ISOLATED FROM DIRECT CONTACT BY MEANS OF COMPATIBLE MATERIALS. IT SHALL RECEIVE A BEAD OF CAULKING OR SEALANT TO MATCH COLOR OF ADJACENT SURFACES INSTALLED OVER A COMPRESSIBLE BACKER ROD OF COMPATIBLE MATERIAL AND APPROPRIATE WIDTH FOR THE JOINT. COORDINATE COLORS WITH ARCHITECT, INTERIOR DESIGNER AND/OR OWNER.
- AS A **PRE-REQUISITE** TO SUBSTANTIAL COMPLETION, THE CONTRACTOR SHALL BE RESPONSIBLE FOR REMOVING ALL DEBRIS AND CONSTRUCTION MATERIAL FROM THE PROJECT SITE. CONTRACTOR SHALL ALSO BE RESPONSIBLE FOR PROPERLY CLEANING ALL AREAS PRIOR TO FINAL ACCEPTANCE BY THE OWNER INCLUDING BUT NOT LIMITED TO WINDOWS, STOREFRONT, FLOOR TILES, CARPETS, WALLS, DOORS, LIGHT FIXTURES, DIFFUSERS, LOUVERS AND GRILLES, ETC.
- AS A PRE-REQUISITE TO SUBSTANTIAL COMPLETION, THE CONTRACTOR SHALL PROVIDE THE OWNER A COMPLETE SET OF AS-BUILT DRAWINGS DOCUMENTING ANY DEVIATIONS FROM THESE DOCUMENTS TO INCLUDE ARCHITECTURAL, STRUCTURAL, PLUMBING, FIRE PROTECTION, MECHANICAL AND ELECTRICAL DRAWINGS ALONG WITH THE WRITTEN GUARANTIES, OPERATION AND MAINTENANCE MANUALS OF ALL EQUIPMENT AND FINISHES INSTALLED. THE CONTRACTOR SHALL MAINTAIN A CURRENT SET OF AS-BUILT DRAWINGS ON SITE AT ALL TIMES. ALL DEVIATIONS FROM THESE DRAWINGS SHALL BE RECORDED BY THE CONTRACTOR AS CONSTRUCTION PROGRESSES.
- THE CONTRACTOR, ALL SUBCONTRACTORS AND SUPPLIERS SHALL GRANT TO THE OWNER/DEVELOPER, INSTITUTIONAL MORTGAGEE AND TO THE PURCHASER OF EACH UNIT, EXPRESSED AND IMPLIED WARRANTIES OF FITNESS FOR THE LABOR/WORK PERFORMED AND MATERIALS SUPPLIED BY THEM AS FOLLOWS: a. FOR A PERIOD OF FIVE (5) YEARS FROM THE DATE OF SUBSTANTIAL COMPLETION, A WARRANTY AS TO THE ROOFING SYSTEM, WATERPROOFING, STRUCTURAL COMPONENTS OF THE BUILDING AND MECHANICAL AND PLUMBING ELEMENTS, EXCEPT MECHANICAL ELEMENTS SERVING ONLY ONE UNIT; b. FOR A PERIOD OF THREE (3) YEARS FROM DATE OF SUBSTANTIAL COMPLETION, A WARRANTY AS TO ALL OTHER IMPROVEMENTS AND MATERIALS; c. AS TO PERSONAL PROPERTY, A WARRANTY WHICH IS FOR THE SAME PERIOD AS THAT PROVIDED BY THE MANUFACTURER OF THE PERSONAL PROPERTY, COMMENCING FROM THE DATE OF CLOSING OF THE PURCHASE OR THE DATE OF POSSESSION OF THE UNIT, WHICHEVER IS EARLIEST. d. THE TERM "COMPLETION OF A BUILDING OR IMPROVEMENT" MEANS **FINAL** COMPLETION OF CONSTRUCTION, FINISHING AND EQUIPPING OF THE BUILDING IN ACCORDANCE WITH THE PLANS AND SPECIFICATIONS, THE ISSUANCE OF A CERTIFICATE OF OCCUPANCY FOR THE ENTIRE BUILDING BY THE LOCAL AUTHORITY HAVING JURISDICTION AND FINAL ACCEPTANCE BY THE OWNER.
- COMPLY WITH THE FOLLOWING APPLICABLE ITEMS OF FBC CHAPTER 36- SECURITY ENFORCED ENTRY PREVISION: a. ALL LOCKS ON EXTERIOR DOORS SHALL BE CAPABLE OF RESISTING A FORCE OF 300 LB APPLIED IN ANY MOVABLE DIRECTION AND IN ACCORDANCE WITH RESISTANCE STANDARDS SET FORTH IN FBC SUBSECTION 3601.2. b. ALL SINGLE EXTERIOR SWING DOORS SHALL HAVE A LOCK TO BE KEY OPERATED FROM EXTERIOR WITH A MIN. OF 600 POSSIBLE KEY CHANGES OR LOCKING COMBINATIONS AUXILIARY SINGLE DEAD BOLT WITH HARDENED BOLT INSERTS. c. THE ACTIVE LEAF OF PAIRS OF EXTERIOR SWING DOORS SHALL HAVE SAME LOCKS AS REQUIRED FOR SINGLE EXTERIOR SWING DOORS. THE INACTIVE LEAF OF THESE PAIR OF DOORS SHALL HAVE MULTIPLE POINT LOCKS WITH 5/8" MIN. THROW BOLTS WITH INSERTS. d. SLIDING GLASS DOORS SHALL BE PROVIDED WITH SLIDING DOORS DEAD BOLTS OR A BOLT OR PIN NOT REMOVABLE OR OPERABLE FROM EXTERIOR, AT THE JAMB, HEAD, SILL OR AT MEETING MULLIONS. THESE DOORS SHALL BE REINFORCED IN THE STRIKE AND MAINTAIN BOLT STRENGTH EFFECTIVENESS, IF NECESSARY, AND SUCH DOORS SHALL HAVE NO SCREWS REMOVABLE FROM OUTSIDE WHICH WOULD FACILITATE READY ENTRY FROM OUTSIDE. e. HINGES ON EXTERIOR OUT SWINGING DOORS SHALL HAVE NO REMOVABLE PINS. f. SINGLE, SWINGING EXTERIOR DOORS, IF WOOD SHALL BE SOLID CORED AND INSULATED OF NOT LESS THAN 1-3/4" THICK. g. GLASS SHALL COMPLY WITH THE AMERICAN NATIONAL STANDARDS INSTITUTE (ANSI) Z97.1. h. SLIDING GLASS DOORS SHALL BE INSTALLED AND CONSTRUCTED SO THAT NO PANEL CAN BE LIFTED FROM THE TRACKS WHEN IN THE LOCKED POSITION AND SO AS TO COMPLY WITH ARCHITECTURAL ALUMINUM MFGS ASSOC. STANDARDS FOR FORCED ENTRY RESISTANCE AAMA 1303.5 AND ANSI/AAMA 101.
- SWIMMING POOL AND SPA, COMPLETE WITH ALL SHOWN PIPING, PUMPS, PANELS, ALARMS AND SUPPORTING EQUIPMENT SHALL BE PART OF A SEPARATE PERMIT BY THE APPROPRIATE AGENCIES HAVING JURISDICTION.
- A SEPARATE PERMIT AND PRODUCT CONTROL APPROVAL, WHEN APPLICABLE, ARE REQUIRED FOR THE FOLLOWING: STRUCTURAL GLAZING, CURTAIN WALLS, RAINSCREEN SYSTEMS, SIGNS, FENCES, WINDOWS, DOORS, AWNINGS, DEMOLITION, STEEL JOISTS, STOREFRONTS, PRECAST SYSTEMS, ROOFING, RAILINGS, MULLIONS, HANDRAILS, GLASS BLOCK, ALUMINUM TRELLIS & GRID PANELS & LOUVERS, CANOPIES, & METAL STRUCTURAL COLUMN, METAL ROOF FEATURES, ELEVATORS, GLASS & ALUMINUM RAIL, STAIR RAIL & BALCONY GUARDRAIL, STEEL FRAMES & METAL DECKS, TRANSLUCENT MATERIAL "KALWALL". SPIRAL STAIR (TO RESIST PENDULUM LATERAL IMPACT 400#)
- ROOF SYSTEM SHALL BE INSTALLED IN COMPLETE CONFORMANCE WITH THE SOUTH FLORIDA BUILDING CODE/ MIAMI DADE COUNTY PRODUCT APPROVAL AND MANUFACTURERS SPECIFICATIONS. REFER TO ROOFING AND WATERPROOFING NOTES AND DETAILS ELSEWHERE IN THESE DRAWINGS.
- ALL ELECTRICAL, MECHANICAL AND PLUMBING EQUIPMENT MUST BE LOCATED AT OR ABOVE BASE FLOOD ELEVATION (10.00'). ALL FINISH MATERIALS BELOW BFE MUST BE MADE OF FLOODDPROOF MATERIALS.
- ALL LIGHTING FIXTURES BELOW BFE MUST BE WATER SUMERSIBLE.
- AS PER FBC R 320 TERMITE PROTECTION SHALL BE PROVIDED BY REGISTERED TERMITICIDES, INCLUDING SOIL APPLIED PESTICIDES, BAITING SYSTEMS, AND PESTICIDES APPLIED TO WOOD, OR OTHER APPROVED METHODS OF TERMITE PROTECTION LABELED FOR USE AS A PREVENTATIVE TREATMENT TO NEW CONSTRUCTION (SEE SECTION, REGISTERED TERMITICIDE). UPON COMPLETION OF THE APPLICATION OF THE TERMITE PROTECTIVE TREATMENT, A CERTIFICATE OF COMPLIANCE SHALL BE ISSUED TO THE BUILDING DEPARTMENT BY THE LICENSED PEST CONTROL COMPANY THAT CONTAINS THE FOLLOWING STATEMENT: "THE BUILDING HAS RECEIVED A COMPLETE TREATMENT FOR THE PREVENTION OF SUBTERRANEAN TERMITES. TREATMENT IS IN ACCORDANCE WITH RULES AND LAWS ESTABLISHED BY THE FLORIDA DEPARTMENT OF AGRICULTURE AND CONSUMER SERVICES."


ISSUE [DATE: 01/0	03/2022	DRB FINAL SUBMITTAL
No.	Date		Description

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Project Team	

Project Name

CASA BAHIA

253 N COCONUT LN MIAMI BEACH, FLORIDA, 33139 FOLIO # 02-4205-002-0160

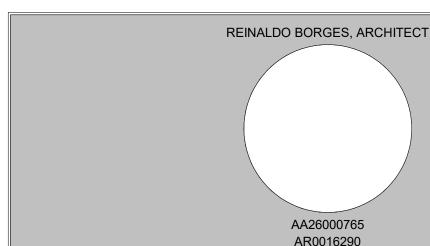21-3600

Drawing Name	
OFNEDAL NOTEO	
GENERAL NOTES	

Drawing Number

As indicated

Scale:

Project Number

ZONING DATA

PROJECT DESCRIPTION: NEW CONSTRUCTION-SINGLE FAMILY MUNICIPALITY: MIAMI BEACH STREET ADDRESS: 253 N COCONUT LN MIAMI BEACH, FLORIDA, 33139 FOLIO NUMBER: 02-4205-002-0160 ZONING DISTRICT RS-4 FEMA ZONE: AH

CODE OF ORDINANCES' REFERENCES: LOT AREA: 142-105 MINIMUM LOT WIDTH: 142-105 GROSS BUILDING AREA: 142-105 LOT COVERAGE: 142-105 BUILDING HEIGHT: 54-35 BUILDING SETBACKS: 142-106 FENCE HEIGHT:142-1132 DRIVEWAYS: 142-1132 POOL SETBACK: 142-1133 PROJECTIONS: 142-1132, 142-105 OTHER DIMENSIONAL REQUIREMENTS:142-105

BFE: 8.00' NGVD +2.00' NGVD (FREE BOARD) = 10.00' NGVD

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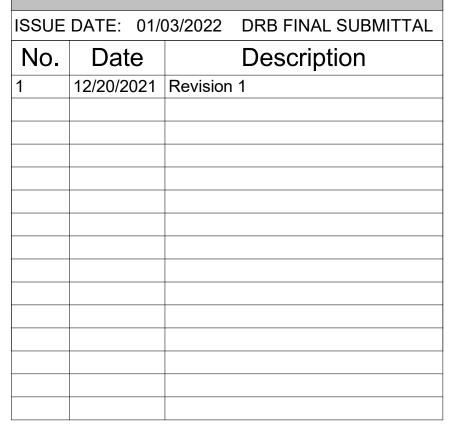
ZONING DATA SHEET

ITEM #	Zoning Information				
1	Address:	253 COCONUT LN. MIAN	ЛІ BEACH, FLORIDA 3313	9	
2	Folio number(s):	02-4205-002-0160			
3	Board and file numbers:	N/A			
4	Year built:	1935	Zoning District:		RS-4
5	Based Flood Elevation:	8.00' NGVD (8'+2' FB)	Grade value in NGVD:		3.08' NGVD
6	Adjusted grade (Flood+Grade/2):	8'+3.08/2=5.54' NGVD	Free board:		2'-0"
7	Lot Area:	7,000 sf (0.16 ac)			
8	Lot width:	50 ft.	Lot Depth:		140 ft.
9	Max Lot Coverage SF and %:	2,100 sf (30%)	Proposed Lot Coverag	e SF and %:	2,100 sf (30%)
10	Existing Lot Coverage SF and %:	N/A	Lot coverage deducted	d (garage-storage) SF:	500 sf (garage)
11	Front Yard Open Space SF and %:	750 sf (50%)	Rear Yard Open Space	SF and %:	735 sf (70%)
12	Max Unit Size SF and %:	3,500 sf (50%)	Proposed Unit Size SF	and %:	3,500 sf (50%)
13	Existing First Floor Unit Size:	2,283 sf	Proposed First Floor U	nit Size:	1,718 sf
14	Existing Second Floor Unit Size	N/A	Proposed Second Floo % (Note: to exceed 70 main home require DF		
15			Proposed Second Floo	1,705 sf	
16			Proposed Roof Deck A Maximum is 25% of th immediately below):	426 sf (25%) (1,705 x 0.25)	
		Required	Existing	Proposed	Deficiencies
17	Height:	24 ft.	1 Story	24 ft. / 2 stories	
18	Setbacks:				
19	Front First level:	20 ft.	N/A	20 ft.	
20	Front Second level:	30 ft.	N/A	40 ft.	
21	Side 1:	7'-6"	N/A	7'-6"	
22	Side 2 or (facing street):	7'-6"	N/A	7'-6"	
23	Rear:	21'-0"	N/A	21'-0"	
	Accessory Structure Side 1:		N/A	N/A	
24	Accessory Structure Side 2 or (facing street):		N/A	N/A	
25	Accessory Structure Rear:		N/A	N/A	
26	Sum of Side yard:	15'-0"	N/A	15'-0"	
27	Located within a Local Historic District?			No	
21	Located Within a Local Historic District:				

29 Determined to be Architecturally Significant?








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Project Team

Project Name

CASA BAHIA

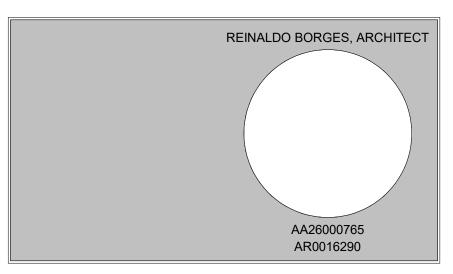253 N COCONUT LN MIAMI BEACH, FLORIDA, 33139 FOLIO # 02-4205-002-0160

	Drawing Name
(LOT COVERAGE AND OPEN AREA DIAGRAMS
,	

Scale:

Project Number 21-3600

3/32" = 1'-0"

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ZONING DATA SHEET

28 Designated as an individual Historic Single Family Residence Site?


29 Determined to be Architecturally Significant?

Notes:

ITEM #	Zoning Information									
1	Address:	253 COCONUT LN. MIAN	II BEACH, FLORIDA 3313	9						
2	Folio number(s):	02-4205-002-0160								
3	Board and file numbers:	N/A								
4	Year built:	1935	Zoning District: RS-4							
5	Based Flood Elevation:	8.00' NGVD (8'+2' FB)	Grade value in NGVD:	Grade value in NGVD:						
6	Adjusted grade (Flood+Grade/2):	8'+3.08/2=5.54' NGVD	Free board:		2'-0"					
7	Lot Area:	7,000 sf (0.16 ac)								
8	Lot width:	50 ft.	Lot Depth:		140 ft.					
9	Max Lot Coverage SF and %:	2,100 sf (30%)	Proposed Lot Coverage	e SF and %:	2,100 sf (30%)					
10	Existing Lot Coverage SF and %:	N/A	Lot coverage deducted	(garage-storage) SF:	500 sf (garage)					
11	Front Yard Open Space SF and %:	750 sf (50%)	Rear Yard Open Space	Rear Yard Open Space SF and %:						
12	Max Unit Size SF and %:	3,500 sf (50%)	Proposed Unit Size SF	and %:	3,500 sf (50%)					
13	Existing First Floor Unit Size:	2,283 sf	Proposed First Floor U	1,718 sf						
14	Existing Second Floor Unit Size	N/A	Proposed Second Floor % (Note: to exceed 709 main home require DR							
15			Proposed Second Floo	1,705 sf						
16			Proposed Roof Deck Area SF and % (Note: Maximum is 25% of the enclosed floor area immediately below):		426 sf (25%) (1,705 x 0.25)					
		Required	Existing	Proposed	Deficiencie					
17	Height:	24 ft.	1 Story	24 ft. / 2 stories						
18	Setbacks:									
19	Front First level:	20 ft.	N/A	20 ft.						
20	Front Second level:	30 ft.	N/A	40 ft.						
20			N/A 7'-6"							
21	Side 1:	7'-6"	N/A	7'-6"						
		7'-6" 7'-6"	N/A N/A	7'-6" 7'-6"						
21	Side 1:									
21 22	Side 1: Side 2 or (facing street):	7'-6"	N/A	7'-6"						
21 22 23	Side 1: Side 2 or (facing street): Rear:	7'-6"	N/A N/A	7'-6" 21'-0"						
21 22	Side 1: Side 2 or (facing street): Rear: Accessory Structure Side 1: Accessory Structure Side 2 or (facing	7'-6"	N/A N/A N/A	7'-6" 21'-0" N/A						





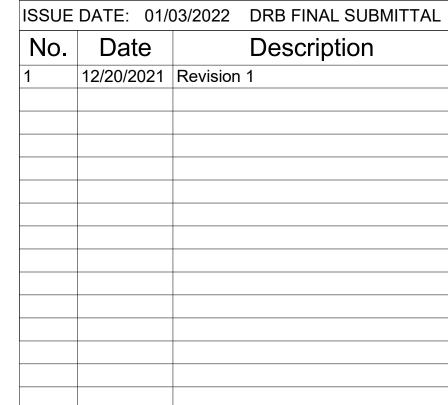


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Project Team

Project Name


CASA BAHIA

253 N COCONUT LN MIAMI BEACH, FLORIDA, 33139 FOLIO # 02-4205-002-0160

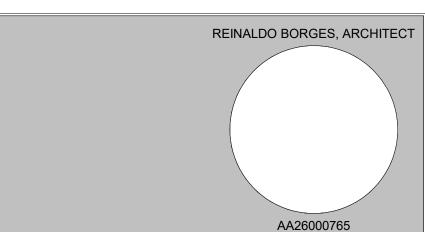Project Number 21-3600 **Drawing Name** UNIT SIZE DIAGRAMS

Scale:

3/32" = 1'-0"

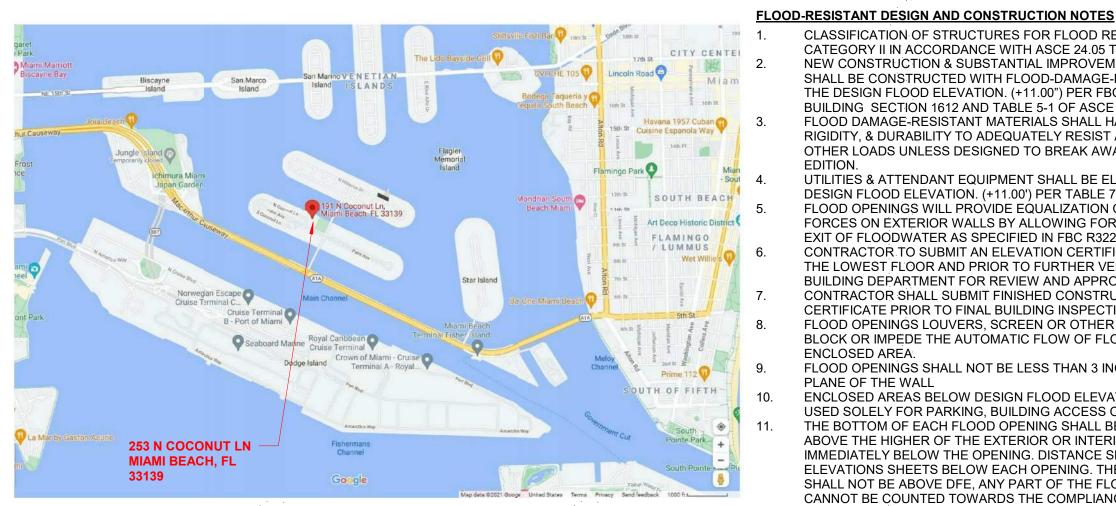

ZONING DATA

MUNICIPALITY: MIAMI BEACH

MIAMI BEACH, FL 33139

ZONING DISTRICT RS-4

FIRM MAP: 12086 C 0316-L

ADJUSTED GRADE

BASE FLOOD ELEV.

1ST FLOOR ELEV.

2ND FLOOR ELEV.

ROOF ELEV.

FEMA ZONE: AE

STREET ADDRESS: 253 N COCONUT LN

GARAGE FLOOR ELEV. @ 5.25' NGVD

FOLIO NUMBER: 02-4205-002-0160

PROJECT DESCRIPTION: NEW CONSTRUCTION-SINGLE

5.54' NGVD

@ 11.00' NGVD

@ 23.92' NGVD

@ 35.00' NGVD

@ 8.00' NGVD +2.00' (10.00' NGVD) 1929

CITY MAP - NTS

CODE OF ORDINANCES' **REFERENCES:**

CODE OF ORDINANCES' REFERENCES: LOT AREA: 142-105 MINIMUM LOT WIDTH: 142-105 **GROSS BUILDING AREA: 142-105** LOT COVERAGE: 142-105 **BUILDING HEIGHT: 54-35 BUILDING SETBACKS: 142-106** FENCE HEIGHT:142-1132 DRIVEWAYS: 142-1132 POOL SETBACK: 142-1133 PROJECTIONS: 142-1132, 142-105 OTHER DIMENSIONAL REQUIREMENTS:142-105

ELEVATIONS NOTE

ALL ELEVATIONS ARE BASED UPON NATIONAL GEODETIC VERTICAL DATUM OF1929 (NGVD 1929). SCOPE OF WORK

1. DESCRIPTION New construction 2 stories single family residence

2. SCOPE INCLUDES 2.1 Demolition of existing structure 2.2 New construction 2 stories single family residence

CLASSIFICATION OF STRUCTURES FOR FLOOD RESISTANCE DESIGN SHALL BE CATEGORY II IN ACCORDANCE WITH ASCE 24.05 TABLE 1.1. NEW CONSTRUCTION & SUBSTANTIAL IMPROVEMENTS IN FLOOD HAZARD AREAS SHALL BE CONSTRUCTED WITH FLOOD-DAMAGE-RESISTANT MATERIALS BELOW THE DESIGN FLOOD ELEVATION. (+11.00") PER FBC FIFTH EDITION (2014) BUILDING SECTION 1612 AND TABLE 5-1 OF ASCE 24. LATEST EDITION.

FLOOD DAMAGE-RESISTANT MATERIALS SHALL HAVE SUFFICIENT STRENGTH, RIGIDITY, & DURABILITY TO ADEQUATELY RESIST ALL FLOOD-RELATED AND OTHER LOADS UNLESS DESIGNED TO BREAK AWAY PER ASCE 24, LATEST EDITION. UTILITIES & ATTENDANT EQUIPMENT SHALL BE ELEVATED AT OR ABOVE THE DESIGN FLOOD ELEVATION. (+11.00') PER TABLE 7-1 OF ASCE 24, LATEST EDITION.

FLOOD OPENINGS WILL PROVIDE EQUALIZATION OF HYDROSTATIC FLOOD FORCES ON EXTERIOR WALLS BY ALLOWING FOR THE AUTOMATIC ENTRY AND EXIT OF FLOODWATER AS SPECIFIED IN FBC R322.2.2 AND ASCE 24. CONTRACTOR TO SUBMIT AN ELEVATION CERTIFICATE UPON PLACEMENT OF THE LOWEST FLOOR AND PRIOR TO FURTHER VERTICAL CONSTRUCTION TO BUILDING DEPARTMENT FOR REVIEW AND APPROVAL

CONTRACTOR SHALL SUBMIT FINISHED CONSTRUCTION ELEVATION CERTIFICATE PRIOR TO FINAL BUILDING INSPECTION APPROVAL OR CO. FLOOD OPENINGS LOUVERS, SCREEN OR OTHER OPENING COVER SHALL NOT BLOCK OR IMPEDE THE AUTOMATIC FLOW OF FLOOD WATER INTO OR OUT OF ENCLOSED AREA.

FLOOD OPENINGS SHALL NOT BE LESS THAN 3 INCHES IN ANY DIRECTION IN THE PLANE OF THE WALL ENCLOSED AREAS BELOW DESIGN FLOOD ELEVATION (+11.00' NGVD) SHALL BE

USED SOLELY FOR PARKING, BUILDING ACCESS OR STORAGE. THE BOTTOM OF EACH FLOOD OPENING SHALL BE NO HIGHER THAN 1.0 FT ABOVE THE HIGHER OF THE EXTERIOR OR INTERIOR GRADE OR FLOOR IMMEDIATELY BELOW THE OPENING. DISTANCE SHALL BE NOTED ON EXTERIOR ELEVATIONS SHEETS BELOW EACH OPENING. THE TOP OF THE FLOOD OPENING SHALL NOT BE ABOVE DFE, ANY PART OF THE FLOOD OPENING ABOVE THE DFE CANNOT BE COUNTED TOWARDS THE COMPLIANCE WITH THE FLOOD OPENING

PUBLIC WORKS NOTES

REQUIREMENTS.

RECONSTRUCT SWALE/SOD ALONG THE ENTIRE PROPERTY. MILL AND RESURFACE 2 INCHES AVERAGE USING TYPE S-III ASPHALT MIX DESIGN ON THE DRIVING LANE (10 FOOT WIDE) ALONG THE ENTIRE PROPERTY. ANY WORK AND/OR IMPROVEMENTS FROM/TO THE RIGHT-OF-WAY INCLUDING LANDSCAPING AND IRRIGATION REQUIRE A SEPARATE CMB PUBLIC WORKS

DEPARTMENT RIGHT-OF-WAY CONSTRUCTION PERMIT. ALL CONSTRUCTION AND/OR USE OF EQUIPMENT IN THE RIGHT-OF-WAY WILL REQUIRE A SEPARATE CITY OF MIAMI BEACH PUBLIC WORKS DEPARTMENT RIGHT-OF-WAY CONSTRUCTION PERMIT PRIOR TO START OF CONSTRUCTION.

PUBLIC WORKS-REMINDER NOTES

THE CONTRACTOR/PERMIT HOLDER SHALL EMPLOY AN EFFECTIVE INTEGRATED MOSQUITO MANAGEMENT PROGRAM UTILIZING BEST MANAGEMENT PRACTICES DURING THE ENTIRE TIME THE PERMIT IS IN EFFECT.

A CMB RIGHT OF WAY CONSTRUCTION PERMIT IS REQUIRED BEFORE STARTING ANY DEMOLITION AND/OR CONSTRUCTION ACTIVITY INSIDE RIGHT-OF-WAY. THE PUBLIC WORKS DEPARTMENT RECOMMENDS THAT THE SANITARY SEWER LATERAL BETWEEN PROPERTY LINE AND THE SANITARY SEWER MAIN BE REPLACED IN ALL SUBSTANTIAL IMPROVEMENT PROJECTS. AS A SUBJECTION CONTRACTOR TO DO A VIDEO INSPECTION OF THE SIX INCHES SANITARY SEWER LATERAL TO CONFIRM THE CONDITION OF THE PIPE AND PROVIDE TWO DIGITAL COPY FOR THE PUBLIC WORKS DEPARTMENT TO REVIEW AND TO CONFIRM THE CONDITION OF THE LATERAL PIPE.

CONCRETE DECORATIVE REQUIRE A CITY OF MIAMI BEACH RIGHT OF WAY PERMITS FOR CONCRETE DECORATIVE DRIVEWAY CONNECTION (PUBLIC WORKS MANUAL PART I / SECTION 2 / A / 4).


LANDSCAPE IMPROVEMENTS WITHIN THE RIGHT-OF-WAY REQUIRE PRELIMINARY APPROVALS FROM THE PUBLIC WORKS URBAN FORESTER PRIOR TO APPLYING FOR A PUBLIC WORKS DEPARTMENT RIGHT-OF-WAY CONSTRUCTION PERMIT.

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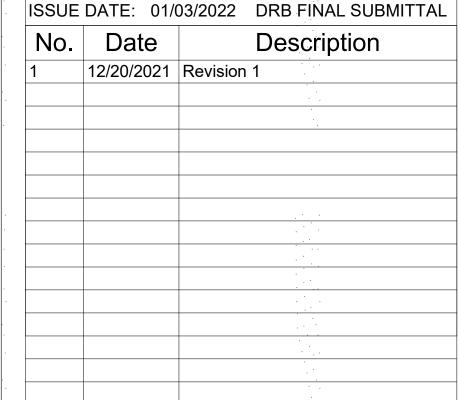
ZONING DATA SHEET



SITE NOTE:

- RECONSTRUCT THE SWALE ALONG THE ENTIRE PROPERTY.
- MILL AND RESURFACE 2" AVERAGE (USE TYPE S-III ASPHALT MIX DESIGN) AT THE DRIVING LANE (10' WIDE) ALONG THE ENTIRE PROPERTY.
- IMPROVEMENTS TO THE RIGHT-OF-WAY REQUIRES A SEPARATE CMB PUBLIC WORK DEPARTMENT PERMIT WITH CITY OF MIAMI BEACH CAPITALIMPROVEMENT PROJECTS OFFICE APPROVAL IN REGARDS TO PALM-HIBISCUS NEIGHBORHOOD IMPROVEMENTS PROJECT. USE THE CMB PUBLIC WORKS DEPARTMENT MANUAL FOR CMB UTILITIES AND/OR ANY IMPROVEMENT WITHTIN THE RIGHT-OF-WAY.
- ALL DOORS AND WINDOWS PROVIDING DIRECT ACCESS FROM THE HOME TO THE POOL SHALL BE EQUIPPED WITH AN ALARM COMPLYING WITH UL-2017 THAT HAS A MINIMUM SOUND PRESSURE RATING OF 85 DBA AT 10 FEET AS PER FBC R4101.17.1.9.1. AN ALARM WHICH PRODUCES AN AUDIBLE WARNING WHEN THE DOOR AND ITS SCREEN ARE OPENED. THE NORMAL HOUSEHOLD ACTIVITIES. THE ALARM SHALL AUTOMATICALLY RESET UNDER ALL CONDITIONS. THE ALARM SHALL BE EQUIPPED WITH A MANUAL MEANS TO TEMPORARILY THAN 15 SECONDS. THE DEACTIVATION SWITCH SHALL BE LOCATED AT LEAST 54 INCHES

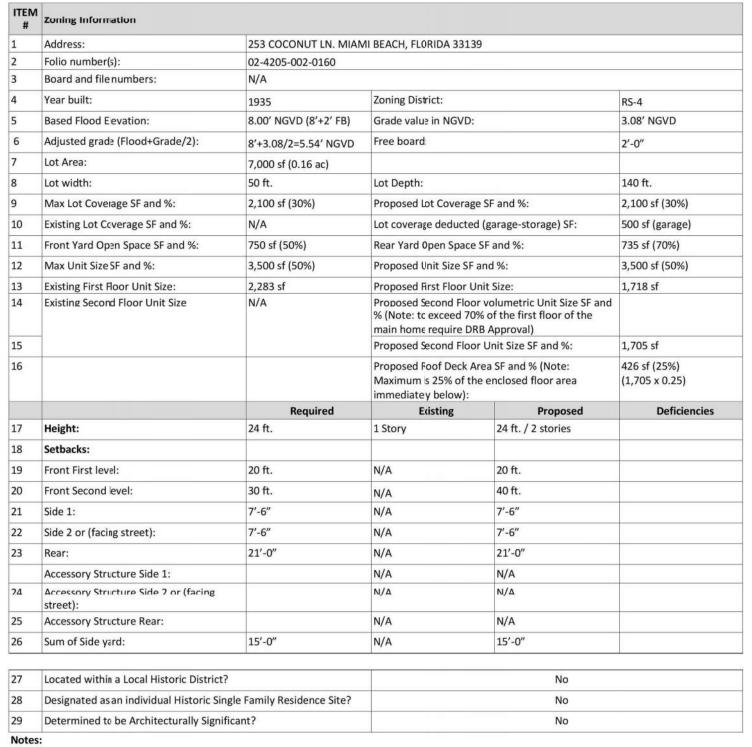
ALARM SHALL SOUND CONTINUOUSLY FOR A MINIMUM OF 30 SECONDS IMMEDIATELY AFTER THE DOOR IS OPENED AND BE CAPABLE OF BEING HEARD THROUGHOUT THE HOUSE DURING DEACTIVATE THE ALARM FOR A SINGLE OPENING. SUCH DEACTIVATION SHALL LAST NO MORE ABOVE THE THRESHOLD OF THE DOOR. VAPOR BARRIER 15 ml POLYETHYLENE VAPOR RETARDER W/JOINTS LAPPED NOT LESS THAN 6 INCHES, OR OTHER APPROVED EQUIVALENT METHODS OR MATERIALS. PROTECTION AGAINST TERMITES: R318.1 TERMITE PROTECTION SHALL BE PROVIDED BY REGISTERED TERMITICIDES, INCLUDING SOIL APPLIED PESTICIDES, BAITING SYSTEMS, AND PESTICIDES APPLIED TO WOOD. OR OTHER APPROVED METHODS OF TERMITE PROTECTION LABELED FOR USE AS A PREVENTATIVE TREATMENT TO NEW CONSTRUCTION (SEE SECTION 202, REGISTERED TERMITICIDE). UPON COMPLETION OF THE APPLICATION OF THE TERMITE PROTECTIVE TREATMENT, A CERTIFICATE OF COMPLIANCE SHALL BE ISSUED TO THE BUILDING DEPARTMENT BY THE LICENSED PEST CONTROL COMPANY THAT CONTAINS THE FOLLOWING STATEMENT: "THE BUILDING HAS RECEIVED A COMPLETE TREATMENT FOR THE PREVENTION OF SUBTERRANEAN TERMITES. TREATMENT IS IN ACCORDANCE WITH RULES AND LAWS ESTABLISHED BY THE FLORIDA DEPARTMENT OF AGRICULTURE AND CONSUMER REFER TO LANDSCAPE DRAWINGS FOR PLANTS SPECS, DIMENSIONS, IRRIGATION LAYOUT AND DETAILS. REFER TO CIVIL DRAWINGS FOR DRAINAGE LAYOUT AND CALCULATION. SEE LANDSCAPE DRAWINGS FOR: TREE MITIGATION/RELOCATION, LANDSCAPE SOFTSCAPE AND HARDSCAPE LAYOUT. ALL YARDS SHALL BE SLOPED TO RETAIN ALL STORMWATER ON SITE, AND SHALL NOT DRAIN ONTO ADJACENT PROPERTIES. CONTRACTOR SHALL REQUEST VERIFICATIONS AND LOCATION MARKINGS FROM UTILITY COMPANIES FOR ALL UNDERGROUND UTILITY SERVICES PRIOR TO BEGINNING ANY CONTRACTOR IS RESPONSIBLE FOR PROVIDING SURVEYOR SITE LAYOUT OF ALL FOUNDATIONS AND STRUCTURE LOCATIONS, IN ADDITION TO SITE GRADE ELEVATION ALL DOWNSPOUTS, STORM DRAINS, FOOTING, AND FOUNDATION DRAINS SHALL BE CONNECTED TO THE STORM DRAINAGE SYSTEM AS INDICATED IN CIVIL DWGS. DOWNSPOUTS SHALL BE TIGHT LINED SEPARATE FROM FOUNDATION DRAINS. SHOULD ANY UNUSUAL CONDITIONS BECOME APPARENT DURING GRADING, TRENCHING, FOUNDATION WORK, ETC. CONTRACTOR SHALL CONTACT OWNER AND ARCHITECT FOR INSTRUCTIONS PRIOR TO CONTINUATION OF WORK. THE GEOTECHNICAL REPORTS FOR THE SITE PROVIDED BY THE OWNER SHALL BE PART OF THE CONSTRUCTION AND CONTRACT DOCUMENTS. SLOPE ALL DECKS, WALKWAYS, DRIVEWAYS, IMPERVIOUS GRADE, AND PATIOS AWAY FROM BUILDINGS AT 2% MAXIMUM. PERVIOUS GRADE AREAS SHALL SLOPE AWAY FROM THE BUILDING AS INDICATED IN CIVIL GRADING PLAN. GC TO PROVIDE A SWIMING POOL ALARM THAT, WHEN PLACED IN A POOL, SOUNDS AN ALARM UPON DETECTION OF AN ACCIDENTAL OR UNAUTHORIZED ENTRANCE INTO THE WATER. REFER TO 2016 FLORIDA STATUTES, CHAPTER 515. 7' - 0" 21' - 0" REAR SETBACK (15% LOT DEPTH) 5' - 4" 34' - 3" 8' - 2" 7' - 6" POOL SETBACK




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Project Name


CASA BAHIA


253 N COCONUT LN MIAMI BEACH, FLORIDA, 33139 FOLIO # 02-4205-002-0160

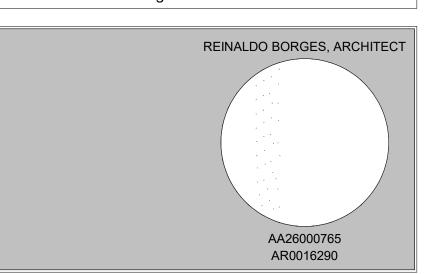Project Number 21-3600 **Drawing Name** SITE PLAN

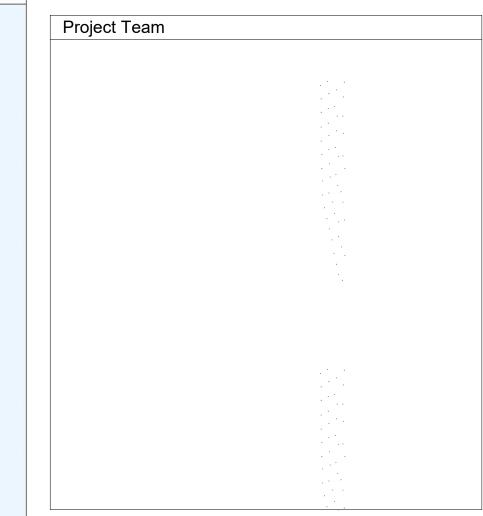Scale:

1/8" = 1'-0"

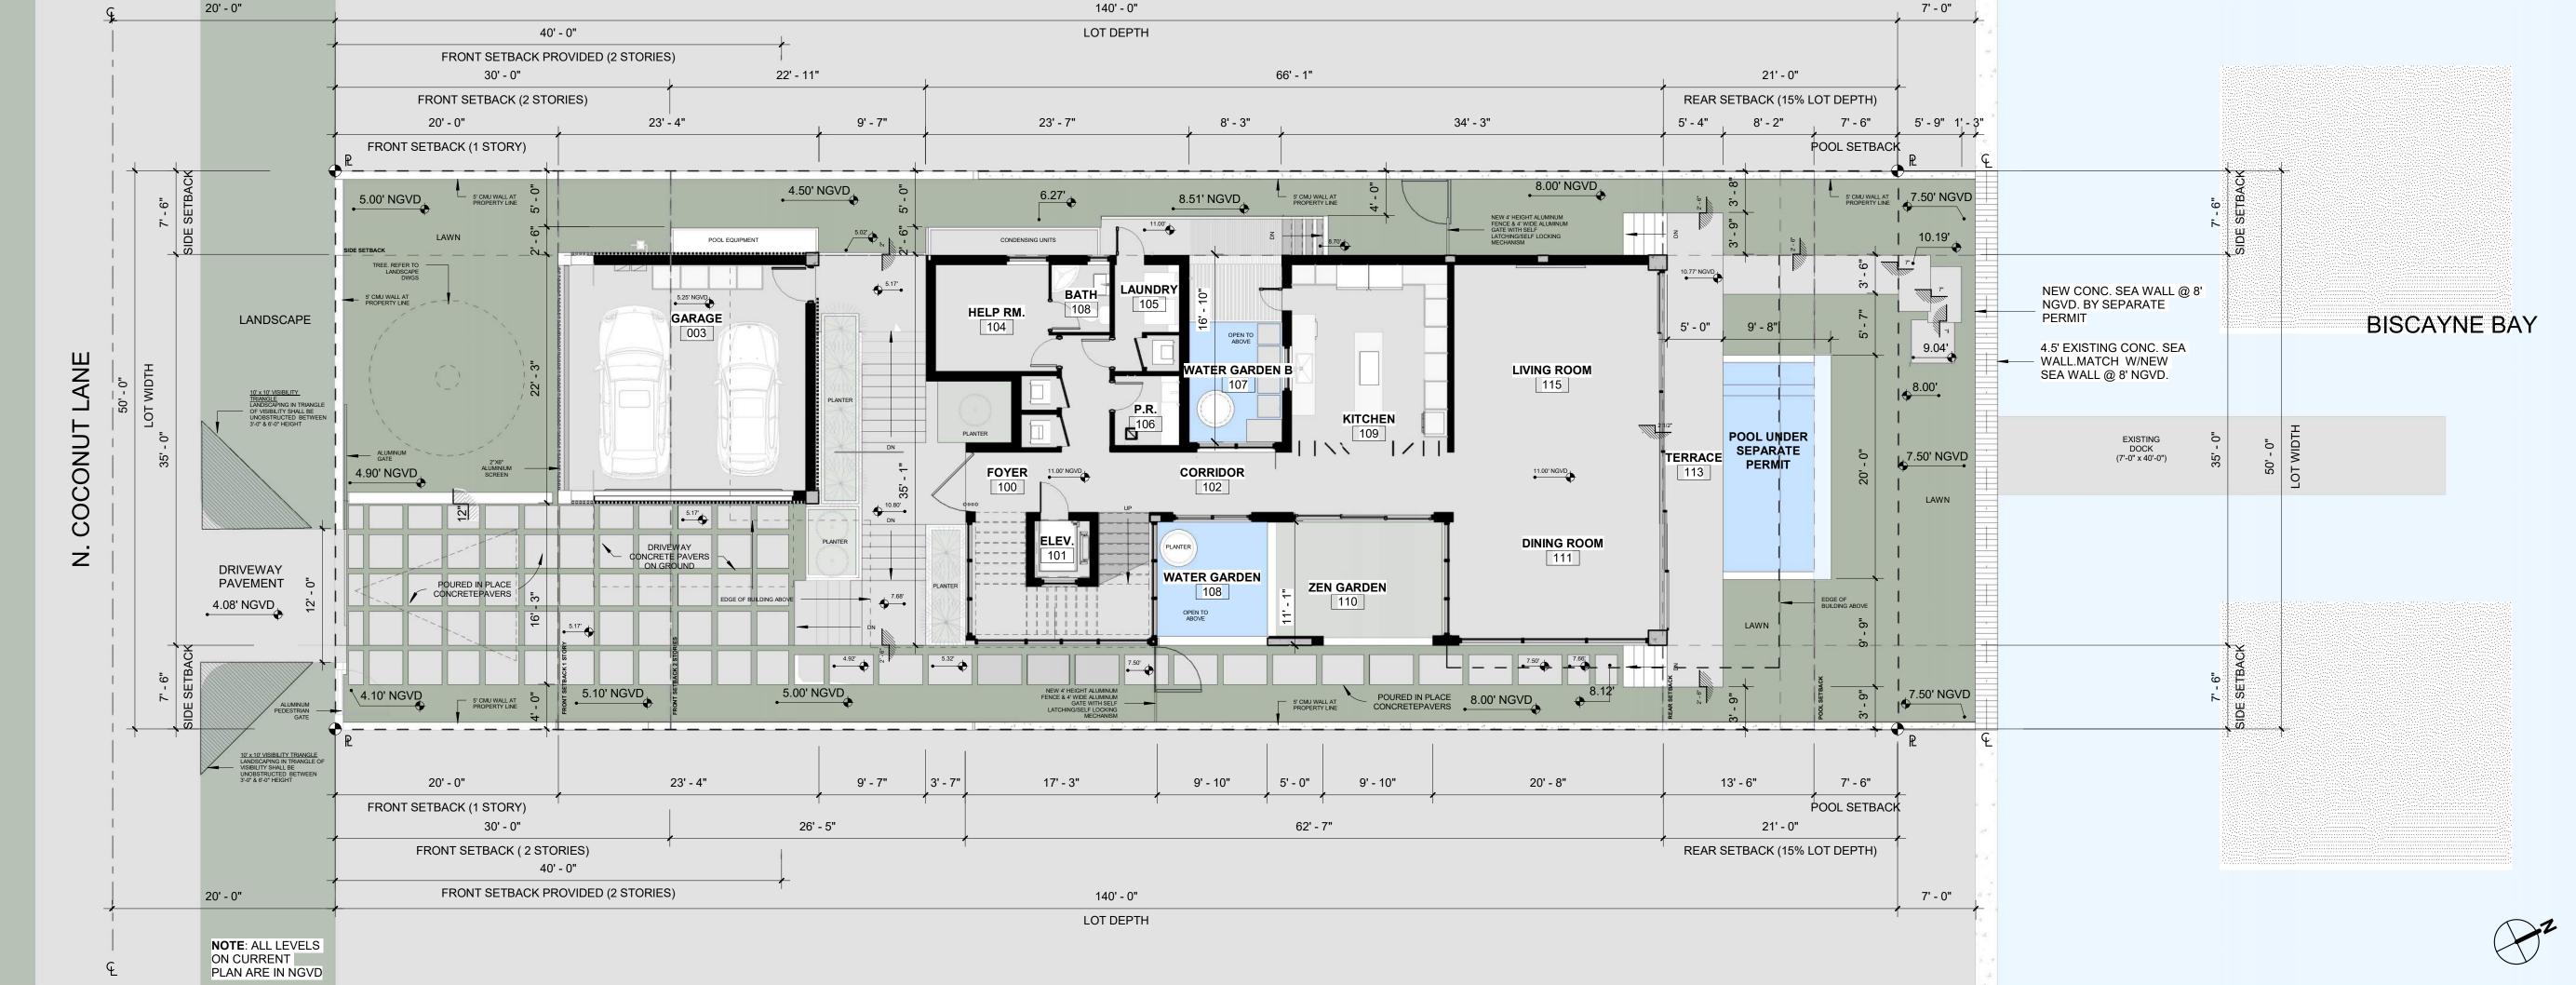

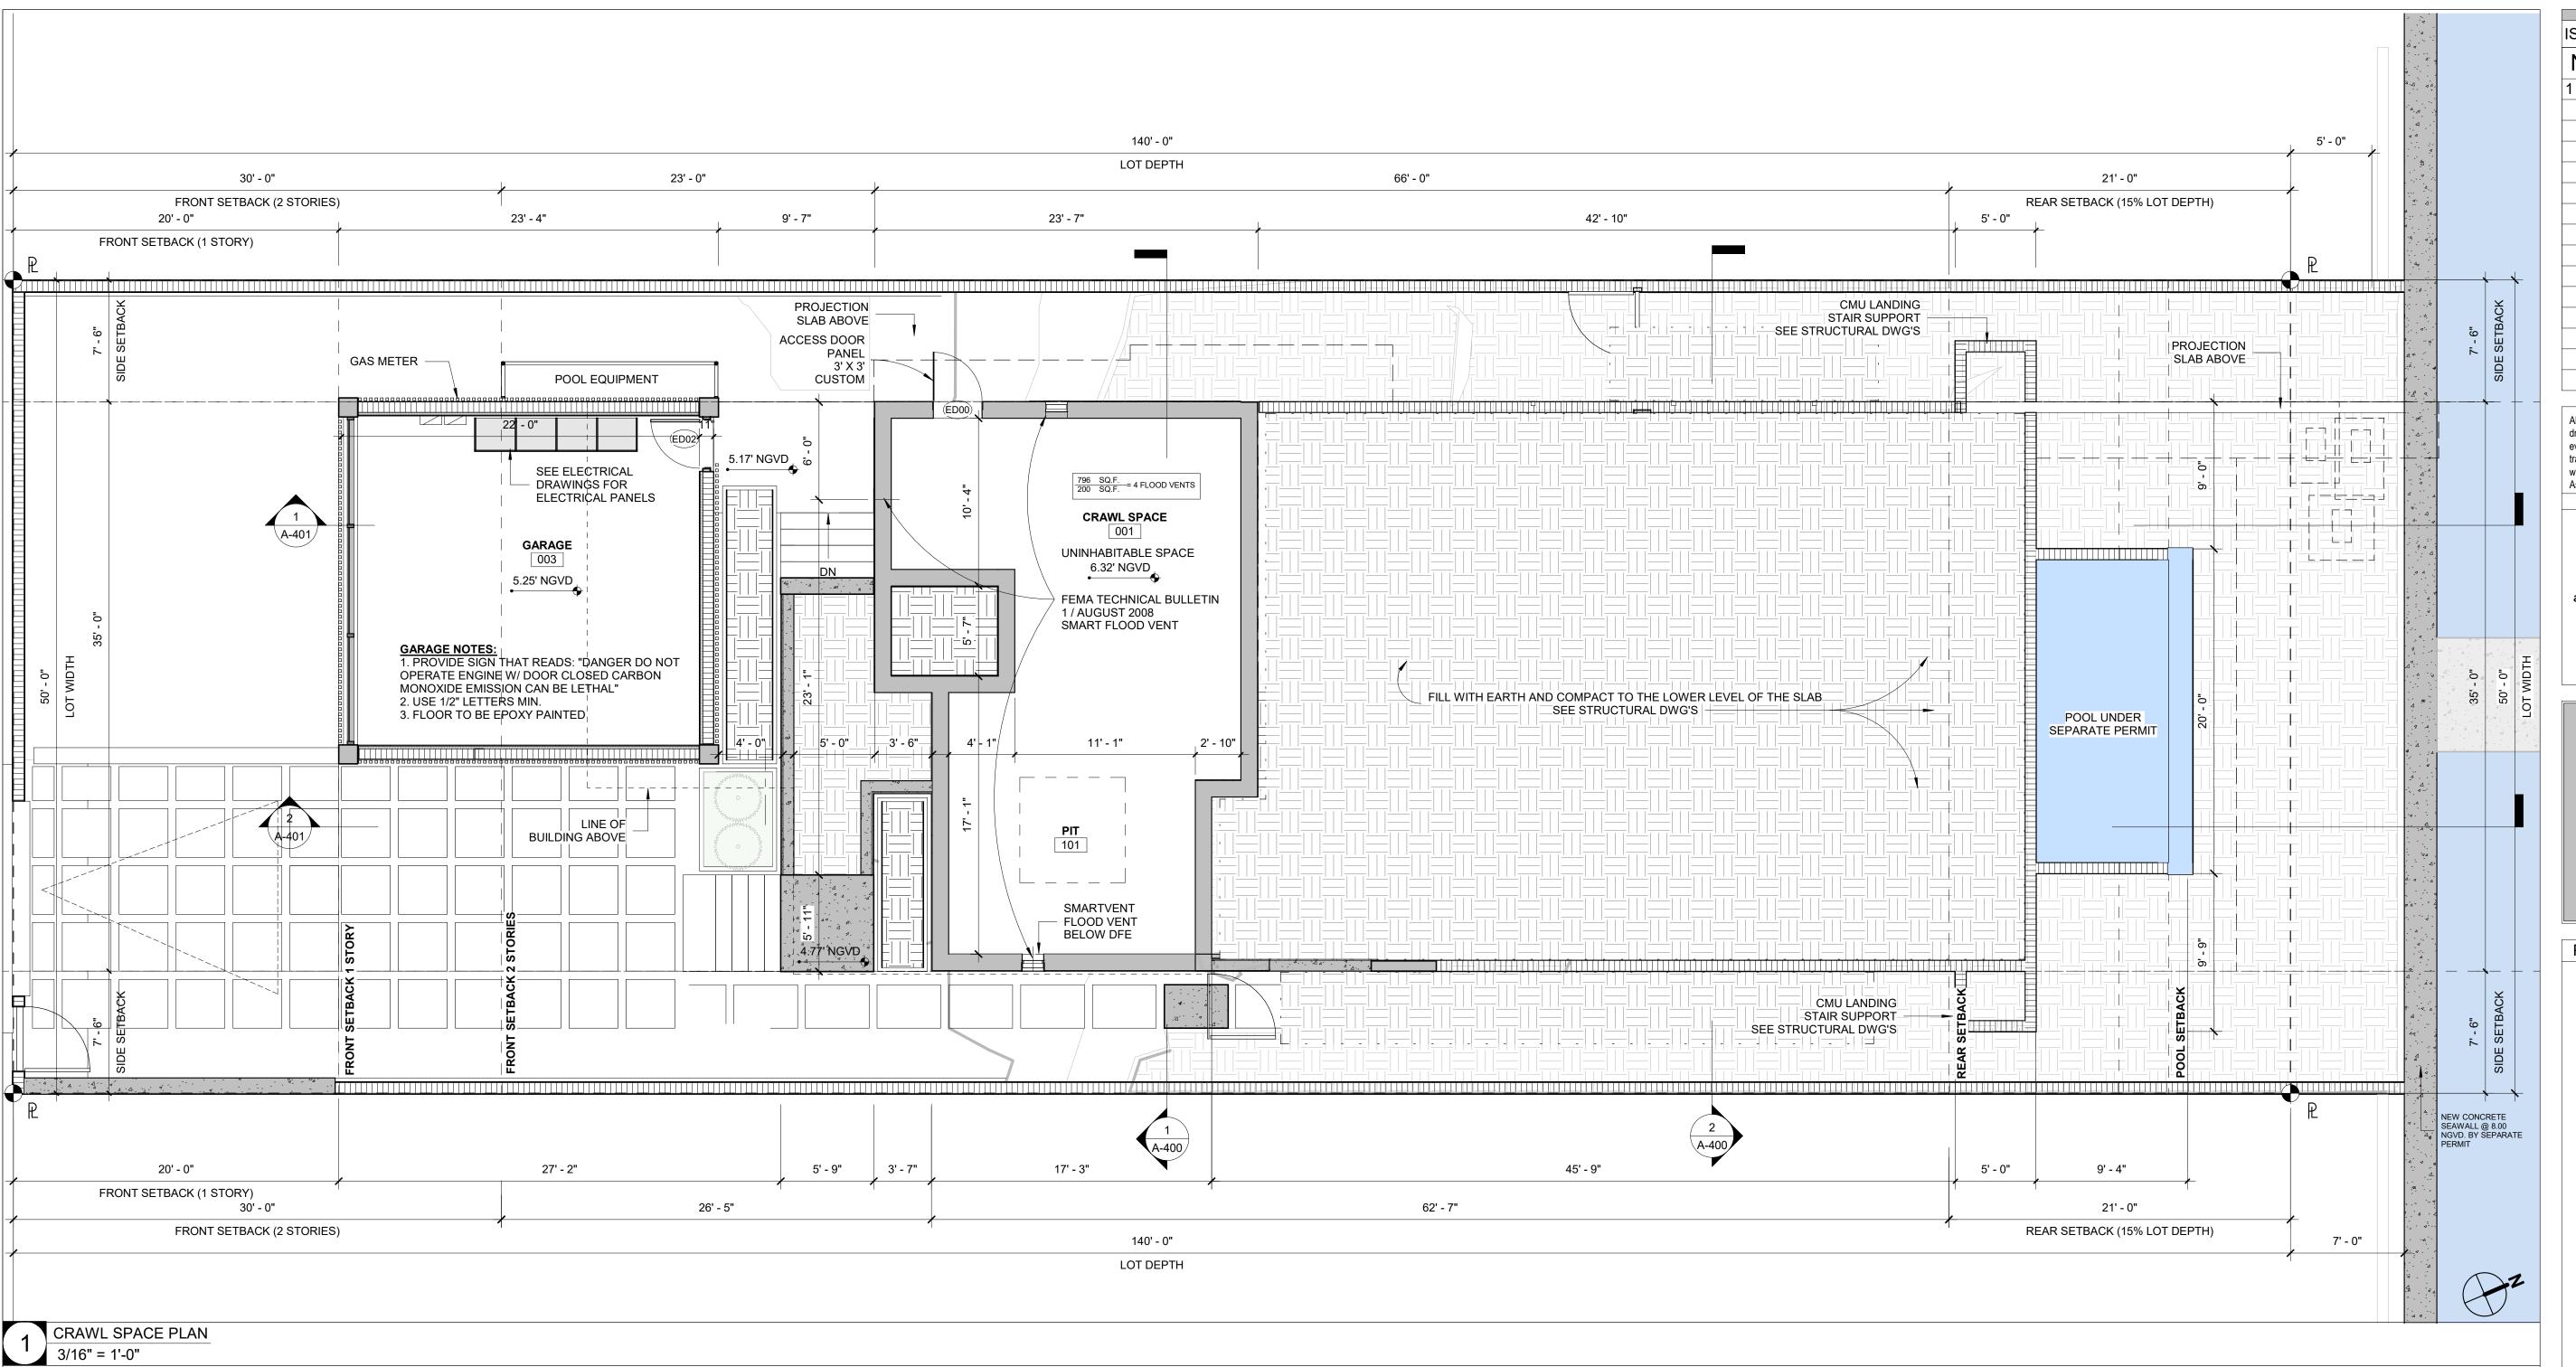

FLOOD NOTES:

OUT OF ENCLOSED AREA.

THE PLANE OF THE WALL

WITH THE FLOOD OPENING REQUIREMENTS.

FLOOD OPENINGS WILL PROVIDE EQUALIZATION OF HYDROSTATIC FLOOD

FORCES ON EXTERIOR WALLS BY ALLOWING FOR THE AUTOMATIC ENTRY

AND EXIT OF FLOODWATER AS SPECIFIED IN FBC R322.2.2 AND ASCE 24.

FLOOD OPENINGS LOUVERS, SCREEN OR OTHER OPENING COVER SHALL

NOT BLOCK OR IMPEDE THE AUTOMATIC FLOW OF FLOOD WATER INTO OR

FLOOD OPENINGS SHALL NOT BE LESS THAN 3 INCHES IN ANY DIRECTION IN

THE BOTTOM OF EACH FLOOD OPENING SHALL BE NO HIGHER THAN 1.0 FT.

ABOVE THE HIGHER OF THE EXTERIOR OR INTERIOR GRADE OR FLOOR

EXTERIOR ELEVATIONS SHEETS BELOW EACH OPENING. THE TOP OF THE

MATERIALS BELOW DFE (11' NGVD) SHALL BE FLOOD-DAMAGE RESISTANT

PER FEMA TECHNICAL BULLETIN 2, MATERIALS CLASS 4 AND 5.

OPENING ABOVE THE DFE CANNOT BE COUNTED TOWARDS THE COMPLIANCE

FLOOD OPENING SHALL NOT BE ABOVE DFE, ANY PART OF THE FLOOD

IMMEDIATELY BELOW THE OPENING. DISTANCE SHALL BE NOTED ON

FLOOR PLAN NOTES


- GC TO PROVIDE MIAMI D.C. PRODUCT CONTROL APPROVAL FOR IMPACT RESISTANT EXTERIOR DOOR AND WINDOWS. ALL BEDROOMS SHALL HAVE 'EGRESS' TYPE DOORS OR WINDOWS, U.O.N. REFER TO DOOR / WINDOW SCHEDULE. THE EGRESS WINDOW SHALL BE OPERABLE FROM THE INSIDE WITHOUT THE USE OF TOOLS AND PROVIDING A CLEAR OPENING OF NOT LESS THAN 20" IN WIDTH, 24" IN HEIGHT, AND 5.7 SQ.FT. IN AREA. THE BOTTOM OF THE OPENING SHALL NOT BE MORE THAN 44" OFF THE FLOOR. THE MODE OF OPERATION DOES NOT REQUIRE THE USE OF A KEY, TOOL, SPECIAL KNOWLEDGE, OR EFFORT TO MAKE AVAILABLE THE REQUIRED CLEAR OPENING, AND NO PART OF THE MECHANISM SHALL BE PLACED HIGHER THAN 54" ABOVE THE FINISHED FLOOR.
- GENERAL CONTRACTOR TO VERIFY AND COORDINATE ACTUAL WINDOW DIMENSIONS AND ROUGH OPENINGS PRIOR TO CONSTRUCTION.
- ANY CHANGE OF INTERIOR FINISHES BY OWNER/G.C. SHALL BE COORDINATED WITH ARCHITECT OF RECORD.
- INTERIOR / EXTERIOR PARTITION FRAMING, SIZING AND REINFORCING TO BE BY SPECIALTY ENGINEERING. BATH DOORS SHALL BE OPERABLE FROM OUTSIDE IN EMERGENCY SITUATIONS.
- CLOSET DOORS SHALL BE OPERABLE BY CHILDREN FROM INSIDE.
- SEPARATE PERMIT REQUIRED FOR ROOFING, RAILINGS, WINDOWS AND DOORS. FOR SECURITY ENTRY NOTES REFER TO BUGLARY NOTES SHEET A-003.
- SHOWERS. SHOWER COMPARTMENTS SHALL HAVE FLOORS AND WALLS CONSTRUCTED OF SMOOTH, CORROSION RESISTANT AND NONABSORBENT WATER-RESISTANT MATERIALS TO A HEIGHT OF NOT LESS THAN 70 INCHES (1778 MM) ABOVE THE COMPARTMENT FLOOR AT THE DRAIN.
- 11. SHOWER PANS SHOULD BE WATERPROOFED A MIN. OF 12" UP EACH PERIMETER WALL.
- WINDOWS AT LESS THAN 4FT. FROM DOORS SHALL HAVE CAT. II GLAZING PER FBC SEC. R4410.2.4.3.2
- WHEN THERE IS A DROP OF LESS THAN 4 FT. ON EITHER SIDE OF A WINDOW IT SHALL COMPLY WITH FBC SEC R4410.2.4.2 AND R4403.7.3.1 ALL SHOWER ENCLOSURES AND ANY GLAZING WITHIN 60" OF THE FINISHED FLOOR SURFACE IN WALLS SURROUNDING ANY TUB OR SHOWER ENCLOSURE SHALL BE CAT. II SAFETY GLASS PER FBC 2010 R4410.2.6.2 SAFEGUARDS.
- ALL GLASS RAILINGS TO COMPLY WITH FBC SEC. R4403.7.3.6
- GC TO REFER TO INTERIOR DESIGN DRAWINGS FOR CLARIFICATION OF ALL FINISHES AND RELATED DETAILS.
- ALL FINISHES TO BE SELECTED BY OWNER/INTERIOR DESIGNER.
- ALL FINISH HARDWARE TO BE SELECTED BY OWNER/INTERIOR DESIGNER.
- SEE INTERIOR DESIGN FOR ALL BATH ACCESSORIES. GC TO PROVIDE BACKING AS NECESSARY. REFER TO INTERIOR DESIGN DRAWINGS FOR LOCATIONS OF MILLWORK AND OTHER BUILT-IN FURNITURE. PROIVDE PROPER BACKING AS
- NECESSARY. FINISH DIMENSIONS SUBJECT TO CHANGE. REFER TO INTERIOR DESIGN DRAWINGS FOR FINAL DIMENSIONS AND NOTIFY ARCHITECT OF ANY
- CONFLICTS. WALL AND CEILING FINISHES SHALL HAVE A FLAME-SPREAD CLASSIFICATION OF NOT GREATER THAN 200 AND A SMOKE-DEVELOPED INDEX NOT GREATER THAN 450 AS PER ASTM E-84 OR UL 273. FBCR 302.9.
- INSULATION MATERIALS, FACINGS, VAPOR RETARDERS SHALL HAVE A FLAME-SPREAD CLASSIFICATION OF NOT GREATER THAN 25 AND A SMOKE-DEVELOPED INDEX NOT GREATER THAN 450 AS PER ASTM E-84 OR UL 273. FBCR 302.10 ALL ELEVATIONS ARE BASED UPON NATIONAL GEODETIC VERTICAL DATUM 1929 (NGVD 1929). ALL ELEVATIONS IN RCPs ARE RELATIVE TO
- GC TO COORDINATE FINAL LOCATION OF ACCESS HATCH WITH MECHANICAL EQUIPMENT AND NOTIFY ARCHITECT OF ANY CONFLICTS.
- GC TO VERIFY SPACE REQUIRED FOR VERTICAL AIR DIFFUSERS AND RETURNS IN COVES.

ISSUE DATE: 01/03/2022 DRB FINAL SUBMITTAL Description 12/20/2021 Revision 1

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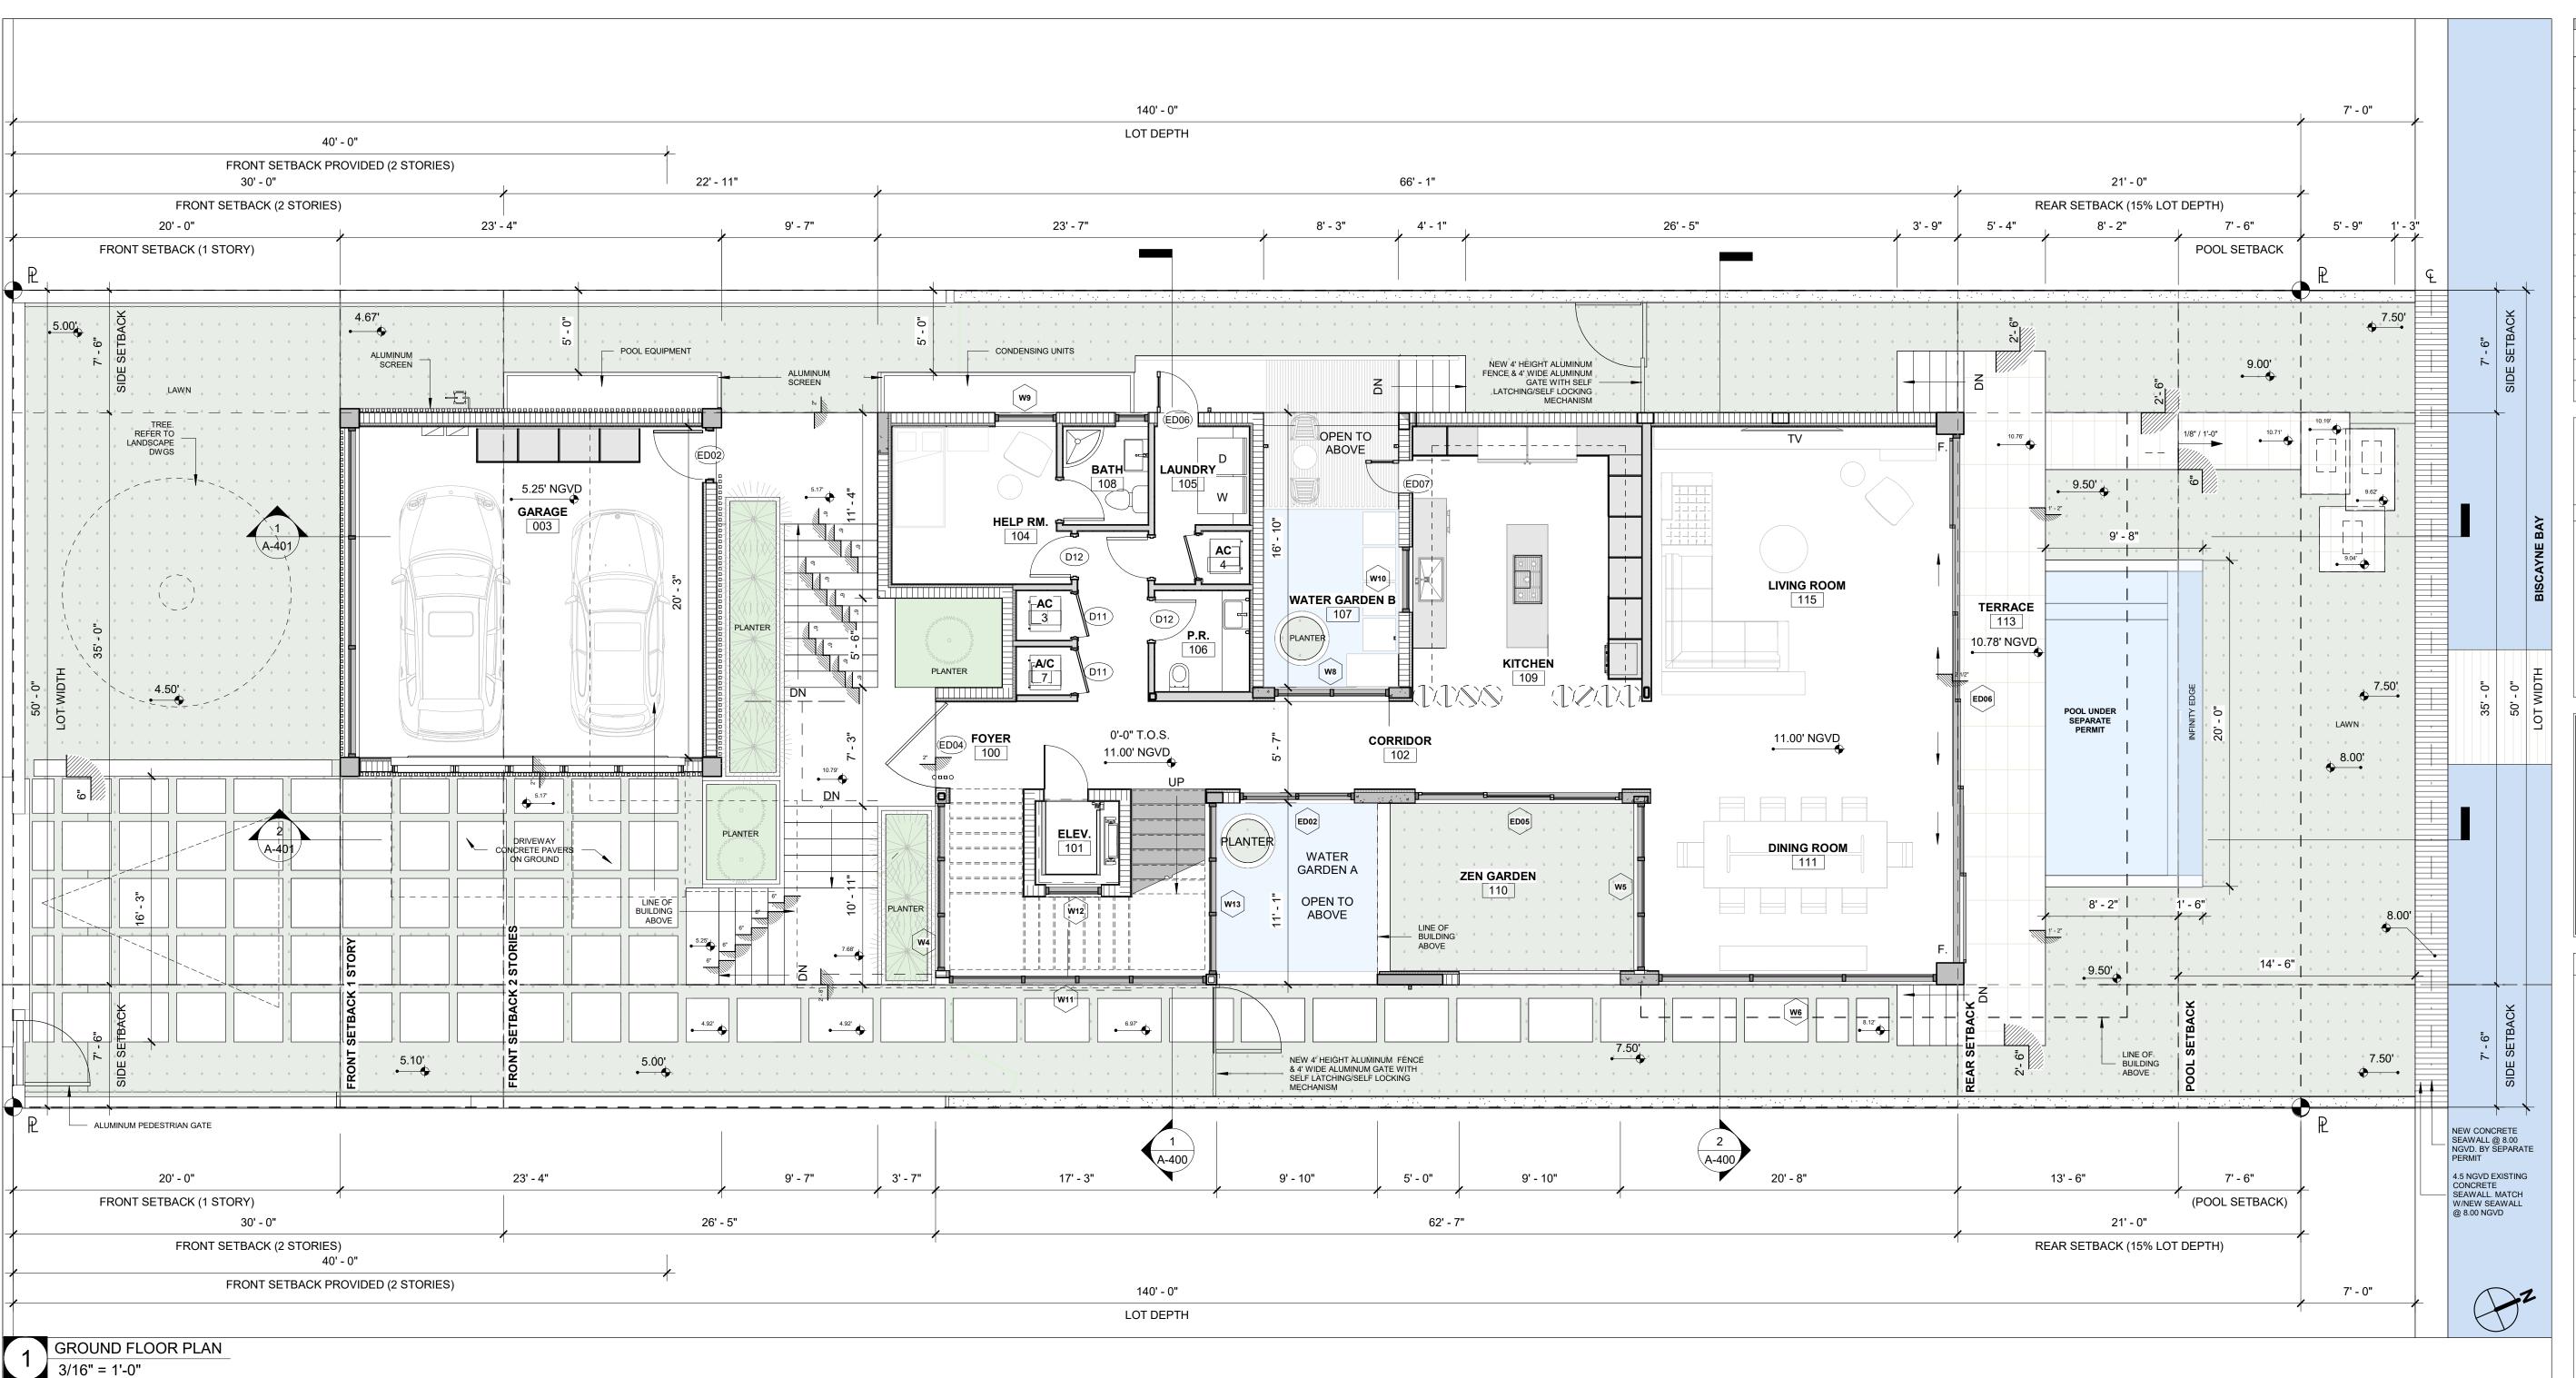
Project Name

CASA BAHIA

253 N COCONUT LN MIAMI BEACH, FLORIDA, 33139 FOLIO # 02-4205-002-0160

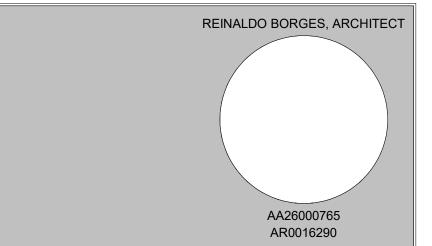21-3600 Project Number Drawing Name

Scale:




FLOOD NOTES:

- FLOOD OPENINGS WILL PROVIDE EQUALIZATION OF HYDROSTATIC FLOOD FORCES ON EXTERIOR WALLS BY ALLOWING FOR THE AUTOMATIC ENTRY
- AND EXIT OF FLOODWATER AS SPECIFIED IN FBC R322.2.2 AND ASCE 24. FLOOD OPENINGS LOUVERS, SCREEN OR OTHER OPENING COVER SHALL NOT BLOCK OR IMPEDE THE AUTOMATIC FLOW OF FLOOD WATER INTO OR OUT OF ENCLOSED AREA.
- FLOOD OPENINGS SHALL NOT BE LESS THAN 3 INCHES IN ANY DIRECTION IN THE PLANE OF THE WALL
- THE BOTTOM OF EACH FLOOD OPENING SHALL BE NO HIGHER THAN 1.0 FT. ABOVE THE HIGHER OF THE EXTERIOR OR INTERIOR GRADE OR FLOOR IMMEDIATELY BELOW THE OPENING. DISTANCE SHALL BE NOTED ON EXTERIOR ELEVATIONS SHEETS BELOW EACH OPENING. THE TOP OF THE FLOOD OPENING SHALL NOT BE ABOVE DFE, ANY PART OF THE FLOOD OPENING ABOVE THE DFE CANNOT BE COUNTED TOWARDS THE COMPLIANCE WITH THE FLOOD OPENING REQUIREMENTS.
- MATERIALS BELOW DFE (11' NGVD) SHALL BE FLOOD-DAMAGE RESISTANT PER FEMA TECHNICAL BULLETIN 2, MATERIALS CLASS 4 AND 5.

FLOOR PLAN NOTES


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Project Name

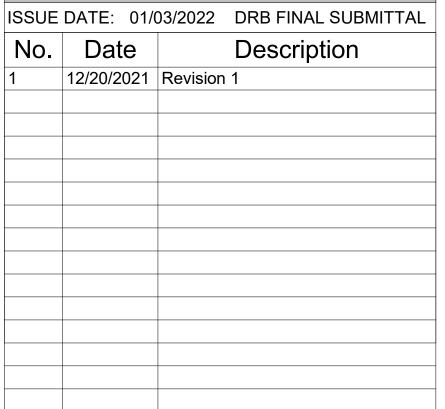
CASA BAHIA

253 N COCONUT LN MIAMI BEACH, FLORIDA, 33139 FOLIO # 02-4205-002-0160

Project Number 21-3600 Drawing Name **GROUND FLOOR PLAN**

Scale: Drawing Number

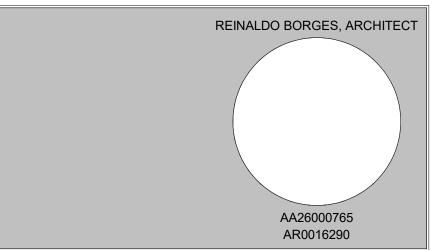As indicated

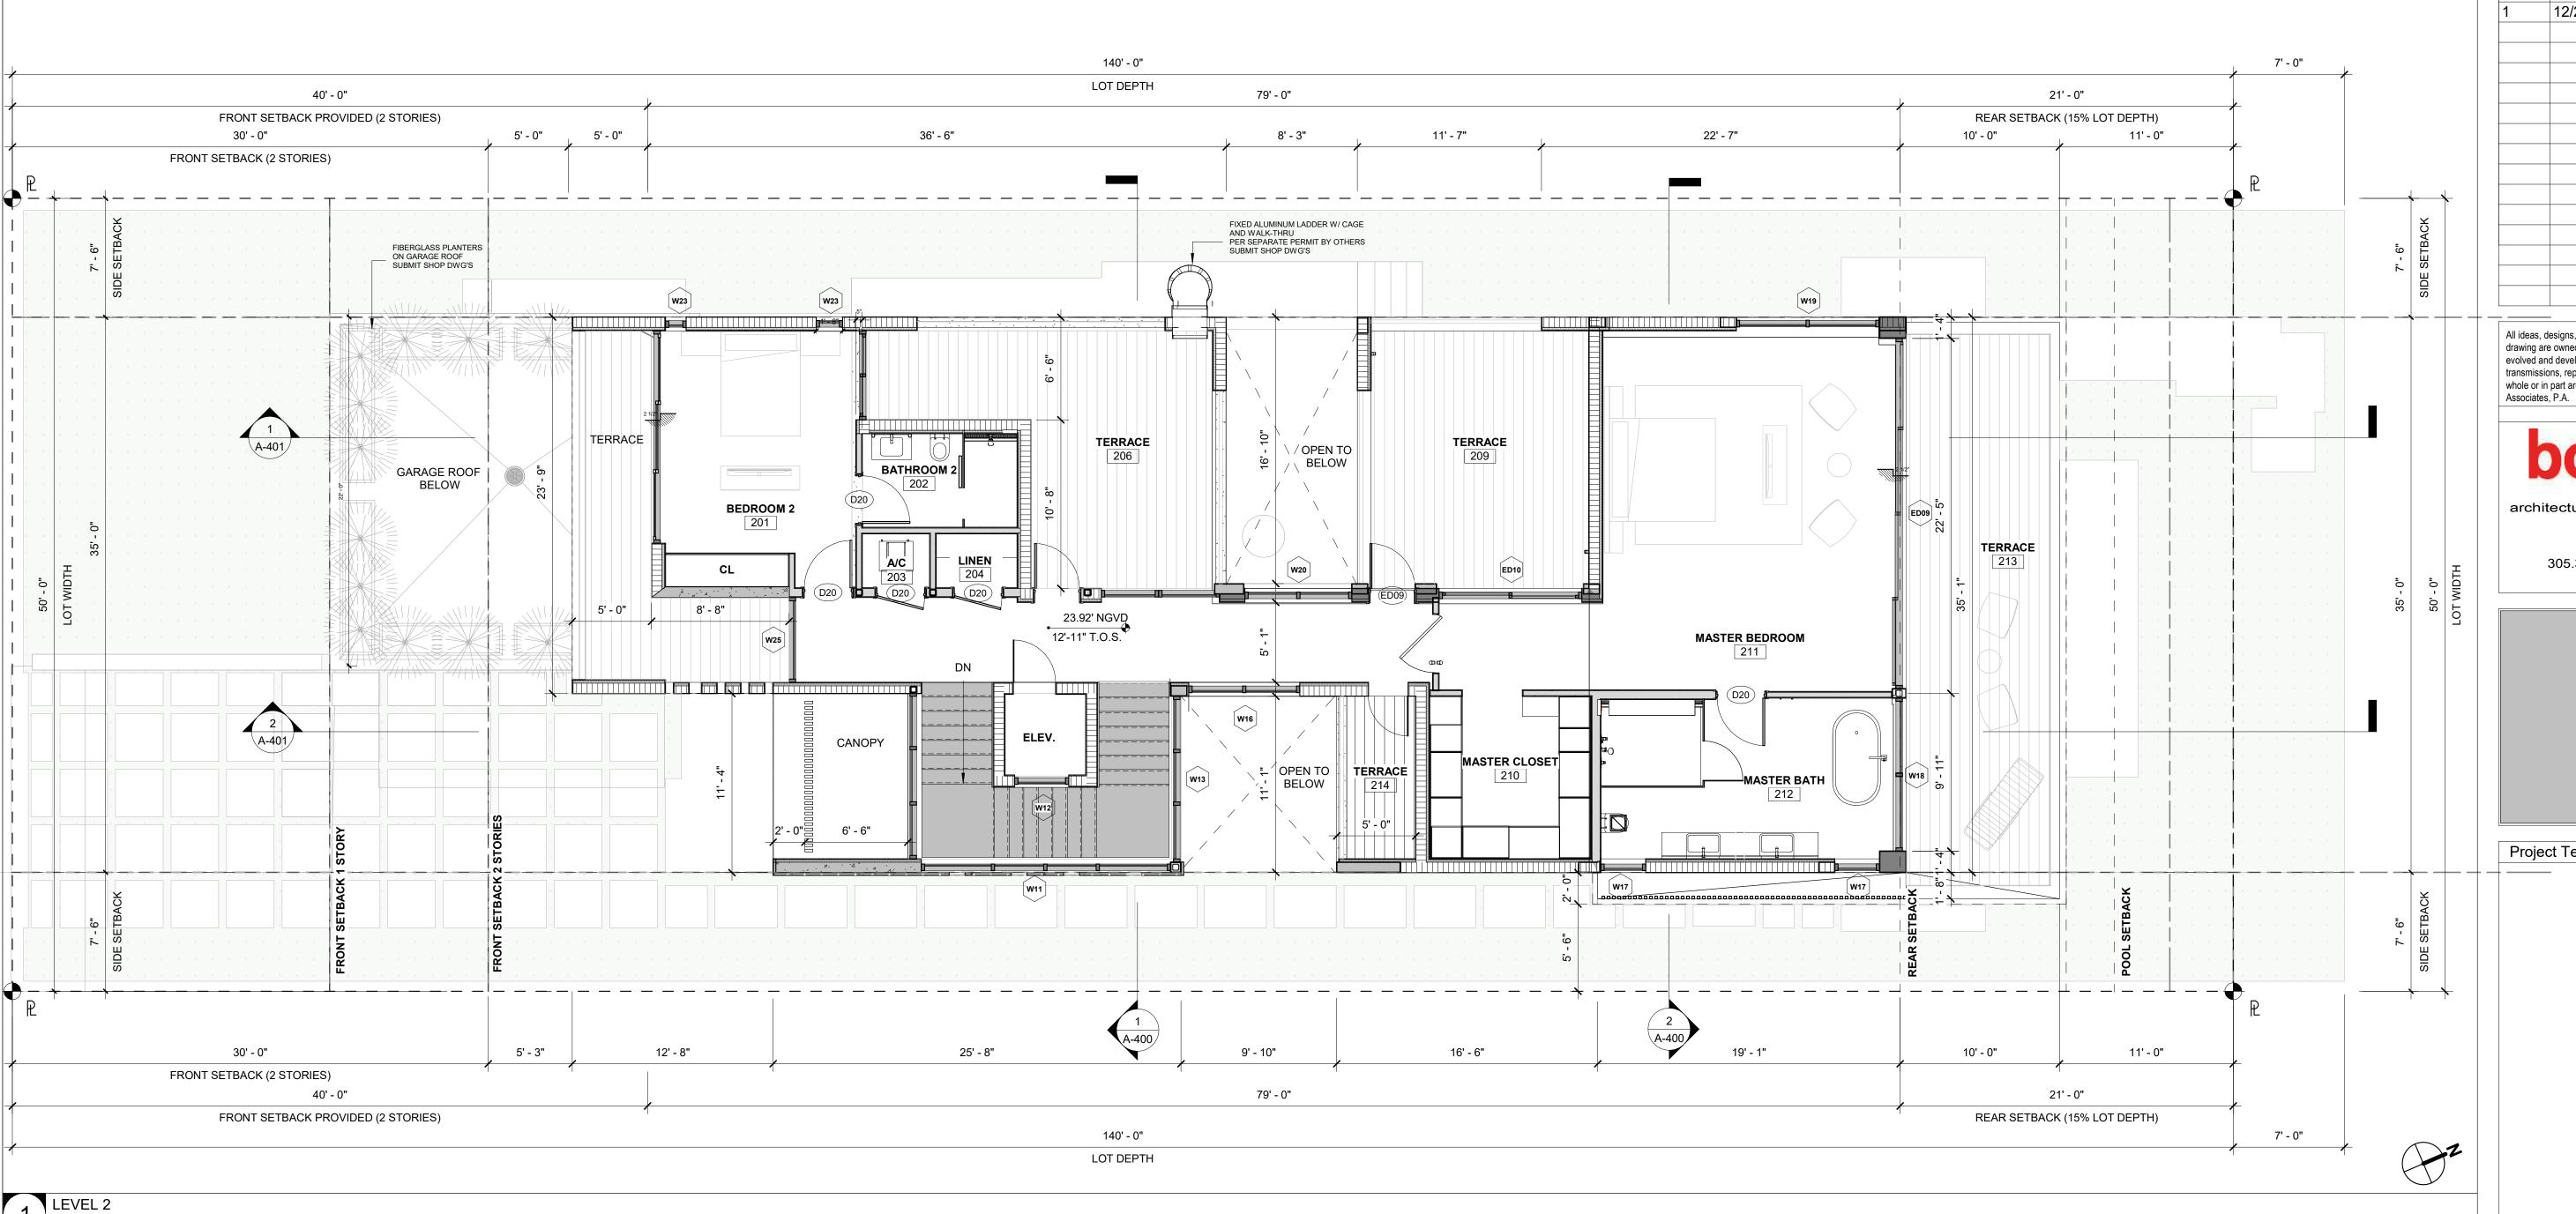

3/16" = 1'-0"

FLOOD NOTES:

ENCLOSED AREA.

- FLOOD OPENINGS WILL PROVIDE EQUALIZATION OF HYDROSTATIC FLOOD FORCES ON EXTERIOR WALLS BY ALLOWING FOR THE AUTOMATIC ENTRY AND
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- MATERIALS BELOW DFE (11' NGVD) SHALL BE FLOOD-DAMAGE RESISTANT PER FEMA TECHNICAL BULLETIN 2, MATERIALS CLASS 4 AND 5.

FLOOR PLAN NOTES

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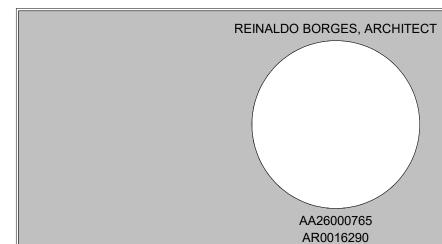
ISSUE DATE: 01/03/2022 DRB FINAL SUBMITTAL

12/20/2021 Revision 1

Description

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Project Team

Project Name


CASA BAHIA

253 N COCONUT LN MIAMI BEACH, FLORIDA, 33139 FOLIO # 02-4205-002-0160

21-3600 Project Number Drawing Name LEVEL 2 - FLOOR PLAN

Scale:

As indicated

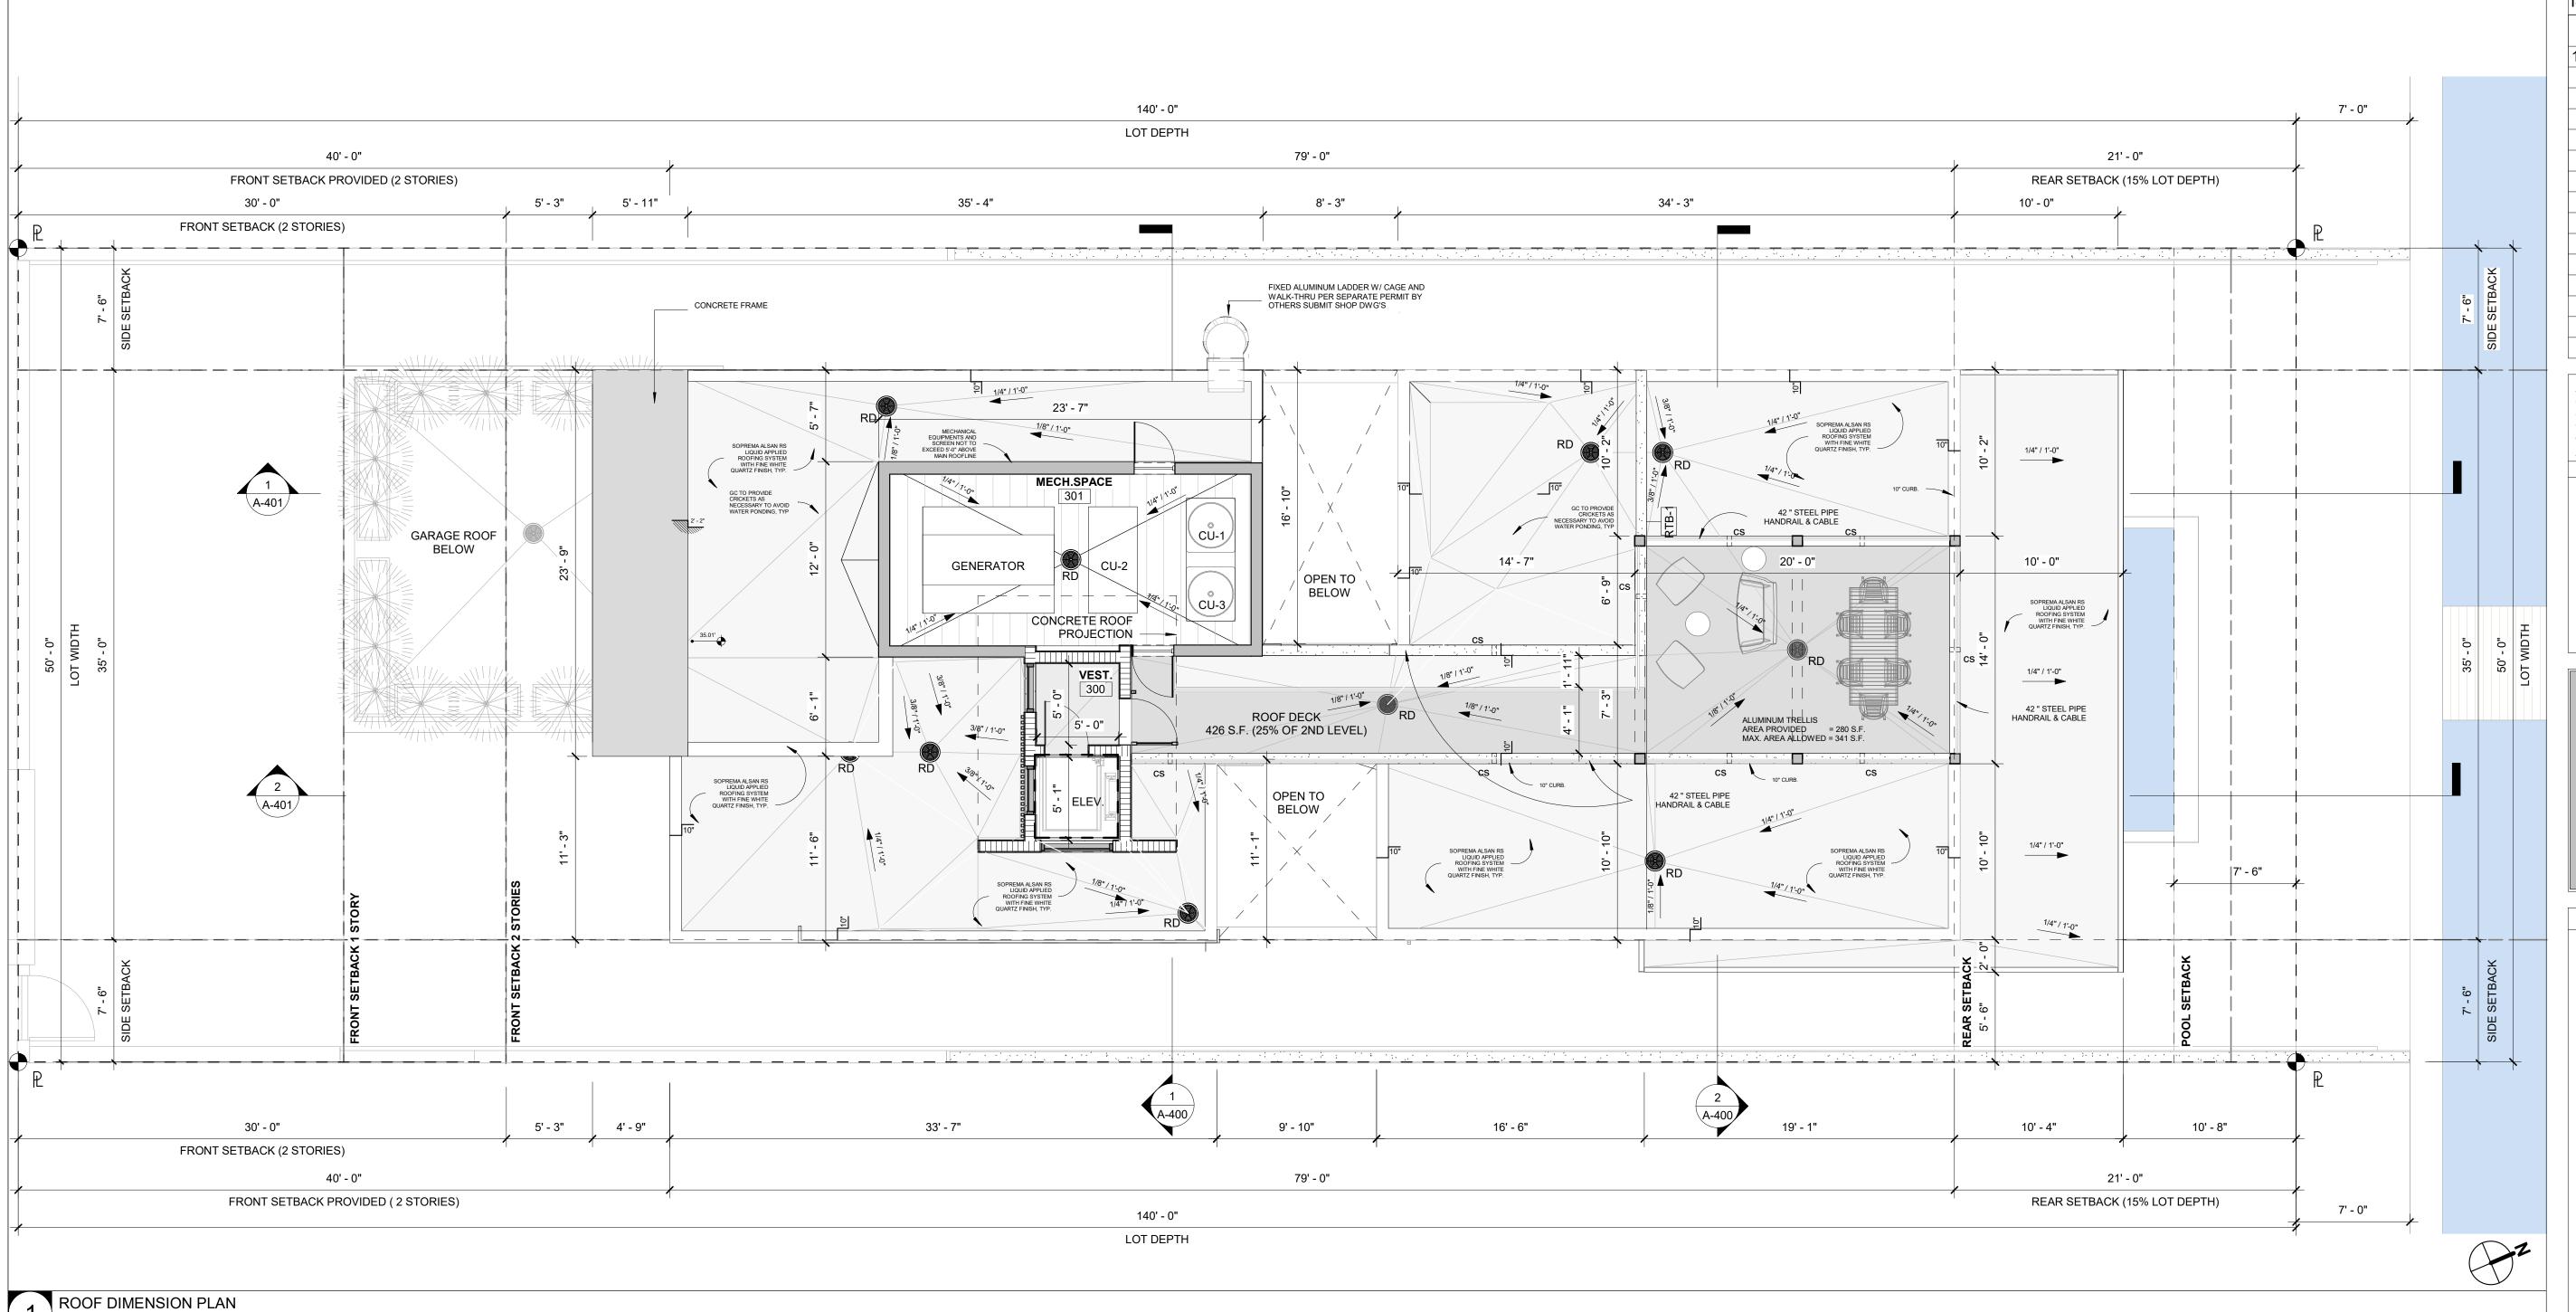

3/16" = 1'-0"

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- MATERIALS BELOW DFE (11' NGVD) SHALL BE FLOOD-DAMAGE RESISTANT PER FEMA TECHNICAL BULLETIN 2, MATERIALS CLASS 4 AND 5.

ROOF NOTES:

- CLOSED CELL ICYNENE SPRAYED FOAM INSULATION OR SIMILAR APPROVED. PROVIDE OVERCOAT INTUMESCENT. MUST BE SEPARATED FROM THE INTERIOR OF THE BUILDING BY AN APPROVED THERMAL BARRIER SUCH A S 1/2- INCH GYPSUM WALLBOARD INSTALLED USING MECHANICAL FASTENERS IN ACCORDANDE WITH APPLIACABLE CODE OR AN EQUIVALENT 15-MINUTE THERMAL BARRIER. GC TO INSTALL PRODUCT AS PER MANUFACTURER SPECIFICATIONS. INSTALL UNDER ROOF SLABS OVER ALL INHABITABLE AREAS. R-30 MIN. TYP.
- ALL ROOF TO BE COVERED WITH LIQUID APPLIED SOPREMA ALSAN RS ROOFING SYSTEM WITH FINE WHITE QUARTZ FINISH OR APPROVED
- ALL ROOFING AND WATERPROOFING DIAGRAMS AND DETAILS TO BE USED IN CONJUNCTION WITH SOPREMA'S GENERAL REQUIREMENTS. APPLICATION METHODS, COUNTY APPROVALS AND APPROVED DETAILS.
- CONTACT THE ARCHITECT SHOULD ANY DISCREPANCY ARISE. COORDINATE FINAL LOCATION OF ROOF PENETRATIONS WITH ARCHITECT AND MEP DRAWINGS.
- ALL ELEVATIONS ARE BASED UPON NATIONAL GEODETIC VERTICAL DATUM 1929 (NGVD 1929).

FLOOR PLAN NOTES


- GC TO PROVIDE MIAMI D.C. PRODUCT CONTROL APPROVAL FOR IMPACT RESISTANT EXTERIOR DOOR AND WINDOWS. ALL BEDROOMS SHALL HAVE 'EGRESS' TYPE DOORS OR WINDOWS, U.O.N. REFER TO DOOR / WINDOW SCHEDULE. THE EGRESS WINDOW SHALL BE OPERABLE FROM THE INSIDE WITHOUT THE USE OF TOOLS AND PROVIDING A CLEAR OPENING OF NOT LESS THAN 20" IN WIDTH, 24" IN HEIGHT, AND 5.7 SQ.FT. IN AREA. THE BOTTOM OF THE OPENING SHALL NOT BE MORE THAN 44" OFF THE FLOOR. THE MODE OF OPERATION DOES NOT REQUIRE THE USE OF A KEY, TOOL, SPECIAL KNOWLEDGE, OR EFFORT TO MAKE AVAILABLE THE REQUIRED CLEAR OPENING, AND NO PART OF THE MECHANISM SHALL BE PLACED HIGHER THAN 54" ABOVE THE FINISHED FLOOR.
- GENERAL CONTRACTOR TO VERIFY AND COORDINATE ACTUAL WINDOW DIMENSIONS AND ROUGH OPENINGS PRIOR TO CONSTRUCTION.
- ANY CHANGE OF INTERIOR FINISHES BY OWNER/G.C. SHALL BE COORDINATED WITH ARCHITECT OF RECORD. INTERIOR / EXTERIOR PARTITION FRAMING, SIZING AND REINFORCING TO BE BY SPECIALTY ENGINEERING.
- BATH DOORS SHALL BE OPERABLE FROM OUTSIDE IN EMERGENCY SITUATIONS. CLOSET DOORS SHALL BE OPERABLE BY CHILDREN FROM INSIDE.
- SEPARATE PERMIT REQUIRED FOR ROOFING, RAILINGS, WINDOWS AND DOORS. FOR SECURITY ENTRY NOTES REFER TO BUGLARY NOTES SHEET A-003.
- SHOWERS. SHOWER COMPARTMENTS SHALL HAVE FLOORS AND WALLS CONSTRUCTED OF SMOOTH, CORROSION RESISTANT AND NONABSORBENT WATER-RESISTANT MATERIALS TO A HEIGHT OF NOT LESS THAN 70 INCHES (1778 MM) ABOVE THE COMPARTMENT FLOOR AT
- THE DRAIN. SHOWER PANS SHOULD BE WATERPROOFED A MIN. OF 12" UP EACH PERIMETER WALL.
- WINDOWS AT LESS THAN 4FT. FROM DOORS SHALL HAVE CAT. II GLAZING PER FBC SEC. R4410.2.4.3.2
- WHEN THERE IS A DROP OF LESS THAN 4 FT. ON EITHER SIDE OF A WINDOW IT SHALL COMPLY WITH FBC SEC R4410.2.4.2 AND R4403.7.3.1 ALL SHOWER ENCLOSURES AND ANY GLAZING WITHIN 60" OF THE FINISHED FLOOR SURFACE IN WALLS SURROUNDING ANY TUB OR SHOWER ENCLOSURE SHALL BE CAT. II SAFETY GLASS PER FBC 2010 R4410.2.6.2 SAFEGUARDS.
- ALL GLASS RAILINGS TO COMPLY WITH FBC SEC. R4403.7.3.6
- GC TO REFER TO INTERIOR DESIGN DRAWINGS FOR CLARIFICATION OF ALL FINISHES AND RELATED DETAILS.
- ALL FINISHES TO BE SELECTED BY OWNER/INTERIOR DESIGNER.
- ALL FINISH HARDWARE TO BE SELECTED BY OWNER/INTERIOR DESIGNER.
- SEE INTERIOR DESIGN FOR ALL BATH ACCESSORIES. GC TO PROVIDE BACKING AS NECESSARY. REFER TO INTERIOR DESIGN DRAWINGS FOR LOCATIONS OF MILLWORK AND OTHER BUILT-IN FURNITURE. PROIVDE PROPER BACKING AS
- NECESSARY. FINISH DIMENSIONS SUBJECT TO CHANGE. REFER TO INTERIOR DESIGN DRAWINGS FOR FINAL DIMENSIONS AND NOTIFY ARCHITECT OF ANY
- CONFLICTS. WALL AND CEILING FINISHES SHALL HAVE A FLAME-SPREAD CLASSIFICATION OF NOT GREATER THAN 200 AND A SMOKE-DEVELOPED INDEX NOT GREATER THAN 450 AS PER ASTM E-84 OR UL 273. FBCR 302.9.
- INSULATION MATERIALS, FACINGS, VAPOR RETARDERS SHALL HAVE A FLAME-SPREAD CLASSIFICATION OF NOT GREATER THAN 25 AND A SMOKE-DEVELOPED INDEX NOT GREATER THAN 450 AS PER ASTM E-84 OR UL 273. FBCR 302.10 ALL ELEVATIONS ARE BASED UPON NATIONAL GEODETIC VERTICAL DATUM 1929 (NGVD 1929). ALL ELEVATIONS IN RCPs ARE RELATIVE TO
- GC TO COORDINATE FINAL LOCATION OF ACCESS HATCH WITH MECHANICAL EQUIPMENT AND NOTIFY ARCHITECT OF ANY CONFLICTS. GC TO VERIFY SPACE REQUIRED FOR VERTICAL AIR DIFFUSERS AND RETURNS IN COVES.

ISSUE DATE: 01/03/2022 DRB FINAL SUBMITTAL Description 12/20/2021 Revision 1

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Project Team

Project Name


CASA BAHIA

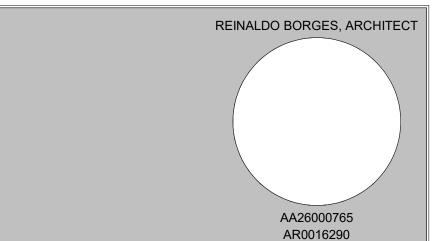253 N COCONUT LN MIAMI BEACH, FLORIDA, 33139 FOLIO # 02-4205-002-0160

Project Number 21-3600 Drawing Name **ROOF PLAN**

Scale:

As indicated

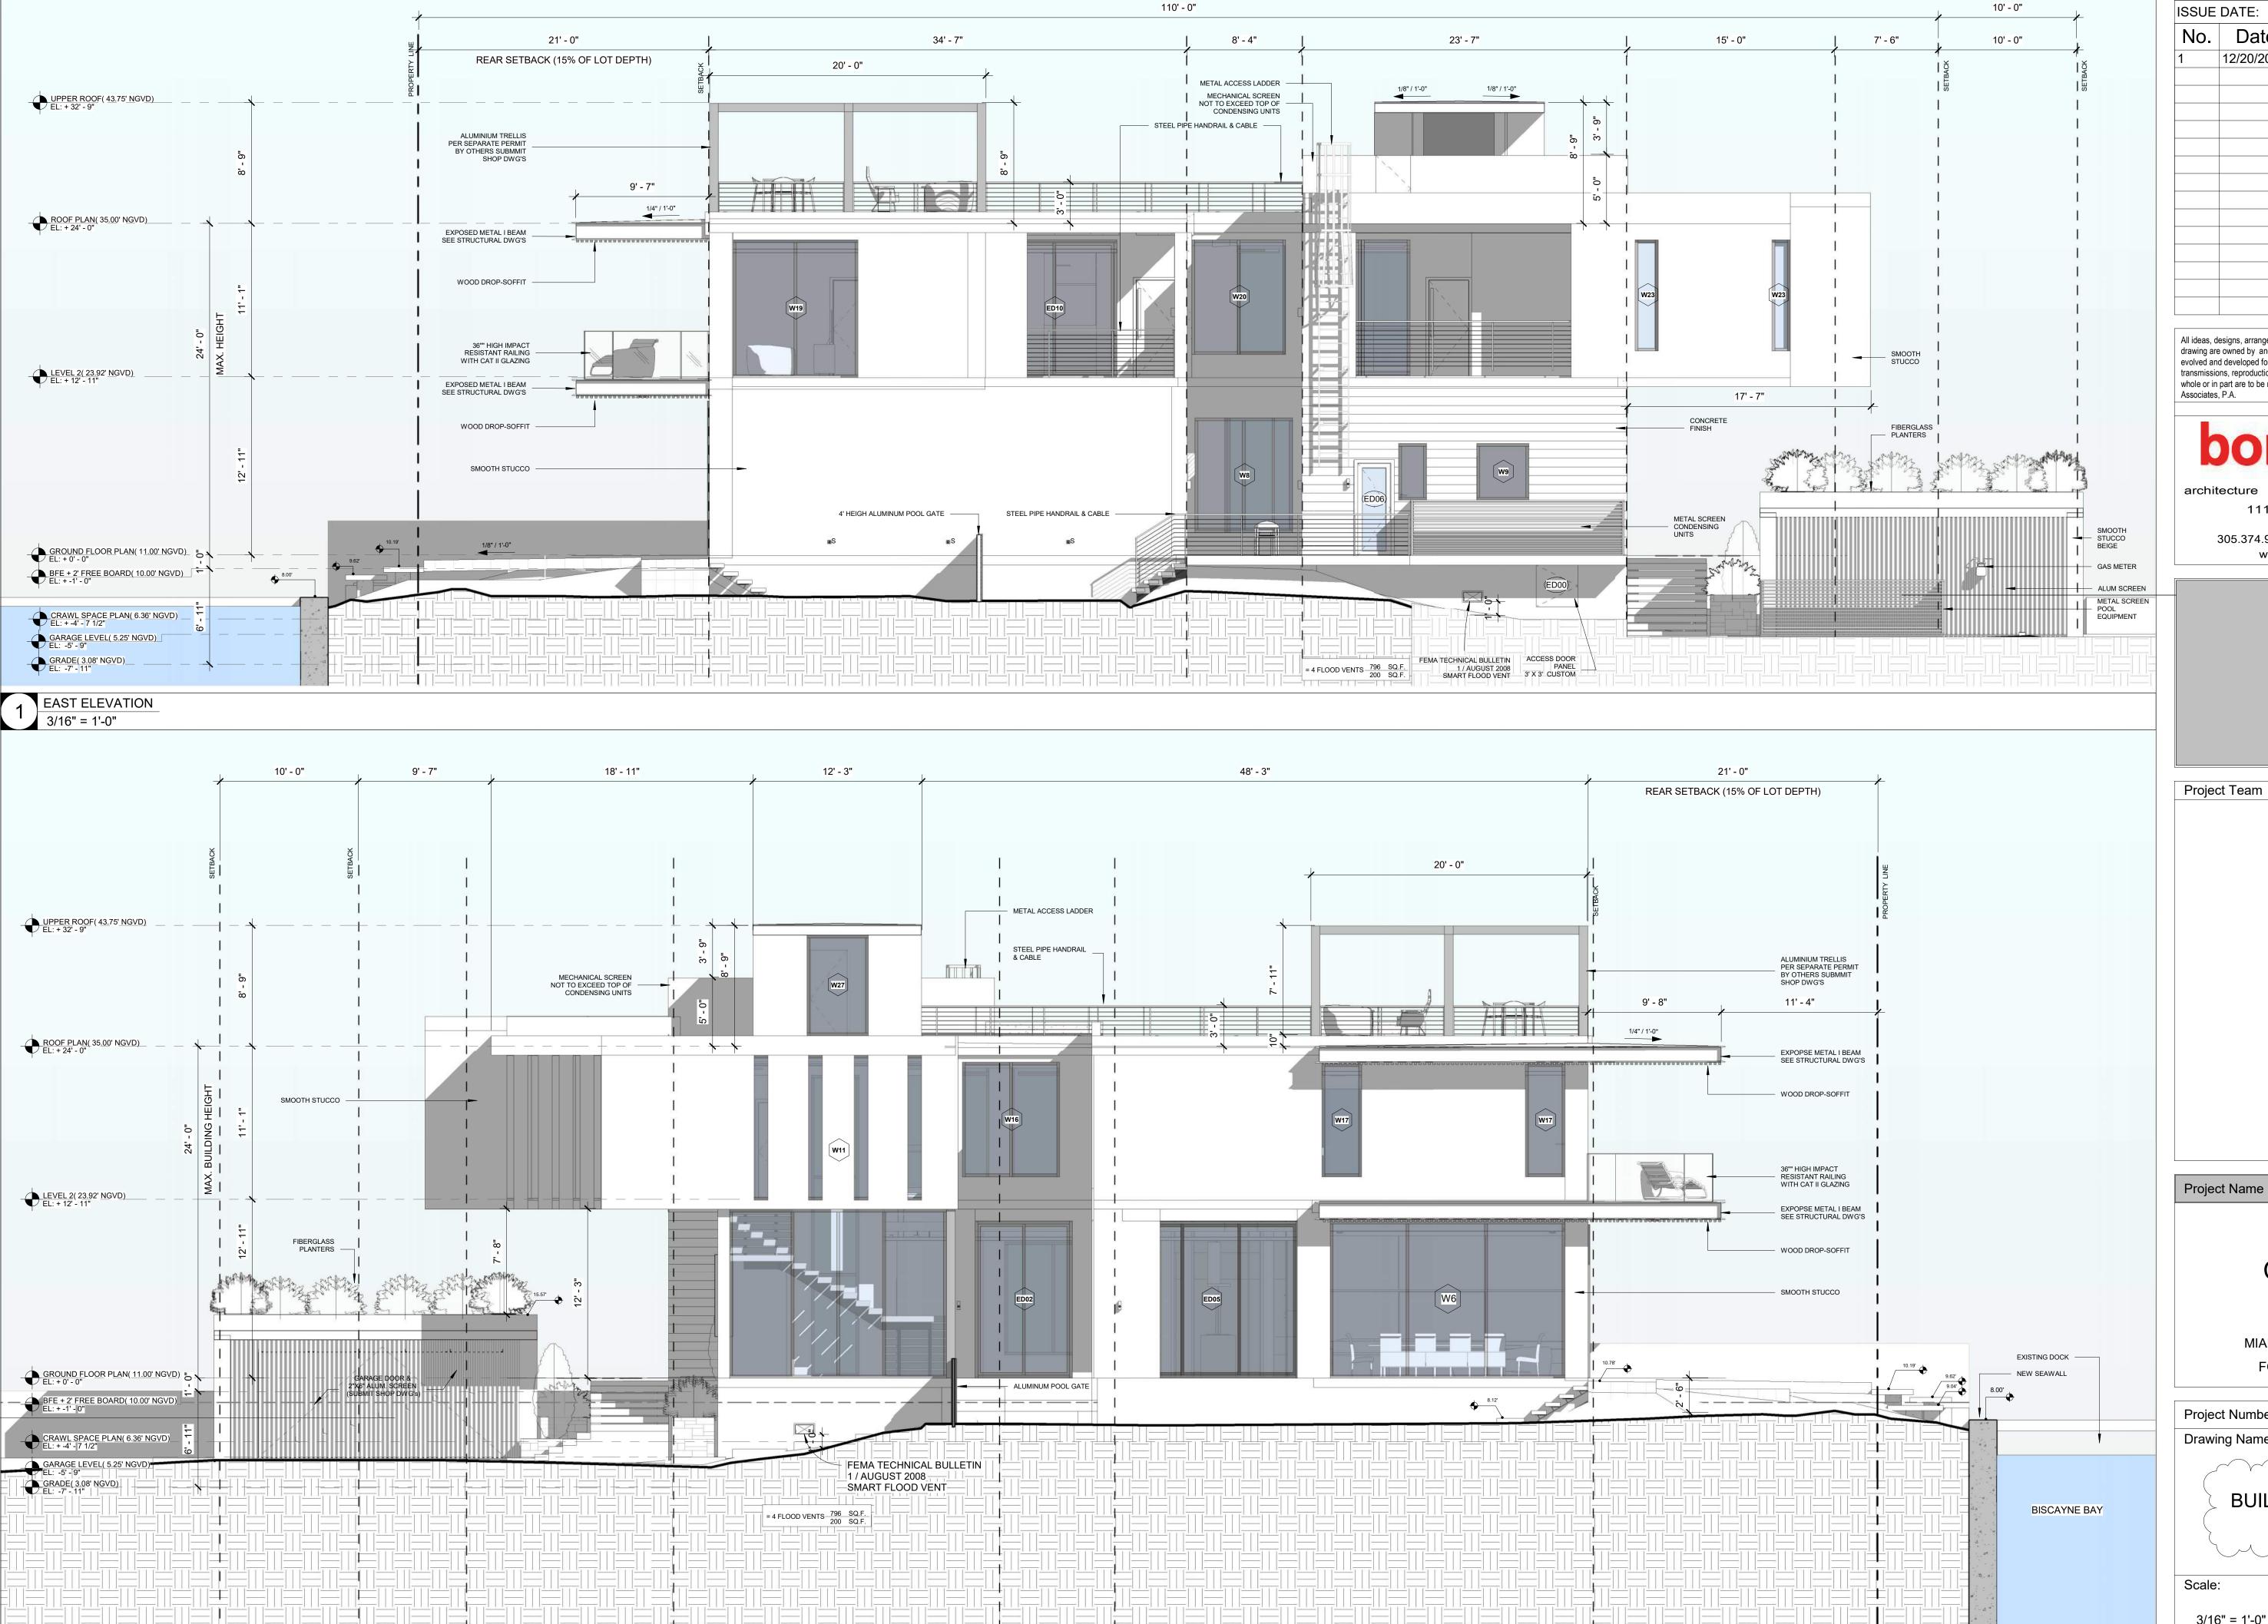


2 WEST ELEVATION
3/16" = 1'-0"


ISSUE DATE: 01/03/2022 DRB FINAL SUBMITTAL Description 12/20/2021 Revision 1

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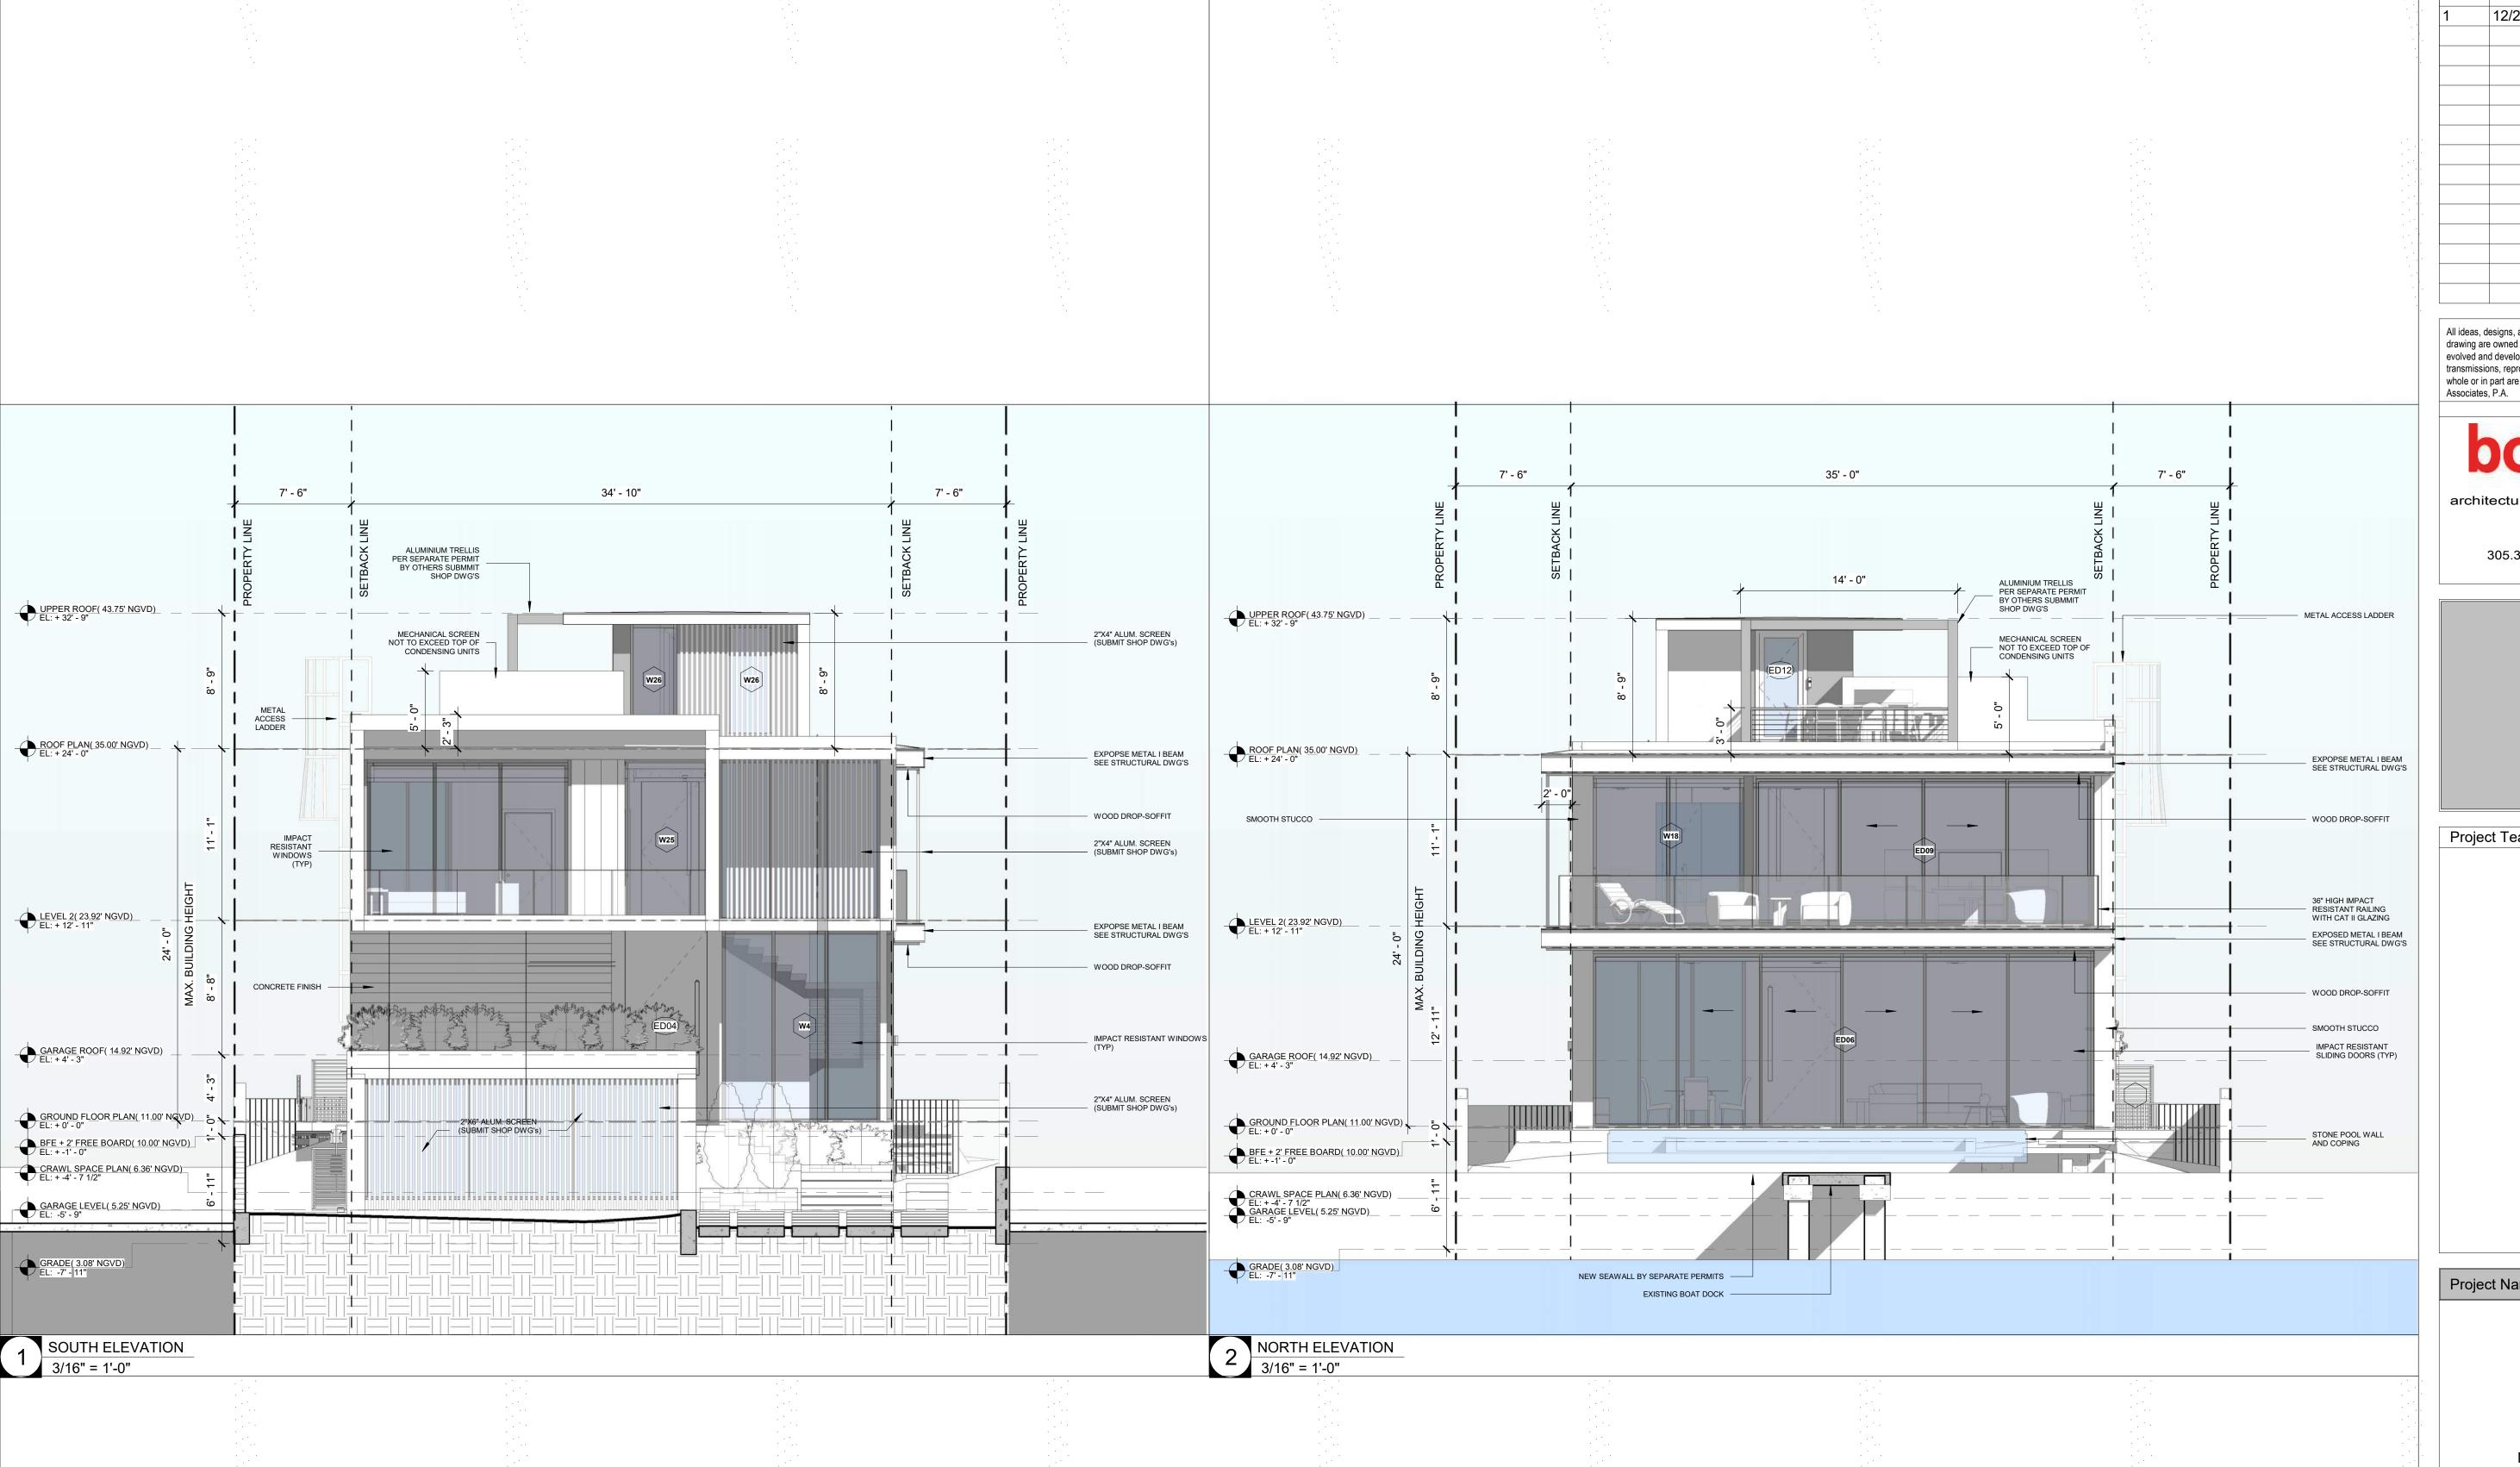



Project Name

CASA BAHIA

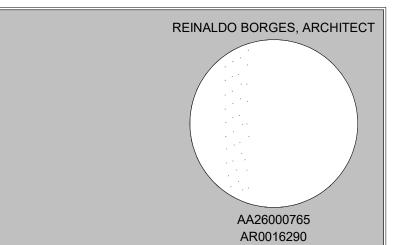253 N COCONUT LN MIAMI BEACH, FLORIDA, 33139 FOLIO # 02-4205-002-0160

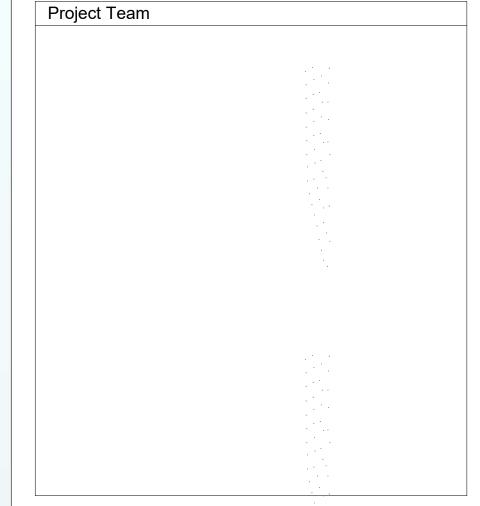
21-3600 Project Number **Drawing Name BUILDING ELEVATIONS**



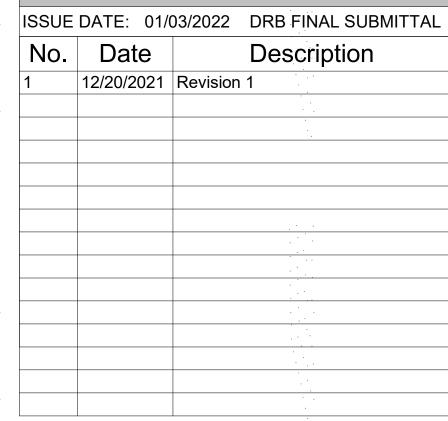

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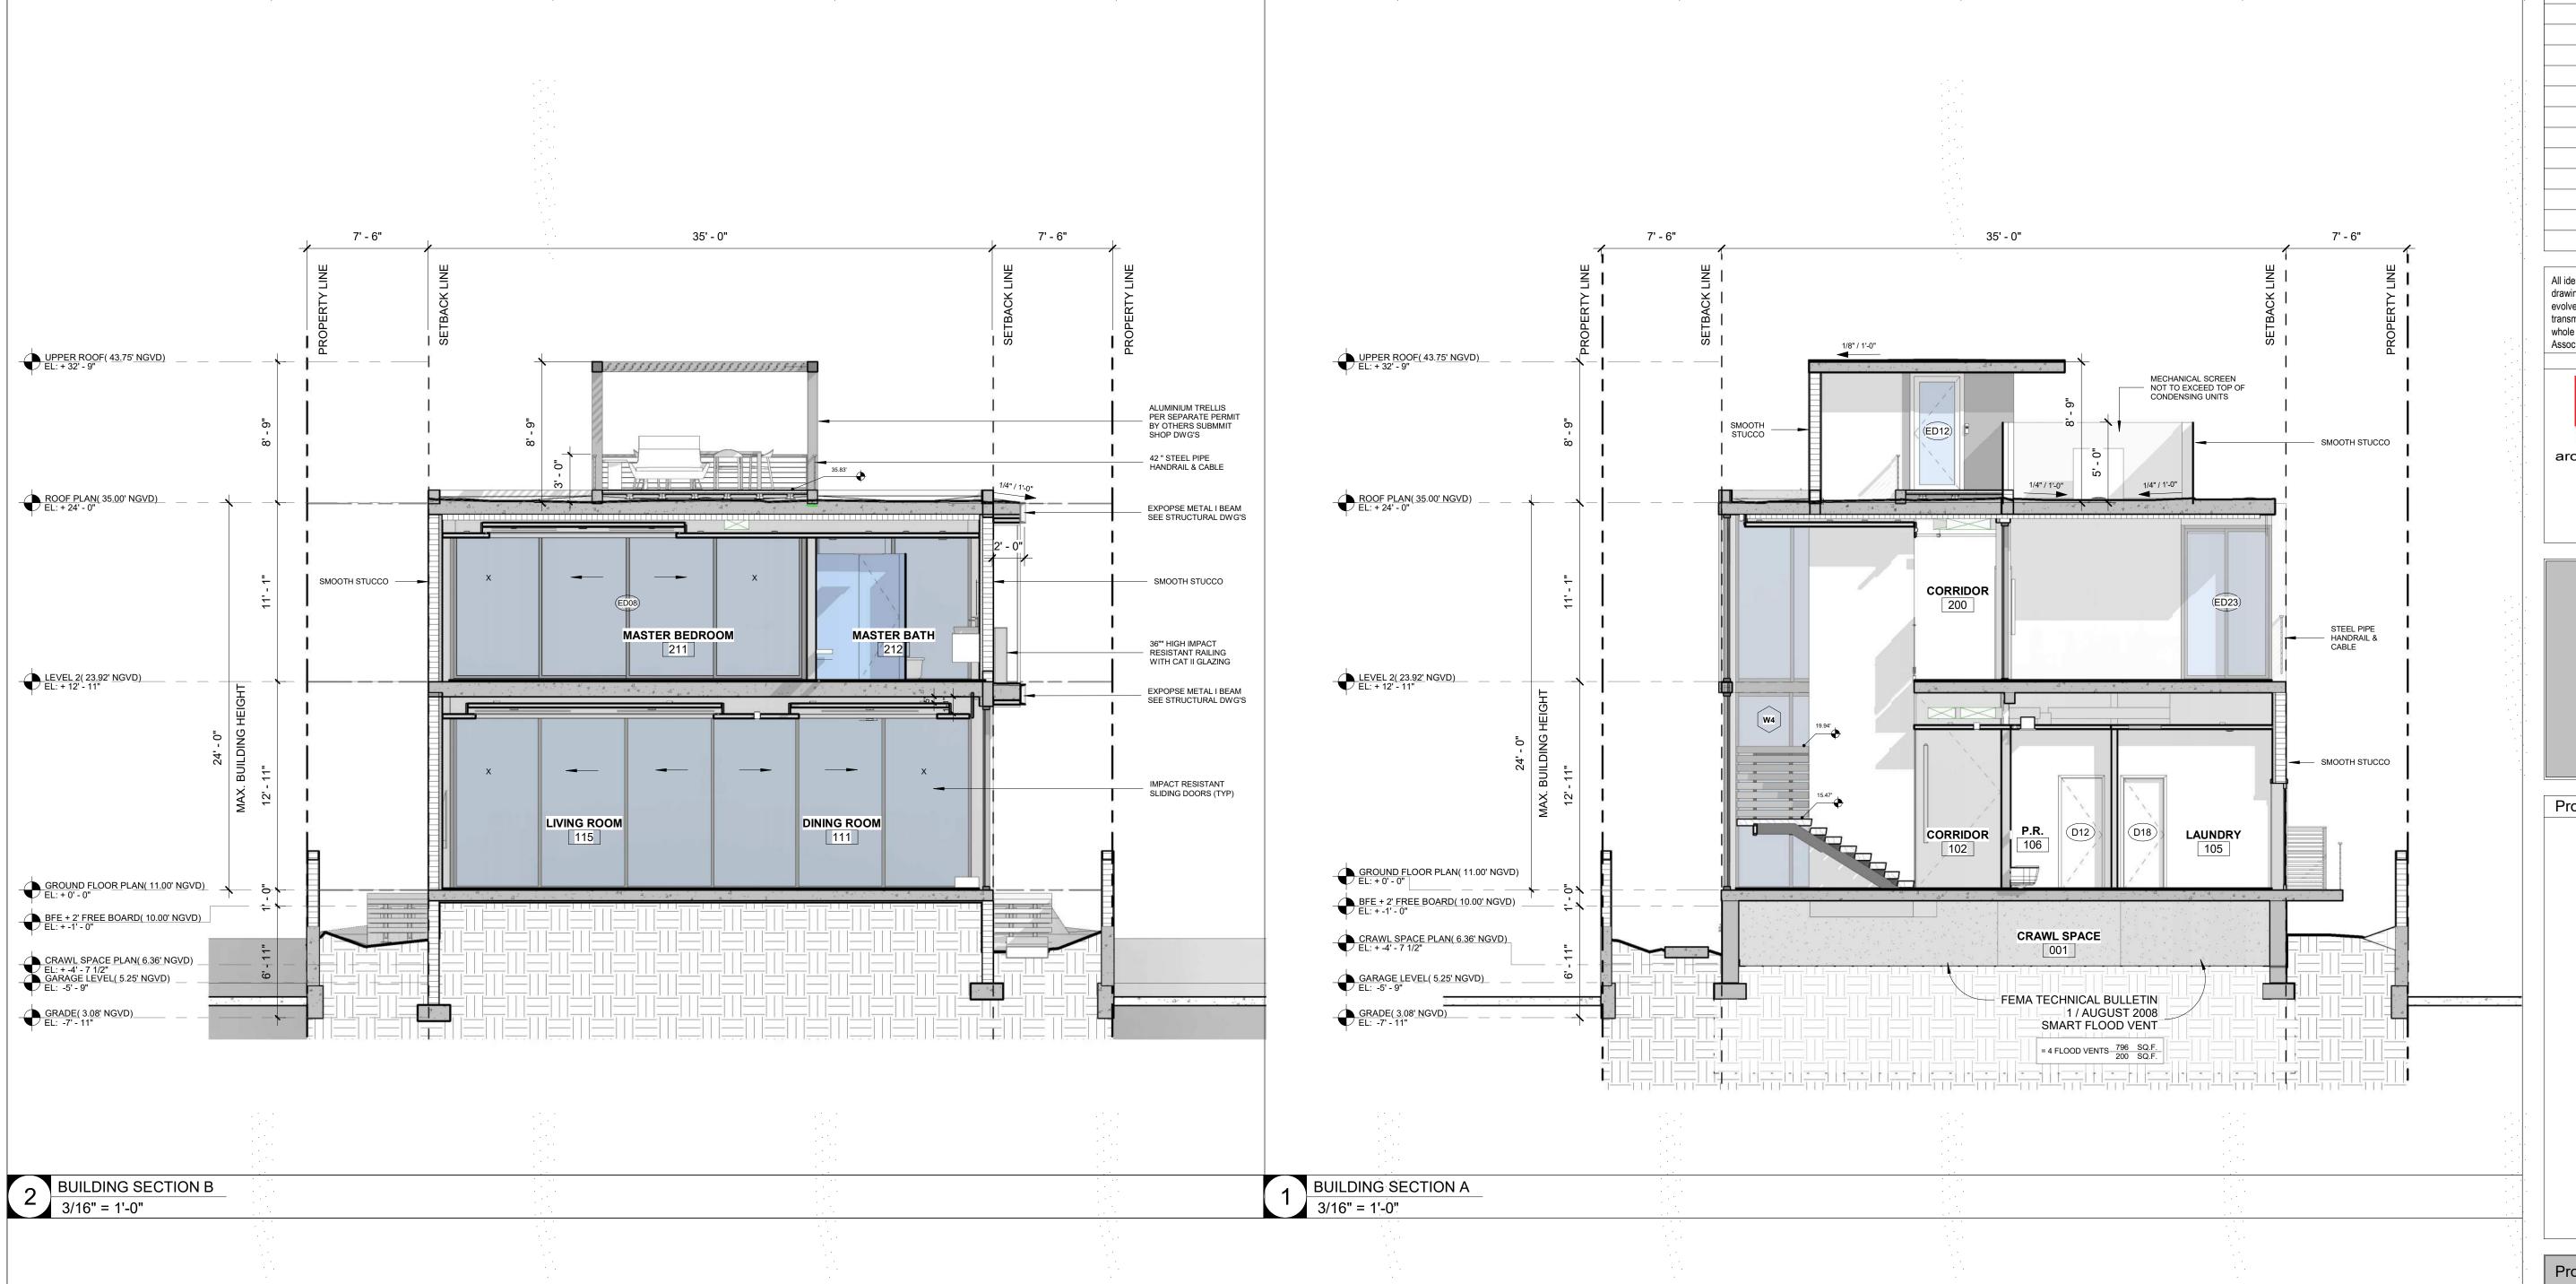
CASA BAHIA

253 N COCONUT LN MIAMI BEACH, FLORIDA, 33139 FOLIO # 02-4205-002-0160

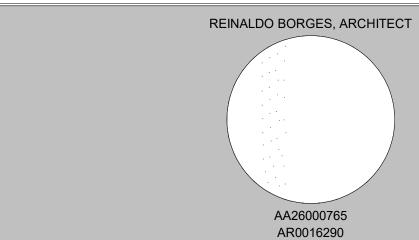Project Number 21-3600 Drawing Name **BUILDING ELEVATIONS**

Scale:

3/16" = 1'-0"



No. Date Description

1 12/20/2021 Revision 1

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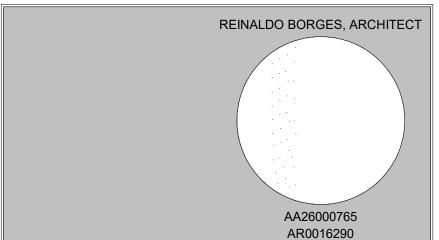
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Project Team

Project Name

CASA BAHIA

253 N COCONUT LN MIAMI BEACH, FLORIDA, 33139 FOLIO # 02-4205-002-0160

Project Number 21-3600

Drawing Name


BUILDING SECTIONS

Scale:

3/16" = 1'-0"

Drawing Number

A-400

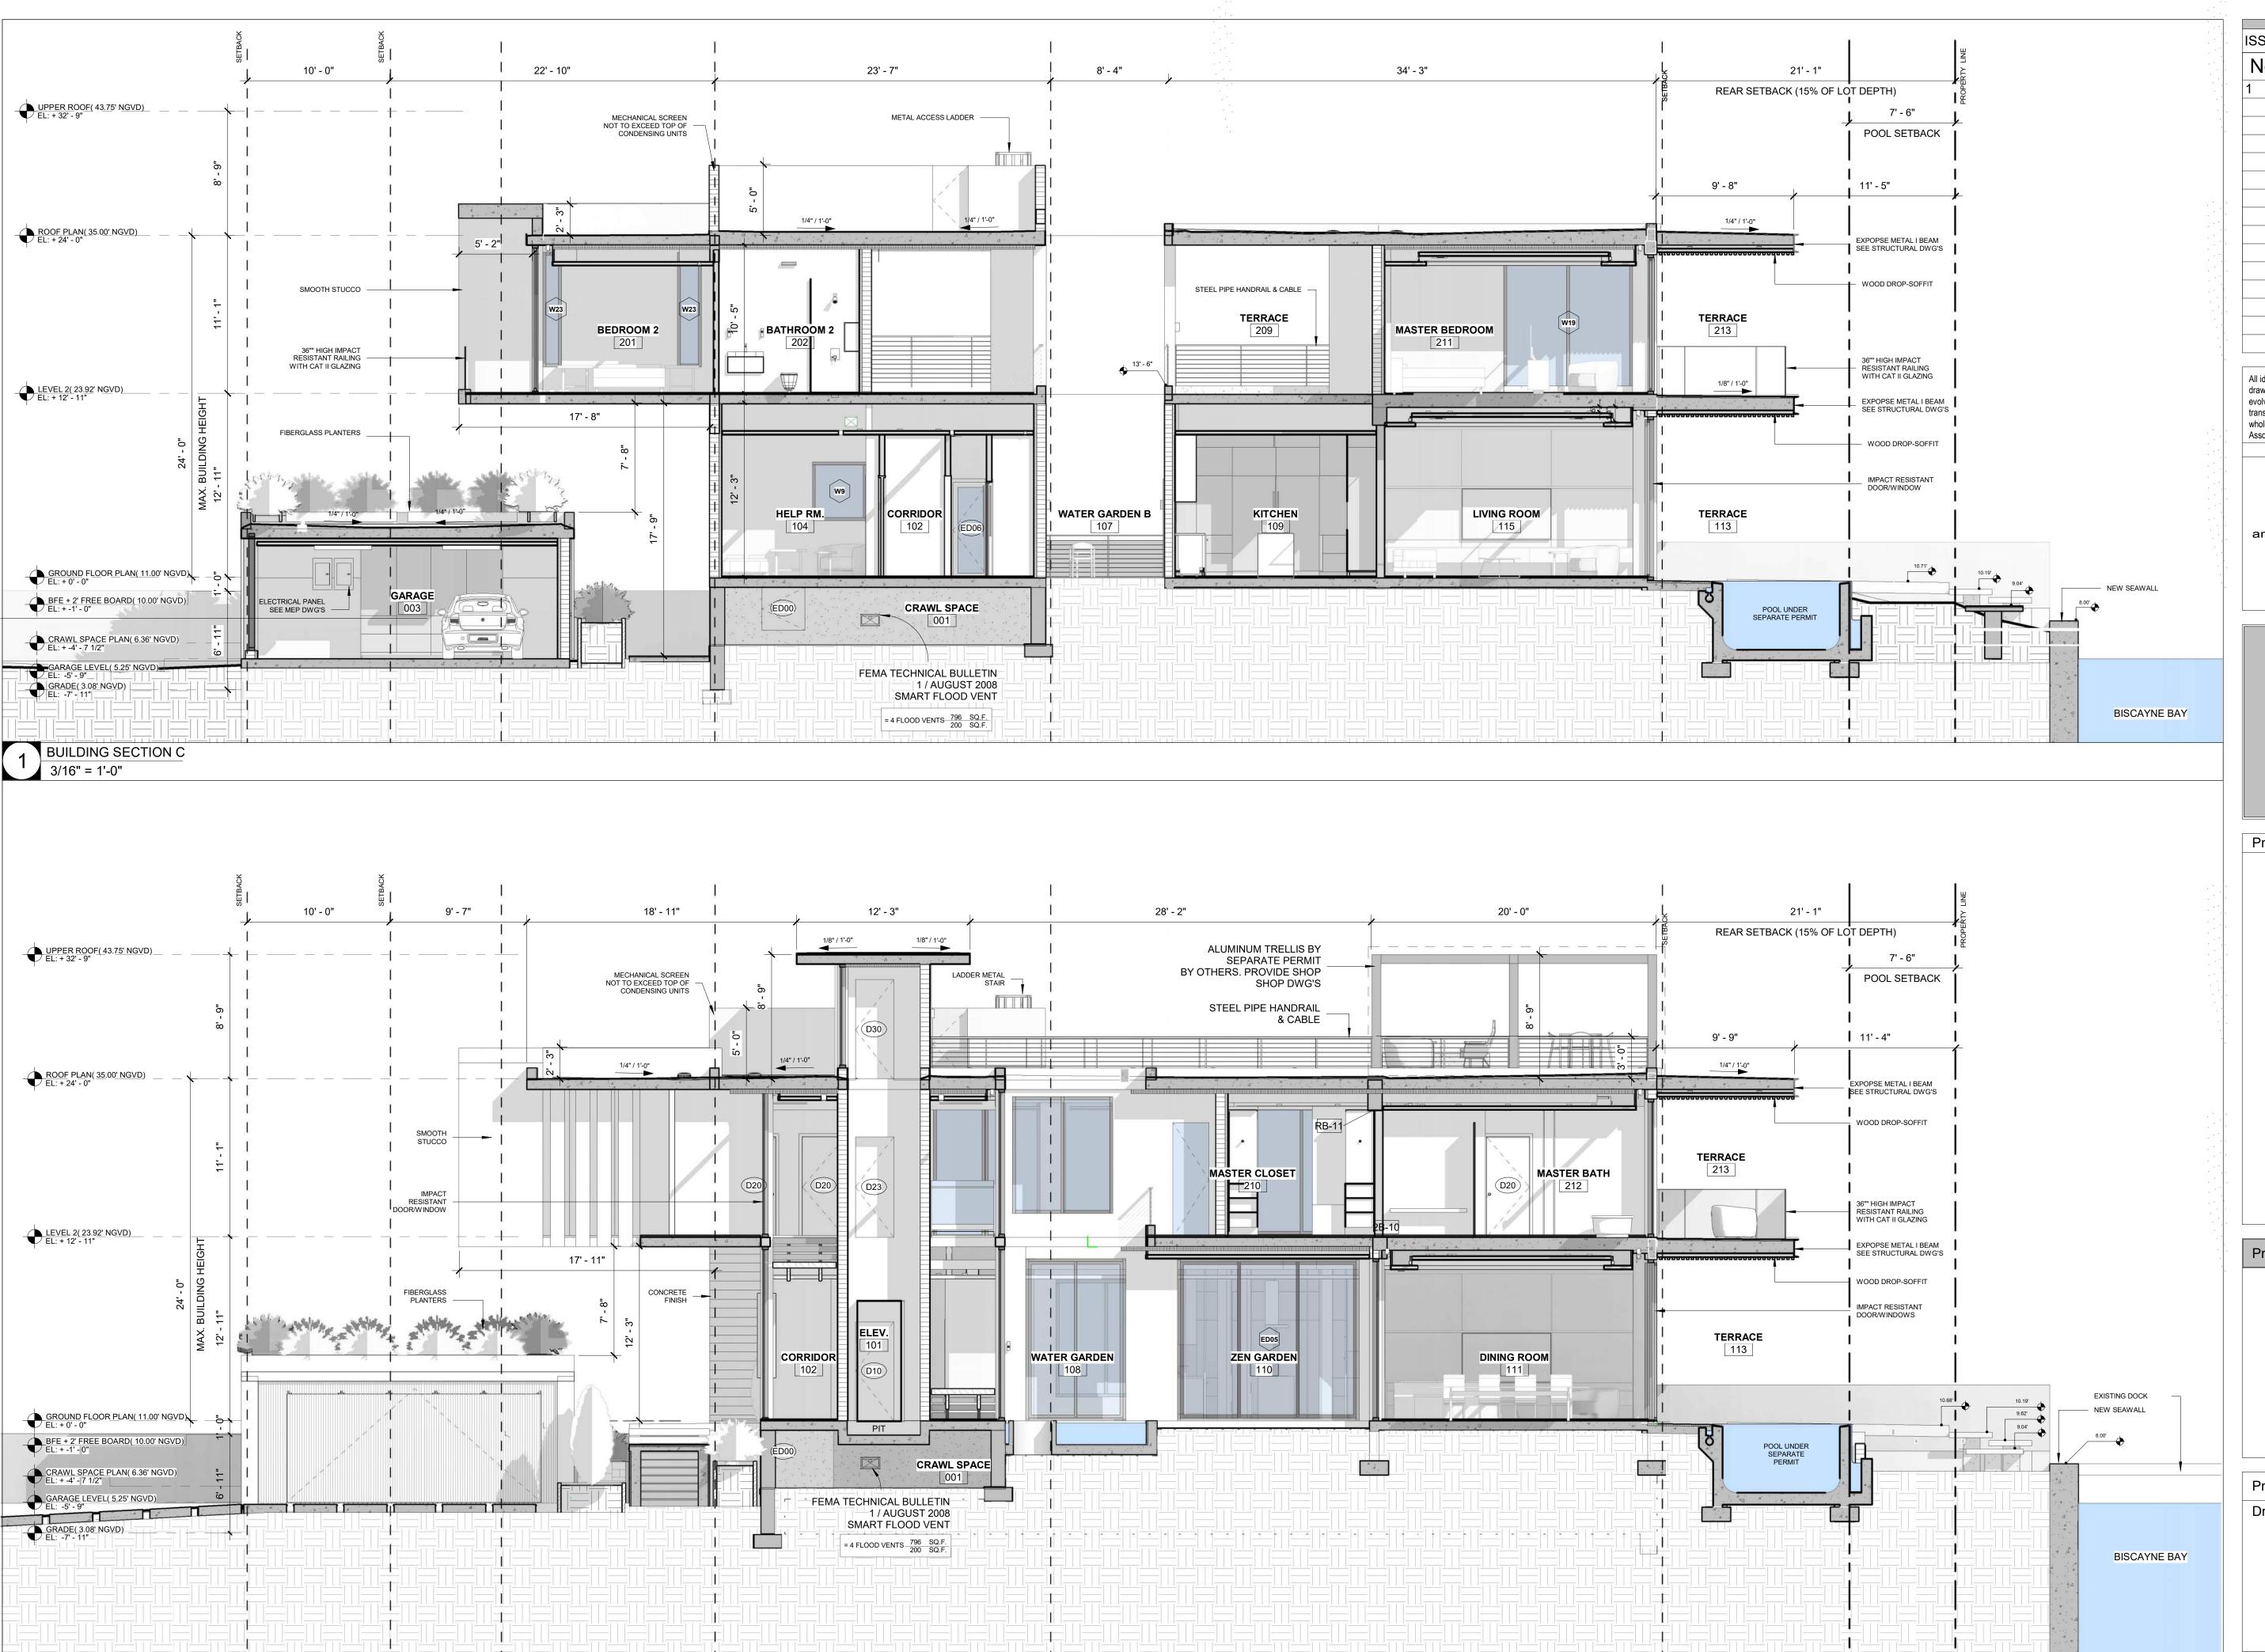

2 BUILDING SECTION D
3/16" = 1'-0"

No. Date Description

1 12/20/2021 Revision 1

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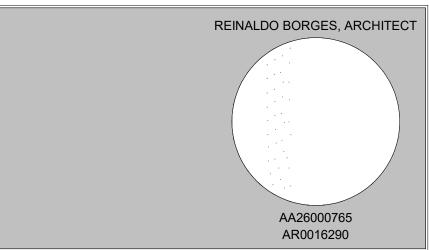
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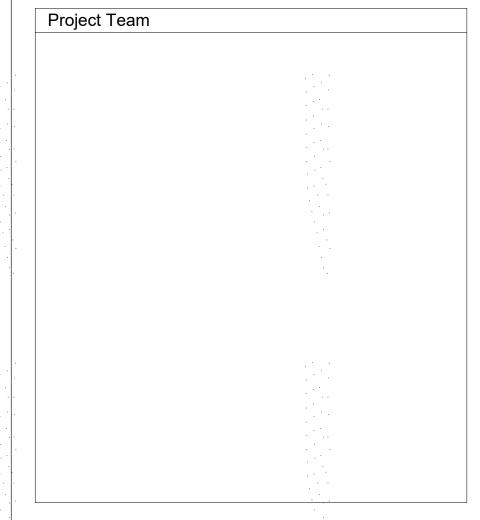
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Project Name

CASA BAHIA

253 N COCONUT LN MIAMI BEACH, FLORIDA, 33139 FOLIO # 02-4205-002-0160

Project Number 21-3600

Drawing Name


BUILDING SECTIONS

Scale:

Drawing Number

3/16" = 1'-0"

MAP OF BOUNDARY SURVEY

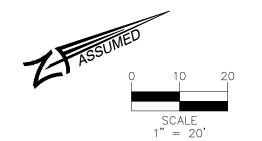

LEGEN	ID
SYMBOL	DESCRIPTION
•	FOUND IRON REBAR
0	FOUND IRON PIPE WITH CAP
P/L	PROPERTY LINE
R/W	RIGHT-OF-WAY
CBS	CONCRETE BLOCK STUCCO
N.G.V.D.	NATIONAL GEODETIC VERTICAL DATA
PB	PLAT BOOK
PG	PAGE
DB	DEED BOOK
7	NUMBER OF PARKING SPACES
S.I.P.	SET IRON PIPE
T.O.P.	TOP OF PIPE
SWK	SIDEWALK
P.O.B.	POINT OF BEGINNING
N.T.S.	NOT TO SCALE
T.B.M.	TEMPORARY BENCH MARK
F.F.E.	FINISH FLOOR ELEVATION
S.I.R.	SET IRON REBAR
F.D.H.	FOUND DRILL HOLE
F.I.P.	FOUND IRON PIPE
F.I.R.	FOUND IRON REBAR
	CATCH BASIN
E	ELECTRICAL WALL PANEL
FH	FIRE HYDRANT
	DRAINAGE CURB INLET
PEIMOCHIDI	BACKFLOW_PREVENTOR
◆	SUBDIVISION BLOCK NUMBER
	PEDESTRIAN SIGNAL

WATER METER

WATER VALVE

MHD (C

0 0 0

— sтм —

— SAN ——

. . .

•••

BUILDING HATCH

ASPHALT PAVEMENT

HANDICAP TACTILE STRIP

CONCRETE

GREASE-TRAP MANHOLE

SANITARY SEWER VALVE

SANITARY SEWER CLEAN-OUT SANITARY SEWER MANHOLE

PEDESTRIAN SIGNAL ELECTRIC UTILITY BOX LIGHT POLE GUY ANCHOR

	MANHOLE_UNKNOWN					
)	DRAINAGE MANHOLE	-				
-	SIGNAL MAST ARM			DIAMETER(INCHES)		
	INTERCOM	T1	PALM (2 trunks)	6	18	8
	POST	T2	PALM	14	15	10
	SIGN	T3	TREE-U	24	45	30
	MAILBOX	T4	ROYAL POINCIANA	22	50	25
	CONCRETE UTILITY POLE	T5	PALM	6	20	8
	GUARDRAIL	T6	PALM	20	50	20
	FPL TRANSFORMER	T7	PALM	20	50	20
_		T8	PALM	20	50	20
	WOOD UTILITY POLE	T9	PALM	10	25	10
	TREE NUMBER	T10	PALM	6	20	8
	UTILITY STRUCTURE NUMBER	T11	PALM	6	20	8
2	ICBS WALL	T12	PALM	6	20	8
	WOOD FENCE	T13	PALM	6	20	8
	IRON FENCE	T14	PALM (4 trunks)	6	20	8
	IRON ROLLING GATE	T15	PALM (4 trunks)	6	20	8
	IRON SWING GATE	T16	PALM (4 trunks)	6	20	8
	CHAIN-LINK FENCE	T17	PALM (4 trunks)	6	20	8
	CHAIN-LINK ROLLING GATE	T18	PALM (4 trunks)	6	20	8
		T19	PALM (4 trunks)	6	20	8
_	CHAIN-LINK SWING GATE	T20	PALM (4 trunks)	6	20	8
	FENCE_OTHER	T21	PALM (4 trunks)	6	20	8
	TREE	T22	PALM (4 trunks)	6	20	8
	PINE TREE	T23	PALM (4 trunks)	6	20	8
	PALM TREE	T24	PALM	14	45	20
	PROPERTY LINE	T25	PALM	18	35	15
	RIGHT-WAY-LINE	T26	PALM	18	40	15
	EASEMENT LINE	T27	PALM	18	40	15
	X-UTL-DRAIN	T28	PALM	15	35	15
_	X-UTL-SANT	T29	PALM	20	45	15
_	OVERHEAD UTILITY LINE	T30	PALM	20	45	15
_		T31	PALM	10	15	10
Α.	EXISTING ELEVATION	T32	PALM	6	20	8
Š	GRAVEL					

NO. STRUCTURE RIM DIRECTION DOWN INVERT DESCRIPTION 3.50 BOTTOM | 4.40 | 4.40 -0.90 PVC 12" S 4.40 | -0.90 | PVC 12"

2.50 | 1.00

PVC 8"

SURVEYOR'S NOTES:

SECTION 1) DATE OF FIELD SURVEY:

1. The date of completion of the field work of the Boundary Survey was on December 01, 2021.

SECTION 2) LEGAL DESCRIPTION:

Lot 17, Block 2-A, of RIVIERA PALM ISLAND, according to the Plat thereof, recorded in Plat Book 32, Page 37, of the Public Records of Miami-Dade County,


Together with that part of the 20 foot strip contiguous to and abutting said lot which was conveyed to the Biscayne Bay Islands Company by deed recorded in Deed Book 1501, Page 479, more specifically described by metes and bounds as

Commencing at the Southwesterly corner of Lot 17, Block 2-A of RIVIERA as per Amended Plat recorded in Plat Book 32, Page 37, of the Public records of Miami-Dade County, Florida; thence Northeasterly 160 feet along the dividing line between Lots 16 and 17 and its extension into the Bay; thence at a right angle to the right 50 feet; thence at a right angle to the right 160 feet along the dividing line between Lots 17 and 18 and its extension into the Bay to the Southeasterly corner of Lot 17; thence at a right angle to the right 50 feet along the dividing line of Lot 17 and the street to the Point of Beginning.

Containing 8,000 Square Feet or 0.18 Acres, more or less, by calculations.

Property Address and Tax Folio Number:

253 North Coconut Lane, Miami Beach, FL 33139 Folio No.: 02-4205-002-0160

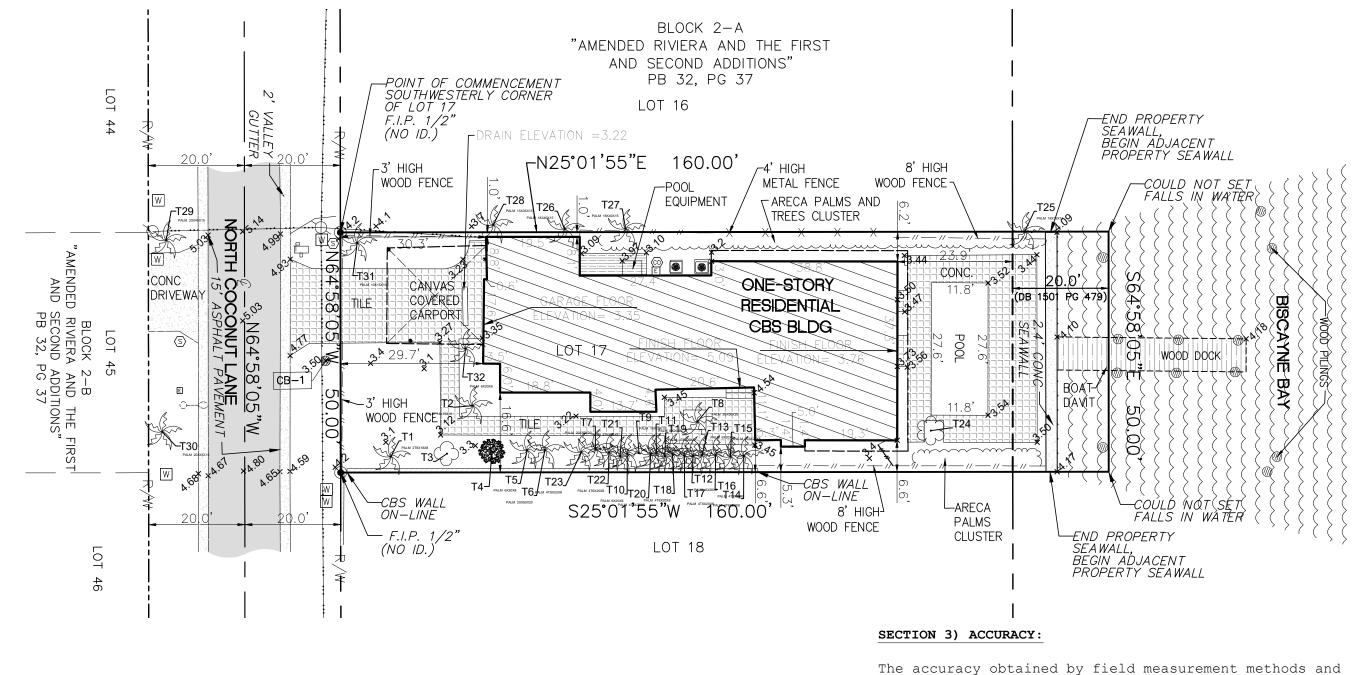

office calculations of closed geometric figures meets and exceeds the Standards of Practice requirement for this Type of Survey as defined in Rule 5J-17.051, Florida Administrative Code.

Elevations of well identified features as depicted on the Survey Map were measured to an estimated vertical position accuracy of 1/100 of a foot on hard surfaces and 1/10 of a foot on ground surfaces.

Well identified features as depicted on the Survey Map were measured to an estimated horizontal position accuracy of 1/10 of a foot.

This Map of Survey is intended to be displayed at a scale of (1"=20') or smaller.

SECTION 4) SOURCES OF DATA:

North arrow direction is based on an assumed Meridian.

Plat of "AMENDED RIVIERA AND THE FIRST AND SECOND ADDITIONS", recorded in Plat Book 32, at Page 37, Miami-Dade County Records.

Warranty Deed, dated February 16th, 2017, recorded in Official Records Book 30433, Page 2725, Miami-Dade County Records.

Bearings as shown hereon are based upon the Center Line of the Subject Site with an assumed bearing of N64°50'18"W, said line to be considered a well established and monumented line.

This property is to be located in Flood Zone "AE", with an Elevation of 9, as per Federal Emergency Management Agency (FEMA) Community Number 120651 (City of Miami Beach), Map Panel No. 12086C0316, Suffix L, Map Revised Date: September

Legal Description was furnished by client.

Elevations as shown hereon are based on the National Geodetic Vertical Datum of 1929 (NGVD 1929). Benchmark used, City of Miami Beach, Benchmark Number CMB PALM 01 R, Elevation 3.572 feet (NAVD-88). The Benchmark elevation was added 1.51 to be converted to (NGVD 1929) from North American Vertical Datum (NAVD 1988).

SECTION 5 - TOWNSHIP 54 SOUTH - RANGE 42 EAST PALMISLAND/ LOCATION MAP NOT TO SCALE

SECTION 5) LIMITATIONS:

Since no other information were furnished other than that is cited in the Sources of Data, the Client is hereby advised that there may be legal restrictions on the Subject Property that are not shown on the Survey Map that may be found in the Public Records of Miami-Dade County.

The Surveyor makes no representation as to ownership or possession of the Subject Property by any entity or individual that may appear in the public records of this

No excavation or determination was made as to how the Subject Property is served by utilities.

No improvements were located, other than those shown. No underground foundations, improvements and/or utilities were located or shown hereon.

SECTION 6) CLIENT INFORMATION:

This Boundary Survey was prepared at the request of and certified to:

Onur Peker

SECTION 7) SURVEYOR'S CERTIFICATE:

I hereby certify that this "Boundary Survey" and the Survey Map resulting therefrom was performed under my direction and is true and correct to the best of my knowledge and belief and further, that said "Boundary Survey" meets the intent of the applicable provisions of the "Standards of Practice for Land Surveying in the State of Florida", pursuant to Rule 5J-17.051 through 5J-17.052 of the Florida Administrative Code and its implementing law, Chapter 472.027 of the Florida Statutes.

HADONNE CORP., a Florida Corporation Florida Certificate of Authorization Number LB7097


Abraham Hadad, PSM For the Firm Registered Surveyor and Mapper LS6006 State of Florida

NOTICE: Not valid without the original signature and seal of a Florida Licensed Surveyor and Mapper. Additions or deletions to Survey Maps by other than the signing party are prohibited without the written consent of the signing party.

MAP OF BOUNDARY ONUR PEKER 253 N COCONUT LANE, MIAMI BEACH, FL 33139

ield Book: FILE DRAWN BY: MM TECH BY: RI QA/QC BY: JS

21142 1/1

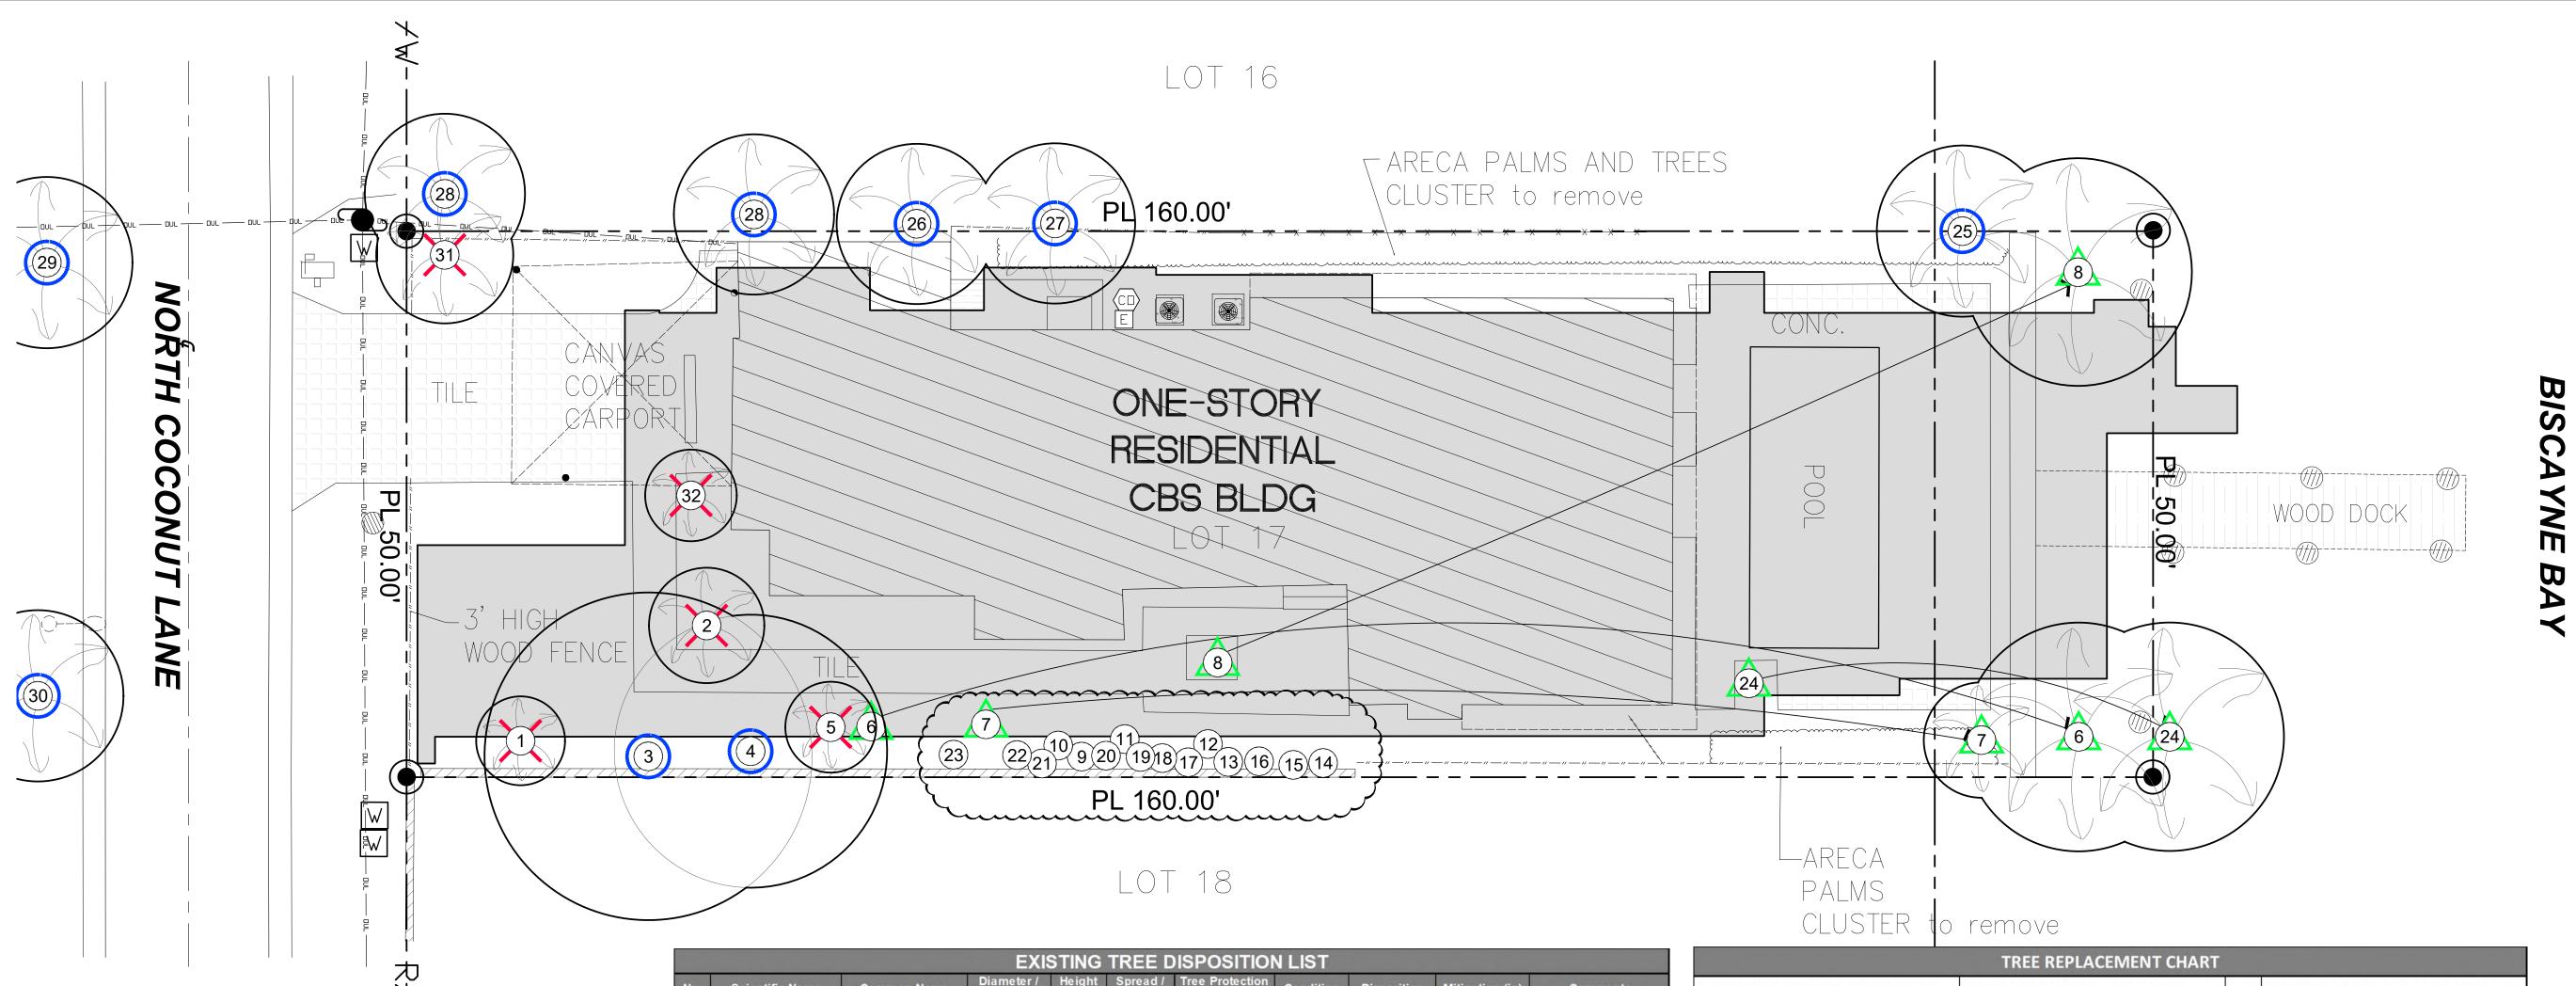

EXISTING TREE DISPOSITION PLAN SCALE:

Sunshine [1]] Call 811 or www.sunshine811.com two full business days before digging to have utilities located and marked. Check positive response codes before you dig!


			LAI	211110	TIVEL D		1 LIO I			
No.	Scientific Name	Common Name	Diameter / DBH (in)	Height (ft)	Spread / Canopy (ft)	Tree Protection Zone Radius (ft)	Condition	Disposition	Mitigation (in)	Comments
1	Veitchia merrillii	Christmas Palm	6	18	8	3	Fair	Remove	1 palm/ tree	
2	Washingtonia robusta	Washington Palm	14	15	10	3	Fair	Remove	1 palm/ tree	
3	Bauhinia Blakeana	Hong Kong orchid tree	24	45	30	16	Fair	Remain		
4	Delonix regia	Royal Poinciana	22	50	25	15	Fair	Remain		
5	Veitchia montgomeryana	Montgomery Palm	6	20	8	3	Fair	Remove	1 palm/ tree	
6	Roystonea regia	Cuban Royal Palm	20	50	20	3	Fair	Transplant		
7	Roystonea regia	Cuban Royal Palm	20	50	20	3	Fair	Transplant		
8	Roystonea regia	Cuban Royal Palm	20	50	20	3	Fair	Transplant		
9	Caryota Mitis	Fishtail palm	10	25	10	3	Fair	Remain		
10	Caryota Mitis	Fishtail palm	6	20	8	3	Fair	Remain		
11	Caryota Mitis	Fishtail palm	6	20	8	3	Fair	Remain		
12	Caryota Mitis	Fishtail palm	6	20	8	3	Fair	Remain		
13	Caryota Mitis	Fishtail palm	6	20	8	3	Fair	Remain		
14	Caryota Mitis	Fishtail palm	6	20	8	3	Fair	Remain		(4 trunks)
15	Caryota Mitis	Fishtail palm	6	20	8	3	Fair	Remain		(4 trunks)
16	Caryota Mitis	Fishtail palm	6	20	8	3	Fair	Remain		(4 trunks)
17	Caryota Mitis	Fishtail palm	6	20	8	3	Fair	Remain		(4 trunks)
18	Caryota Mitis	Fishtail palm	6	20	8	3	Fair	Remain		(4 trunks)
19	Caryota Mitis	Fishtail palm	6	20	8	3	Fair	Remain		(4 trunks)
20	Caryota Mitis	Fishtail palm	6	20	8	3	Fair	Remain		(4 trunks)
21	Caryota Mitis	Fishtail palm	6	20	8	3	Fair	Remain		(4 trunks)
22	Caryota Mitis	Fishtail palm	6	20	8	3	Fair	Remain		(4 trunks)
23	Caryota Mitis	Fishtail palm	6	20	8	3	Fair	Remain		(4 trunks)
24	Cocos nucifera	Coconut Palm	14	45	20	3	Good	Transplant		
25	Roystonea regia	Royal Palm	18	35	15	3	Good	Remain		
26	Roystonea regia	Cuban Royal Palm	16	40	14	3	Fair	Remain		
27	Roystonea regia	Cuban Royal Palm	16	40	14	3	Fair	Remain		
28	Roystonea regia	Cuban Royal Palm	16	40	14	3	Fair	Remain		Outside de property line
28B	Roystonea regia	Cuban Royal Palm	16	40	14	3	Fair	Remain		Outside de property line
29	Roystonea regia	Royal Palm	20	45	15	3	Fair	Remain		Outside de property line
30	Roystonea regia	Royal Palm	20	45	15	3	Fair	Remain		Outside de property line
31	Wodyetia bifurcata	Foxtail Palm	10	16	12	3	Poor	Remove	1 palm/ tree	
32	Veitchia merrillii	Christmas Palm	6	20	8	3	Fair	Remove	1 palm/ tree	
								Mitigate (in)	0	.+ 5 palm/tree

	TREE DISPOSITION LEGEND
0	Existing tree or palm to be transplanted
0	Existing tree or palm to be removed
Tree / Palm	Existing tree and palm to remain in their existing location and be protected during construction, no construction or excavation shall be permitted within the dripline of the trees.
	LIMITS OF EXISTING TREE & PALM PROTECTION ZONE
	PROPOSED BUILDING & PAVED AREAS

	TREE REPLACEMENT CHART					
Total diameter of tree(s) to be removed (sum of inches at DBH)	Total # of replacement trees required (2" DBH minimum each: 12' min. OA)	OR	Total # of replacement trees required (4" DBH minimum each: 16' min. OA)			
2"-3"	1	or	0			
4"-6"	2	or	1			
7"-12"	4	or	2			
13"-18"	6	or	3			
19"-24"	8	or	4			
25"-30"	10	or	5			
31"-36"	12	or	6			
37"-42"	14	or	7			
43"-48"	16	or	8			
49"-60"	20	or	10			
TOTAL: 0"	Total: 0 Trees + 5 palm/tree	or	Total: 0 Trees + 5 palm/tree			
176 1 = 8 	Provided: 4 Trees + 5 palm/tree		Provided: 2 trees			

TREE / PALM PROTECTION FENCES SHALL BE CONSTRUCTED PRIOR TO ANY CONSTRUCTION ACTIVITY INCLUDING GRUBBING FOR ALL TREES / PALMS THAT ARE 'TO REMAIN, BE PROTECTED, or BE RELOCATED'

NO ACTIVITY OR DISTURBANCE SHOULD OCCUR WITHIN THE FENCED AREAS, INCLUDING VEHICLE USE, STORAGE OF MATERIALS, DUMPING OF LIQUIDS OR MATERIALS, GRADE CHANGES, GRUBBING, AND MECHANICAL TRENCHING FOR IRRIGATION, ELECTRICAL, LIGHTING, ETC.

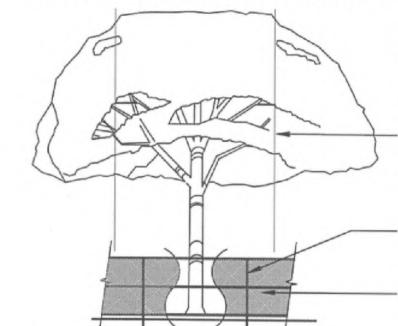

In no case shall the fence be installed less than ten feet from the trunk

Tree + Palm protection barriers to extend beyond the 'dripline' or to the 'critical root zone area' of all trees/palms to be protected. Extend where necessary to protect tree canopy roots

Barriers shall be a minimum of four feet high, and shall be constructed of continuous chain link fence with metal posts at eight-foot spacing, or of two-by-four-inch posts with three equally spaced two-by-four-inch rails. Posts may be shifted to avoid roots.

PROTECTION DETAIL NOTE CONTRACTOR TO INSTALL 'TREE / PALM PROTECTION FENCE BARRIERS' AROUND ALL EXISTING TREES OR PALMS AT THE START OF THE PROJECT. BARRIERS TO REMAIN IN PLACE THROUGHOUT THE DURATION OF THE PROJECT AND SHOULD NOT BE REMOVED OR DROPPED FOR ANY REASON WITHOUT AUTHORIZATION FROM THE CITY OF MIAMI BEACH URBAN FORESTER + PLANNING + ZONING DEPARTMENT


C.M.B. TREE / PALM PROTEC. DETAIL


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No.	Date	Description

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Project Name

CASA BAHIA


253 N COCONUT LANE Miami Beach, FL 3319

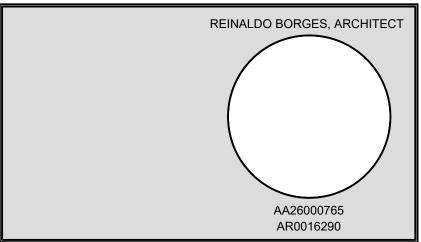Project Number Drawing Name

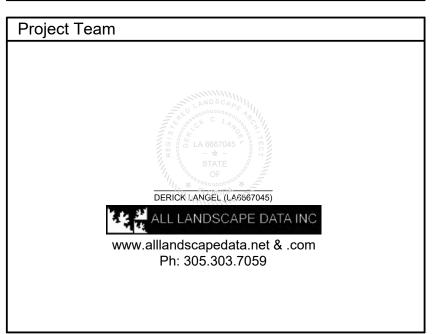EXISTING TREE


DISPOSITION

Scale:

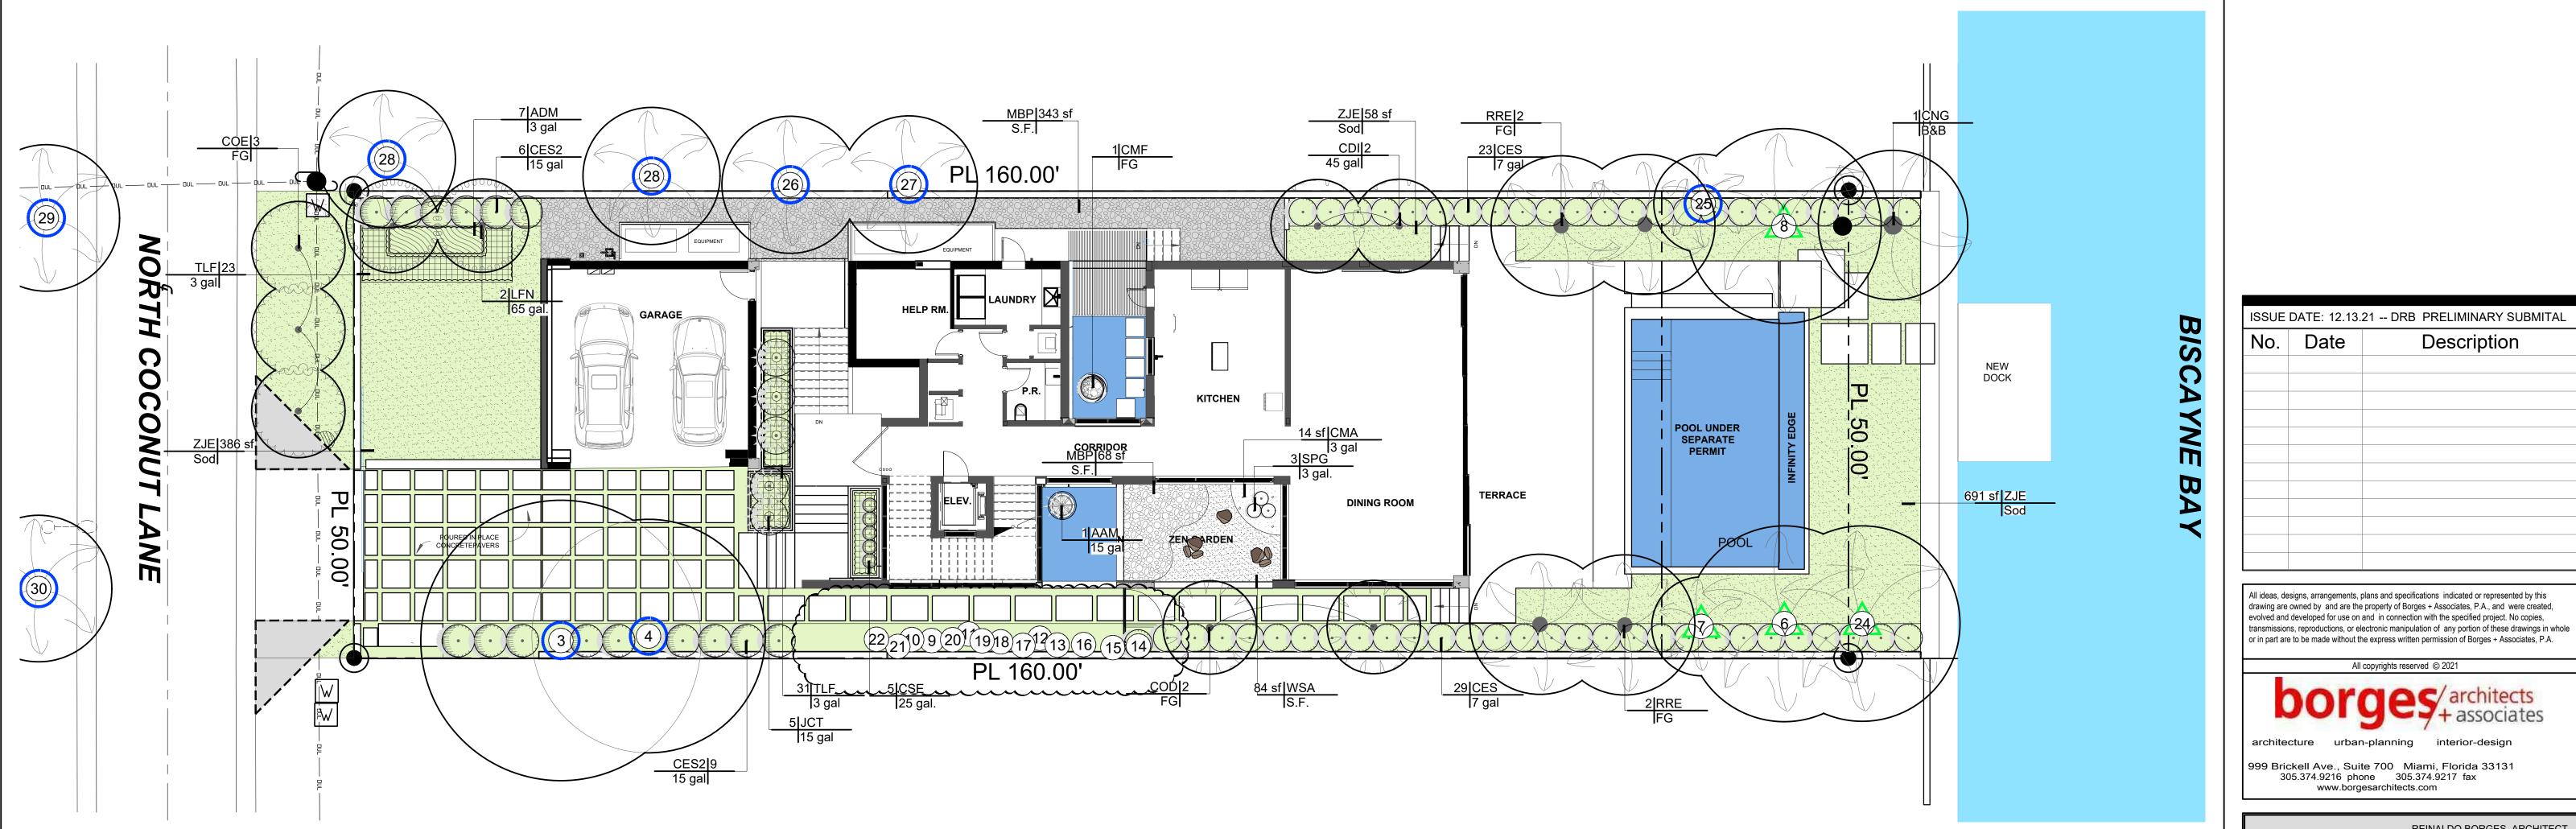

	INFORMATION REQUIRED TO BE PERMANENTLY AFFIXED TO PLANS Zoning District RS-4 Lot Area 8,000 SF Acr	es0.18	_
		REQUIRED/	
	OPEN SPACE	ALLOWED	PROVIDED
A.	Square feet of required Open Space as indicated on site plan:		
	Lot Area = $8,000$ s.f.x 25 % = $2,000$ s.f.	2,000 SF	2,622.4 SF
В.	Square feet of parking lot open space required as indicated on site plan:		
	Number of parking spaces N/A x 10 s.f. parking space =	N/A	N/A
C.	Total square feet of landscaped open space required: A+B=	2,000 SF	2,622.4 SF
	LAWN AREA CALCULATION		
A.	Square feet of landscaped open space required	2,000 SF	2,622.4 SF
В.	Maximum lawn area (sod) permitted= 50 % x _2,622 _ s.f.	1,311 SF	1,134 SF
	TREES		
Δ.	Number of trees required per lot or net lot acre, less existing number of		
	trees meeting minimum requirements=	_	wint O . C Den
	5+2 trees x N/A net lot acres - number of existing trees=	7	xist. 2 + 6 Prov 8
В.	% Natives required: Number of trees provided x 30% = 2.1	3	3
	% Low maintenance / drought and salt tolerant required:		
	Number of trees provided x 50%= 4	4	4
D.	Street Trees (maximum average spacing of 20' o.c.)		
	N/A linear feet along street divided by 20'=	N/A	N/A
E.	Street tree species allowed directly beneath power lines: (maximum average spacing of 20' o.c.):		
	50 linear feet along street divided by 20'=	3	3
		10	
	SHRUBS		
A.	Number of shrubs required: Sum of lot and street trees required x 12=	120	126
В.	% Native shrubs required: Number of shrubs provided x 50%=	63	104
	LARGE SHRUBS OR SMALL TREES		
A.	Number of large shrubs or small trees required: Number of required shrubs		
	100/	40	4-7
	x 10%=	12	17
В.		12	1/

small trees provided x 50%= 0

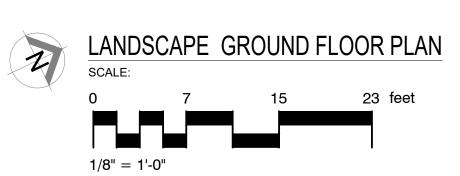

EXISTING TREE LEGEND

The Existing trees or palms transplanted, new location

The Existing trees and palms that remained in their original location

PLANT SCHEDULE									
TREES COD	QTY 2	BOTANICAL NAME Cananga odorata	COMMON NAME Ylang-Ylang	CONT FG	<u>DBH</u> 4"	HGT 16` OA	SRD		REMARKS
CDI	2	Coccoloba diversifolia	Pigeon Plum	45 gal	4"	14` OA	5`-6`		STD - Florida Native - Miami-Dade Landscape Manual - Very Drought Tolerant
LFN	2	Lagerstroemia fauriei `Natchez`	White Crape Myrtle	65 gal.	3"	14` OA	6`-8`		STD - Miami-Dade Landscape Manual - Drought Tolerant - 5` CT
STREET TREES COE	QTY 3	BOTANICAL NAME Conocarpus erectus sericeus	COMMON NAME Silver Buttonwood	CONT FG	<u>DBH</u> 2"	HGT 12` OA	SRD 6`		REMARKS Miami-Dade Landscape Manual-Florida Native- Drought tolerant- Standard
PALM TREES CNG RRE	QTY 1 4	BOTANICAL NAME Cocos nucifera `Green Malayan` Roystonea regia	COMMON NAME Coconut Palm Royal Palm	CONT B&B FG	<u>DBH</u> 10" 18"	<u>HGT</u> 14`-16` GW 10` GW	SRD 18` 16`		REMARKS Curved, Jamaican Certified
SHRUBS	QTY	BOTANICAL NAME	COMMON NAME	CONT	HGT 3`	SRD 3`	SPACING		REMARKS
AAM CMF	1	Agave americana Carmona microphylla	Century Plant Blue Fukien Tea	15 gal FG	3 2.5` OA	3 2.5`			Bonsai tree
CES	52	Conocarpus erectus sericeus	Silver Buttonwood	7 gal	4` OA	3`			Florida Native
CSE	5	Cupressus sempervirens	Italian Cypress	25 gal.	8`-10` OA	1.5`			Tionad Hauro
SPG	3	Eugenia myrtifolia 'Globulus'	Dwarf Brush Cherry	3 gal.	2.5` OA	1`			
JCT	5	Juniperus chinensis `Torulosa`	Hollywood Juniper	15 gal	5`	·			
LARGE SHRUBS	QTY	BOTANICAL NAME	COMMON NAME	CONT	HGT	SRD	SPACING		REMARKS
CES2	17	Conocarpus erectus sericeus	Silver Buttonwood	15 gal	6` OA	4`	<u> </u>		Florida Native
SHRUB AREAS	QTY	BOTANICAL NAME	COMMON NAME	CONT	HGT 1	SRD	WEIGHT	SPACING	REMARKS
ADM	7	Asparagus densiflorus `Myers`	Myers Asparagus	3 gal	1,	1,		24" o.c.	El . I N () 14 . E .
TLF	54	Tripsacum floridanum	Florida Gamagrass	3 gal	2`	2`		20" o.c.	Florida Native - Miami-Dade Landscape Manual
GROUND COVERS	QTY	BOTANICAL NAME	COMMON NAME	CONT	HGT	SRD		SPACING	
CMA	14 sf	Carissa macrocarpa 'Emerald Blanket'	Emerald Blanket Natal Plum	3 gal	12"	12"			
MBP	418 sf	Mexican Black Pebbles	Black Pebbles 1"-3"	S.F.					
ZJE	1,134 sf	Zoysia japonica `Empire`	Korean Grass	Sod					
MULCH & AGGREGATES	QTY	BOTANICAL NAME	COMMON NAME	CONT	<u>HGT</u>	SRD		SPACING	
WSA	84 sf	White Sand	White Sand	S.F.					24" Layer

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	G-
	REINALDO BORGES, AR
3	
ida Native - Miami-Dade Manual - Very Drought	
mi-Dade Landscape Prought Tolerant - 5` CT	AA26000765 AR0016290
3	Project Team
e Landscape orida Native- Drought tandard	1 Tojost Todin
S maican Certified	ANDSCARE THE ANDSC
5	STATE OF THE STATE
e tive	DERICK LANGEL (LA6567045)
	ALL LANDSCAPE DATA INC
	www.alllandscapedata.net & .com



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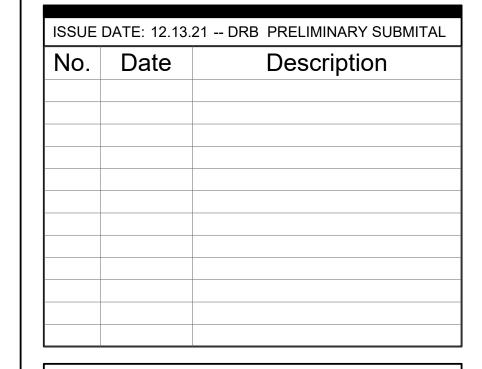
REINALDO BORGES, ARCHITECT

Description

oject Name	
	CASA
	BAHIA
	253 N COCONUT LANE Miami Beach, FL 3319

Project Numb	er
Drawing Nam	е
	LANDSCAPE
	PLAN
Scale:	Drawing Number






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Project Name

CASA BAHIA

253 N COCONUT LANE Miami Beach, FL 3319

Project Number

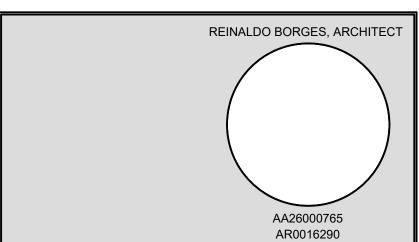Drawing Name

LANDSCAPE IMAGES

Scale:

Drawing Number

L-03


GENERAL NOTES

- 1. Landscape Contractor is responsible for verifying locations of all underground and overhead utilities and easements prior to commencing work. All Utility companies and/or the General Contractor shall be notified to verify utility locations prior to digging. Utility trenching is to be coordinated with the Landscape plans prior to beginning of project. The Owner or Landscape Architect shall not be responsible for damage to utility or irrigation lines.
- 2. Landscape Contractor shall examine the site and become familiar with conditions affecting the installation prior to submitting bids. Failure to do so shall not be considered cause for future extras or complaints.
- 3. Landscape Contractor is responsible for verifying all plant quantities prior to bidding and within (7) seven calendar days of receipt of these plans shall notify the Landscape Architect in writing of any and all discrepancies. In case of discrepancies planting plans shall take precedence over plant list.
- 4. No substitutions shall be made without prior consent of the Landscape Architect, City Urban Forester and or the Planning Department. Plant material supply is the responsibility of the Landscape Contractor, and he/she shall take steps to insure availability at time of planting.
- 5. All plant material shall meet or exceed the size on the plant list. In all cases meeting the height and the spread specifications shall take precedence over container size.
- 6. The Landscape Contractor is responsible for coordinating tree and palm removals and transplants shown on the Tree/Palm Disposition Plan. The Landscape Contractor is to remove and discard from site existing unwanted trees, palms, shrubs, groundcovers, sod and weeds within landscape areas.
- 7. All planted areas to be outfitted with automatic irrigation system providing 100% coverage and 50% overlap. A rain sensor must be
- 8. Landscape contractor to provide finish grade 3" lower than FFE of all hardscapes, i.e. roads, walks, curbs, pavers, etc....., to accommodate 3" layer of mulch.
- 9. All tree and Palm relocations shall be performed in accordance with ANSI A-300 (Part 6) standards and industry accepted good horticultural practices by an ISA Certified Arborist or ASCA Consulting Arborist.


PLANTING NOTES


- 1. Landscape Contractor shall furnish and install all trees, palms, shrubs, groundcover, sod, planting soil, fertilizer, herbicide, preemergence herbicide, seed, and mulch.
- 2. Landscape Contractor shall guarantee all plant material for a period of one year from the day of final acceptance by the Landscape
- 3. All plant material shall be Florida #1 or better, as defined in the Grades and Standards for Nursery Plants, Part I and II by the State of Florida Department of Agriculture.
- 4. Material not meeting Florida #1 or better will not be accepted, Landscape Architect, City Urban Forester and or the Planning Department staff to approve ROW material before it is planted.
- 5. Landscape Contractor shall coordinate his work with that of the Irrigation and Landscape Lighting Contractor.
- 6. The Landscape Contractor shall treat plant areas with preemergence herbicide after weeds and grass have been removed. Landscape Contractor shall wait (7) seven days after preemergence treatment prior to planting.
- 7. Planting soil shall be a mix of 30% inland muck and 70% freshwater sand. Planting soil mix/backfill shall be clean and free of construction debris, weeds, rock and noxious pests and disease.
- 8. All soil mix in plant beds for groundcovers, shrubs, palms and trees shall be as per details. All other areas shall be dressed with a minimum of 4" topsoil.
- 9. All planting areas and planting pits shall be tested for sufficient percolation prior to final planting and irrigation installation to ensure proper drainage. Plant beds in parking lots and in areas compacted by heavy equipment shall be de-compacted so that drainage is
- 10. All synthetic burlap, string, cords or wire baskets shall be removed before trees are planted. All synthetic tape shall be removed from branches and trunks prior to final acceptance. The top 1/3 of the burlap shall be removed or tucked into the plant pit before the trees are backfilled.
- 11. Landscape Contractor is responsible for mulching all plant beds and planters with a minimum 3" layer of natural color Eucalyptus or Environmulch immediately after planting. In no case shall Cypress or red mulch be used. Mulch shall not be applied within 6" of any tree or palm trunk that are installed or incorporated into the project.
- 12. All Trees/Palms in sod areas are to receive a 36"/48" diameter mulched saucer at the base of the trunk respectively.
- 13. Landscape Contractor shall guy and stake all trees and palms as per specifications and details. No nails, screws or wiring shall penetrate the outer surface of trees and palms. All guying and staking shall be removed twelve months after planting. Exceptions require written authorization from the City Urban Forester.
- 14. All palm and tree guy wires and bracing are to be flagged for visibility, for their duration. All unattended and unplanted tree pits shall be properly barricaded and flagged during construction.
- 15. All broken branches and clear trunk branches on street trees are to be pruned according to ANSI A-300 Guidelines for Tree Pruning to min. 5'-0" height clearance to the base of canopy. All tree and root pruning activities shall be performed by ISA Certified Arborist and or ASCA Consulting Arborist in accordance with ANSI A-300 standards and industry accepted good horticultural practices.
- 16. Landscape Contractor to provide all plants with fertilizer 30 days after installation. Fertilizer shall comply with state fertilizer laws. It shall have a chemical designation as indicated for each type of plant: Palms: 12-4-12 N-P-K, Slow Release Palm Special with micronutrients.


Shrubs, Groundcover and Trees: 6-6-6 N-P-K, with micronutrients.

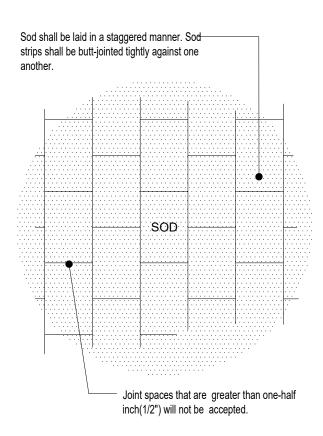

Typical Sod Planting Detail N.T.S.

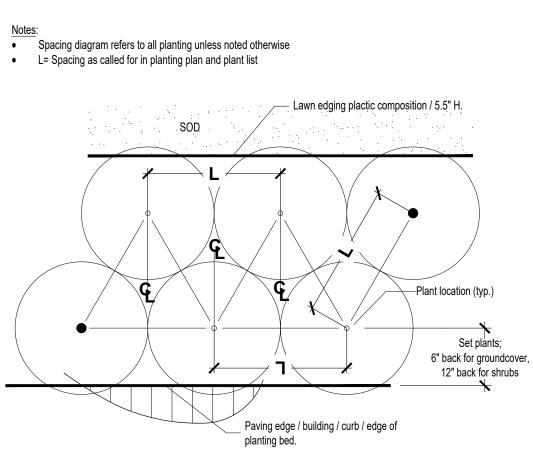

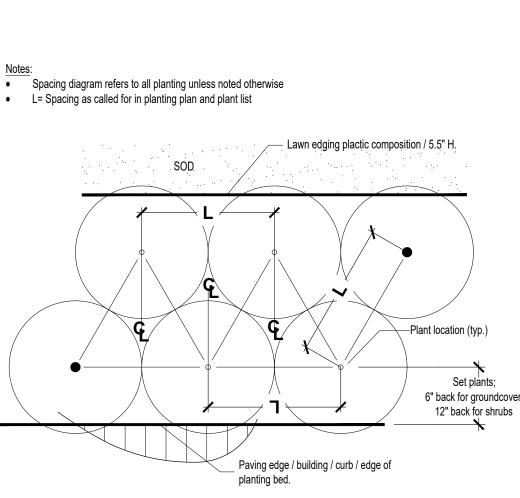

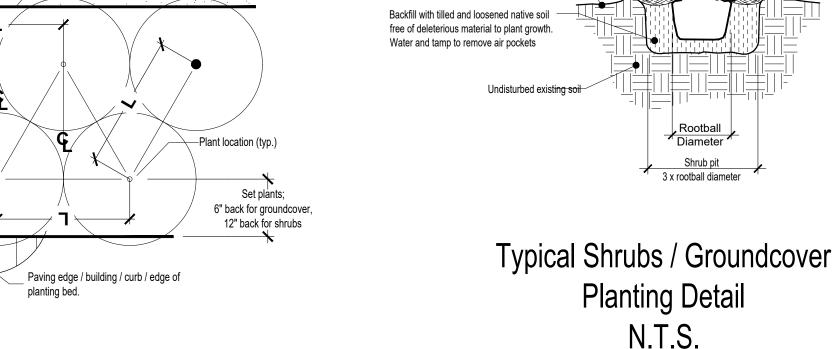

THE RIGHT OF WAY'S PERMIT IS REQUIRE PRIOR TO START THE


finished grade.


Do not mulch on top of root ball

- Apply mulch to a

WORK IN THE RIGHT OF WAY

Finish grade

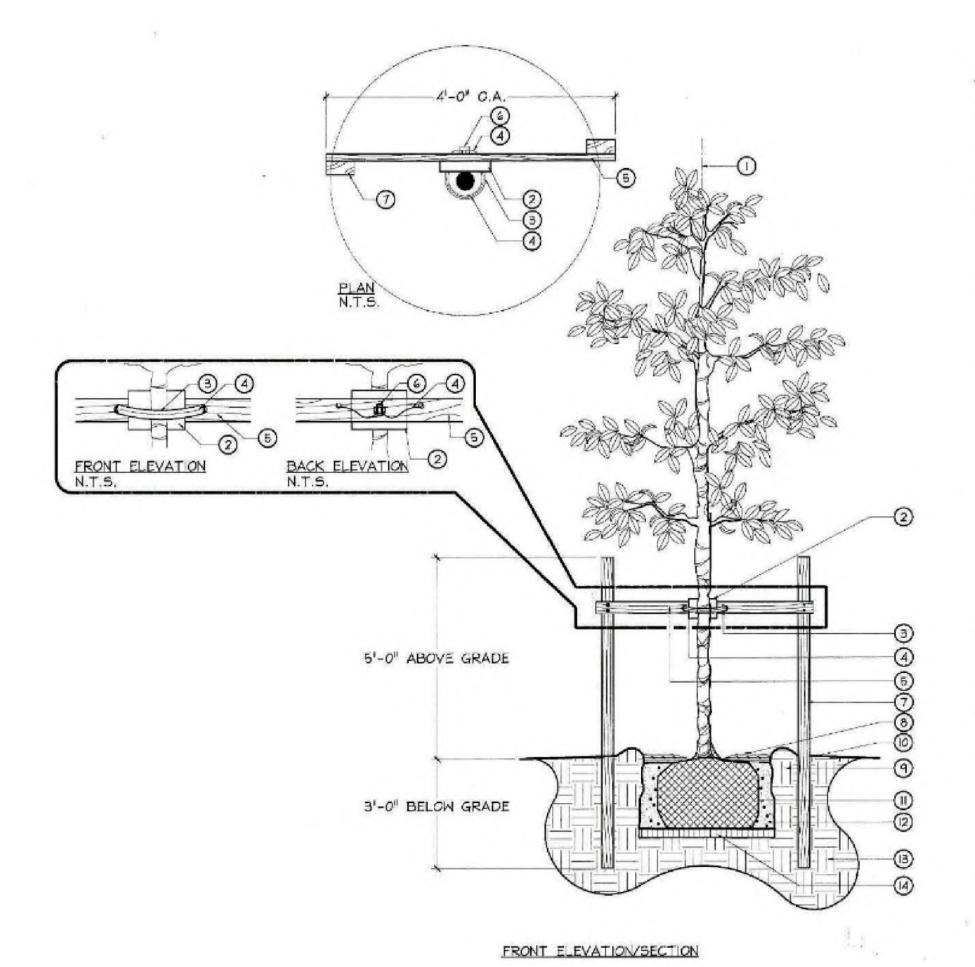

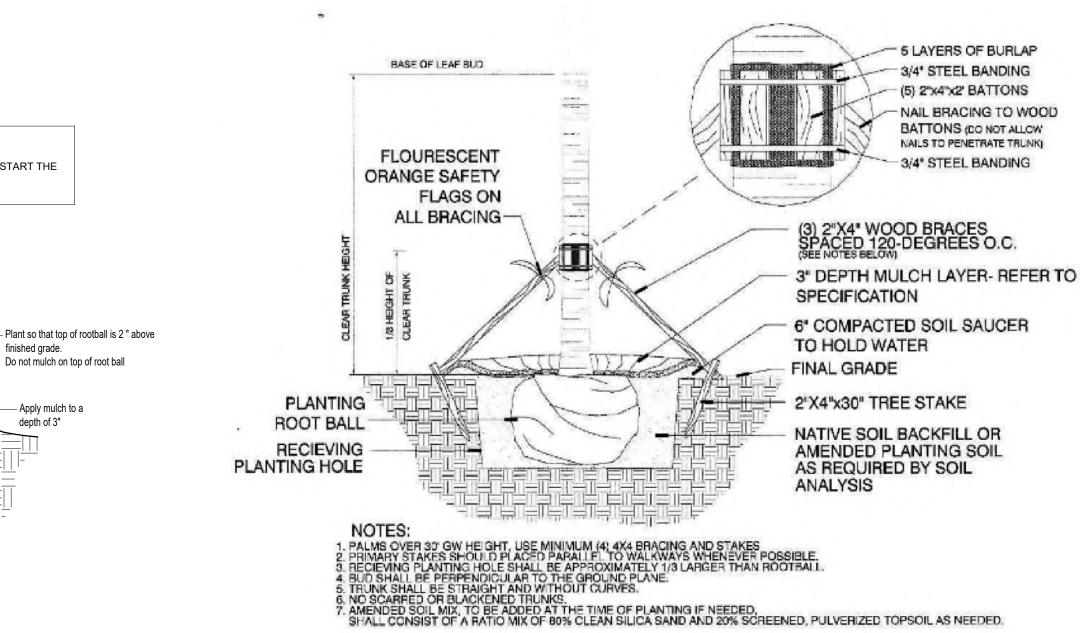


City of Miami Beach Typical Palm Planting Detail N.T.S.

- (1) SET TREE PLUMB IN PLANTING PIT.
- (2) PROTECT TREE TRUNK WITH I NOMACO® STYROFOAM PADDING GUARDS, #6U048048, AS SPECIFIED, OR APPROVED EQUAL.
- (3) AMAZON HOUSE AND RUBBER®, I 1 AIR HOSE #kli46 OR APPROVED EQUAL, TO COVER 10 GAUGE WIRE.
- 1 10 GAUGE GALVANIZED WIRE. WIRE PRODUCT®, OR APPROVED EQUAL.
- (5) I 2"x4'x4' NON TREATED LANDSCAPE TIMBER AS SPECIFIED. FASTEN WITH 4 35" DECK SCREWS TO 2'x4'x8' P.T. LANDSCAPE TIMBERS.
- 6 I I MALLEABLE CLAMP FASTENER FOR WIRE. SUPPLIER: FLORIDA WIRE OR
- (7) 2 2"x4" X B' P.T. LANDSCAPE TIMBER AS
- SPECIFIED. (8) 1"-2" MULCH DEPTH LAYER ON ROOT BALL.
- (9) 4' WATER RING, (WITHIN ROOTBALL DIA.), FILL 3 TIMES IMMEDIATELY AFTER PLANTING, RAKE OUT PRIOR TO MULCHING AND PLANTING.
- (10) ROOT FLARE I"-2" ABOVE FINISHED GRADE.
- (II) B\$B OR CONTAINERIZED ROOTBALL. REMOVE ALL BURLAP IF NOT 100% BIODEGRADABLE. REMOVE CONTAINER FROM ROOTBALL PRIOR TO PLANTING.
- (2) BACKFILL, TOP SOIL TYP, OF AREA, BACKFILL SHALL BE AMENDED THROUGHOUT ENTIRE SITE WITH FERTILIZER AND COMPOST AS REQUIRED.
- (B) UNDISTURBED SUBGRADE.
- (4) COMPACT SOIL IMMEDIATELY BENEATH THE ROOT BALL TO PREVENT SETTLING.

NOTES : I. CONTRACTOR TO ASSURE PERCOLATION IN TREE PITS.

2, NO MULCH WITHIN 4" OF TRUNK.

City of Miami Beach Typical Tree Planting Detail N.T.S.

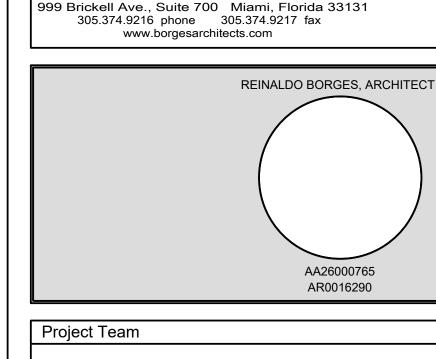

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Description



Project Name

CASA **BAHIA**

253 N COCONUT LANE Miami Beach, FL 3319

Project Number Drawing Name

LANDSCAPE DETAILS

Scale:

Drawing Number

L-04