
	SING	LE FAMILY RESIDENT	TIAL - ZONING D	ATA SHEET				
ΓΕΜ #	Zoning Information							
	Address:	4366 MICHIGAN AVE DR MIAMI BEACH FL33139						
	Folio number(s):	02-3222-008-0460						
	Board and file numbers :	DRB#16-0085						
	Year built:	1940	Zoning District:		RS-3			
	Based Flood Elevation:	+7.0"NGVD	Grade value in NGVD:	4.075'				
	Adjusted grade (Flood+Grade/2):	5.54'FT	Free board:		+8'-0" NGVD			
	Lot Area:	9,270 sf						
	Lot width:	80'	Lot Depth:	115'				
	Max Lot Coverage SF and %:	2,781 (30%)	Proposed Lot Coverage SF and %:		2,312 SF (24.9%)			
	Existing Lot Coverage SF and %:	2,281SF	Lot coverage deducted (garage-storage) SF:		0sf			
	Front Yard Open Space SF and %:	921 sf (57.4%)	Rear Yard Open Space	SF and %:	1,387 SF (85.9%)			
	Max Unit Size SF and %:	4,635 SF (50%)	Proposed Unit Size SF	and %:	3,852 SF (41.6%)			
	Existing First Floor Unit Size:	1,986 SF	Proposed First Floor L		2,312 SF			
	Existing Second Floor Unit Size		Proposed Second Floo and % (Note: to excee the main home requir	1,540SF (66.6%)				
		XXX	Proposed Second Floor Unit Size SF and %:		1,540SF (40%)			
			Proposed Roof Deck Area SF and % (Note: Maximum is 25% of the enclosed floor area immediately below):		N/A			
		Required	Existing	Proposed	Deficiencies			
	Height:	24'-0"	13'-0"	24'-0"	N/A			
	Setbacks:							
	Front First level:	20'-0"	25.13'	30'-0"	N/A			
	Front Second level:	30'-0"	N/A	30'-0"	N/A			
	Side 1:	10'-0"	7.52'	10'-0"	N/A			
	Side 2 or (facing street):	10'-0"	7.49'	19'-11"	N/A			
	Rear:	20'-0"	45.38'	29'-3"	N/A			
	Accessory Structure Side 1:	N/A	N/A	N/A	N/A			
	Accessory Structure Side 2 or (facing street) :	N/A	N/A	N/A	N/A			
	Accessory Structure Rear:	N/A	N/A	N/A	N/A			
	Sum of Side yard :	20'-0"	15.01'	29'-3"	3'-0"			
	Located within a Local Historic District	no						
	Designated as an individual Historic Sin	gle Family Residence Site?	no					
	Determined to be Architecturally Signif		no					
tes	:							
not	applicable write N/A							
oth	ner data information should be presente	d like the above format						


#### PROPOSED BUILDING - SITE PLAN

MIAMI BEACH, FLORIDA

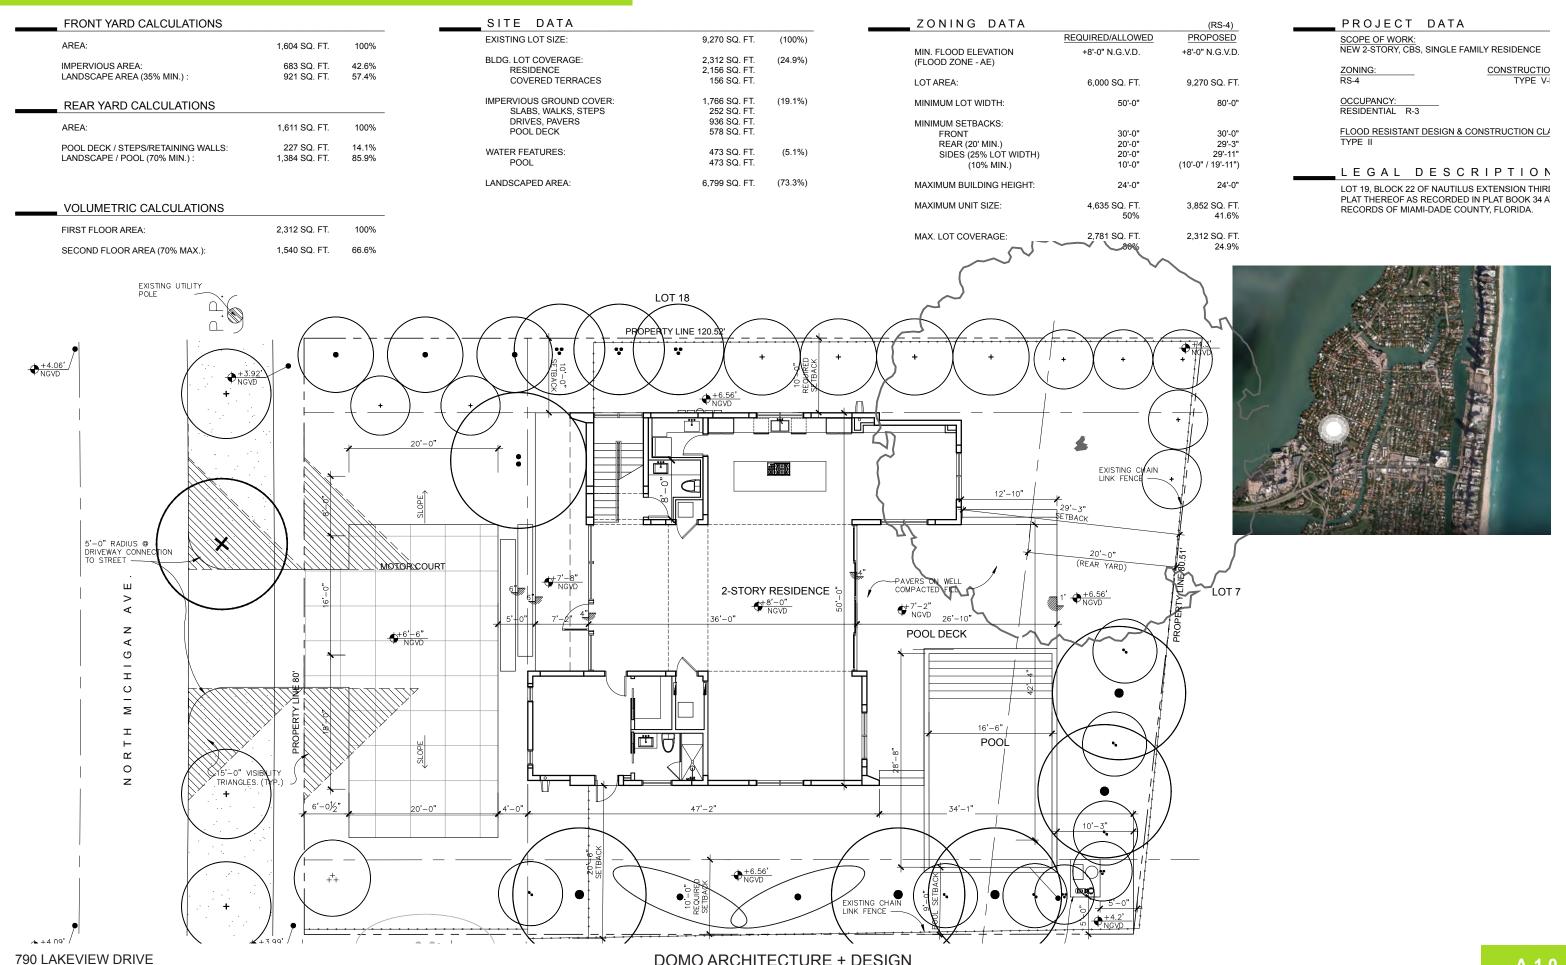


## PROPOSED BUILDING - GROUND FLOOR PLAN +4.30' NGVD +6.56' NGVD +6.56 NGVD DINING POWDER ROOM $\xrightarrow{\operatorname{SL.}}$ MOTOR COURT (DRIVEWAY) LINE OF WALKWAY POOL DECK +8'-0" NGVD FOYER ⊕+7'-2" NGVD +6.56' NGVD BEDROOM #1 MEDIA


# PROPOSED BUILDING - SECOND FLOOR PLAN MASTER BEDROOM \ IMASTER LOW ROOF ⟨SL. |" PER SL. I" PERW H +20'-0" ŁOW ROOF 17) BEDROOM #2.1 BEDROOM #3 BATH (15) 4 8 4'-0" 10'-2" 47'-2"

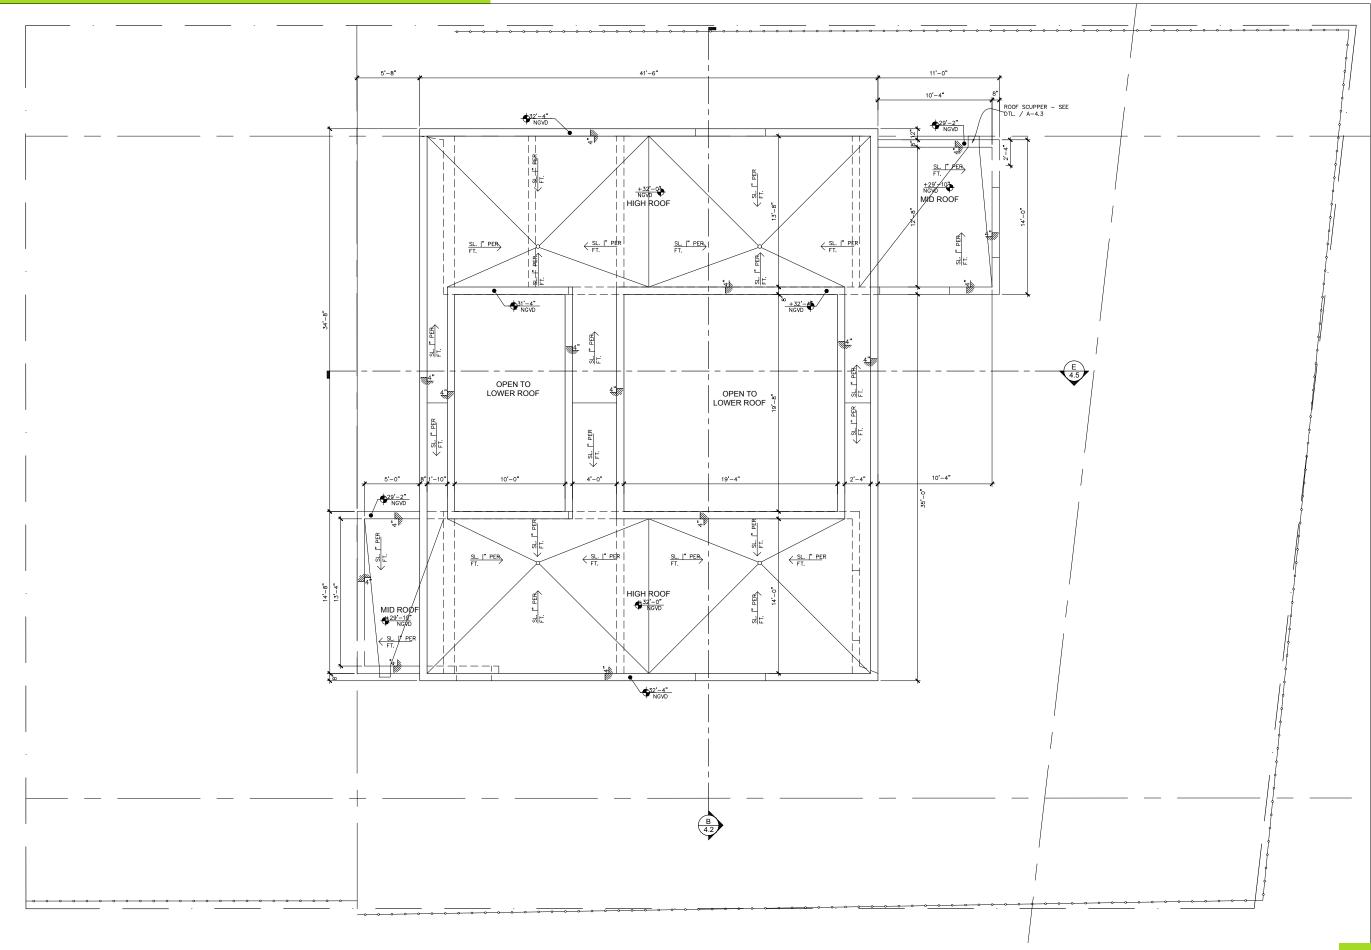


#### **ZONING DIAGRAM - LOT COVEAGE**

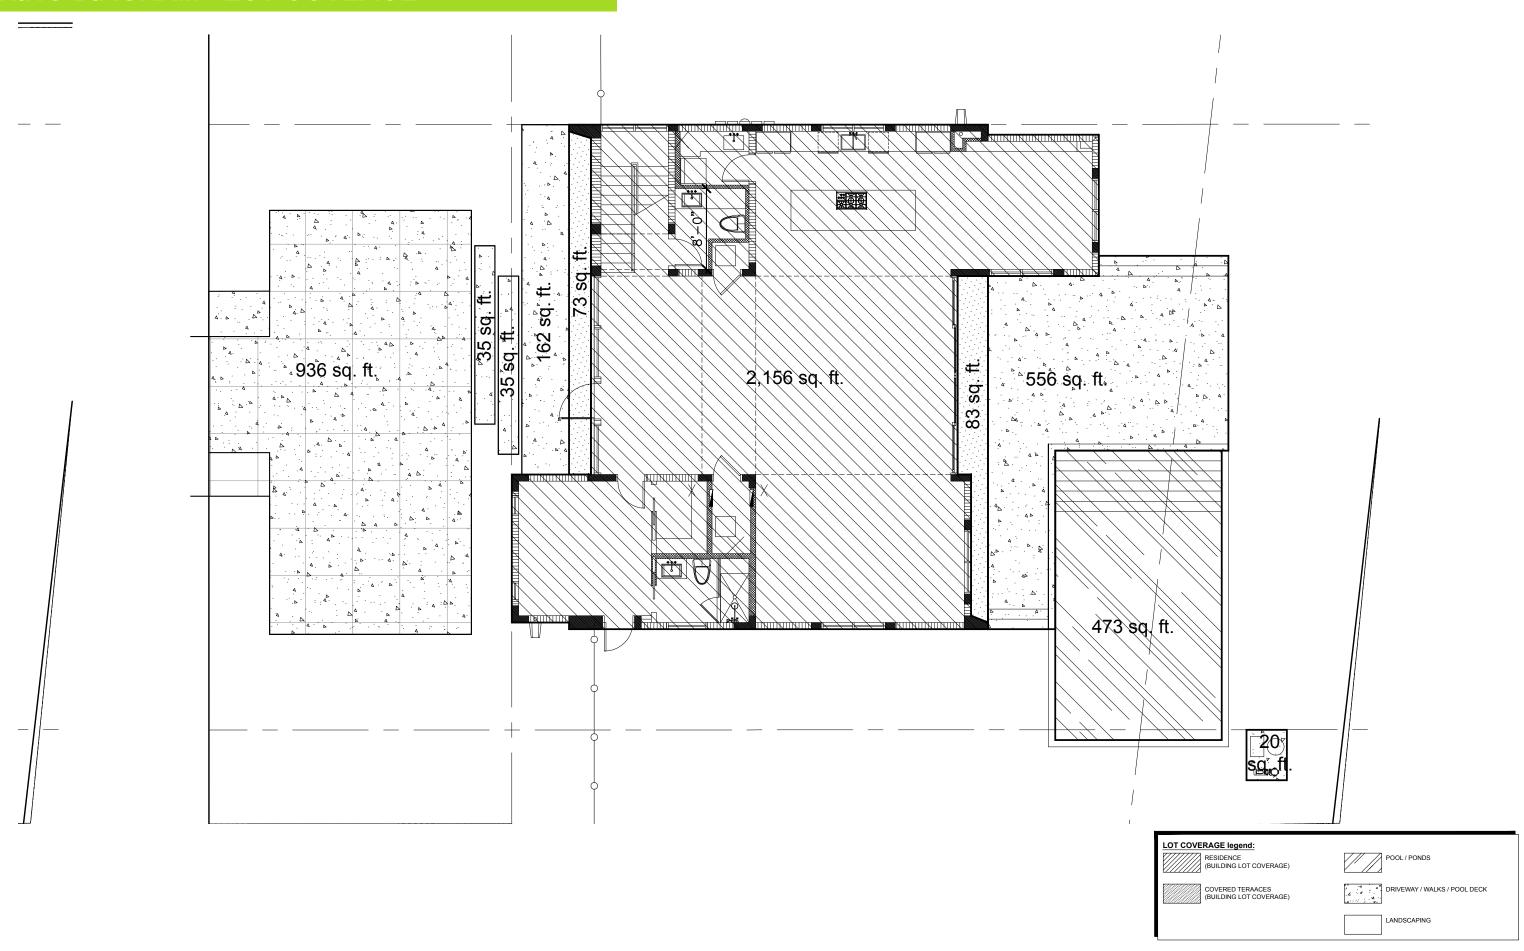


#### **ZONING DIAGRAM - UNIT SIZE**

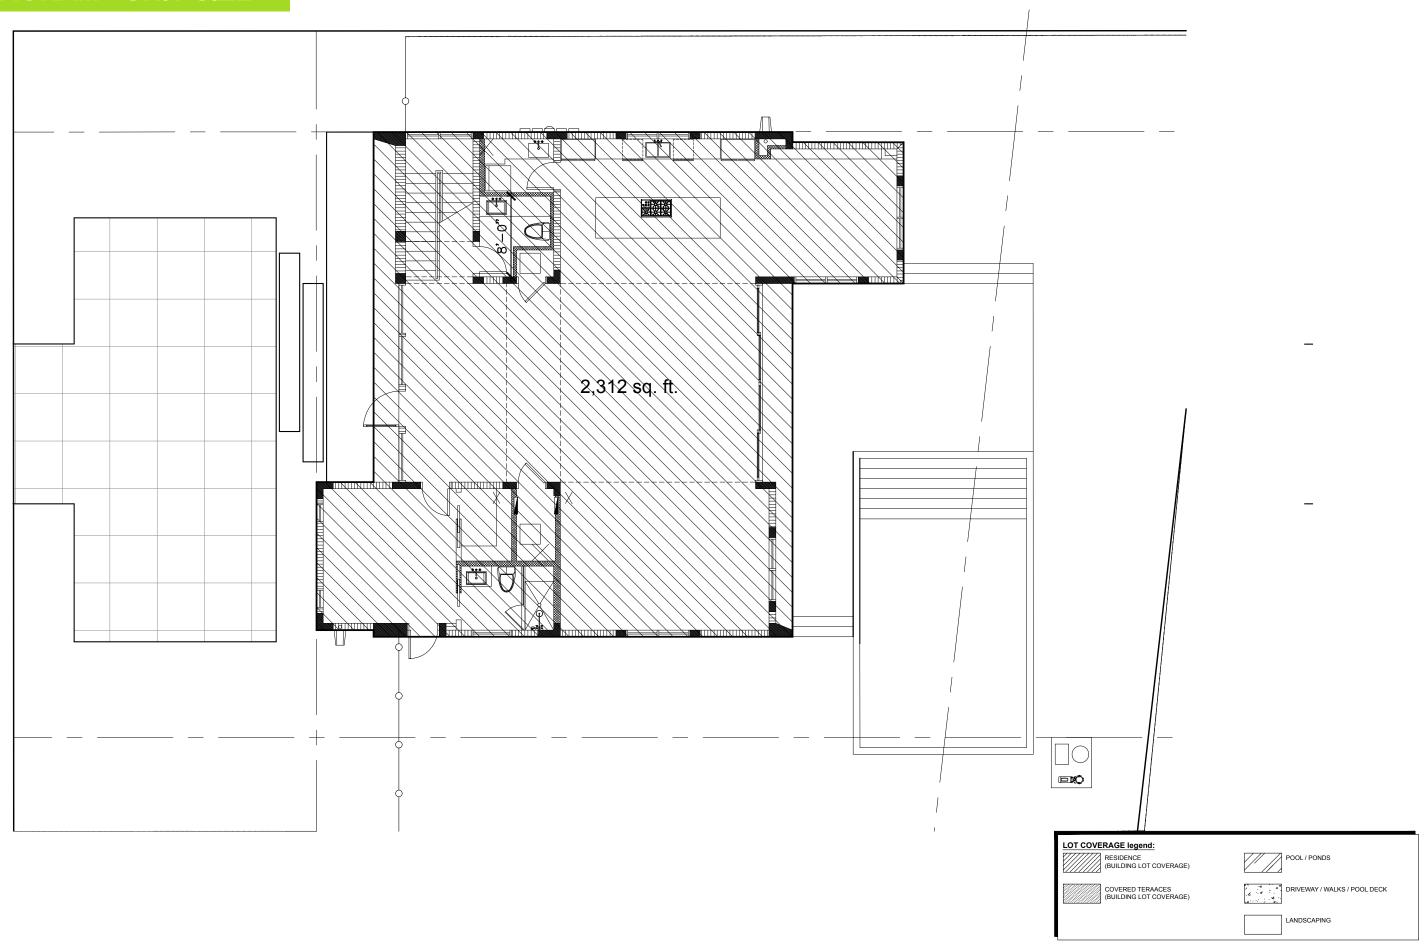


#### **ZONING DIAGRAM - UNIT SIZE**

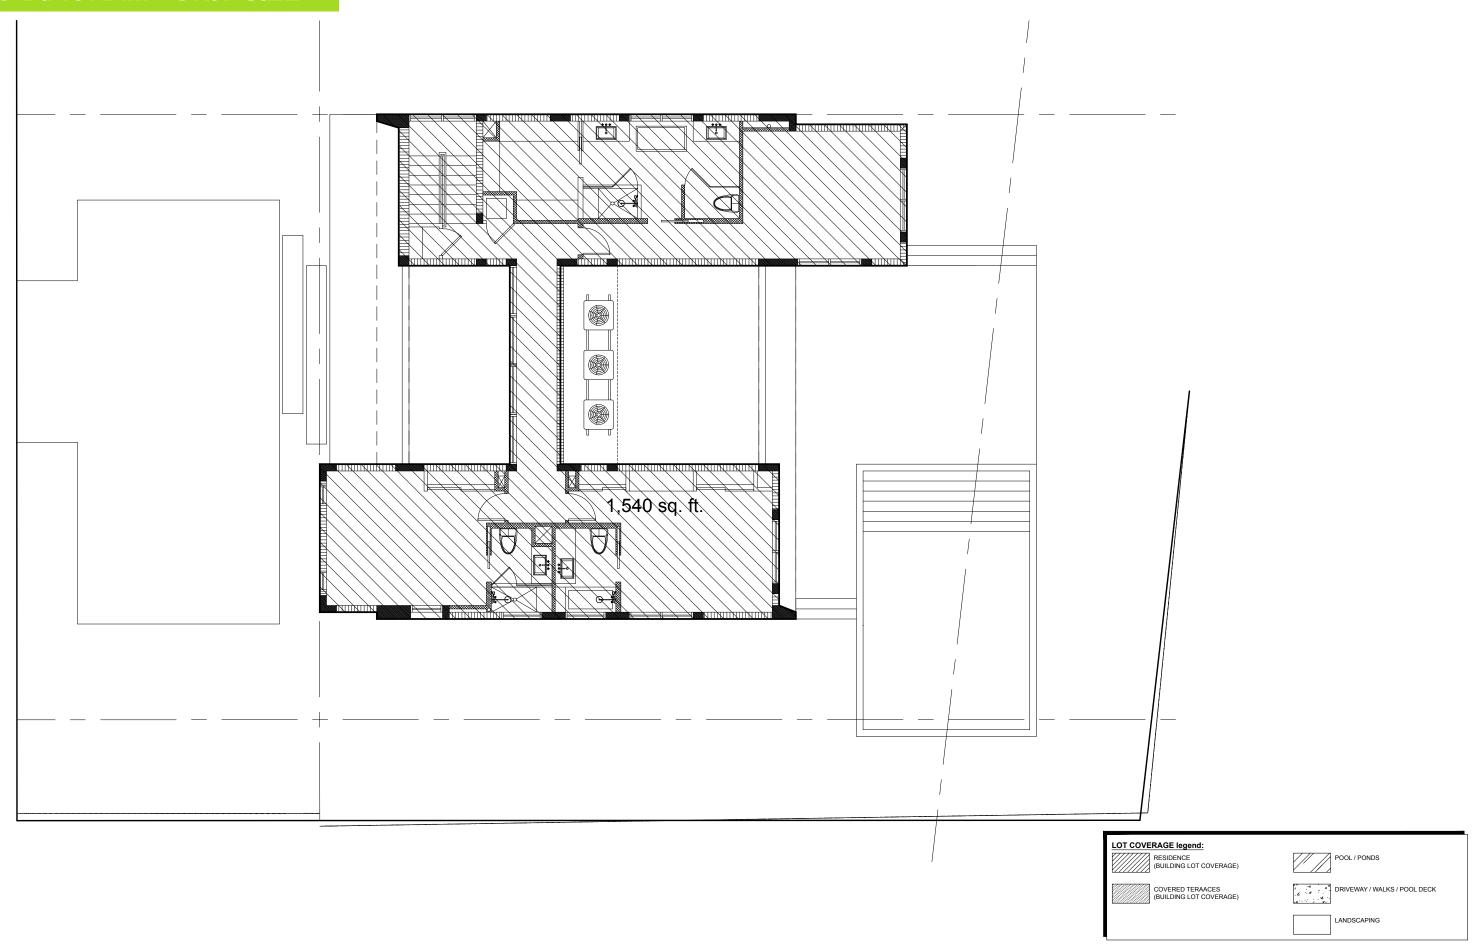


#### **ZONING DIAGRAM - OPEN SPACE**

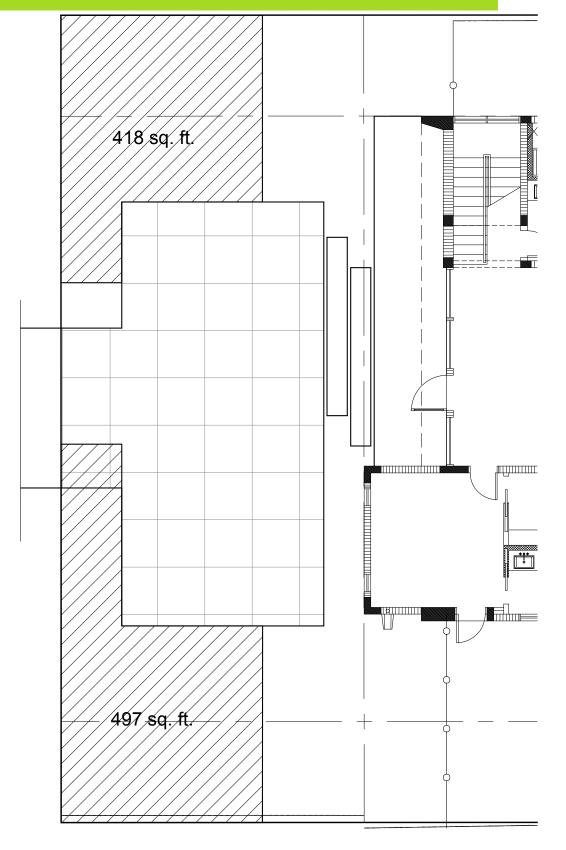

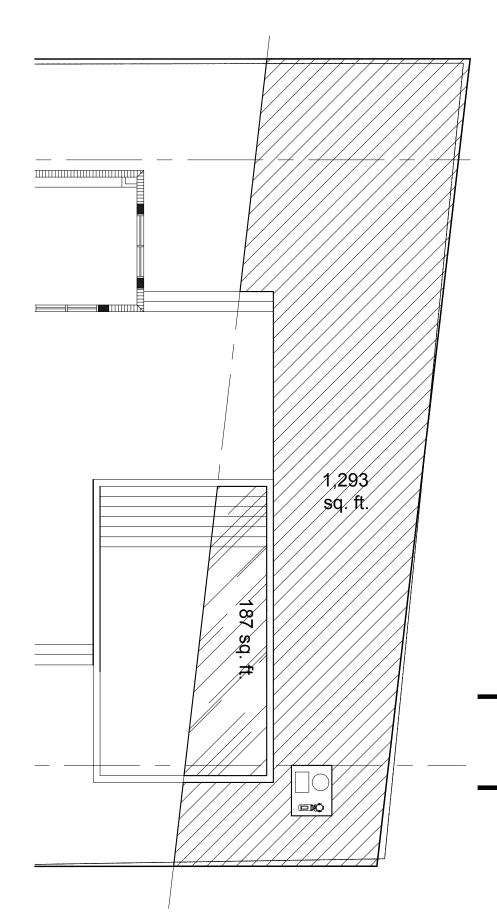

#### FRONT YARD CALCULATIONS

AREA:	1,604 SQ. FT.	100%
IMPERVIOUS AREA: LANDSCAPE AREA (35% MIN.) :	683 SQ. FT. 921 SQ. FT.	42.6% 57.4%
REAR YARD CALCULATIONS		
AREA:	1,611 SQ. FT.	100%
POOL DECK / STEPS/RETAINING WALLS: LANDSCAPE / POOL (70% MIN.):	227 SQ. FT. 1,384 SQ. FT.	14.1% 85.9%

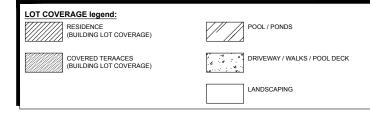

## **ZONING DIAGRAM - AXONOMETRIC**













## **ZONING DIAGRAM - AXONOMETRIC**

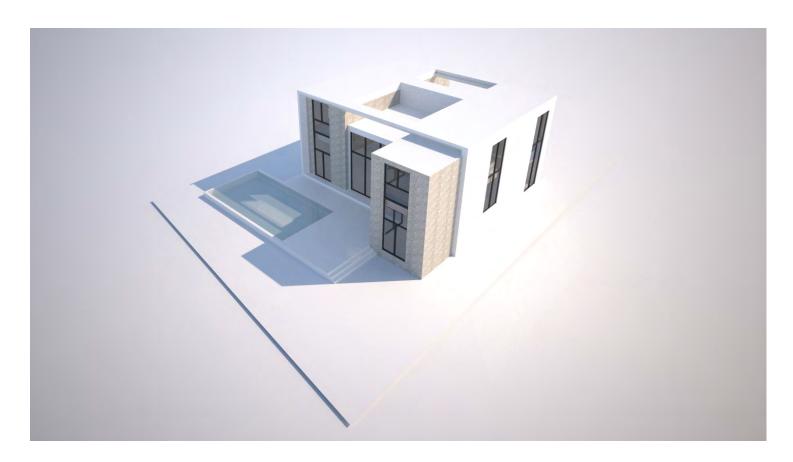

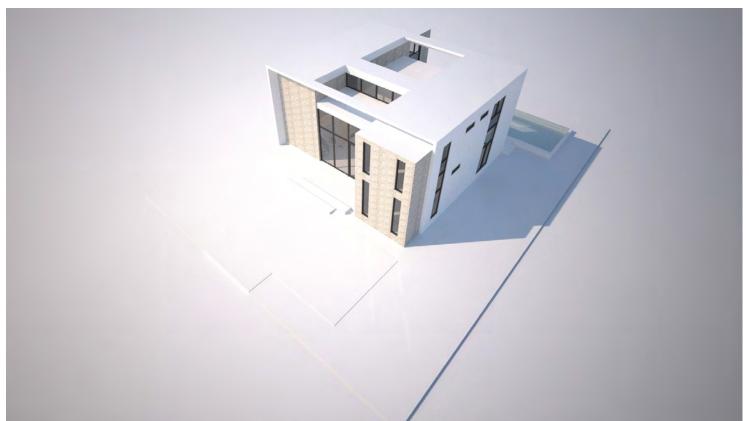

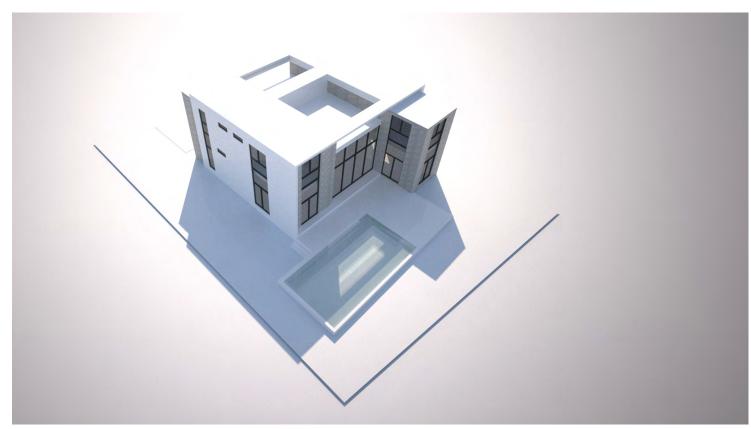

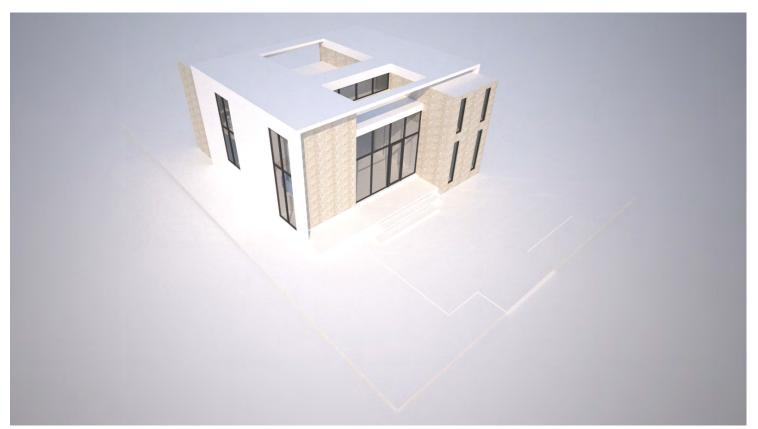

#### MATERIAL BOARD



CLADDING







BRONZE METAL MT1,2 FINISH

GL1 CLEAR GLAZING

ST1

#### **RENDERED ELEVATIONS - SOUTH**



#### **RENDERED ELEVATIONS - NORTH**





#### **RENDERED ELEVATIONS - WEST**




#### **RENDERED ELEVATIONS - EAST**




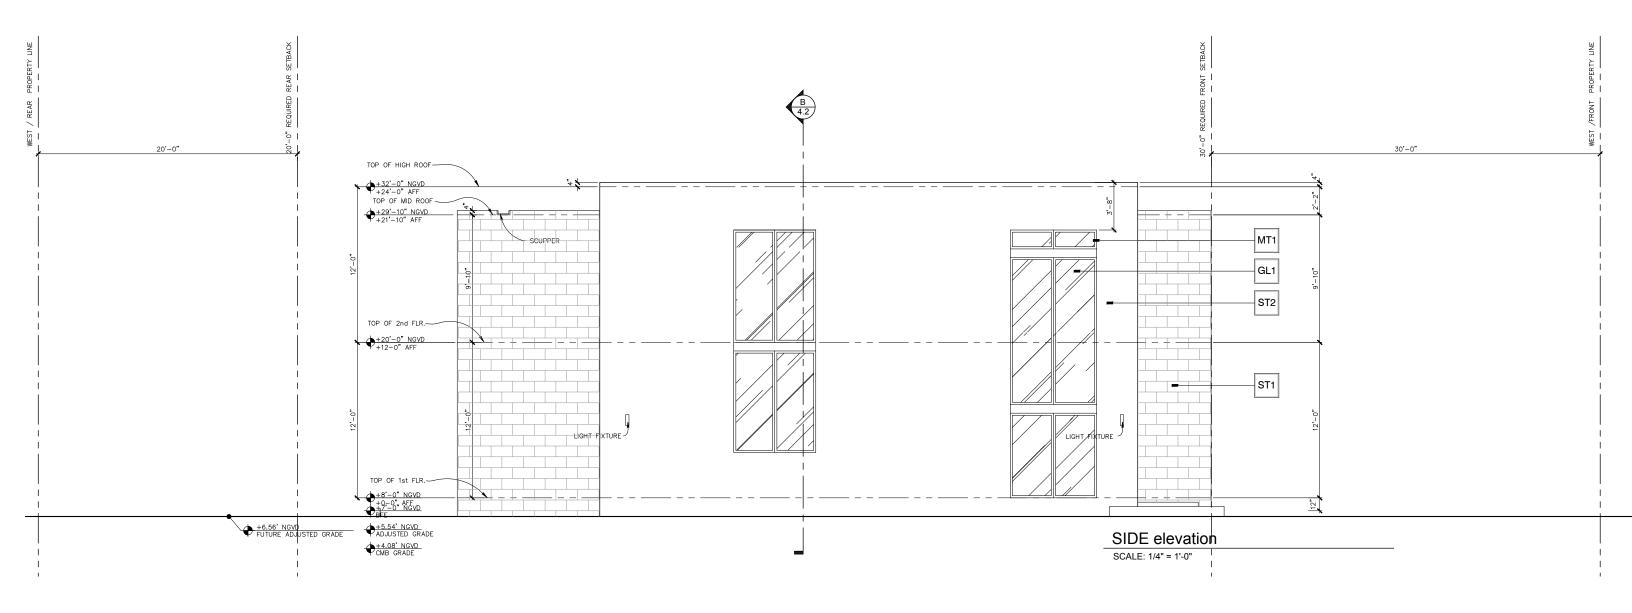


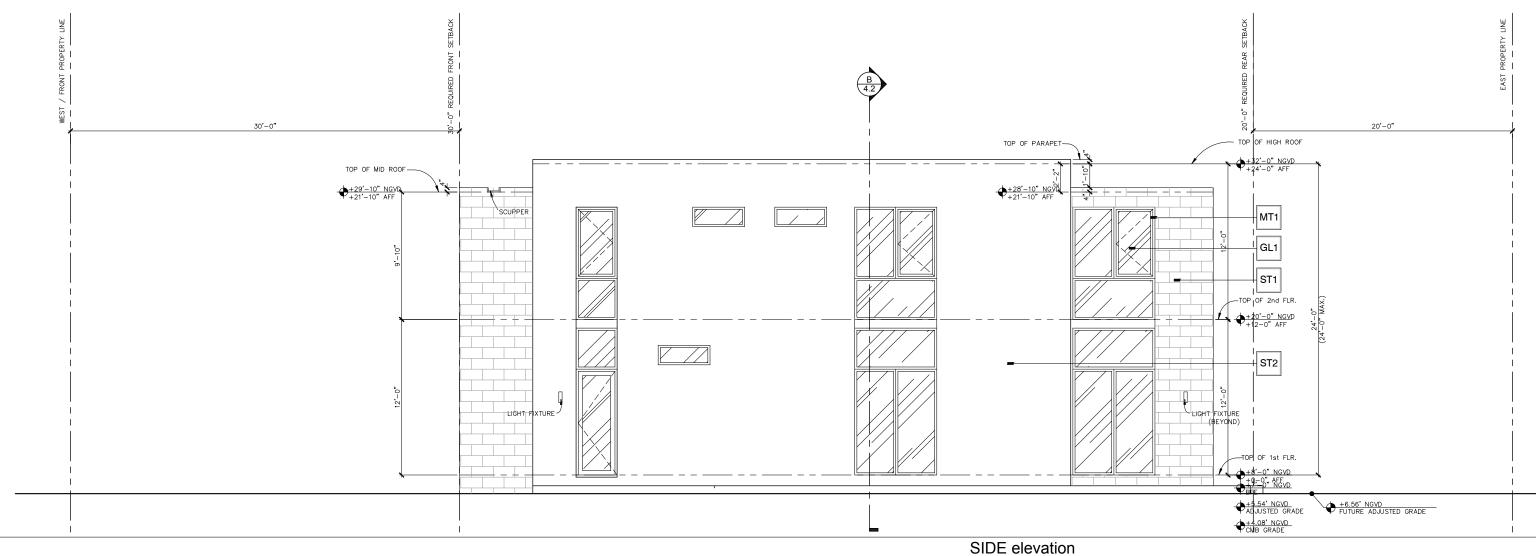



SCALE: 1/4" = 1'-0"

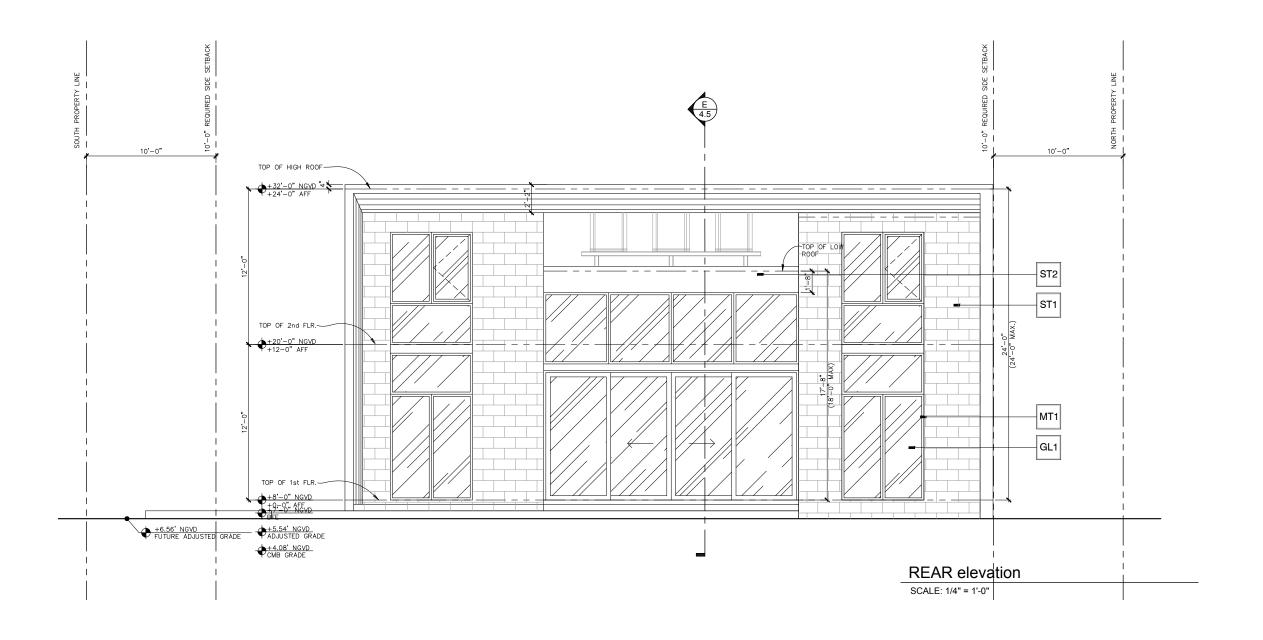

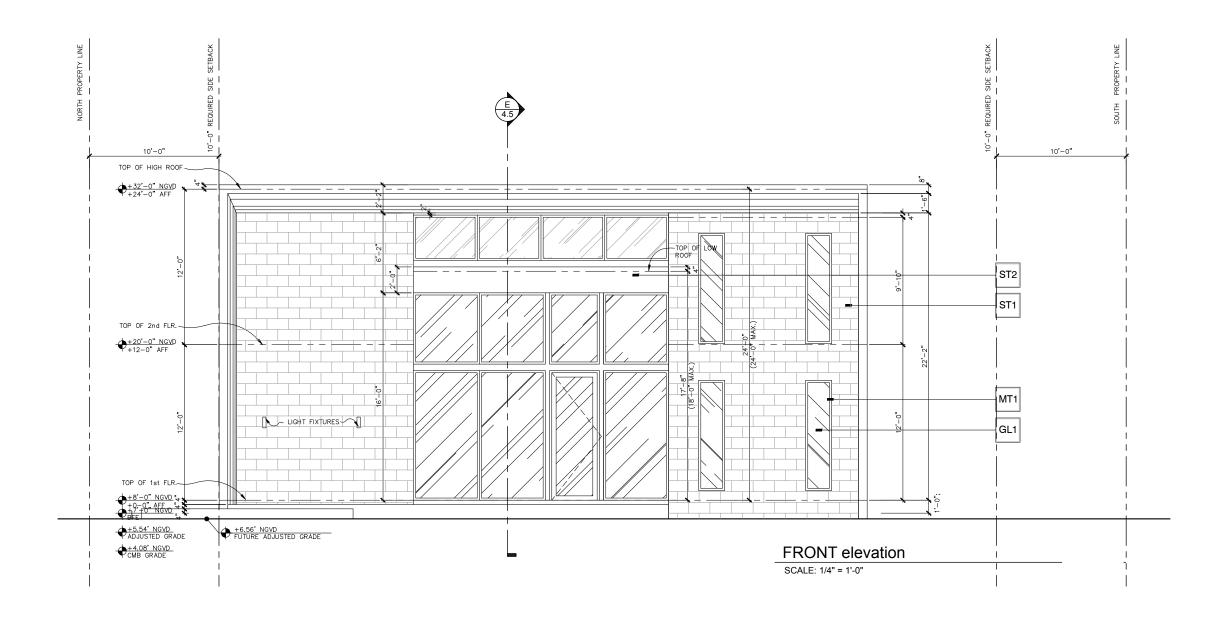

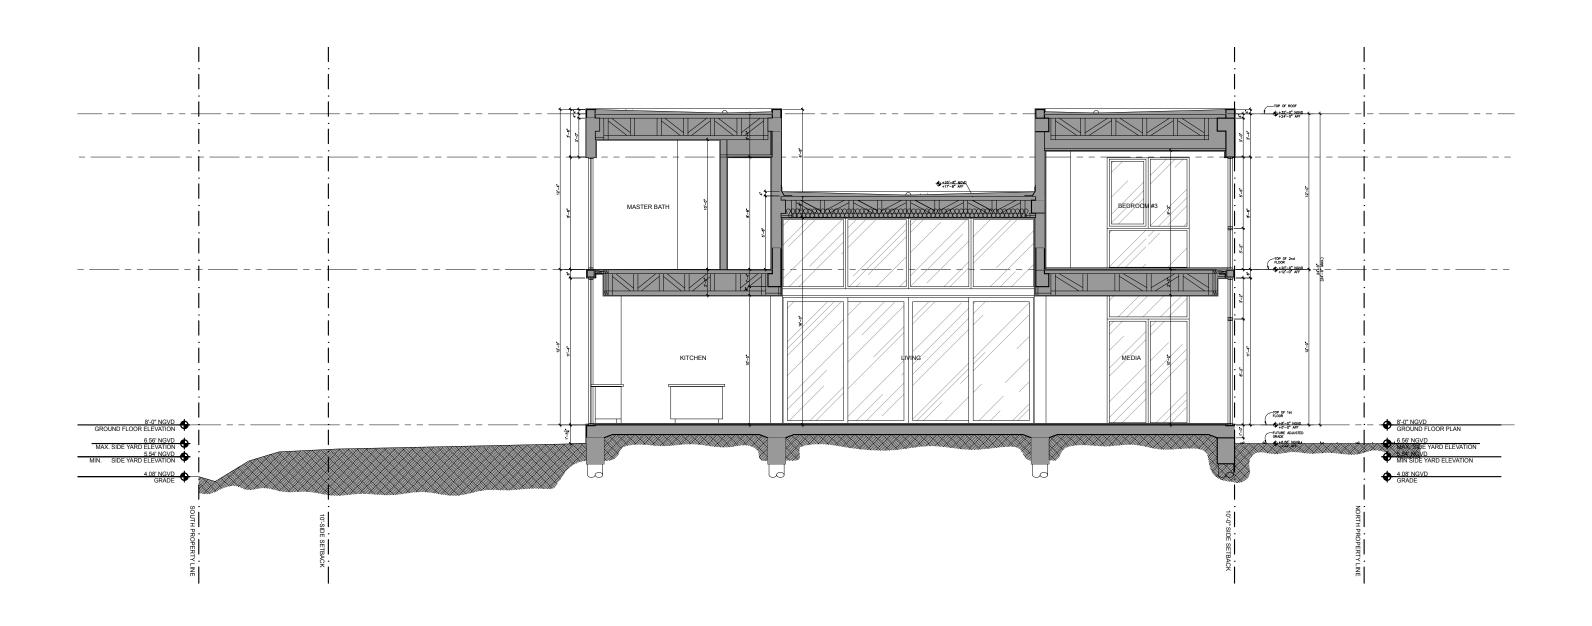


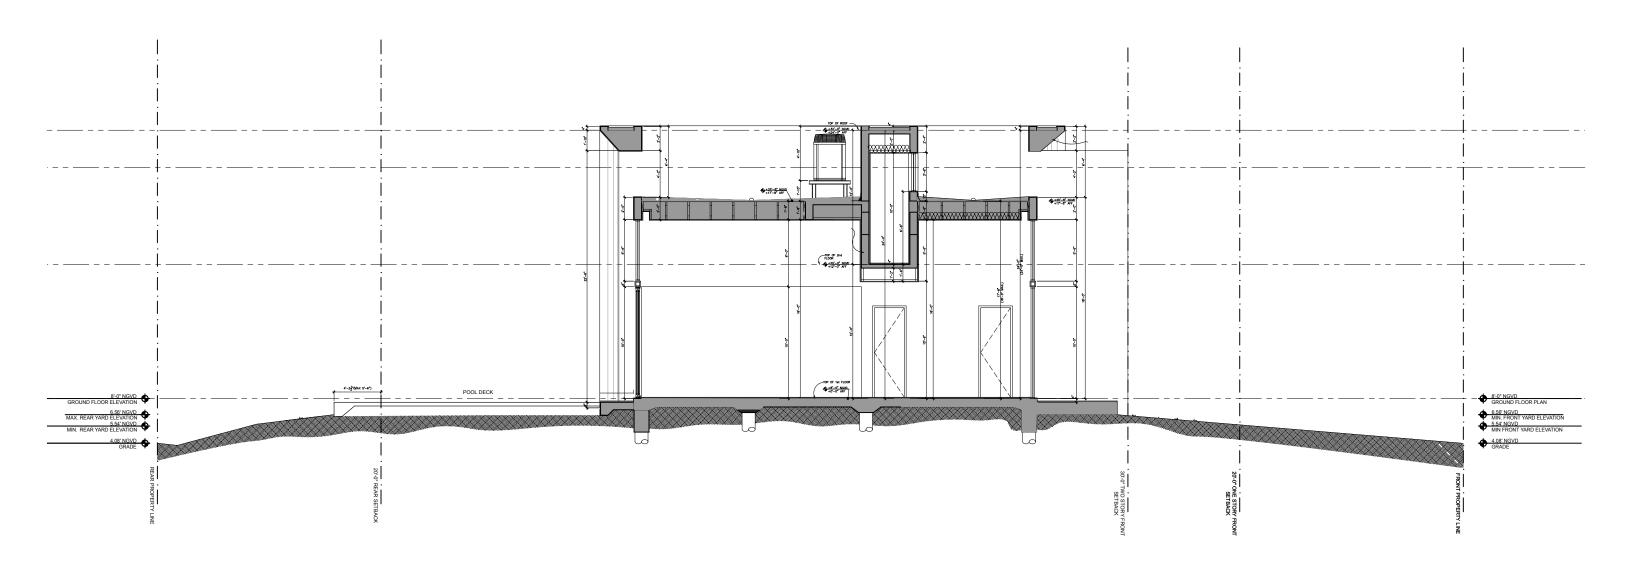

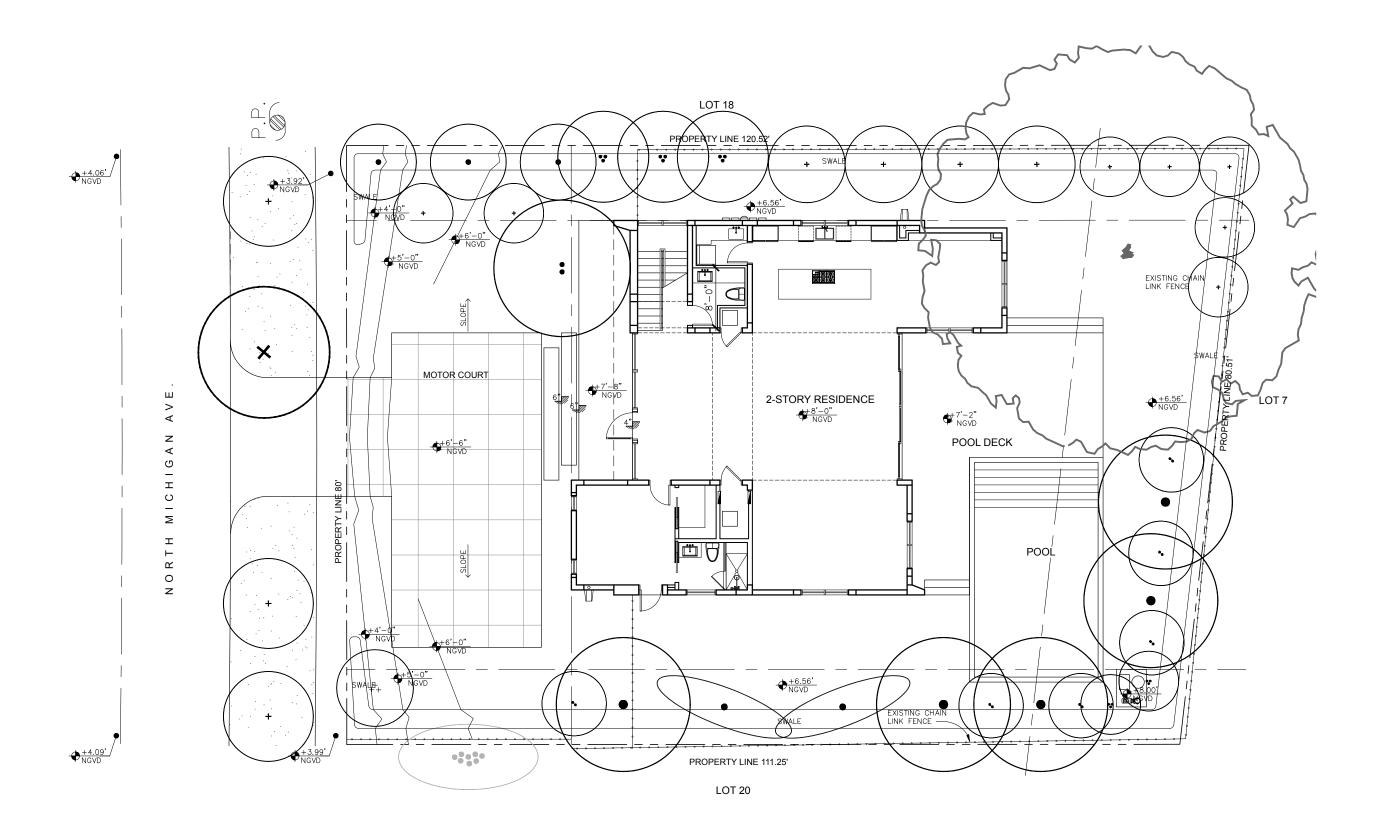





## FRONT YARD SECTION

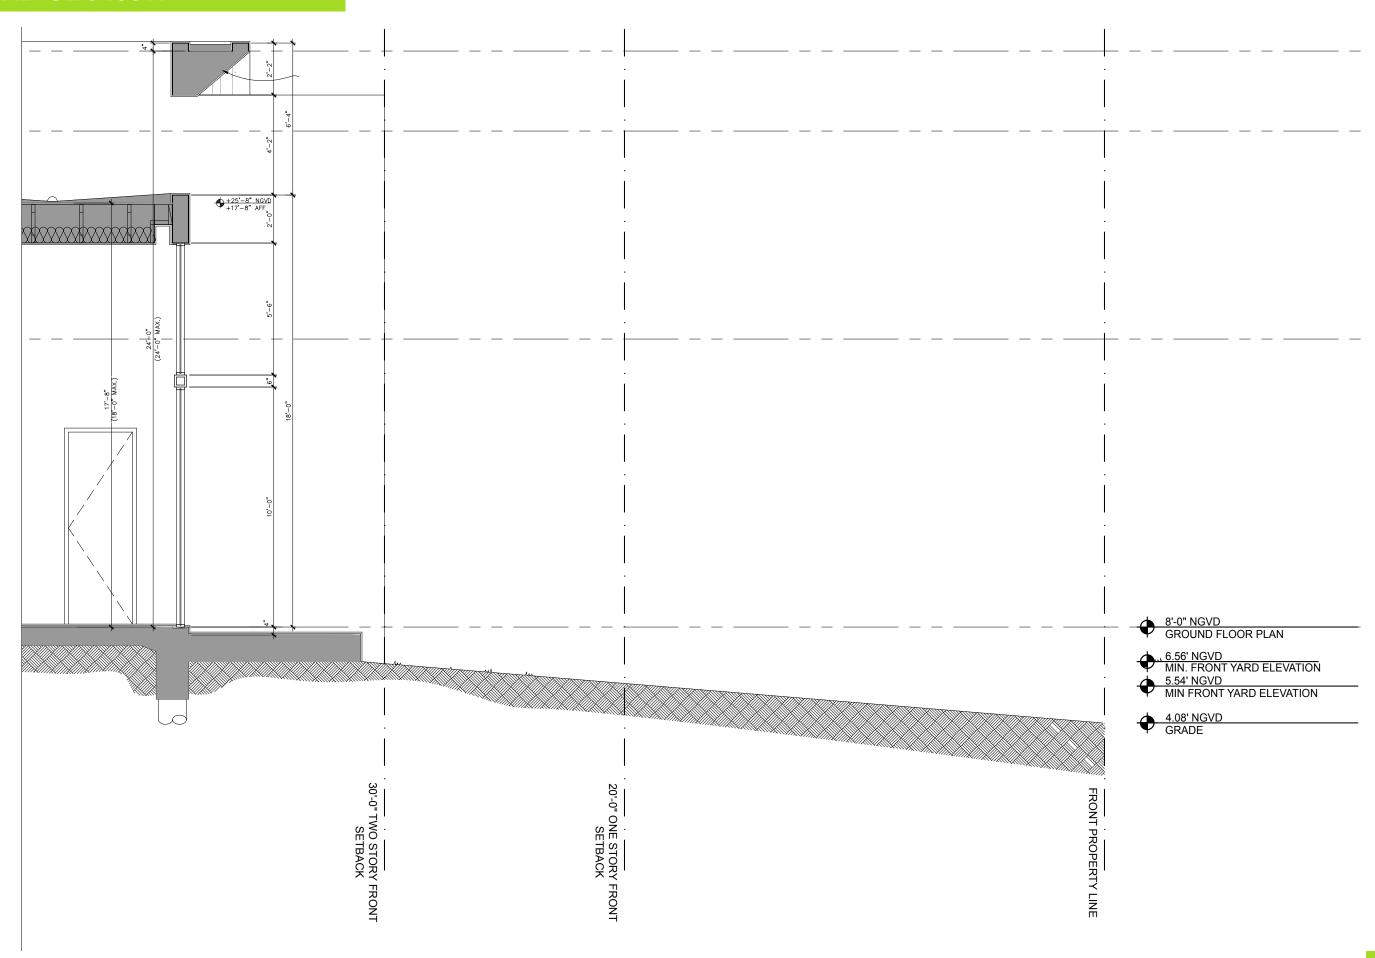

#### **REAR YARD SECTION**

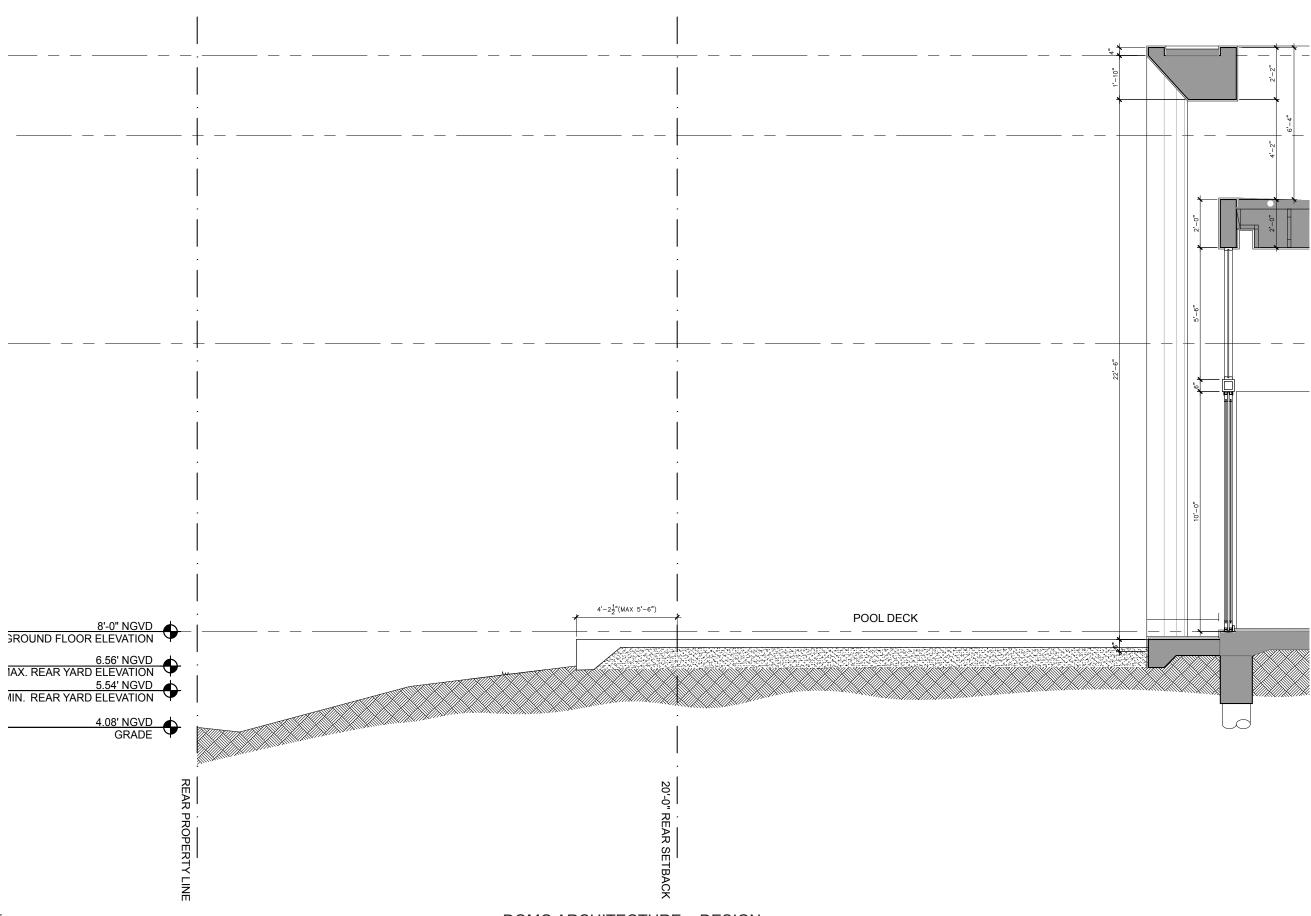

#### **REAR YARD SECTION**

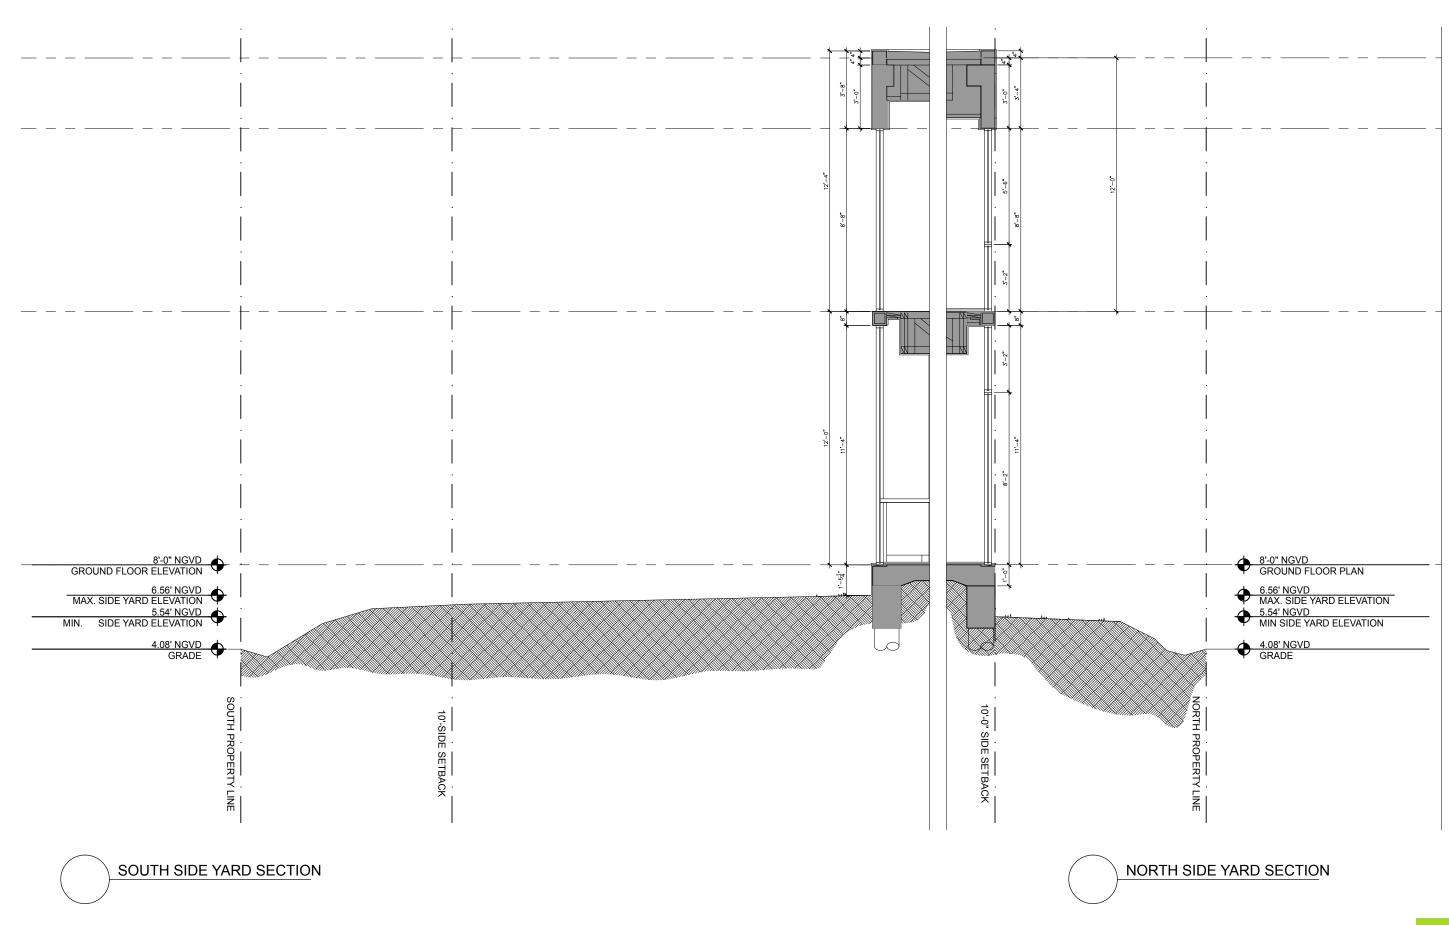

#### NEW RESIDENCE | 4366 NORTH MICHIGAN AVE | MIAMI BEACH, FLORIDA

#### PROPERTY INFORMATION

4366 NORTH MICHIGAN AVE MIAMI BEACH, FL 33140

#### EXISTING VEGETATION SUMMARY

The existing vegetation located on the property is composed primarily of trees, alexander palms, and shrubs. There is one native mahogany street tree located in the public R.O.W. that is in conflict with proposed site architecture and will be relocated. The rear yard contains a native specimen royal poinciana which will be preserved + protected during construction, along with a mango tree, ficus benjamina and specimen alexander palm that are TBD pending site visit from Landscape Architect and/or arborist. An invasive umbrella tree is slated to be removed.

#### SCOPE OF WORK

- Preservation of existing vegetation and landscape
  New landscape design to complement architecture for proposed new residence

#### INDEX OF SHEETS


- L-0 Landscape Cover Page + Sheet IndexL-1 Landscape Plan
- L-2 Landscape Notes + DetailsL-3 Existing Tree Survey + Disposition Chart

CHRISTOPHER CAWLEY CC LANDSCAPE ARCHITECTURE LLC LA Florida Landscape Architecture Business LC 26000460 780 NE 69th Street | Suite 1106 | Miami, FL 33138 T 305.979.1585 | www.christophercawley.com


**NEDRB FI** 

DATE 10.28.2016 REVISION

SHEET NO.

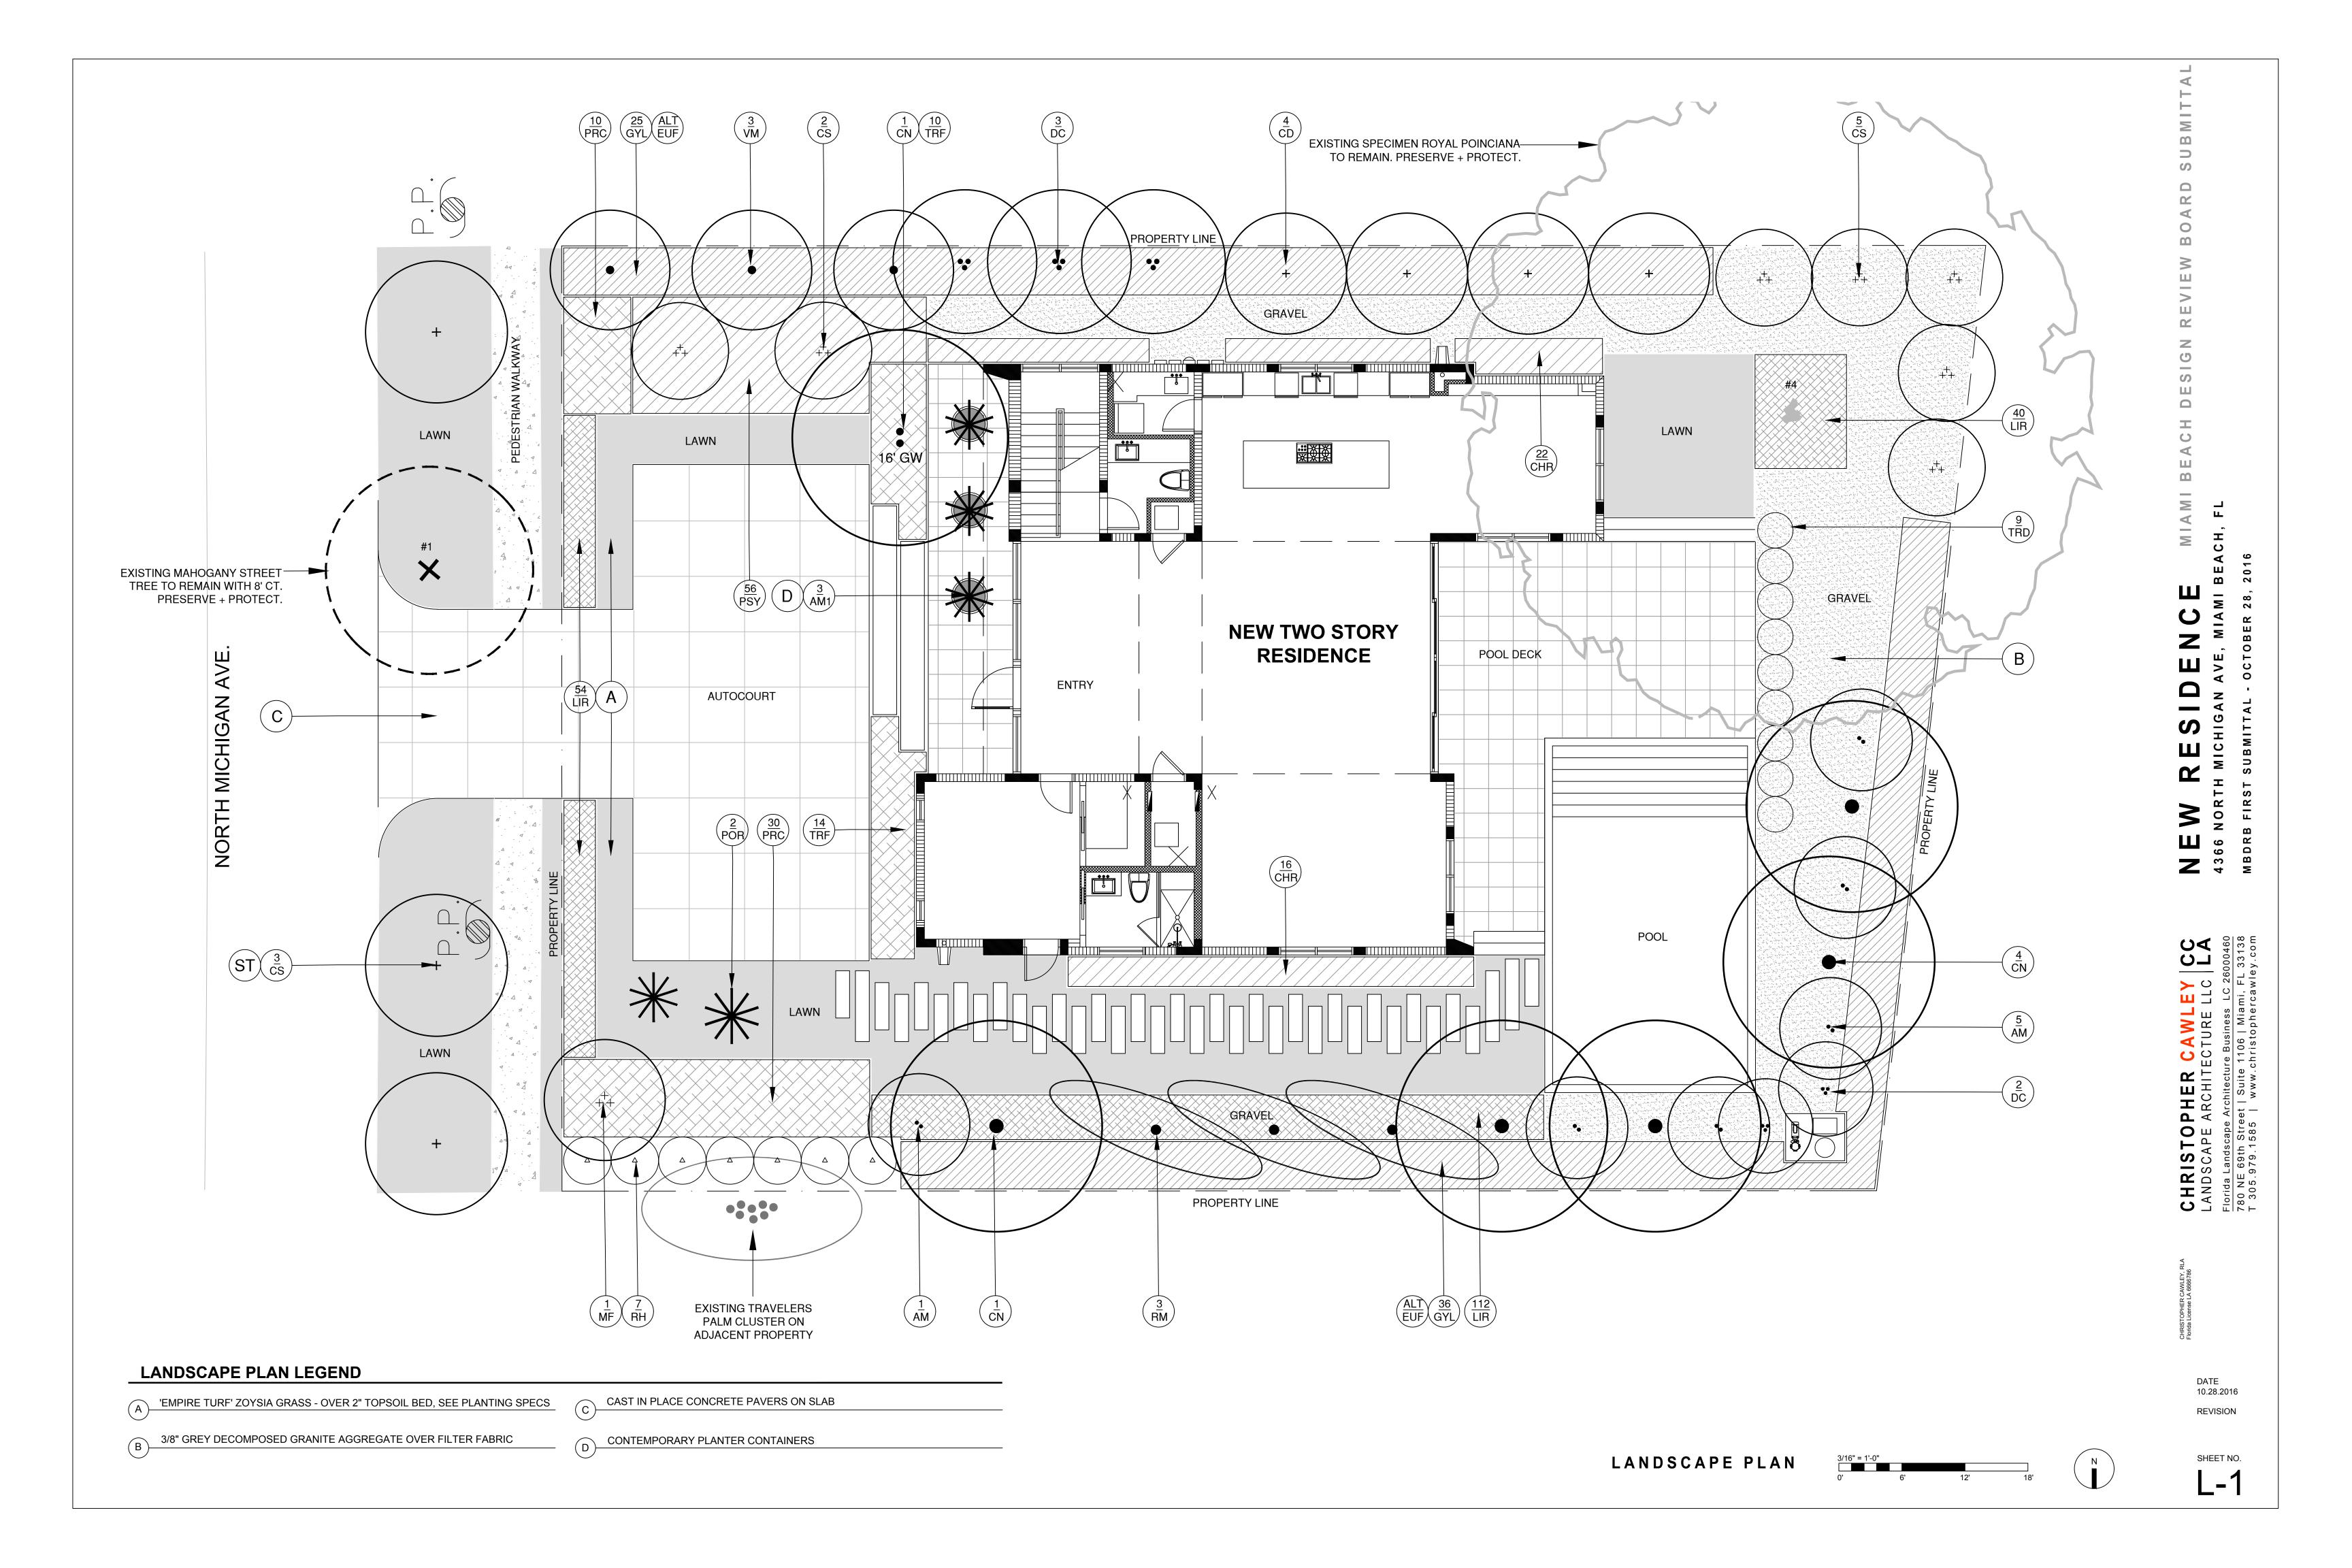

NO ACTIVITY OR DISTURBANCE SHOULD OCCUR WITHIN THE FENCED AREAS, INCLUDING VEHICLE USE, STORAGE OF MATERIALS, DUMPING OF LIQUIDS OR MATERIALS, GRADE CHANGES, GRUBBING, AND MECHANICAL TRENCHING FOR IRRIGATION, ELECTRICAL, LIGHTING, ETC.

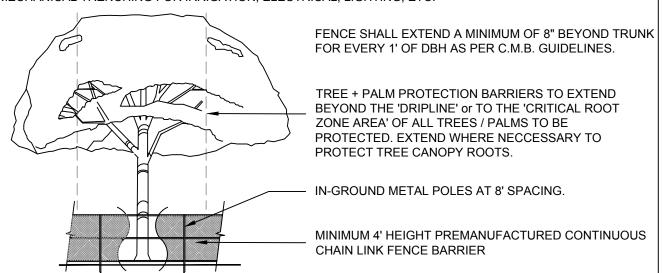


PROTECTION DETAIL NOTE
CONTRACTOR TO INSTALL 'TREE / PALM PROTECTION FENCE BARRIERS' AROUND ALL EXISTING TREES OR
PALMS AT THE START OF THE PROJECT. BARRIERS TO REMAIN IN PLACE THROUGHOUT THE DURATION OF
THE PROJECT AND SHOULD NOT BE REMOVED OR DROPPED FOR ANY REASON WITHOUT AUTHORIZATION
FROM THE CITY OF MIAMI BEACH URBAN FORESTER + PLANNING + ZONING DEPARTMENT

#### C.M.B. TREE / PALM PROTEC. DETAIL (CHAINLINK)

N.T.S.

TRANSPLANT OPERATIONS TO BE SUPERVISED BY AN ISA CERTIFIED ARBORIST.

POST TRANSPLANT WATERING TO PROVIDE MOISTURE AND REDUCE ANY EXCESSIVE STRESS DUE TO DESSICATION. WATERING TO BE ADJUSTED ACCORDING TO CONDITIONS AND AT THE SUPERVISION AND DIRECTION OF THE ISA CERTIFIED ARBORIST OR BIOLOGIST. WATER HOSE APPLICATION OF FLOOD WATERING REMOVES AIR POCKETS WITH

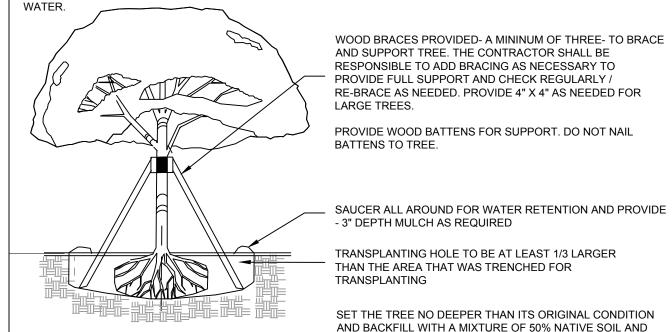

C.M.B. TREE TRANSPLANT DETAIL

50% TOPSIOL / SAND MIXTURE.

N.T.S.

WORK TO BE SUPERVISED BY AN ISA CERTIFIED ARBORIST OR BIOLOGIST OR A COMPANY WITH A CERTIFIED ISA ARBORIST ON STAFF. ROOT PRUNING MUST BE DONE A MINIMUM OF 8 WEEKS PRIOR TO TRANSPLANTING. WATERING MUST PROVIDE SUFFICIENT WATER TO MAINTAIN A MOIST CONDITION IN THE ROOTS. ONCE A WEEK OR MORE ACCORDING TO CONDITIONS. TAKE EXTRA CARE NOT TO DAMAGE THE TRUNK OR BRANCHES. TRENCH TO BE LIGHTLY FILLED WITH FIBROUS MATERIAL SUCH AS LEAVES OR WOOD SHAVINGS. TRENCH SHALL USE SHARP INSTRUMENTS OR MACHINERY. RIPPING OR TEARING OF THE ROOTS IS STRICLY PROHIBITED. ALL TORN ROOTS MUST BE TRIMMED TO SOLID WOOD WITH CLEAN, SHARP INSTRUMENTS

C.M.B. ROOT PRUNING DETAIL

NTS

DEPTH TO BE 18" MIN. TO 36" -VARIES WITH SIZE OF TREE

#### LANDSCAPE NOTES

1. ALL PLANT MATERIAL SHALL BE FLORIDA GRADE NO. 1 OR BETTER.

2. CONTRACTOR SHALL BECOME FAMILIAR WITH THE LOCATION OF, AVOID, AND PROTECT ALL UTILITY LINES, BURIED CABLES, AND OTHER UTILITIES.

3. TREE, PALM, ACCENT AND BED LINES ARE TO BE LOCATED IN THE FIELD AND APPROVED BY THE LANDSCAPE ARCHITECT PRIOR TO INSTALLATION.

4. ALL PLANTING SOIL SHALL BE 50:50 TOPSOIL:SAND MIX, FREE OF CLAY, STONES, ROCKS, OR OTHER FOREIGN MATTER. THIS SPECIFICATION INCLUDES ALL BACKFILL FOR BERMS AND OTHER LANDSCAPE

5. THE SITE CONTRACTOR SHALL BE RESPONSIBLE TO BRING ALL GRADES TO WITHIN 2" OF FINAL GRADES. THIS SHALL INCLUDE A 2" APPLICATION OF 50:50 TOPSOIL:SAND MIX FOR ALL LANDSCAPE AND AREAS TO BE SODDED.


6. ALL PLANTING BEDS SHALL BE MULCHED TO A DEPTH OF 2" WITH A SMALL GRAY GRANITE AGGREGATE FREE FROM WEEDS AND PESTS. NO 'CYPRESS MULCH' OR 'RED DYED MULCH' TO BE ACCEPTED. KEEP MULCH 3" AWAY FROM TREE OR PALM TRUNKS AS PER INDUSTRY RECOMMENDATIONS.


7. SOD SHALL BE 'EMPIRE TURF' ZOYSIA GRASS IN ALL LAWN AREAS AS SHOWN ON THE PLANS. SOD SHALL BE STRONGLY ROOTED, FREE FROM WEED, FUNGUS, INSECTS AND DISEASE. CONTRACTOR SHALL SOD ALL AREAS AS INDICATED ON THE PLANS OR AS DIRECTED. PAYMENT SHALL BE DETERMINED BY THE TOTAL MEASURED SODDED AREAS X THE UNIT PRICE SUBMITTED AND FIELD VERIFIED. SOD SHALL CARRY A 5-MONTH WARRANTY.

8. ALL TREES, PALMS, SHRUBS AND GROUNDCOVERS, AND SOD / LAWN SHALL CARRY A ONE-YEAR WARRANTY FROM THE DATE OF FINAL ACCEPTANCE.

9. IRRIGATION SHALL PROVIDE FOR A 100% COVERAGE WITH 50% OVERLAP MINIMUM AND BE PROVIDED BY A FULLY AUTOMATIC IRRIGATION SYSTEM W/ RAIN MOISTURE SENSOR ATTACHED TO CONTROLLER. ALL FLORIDA BUILDING CODE APPENDIX "F" IRRIGATION REQUIREMENTS SHALL BE STRICTLY ADHERED TO FOR INSTALLATION AND PREVAILING WATER MANAGEMENT DISTRICT RESTRICTIONS AND REGULATIONS SHALL BE IN COMPLIANCE FOR POST-INSTALLATION WATERING SCHEDULES.

SYM.	NATIVE	QTY.	COMMON NAME				
TREES							
CD	YES	4	PIGEON PLUM TREE	Coccoloba diversifolia	50 gallon, 12' height, 6' spread, 3" dbh, equal to Treeworld Wholesale		
cs	YES	10	SILVER BUTTONWOOD TREES	Conocarpus erectus 'Sericeus'	12' height min., 6' spread min., multi trunk, equal to Treeworld		
MF	YES	1	SIMPSON STOPPER TREE	Myrcianthes fragrens	12' height min, 5' spread, 3" dbh, multi trunk		
PALMS							
CN	NO	6	'GR. MALAYAN' COCONUT PALMS	Cocos nucifera 'Green Malayan'	Feet of grey wood as noted, leaning trunks, Florida Fancy		
AM	NO	6	CHRISTMAS PALMS	Adonidia merrillii	12-14' overall height, triple trunks, full heads, equal to Nautilus		
AM1	NO	3	CHRISTMAS PALMS / small	Adonidia merrillii	6' overall height, double trunks, full heads, for pots		
DC	NO	5	CABADA PALM	Dypsis cabadae	(2) 45 gallon, 10' height min. / (3) 20' height min, full to base		
RH	NO	7	LADY PALM	Rhapis excelsa	10 gallon, 4' height min.		
RM	NO	3	TRAVELLER'S PALM	Ravenala madagascarensis	100 gallon, 18' height		
SHRUBS							
CHR	YES	38	COCOPLUM	Chrysobalanus icaco 'Red Tip'	3 gallon, full, space 30" on center		
EUF	YES	ALT	SPANISH STOPPER	Eugenia foetida	15 gallon, full, space 48" on center		
GYL	YES	62	CRABWOOD	Gymnanthes lucida	25 gallon, full, space 48" on center		
PSY	YES	56	DWARF BAHAMA COFFEE	Psychotria ligustrifolia	3 gallon, 24" height x 24" spread, full, space 36" on center.		
TROPICAL	LS & GRO	JNDCO\	/ERS				
LIR	NO	206	LIRIOPE 'BIG BLUE'	Liriope muscari 'Big Blue'	12" height x 12" spread, full, 18" o.c. or as required		
POR	NO	2	PORTEA BROMELIADS	Portea petropolitana	24" x 24" minimum, equal to Bullis Bromeliads		
PRC	NO	40	PHILODENDRON 'ROJO CONGO'	Philodendron 'Rojo Congo'	3 gallon, 24" height x 24" spread, full, 30" on center		
TRD	YES	9	FAKAHATCHEE GRASS	Tripsacum dactyloides	3 gallon, 36" height x 36" spread, full, space 36" on center		
TRF	YES	24	DWARF FAKAHATCHEE GRASS	Tripsacum floridana	3 gallon, full, 36" on center		
VINES							
FPU	NO		CREEPING FIG	Ficus pumila	1 gallon, full, space 12" o.c.		
SOD, AGG	REGATE,	& MULC	CH				
LAWN	ZOYSIA 'EMPIRE' - OVER 2" TOPSOIL BED, SEE PLANTING SPECS.						
AGR	3/8" DECOMPOSED 'GREY' GRANITE AGGREGATE OR STONE TO BE SELECTED, INSTALL OVER FILTER FABRIC						
	1	DARK BROWN 'FLORI MULCH' SHREDDED ORGANIC MULCH (NO CYPRESS), TO BE DETERMINED					

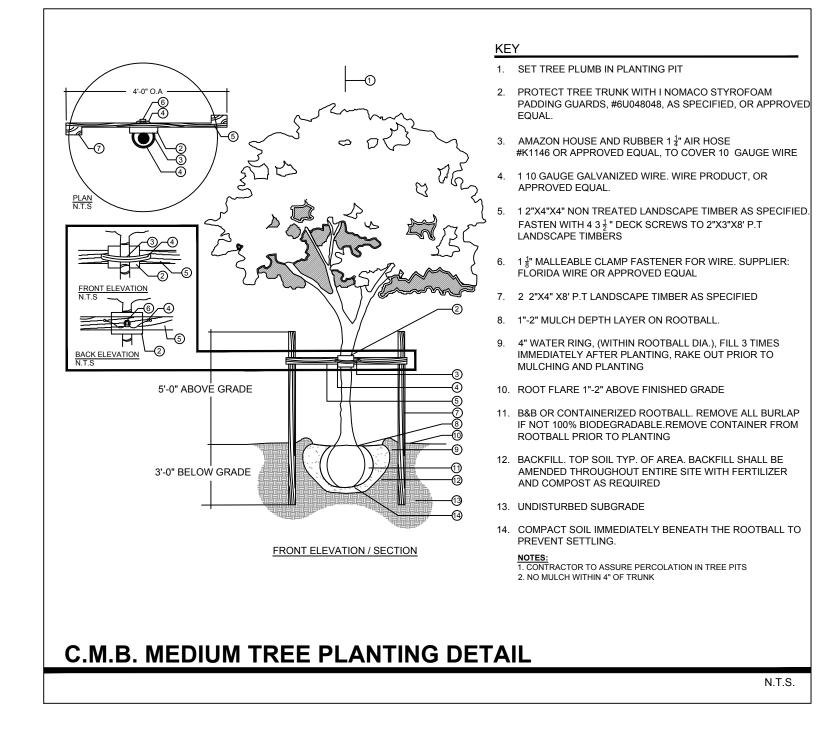

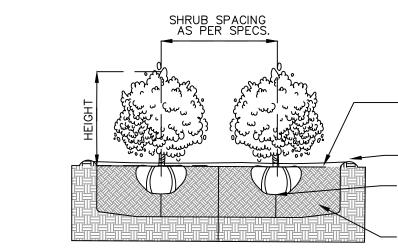

THE CITY URBAN FORESTER SHALL BE CONSULTED.

TO THE PRUNING ACTVITIES TAKING PLACE.

REGULAR BASIS.

PLANT MATERIAL SHALL NOT BE PRUNED PRIOR TO INSTALLATION, AFTER PLANTS HAVE BEEN INSTALLED, EACH PLANT SHALL BE PRUNED FOR UNIFORMITY OR AT THE DIRECTION OF THE PROJECT LANDSCAPE ARCHITECT.

MULCH SHALL BE LEVEL WITH ALL EDGES OF PAVEMENT TYPICAL

MULCH - SEE SPECS. FOR DEPTH, TYPE, ETC.

2" MIN. SAUCER COLLAR FOR WATER RETENTION

 LEAVE MOUND OF UNDISTURBED SOIL TO PREVENT SETTLING, OR, COMPACT THOROUGHLY

UNDER SHRUB AS NEEDED.

PLANTING SOIL MIX - SEE LANDSCAPE NOTES, FOR MIX,

SHRUB PLANTING DETAIL

TO DETERMINE CORRECTIVE ACTIONS THAT MAY INCLUDE REMOVAL, CORRECTIVE PRUNING AND OR

SHOULD ANY EXISTING TREES OR PALMS BE DAMAGED THEY SHALL BE EVALUATED BY THE CITY URBAN FORESTER

REPLACEMENT. ANY CORRECTIVE ACTIONS REQUIRED SHALL BE PERFORMED IN ACCORDANCE WITH MIAMI BEACH CODE, THE MOST CURRENT ANSI A-300 PRUNING STANDARDS AND OR AN ISSUED CITY OF MIAMI BEACH TREE

WORK PERMIT. ANY CORRECTIVE PRUNING REQUIRED SHALL BE PERFORMED BY AN ISA CERTIFIED ARBORIST AND

DRIPLINES OF TREES SLATED TO REMAIN IN PLACE OR BE RELOCATED. IF CONSTRUCTION REQUIRES THE CUTTING

OF ANY ROOTS WITH A DIAMETER OF 2" OR GREATER, ROOTS SHALL BE CLEANLY CUT WITH A SHARP TOOL, AS DIRECTED BY AN ISA CERTIFIED ARBORIST, AND IN ACCORDANCE WITH THE ANSI A-300 STANDARDS. CUT ROOTS SHOULD BE IMMEDIATELY COVERED WITH SOIL TO PREVENT DRYING. ROOTS SHOULD NOT BE TORN OR BROKEN

BY HEAVY EQUIPMENT, AND NO SHREDDED, RAGGED OR BROKEN ROOT ENDS SHOULD BE LEFT.THE CITY URBAN FORESTER SHALL BE NOTIFIED IN WRITING AND OR CONSULTED PRIOR TO ANY ROOT PRUNING TAKING PLACE.

SHOULD ANY CORRECTIVE STRUCTURAL PRUNING BE NECESSARY FOR TREES PROPOSED TO REMAIN ONSITE,

DUE TO CLEARANCE, SAFETY OR FOR CONSTRUCTION RELATED REASONS THE PRUNING SHALL BE PERFORMED BY AN ISA OR ASCA CERTIFED ARBORIST IN ACCORDANCE WITH THE LATEST VERSION OF THE ANSI A-300 PRUNING

STANDARDS AND GOOD HORTICULTURAL PRACTICES. THE CITY URBAN FORESTER SHALL BE PROVIDED WITH A WRITTEN COPY OF THE PROPOSED PRUNING PLAN INCLUDING THE REASONS WHY PRUNING IS NECESSARY, PRIOR

1. ANY ROOT PRUNING, IF REQUIRED DURING THE PROJECT, SHALL BE CONDUCTED UNDER THE SUPERVISION OF AN ISA CERTIFIED ARBORIST OR ACSA CONSULTING ARBORIST. ANY ROOT PRUNING, IF REQUIRED, WILL BE LIMITED

TO WHAT IS ABSOLUTELY NECESSARY FOR CONSTRUCTION. ADDITIONALLY, AND ROOT PRUNING WORK WILL BE

DOCUMENTED WITH COLOR PICTURES AND PROVIDED TO MR. MARK WILLIAMS AT C.M.B. PUBLIC WORKS / GREENSPACE MANAGEMENT + MR. RICARDO GUZMAN AT C.M.B. PLANNING + ZONING DEPARTMENTS ON A

. CARE SHALL BE TAKEN TO AVOID UTILITY OR CONSTRUCTION TRENCHING THROUGH EXISTING TREE OR PALM

C.M.B. PUBLIC WORKS / GREENSPACE MANAGEMENT CONDITIONS

#### LANDSCAPE LEGEND

MIAMI - DADE COUNTY LANDSCAPE ORDINANCE CHAPTER 18-A (RESIDENTIAL VERSION)

TREES
3 TREES REQUIRED PER LOT / 15 TREES PROVIDED MEETING MINIMUM REQUIREMENTS.
(4) PIGEON PLUM, (10) SILVER BUTTONWOOD, (1) SIMPSON STOPPER

30% OF REQUIRED TREES OR .30 X 6 = 2 NATIVE TREES REQUIRED / 15 NATIVE TREES PROVIDED. (4) PIGEON PLUM, (10) SILVER BUTTONWOOD, (1) SIMPSON STOPPER

SHRUBS 10 SHRUBS REQUIRED FOR EACH REQUIRED TREE or 10 X (3) = 30 REQUIRED / 156

SHRUBS PROVIDE

NATIVE SHRUBS

30% OF TOTAL SHRUBS REQUIRED MUST BE NATIVE or .30 X 30 = 9 / 156 NATIVE SHRUBS

PROVIDED 38 COCOPLUM, 62 CRABWOOD, 56 DWARF BAHAMA SHRUBS PROVIDED

<u>LAWN AREA</u>
50% MAXIMUM OF LANDSCAPE AREA: NEW LAWN AREAS ARE LESS THAN 50% OF

LANDSCAPE AREA

IRRIGATION SYSTEM

100% COVERAGE PROVIDED PURSUANT TO MIAMI DADE CODE

#### C.M.B. CHAPTER 46, DIVISION 2 - TREE INVENTORY + DISPOSITION PLAN NOTES

1. THIS 'EXISTING TREE INVENTORY + DISPOSITION PLAN' HAS BEEN PREPARED IN ACCORDANCE WITH THE CITY OF MIAMI BEACH, CHAPTER 46 - ENVIRONMENT, DIVISION 2, TREE PRESERVATION and PROTECTION ORDINANCE.

2. EXISTING TREE, PALM, AND VEGETATION INFORMATION AS INDICATED HAS BEEN PREPARED AS AN OVERLAY ON THE SURVEY PREPARED BY- AMERICAN SERVICES OF MIAMI CORP. DATED

3. THE INFORMATION AS PRESENTED HEREIN HAS BEEN FIELD VERIFIED BY THE LANDSCAPE ARCHITECT ON XX.XX.XX.

4. THE OWNER RESERVES THE RIGHT TO REMOVE ANY VEGETATION NOT LOCATED WITHIN THE CITY R.O.W. w/ a D.B.H. OF LESS THAN 6" WITHOUT OBTAINING A TREE REMOVAL PERMIT.

5. THERE ARE NO TREES or PALMS LOCATED ON THIS PROPERTY THAT WILL REQUIRE TEMPORARY IRRIGATION. ALL EXISTING TREES + PALMS ARE MATURE AND ARE CURRENTLY THRIVING WITHOUT SUPPLEMENTAL IRRIGATION WATER.

5 LAYERS OF BURLAP 3/4" STEEL BANDING (5) 2"X4"22' BATTONS NAIL BRACING TO WOOD BATTONS (DO NOT ALLOW NAILS TO PENETRATE TRUNK) -3/4" STEEL BANDING (3) 2"X4" WOOD BRACES SPACED 120-DEGREES O.C (see notes below) BASE OF LEAD BUD — 3" DEPTH MULCH LAYER-REFER TO SPECIFICATION ORANGE SAFETY 26" COMPACTED SOIL SAUCE TO HOLD WATER 2"X4"X30" TREE STAKE FINAL GRADE - NATIVE SOIL BACKFILL OR AMENDED PLANTING SOIL AS REQUIRED BY SOIL ANALYSIS PLANTING ROOTBALL RECEIVING PLANTING HOLE

NOTES:

1. PALMS OVER 30' GW HEIGHT, USE MINIMUN (4) 4X4 BRACING AND STAKES

2. PRIMARY STAKES SHOULD PLACED PARALLEL TO WALKWAYS WHENEVER POSSIBLE

3.RECEIVING PLANTING HOLE SHALL BE APPROXIMATELY 1/3 LARGER THAN ROOTBALL

4. BUD SHALL BE PERPENDICULAR TO THE GROUND PLANE

5. TRUNK SHALL BE STRAIGHT AND WITHOUT CURVES 6. NO SCARRED OR BLACKENED TRUNKS

7. AMENDED SOIL MIX TO BE ADDED AT THE TIME OF PLANTING NEEDED, SHALL CONSIST OF A RATIO MIX OF 80% CLEAN SILICA SAND AND 20% SCREENED PULVERIZED TOPSOIL AS NEEDED

C.M.B. PALM PLANTING DETAIL

N.T.S.

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GROUNDCOVERS TO BE STAGGERED AS SHOWN - SPACING BETWEEN ROWS TO BE AT A 60 DEGREE ANGLE OF THE O.C. DISTANCE AS SHOWN

O.C. DIST.

MULCH - SEE SPECS. FOR DEPTH, TYPE, ETC.

MULCH SHALL BE LEVEL WITH ALL EDGES OF PAVEMENT TYPICAL

PLANTING SOIL MIX - SEE NOTES FOR TYPE, DEPTH, ETC.

GROUNDCOVER PLANTING DETAIL

N.T.

RISTOPHER CAWLI DSCAPE ARCHITECTURE 1

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CHRISTOPHER
LANDSCAPE ARCHI
Florida Landscape Architec
780 NE 69th Street | Suit


DATE 10.28.2010

DATE 10.28.2016 REVISION

SHEET NO.

LANDSCAPE NOTES + DETAILS

L-2

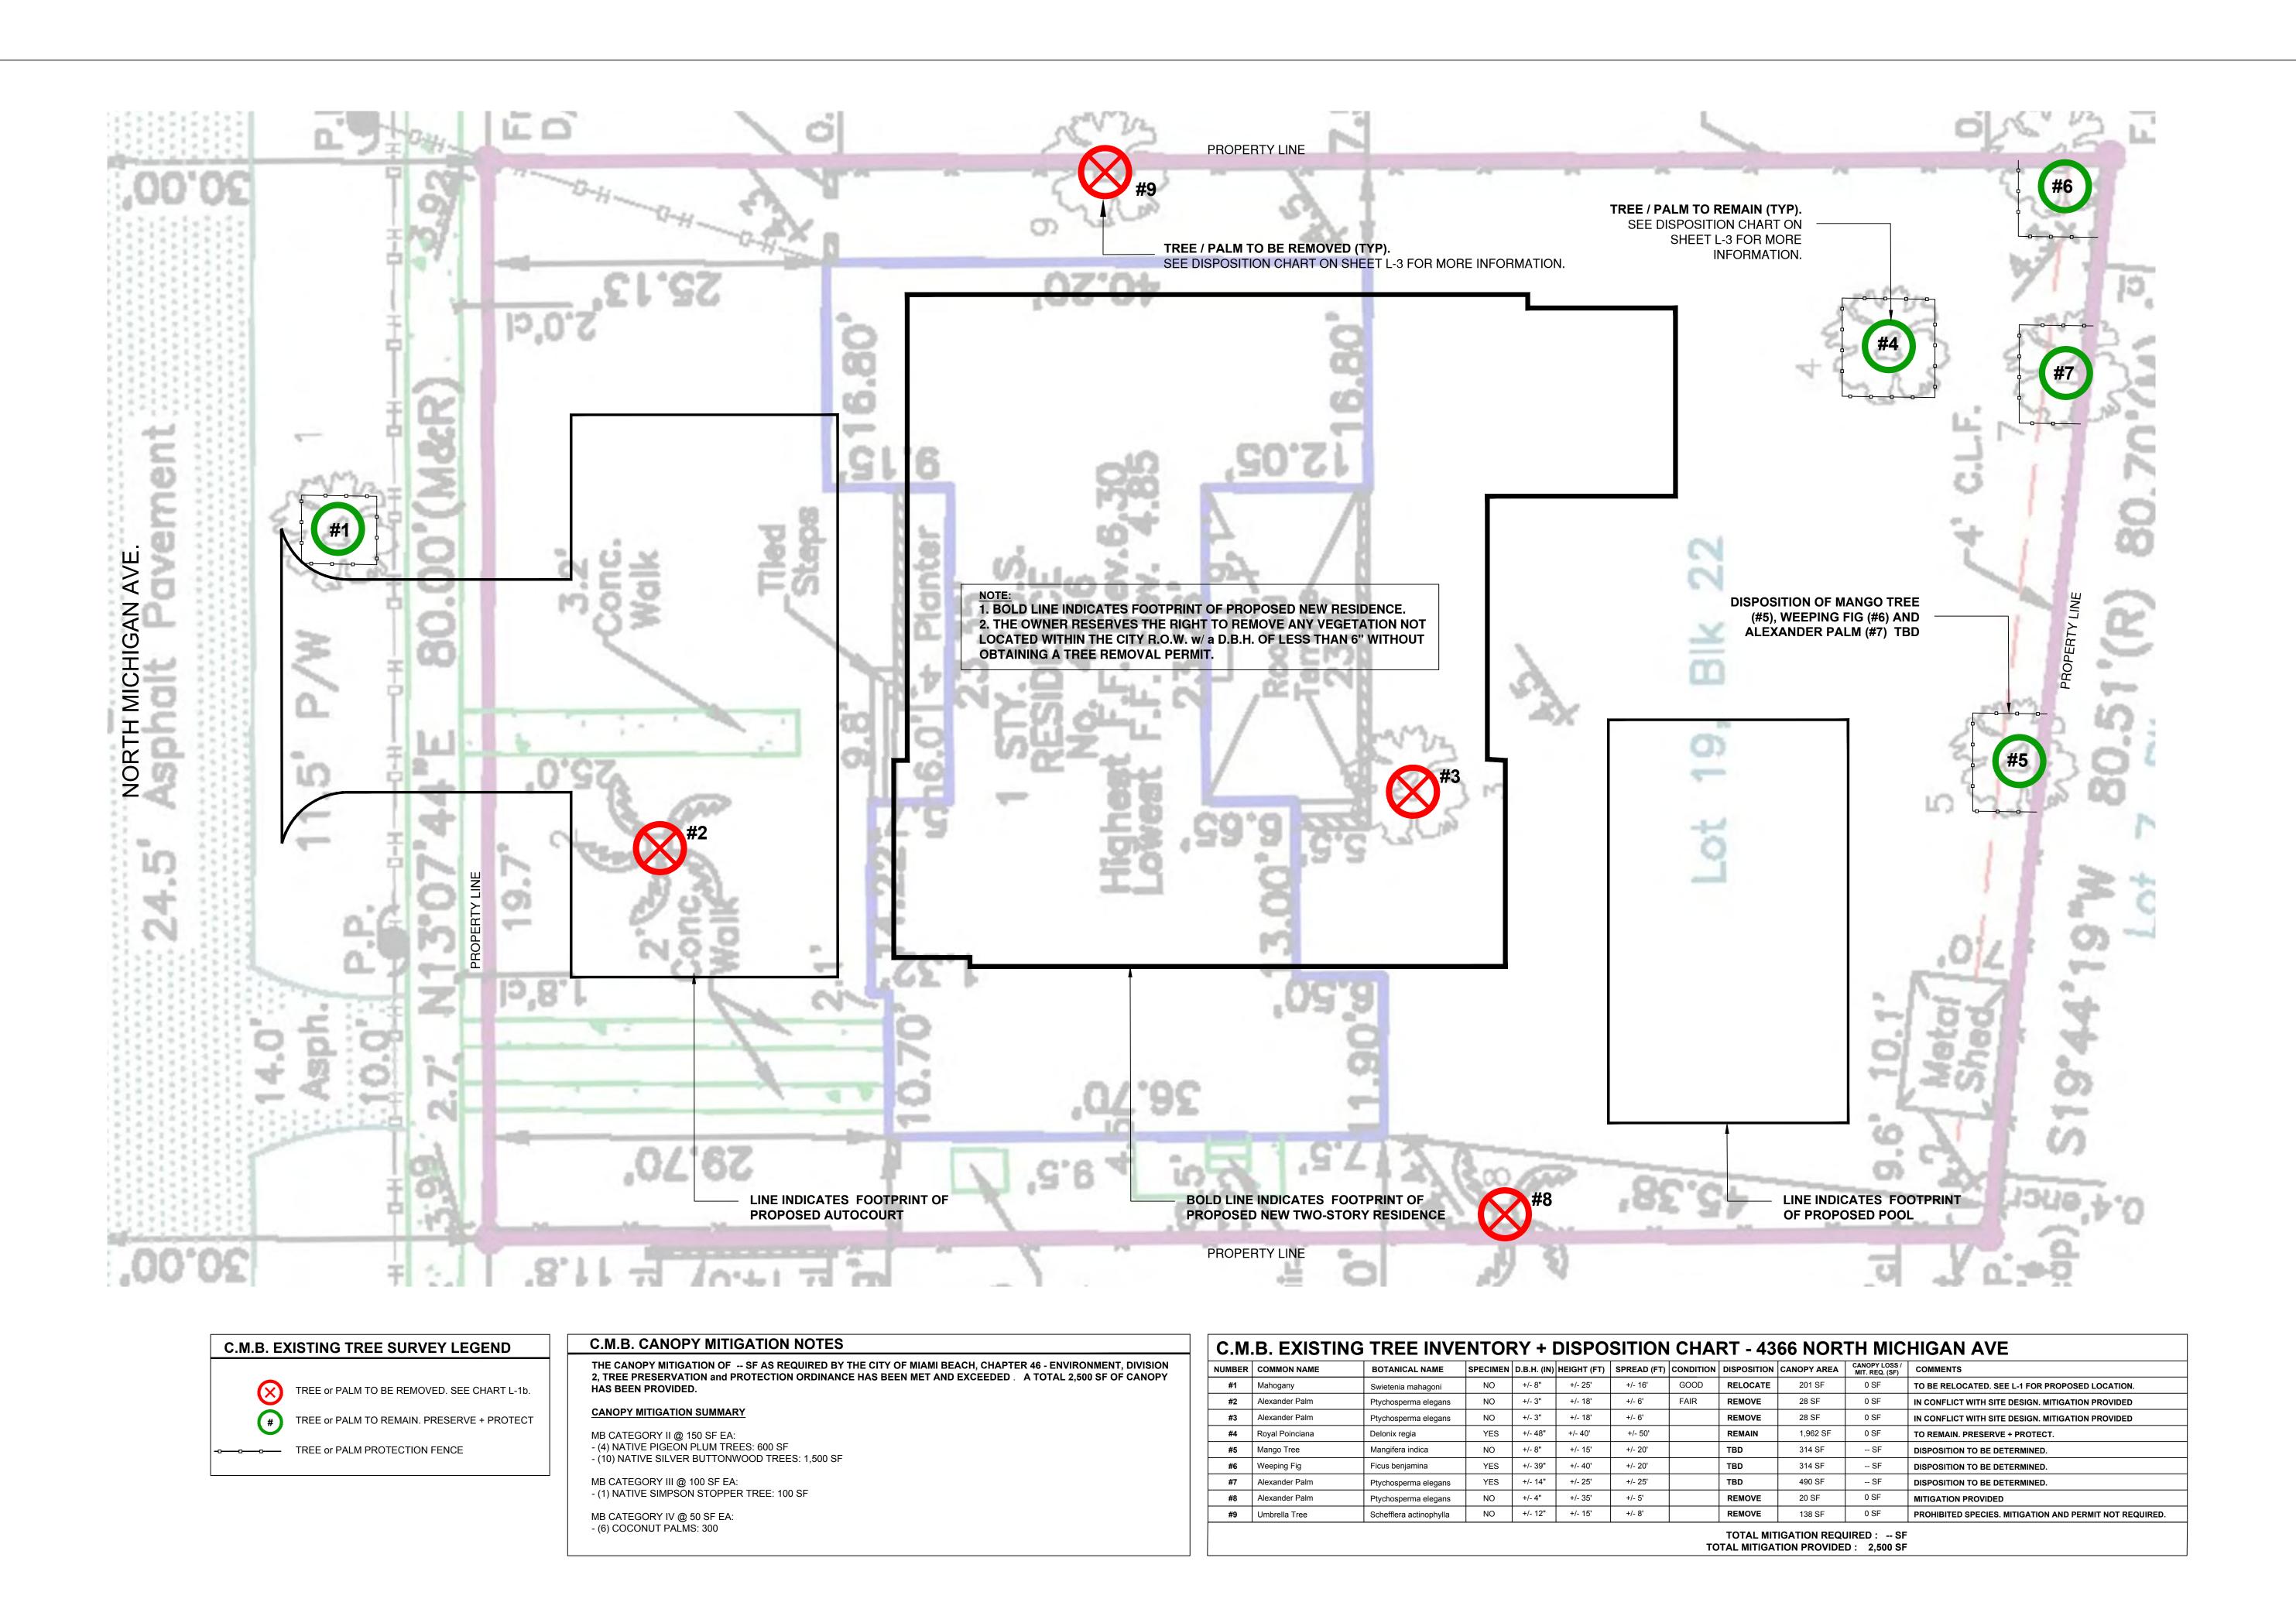

DATE 10.28.2016 REVISION

SHEET NO.

L-3

CHRISTOPHER CAWLEY
LANDSCAPE ARCHITECTURE LLC

#### **RENDERINGS**



MAIN ENTRY VIEW


#### RENDERINGS



REAR VIEW

## CONTEXTUAL STREETSCAPE STUDY



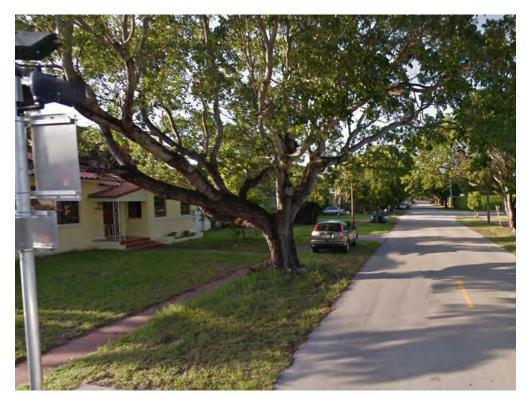





SOUTH APPROACH EAST APPROACH NORTH APPROACH