

DWG. TITLE

OVERALL SITE PLAN GROUND LEVEL BLDG #3


THE PETER MILLER HOTEL (A LENNOX HOTEL)

1900 COLLINS AVE. MIAMI BEACH, FL 33139

BUILDING # 1




ARCHITECTURE AACO01062
JOSE L. GOMEZ ARO015416
8101 BISCAYNE BLVD.
SUITE 309
MIAMI FL 33138-4664
TEL (305) 559.1250

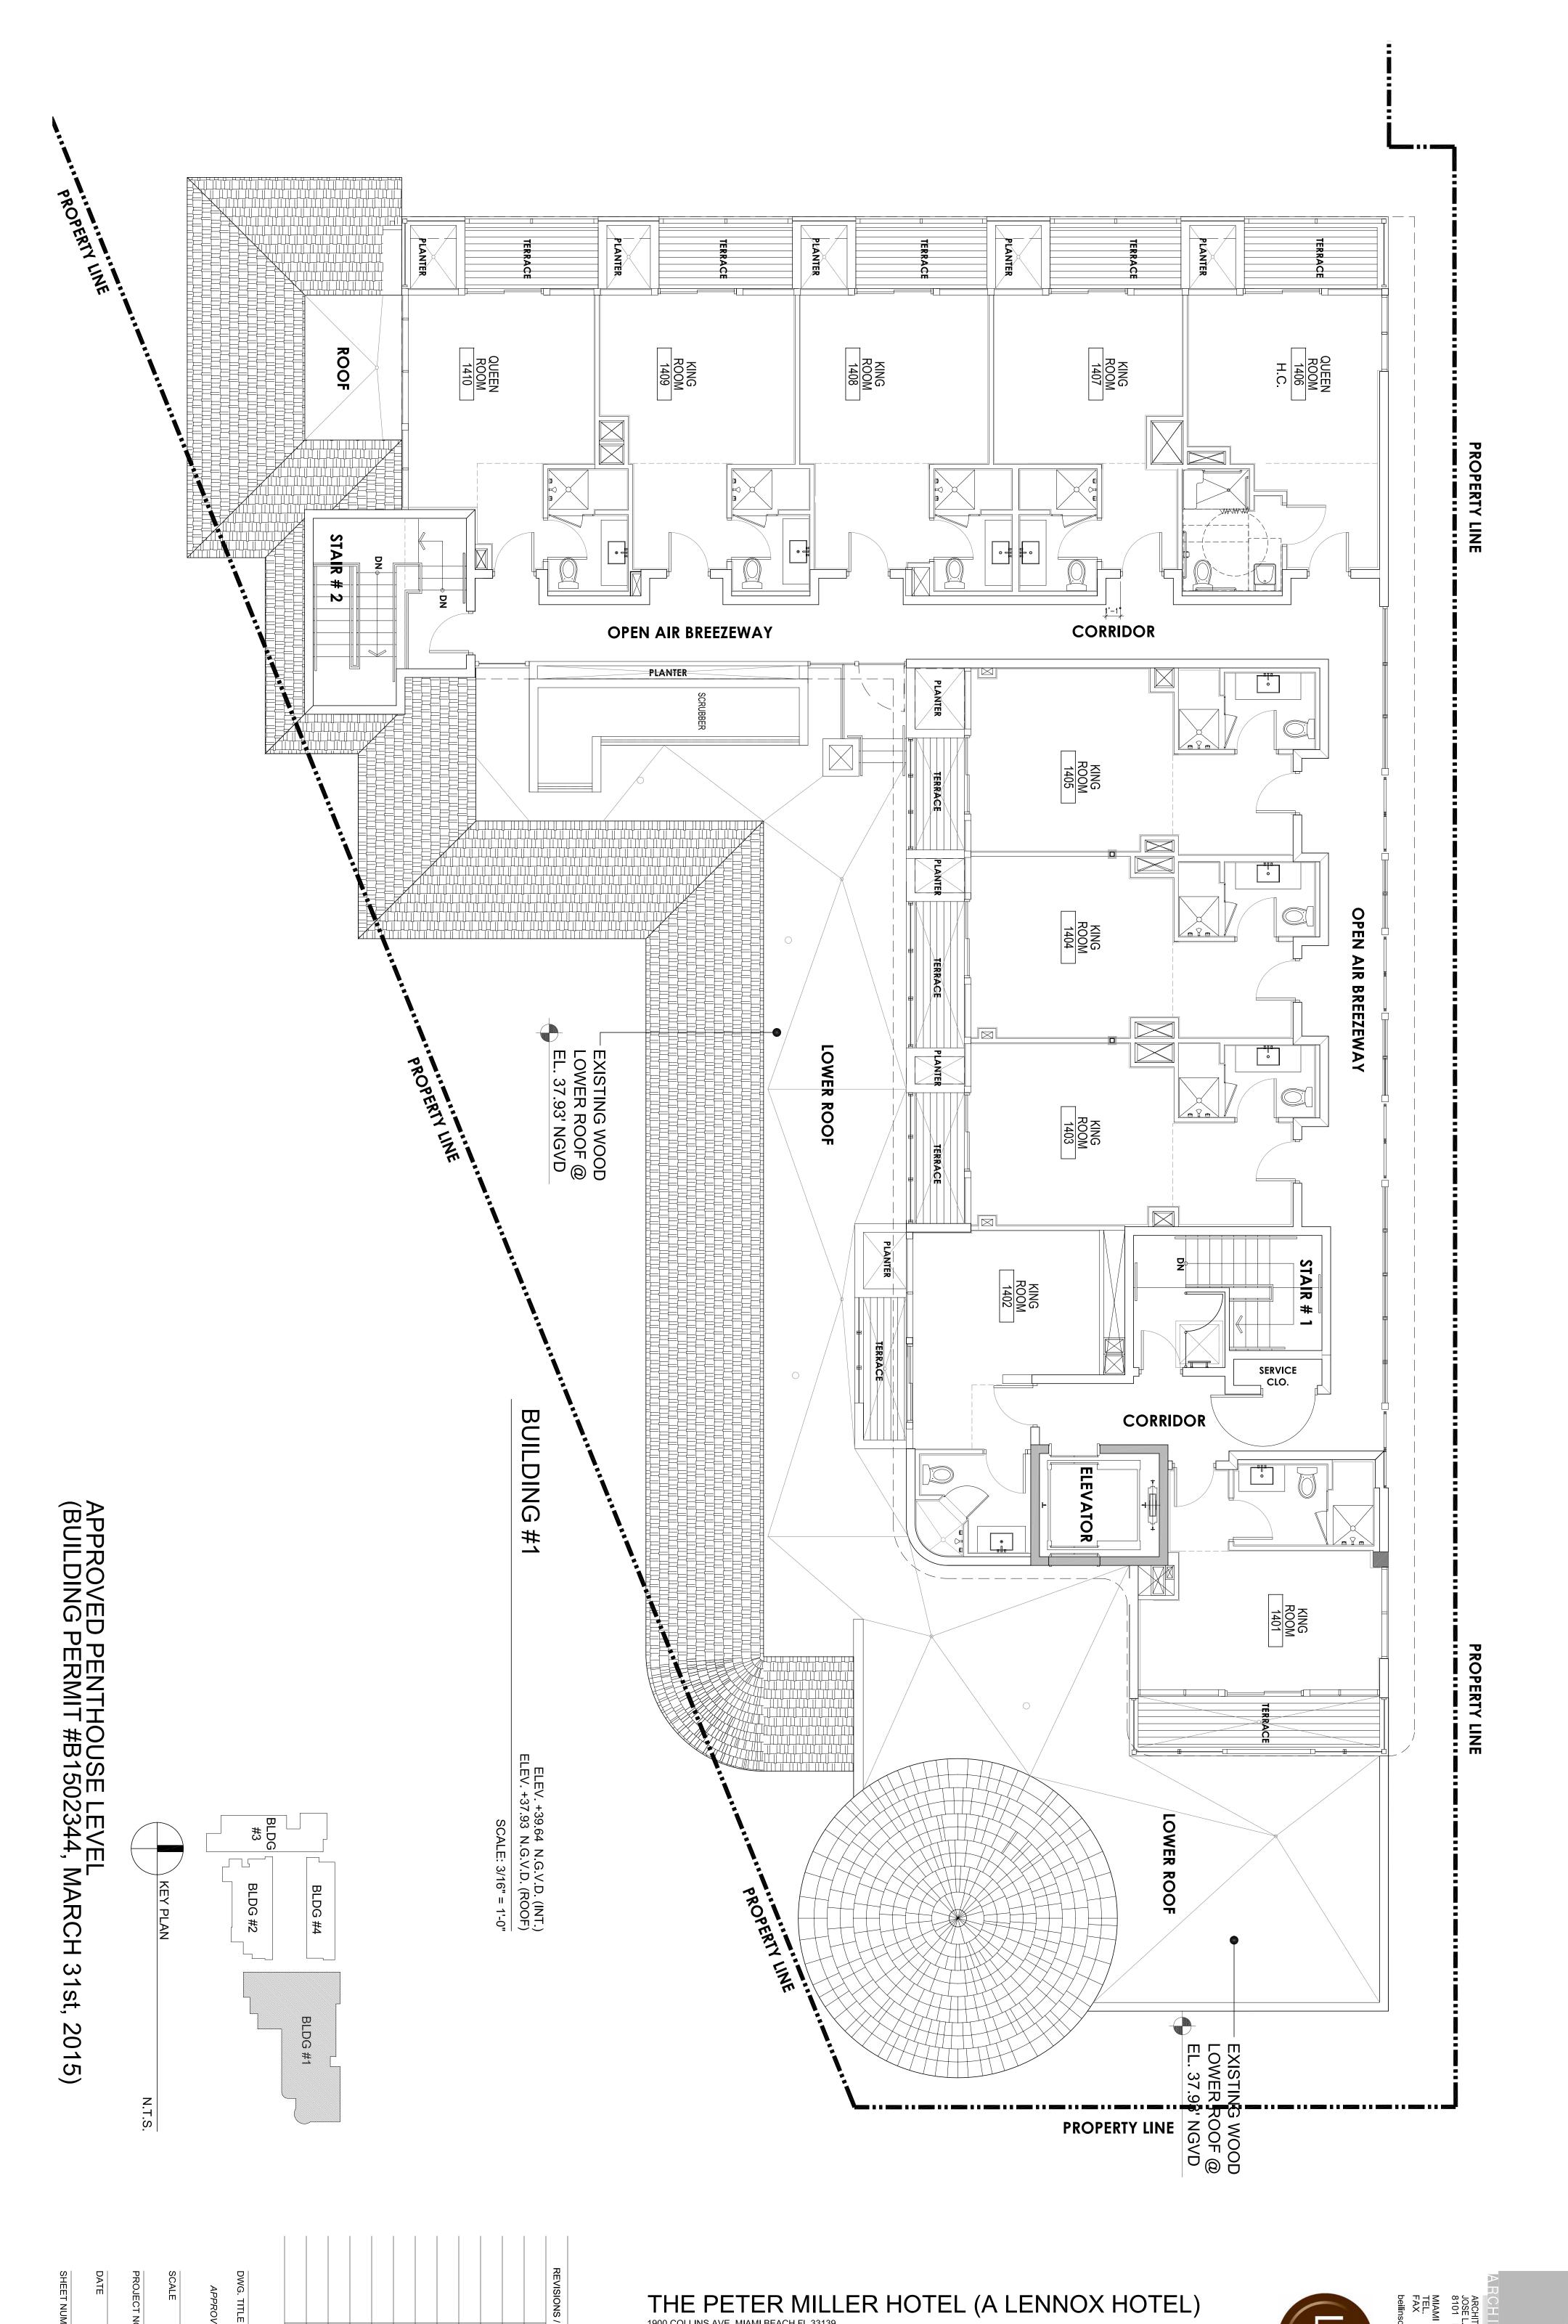

A2.00




ARCHITECTURE AAC001062
JOSE L. GOMEZ AR0015416
8101 BISCAYNE BLVD.
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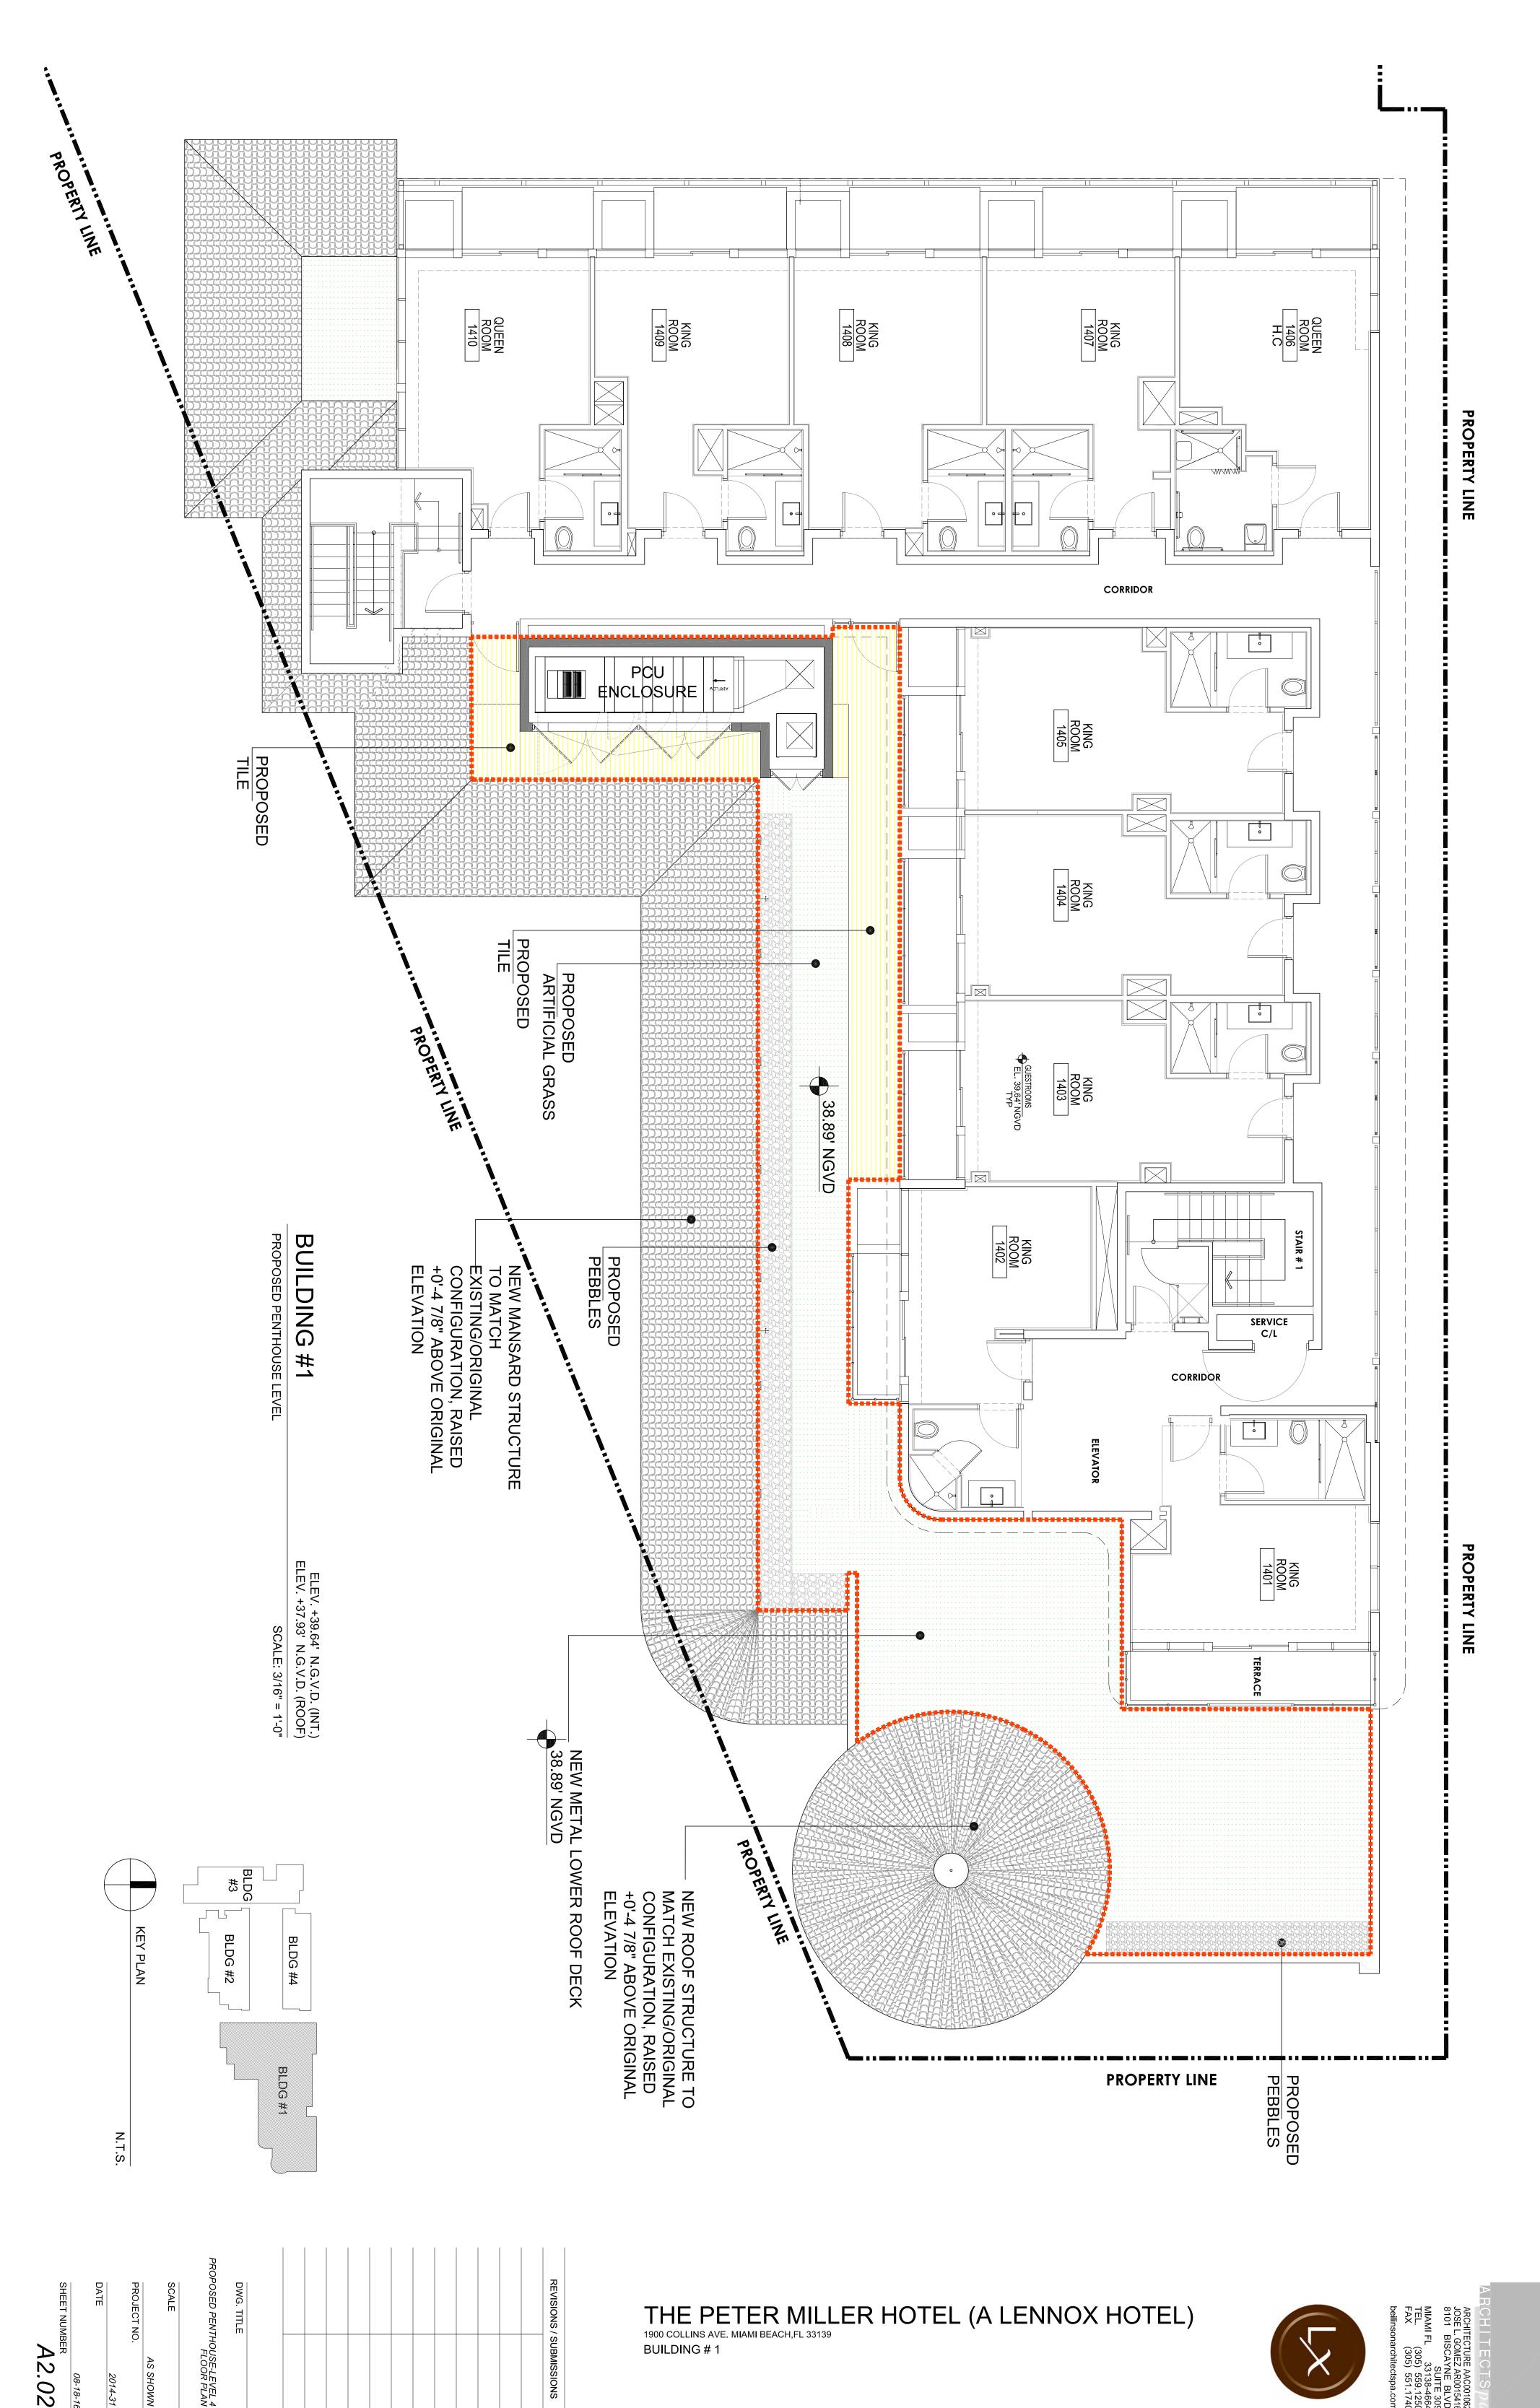

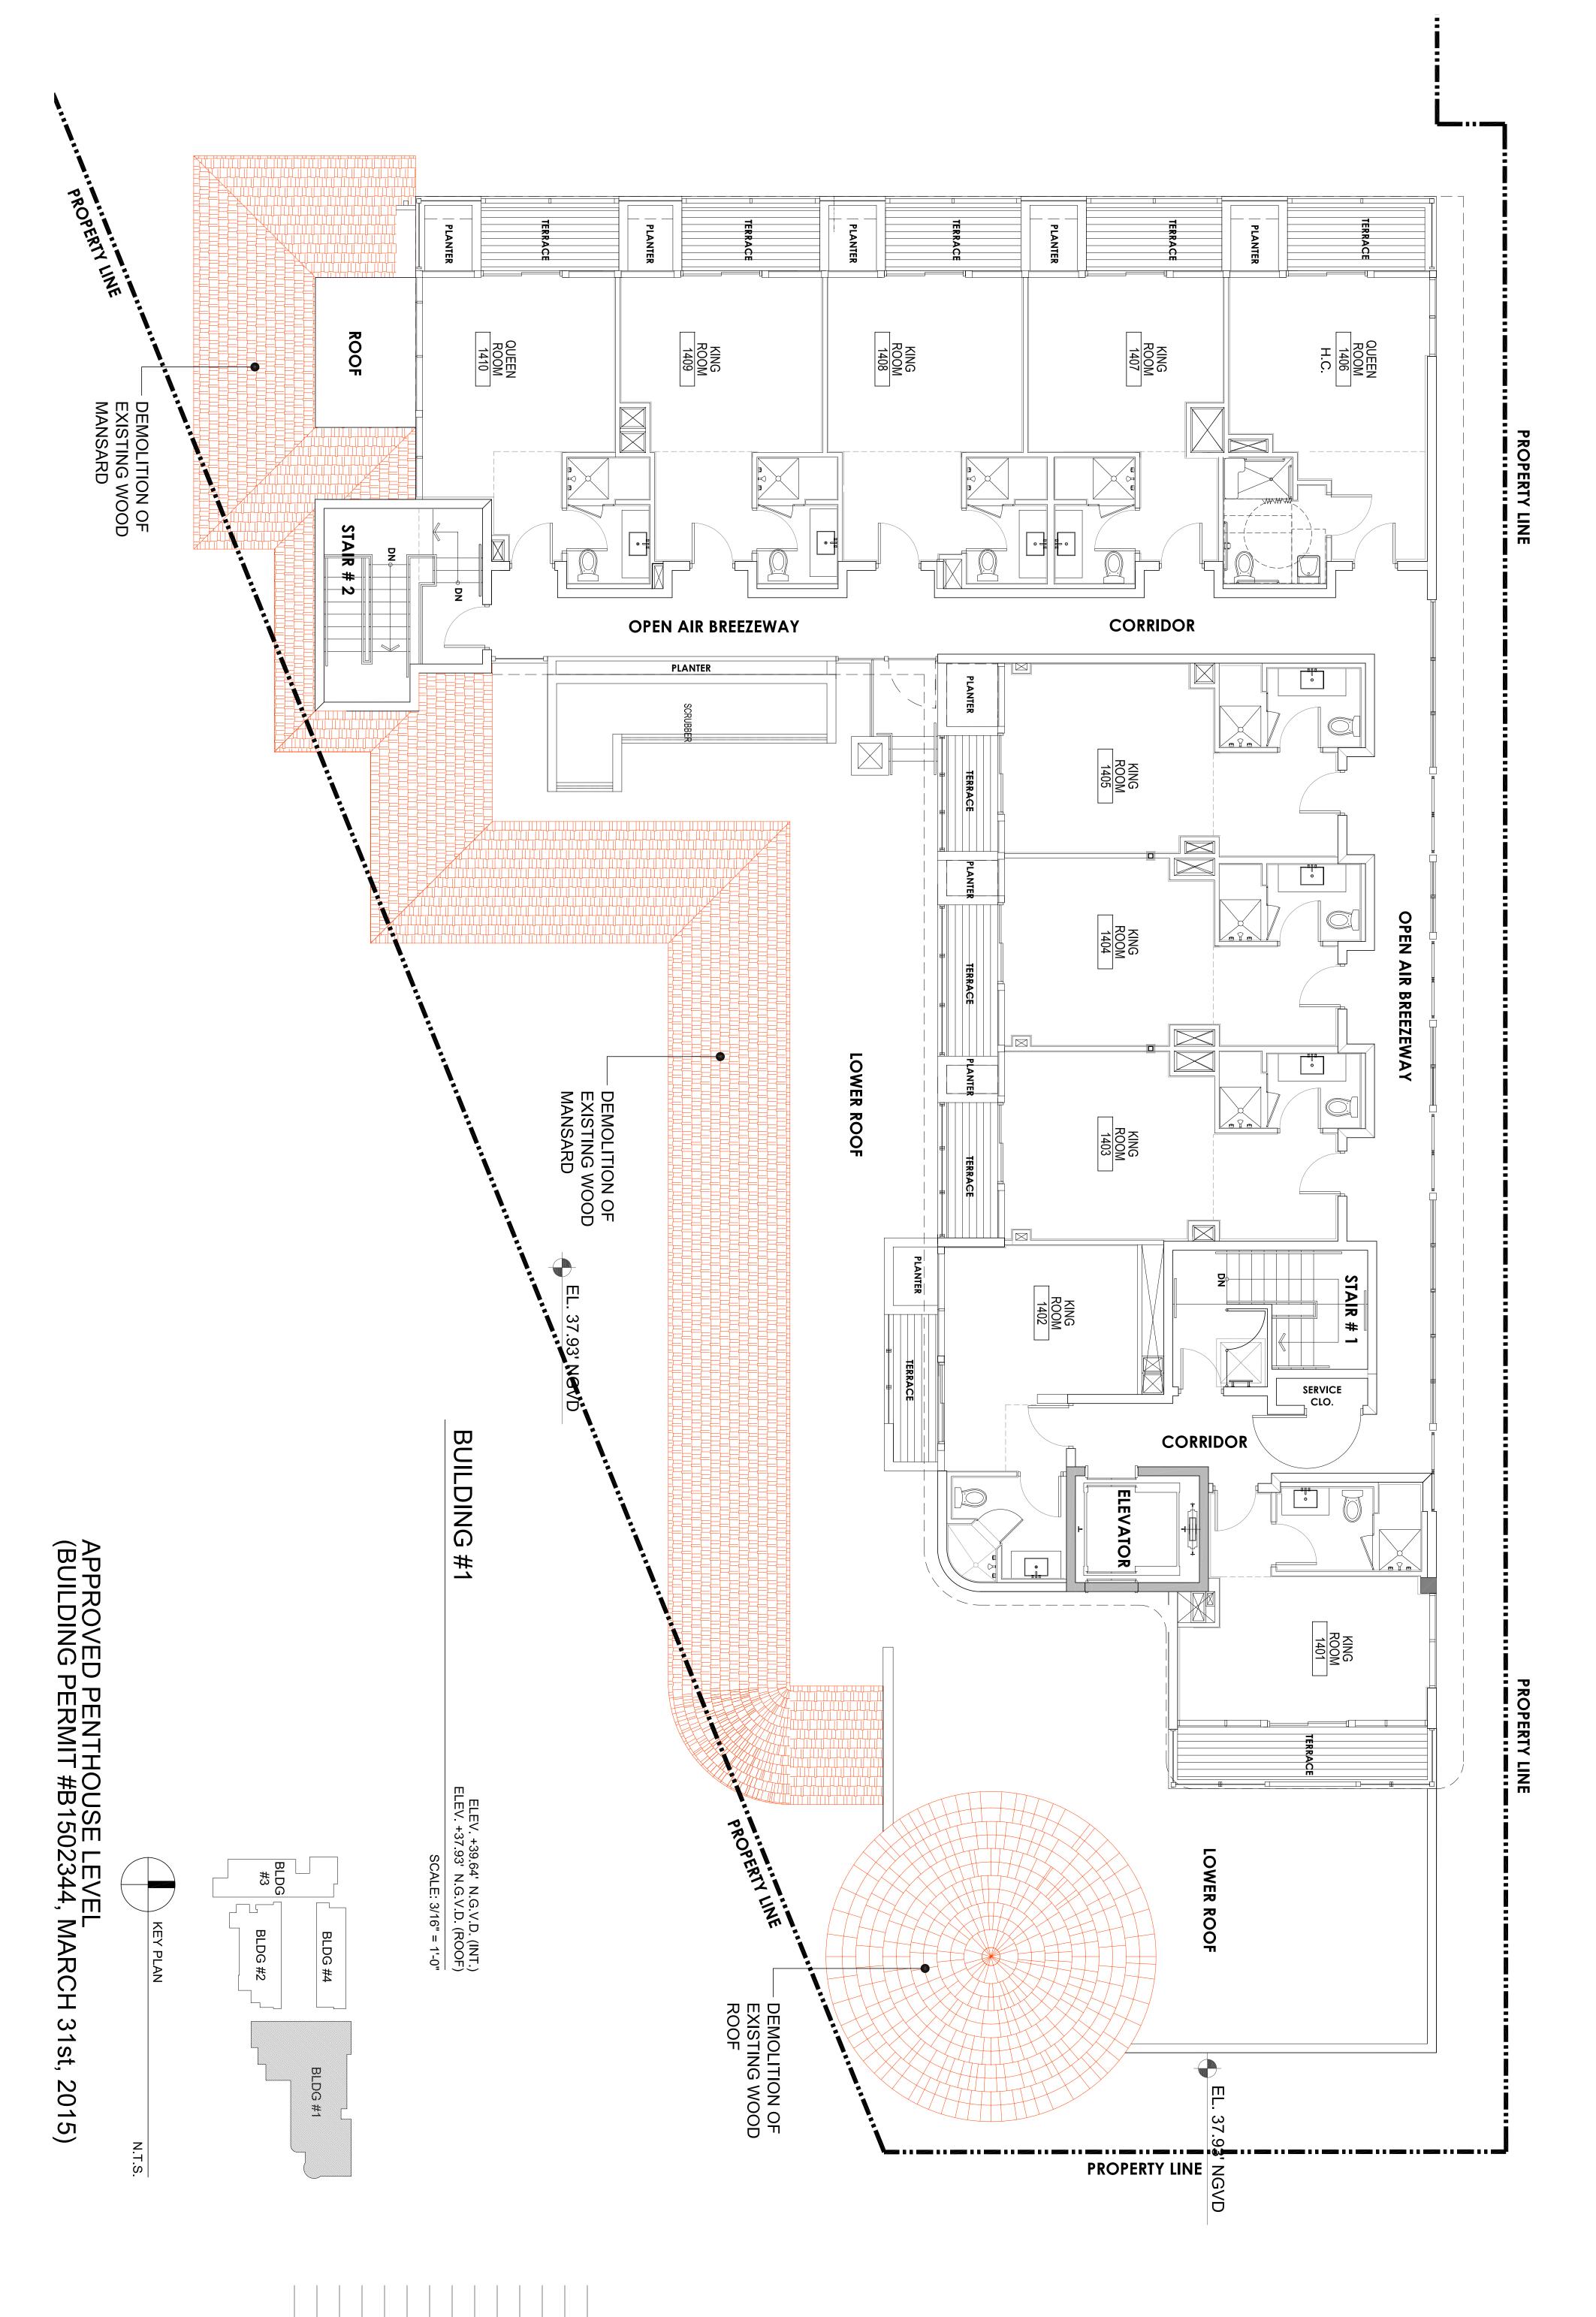
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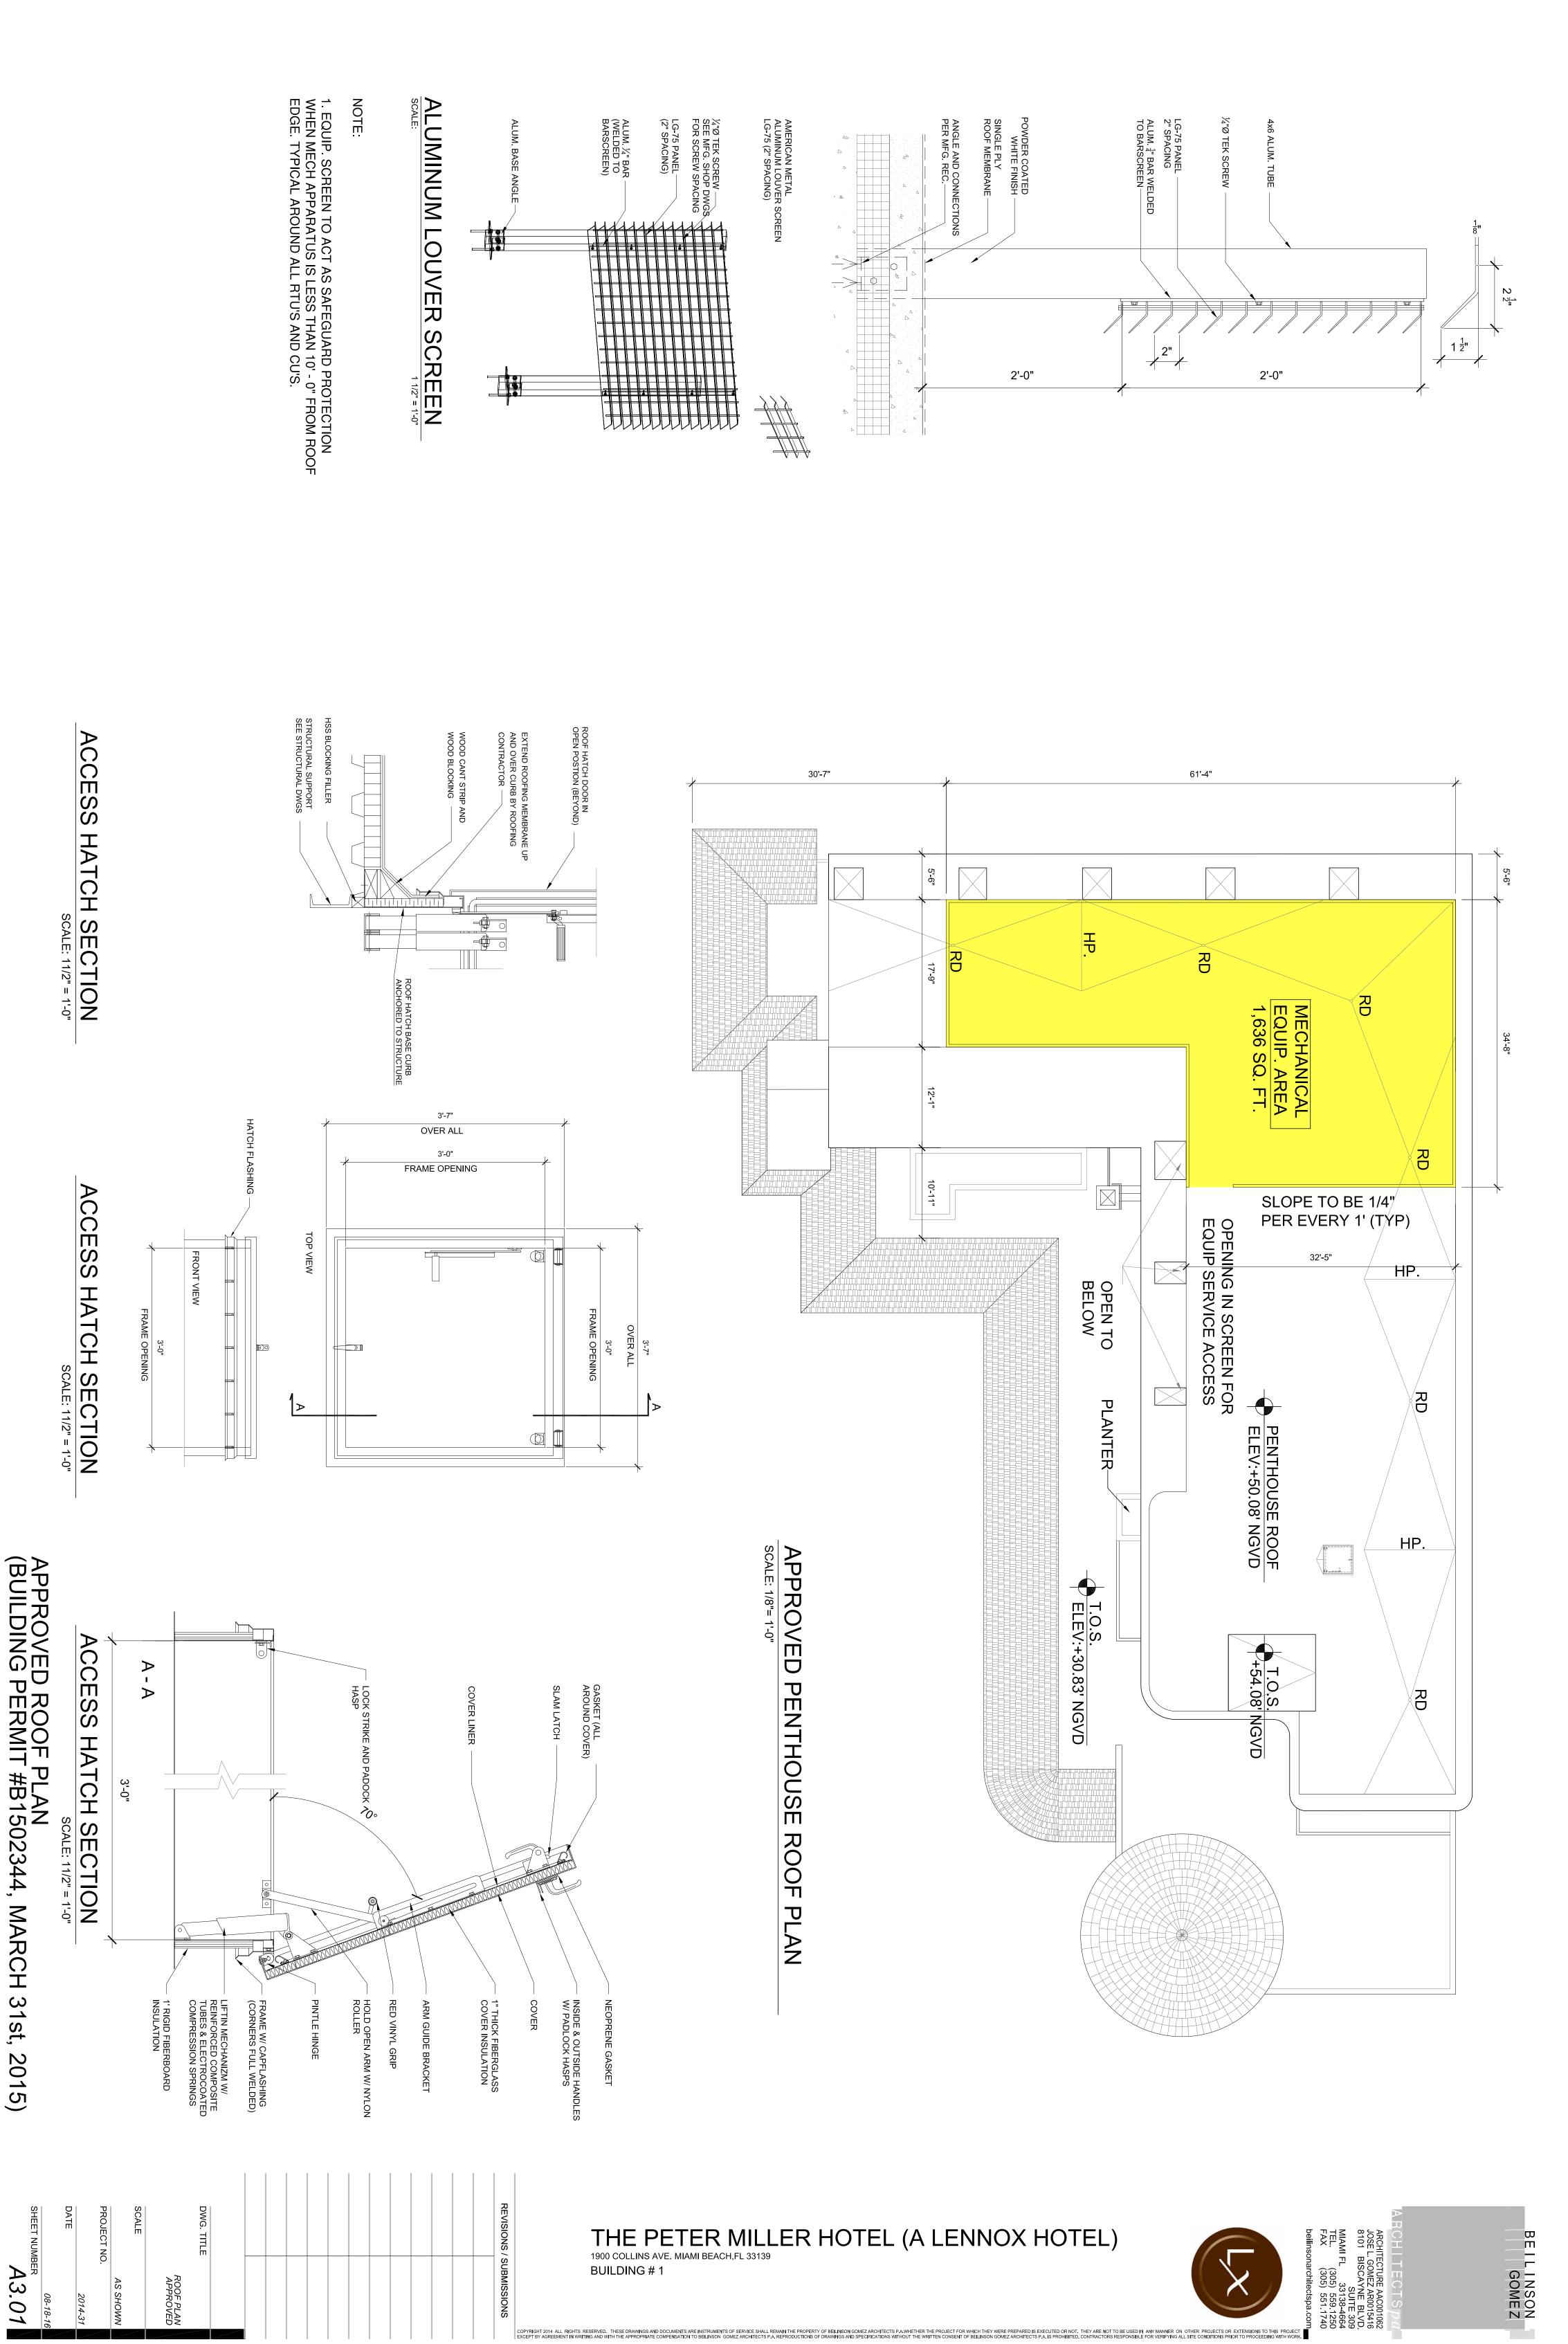





DWG. TITLE

AS SHOWN

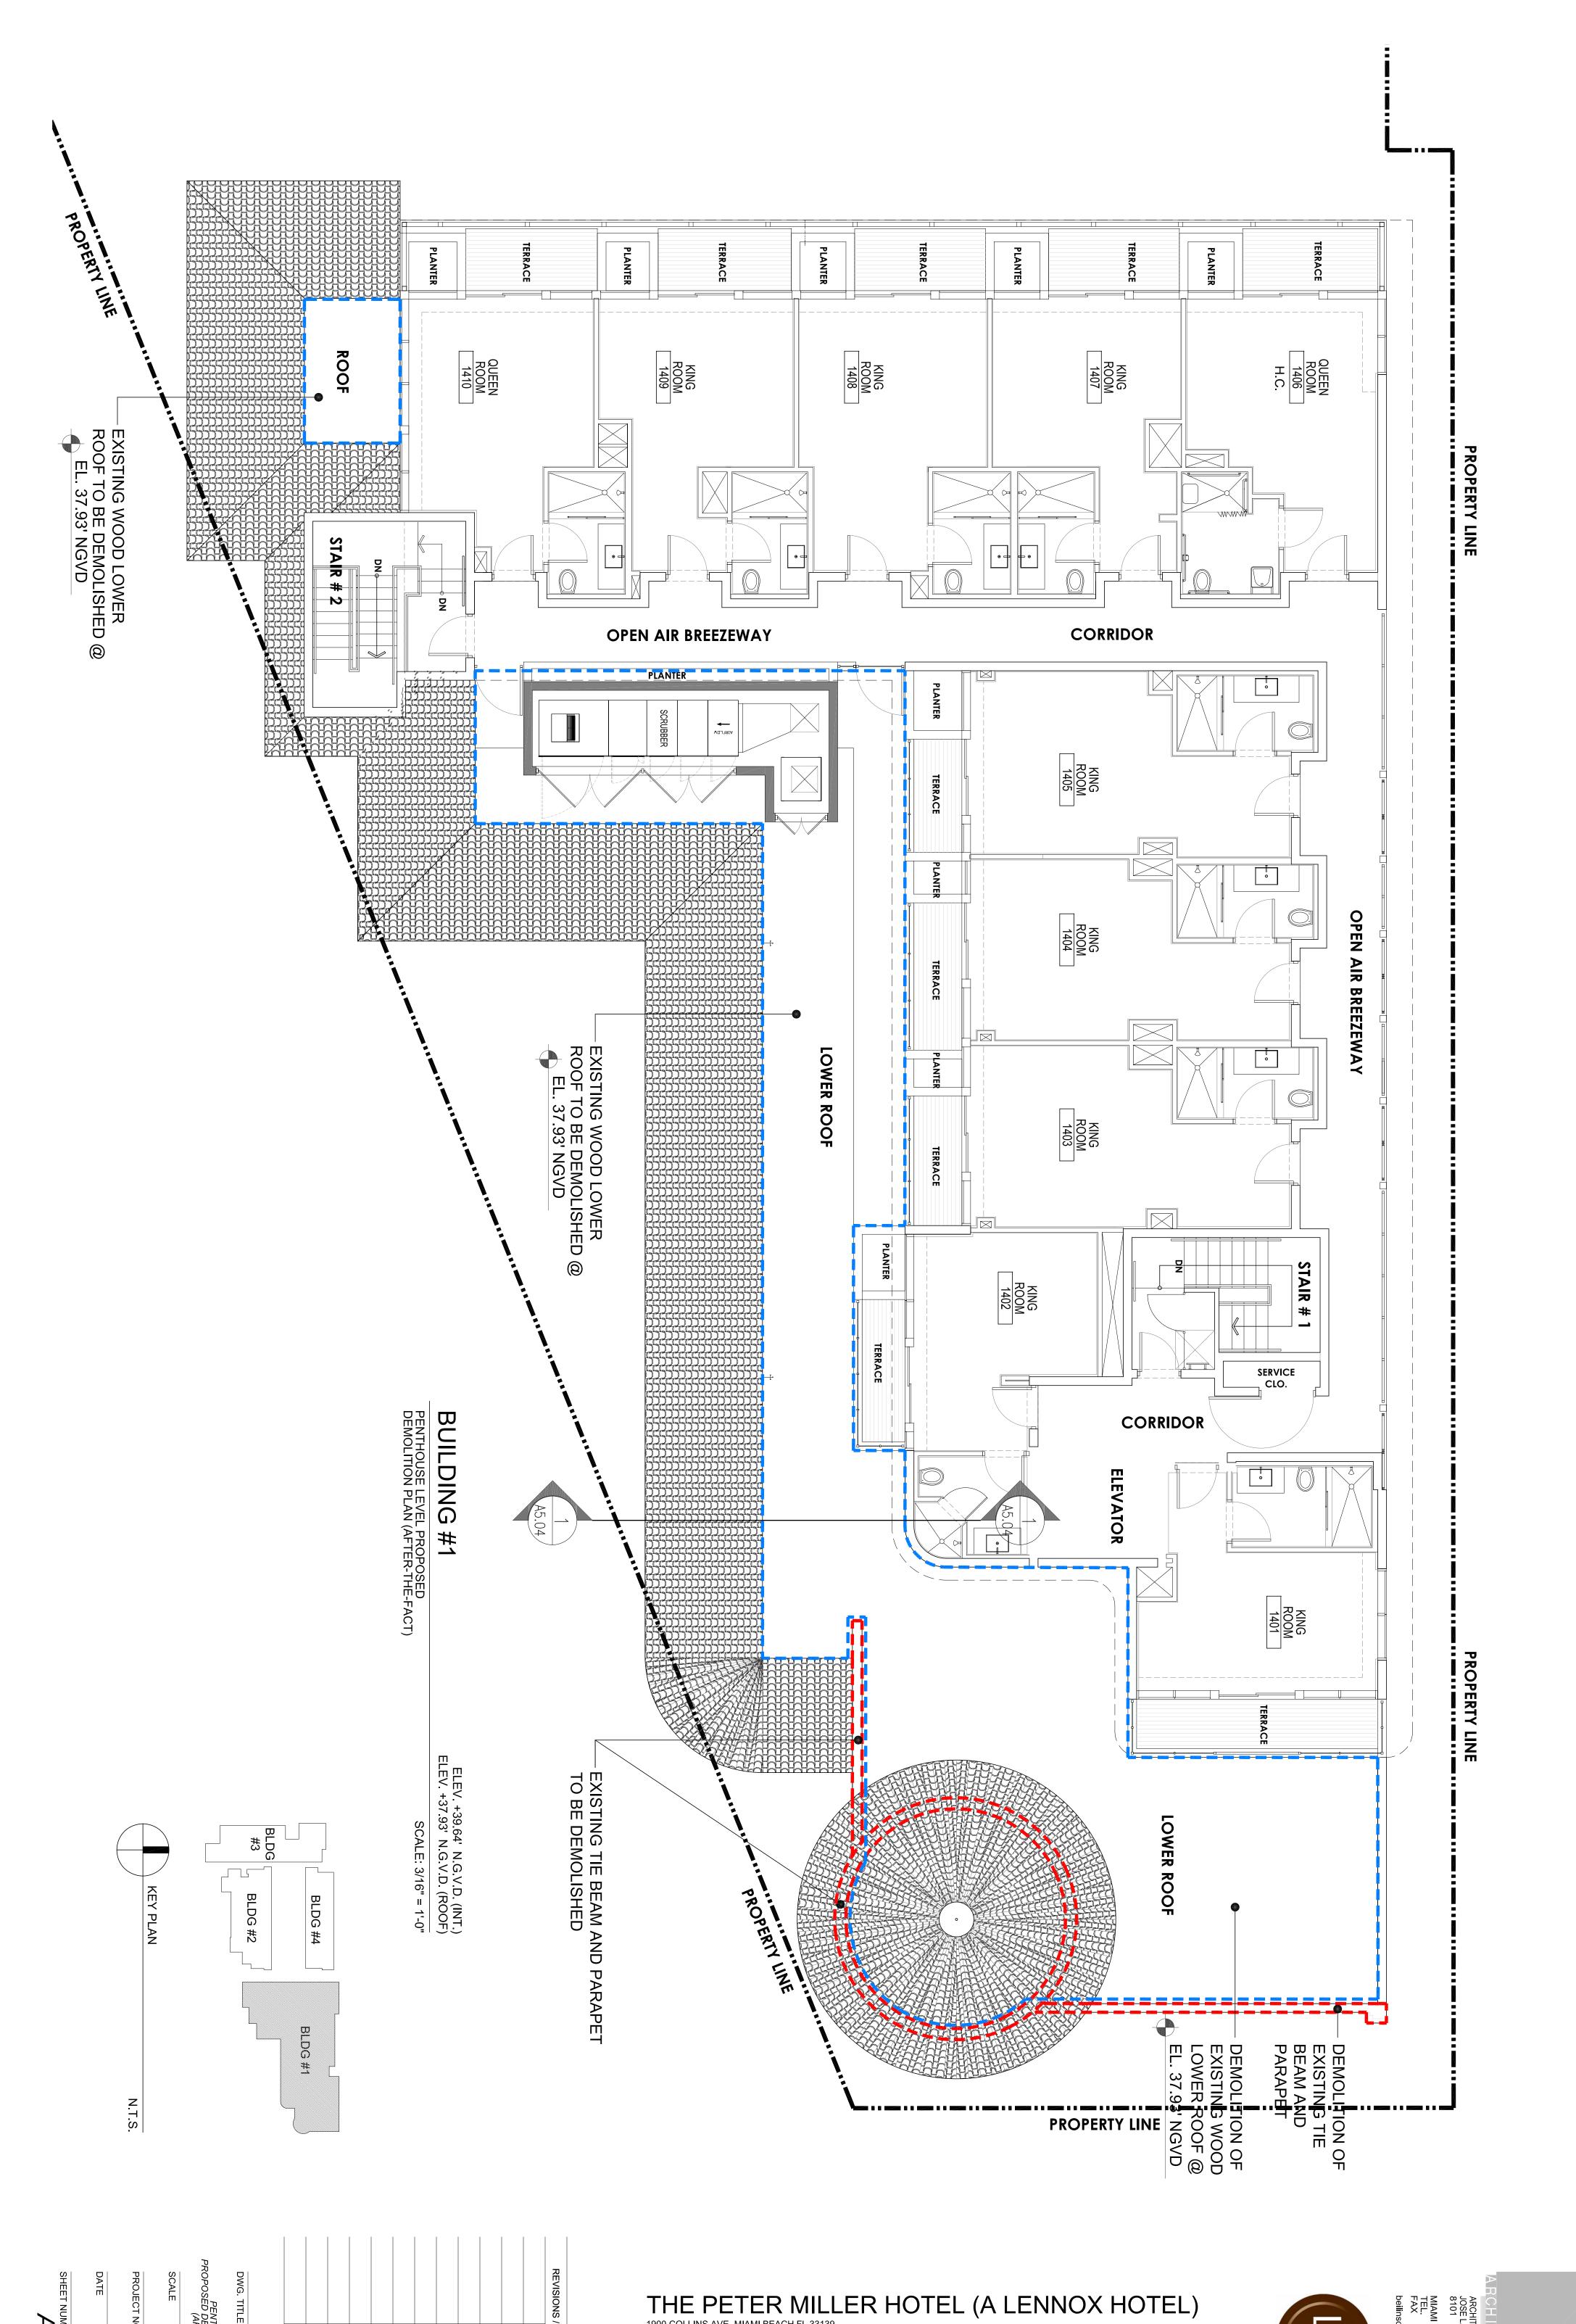A2.02



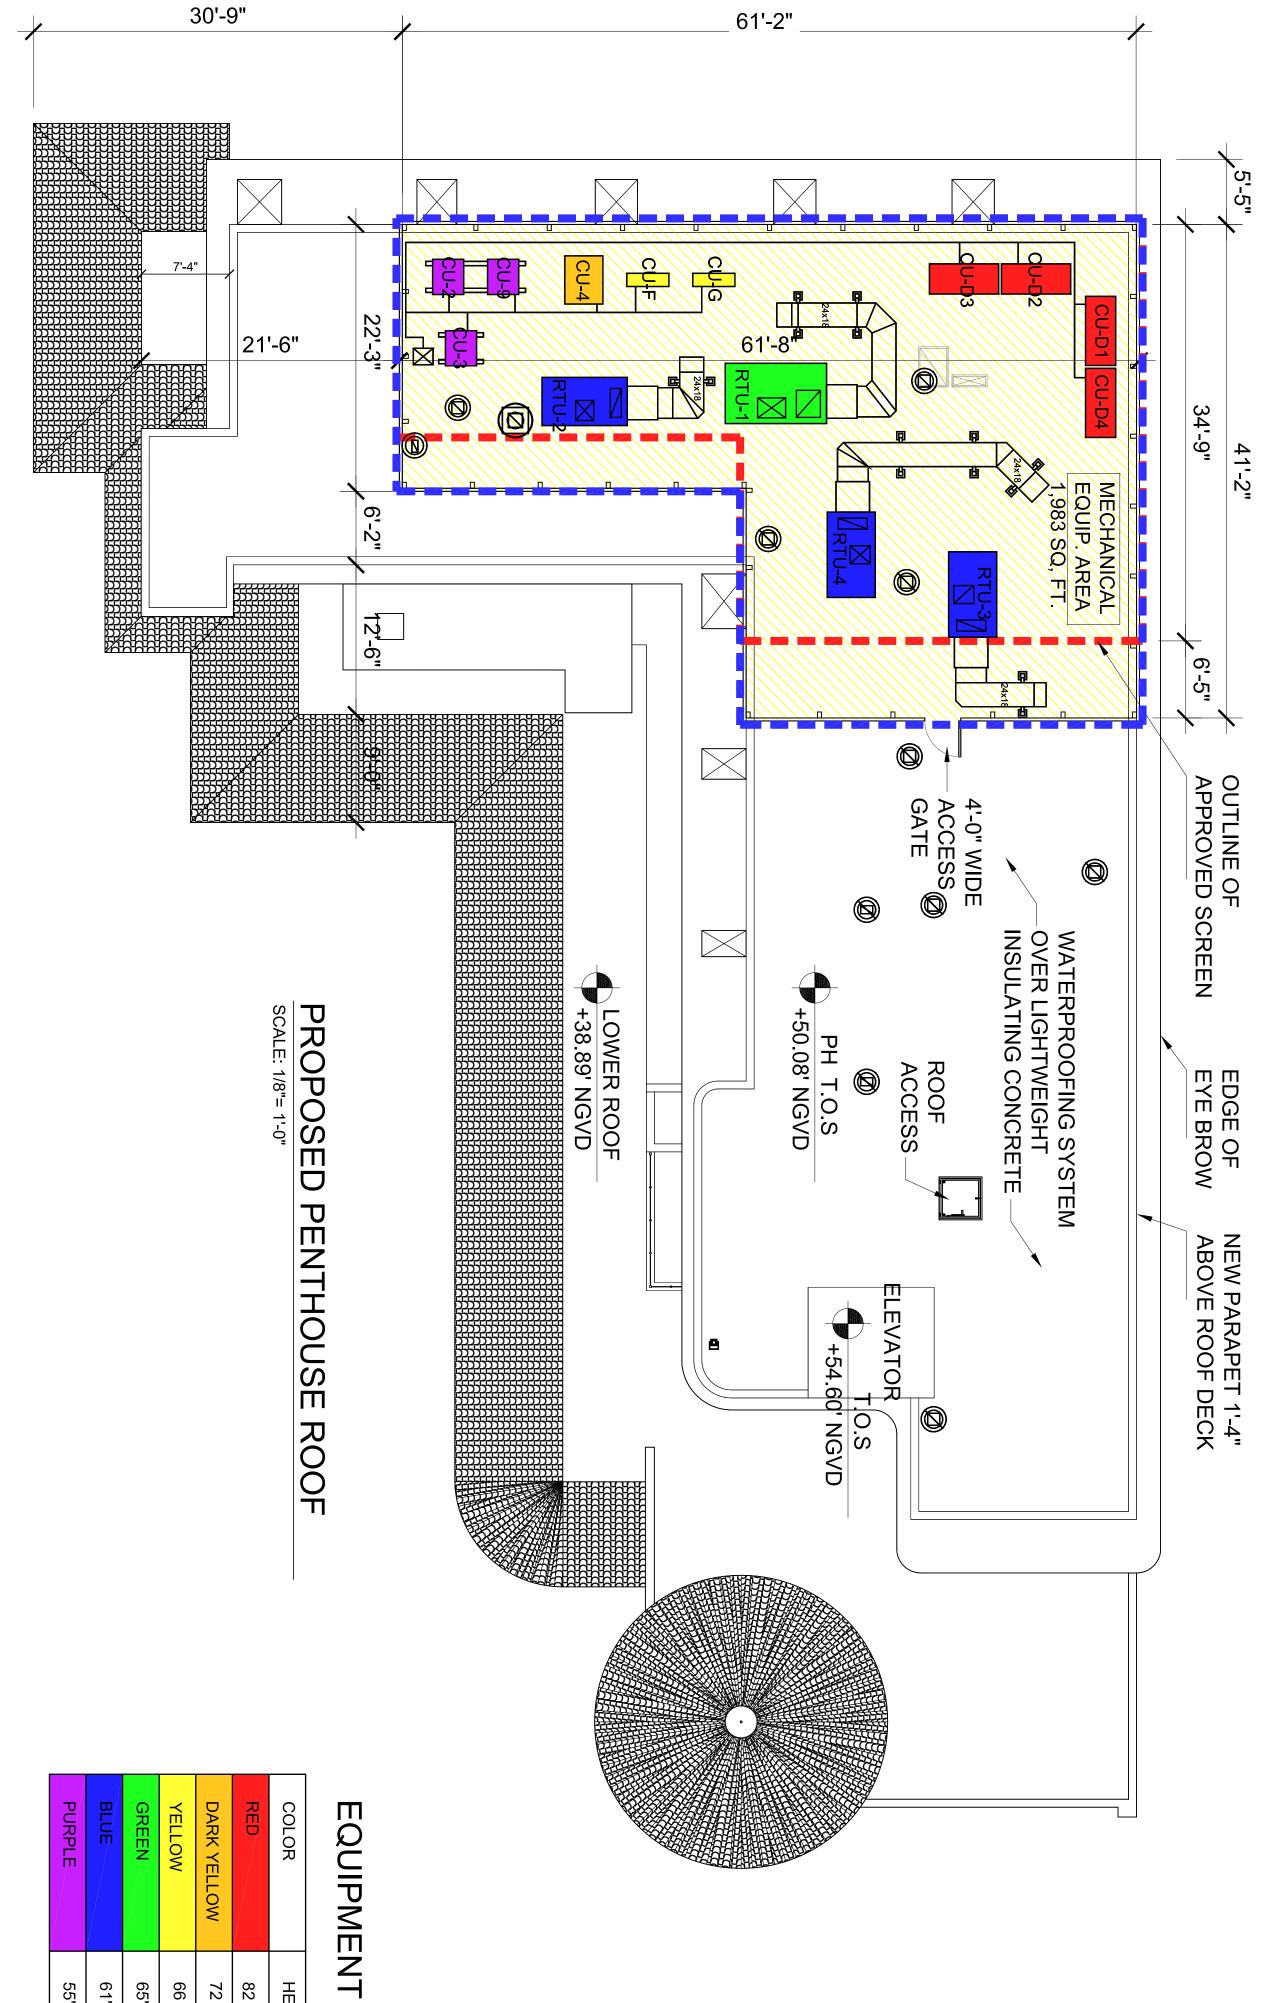

LEGEND:


APPROVED MECHANICAL AREA BOUNDARY
 PROPOSED MECHANICAL AREA BOUNDARY

PROPOSED EQUIP. AREA (2016)	BUILDING PERMIT. APPROVED. REV18(09-25-14)	MECHANICAL EQUIPMENT AREA	
1,983	1,672	S.F.	

COLOR	HEIGHT	EQUIPMENT
RED	$82\frac{1}{2}$ "	CU-D1,CU-D2,CU-D3,CU-D4
DARK YELLOW	$72\frac{3}{4}$ "	CU-4
YELLOW	66 <u>11</u> "	CU-6, CU-F
GREEN	65"	RTU1
BLUE	61"	RTU-2,RTU-4,RTU-3
PURPLE	55"	CU-3,CU-2,CU-9,

LEGEND:

SHEEI NUMBER	08-18-16	DATE	2014-31	PROJECT NO.	AS SHOWN	SCALE	PROPOSED PENTHOUSE ROOF	DWG. TITLE	

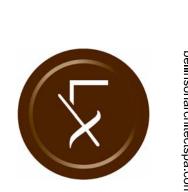

MARCH 31st, 2015) SCALE: 3/16" = 1'-0"




APPROVED EAST

PROJECT NO.

AS SHOWN

DWG. TITLE

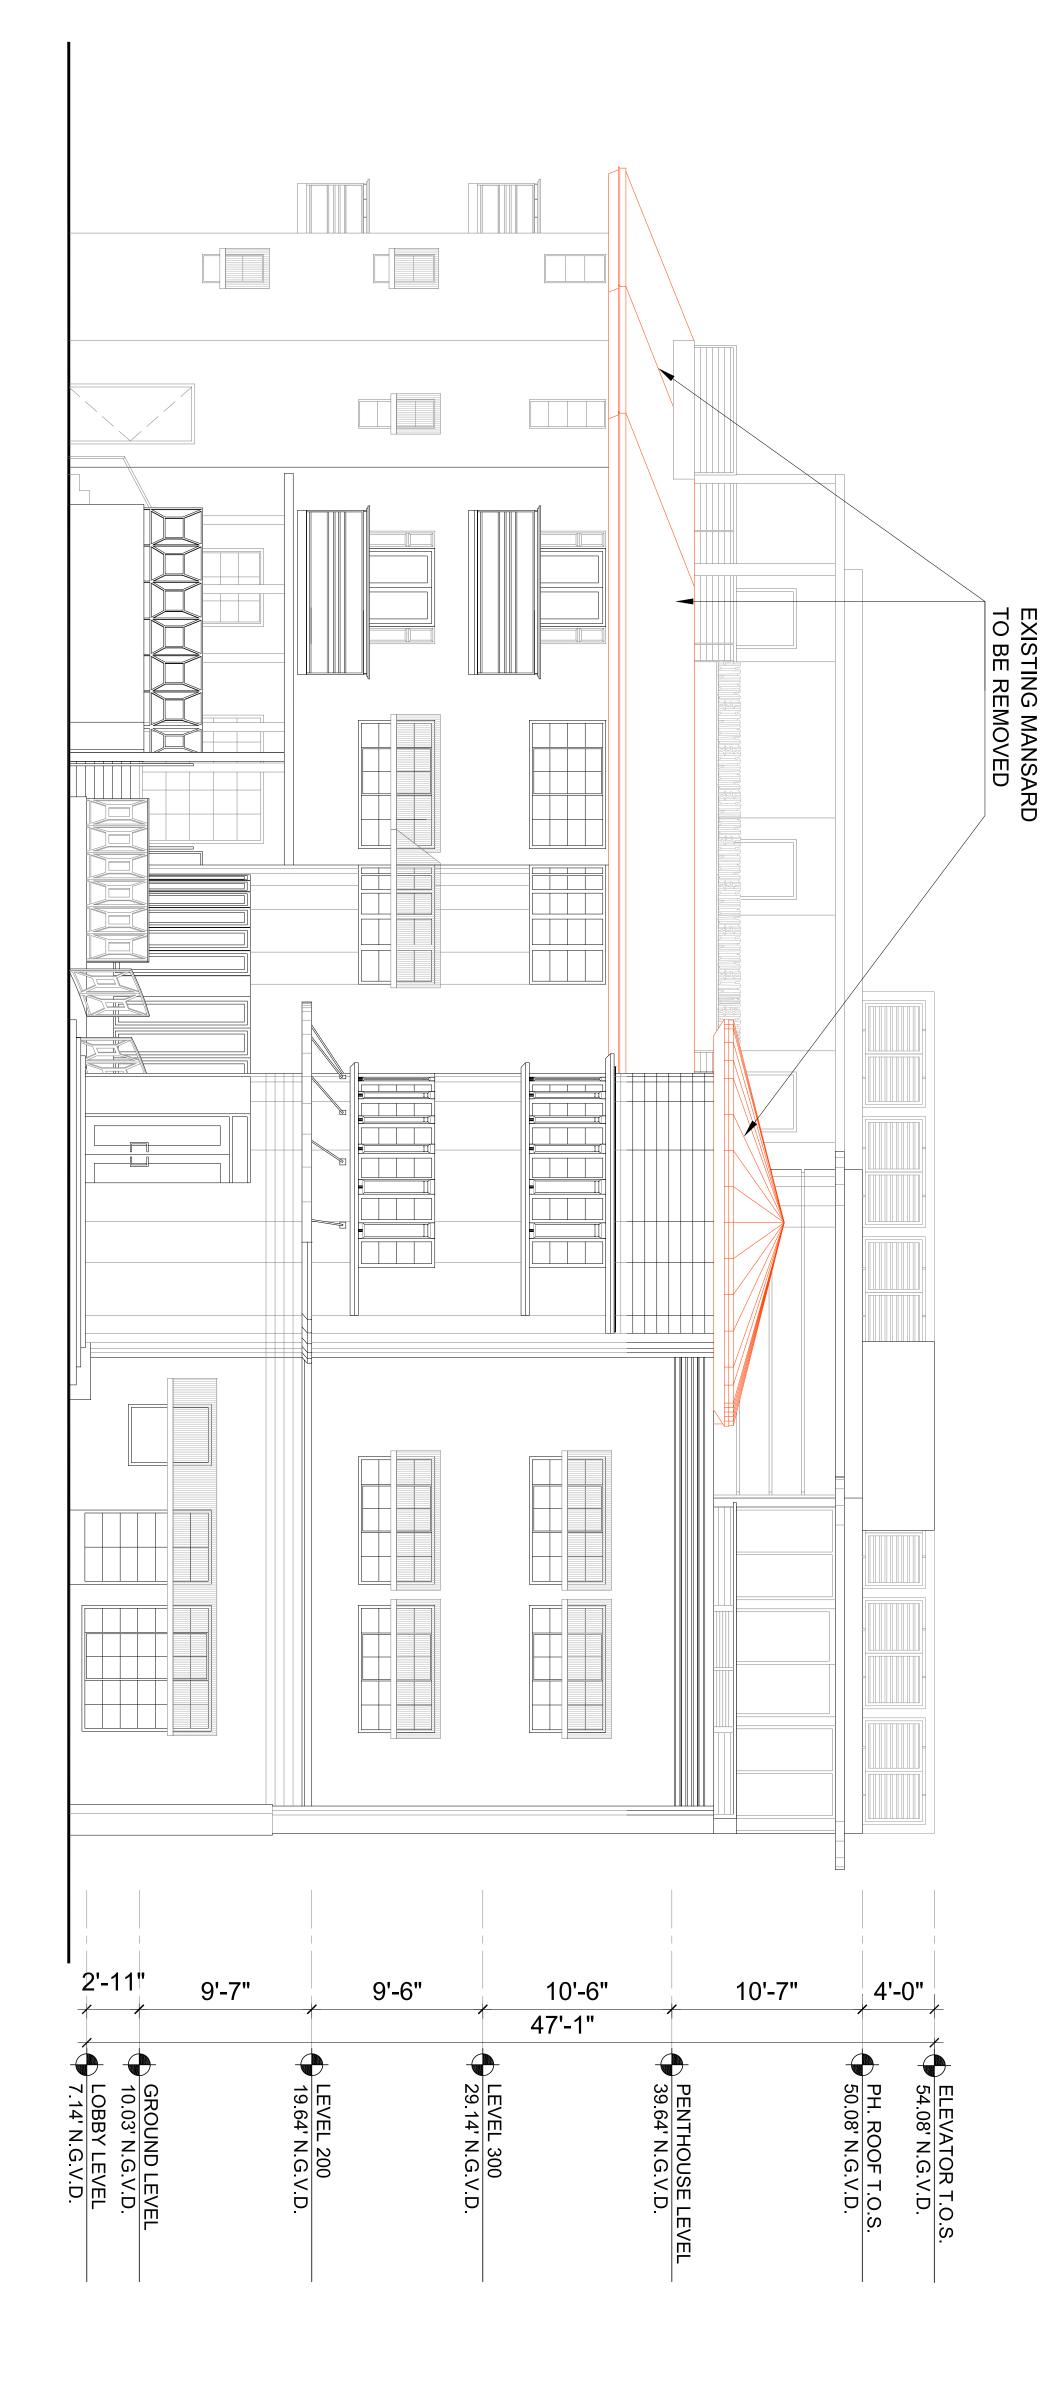

APPROVED EAST ELEVATION. DEMOLITION. (BUILDING PERMIT #B1502344, MARCH 31st, 2015)


SCALE: 3/16" = 1'-0"

APPROVED EAST ELEVATION. DEMOLITION

AS SHOWN

DWG. TITLE

SHEET NUMBER A4.02

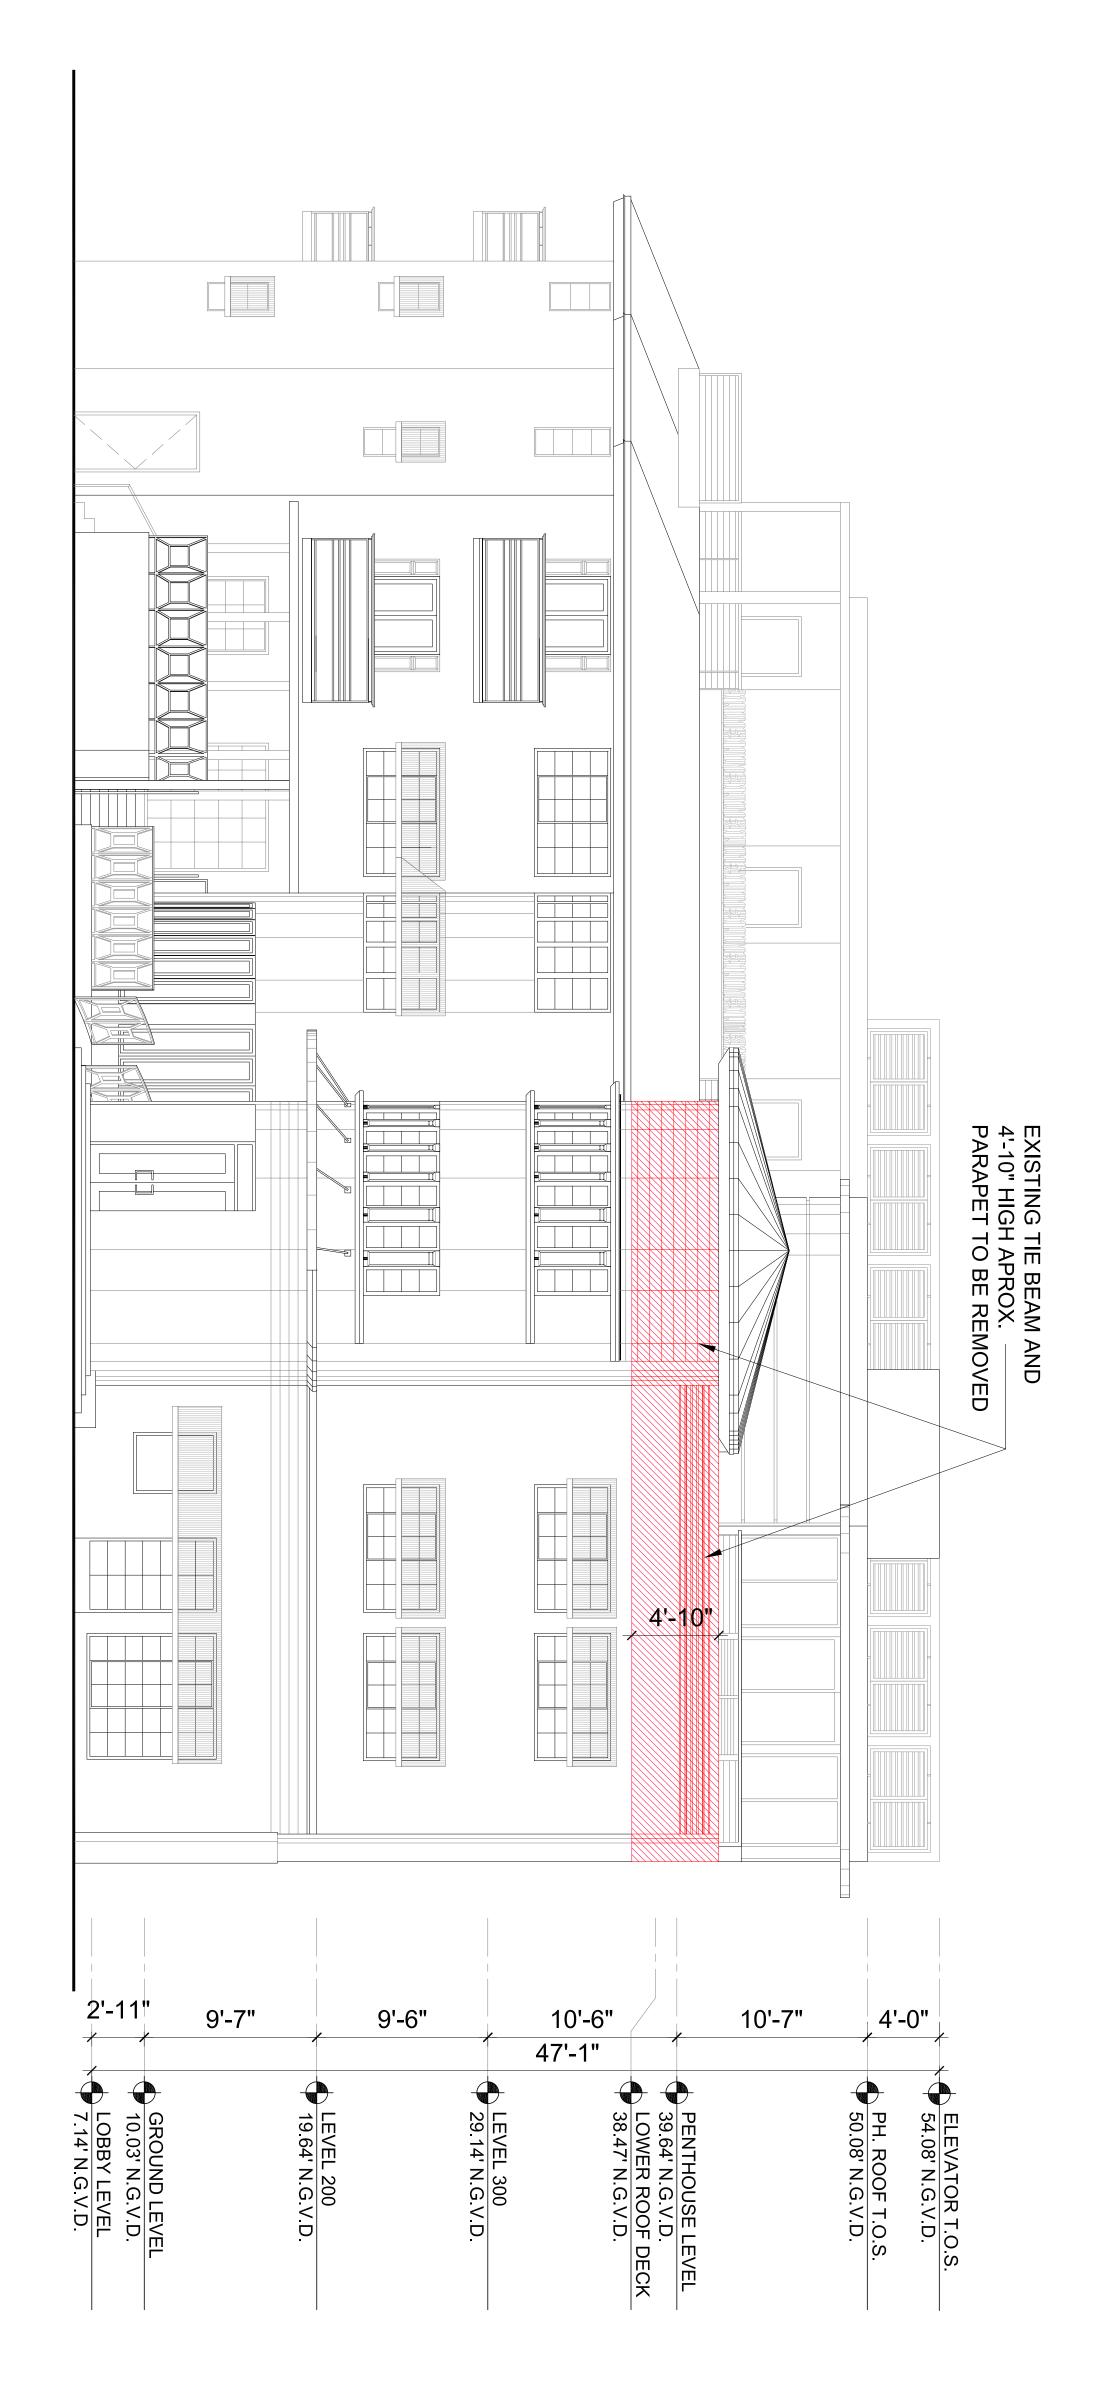







DWG. TITLE

EAST ELEVATION PROPOSED DEMOLITION (AFTER-THE-FACT)

AS SHOWN

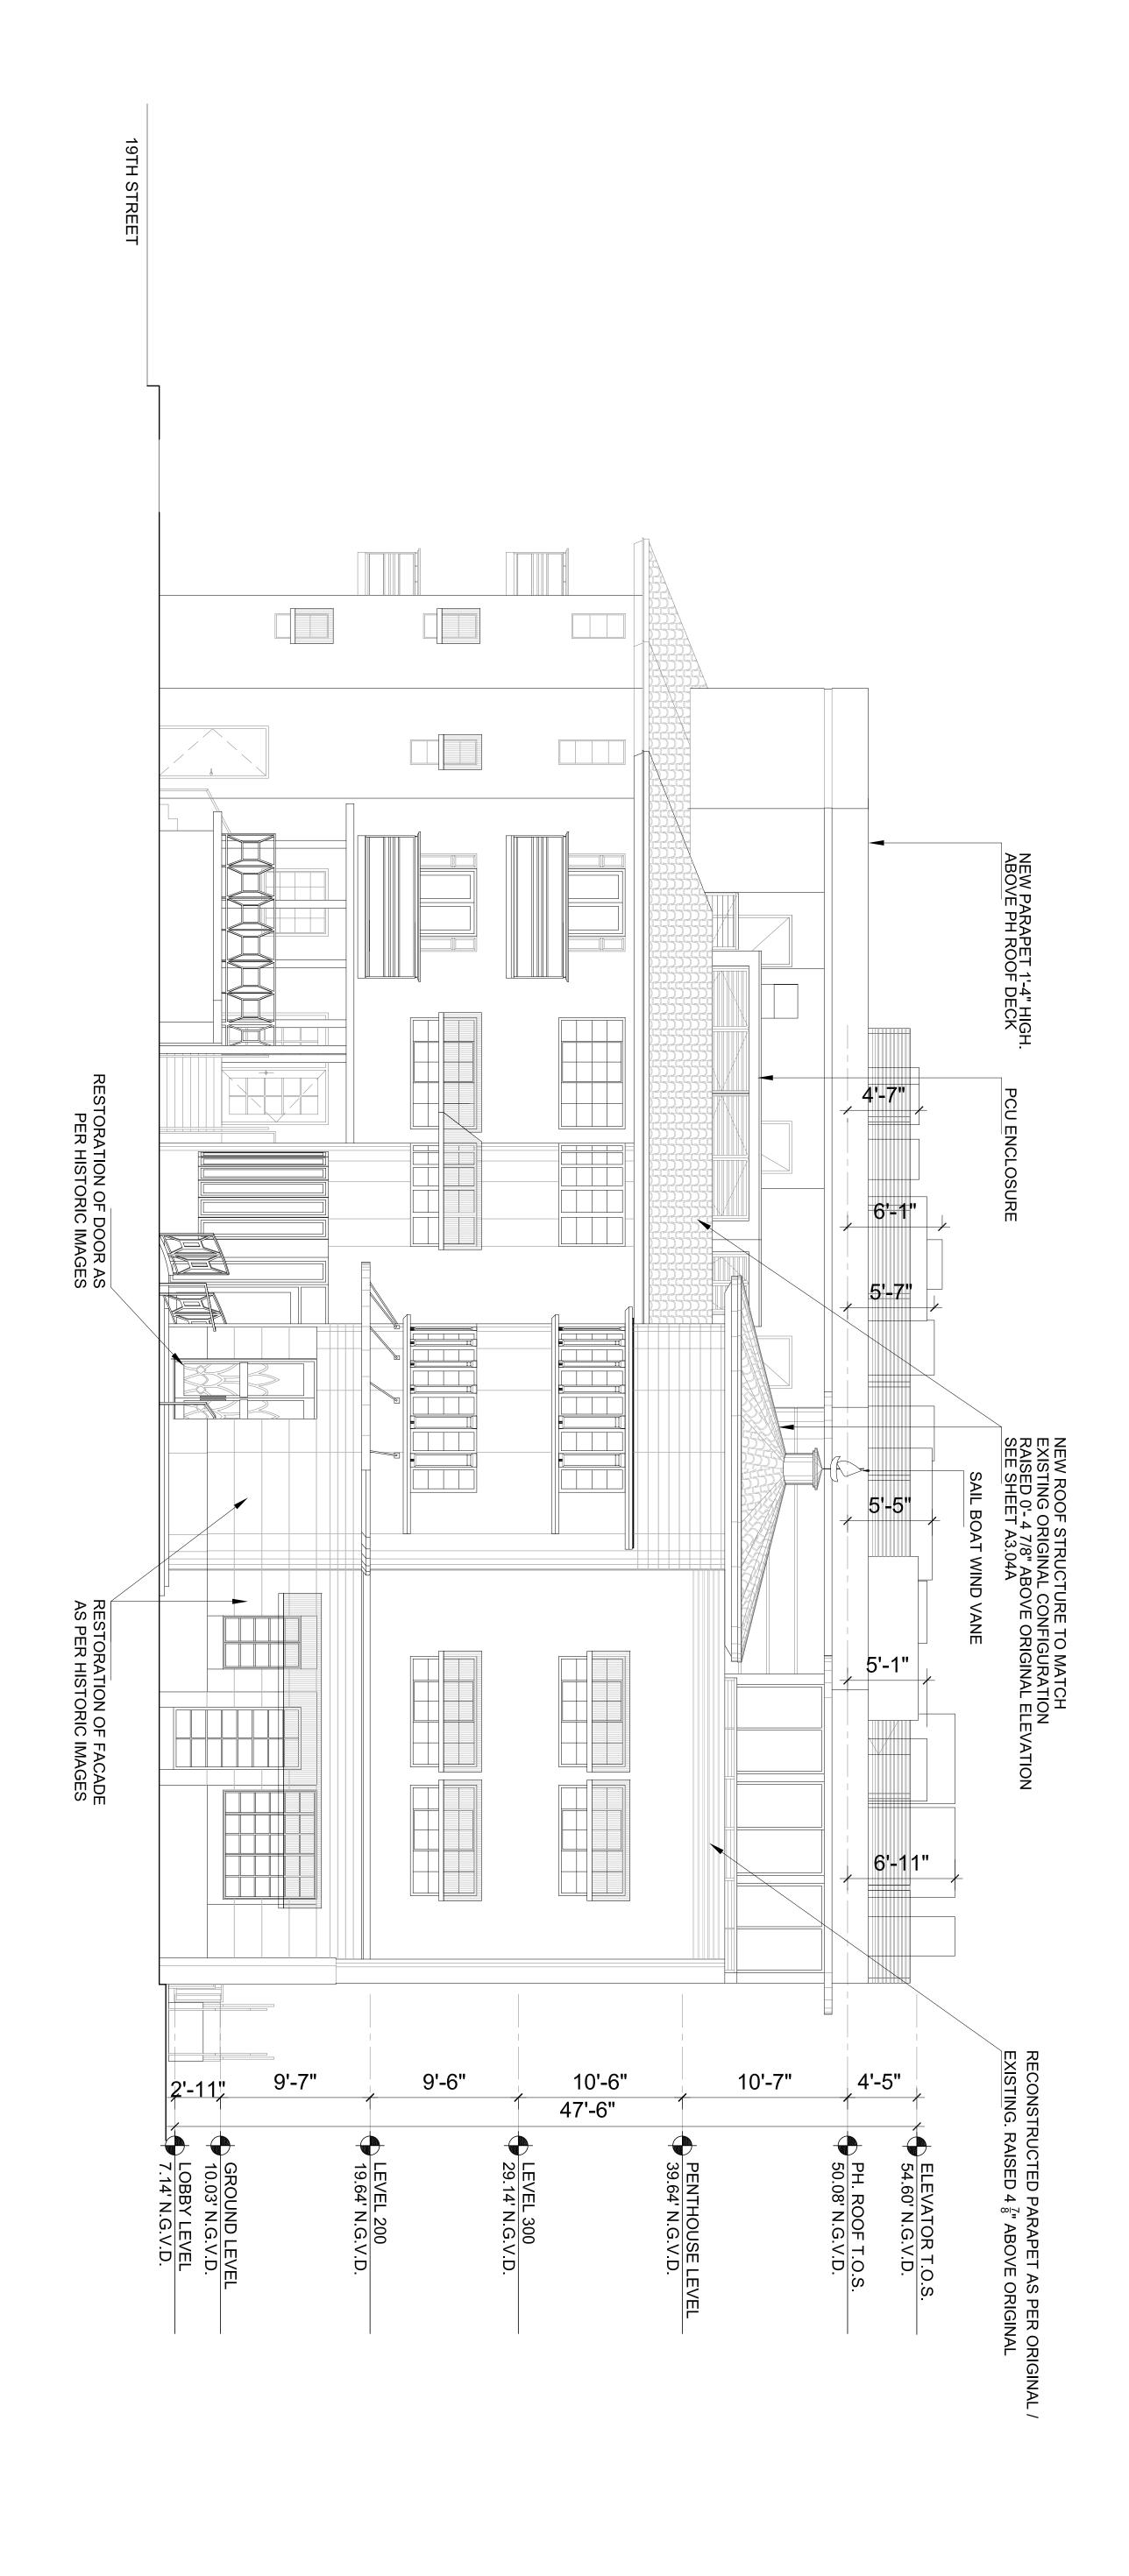

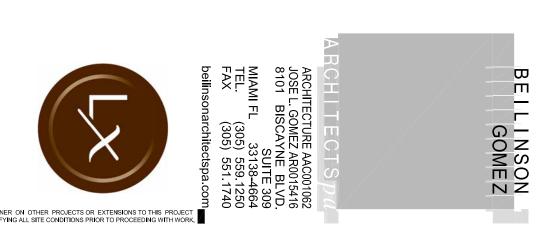

A4.03

DWG. TITLE

PROPOSED EAST ELEVATION









SHEET NUMBER A4.05

APPROVED SOUTH EL

AS SHOWN

DWG. TITLE

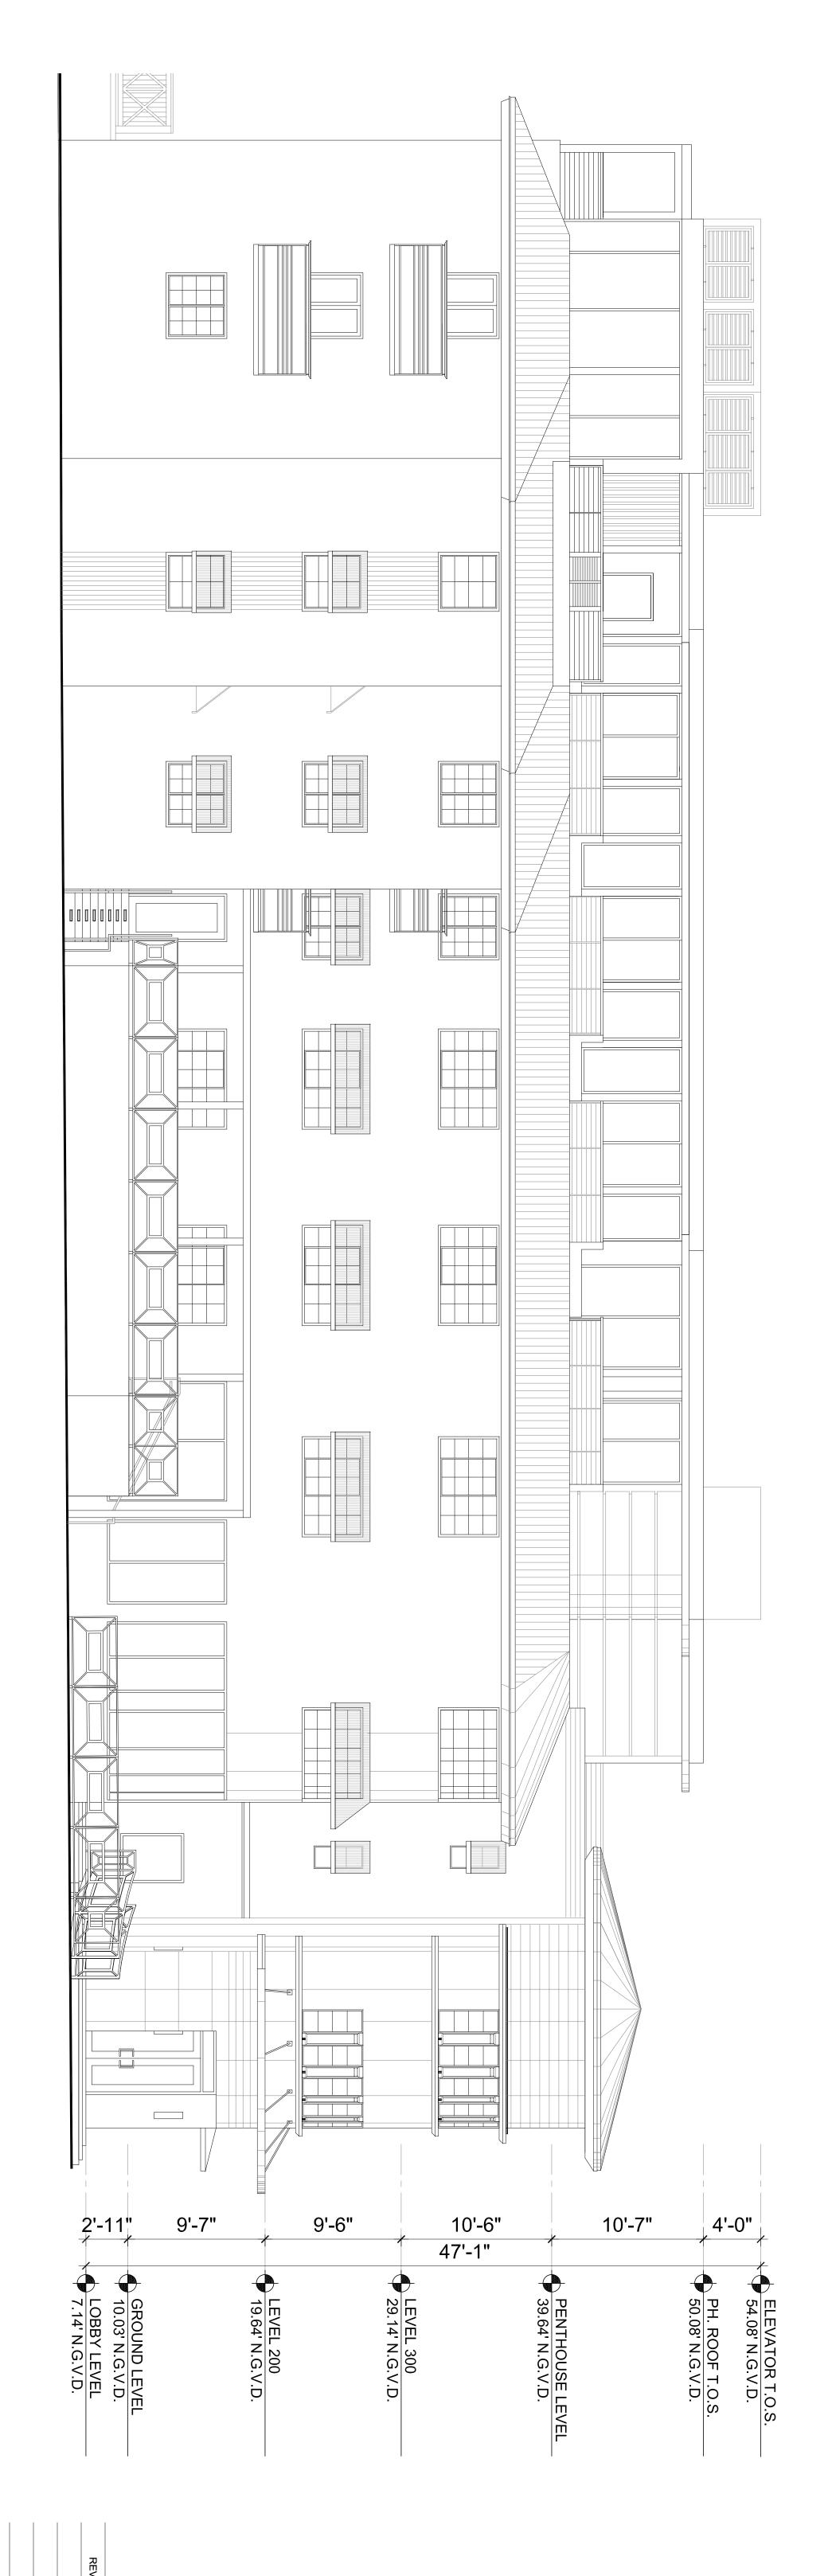

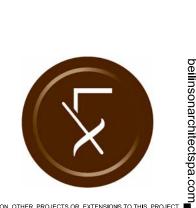




APPROVED SOUTH ELEVATION. DEMOLITION PLAN


PROJECT NO.


AS SHOWN

A4.06

DWG. TITLE

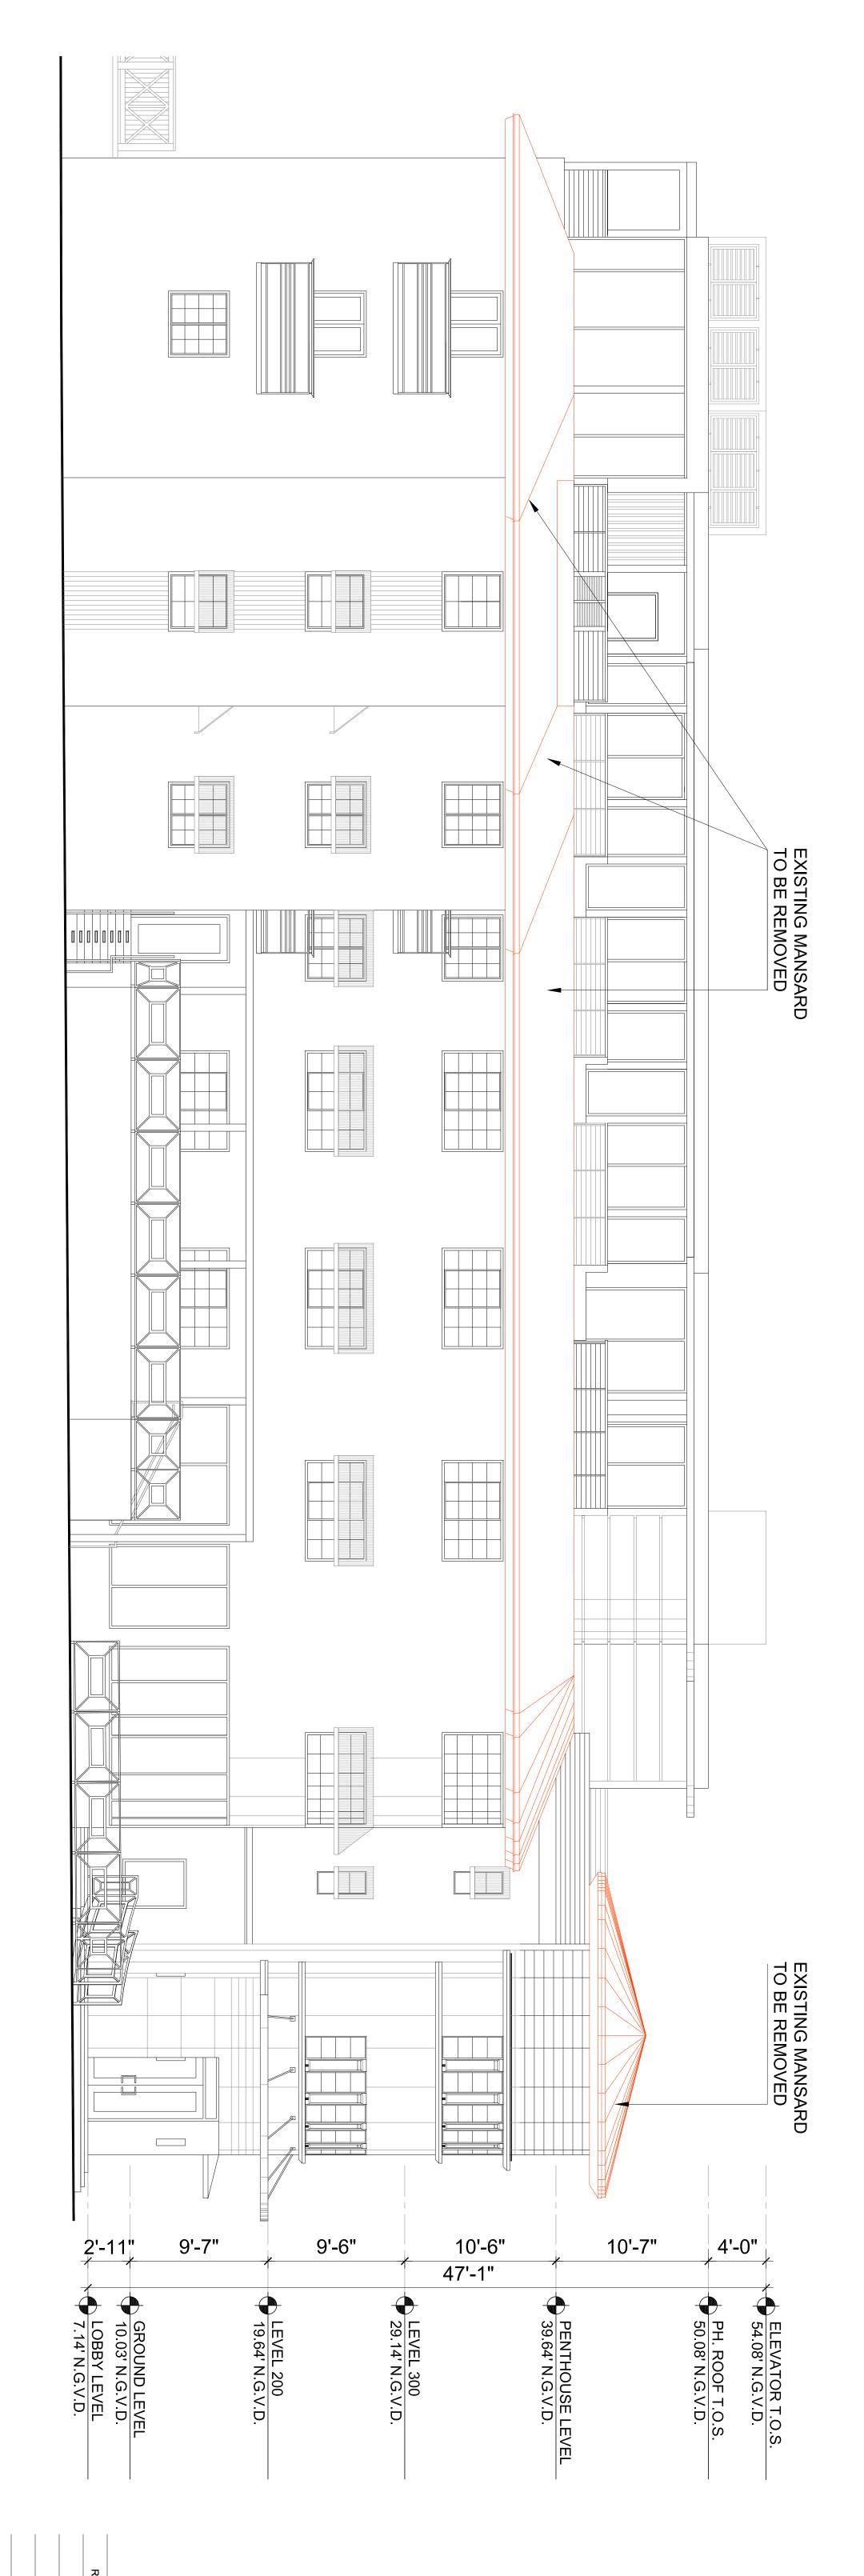

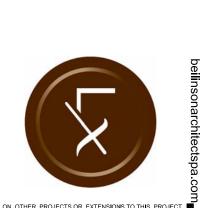


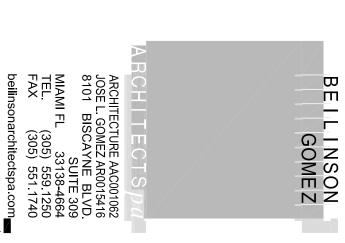


A4.06.1


DWG. TITLE


SOUTH ELEVATION. PROPOSED DEMOLITION (AFTER-THE-FACT)

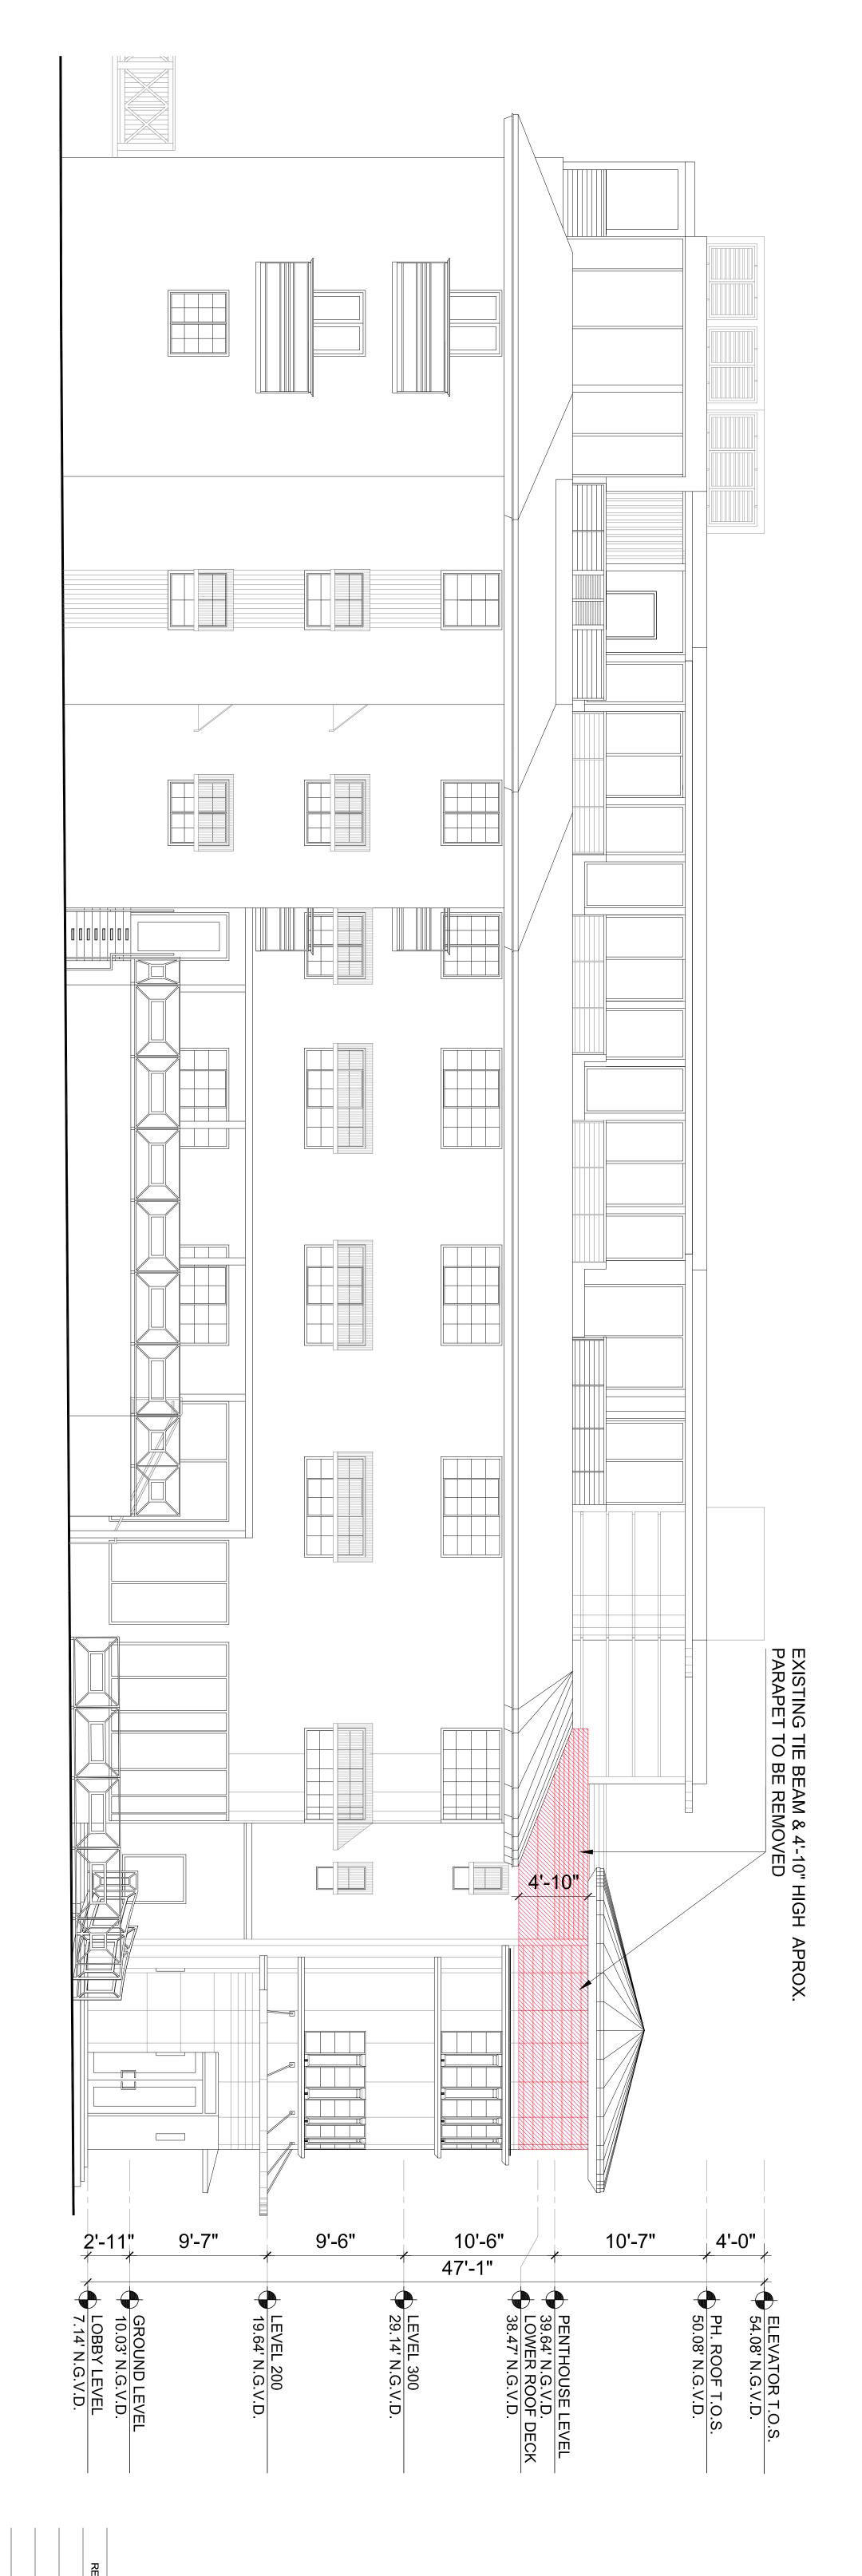



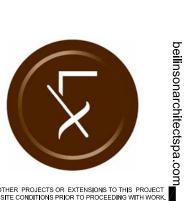

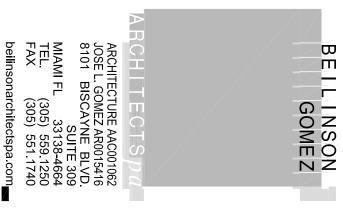

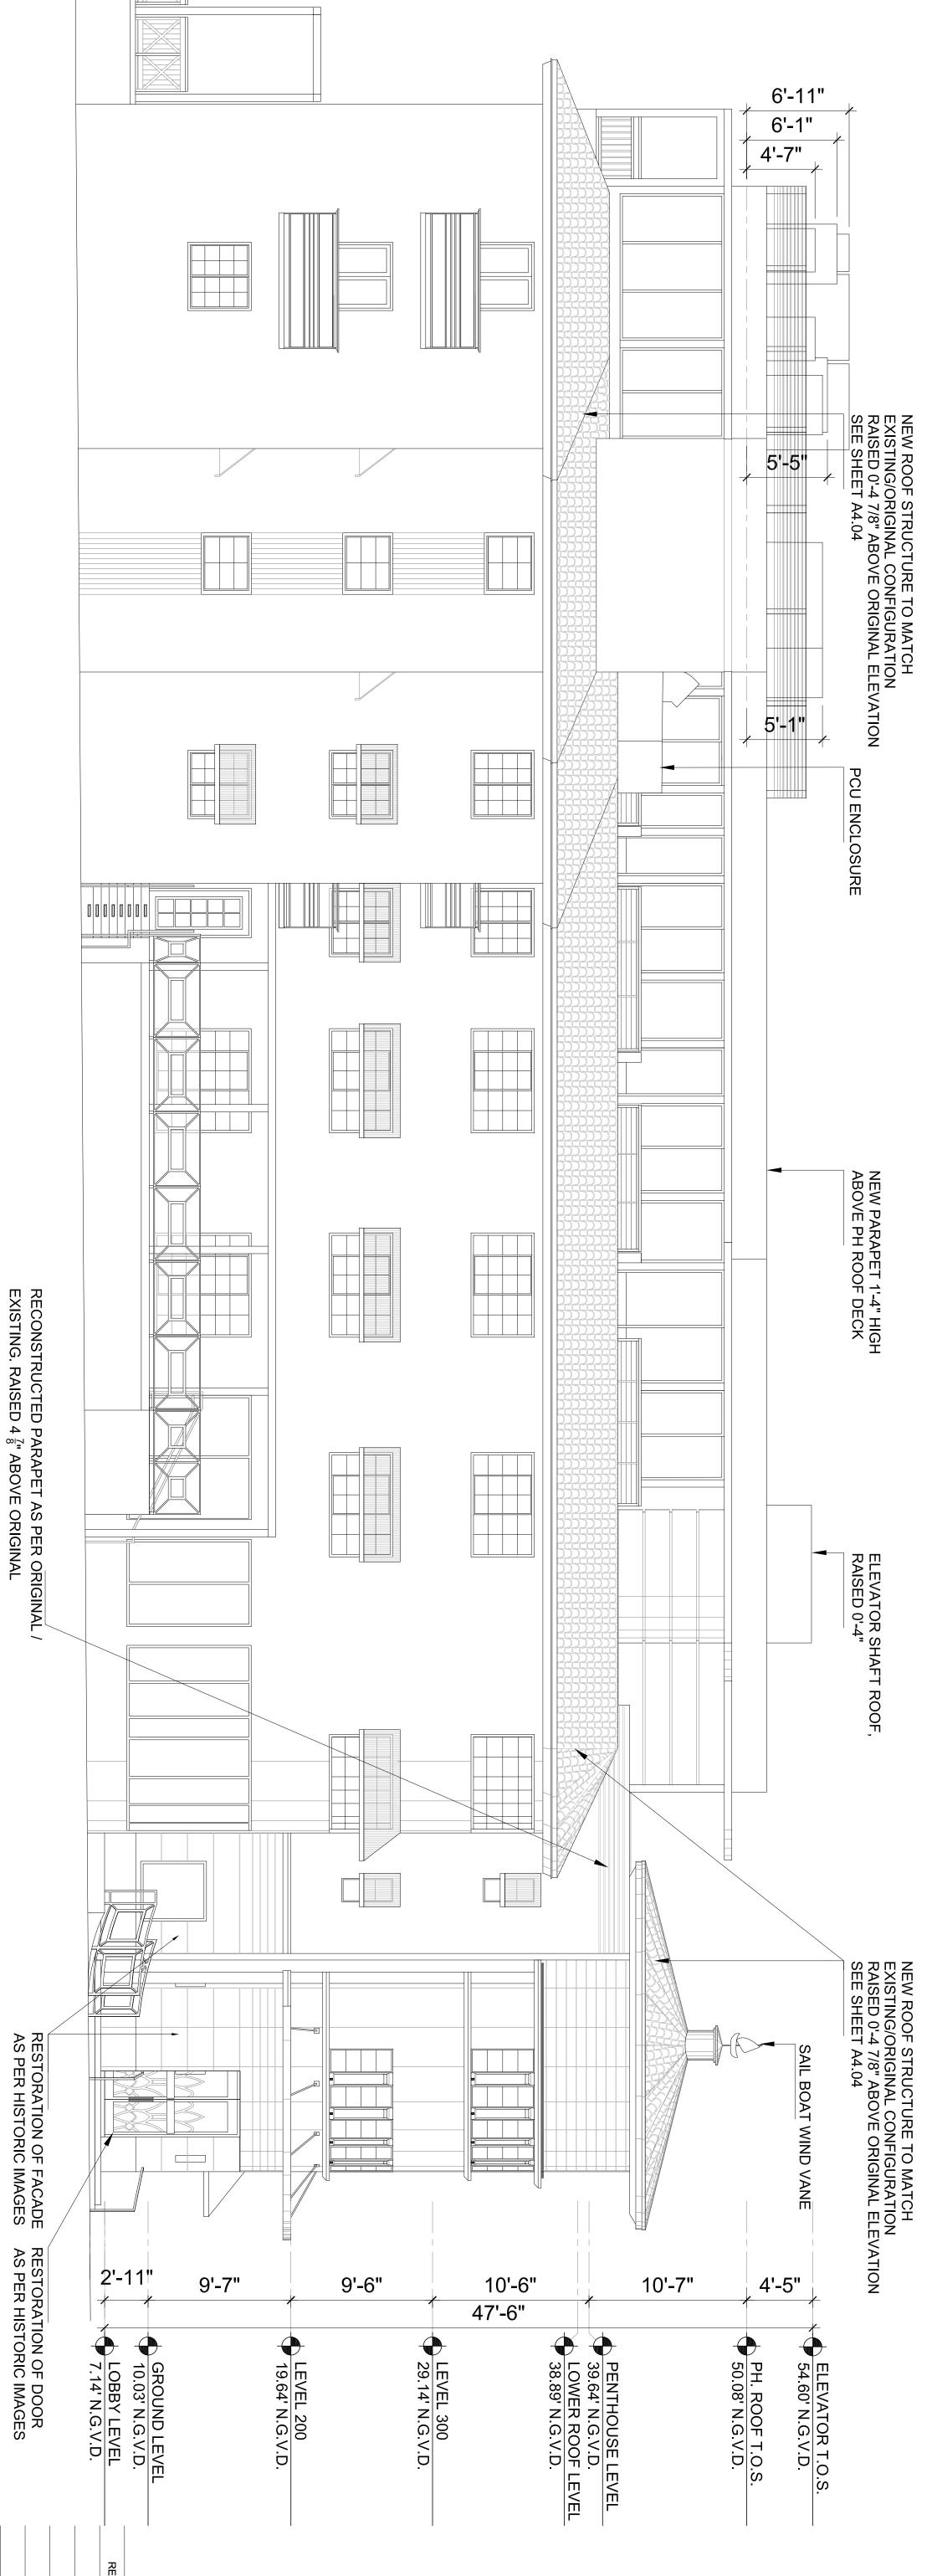






DWG. TITLE

PROPOSED SOUTH ELEVATION

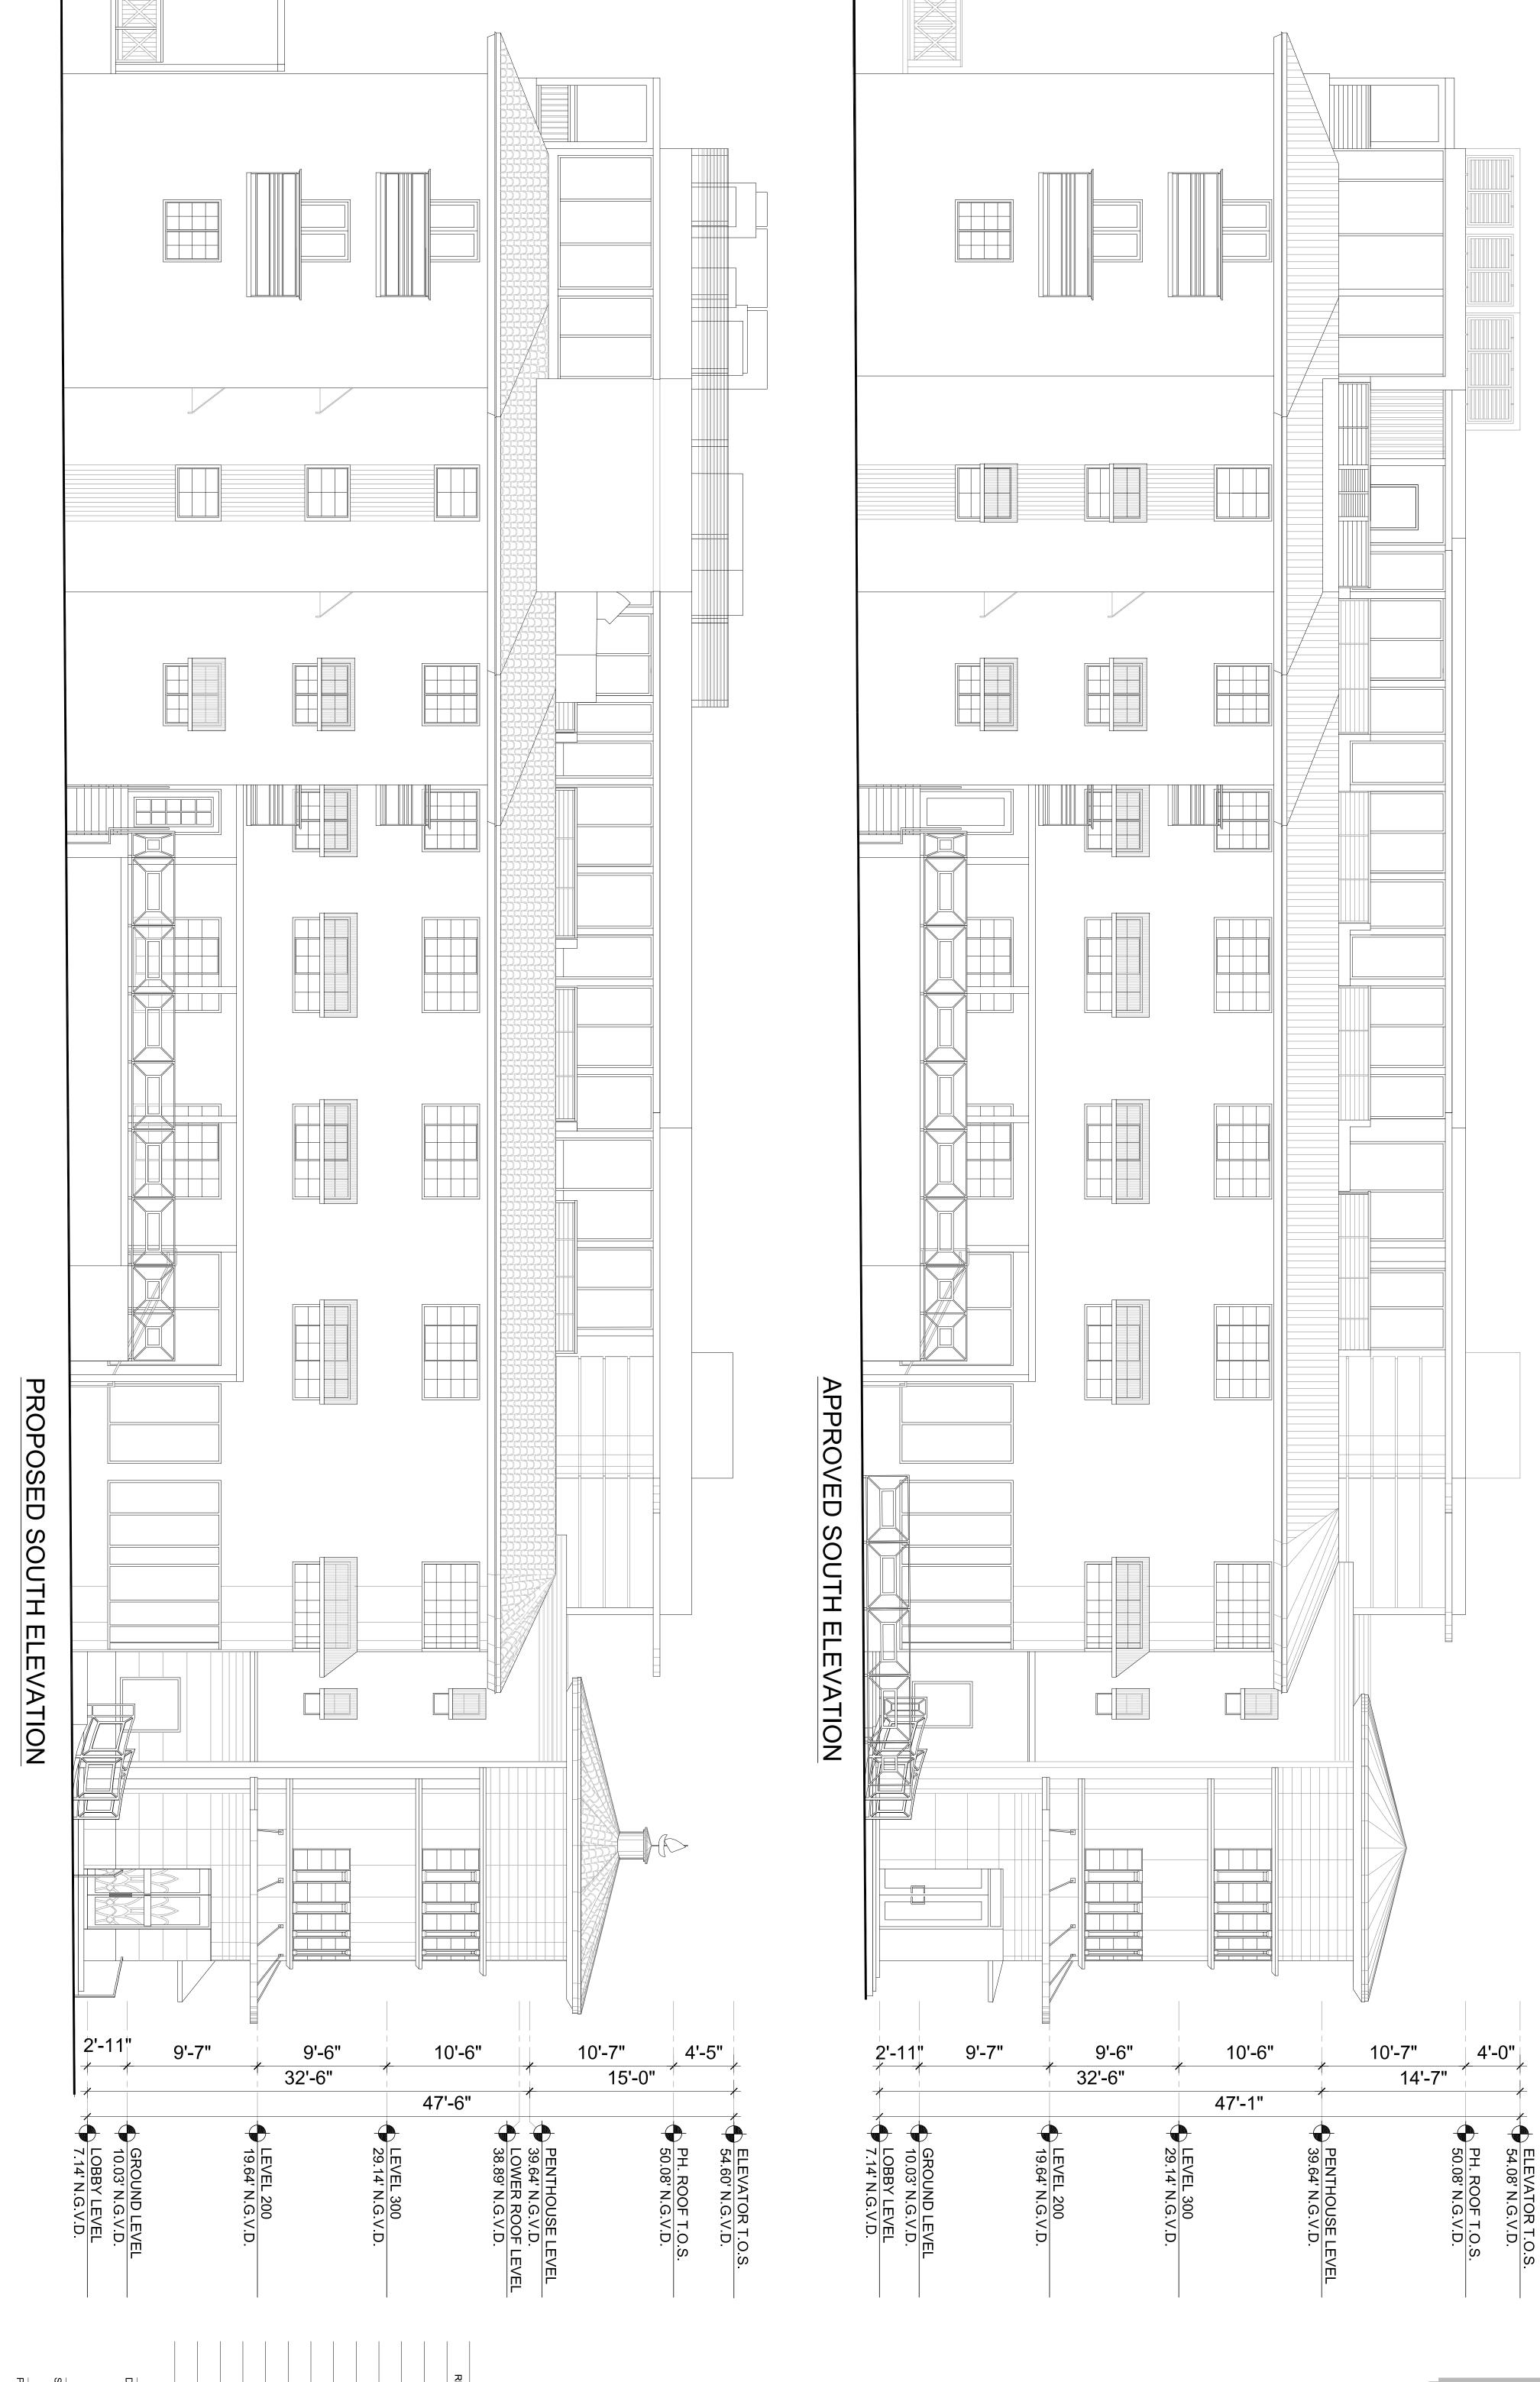

COMPARATIVE


SOUTH ELEVATION

SCALE: 3/16"=1'-0"

A4.08


SOUTH ELEVATION. COMPARATIVE



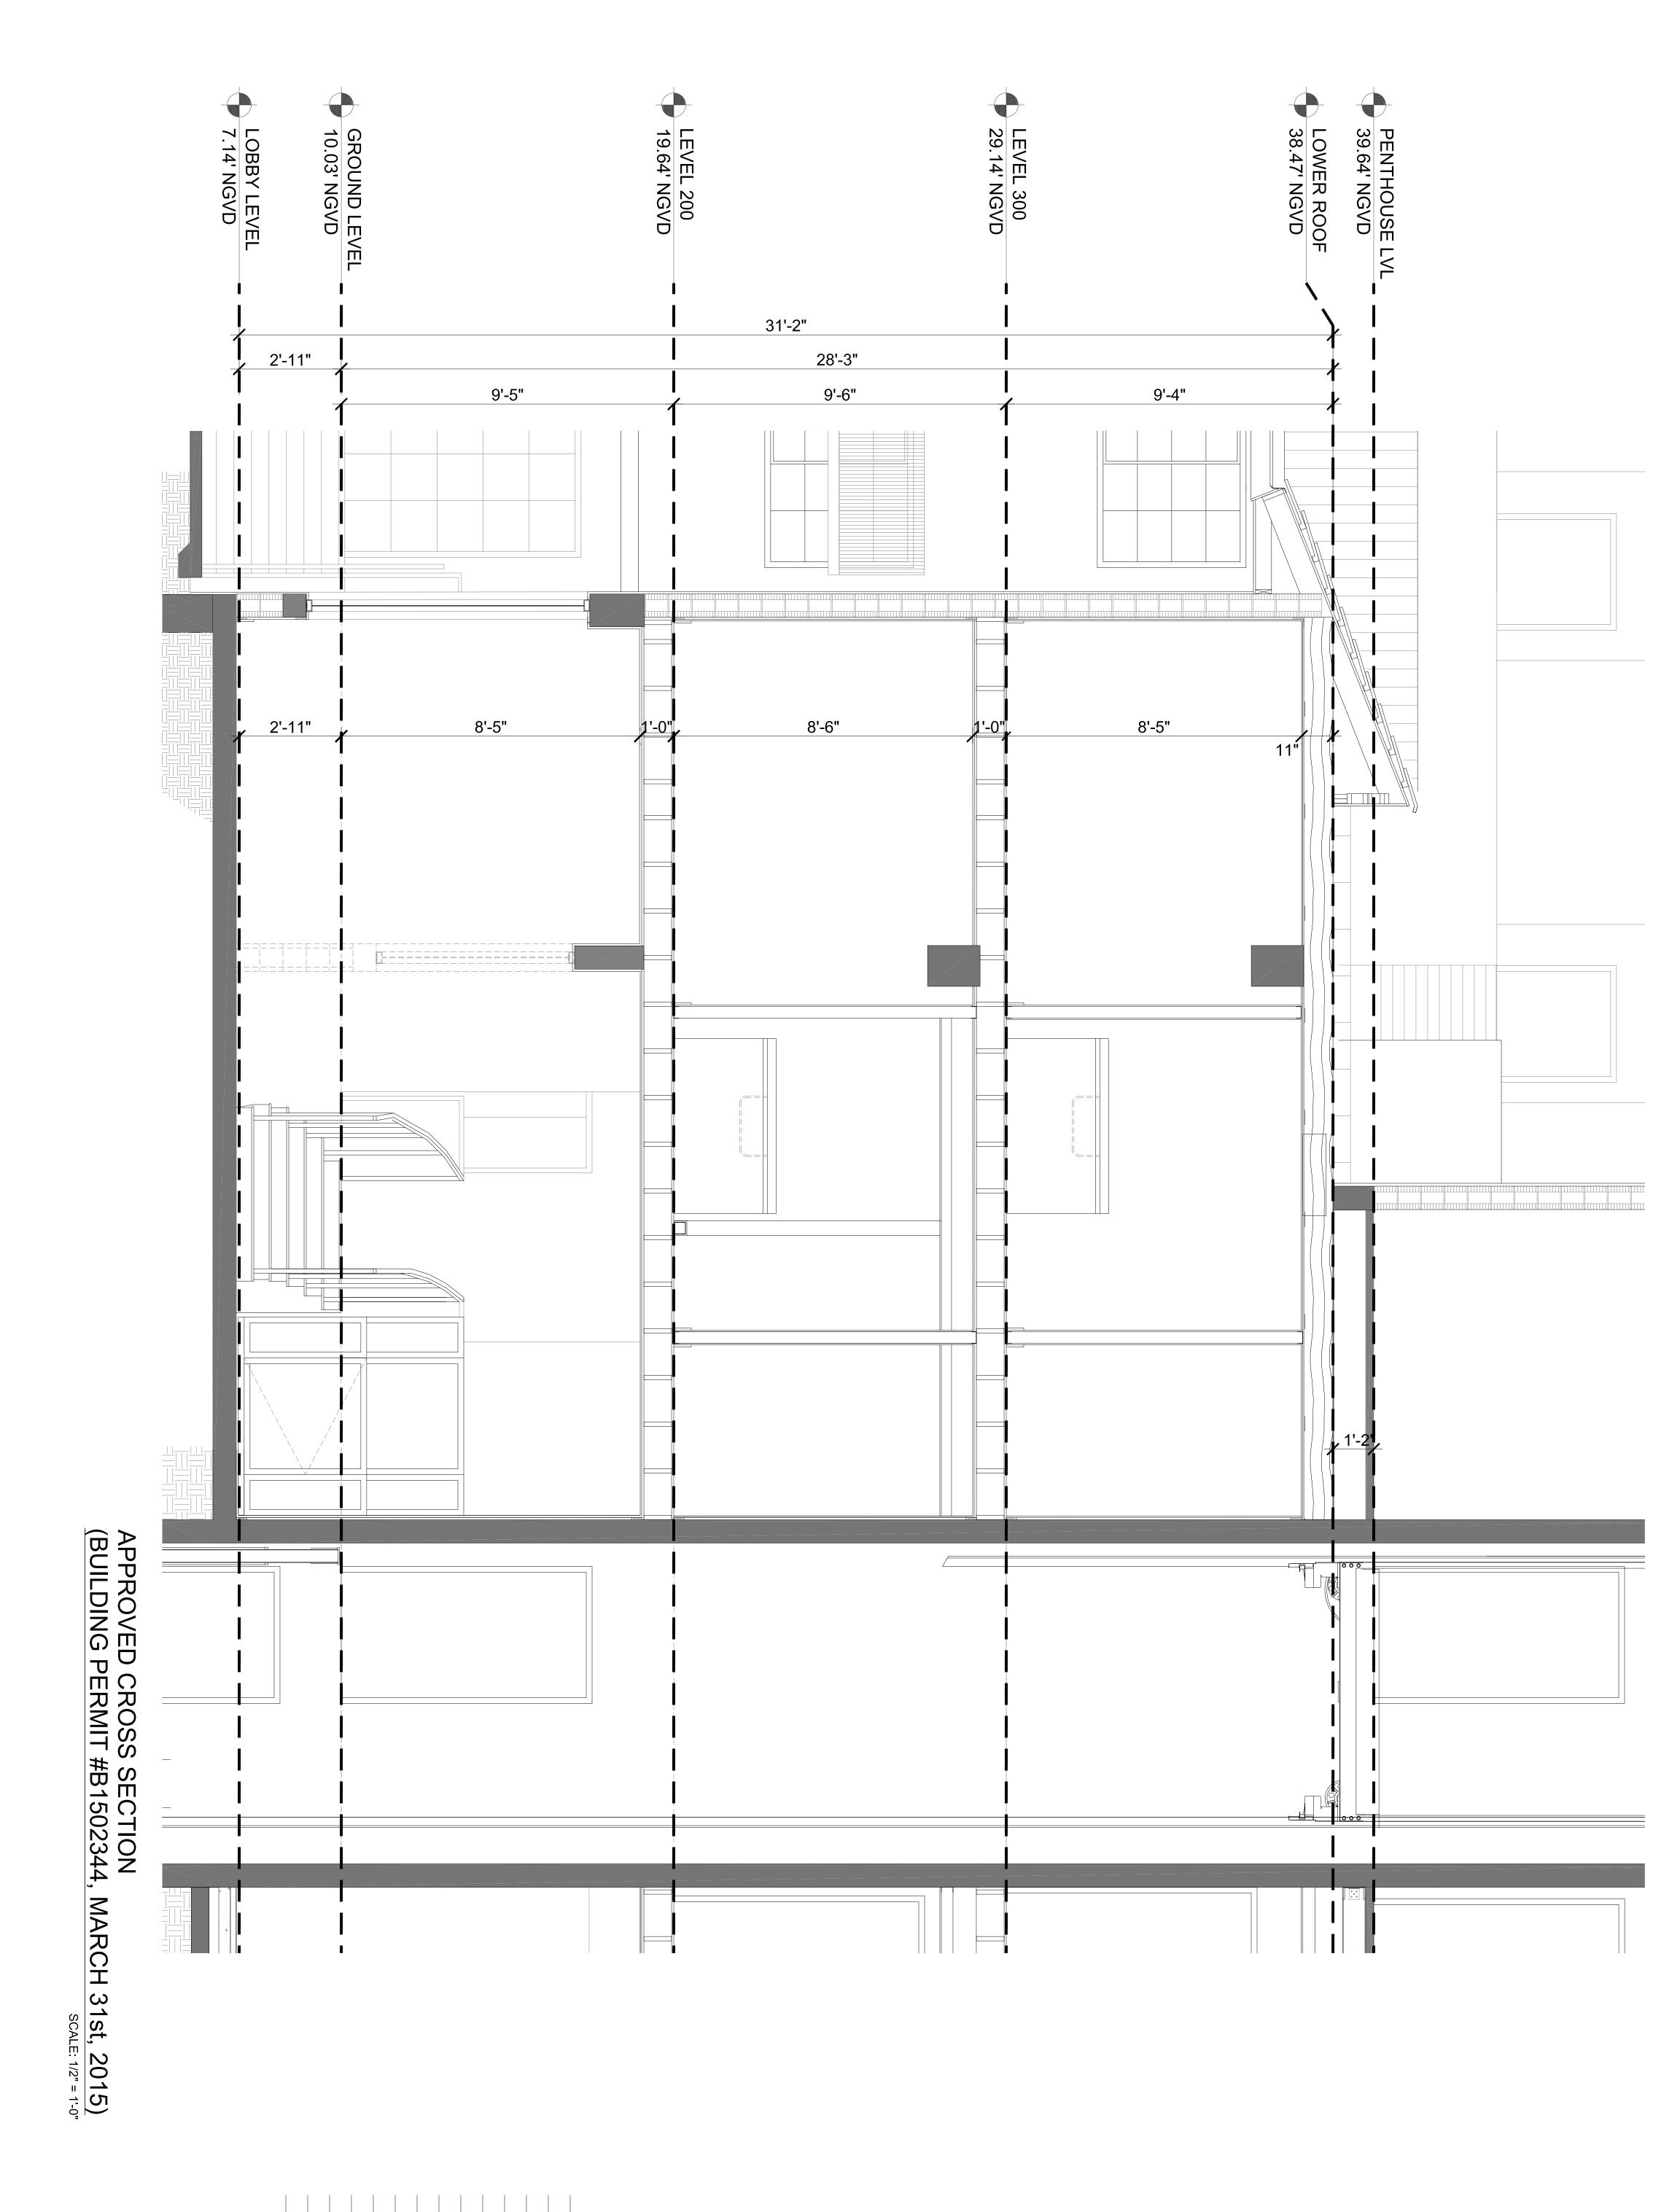

SHEET NUMBER A5.01

DWG. TITLE

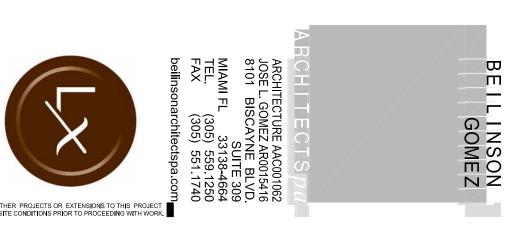



CROSS SECTION. PROPOSED (AFTER-THE-FACT) DEMOLITION


SCALE: 1/2" = 1'-0"


PROPOSED CROSS SECTION


SCALE: 1/2" = 1'-0"

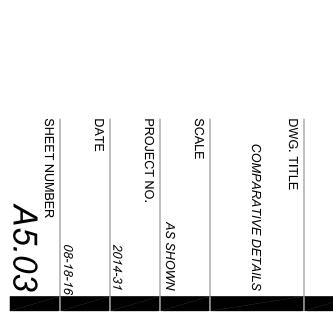

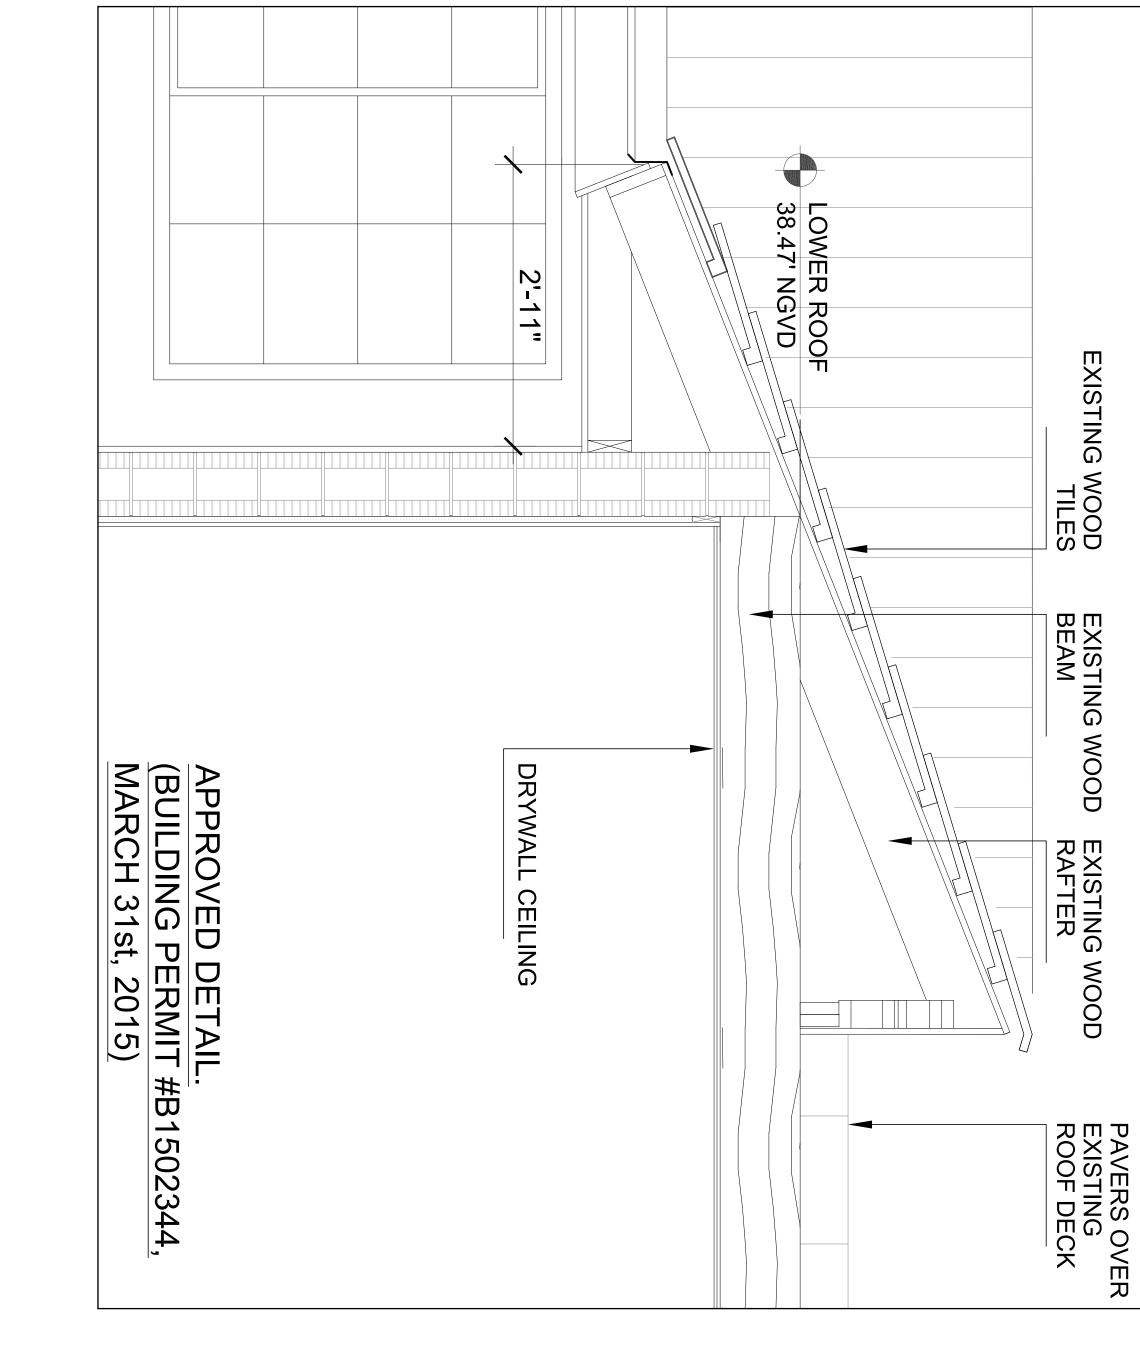


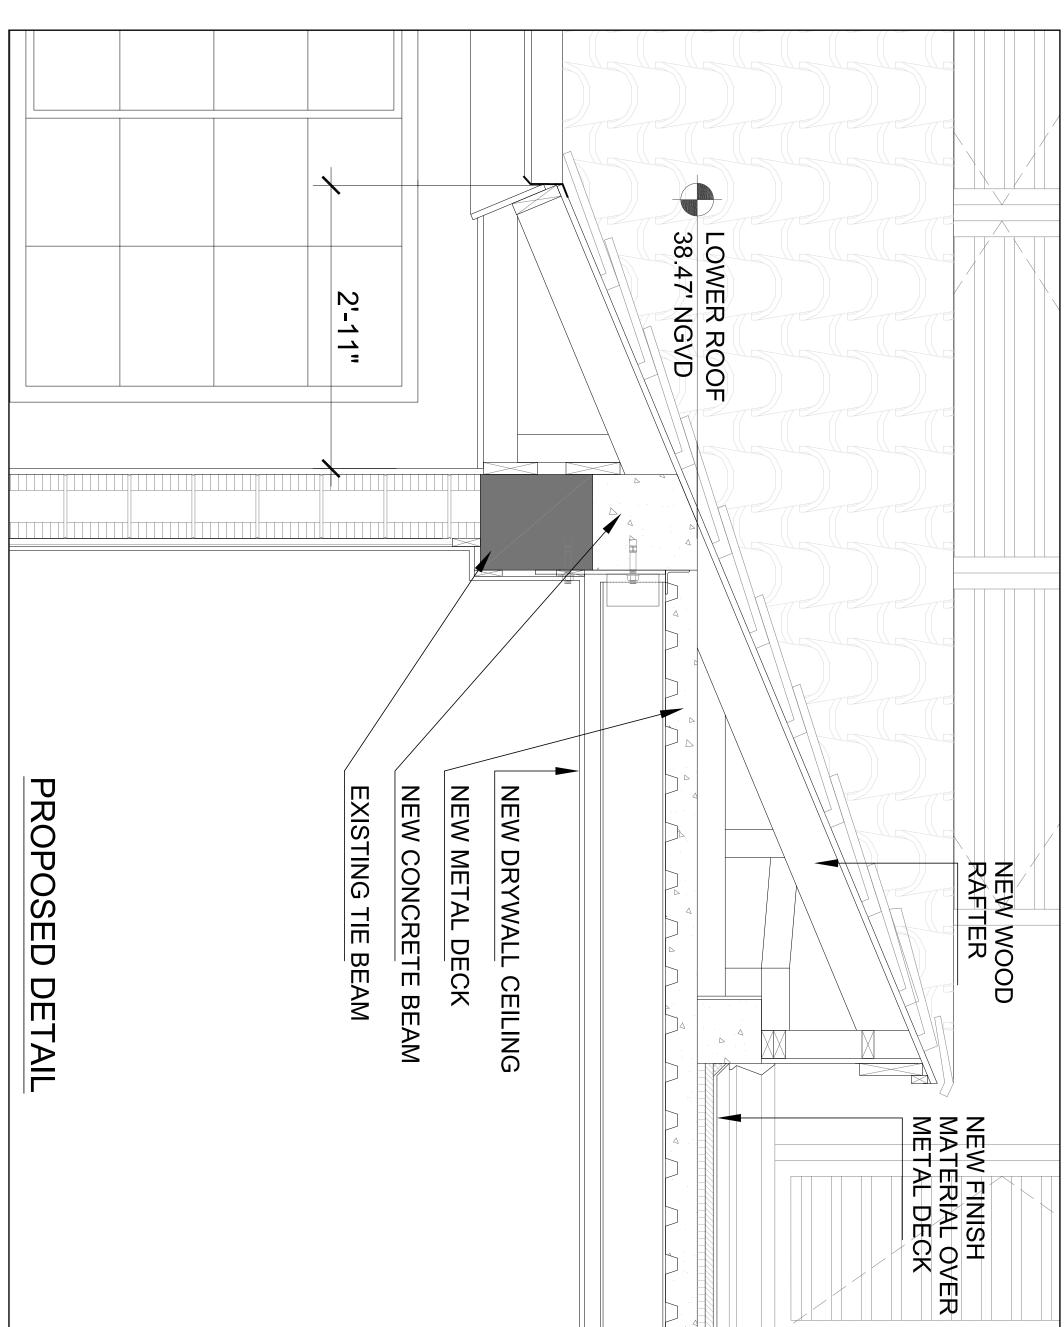

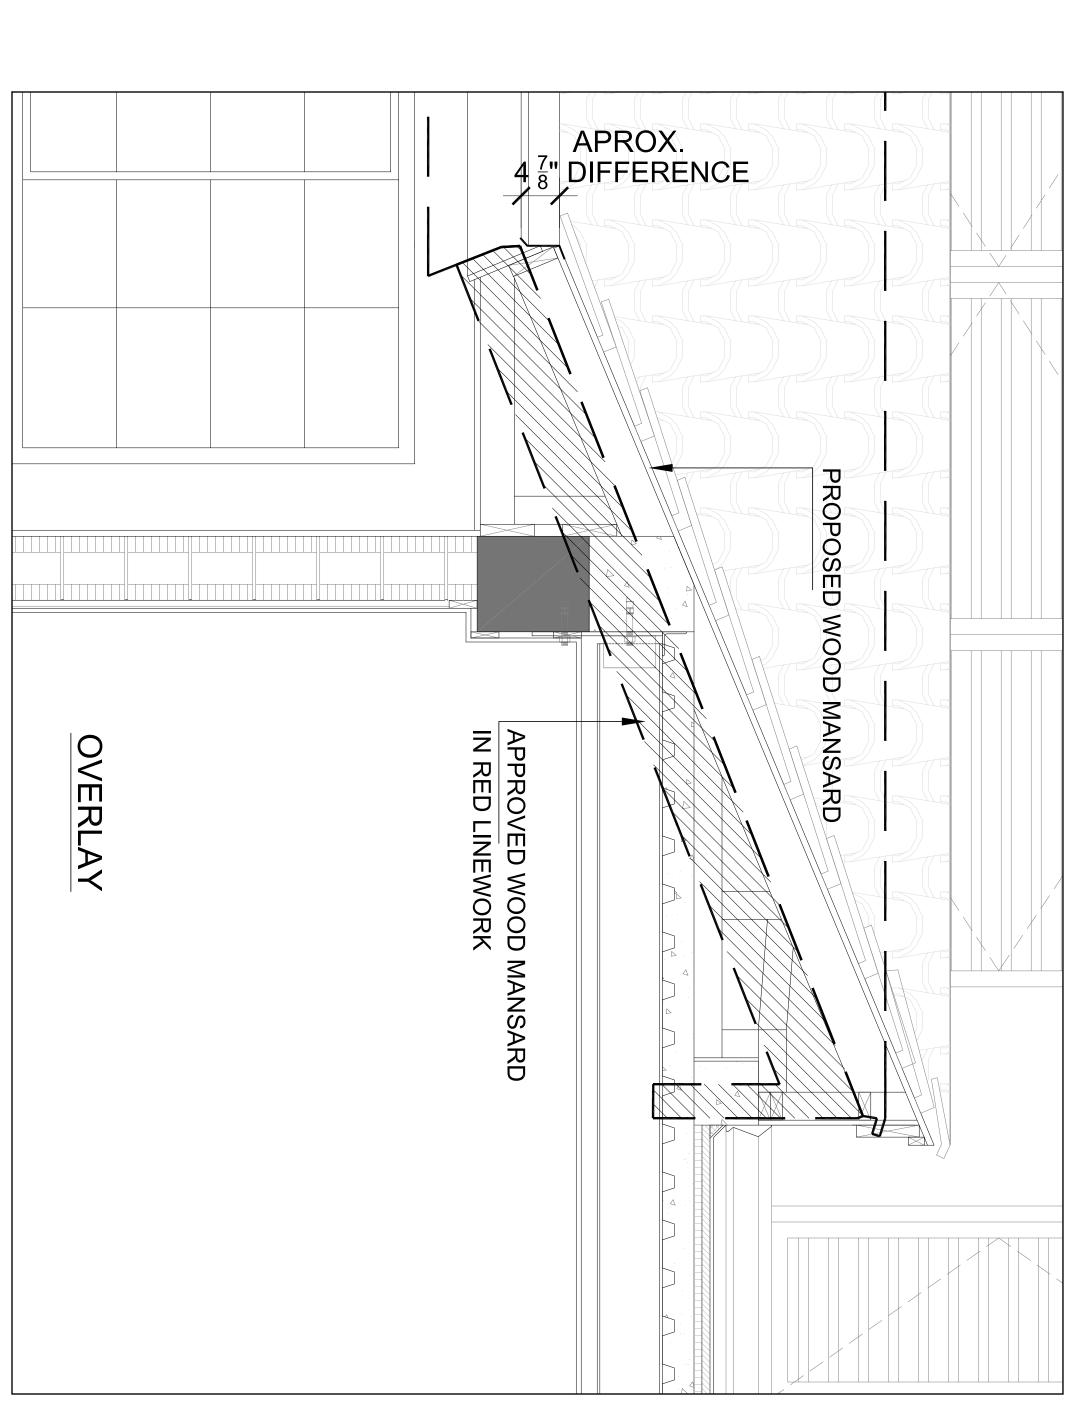


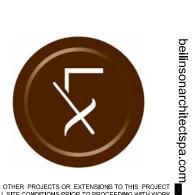





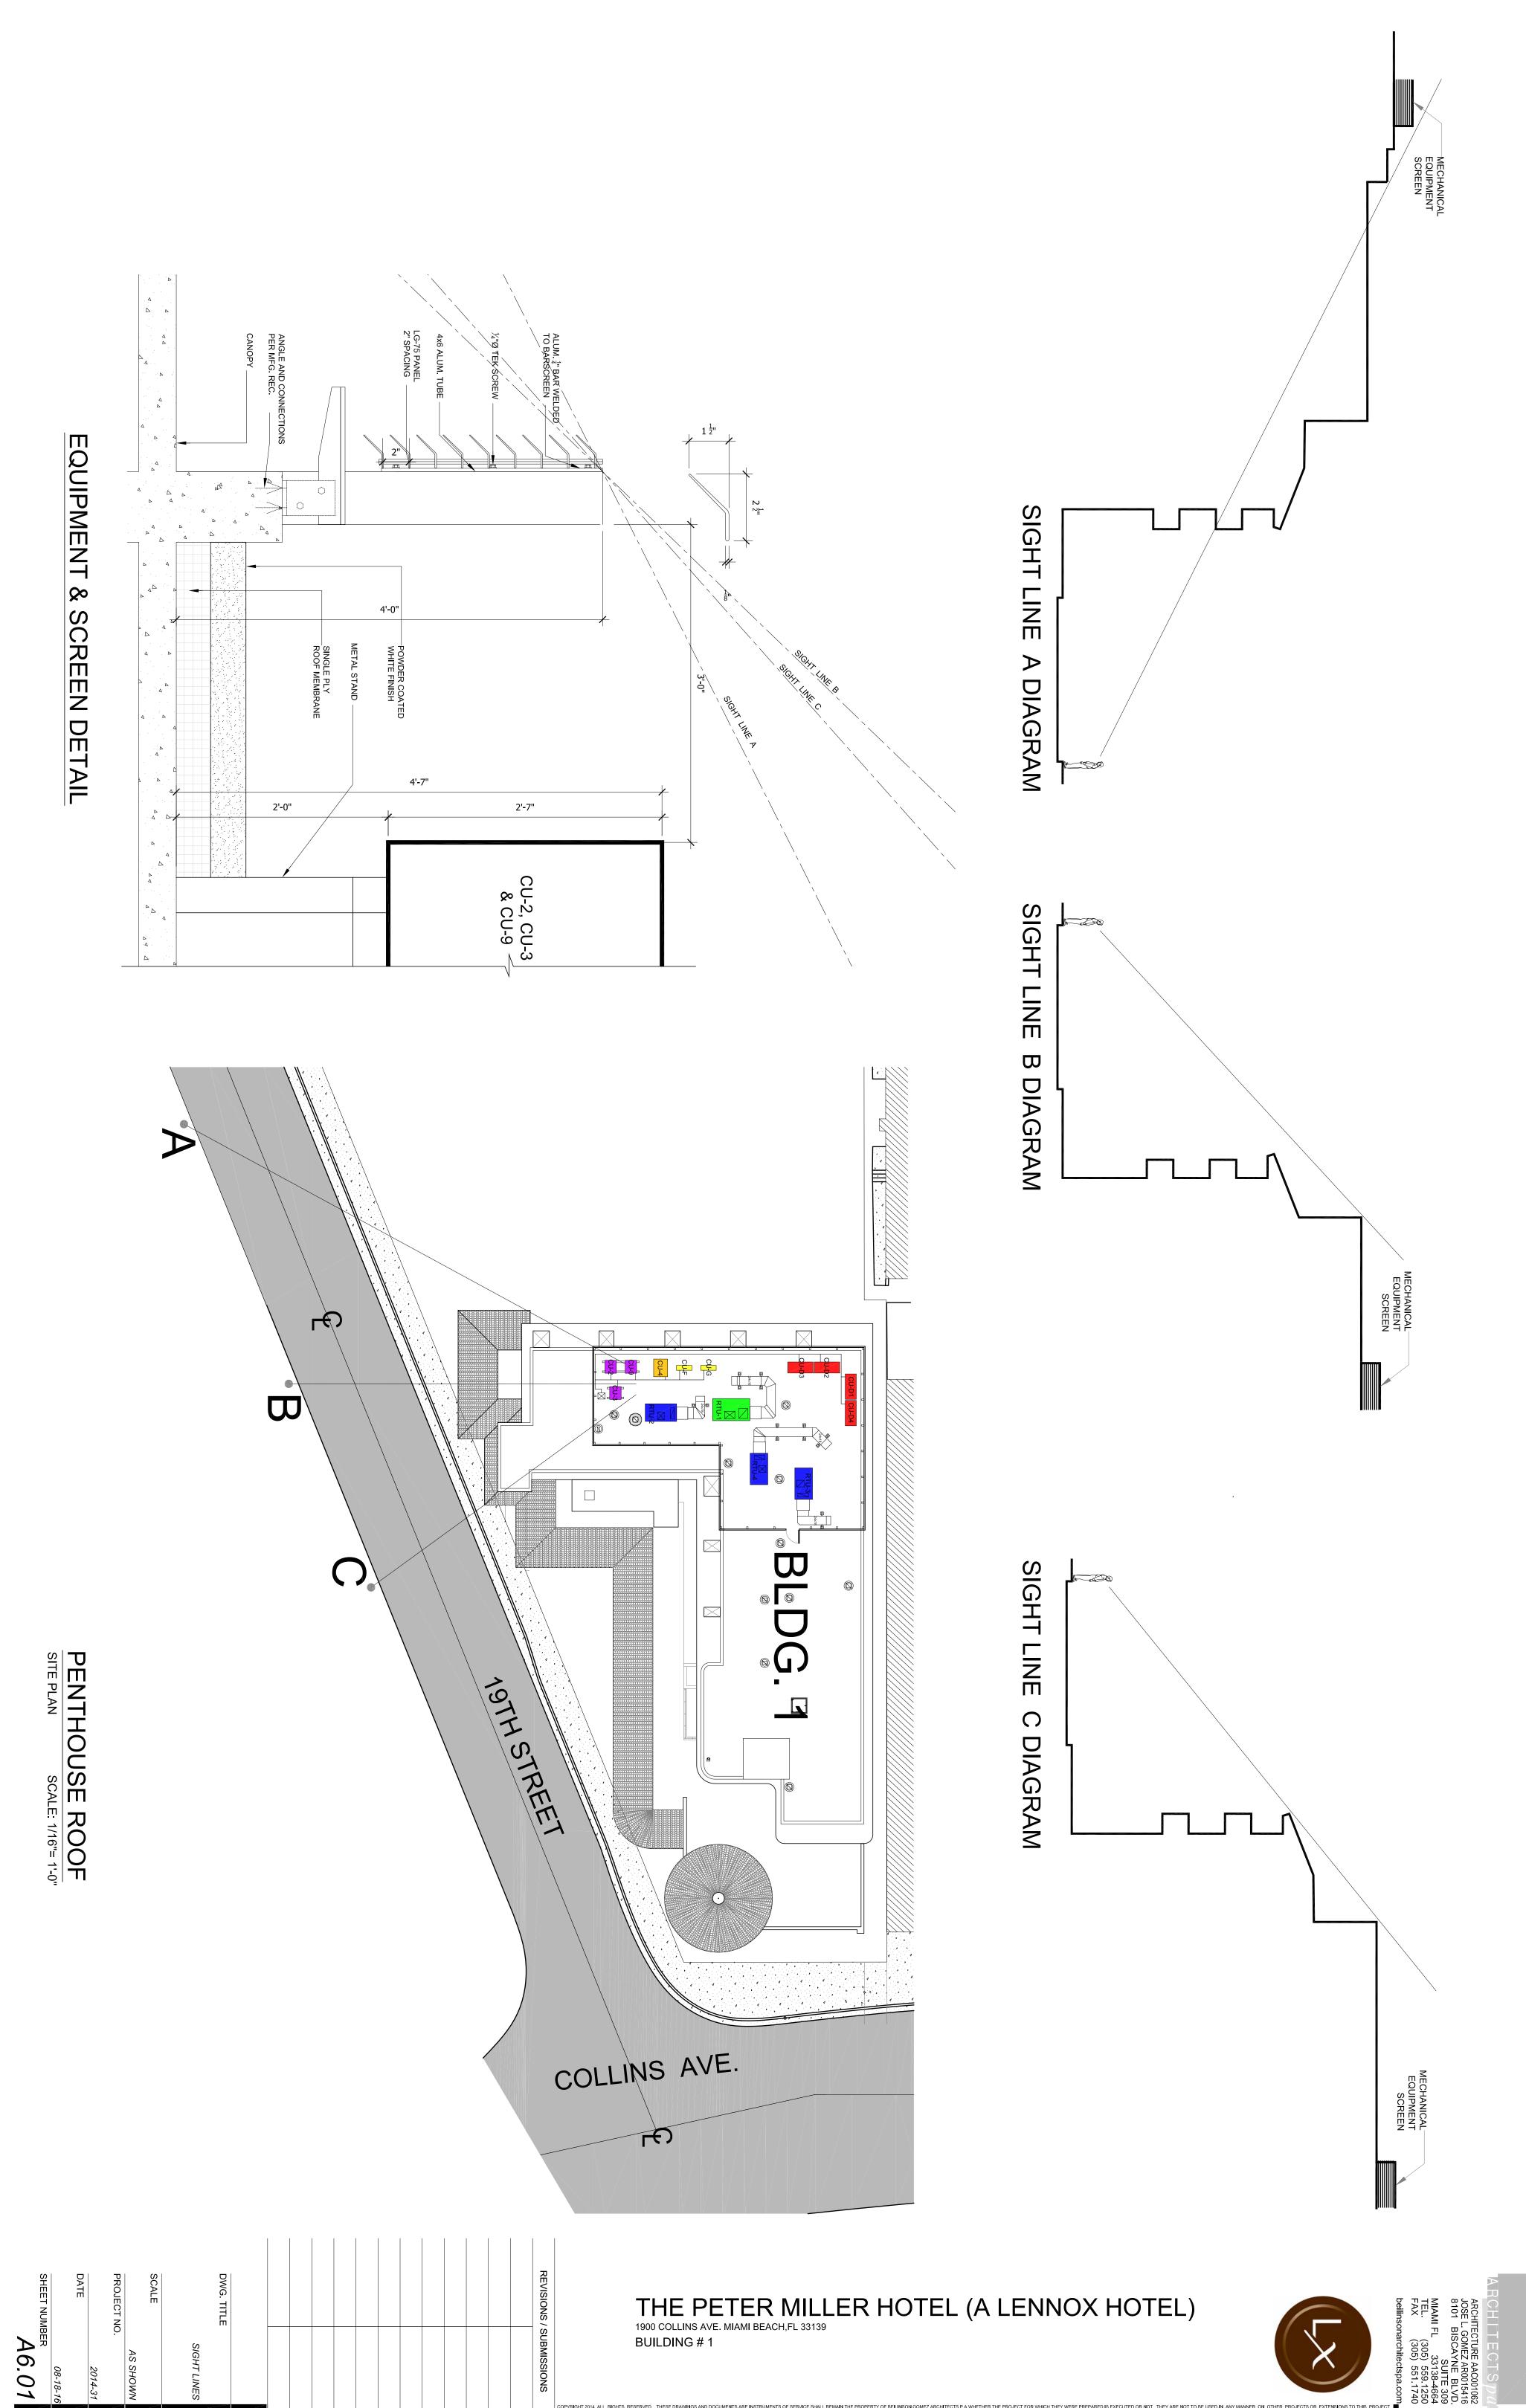



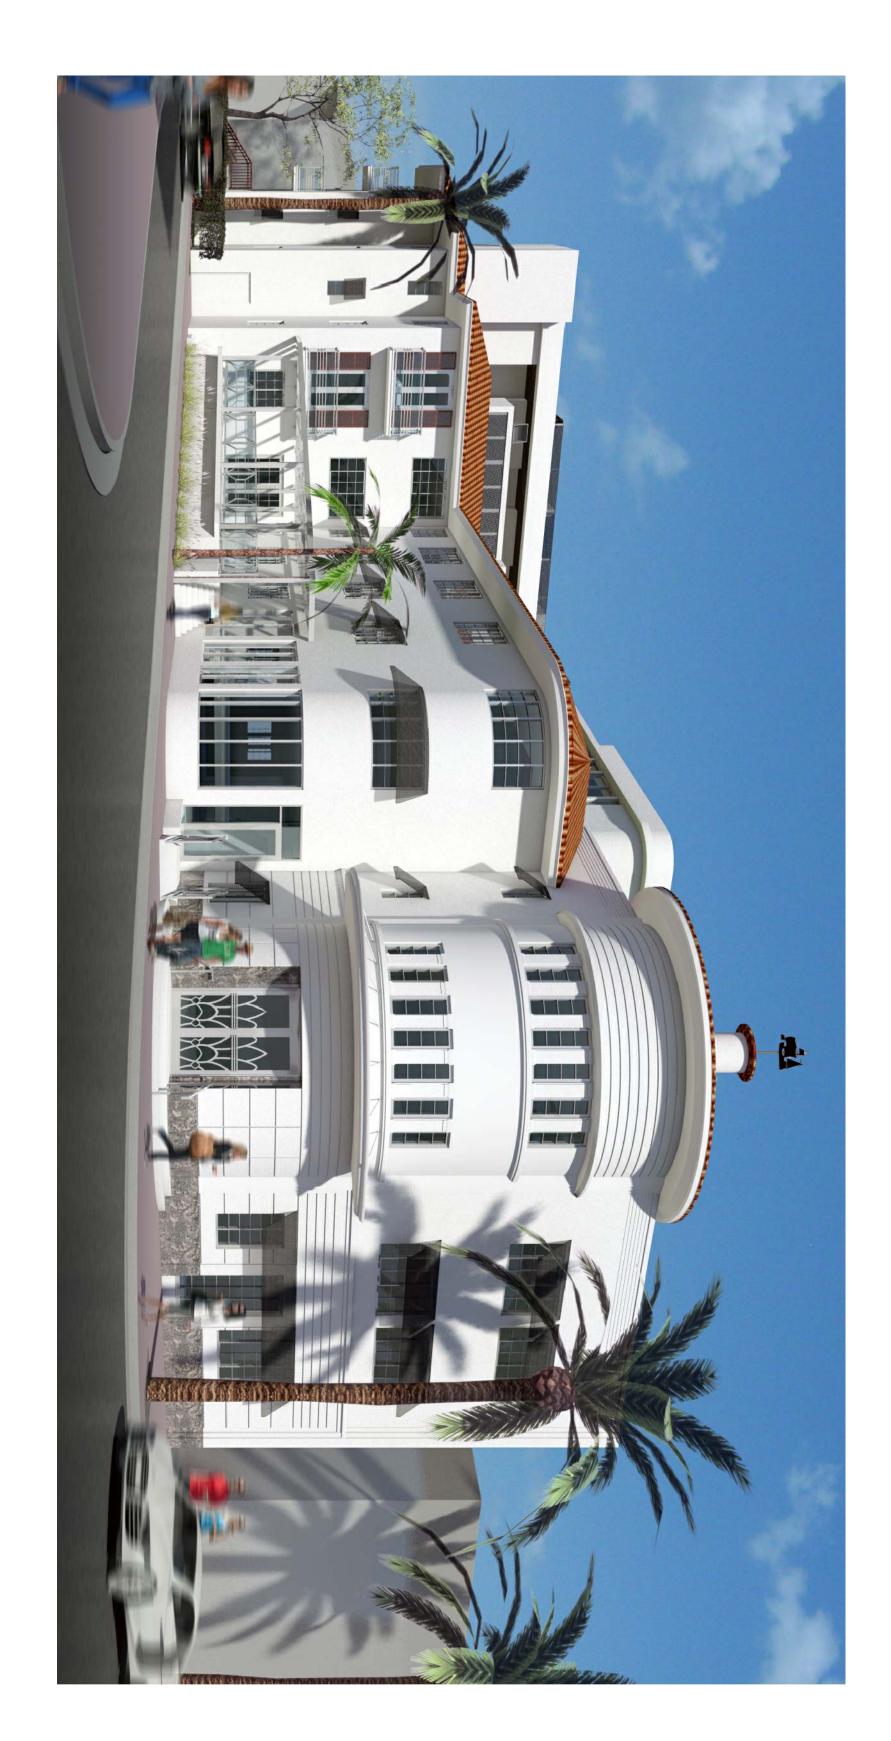

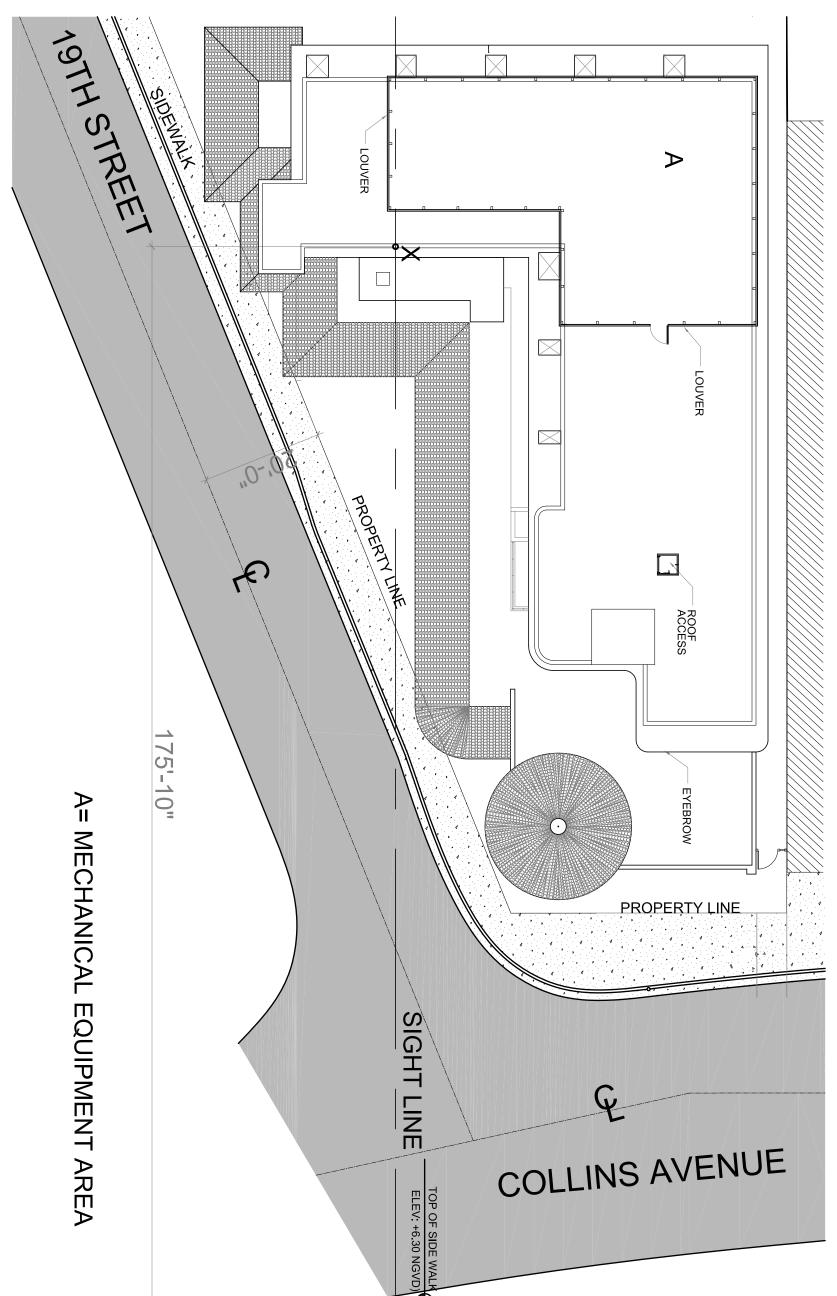

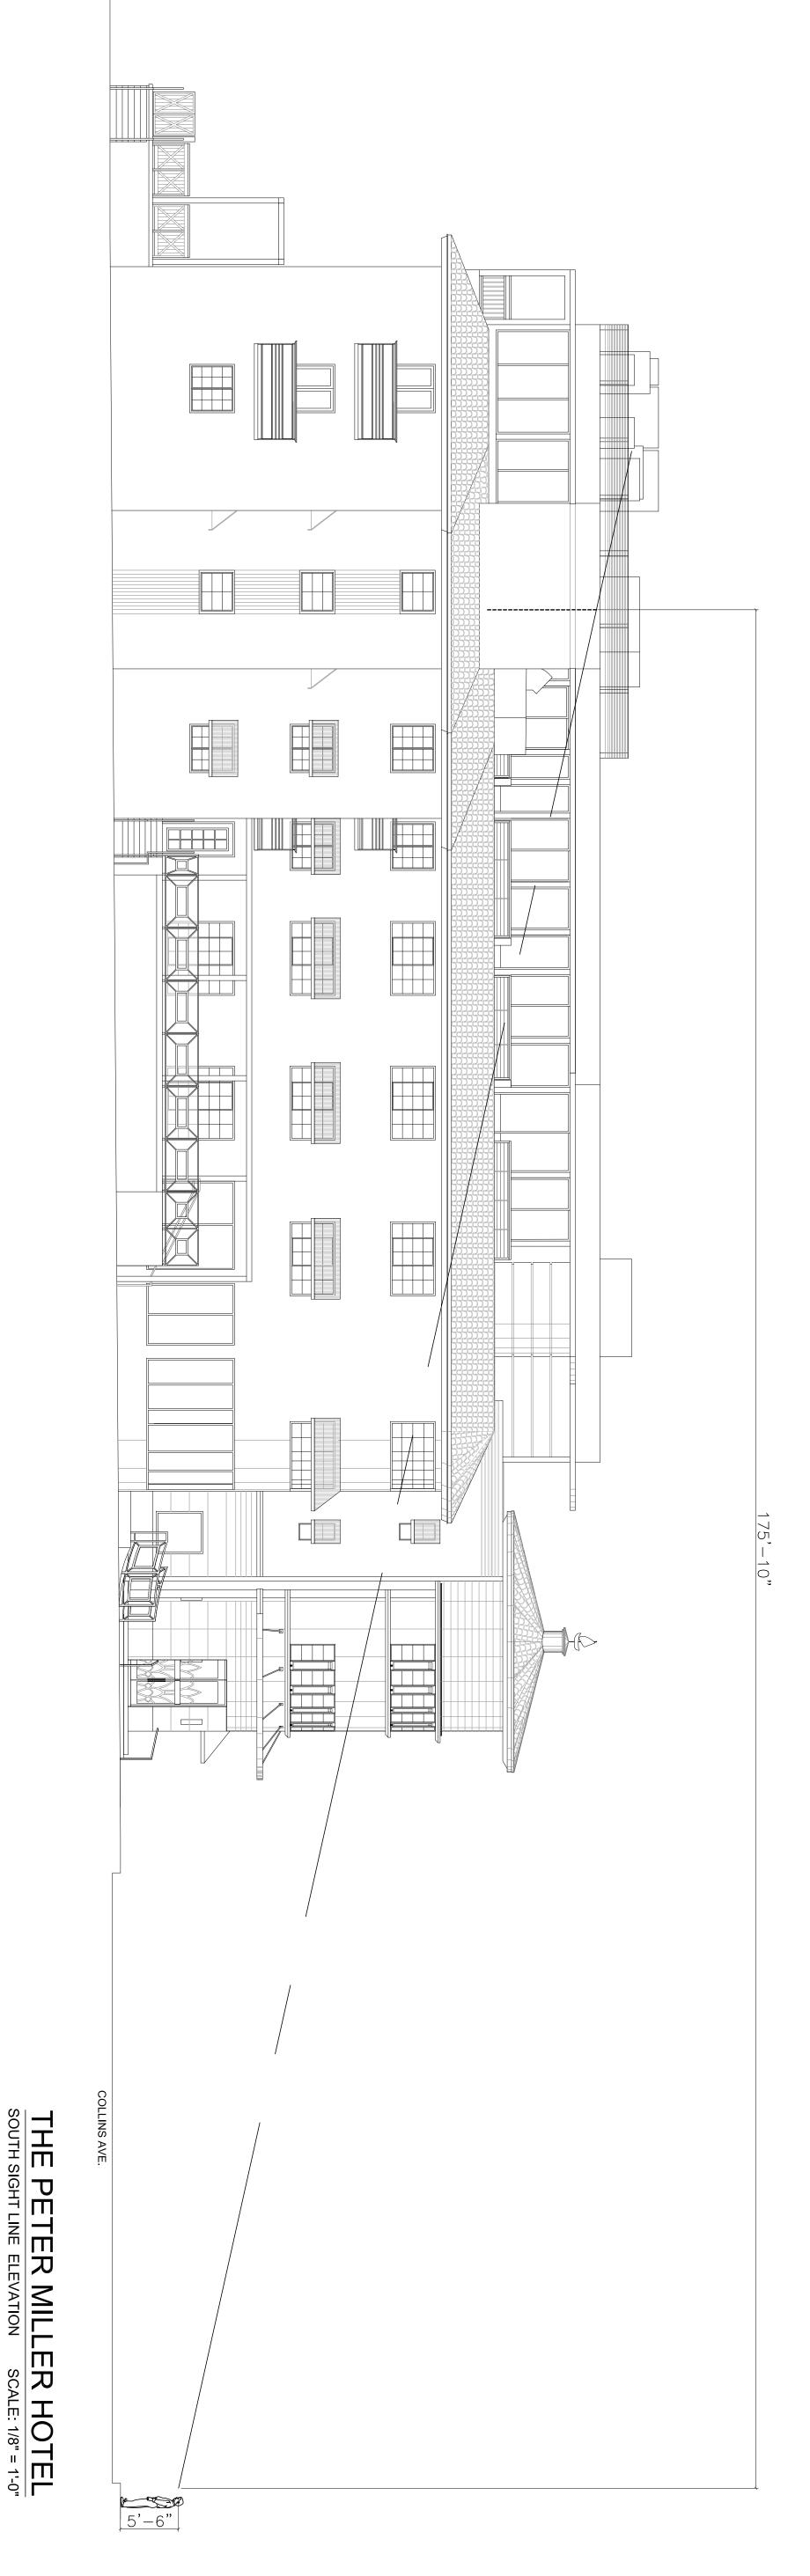





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beilinsonarchitectspa.com


SHEET NUMBER A6.03



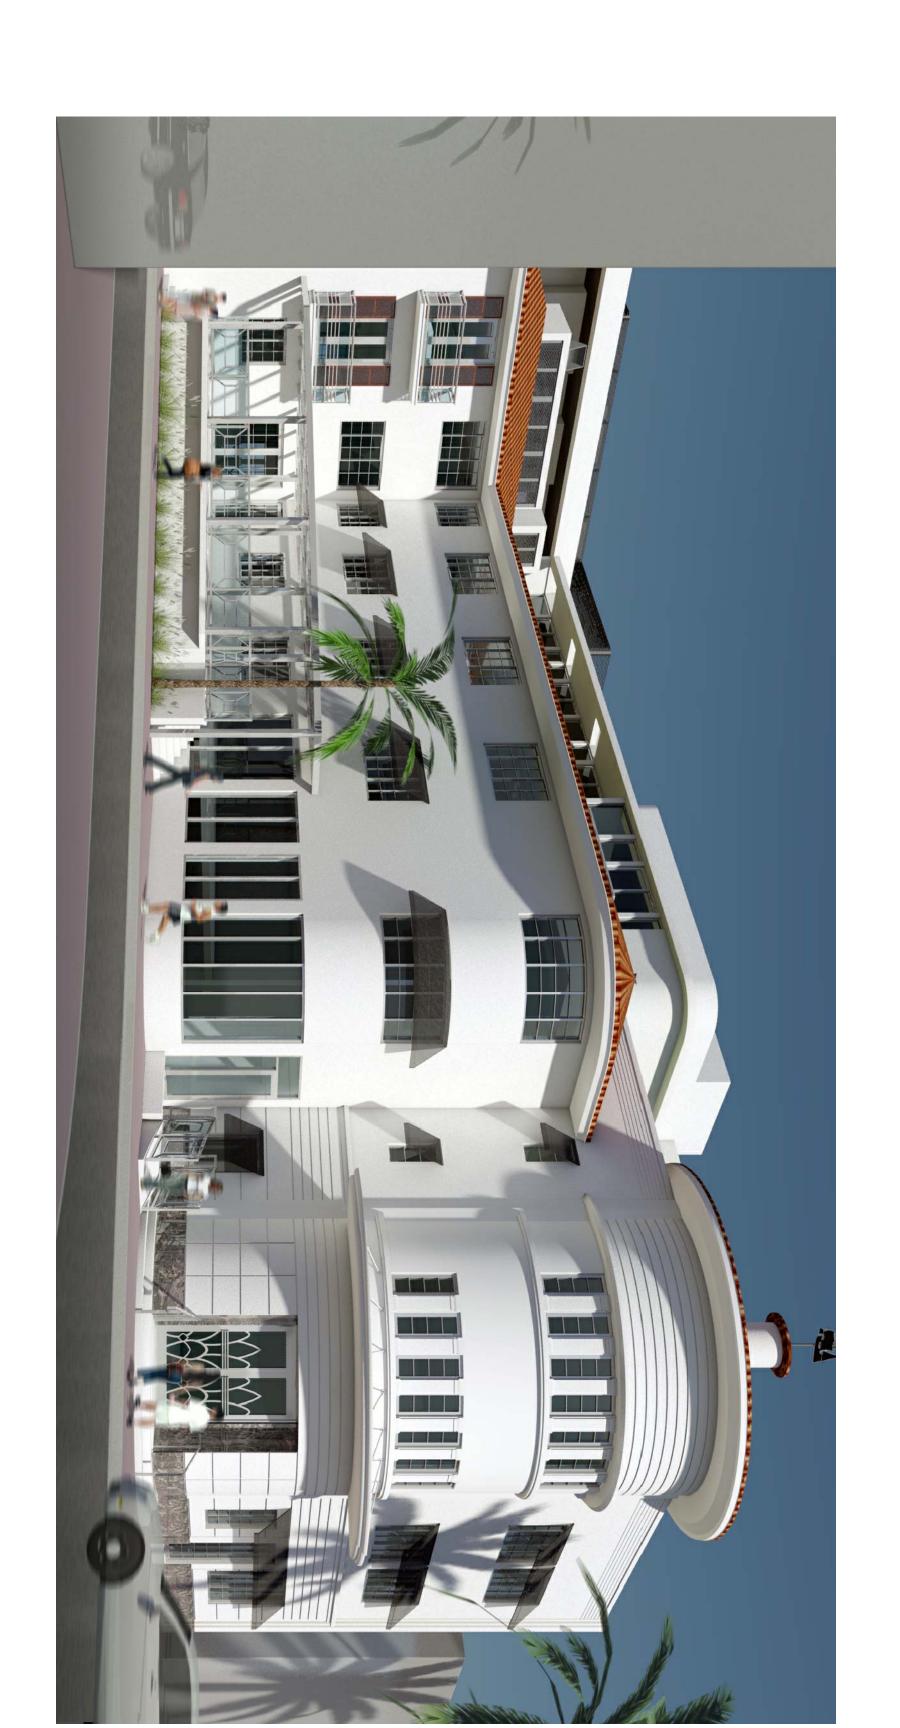

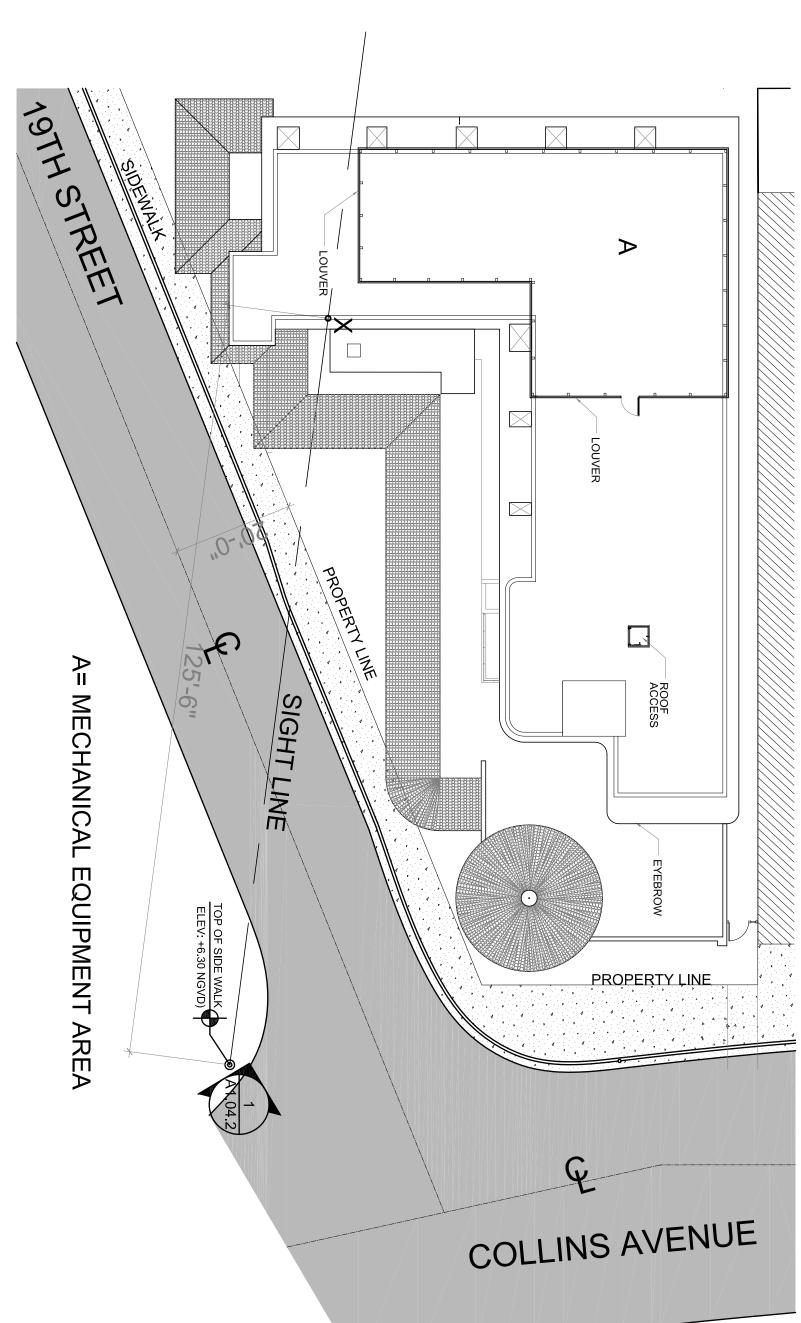


TOP OF EQUIPMENT ALUM. SCREEN

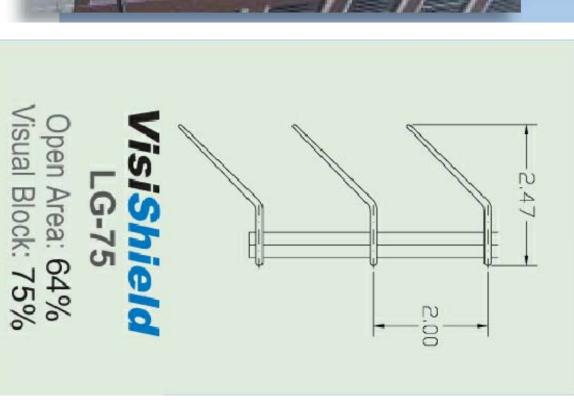

EAST ELEVATION PETER MILLER HOTEL


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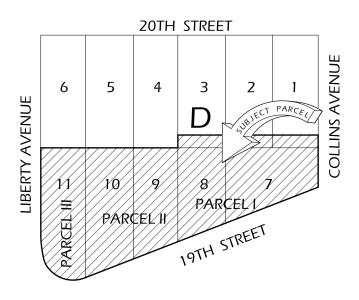


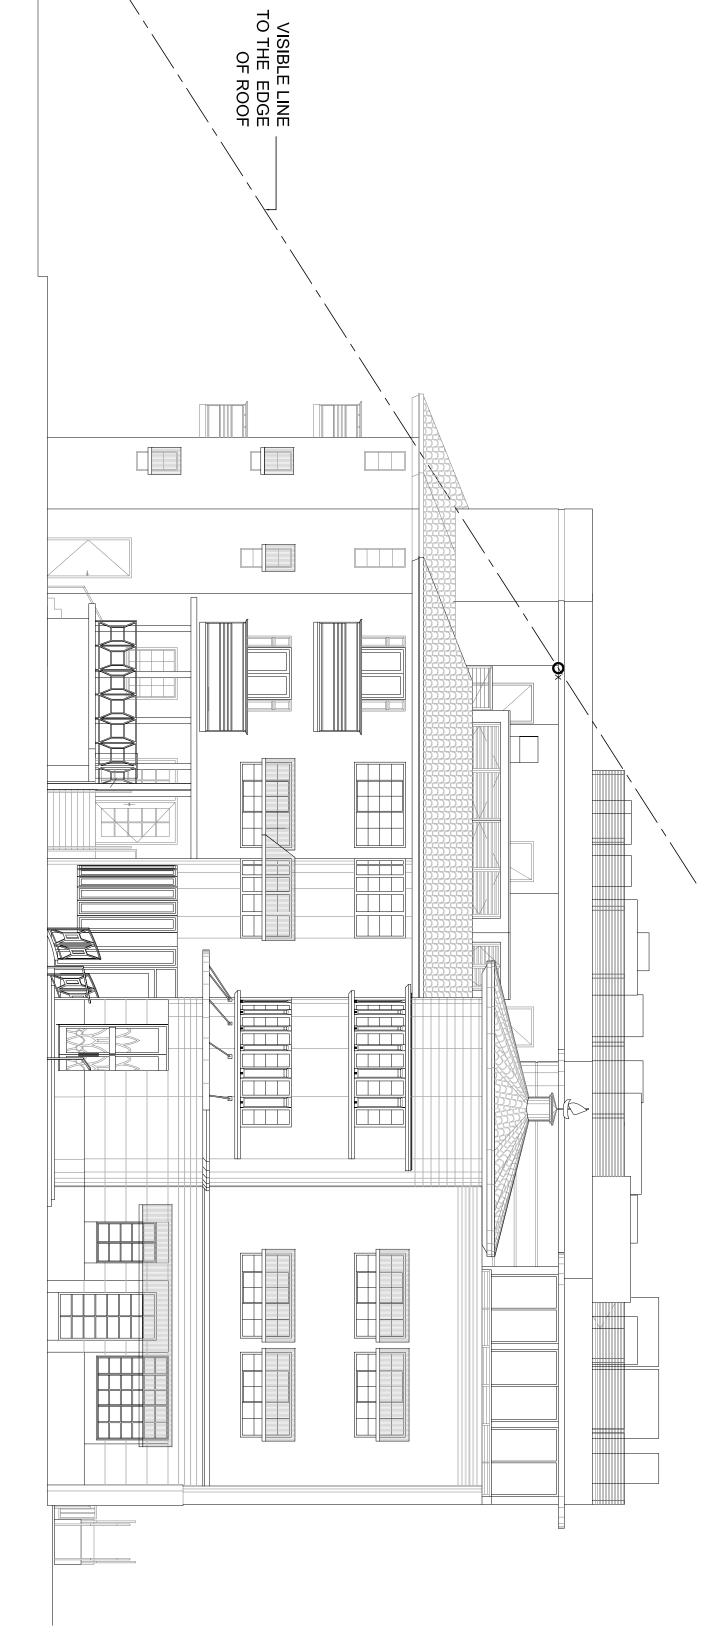

BOUNDARY SURVEY





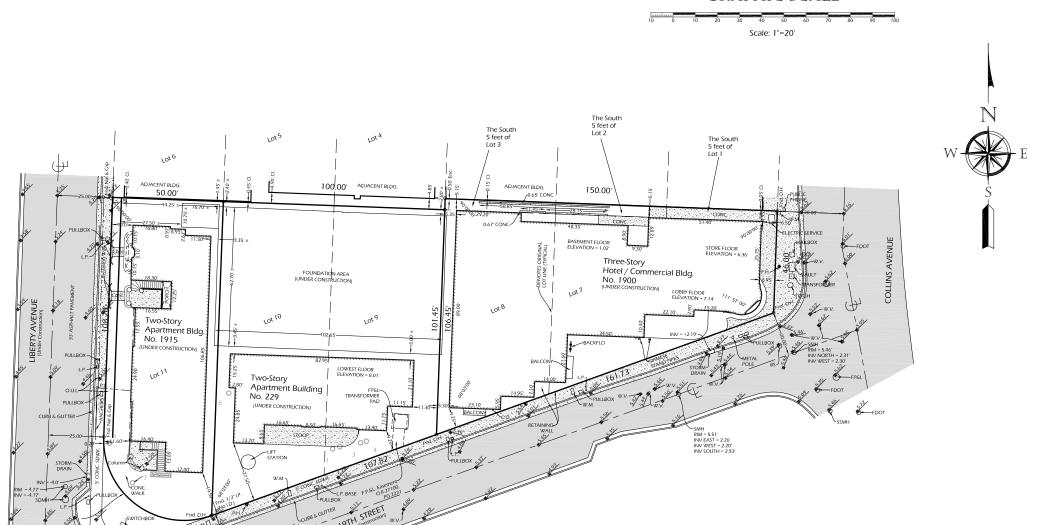

NTS

LOCATION SKETCH

LEGAL DESCRIPTION: PARCEL I

PARCEL1

Lots 7 & 8 and the South 5 feet of Lots 1, 2 & 3, Block D, OCEAN FRONT PRPOERTY OF THE MIAMI BEACH
IMPROVEMENT COMPANY, according to the Plat thereof, as recorded in Plat Book 5, Page 7, of the Public
Records of MIAMI-DADE County, Florida.
AND
PARCEL II

Lots 9 & 10, Block D, OCEAN FRONT PRPOERTY OF THE MIAMI BEACH IMPROVEMENT COMPANY,
according to the Plat thereof, as recorded in Plat Book 5, Page 7, of the Public Records of MIAMI-DADE
County, Florida.
AND
PARCEL III


Lots 11, Block D, OCEAN FRONT PRPOERTY OF THE MIAMI BEACH IMPROVEMENT COMPANY, according to the Plat thereof, as recorded in Plat Book 5, Page 7, of the Public Records of MIAMI-DADE County, Florida

PREPARED FOR: Diego Arguello or assigns, 1900 Collins Avenue, Miami Beach, FL 33139

- Surveyor's Note:

 • Denotes Spot Elevation at NGVD 1929
- to City of Miami Beach Benchmark No. 20-02; Elevation =5.45 Bay Datum (4.67 NGVD 1929).

Surveyor's Notes: All clearances and/or encroachments shown in Underground utilities shown are based on field. Bearings, if shown, are based on assumed me	d ground markings provid	nature. Fence ownership by visual means. Legal owner ded by others.	hip of fences not determined.											PREPARED FOR: Diego	Argu
 There may be additional restrictions not show 	It is not a certification of n on this survey that may for the exclusive use of th	of-ways of records. title, zoning, easements, or freedom from encumbrance to be found in the public records of this county. ABSTRAN ee entities named hereon. The Certificate does not exte	T NOT REVIEWED.											Surveyor's Note: •	
LEGEND	CI. = Clear Conc. = Concre D - Deed Ø - Diame DH = Drill He	Link Fence F.H. ete FIR ete FP&L ID ID tter INV cole I.P. sge 6 Maintenance Easm't L.B. sent I.P.	- Florida Department of Transportation Storm Manhole - Fire Hydrant - Found 1/2 Fon Rebar - Florida Power & Light Manhole - Identification - Invert Elevation - Knop Pipe - Licersed Business - Light Pole - Land Surveyor - Land Surveyor	M MAINT. ME MH Me Mon. N/A N/D N' NTS	- Measured - Maintenance - Maintenance Easement - Maintonance Easement - Mannole - Monument Line - Monument - Not Applicable - Nail & Disc - Number - Not to Scale	O/S O.U.L. P PB PC PCP PG PS P.I. PKWY	- Offset - Overhead Utility Lines - Plat - Plat Book - Point of Curvature - Permanent Control Point - Page - Point of Intersection - Parkway - Property Line	PL PLS P.O.B. P.O.C. P.P. PRC PRM PT R Res.	Pilanter Professional Land Surveyor Point of Beginning Point of Commencement Power Pole Point of Reverse Curvature Point of Reverse Monument Point of Reverse Curvature Point of Reference Monument Point of Tangency Reddus Residence	R.L.S. RNG R/R RSM R/W Sdwk Sec. SDMH S.M.H. SSMH	Registered Land Surveyor Range Rairoad Registered Surveyor & Mapper Righted ViAvy Sidewalk Section Sorm Drain Manhole Sanitary Manhole Sanitary Manhole Sanitary Sewer Manhole	T Trans. U.E. UTIL W.F. W.M. W.V.	= Tangent = Tansformer - Unity Seament - Unity = Unity - Unity - Unity - Wood Fence = Water Meter = Water Valve	SURVEYOR'S SEAL Unless it bears the signature and the original raised seal of a Florida license surveyor and mapper, this map/repor is for informational purposes only and is not valid. REVISED: 01-21-12 07-08-16	t

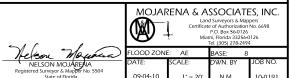

U.S. DEPARTMENT OF HOMELAND SECURITY

ELEVATION CERTIFICATE

IMPORTANT: Follow the instructions on pages 1–9.

OMB No. 1660-0008 Expiration Date: July 31, 2015

	gency Management A d Insurance Program	gency	IMPORTANT: Follow th	ne instructions on pag	es 1–9.	L	Expiration	n Date: July 31, 2015
			SECTION A - PRO	PERTY INFORMA	TION		FOR INSUF	RANCE COMPANY USE
A1. Build	ling Owner's Name	Diego Ag	nelli or assigns				Policy Num	ber:
A2. Buildir		luding Apt., Unit, Su	uite, and/or Bldg. No.) or P.O. R	oute and Box No.			Company N	NAIC Number:
	Miami Beach			State	FL	Ž	ZIP Code 3	33139
	erty Description (L o #02-3226-001		ımbers, Tax Parcel Numb	er, Legal Description,	etc.)			
			esidential, Addition, Acces	sory, etc.) Non-reside	ential			
	ude/Longitude: Lat			ig. <u>-80.12946° W</u>		Horizontal Datum	n: NAD	1927 🛛 NAD 1983
	ch at least 2 photog ling Diagram Numl		ilding if the Certificate is b	eing used to obtain flo	ood insura	ance.		
	building with a cra		closure(s):	A9	. For a bu	uilding with an attache	ed garage:	
	Square footage of o			390.5 sq ft	a) Squ	are footage of attache	ed garage	N/A sq ft
			the crawl space or	0				s in the attached garage
	enclosure(s) within Total net area of flo			 /A sq in		in 1.0 foot above adja al net area of flood op		
d) Engineered flood openings?								
			TION B - FLOOD INSU		AP (FIRM	I) INFORMATION		
	Community Name Miami Beach		Number 120651	B2. County Name	MIAMI-I	DADE		B3. State FL
•	/Panel Number	B5. Suffix	B6. FIRM Index Date	B7. FIRM Panel Eff	ective/	B8. Flood Zone(s)		Flood Elevation(s) (Zone
1200	86C 0317		0/11/00	Revised Date		٨٦	AO, u	use base flood depth)
		L b - D El I	9/11/09	9/11/09		AE	<u> </u>	8
			Elevation (BFE) data or ba		a in item	Б9.		
_	FIS Profile 🔲 Fi ate elevation datur		nunity Determined ☐ □ in Item B9: ☒ NGV		/D 4000	□ Oth = =/C====		
			rier Resources System (C	_		Other/Source	П	′es ⊠ No
	gnation Date			OPA	ise Fiblec	ited Alea (OFA)!	<u></u> '	es 🖂 NO
		SECTIO	DN C - BUILDING ELE	ATION INFORMA	TION (S	URVEY REQUIRE	D)	
C1 Buildin	ng elevations are b		☐ Construction Drawin		•			Construction
			ired when construction of			onoti dottori	i illionoa c	onon donon
			(with BFE), VE, V1-V30, V				AR/AO. Co	mplete Items
	_	_	liagram specified in Item A					
	nmark Utilized <u>City</u>			Vertical Datu				
			evations in items a) through		D 1929	□ NAVD 1988 [
	ũ		be the same as that used		1 2	Check the mea		
,	•	,	ment, crawl space, or enc	losure floor)	1 · <u>2</u> 7 · <u>1</u>	_ ⊠ feet ⊠ feet	☐ mete	
,	op of the next high		ıctural member (V Zones		<u>/</u> · <u> </u> /A .		☐ mete	
•	Attached garage (to		ictural member (v Zones		/A .	_ ⊠ feet	☐ mete	
			quipment servicing the bu		9.9	_ ⊠ feet	☐ mete	
			cation in Comments)		<u> </u>			15
			ext to building (LAG)		5 6	⊠ feet	☐ mete	rs
			ext to building (HAG)		6.4	_ ⊠ feet	☐ mete	
0,	• • • • • • • • • • • • • • • • • • • •	, 0	evation of deck or stairs, i	ncluding	6.2	_ ⊠ feet	☐ mete	
st	tructural support							
This cortif	fination in to be air		TION D - SURVEYOR,					
informatio	on. I certify that the	e information on	by a land surveyor, engine this Certificate represents	s my best efforts to int	terpret the	e data available.	'	
	a <i>nd that any tai</i> se s k here if comments	-	ne punishable by fine or in	<i>าprisonment under 18</i> e latitude and longitud				PLACE
	k here if attachmer	•		e latitude and longitud nsed land surveyor?	Ωe iii Sect ⊠ Ye	<u>.</u>		SEAL HERE
Certifier's	Name Nelso	on Mojarena			Licens	se Number 5504	$\exists $,	
Title	President		Co	mpany Name	Mojaren	na & Associates, Inc.	The	(son havened
Address	P.O. Box 56-0	126	Ci	ty Miami	State	FL Zip Code 33256-012		3/16/2016
Signature	7/2	-0	Da		Telepho	one		RSM #5504
l	1-430x	Mapaca)	'	3/16/2016	(305) 2	278-2494 10-019	1	

ELEVATION CERTIFICATE, page 2


IMPORTANT: In these spaces, copy the corresp			FOR INSURANCE COMPANY USE
Building Street Address (including Apt., Unit, Suite, 1900 Collins Avenue	and/or Bldg. No.) or P.O. Ro		Policy Number:
City Miami Beach	State FL	ZIP Code 33139	Company NAIC Number:
SECTION D - SURV	EYOR, ENGINEER, OR A	ARCHITECT CERTIFICAT	TION (CONTINUED)
Copy both sides of this Elevation Certificate for (1)	community official, (2) insura	nce agent/company, and (3)	building owner.
Comments C2. e) Type of Machinery Servicing Building = Botton	m of Electric Meter		
A5. Obtained Latitude/Longitude from http://itouc	hmap.com/latlong.html		enings information not provided.
C2. a) Top of bottom floor (including basement, crav	wl space, or enclosure floor)	= Basement	
Signature Thereon Stavens		Date 3/16/2016	
SECTION E - BUILDING ELEVATION IN	FORMATION (SURVEY		ONE AO AND ZONE A (WITHOUT BFE)
For Zones AO and A (without BFE), complete Items E1 For Items E1-E4, use natural grade, if available. Check	the measurement used. In Pu	erto Rico only, enter meters.	
 E1. Provide elevation information for the following grade (HAG) and the lowest adjacent grade (I a) Top of bottom floor (including basement, ci b) Top of bottom floor (including basement, ci ci	LAG). rawl space, or enclosure) is rawl space, or enclosure) is od openings provided in Sectorians) of the building is not servicing the building is allable, is the top of the bottom. The local official must cert	feet m feet m feet m feet m fion A Items 8 and/or 9 (see feet m form floor elevated in accordantify this information in Section	leters
SECTION F - PROP	ERTY OWNER (OR OWN	IER'S REPRESENTATIV	E) CERTIFICATION
The property owner or owner's authorized represen Zone AO must sign here. The statements in Section Property Owner's or Owner's Authorized Represent	ns A, B, and E are correct to		thout a FEMA-issued or community-issued BFE) or
Address	С	ity	State ZIP Code
Signature	D	ate	Telephone
Comments			
SEC	TION G - COMMUNITY II	NEORMATION (OPTION)	
		NFORMATION (OPTION)	AL)
The local official who is authorized by law or ordinance to G of this Elevation Certificate. Complete the applicable it G1. The information in Section C was taken frow who is authorized by law to certify elevation G2. A community official completed Section E f	o administer the community's flem(s) and sign below. Check to mother documentation that he information. (Indicate the soor a building located in Zone	oodplain management ordinan he measurement used in Items has been signed and sealed lource and date of the elevati A (without a FEMA-issued o	ce can complete Sections A, B, C (or E), and G8–G10. In Puerto Rico only, enter meters. Or a licensed surveyor, engineer, or architect on data in the Comments area below.) Tricommunity-issued BFE) or Zone AO.
The local official who is authorized by law or ordinance to G of this Elevation Certificate. Complete the applicable it G1. The information in Section C was taken frow ho is authorized by law to certify elevation G2. A community official completed Section E f G3. The following information (Items G4-G9) is	o administer the community's flem(s) and sign below. Check to the documentation that he information. (Indicate the source a building located in Zone provided for community floor	oodplain management ordinan he measurement used in Items nas been signed and sealed l ource and date of the elevati A (without a FEMA-issued of dplain management purposes	ce can complete Sections A, B, C (or E), and G8–G10. In Puerto Rico only, enter meters. by a licensed surveyor, engineer, or architect on data in the Comments area below.) r community-issued BFE) or Zone AO.
The local official who is authorized by law or ordinance to G of this Elevation Certificate. Complete the applicable it G1. The information in Section C was taken frow ho is authorized by law to certify elevation G2. A community official completed Section E for G3. The following information (Items G4-G9) is	o administer the community's flem(s) and sign below. Check to mother documentation that he information. (Indicate the soor a building located in Zone	oodplain management ordinan he measurement used in Items nas been signed and sealed l ource and date of the elevati A (without a FEMA-issued of dplain management purposes	ce can complete Sections A, B, C (or E), and G8–G10. In Puerto Rico only, enter meters. by a licensed surveyor, engineer, or architect on data in the Comments area below.)
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BUILDING PHOTOGRAPHS

See Instructions for Item A6.

IMPORTANT: In these spaces, copy the correspondi	ing information from S	Section A.	FOR INSURANCE COMPANY USI	=
Building Street Address (including Apt., Unit, Suite, and/o 1900 Collins Avenue	or Bldg. No.) or P.O. Rou	ite and Box No.	Policy Number:	
City Miami Beach	State FL	ZIP Code 33139	Company NAIC Number:	

If using the Elevation Certificate to obtain NFIP flood insurance, affix at least 2 building photographs below according to the instructions for Item A6. Identify all photographs with date taken; "Front View" and "Rear View"; and, if required, "Right Side View" and "Left Side View." When applicable, photographs must show the foundation with representative examples of the flood openings or vents, as indicated in Section A8. If submitting more photographs than will fit on this page, use the Continuation Page.

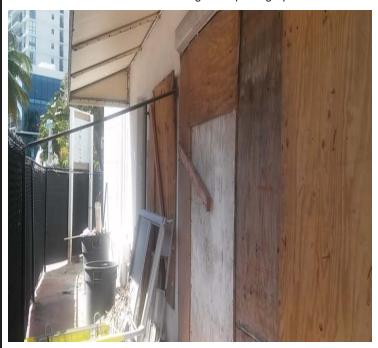

Front View 3/16/2016



Rear View 3/16/2016



Right Side View 3/16/2016

Left Side View 3/16/2016

PROJECT DATA

LEGAL DESCRIPTION

PARCEL I

Lots 7 & 8 and the south 5 feet of Lots 1,2 & 3, Block D, OCEAN FRONT PROPERTY OF THE MIAMI BEACH IMPROVEMENT COMPANY, according to the Plat thereof, as recorded in Plat Book 5, Page 7 of the Public Records of MIAMI DADE County, Florida.

AND

PARCEL II

Lots 9 & 10, Block D, OCEAN FRONT PROPERTY OF THE MIAMI BEACH IMPROVEMENT COMPANY, as recorded in Plat Book 5, Page 7 of the Public Records of MIAMI DADE County, Florida.

AND

PARCEL III

Lots 11, Block D, OCEAN FRONT PROPERTY OF THE MIAMI BEACH IMPROVEMENT COMPANY, as recorded in Plat Book 5, Page 7 of the Public Records of MIAMI DADE County, Florida.

SITE PLAN INFORMATION

ZONING DESIGNATION:

CD -2

FLOOD ZONE:

NET LOT AREA:

AE-8 HOTEL

TYPE OF OCCUPANCY:

30,514 SF (0.70 ACRES)

BASE F.A.R.

BASE F.A.R.:

2.0

FLOOR AREA RATIO

ALLOWED

PROVIDED

30,514 SF X 2.0

61,028 SF

36,914 SF

21,001 SF

EXISTING STRUCTURE NEW CONSTRUCTION

57,915 SF

TOTAL

BUILDING SETBACKS - BUILDINGS 1,2,3 EXISTING TO REMAIN

REQUIRED

PROVIDED

BUILDING 4

FRONT 19TH STREET:

20' - 0"

SIDES

(TOTAL 16% MIN. 8%)

COLLINS AVENUE: LIBERTY AVENUE: N/A N/A N/A

N/A

REAR

NORTH

8' - 3 \frac{3}{4}"

5' - 0" (EXISTING STRUCTURE) 5' - 0" (NEW CONSTRUCTION)

BUILDING HEIGHT BUILDING #4

ALLOWED

5 STORIES

50' - 0" FROM GRADE

PROVIDED

5 STORIES

48' - 4"

HOTEL UNIT COUNT: SQUARE FOOTAGE - VARIANCE REQUIRED

BUILDING #	NO. OF UNITS	UNIT SIZES: -300	UNIT SIZES 300 - 335	UNIT SIZES 335+
BUILDING 1	66	56	5	5
BUILDING 2	14	0	0	14
BUILDING 3	15	0	7	8
BUILDING 4	25	0	0	25
BUILDING 3	15	0 0 0	0 7 0	8

TOTAL # OF UNITS

120 UNITS

PARKING REQUIRED

HOTEL ROOMS (NEW CONSTRUCTION) **BUILDING #1**


PARKING AMENDMENT

BUILDING #4 PARKING AMENDMENT 10 UNITS X 1 SPACE/UNIT = 10 PARKING SPACES (5) UNDER PROPOSED

25 UNITS X 1 SPACE/UNIT = 25 PARKING SPACES (13) UNDER PROPOSED

PARKING PROVIDED

25 PARKING SPACES

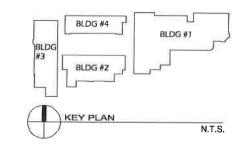



1137

LENNOX HOTEL


10 COLLINS AVENUE / 229 19th STRE
5 LIBERTY AVE. MIAMI BEACH, FL 33 DATA **PROJECT**







CHECKED BY: A0.02

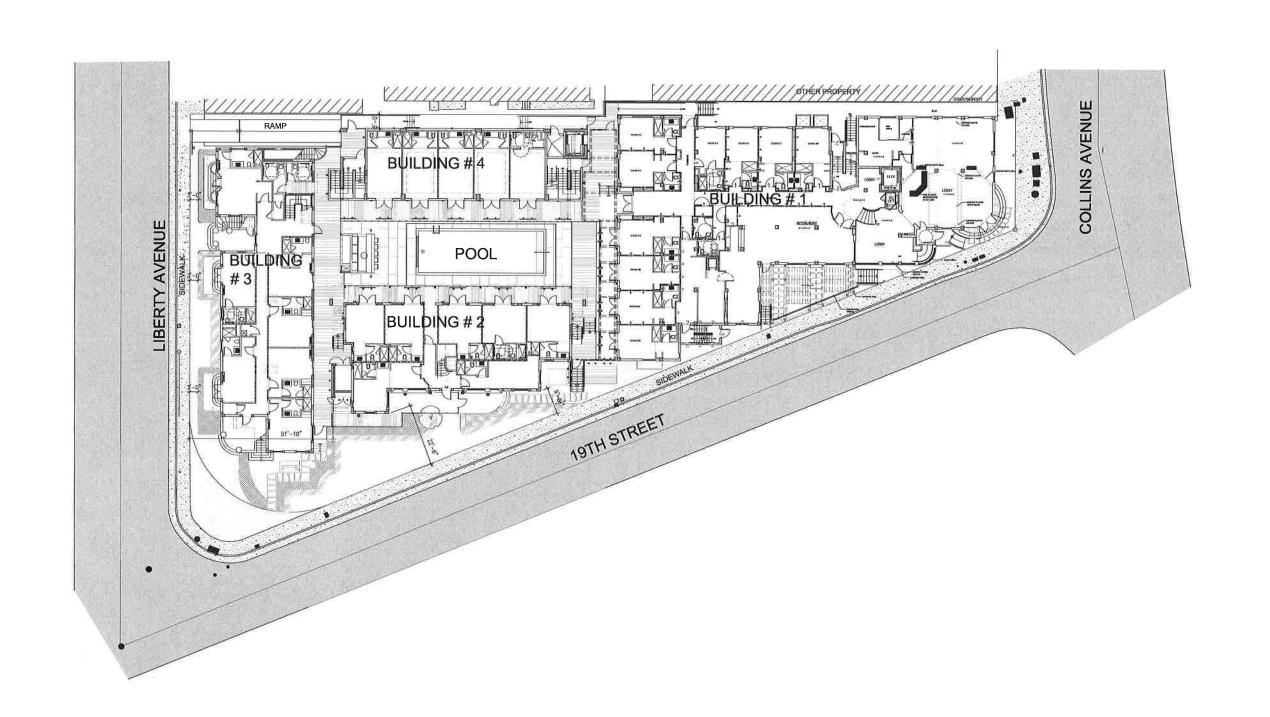

REVISIONS / SUBMISSIONS

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OVERALL SITE PLAN GROUND LEVEL

LENNOX HOTEL
229 19th STREET, MIAMI BEACH,FL 33139
BUILDING #2






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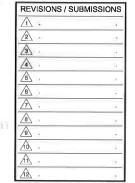
SCALE: 1/16" = 1'-0"

PROPOSED SITE PLAN

18" HIGH LANDSCAPE BARRIER.

42" HIGH LANDSCAPE BARRIER.



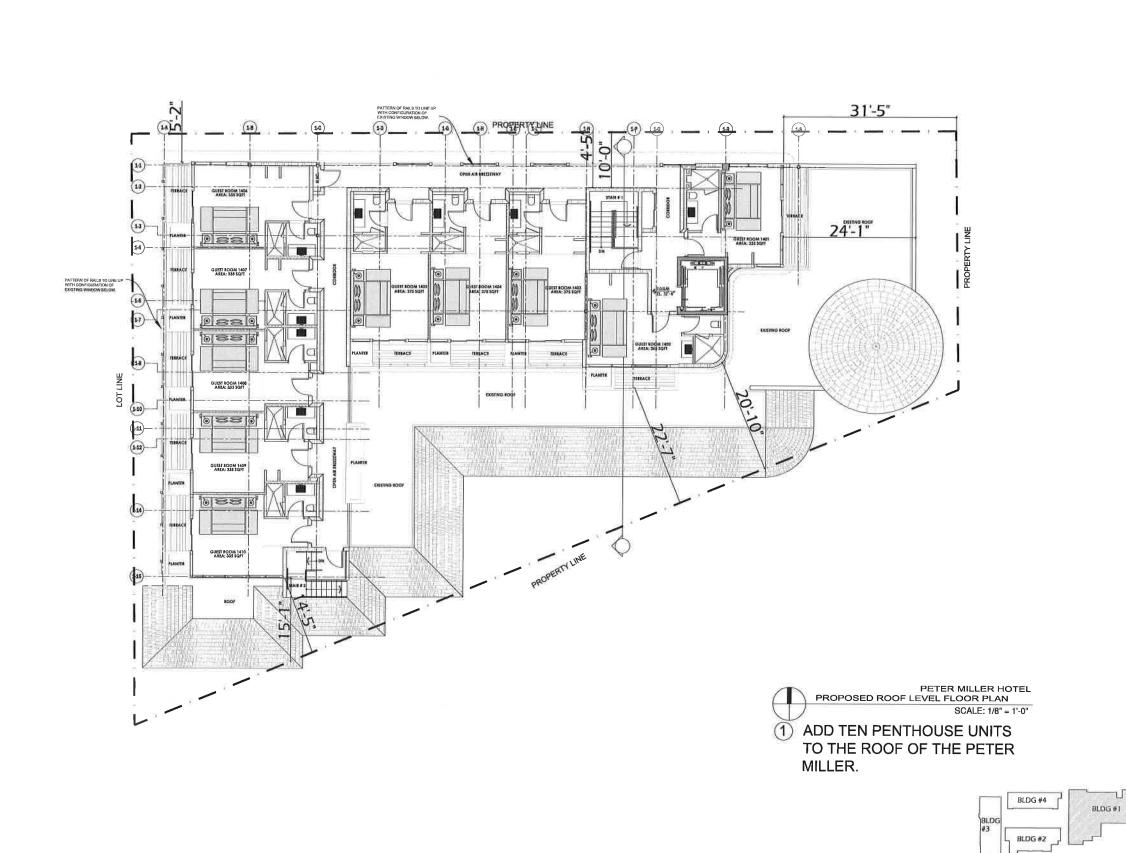

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ALL DRAWINGS AND WRITTEN MATERIAL APPEARING HEREIN CONSTITUTE THE ORIGINAL AND UNFUBLISHED WORK OF KOST MAP ALL, AND MAY NOT THE DUPLICATED, USED, ON DISCLOSED WITHOUT THE EXPRESS WRITTEN CONSEINT OF KOUR KAPP APPLAINED THE APPEAR OF THE ORIGINAL WAY AND A THE ORIGINAL WAY AND A THE ORIGINAL WAY AND A STATE OR THE OR

MARKETURE & STEELING DESIGN, MC AA. (2)

h STREET 1, FL 33139

PROPOSED
ROOF TOP LEVEL
FLOOR PLAN

LENNOX HOTEL
1900 COLLINS AVENUE / 229 19th STREE
1915 LIBERTY AVE. MIAMI BEACH, FL 331



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AIA ASID NCARB 2815 Biscayne Boulevard Suice 200 Marmi, Florida 33137 0.305,5773,1818 F. 305,5773,8786



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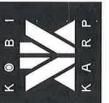
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LENNOX HOTEL
1900 COLLINS AVENUE / 229 19th STREET
1915 LIBERTY AVE. MIAMI BEACH, FL 33139
PETER MILLER HOTEL
ELEVATIONS




ARCHITECTURE
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E 326,573,4188
WWW.KOBIKARP.COM



DRAWN BY:
CHECKED BY:
DATE: 10-19-2012

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PROPOSED EAST SITE LINE PERSPECTIVE SCALE: 1/8" = 1'-0"

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SITE LINE ELEVATION LENNOX HOTEL
1900 COLLINS AVENUE / 229 19th STREET
1915 LIBERTY AVE. MIAMI BEACH, FL 33139

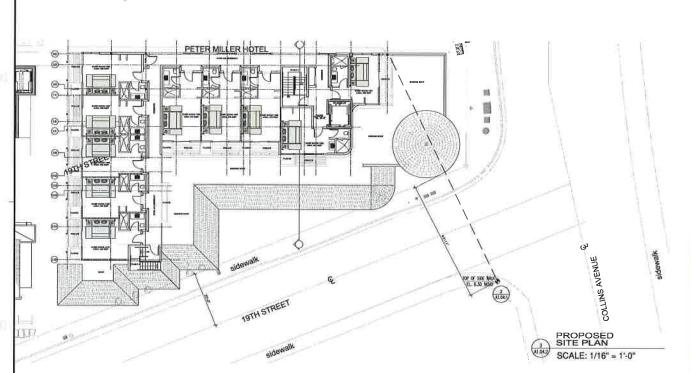



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