


A F I L M

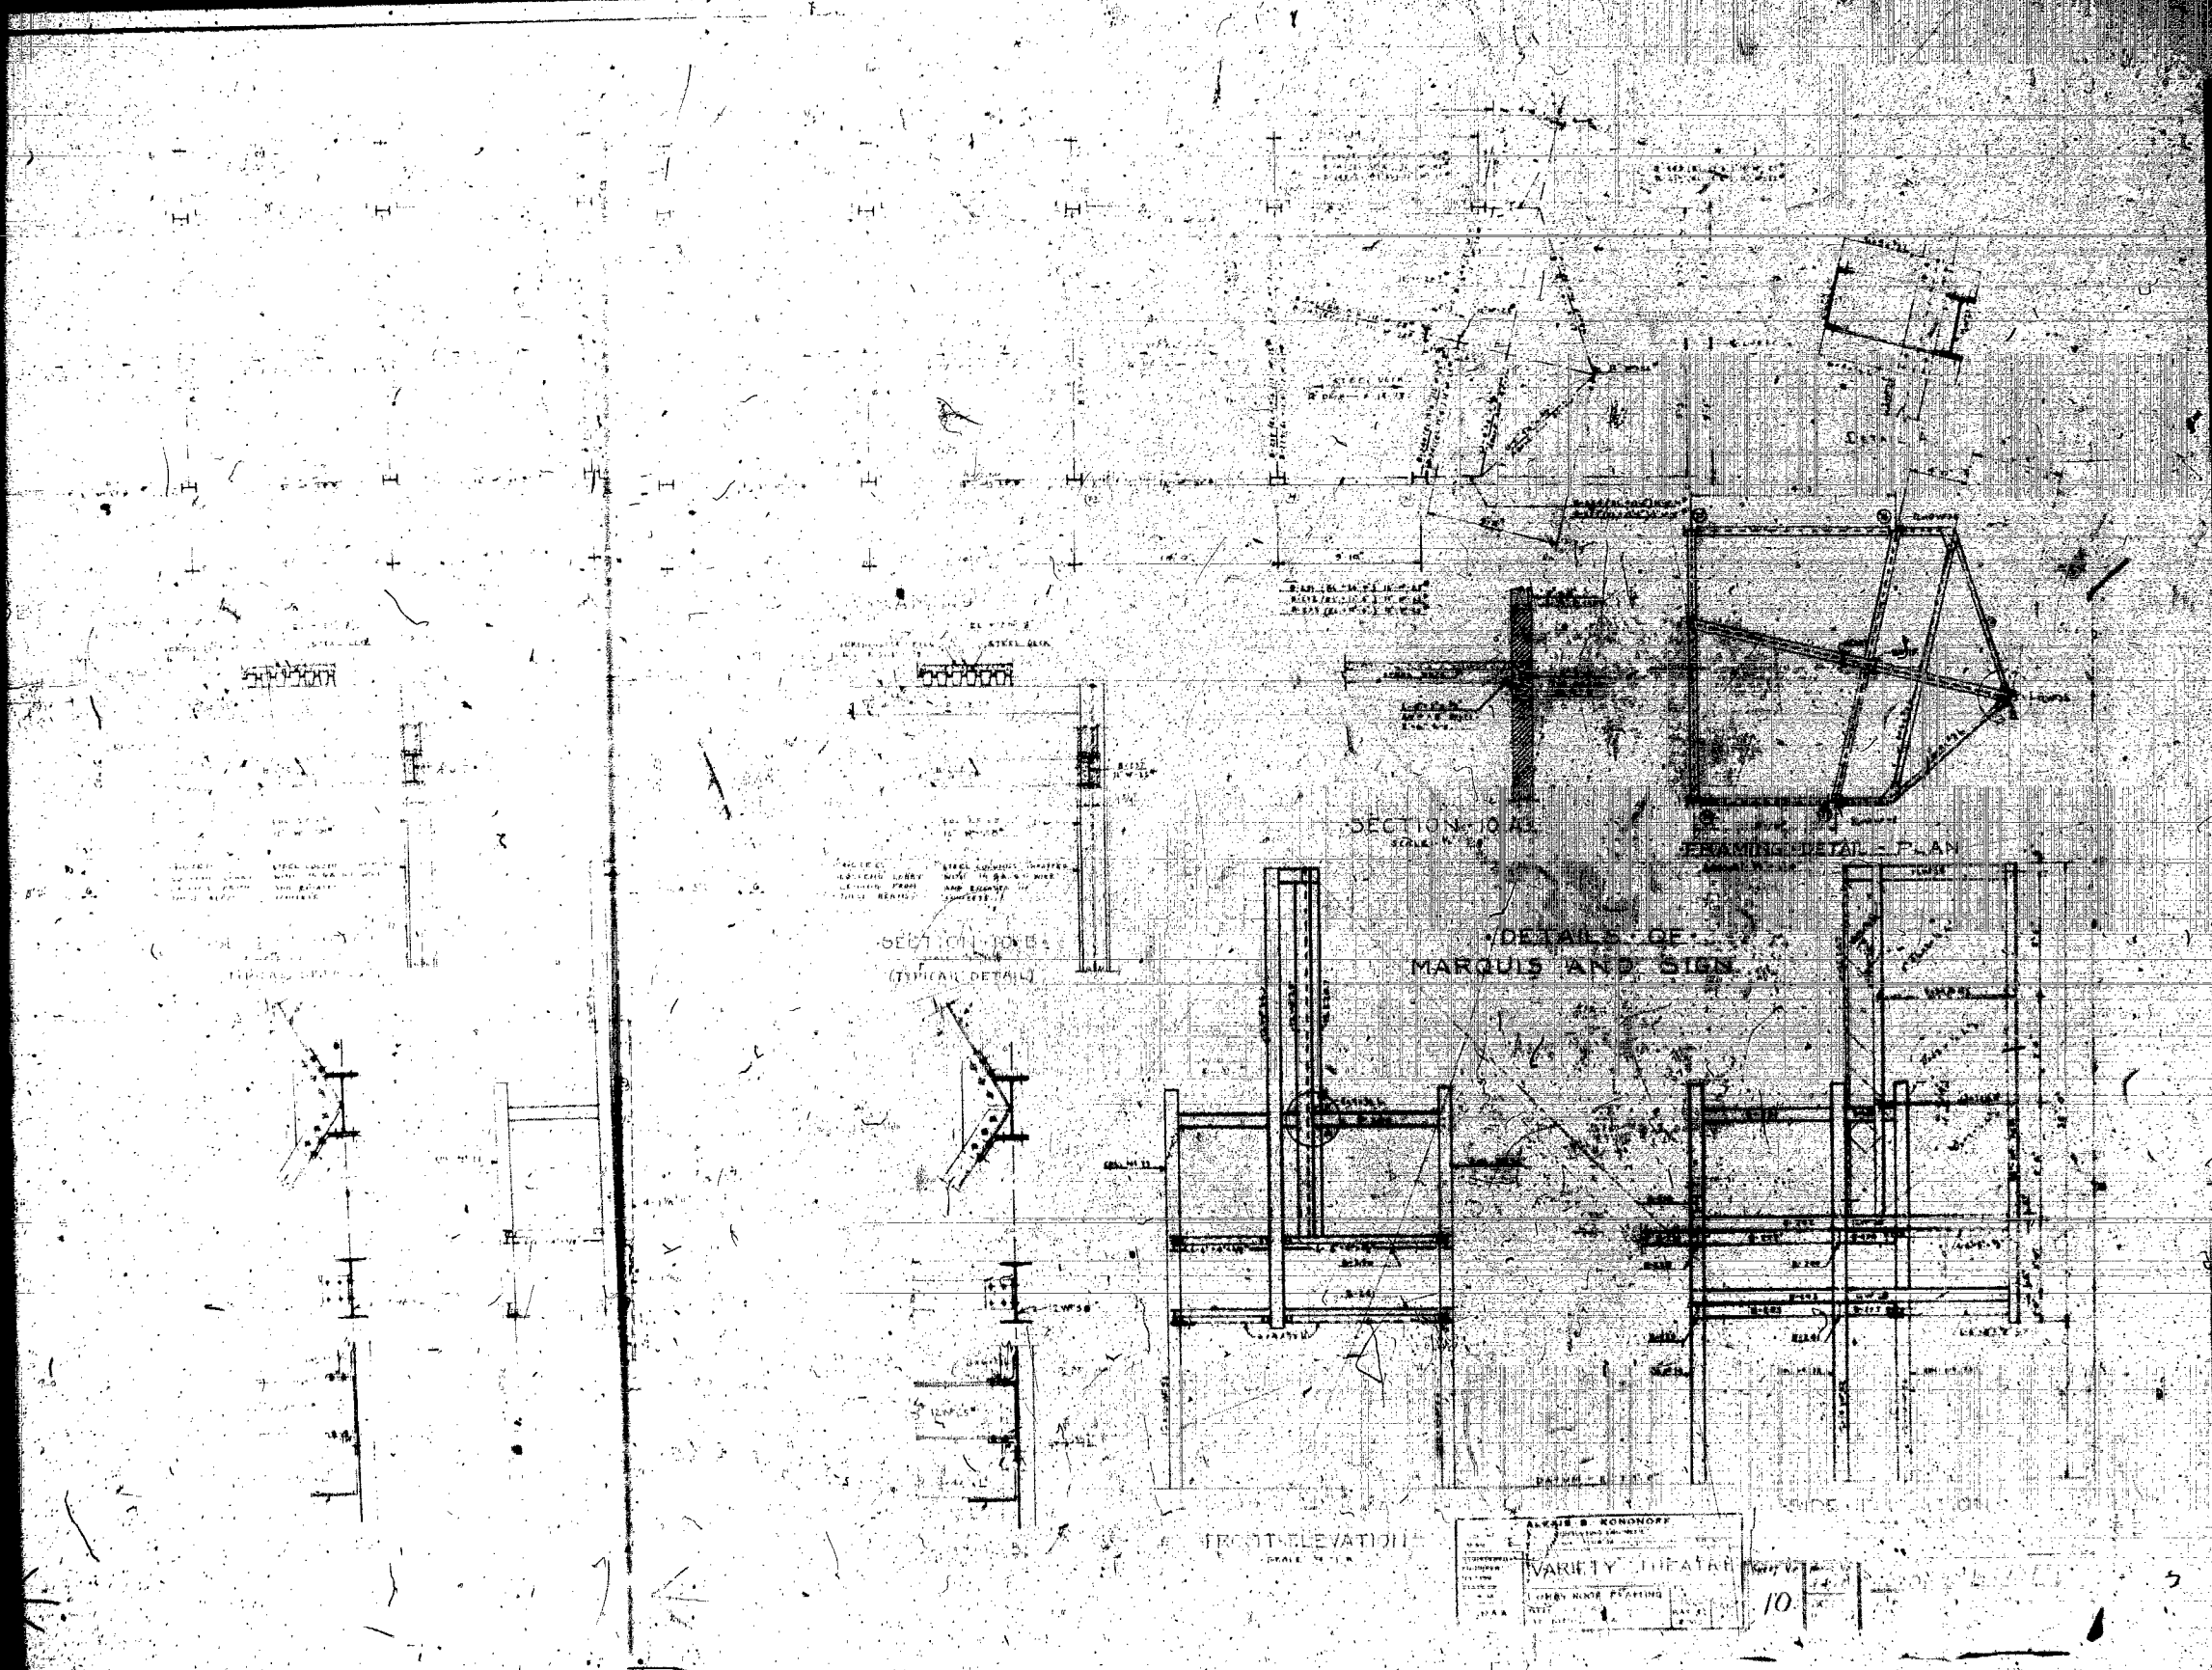

SECTION 10 A1
SCALE 1/4" = 1'-0"

TRUSS DETAIL - PLAN

DETAILS OF
MARQUEE AND SIGN






SECTION 10 B1
(TYPICAL DETAIL)

FRONT ELEVATION
SCALE 1/4" = 1'-0"

SIDE ELEVATION
SCALE 1/4" = 1'-0"


ALEXIS S. KONONOFF	
ARCHITECT	
1000 MARKET STREET	
SAN FRANCISCO, CALIF.	
VARIETY THEATRE	
LORRY HOME PLATING	
1000 MARKET STREET	
SAN FRANCISCO, CALIF.	

10

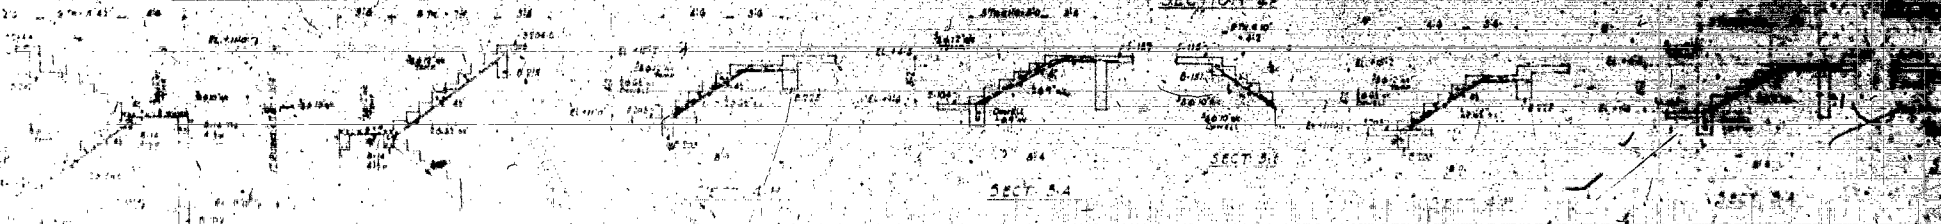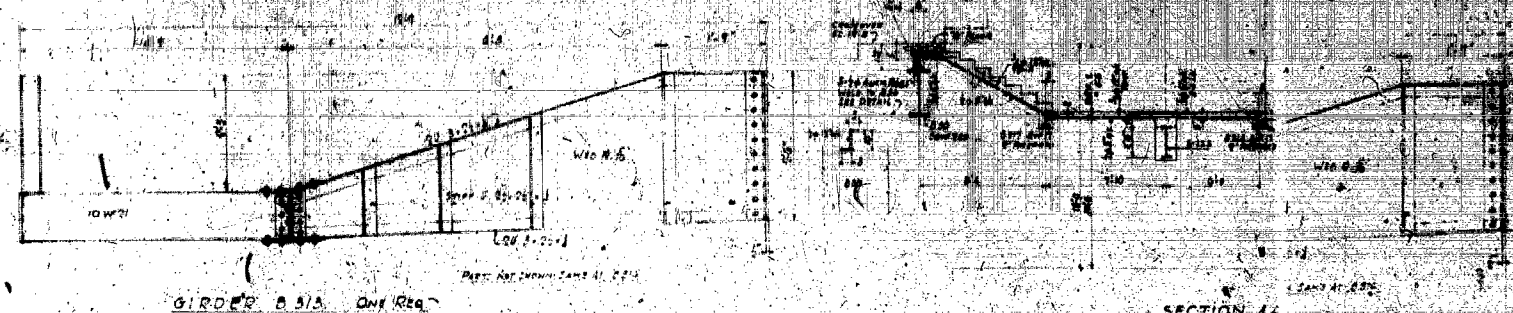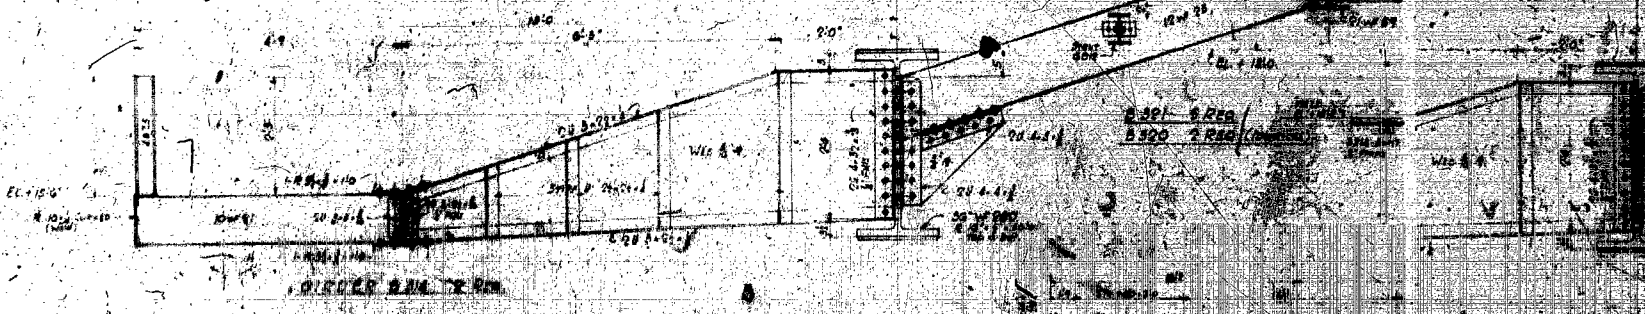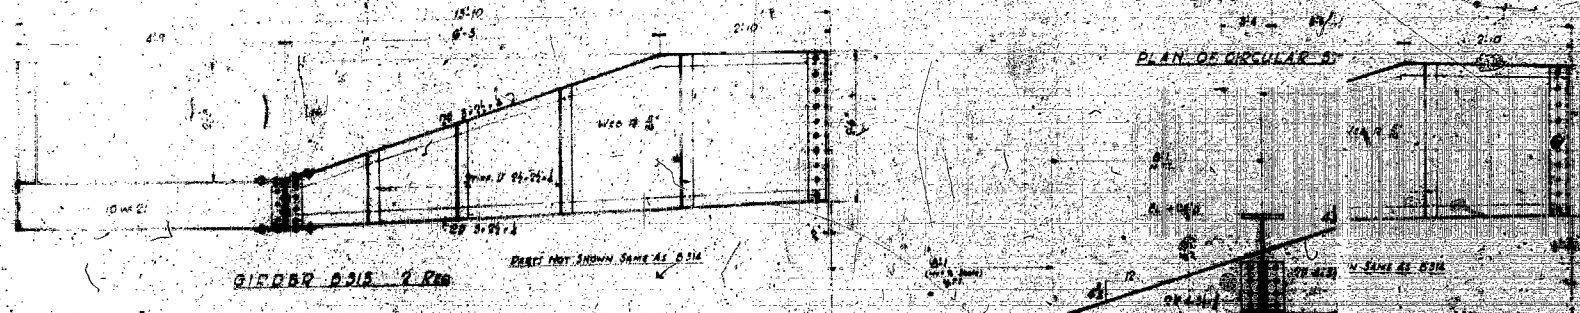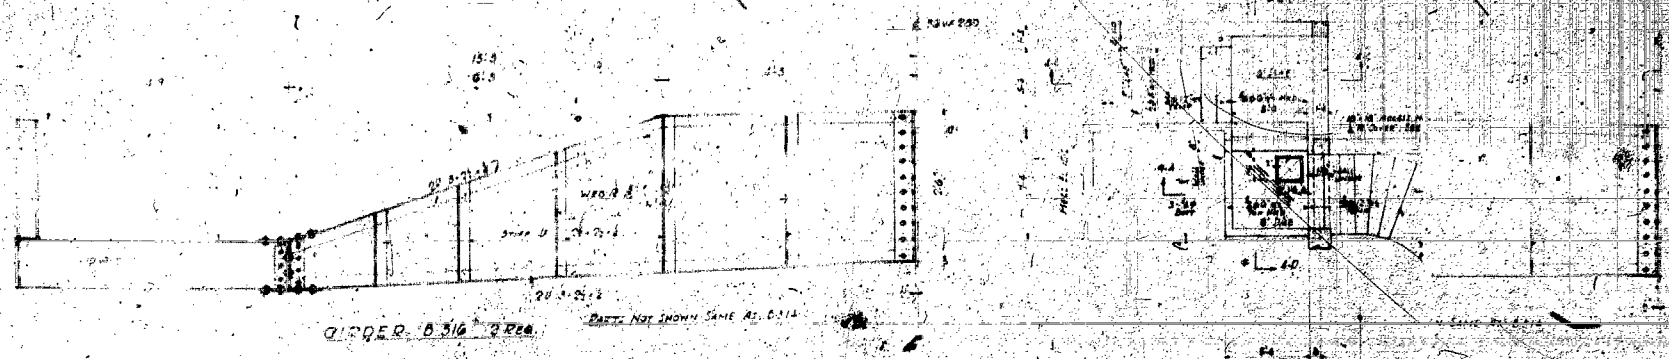


SECTION 41 ←


SECTION 42 ←

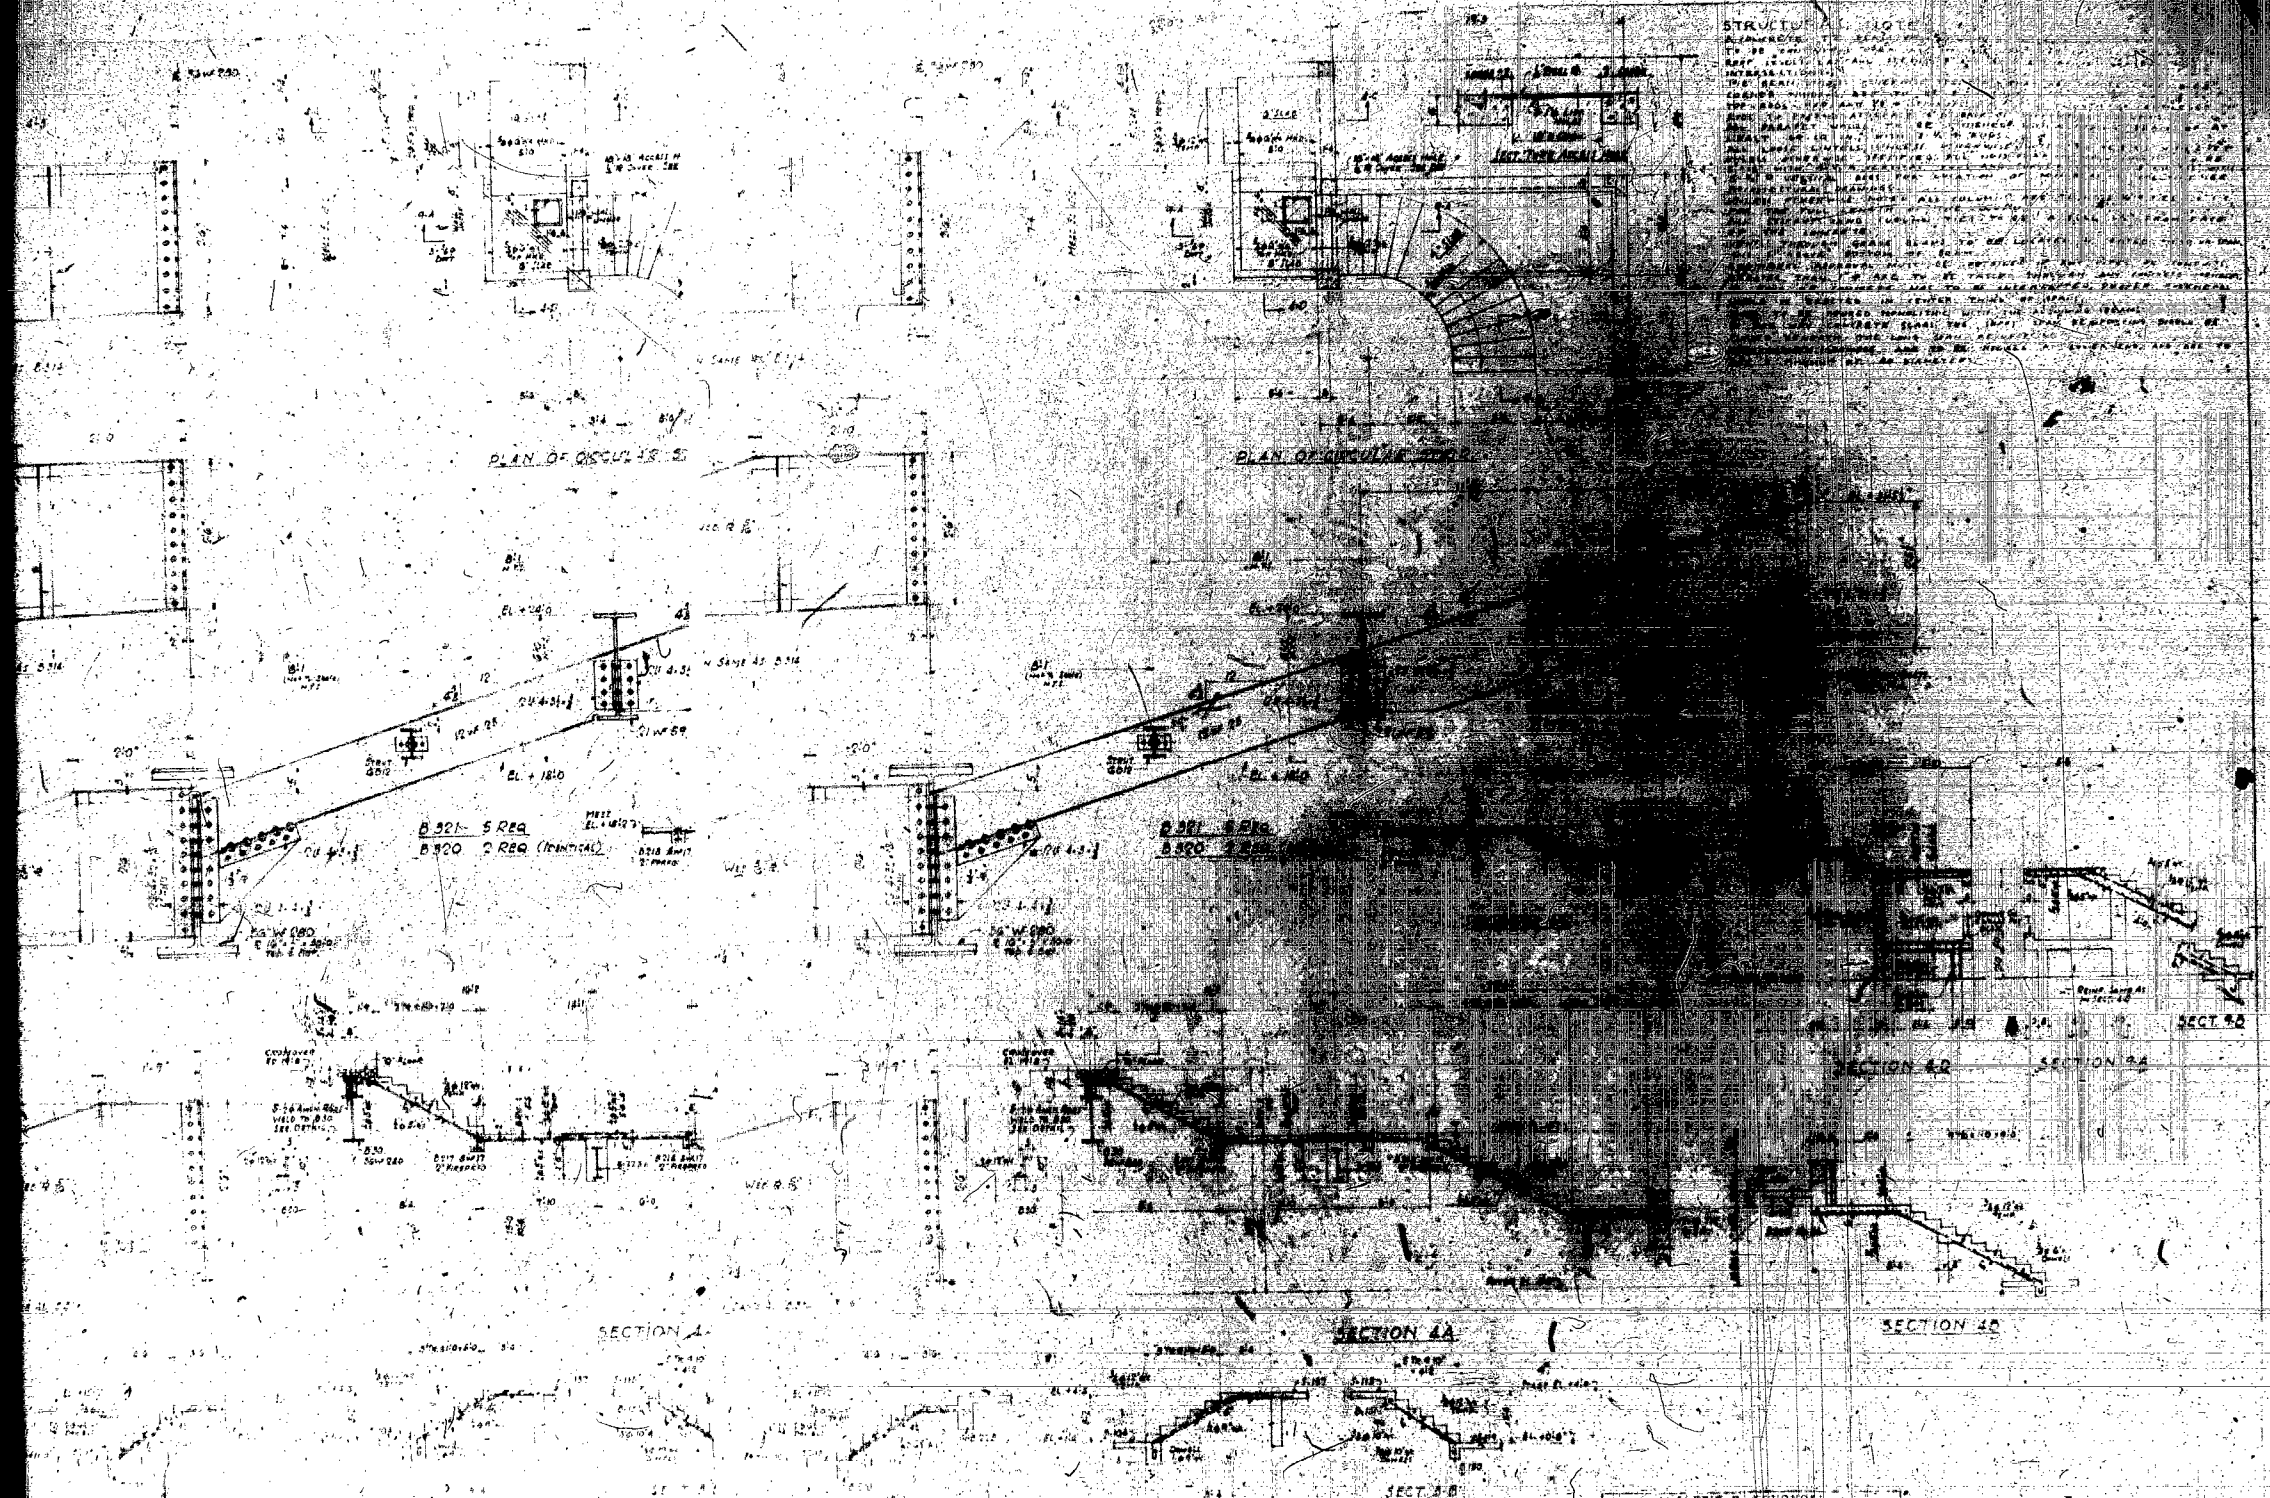

STRUCTURAL NOTE
 1. ALL REINFORCING BARS SHALL BE OF THE HEAVIEST GRADE AVAILABLE.
 2. ALL REINFORCING BARS SHALL BE OF THE HEAVIEST GRADE AVAILABLE.
 3. ALL REINFORCING BARS SHALL BE OF THE HEAVIEST GRADE AVAILABLE.
 4. ALL REINFORCING BARS SHALL BE OF THE HEAVIEST GRADE AVAILABLE.
 5. ALL REINFORCING BARS SHALL BE OF THE HEAVIEST GRADE AVAILABLE.
 6. ALL REINFORCING BARS SHALL BE OF THE HEAVIEST GRADE AVAILABLE.
 7. ALL REINFORCING BARS SHALL BE OF THE HEAVIEST GRADE AVAILABLE.
 8. ALL REINFORCING BARS SHALL BE OF THE HEAVIEST GRADE AVAILABLE.
 9. ALL REINFORCING BARS SHALL BE OF THE HEAVIEST GRADE AVAILABLE.
 10. ALL REINFORCING BARS SHALL BE OF THE HEAVIEST GRADE AVAILABLE.

ALFRED B. EDWARDS
 CIVIL ENGINEER
 1000 ...
 ...
 ...

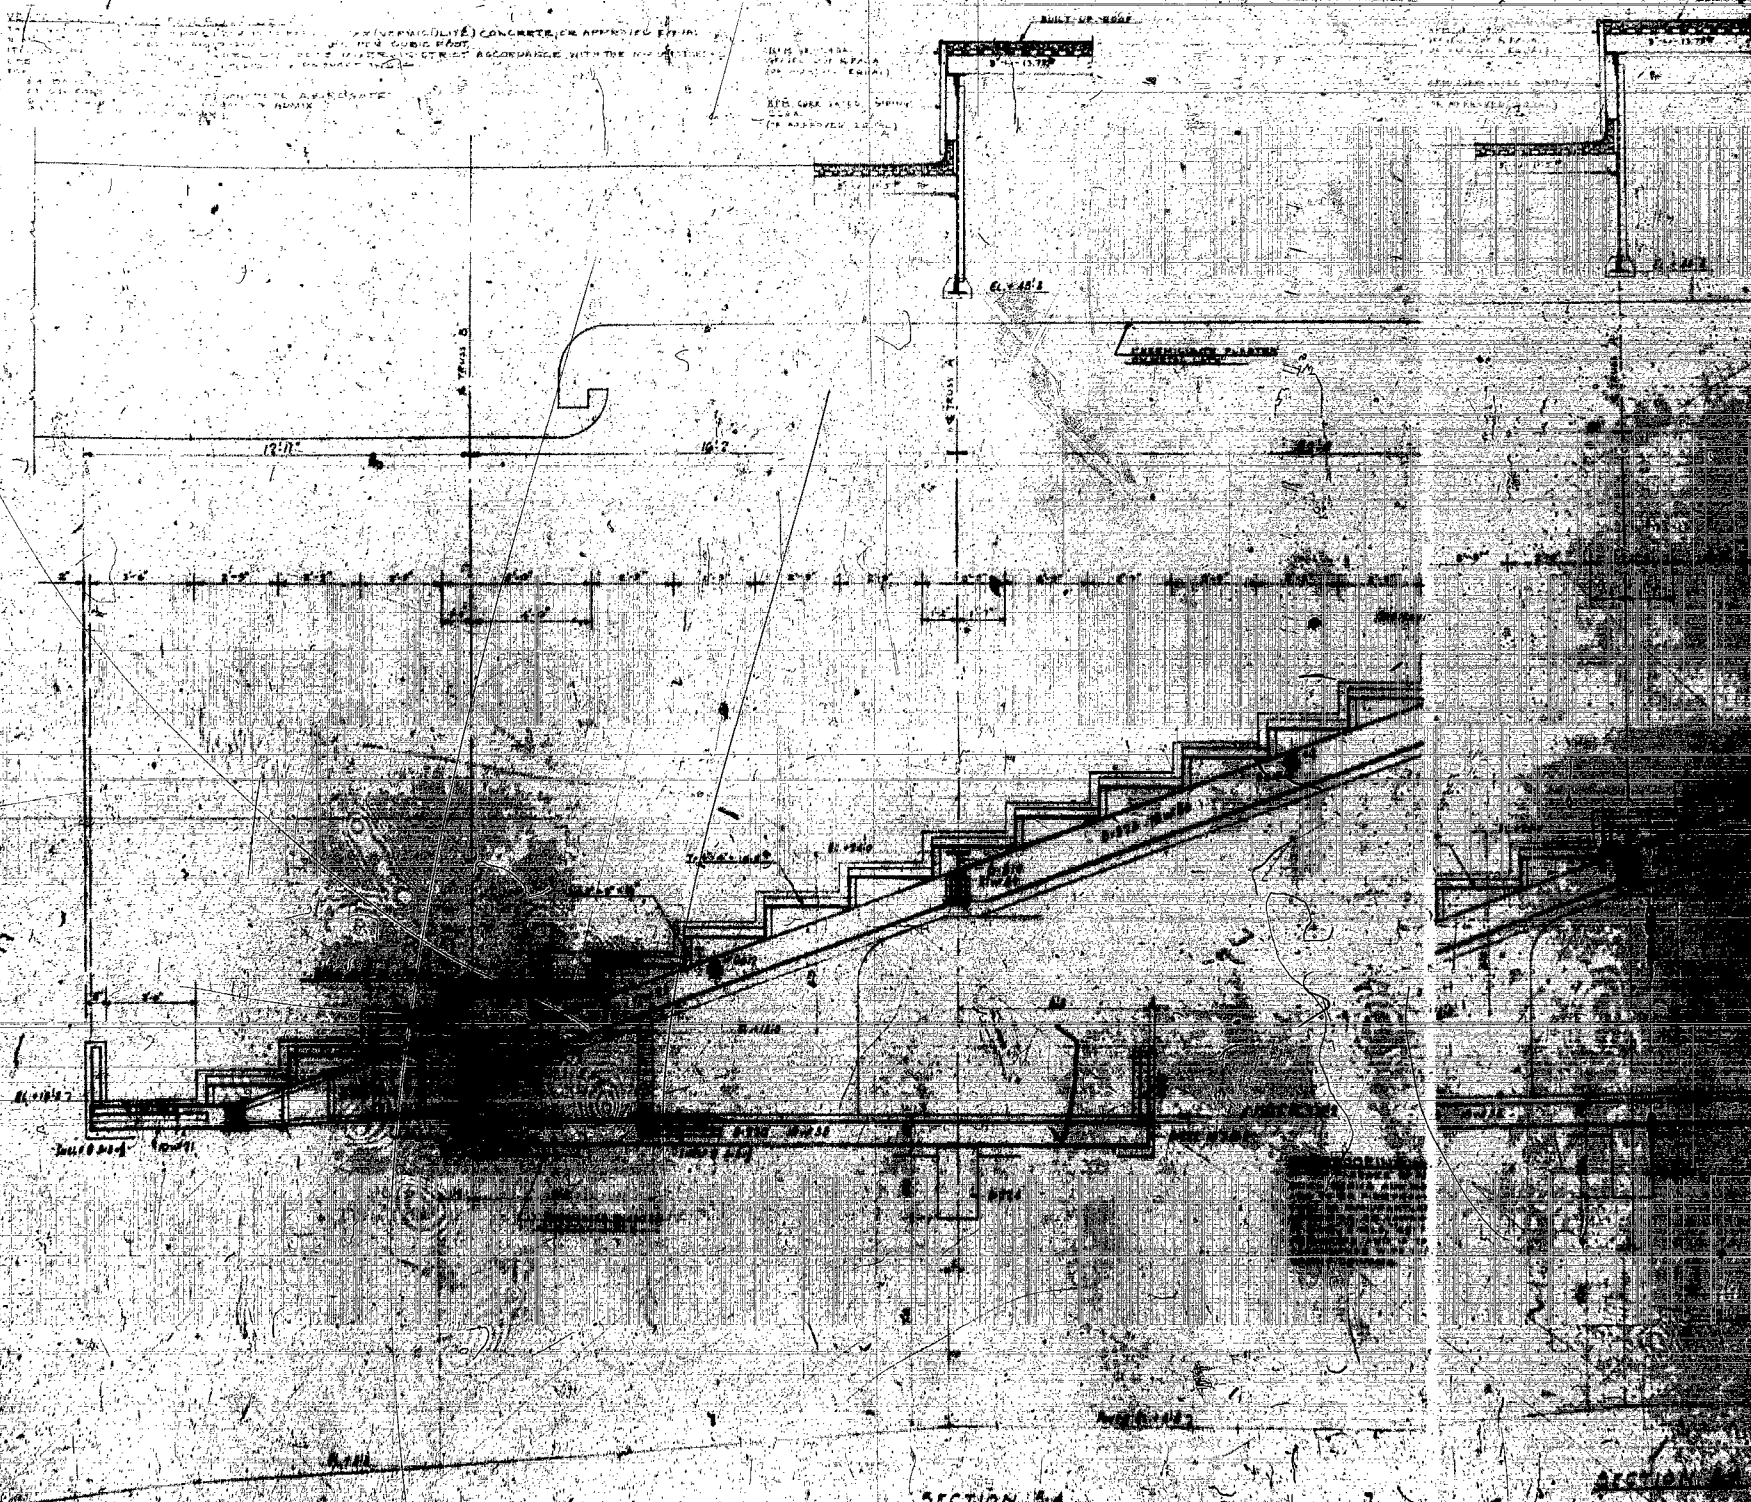

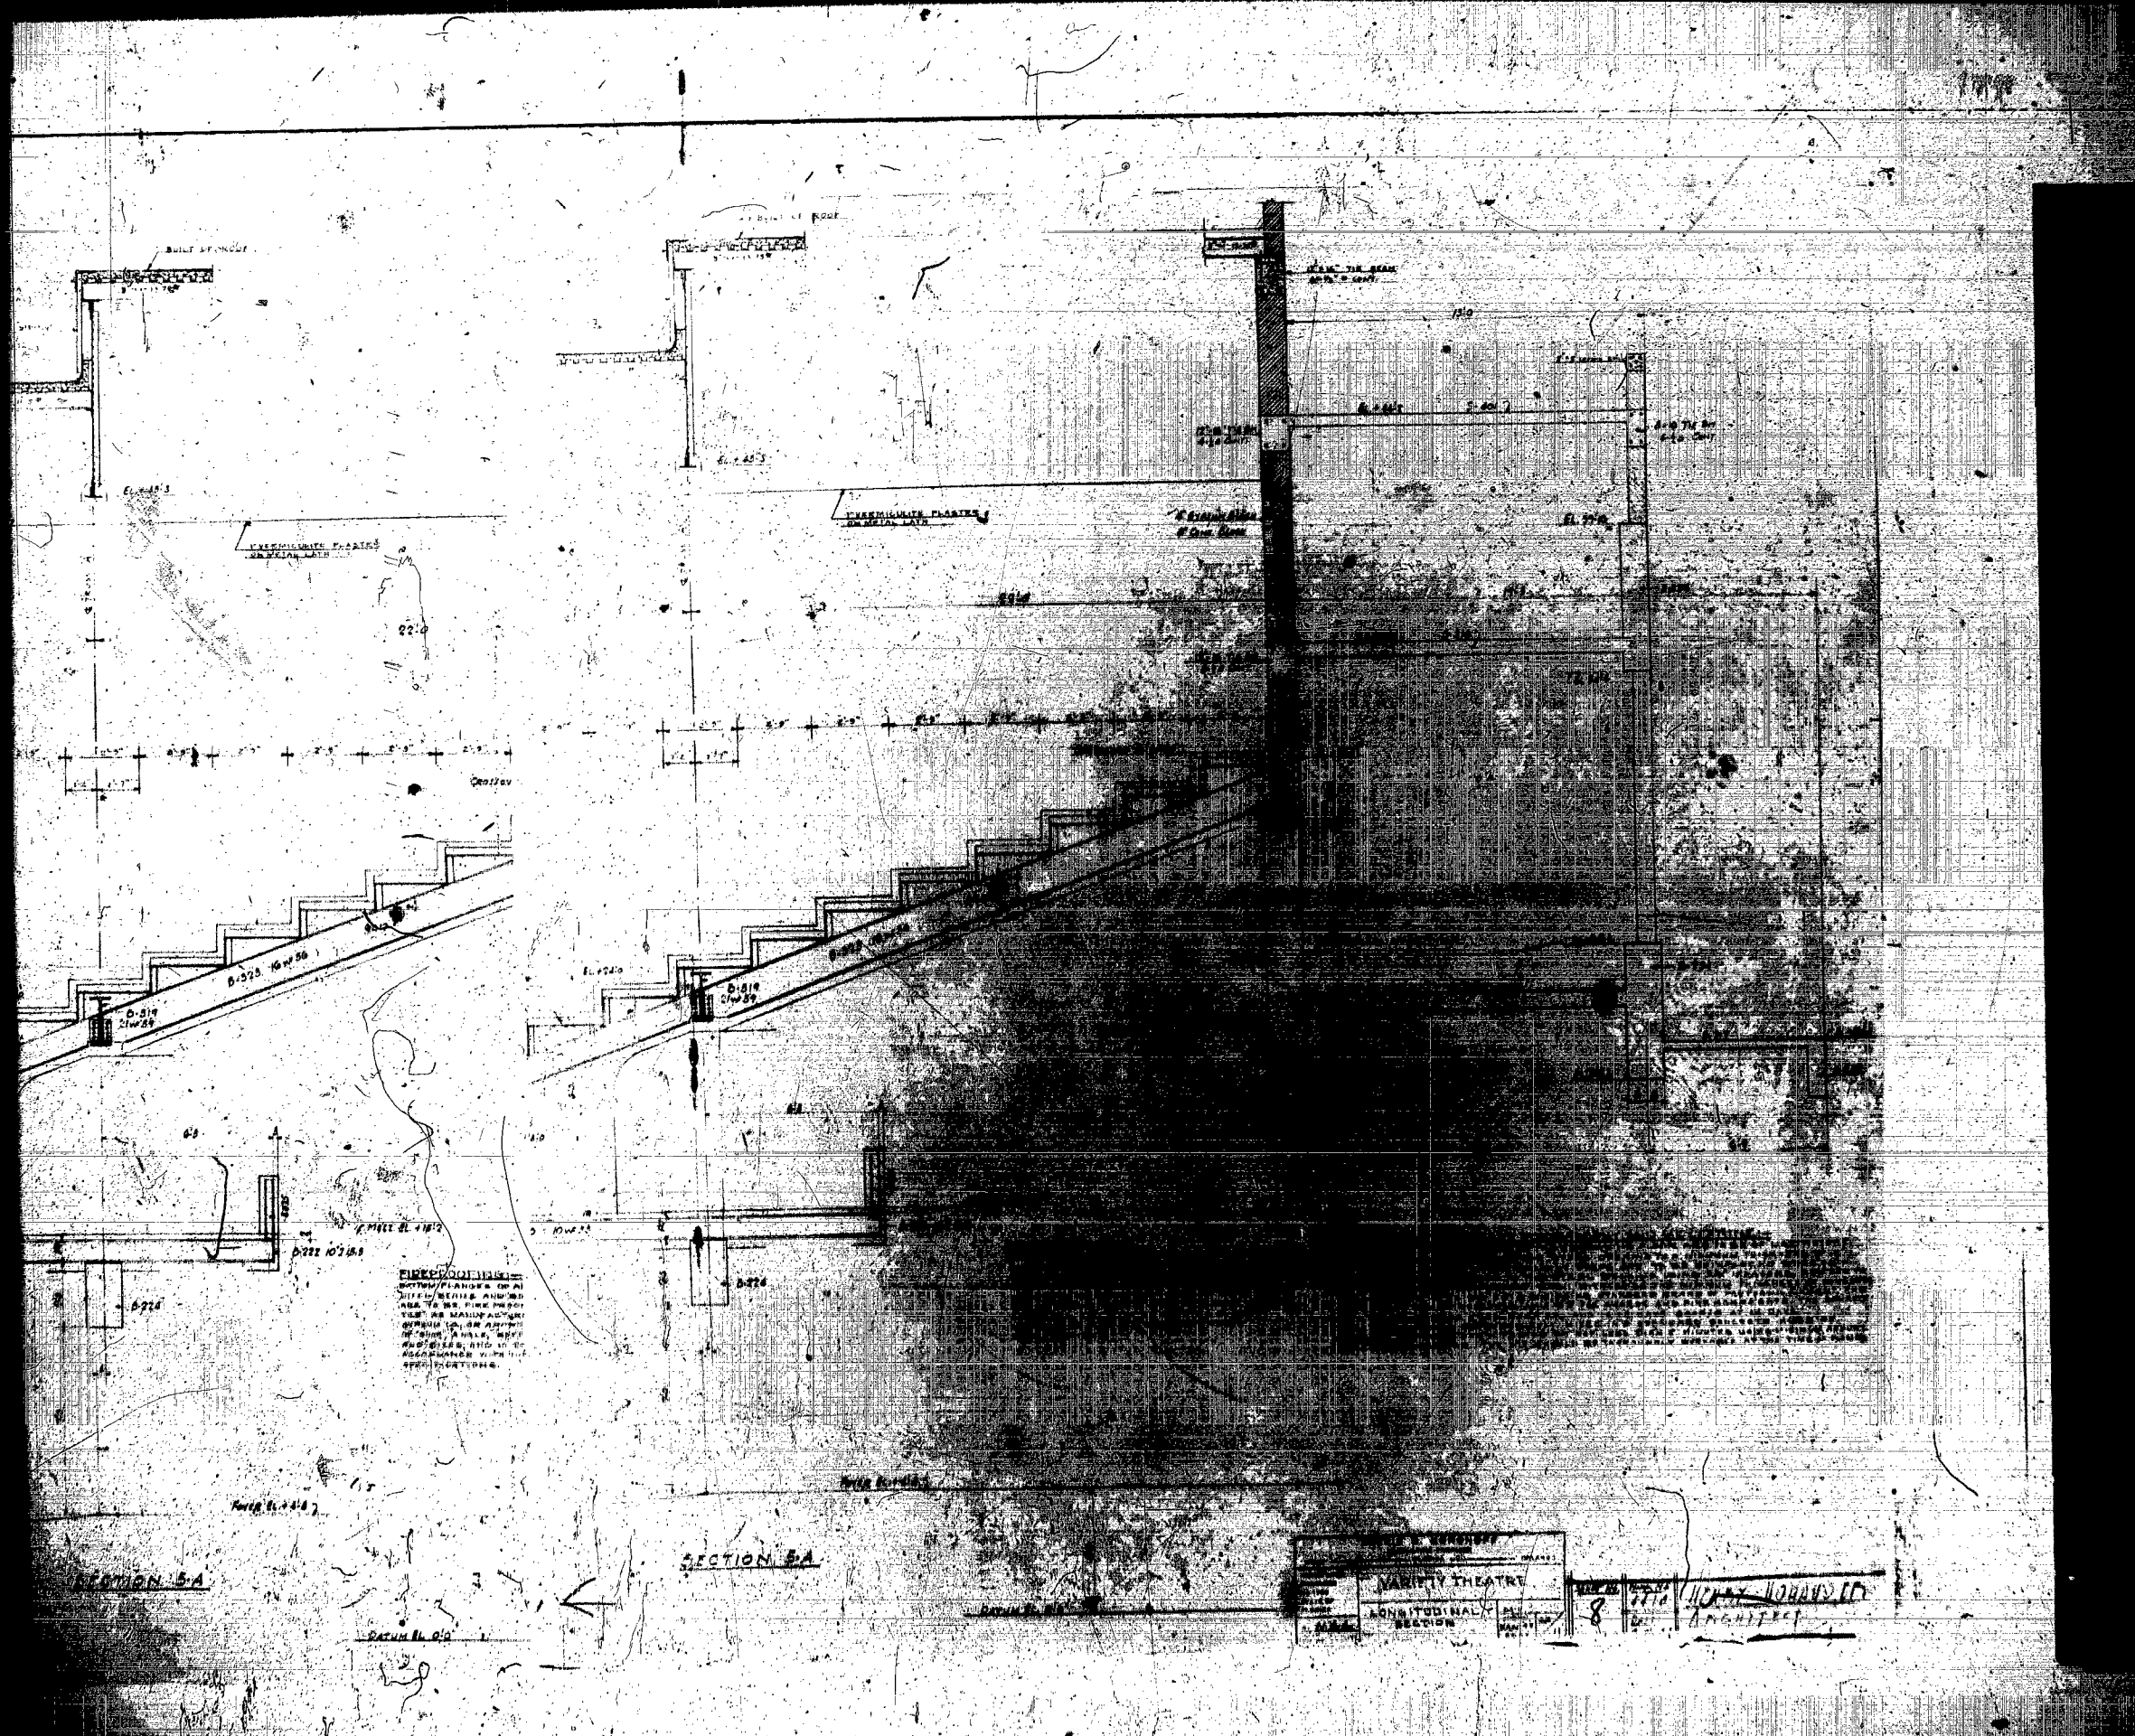

FIRE ESCAPE:
THIS ESCAPE IS TO BE USED IN CASE OF FIRE AND IS TO BE KEPT CLEAR AT ALL TIMES. IT IS TO BE USED ONLY FOR THE PURPOSES INTENDED AND IS NOT TO BE USED FOR ANY OTHER PURPOSE. IT IS TO BE KEPT CLEAR AT ALL TIMES AND IS NOT TO BE USED FOR ANY OTHER PURPOSE.


ALL DIMENSIONS ARE IN FEET AND INCHES UNLESS OTHERWISE SPECIFIED.
ALL WORK TO BE IN ACCORDANCE WITH THE REQUIREMENTS OF THE LOCAL BUILDING DEPARTMENT.
ALL MATERIALS TO BE OF THE BEST QUALITY AND AVAILABLE.
ALL WORKMANSHIP TO BE FIRST CLASS.

SECTION 5A


SECTION 5A

PROJECT	THEATRE
ARCHITECT	HOWE HOWARD CO.
NO.	8
DATE	


HOWE HOWARD CO.
ARCHITECTS

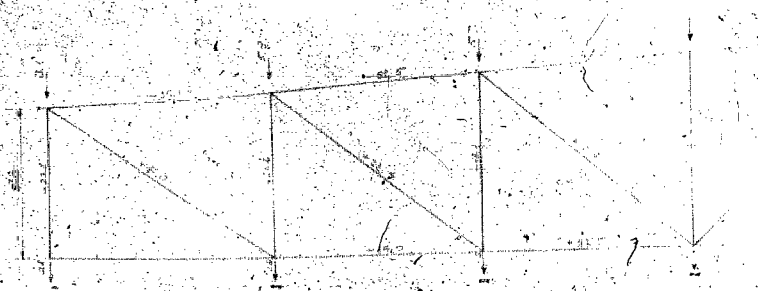

LOADING & STRESSES IN TRUSS A

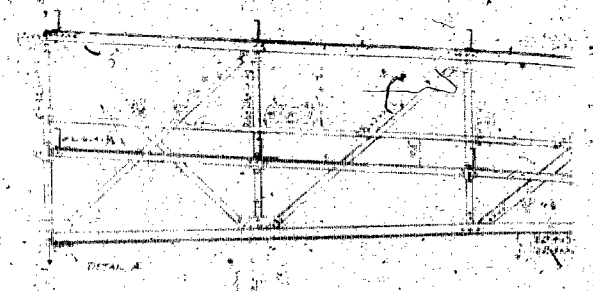

Detail A

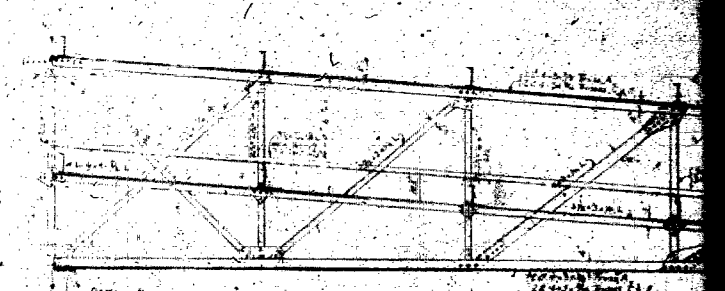


Detail A

TRUSS A C & E




LOADING & STRESSES IN TRUSS B C & D

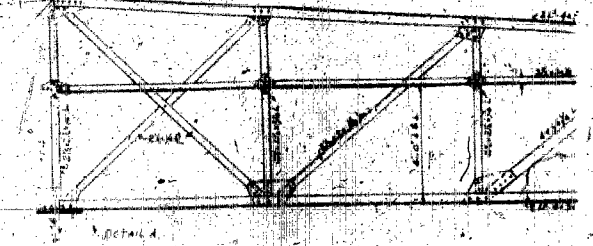


Detail A


TRUSS B C & D

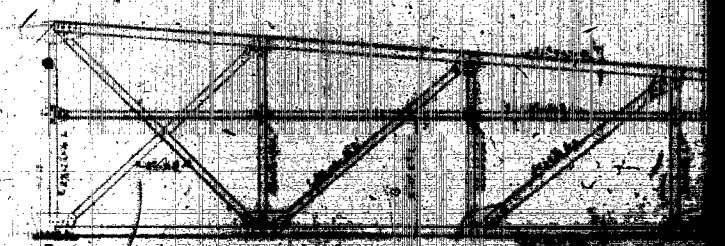

Detail A

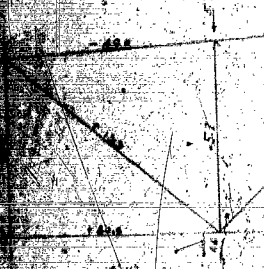

LOADING & STRESSES IN TRUSS C

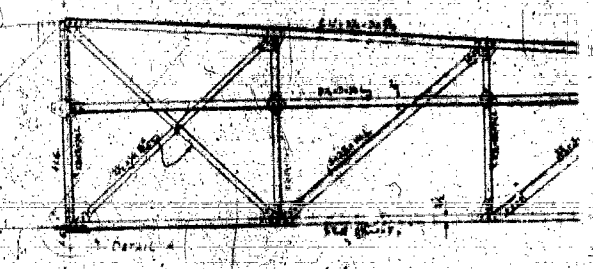


Detail A

TRUSS C



Detail A

TRUSS C









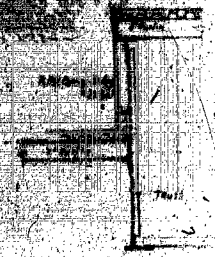


TYPICAL EDGE SECTION
Scale 1/2" = 1'-0"



STANDARD SPECIFICATIONS FOR STEEL BRIDGE DECK GIRDS
 1. GENERAL
 2. MATERIALS
 3. FABRICATION
 4. PAINTING
 5. TESTING
 6. DELIVERY
 7. INSPECTION
 8. REPAIRS


Scale 1/2" = 1'-0"

Scale 1/2" = 1'-0"

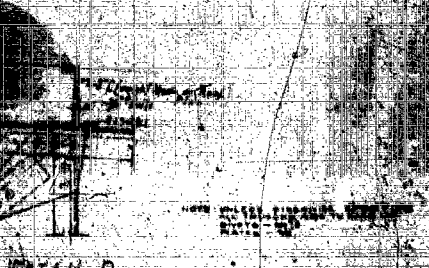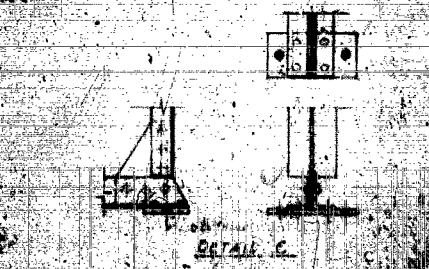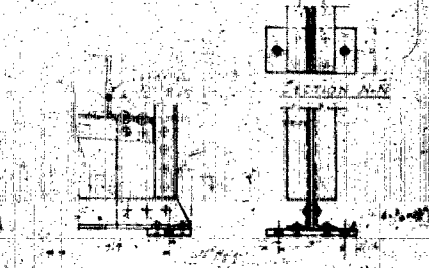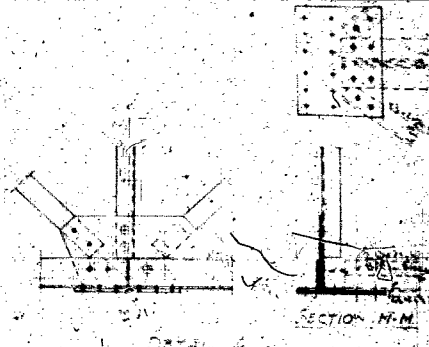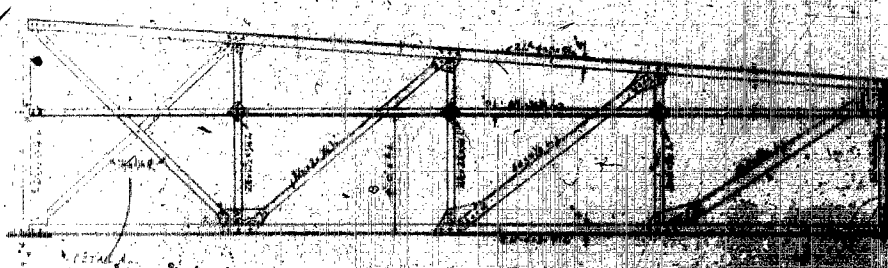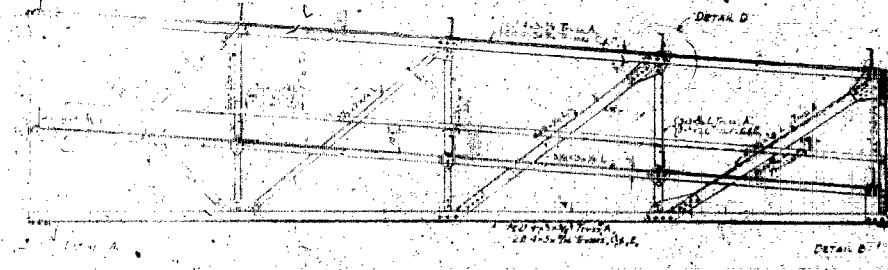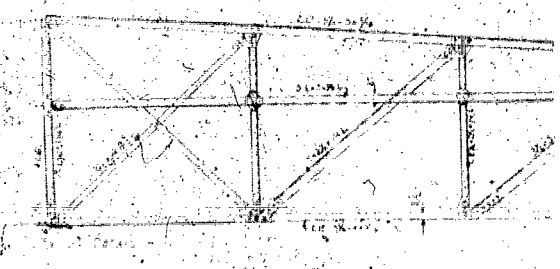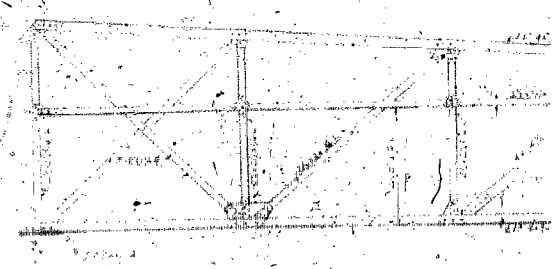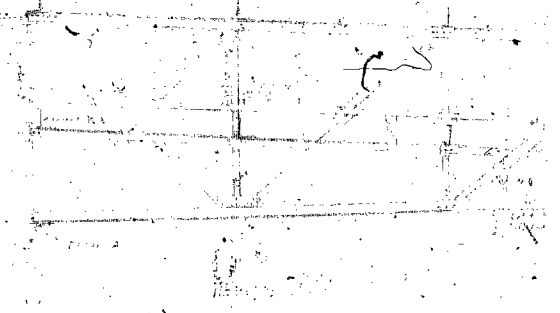

ALBERT W. KORNST		ARCHITECT	
VARIETY THEATRE			
ROOF TRUSSES		7	W. H. HOWARD
SECTION		0	1910

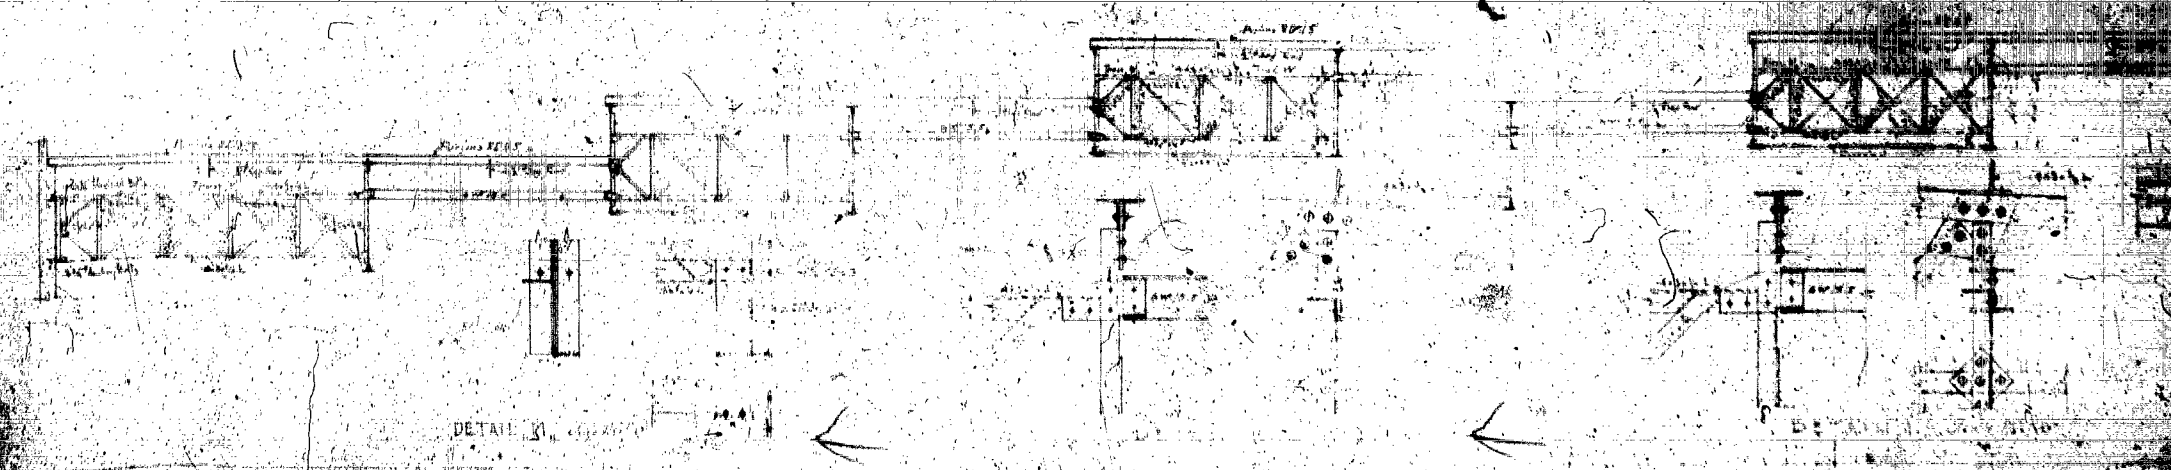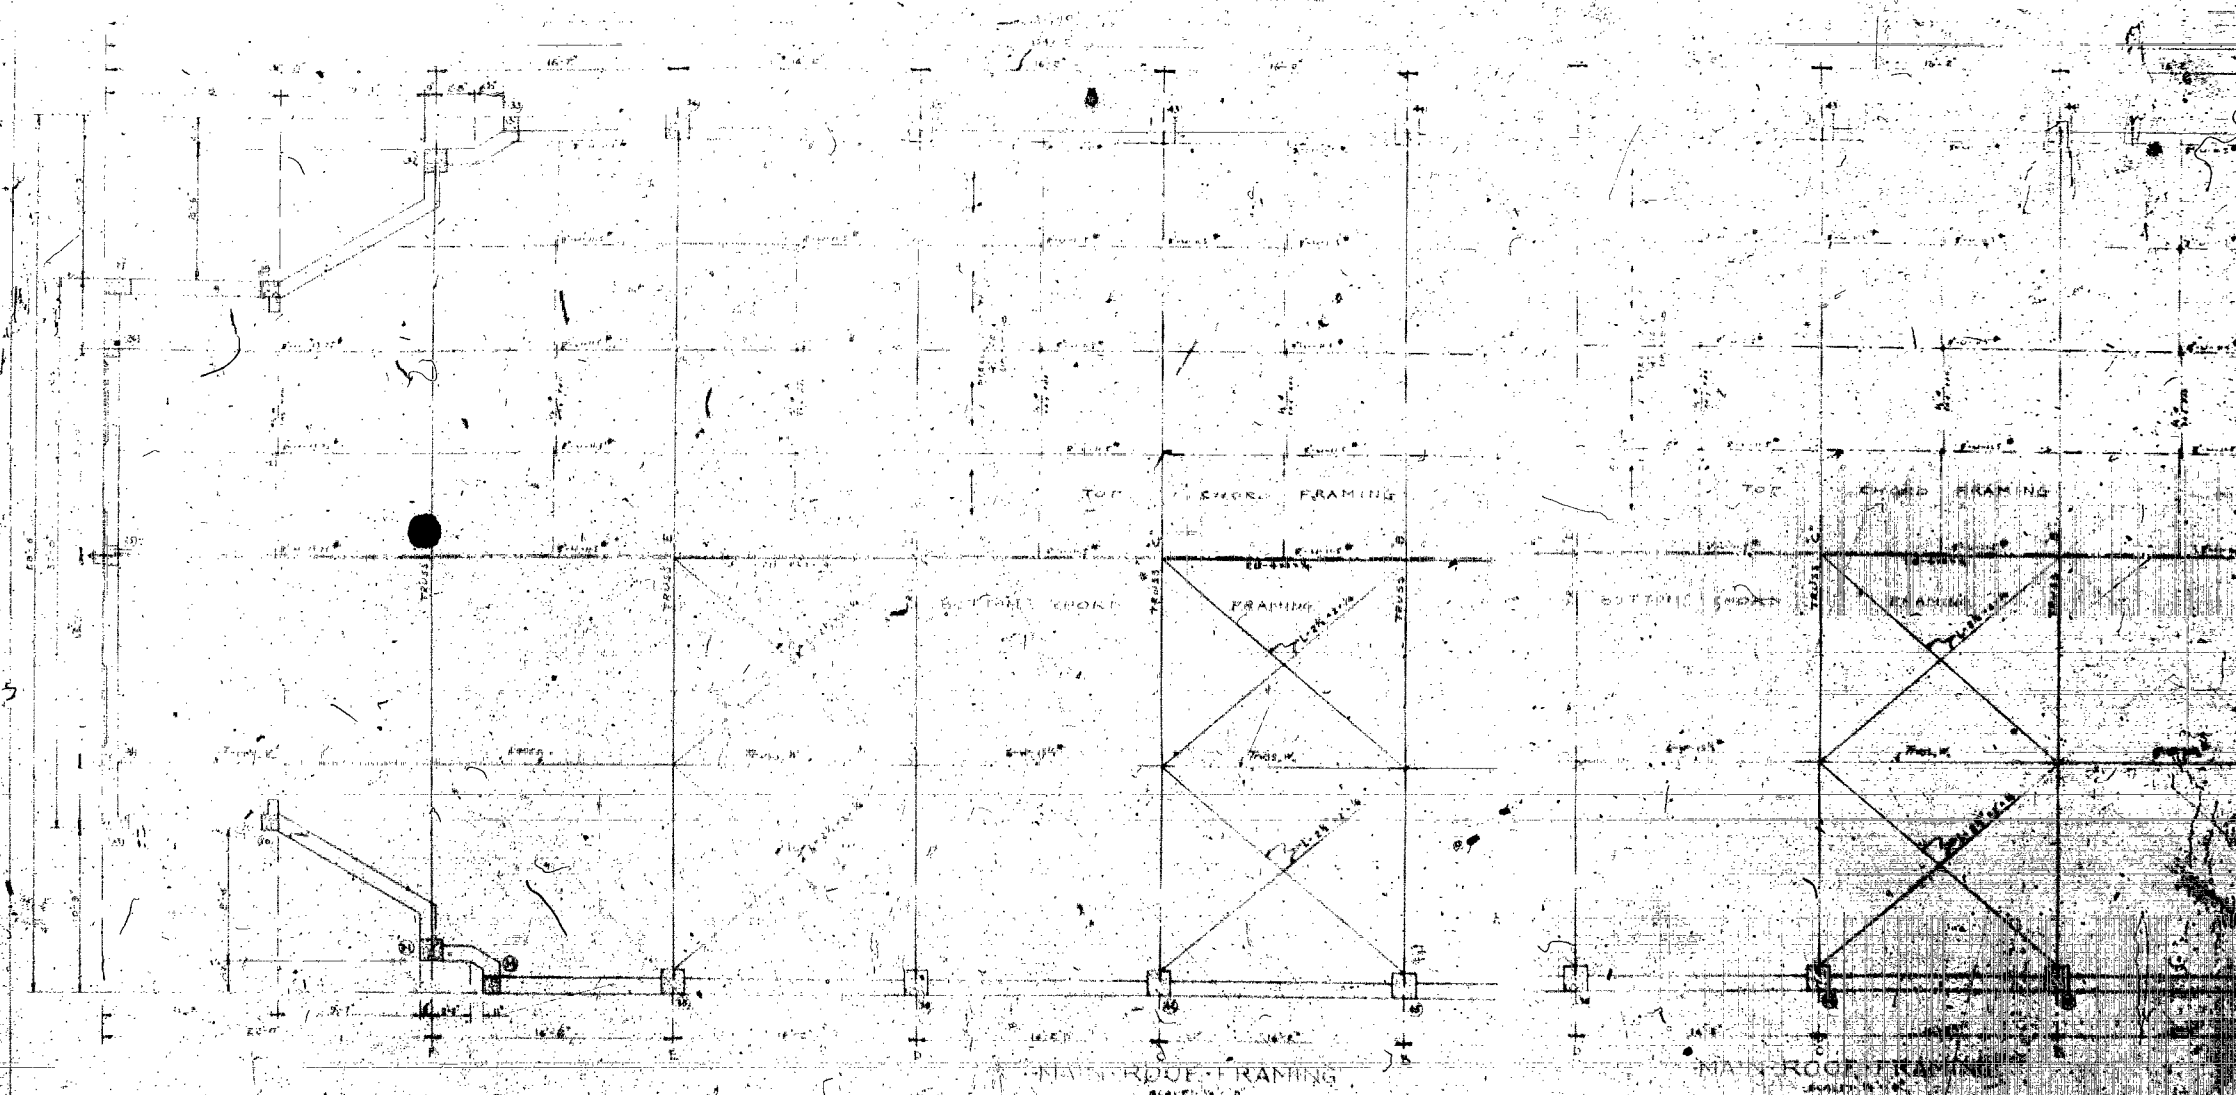

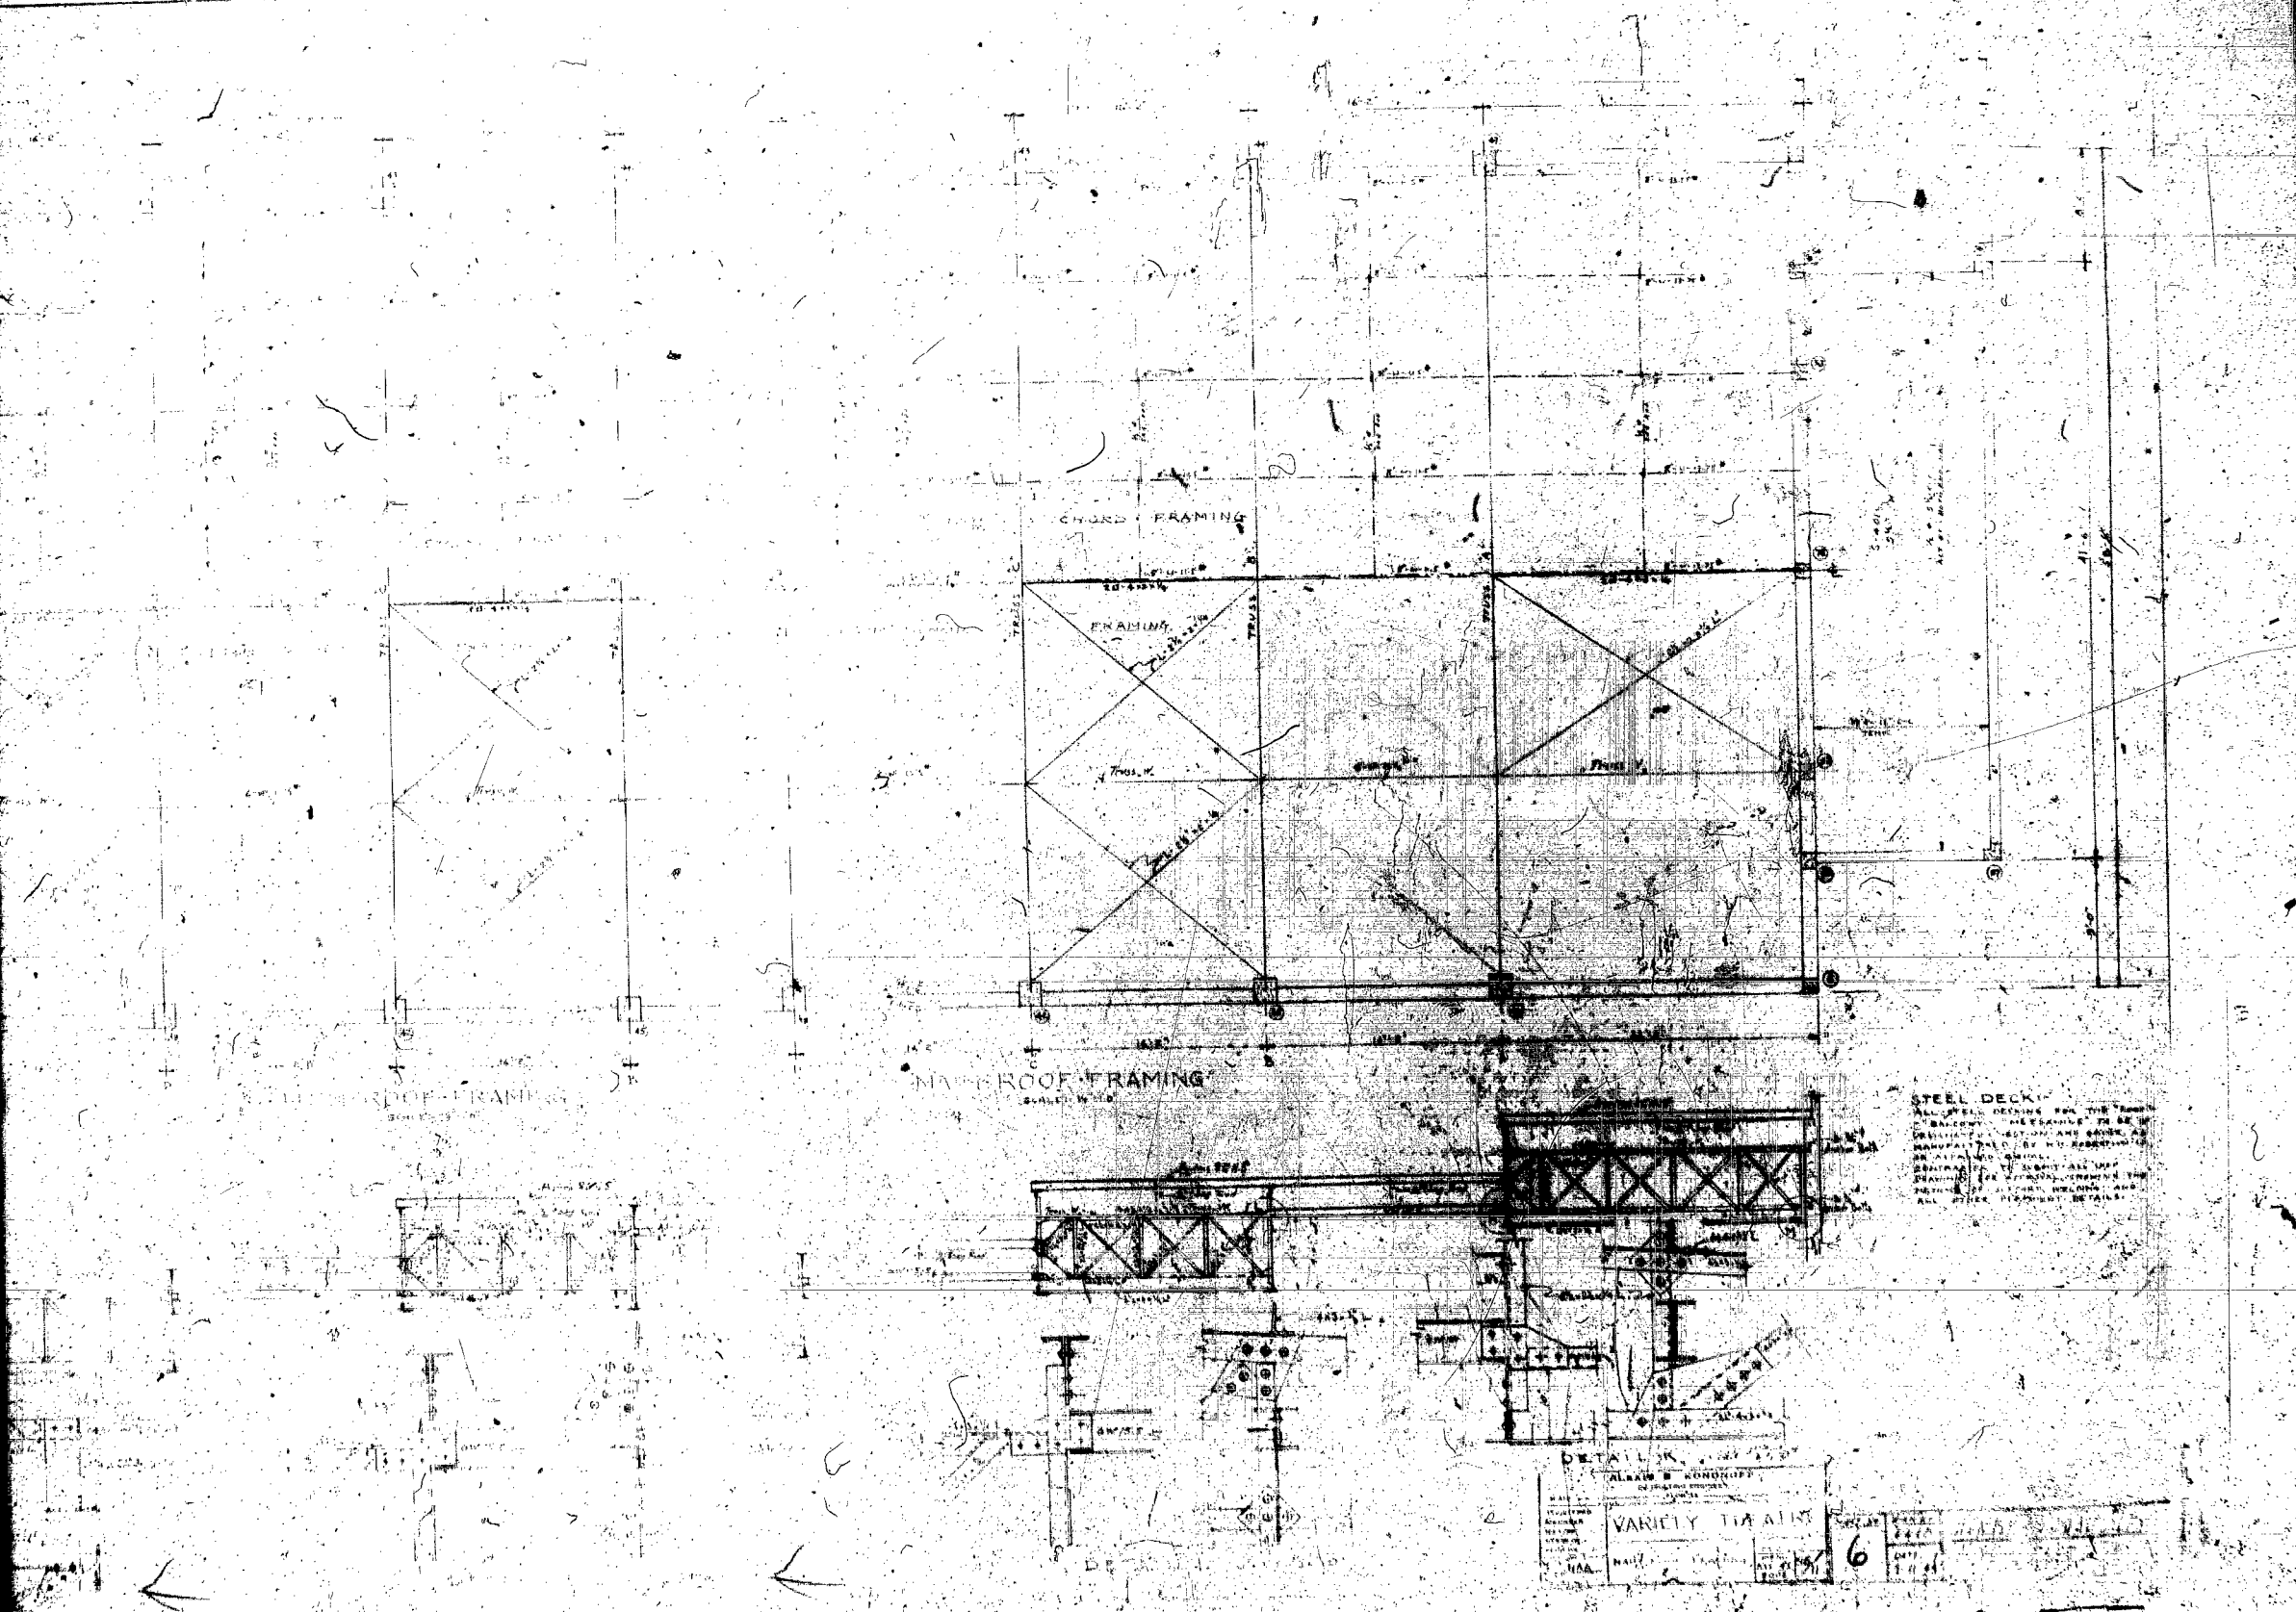


CHORD FRAMING

FRAMING

MAIN ROOF FRAMING

STEEL DECK
 ALL STEEL DECKING FOR THE TRUSS
 SYSTEMS IS TO BE MANUFACTURED
 IN ACCORDANCE WITH THE
 REQUIREMENTS OF THE
 AMERICAN INSTITUTE OF STEEL CONSTRUCTION
 INC. (AISC) SPECIFICATION FOR
 STRUCTURAL STEEL BUILDINGS
 AND ALL OTHER RELEVANT DETAILS.

DETAILS		NO. 6	
VARIETY TRAINING			
DATE	BY	CHECKED	DATE
1/1/41	J. H. H.	J. H. H.	1/1/41

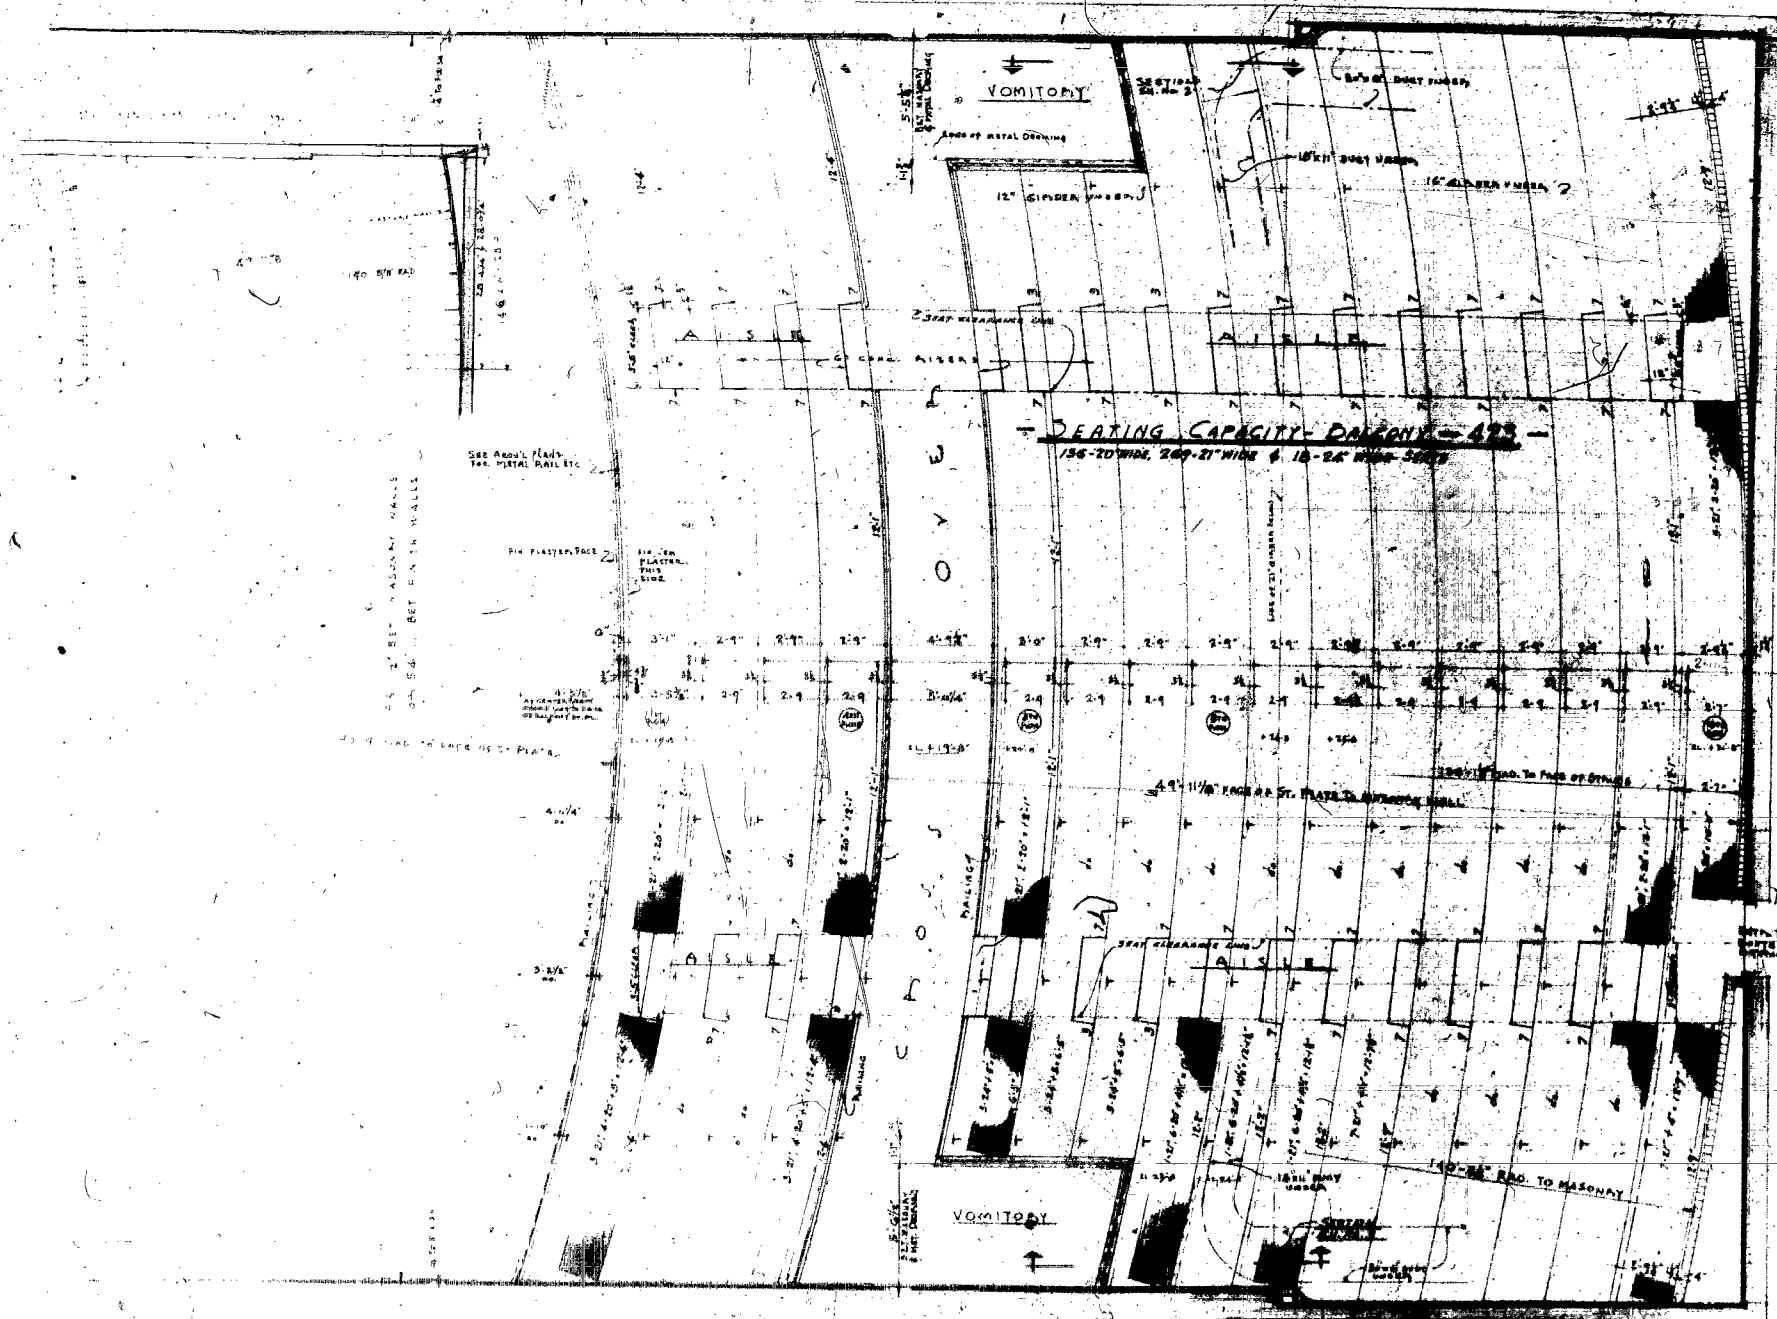


BALCONY PLAN -
 SEATING & AISLES ARRANGEMENT -
 SCALE 1/8" = 1'-0"

NOTE: FOR LONGITUDINAL SECTION AT 4 BLENDED ORGANIZATION SEE SHEET 3.

HENRY HOHAUSER
 ARCHITECT
 4011 CHASE AVENUE
 MIAMI BEACH 40 FLA.

SHEET NO. 2
 JOB NO. 441A
 DATE: 5-1-44

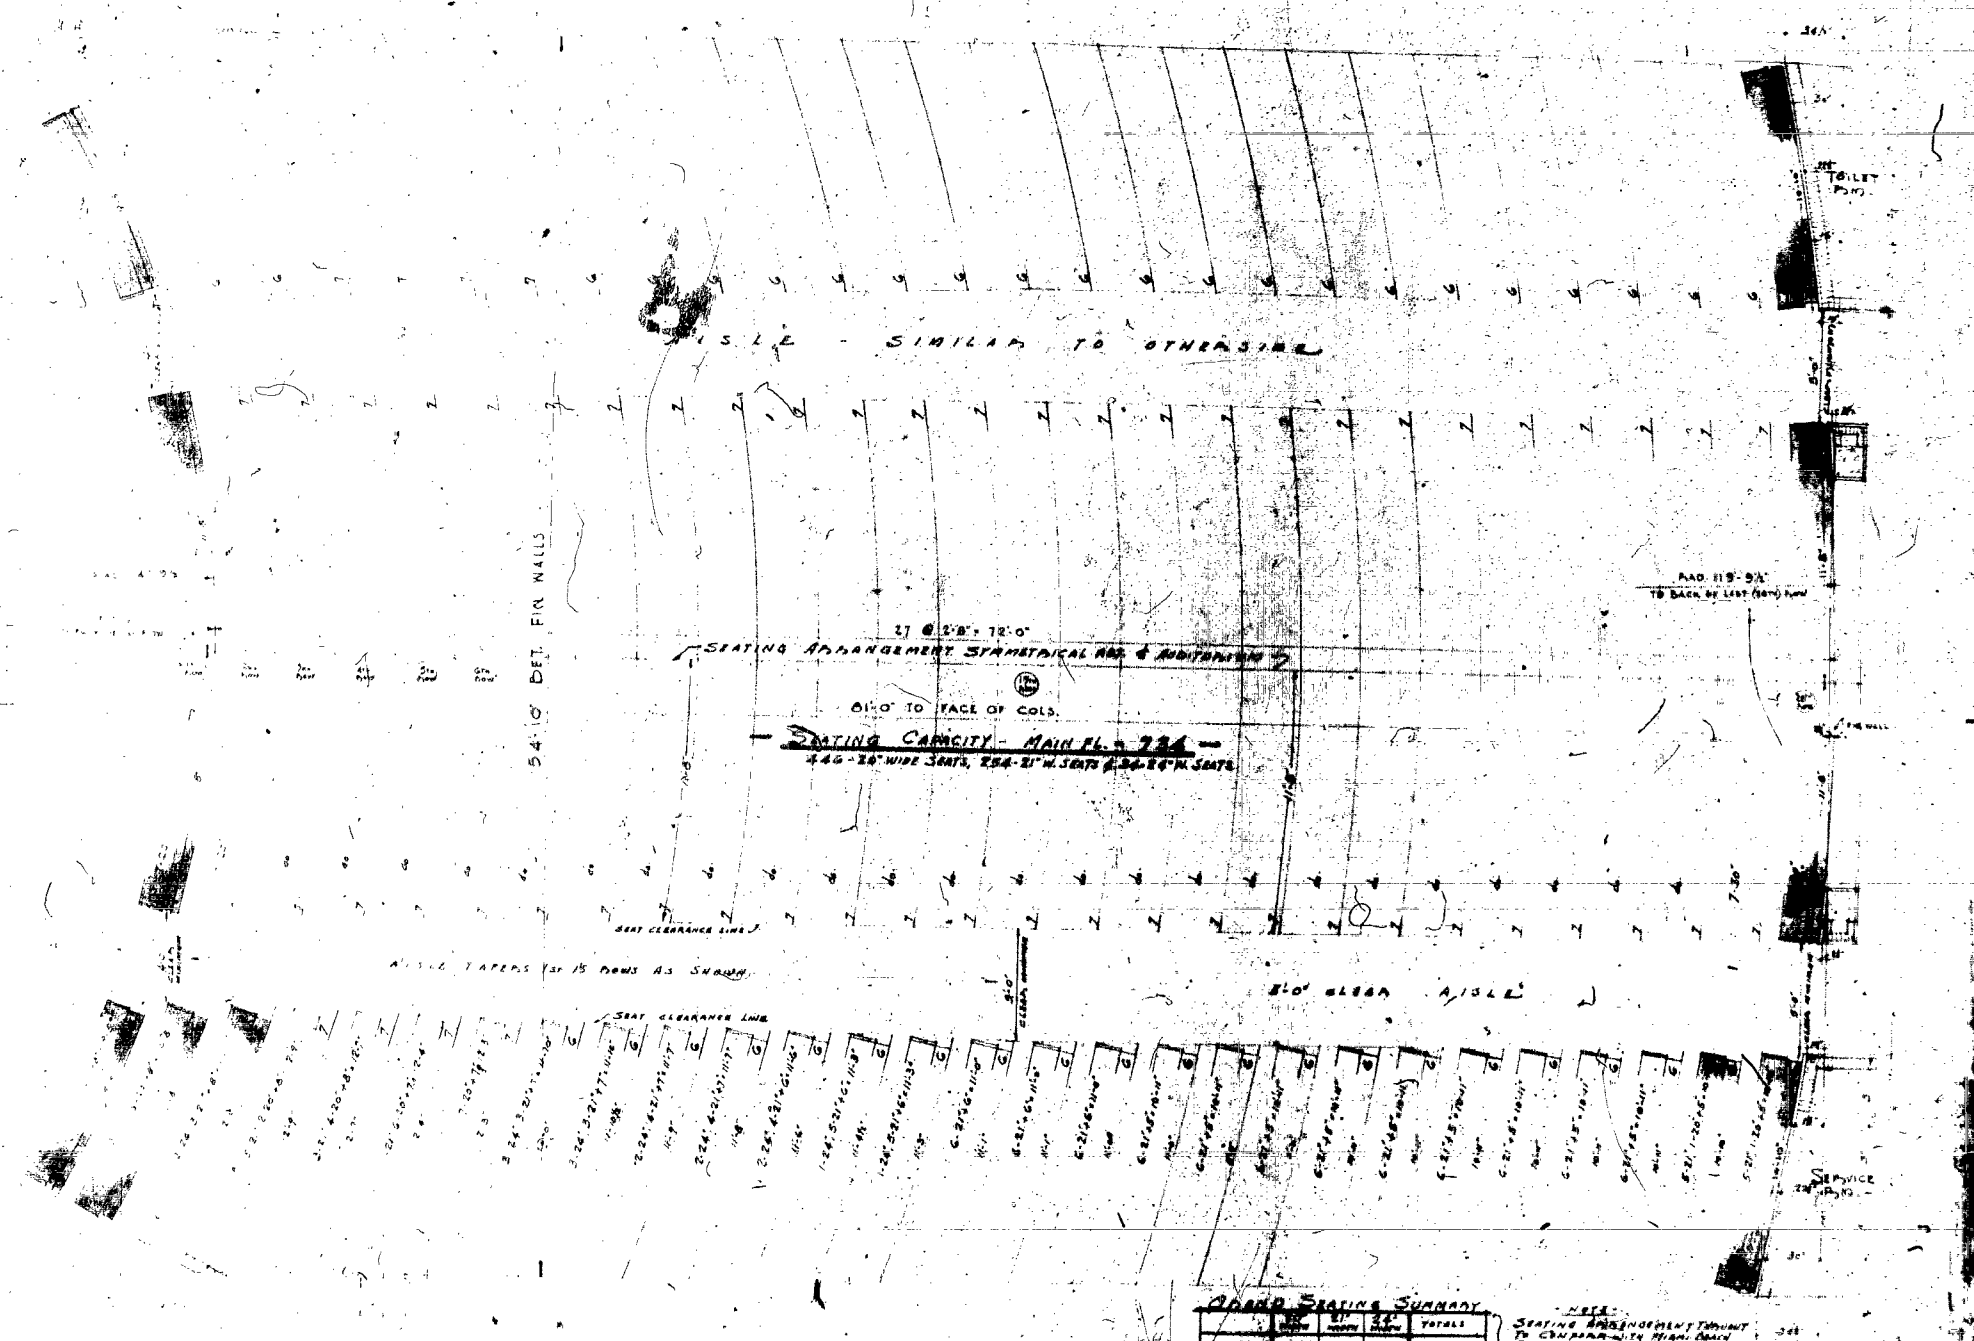

ORCHESTRA FLOOR PLAN
SEATING & AISLES ARRANGEMENT

SCALE 3/8" = 1'-0"



SEATING SUMMARY

SEAT	ST	ST	TOTALS
SEAT	446	254	700
STAIRS	136	269	405
TOTAL	582	923	1505



NOTE:
SEATING ARRANGEMENT SUBJECT TO CHANGE WITH HIGH BOARD BUILDING TYPE SEAT. MINIMUM SEAT PERMITTED - 80"

HENRY JOHNSON
ARCHITECT
4011 CHASE AVENUE
MIAMI BEACH 40, FLA.

PLAN NO. 4418
DATE 1-1-45

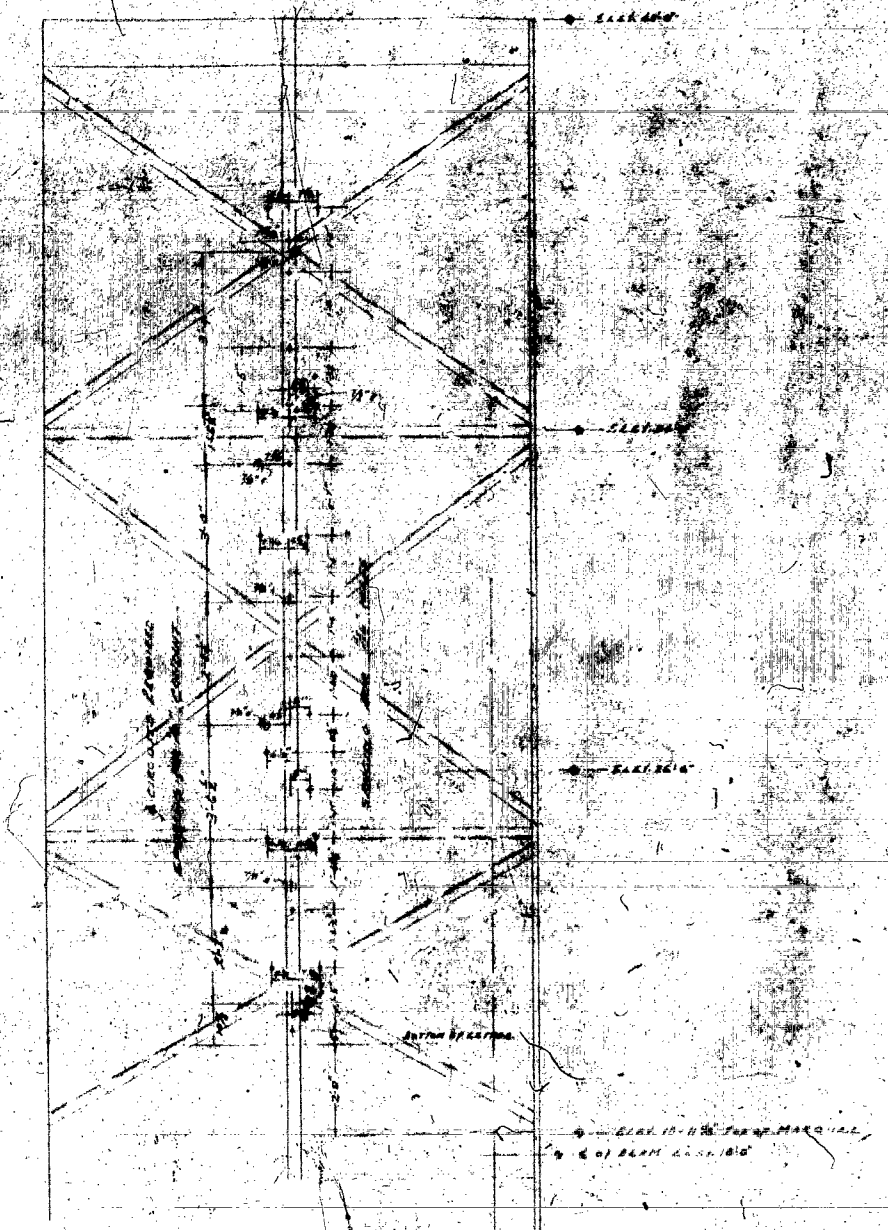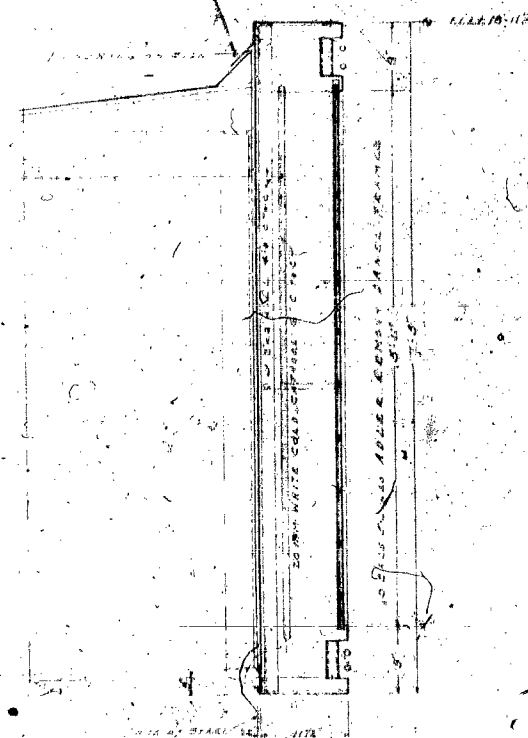


16
 SOCIETY OF ARCHITECTS
 110 N. BROAD ST.
 BALTON, PA. 17310
 177

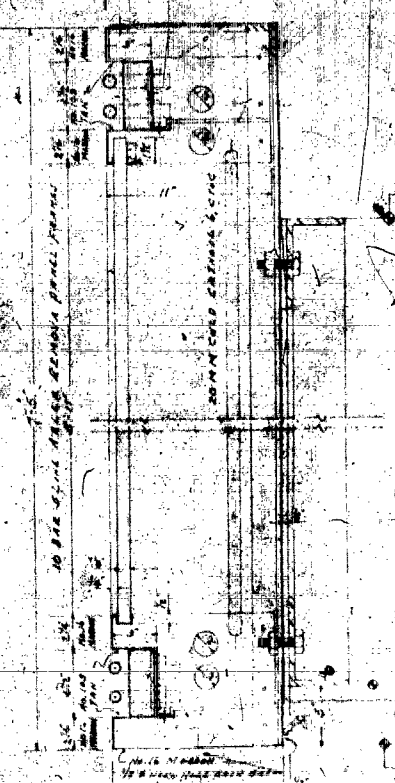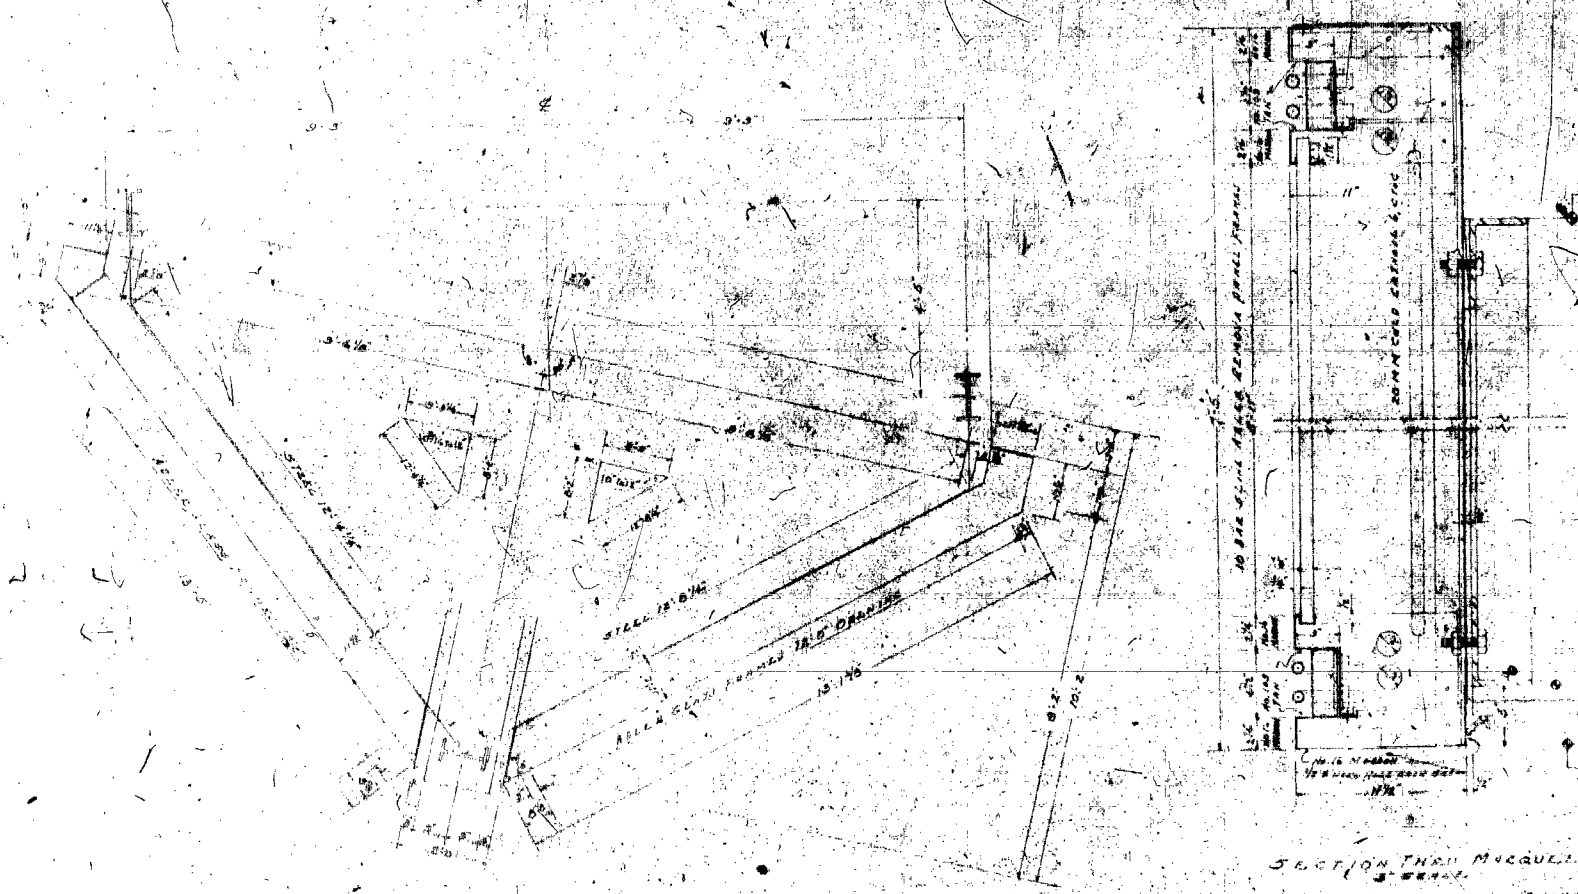


SECTION THROUGH MURQUET
 NOTE: FABRICATION CAN BE CHANGED
 TO QUALIFY FOR MORE RAPID
 SHIPMENT.


BALTON PATRICK 2417 28th Ave. ST. LOUIS, MO. 63114	
DATE: 11/1/54 DRAWN BY: J.P.P. CHECKED BY: J.P.P.	PROJECT NO.: SHEET NO.:

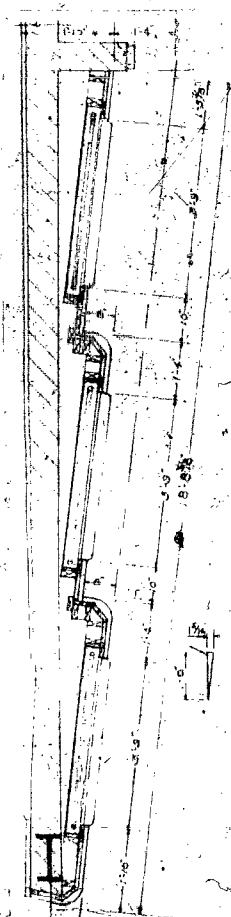


SCOPE OF WORK

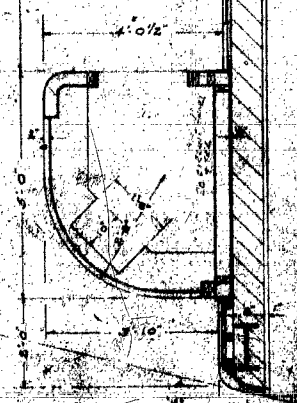

PLAN OF LOBBY WALL
1/4" SCALE

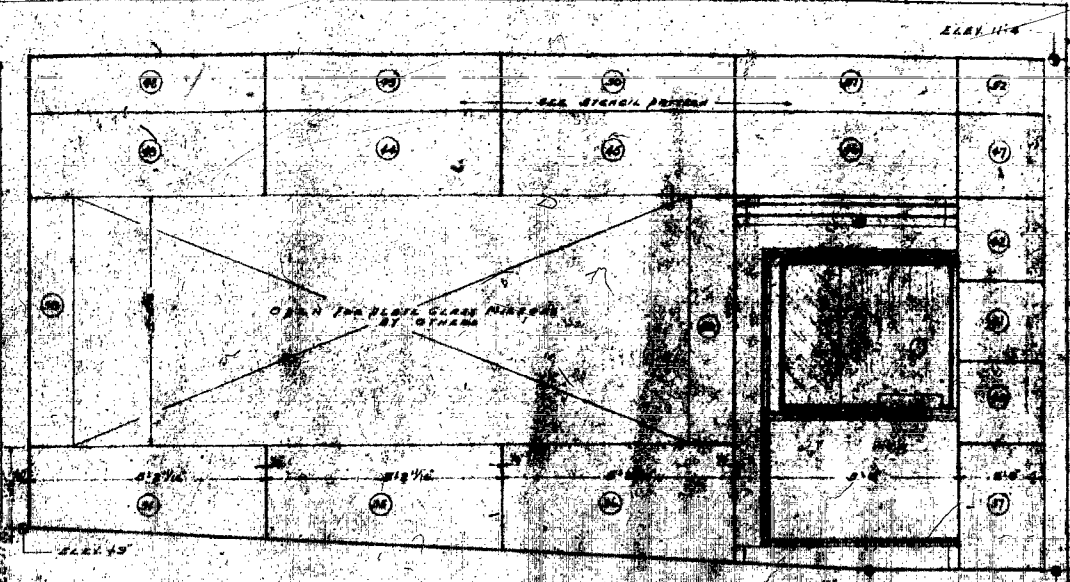


ELEVATION WEST LOBBY WALL

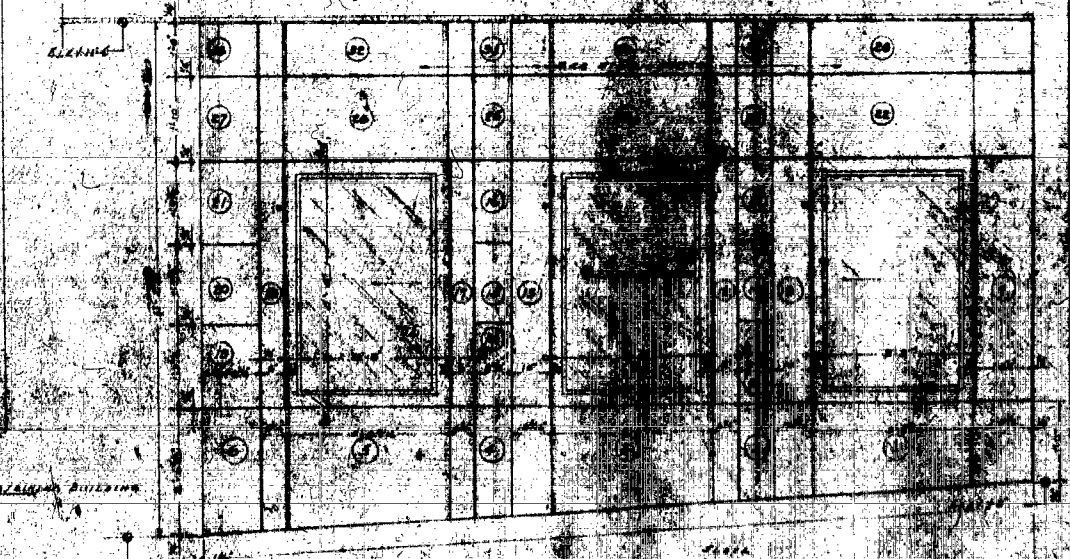

ELEVATION EAST LOBBY WALL


497
WALTER PATRICK
 ARCHITECTS
 1417
 418
 40

VARIETY

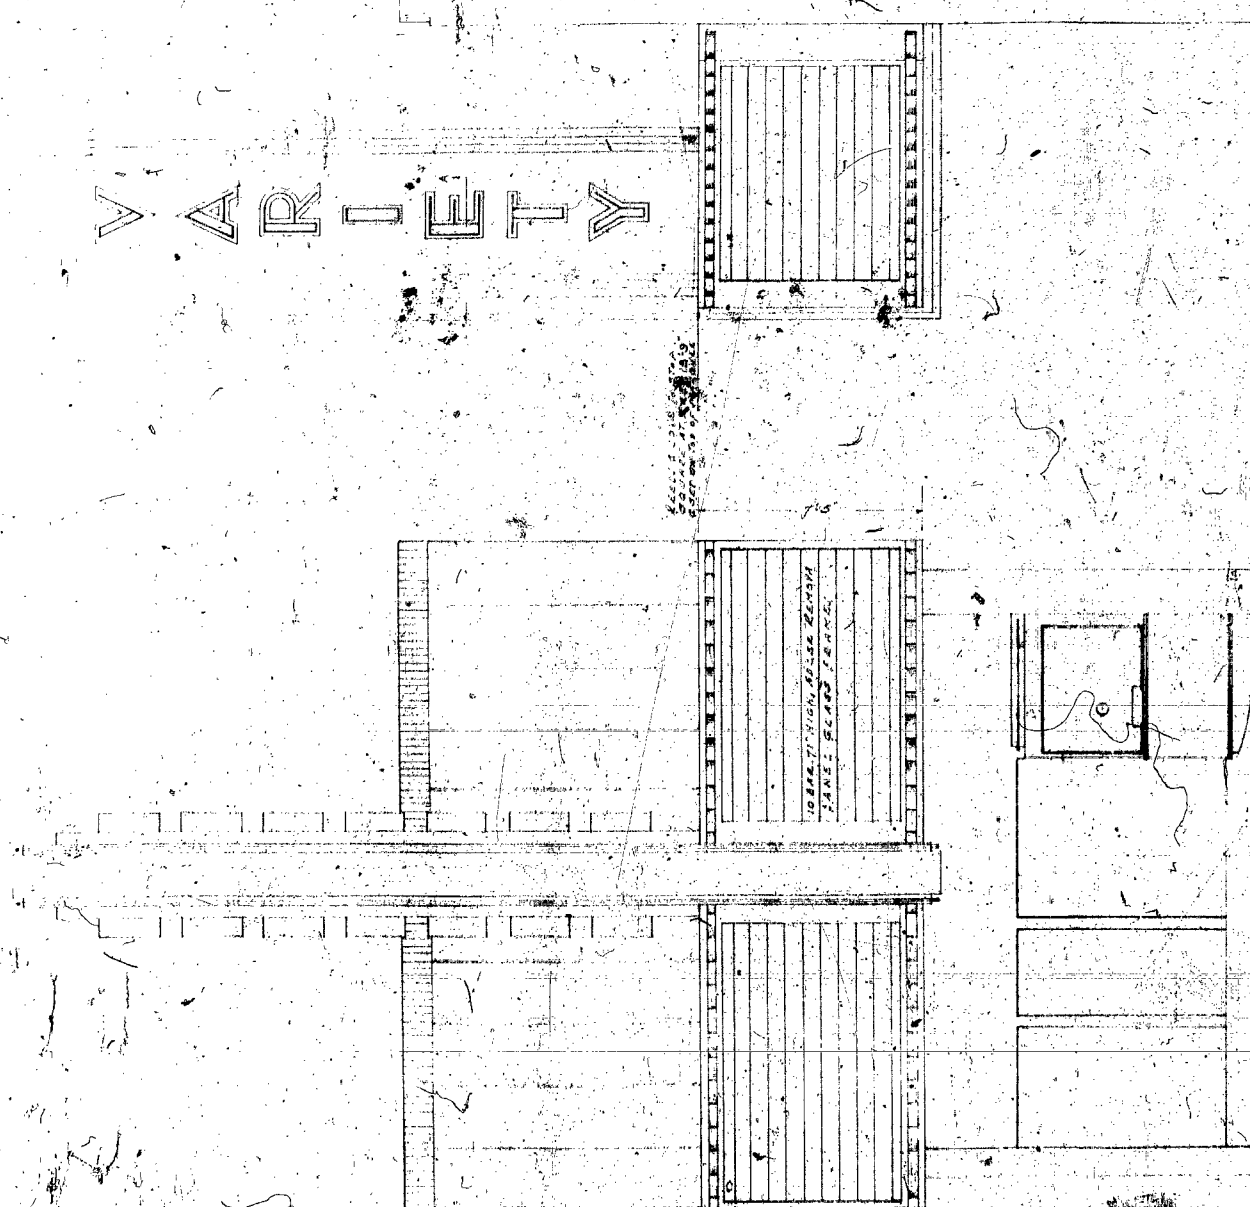

VIA ELEVATION

PROJECTIONS

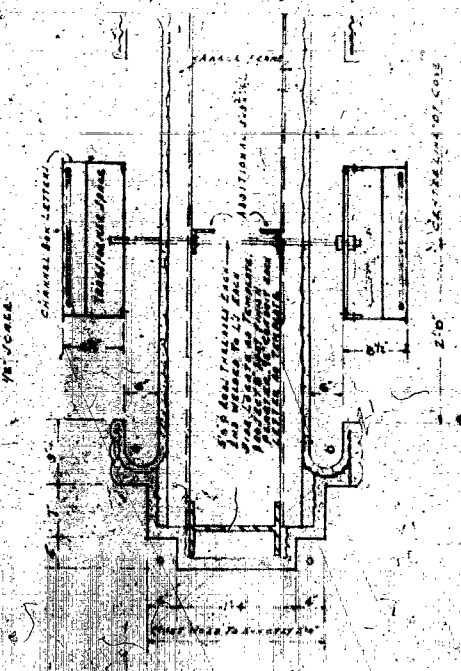

(13)

VARIETY THEATRE BARN
MIAMI, FLORIDA



BALTON PATRICK
ARCHITECT

1417 S. W. 11th St.
MIAMI, FLORIDA

1927

N O D A K S

V
A
R
I
E
T
Y

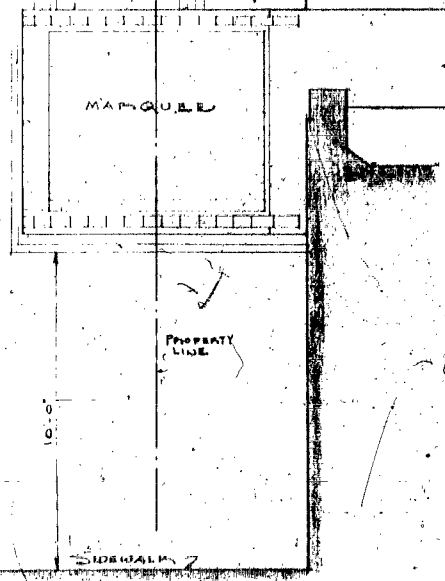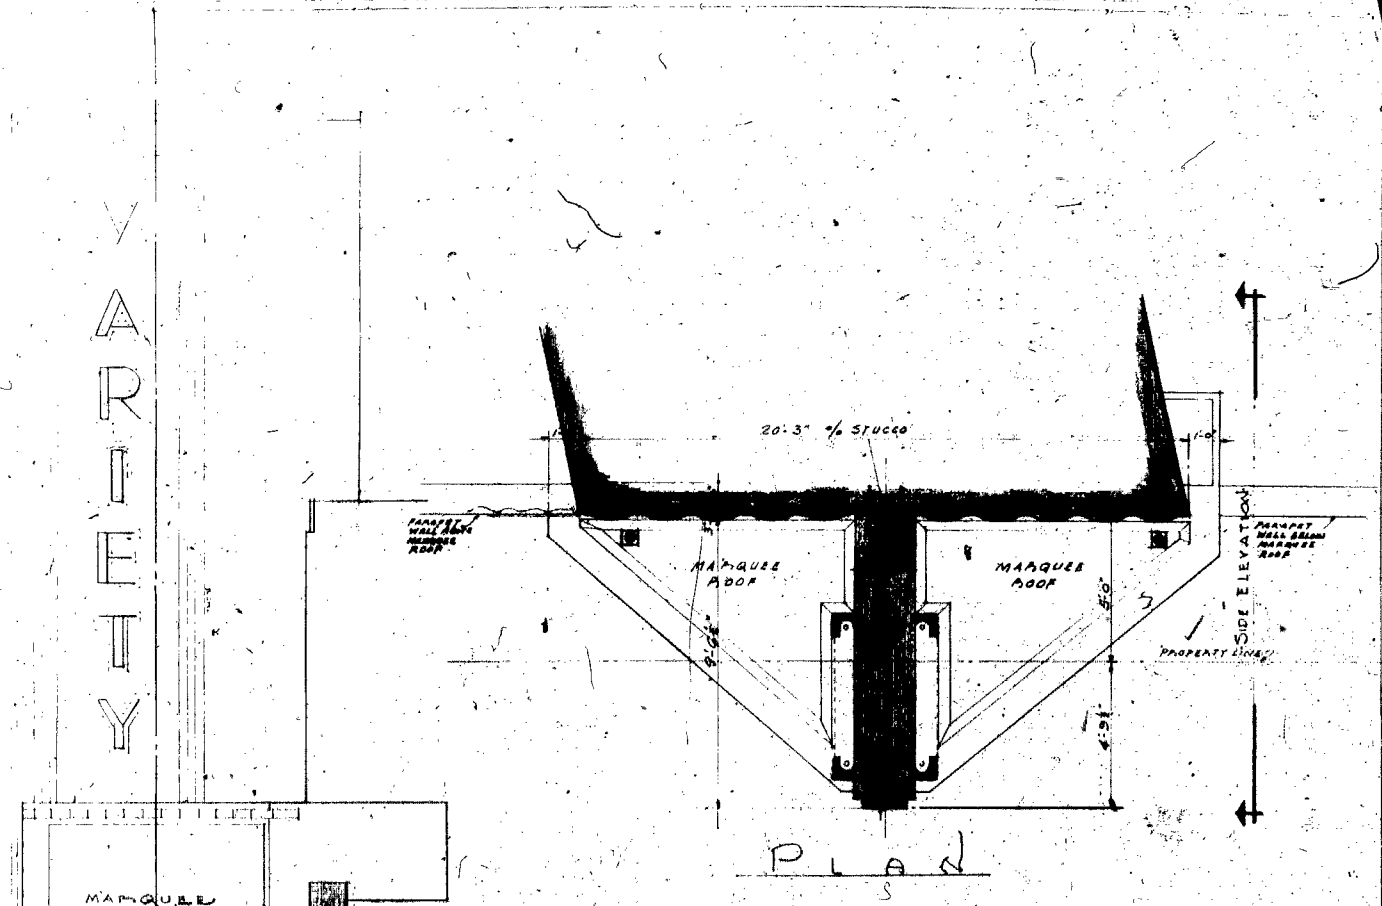



VARIETY THEATRE
MARQUEE & SIGN
SCALE 1/2" = 1'-0"

HENRY MOHAUSER
ARCHITECT
MIAMI BEACH, FLA.

SH. No. 4410
Job No. 4410
DATE MAY 1st 1946


BALTON PATRICK

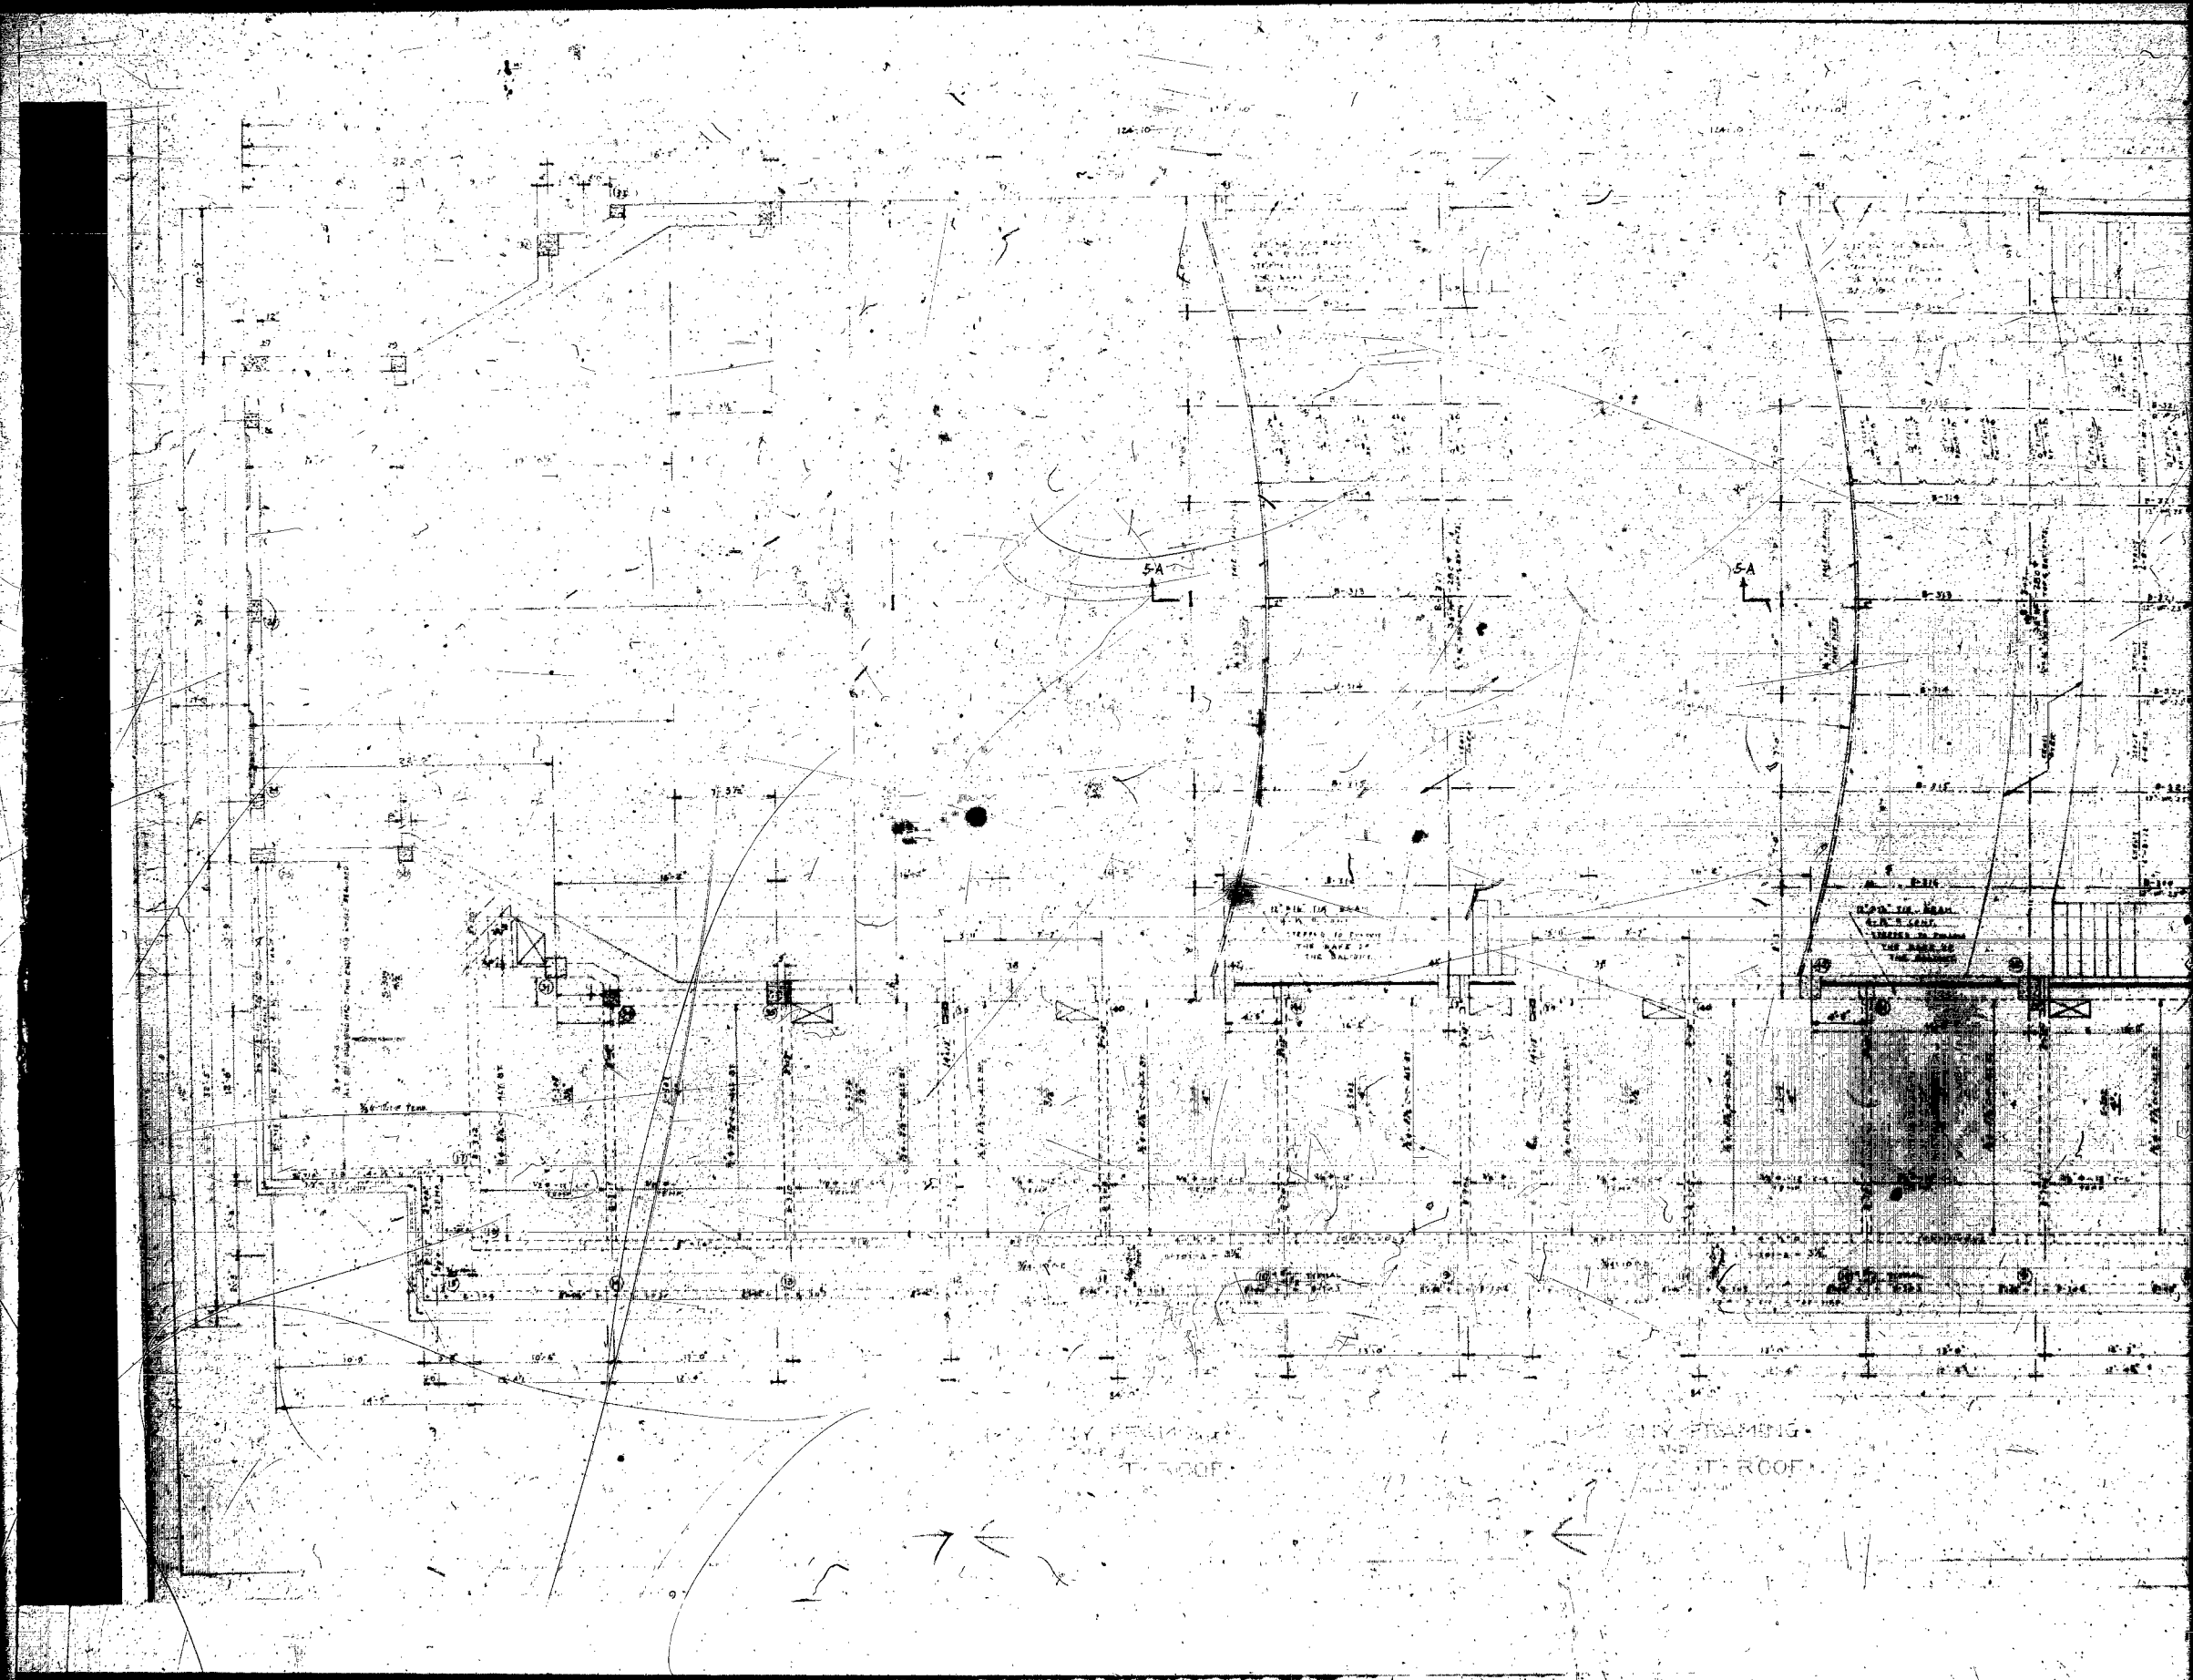

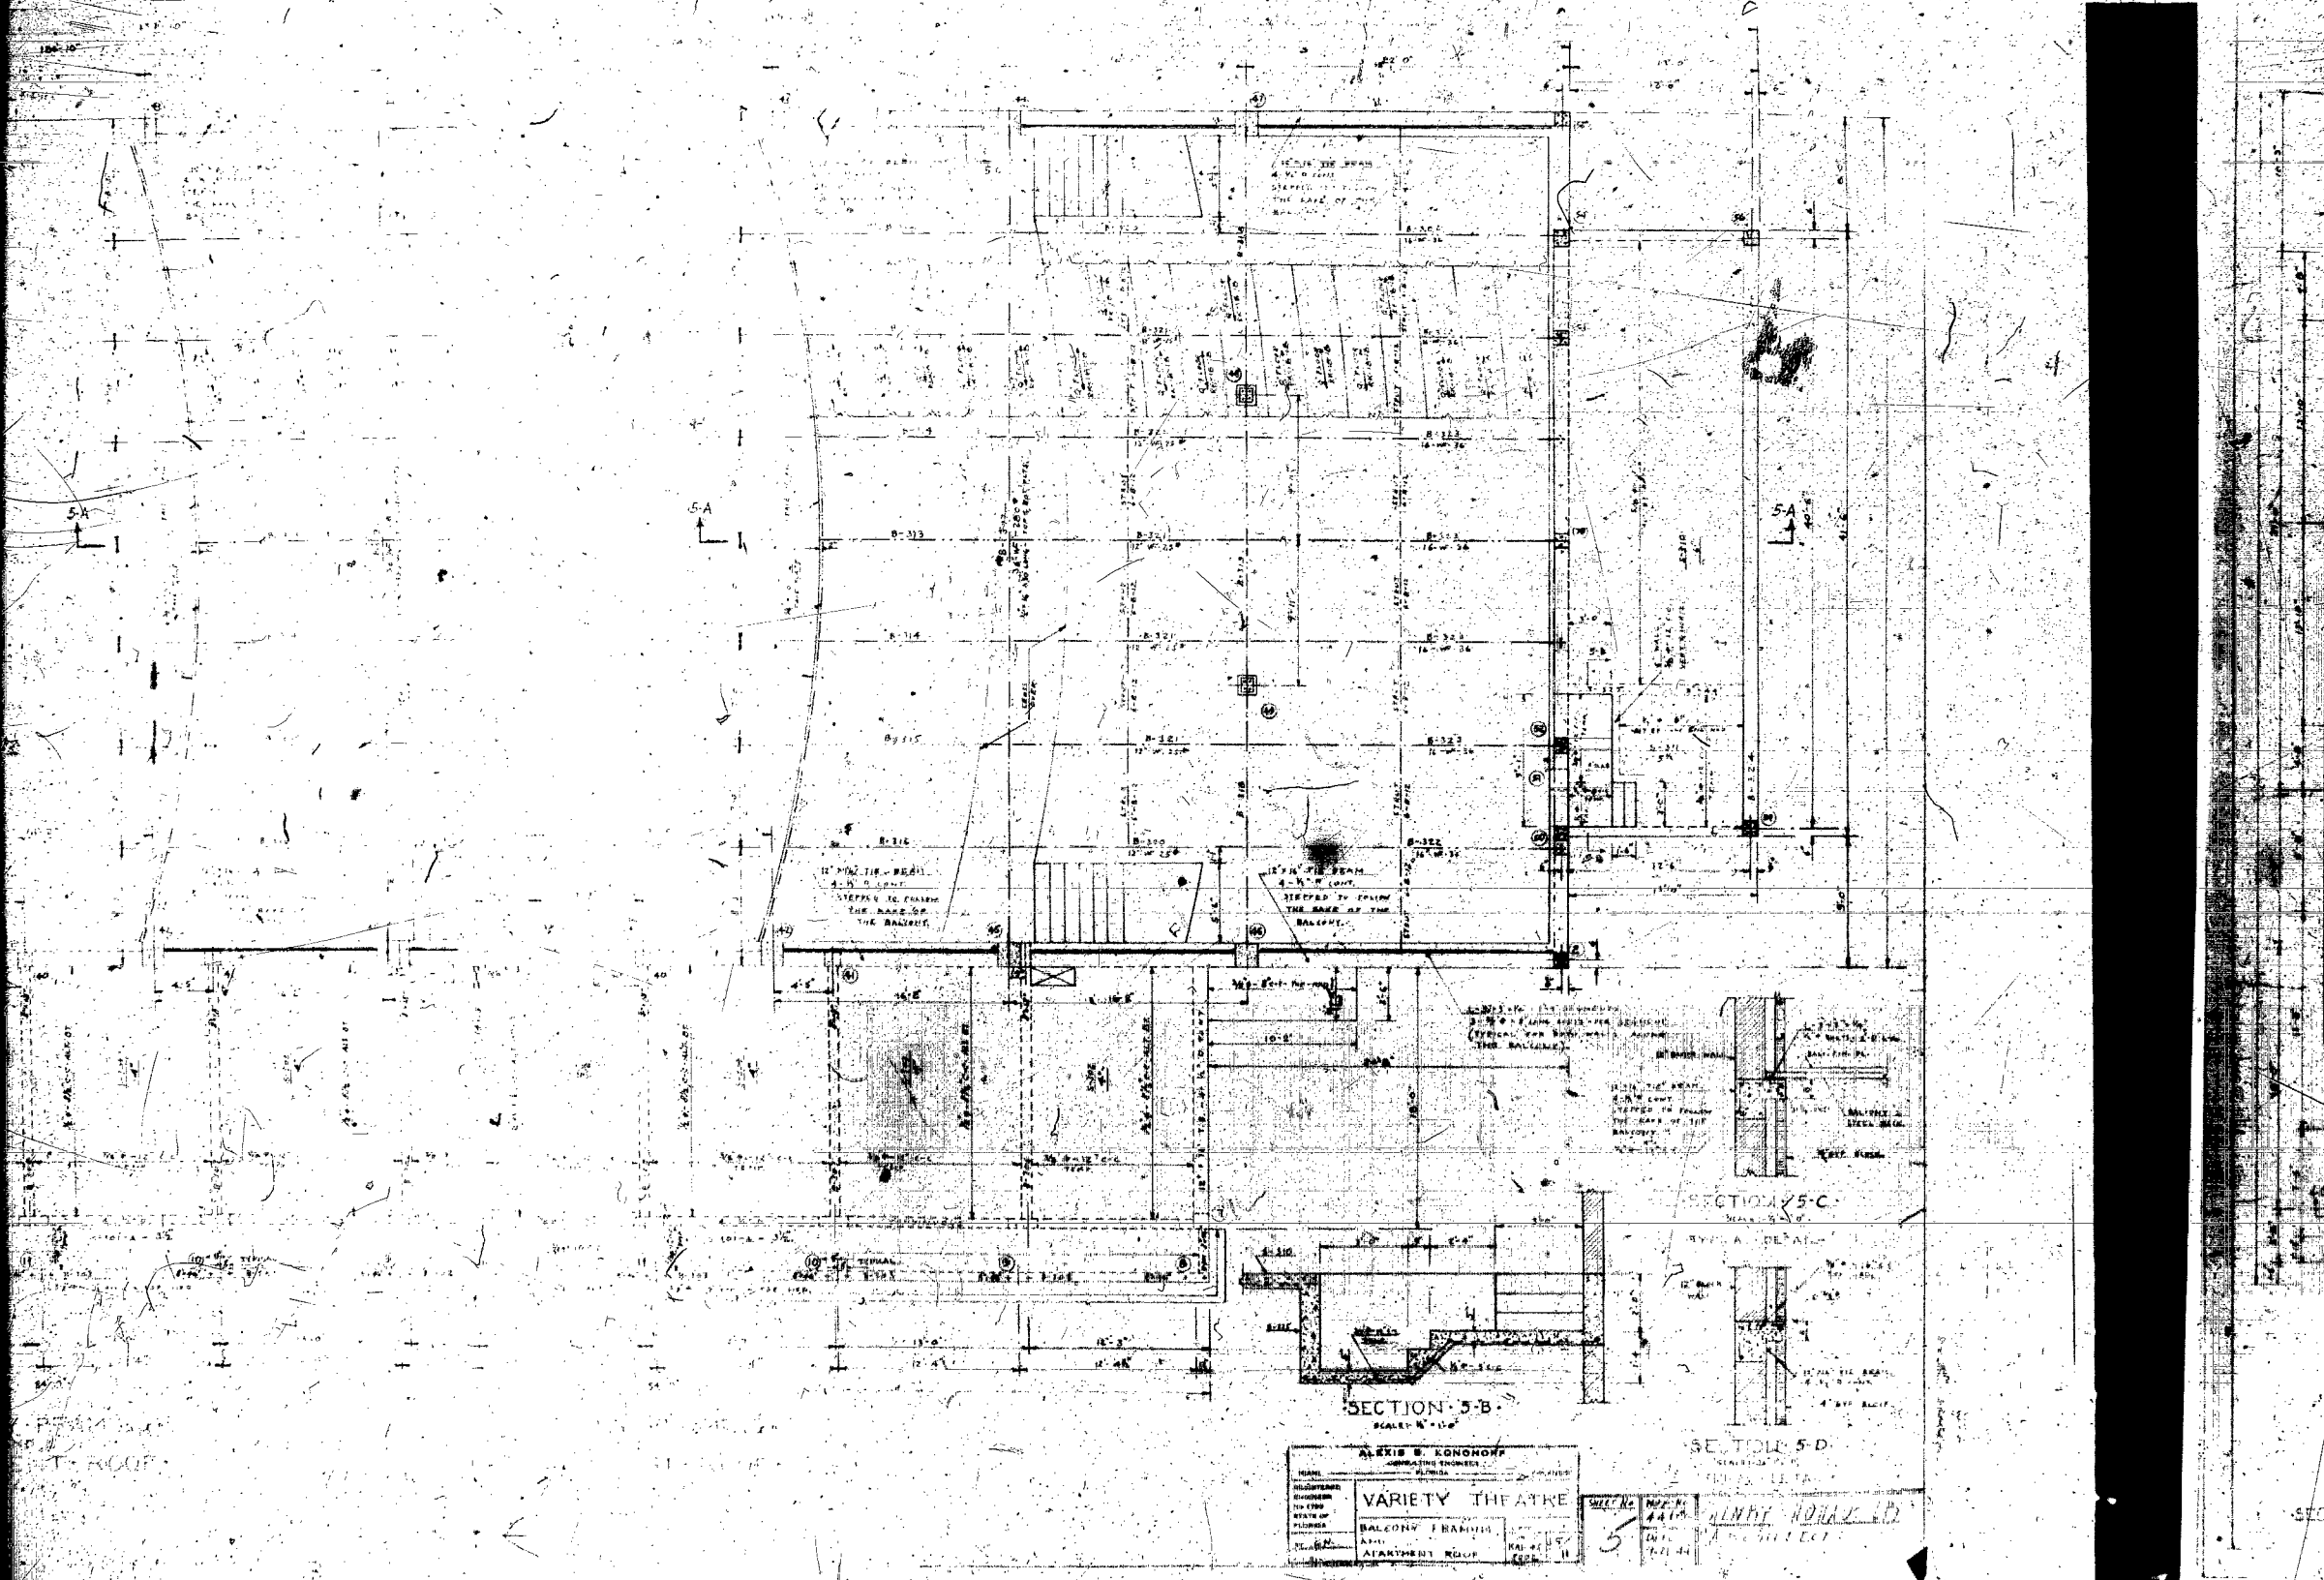

ALEXIS S. KONOHOF
 ARCHITECT
 100 N. W. 10th St.
 MIAMI, FLA.
 VARIETY THEATRE
 BALCONY FRAMING
 PLANTING FLOOR
 SCALE: 1/4" = 1'-0"

VINNY HORAK LTD
 ENGINEERS
 100 N. W. 10th St.
 MIAMI, FLA.

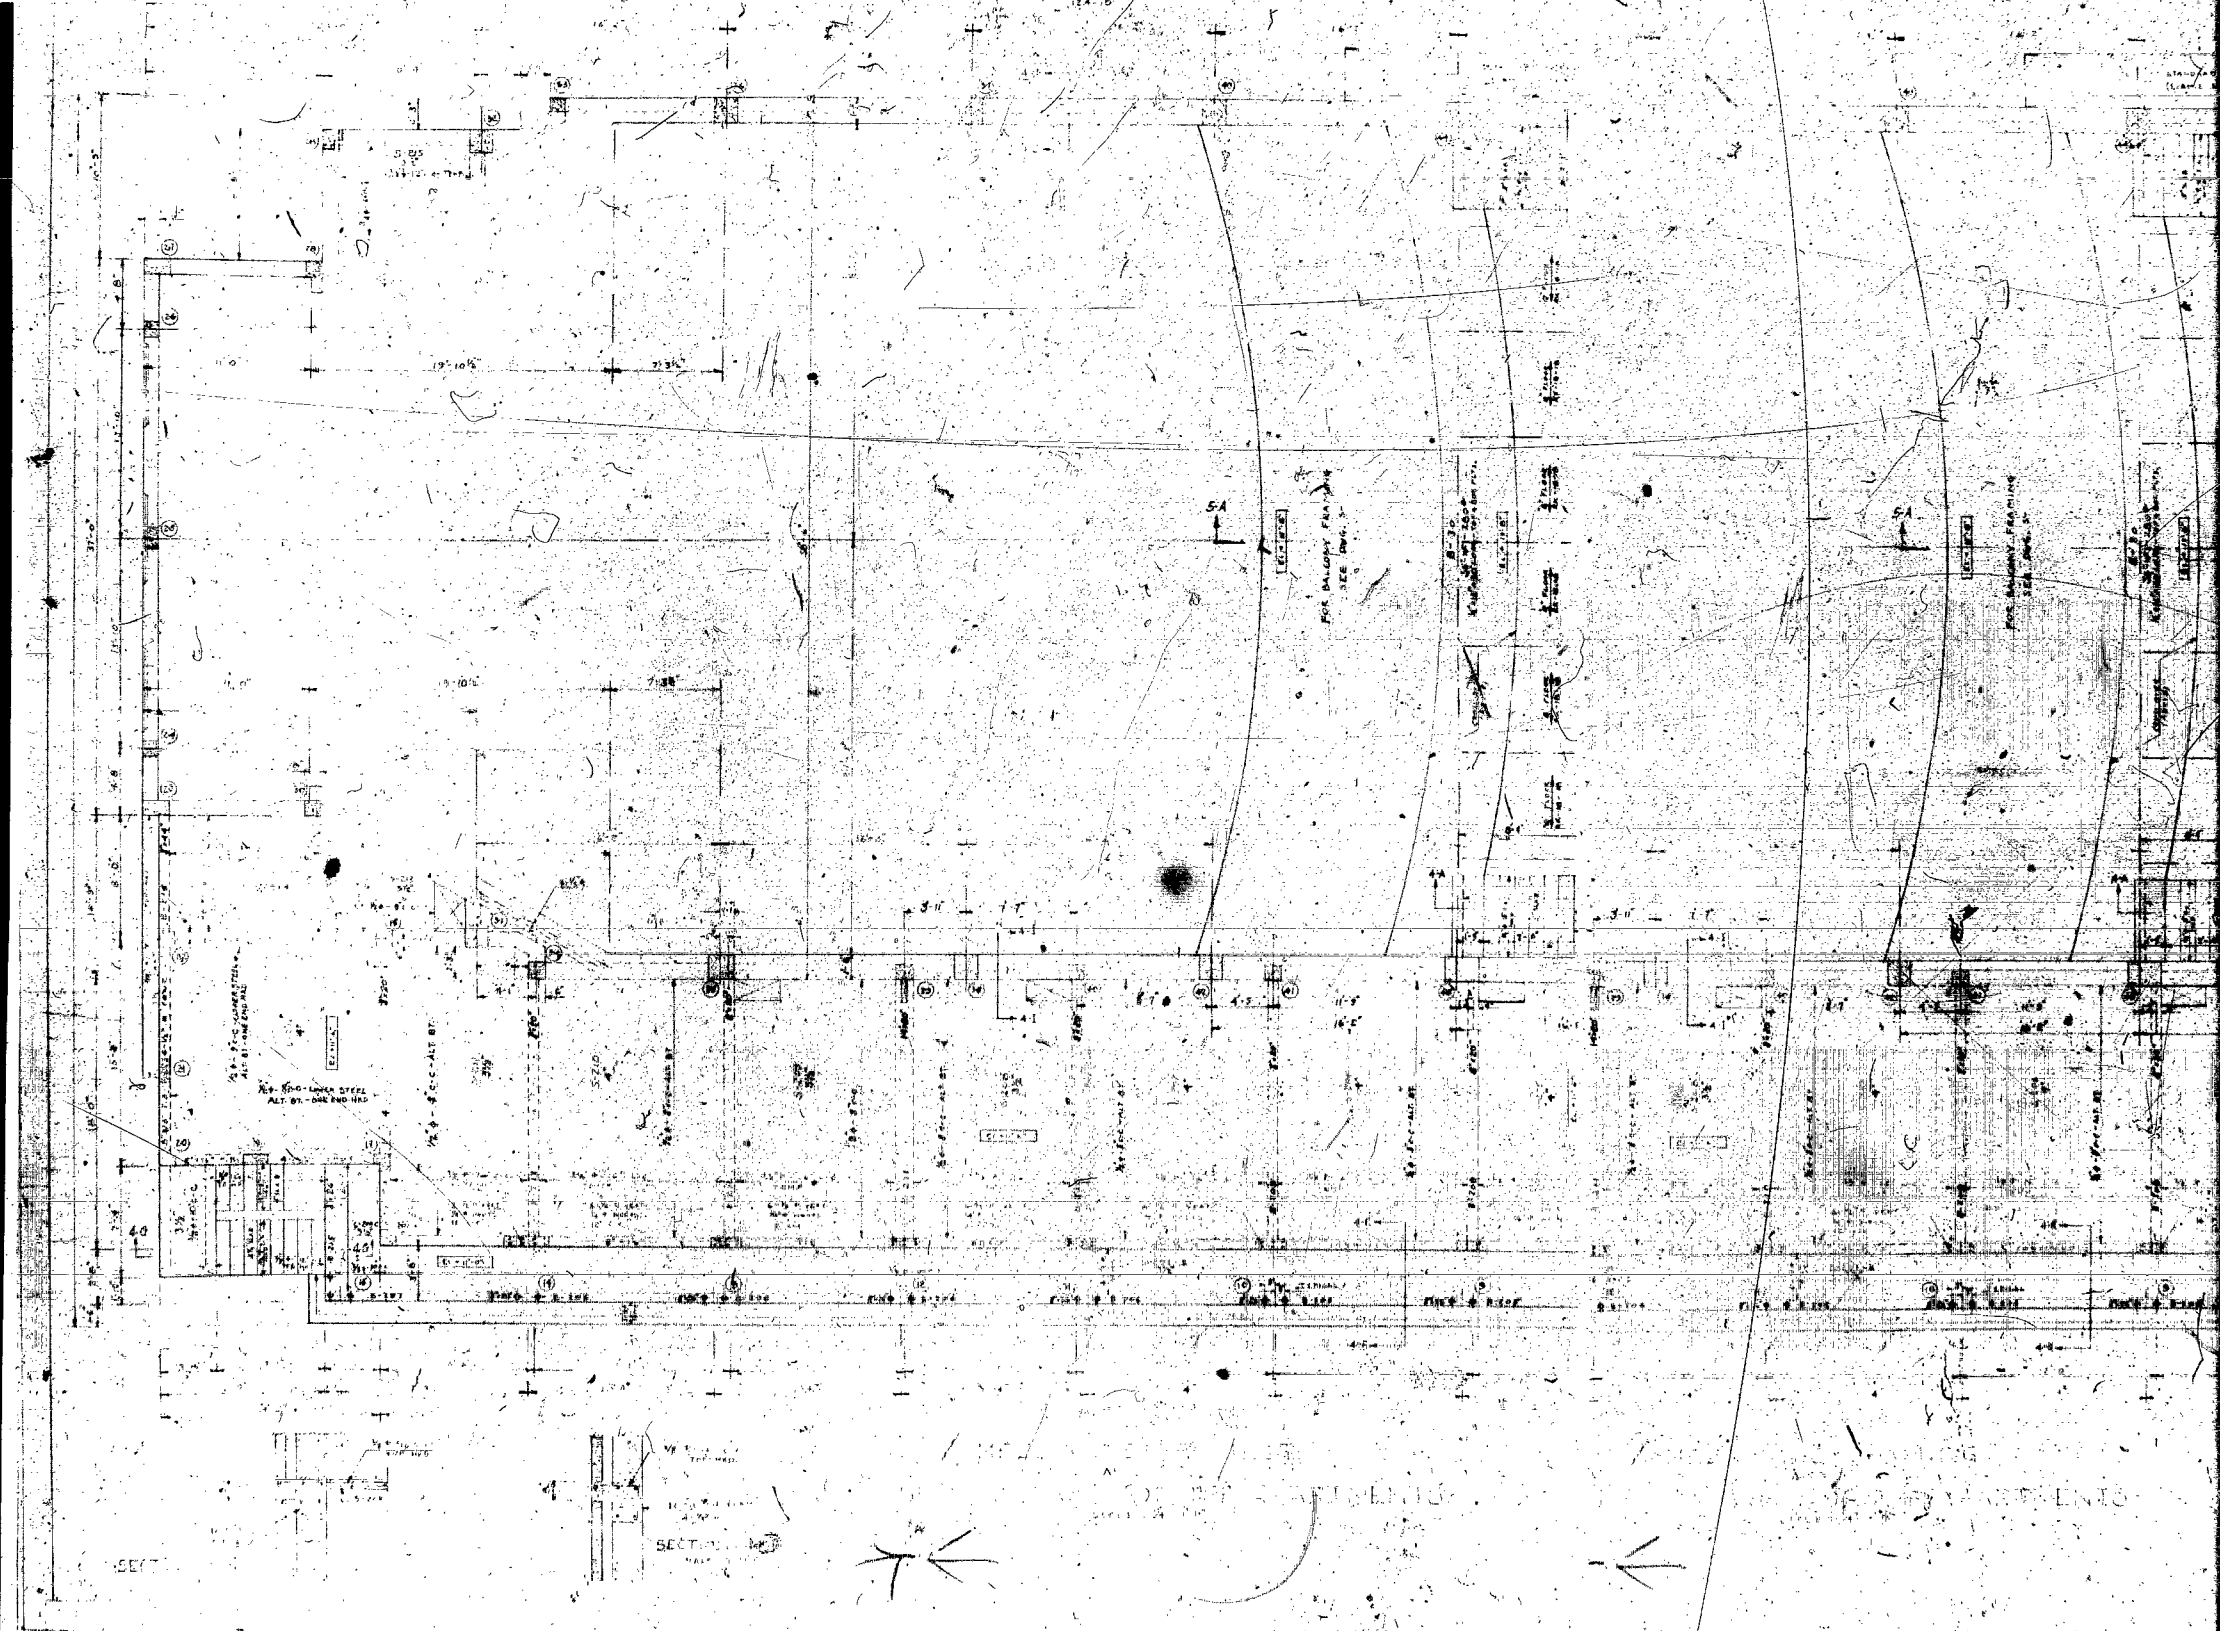

FOR BALCONY FRAMING
SEE PLAN 3


FOR BALCONY FRAMING
SEE PLAN 3


2 1/2" DIA. CONCRETE
AIR CONDITIONING

1/4" DIA. CONCRETE
AIR CONDITIONING

SECTION A-A

SECTION B-B

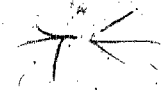

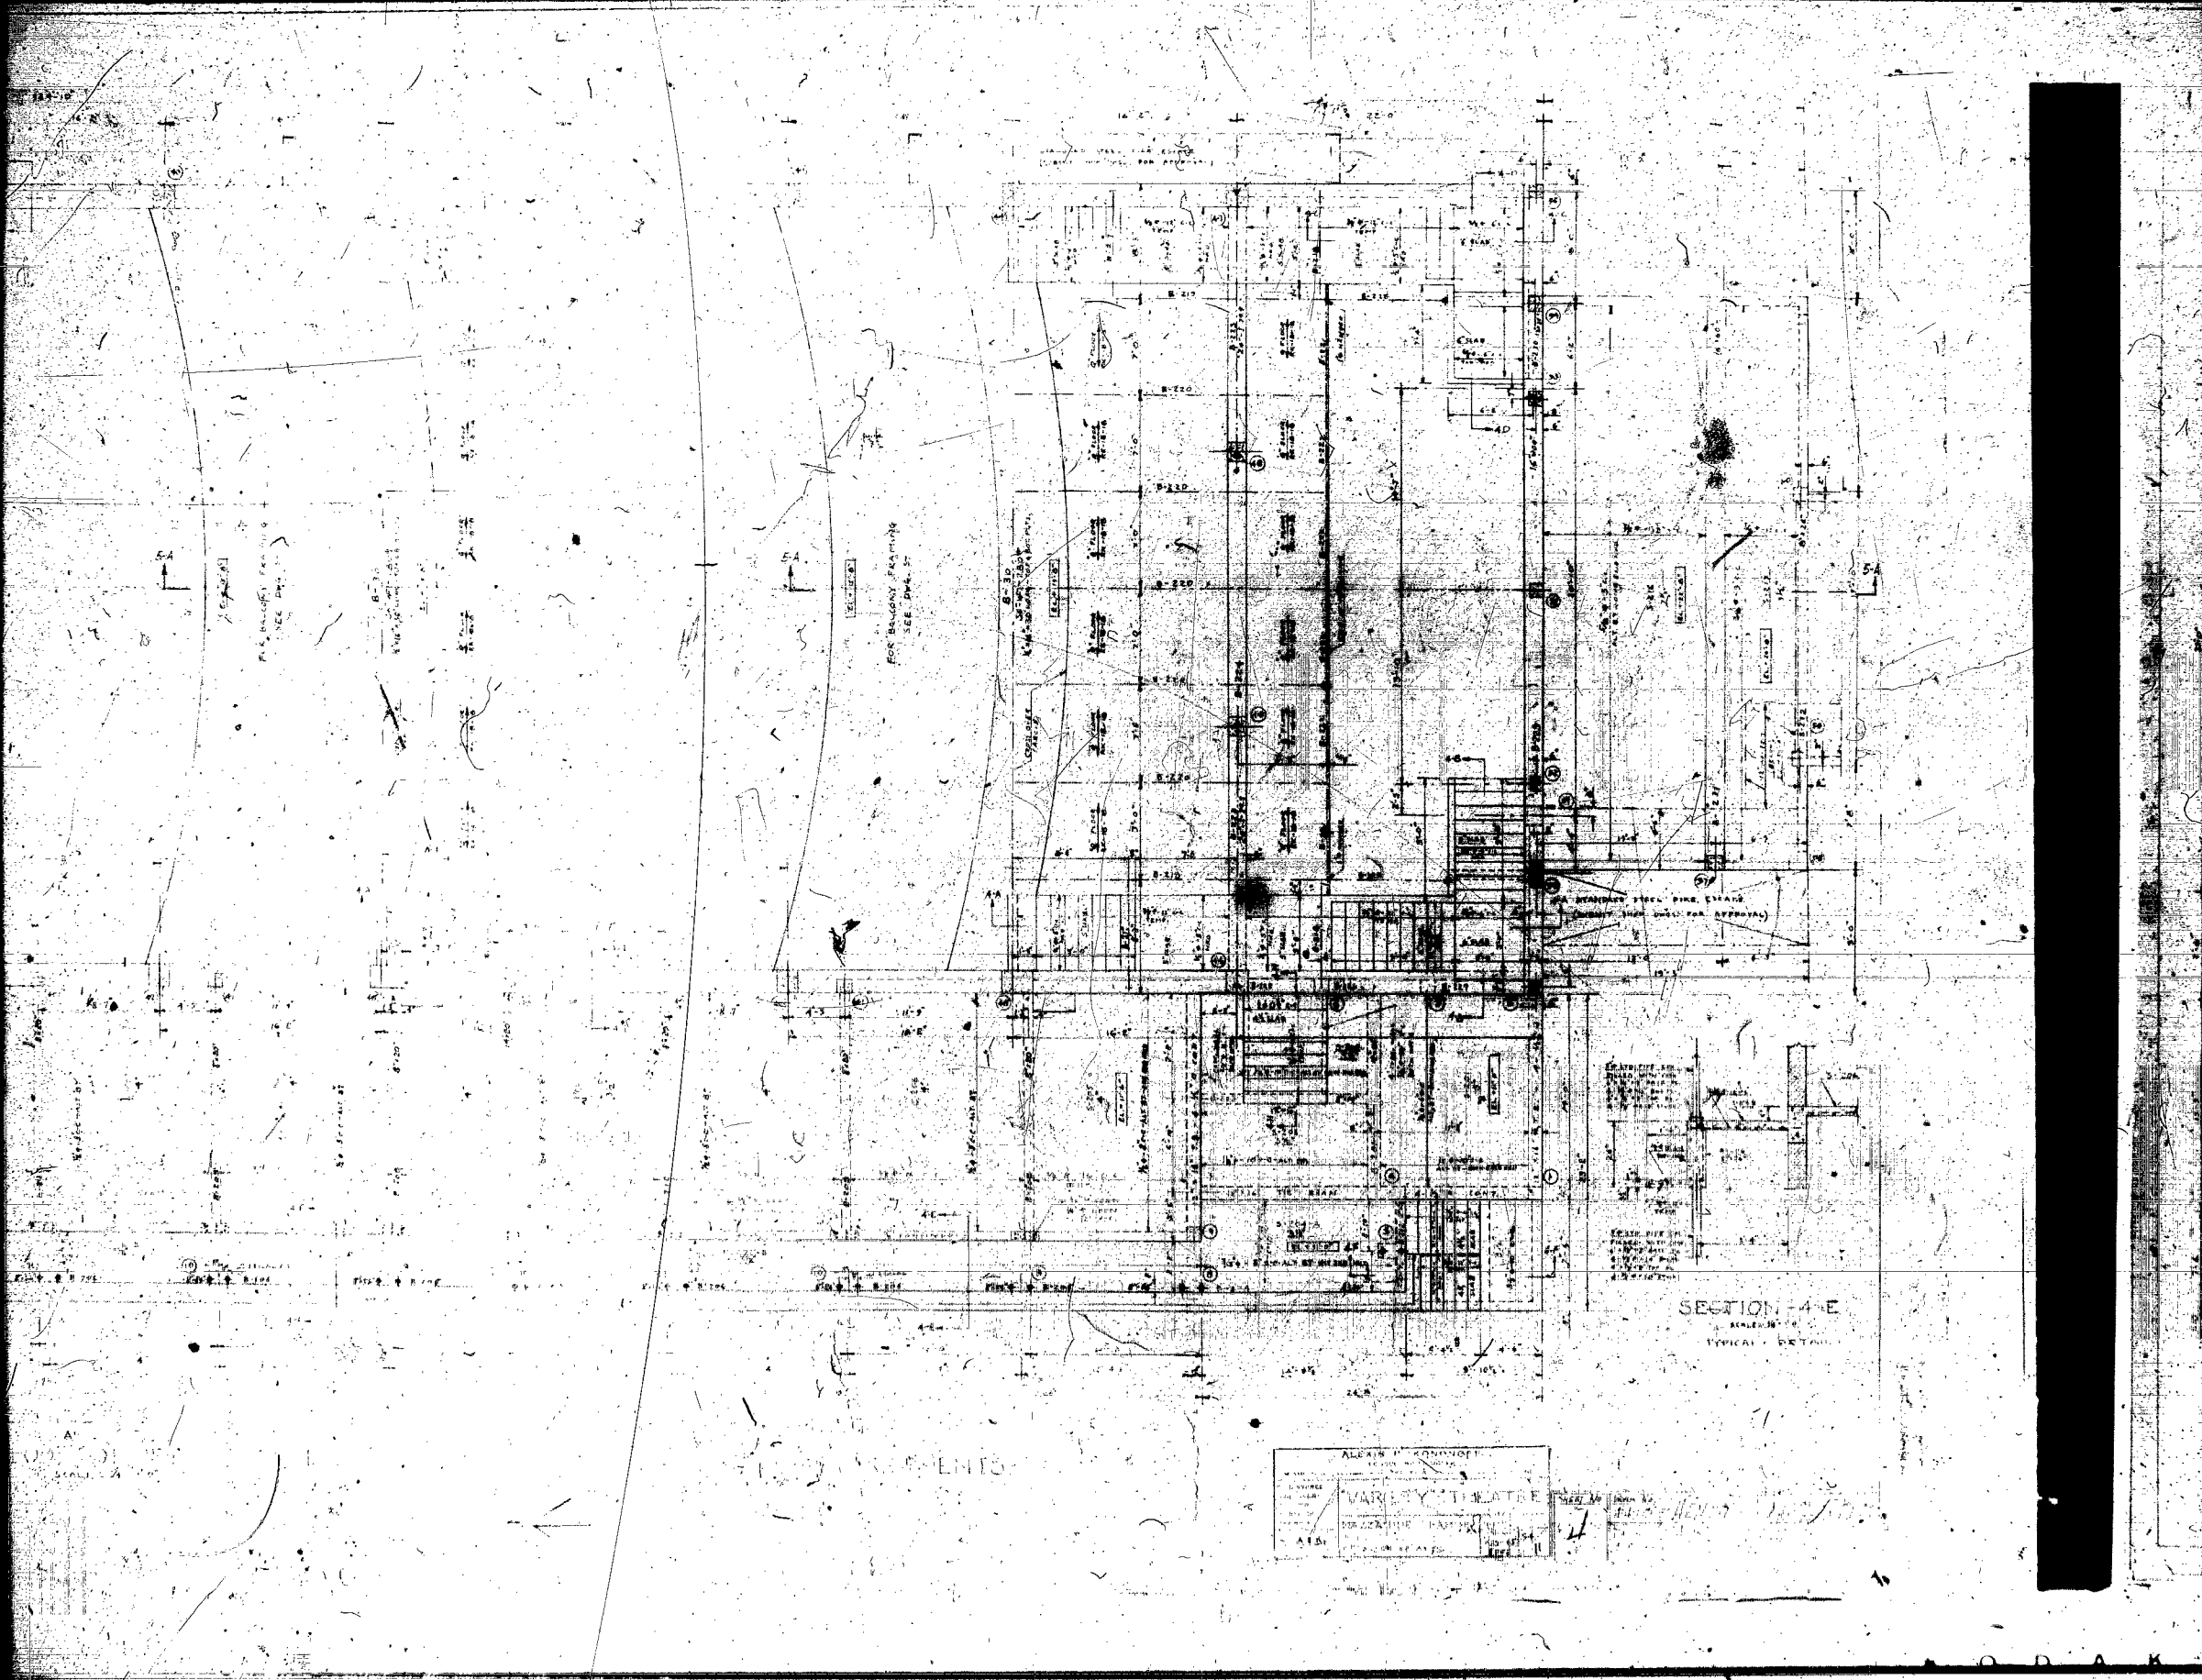

DETAILS


ALEXIS KONNOFF
 ARCHITECT
 1000 BROADWAY
 NEW YORK, N. Y.

VARIETY THEATRE
 1000 BROADWAY
 NEW YORK, N. Y.


NO. 1000
 1000 BROADWAY
 NEW YORK, N. Y.

SECTION 4-E
 SCALE 1/8" = 1'-0"
 TYPICAL DETAIL

1000 BROADWAY

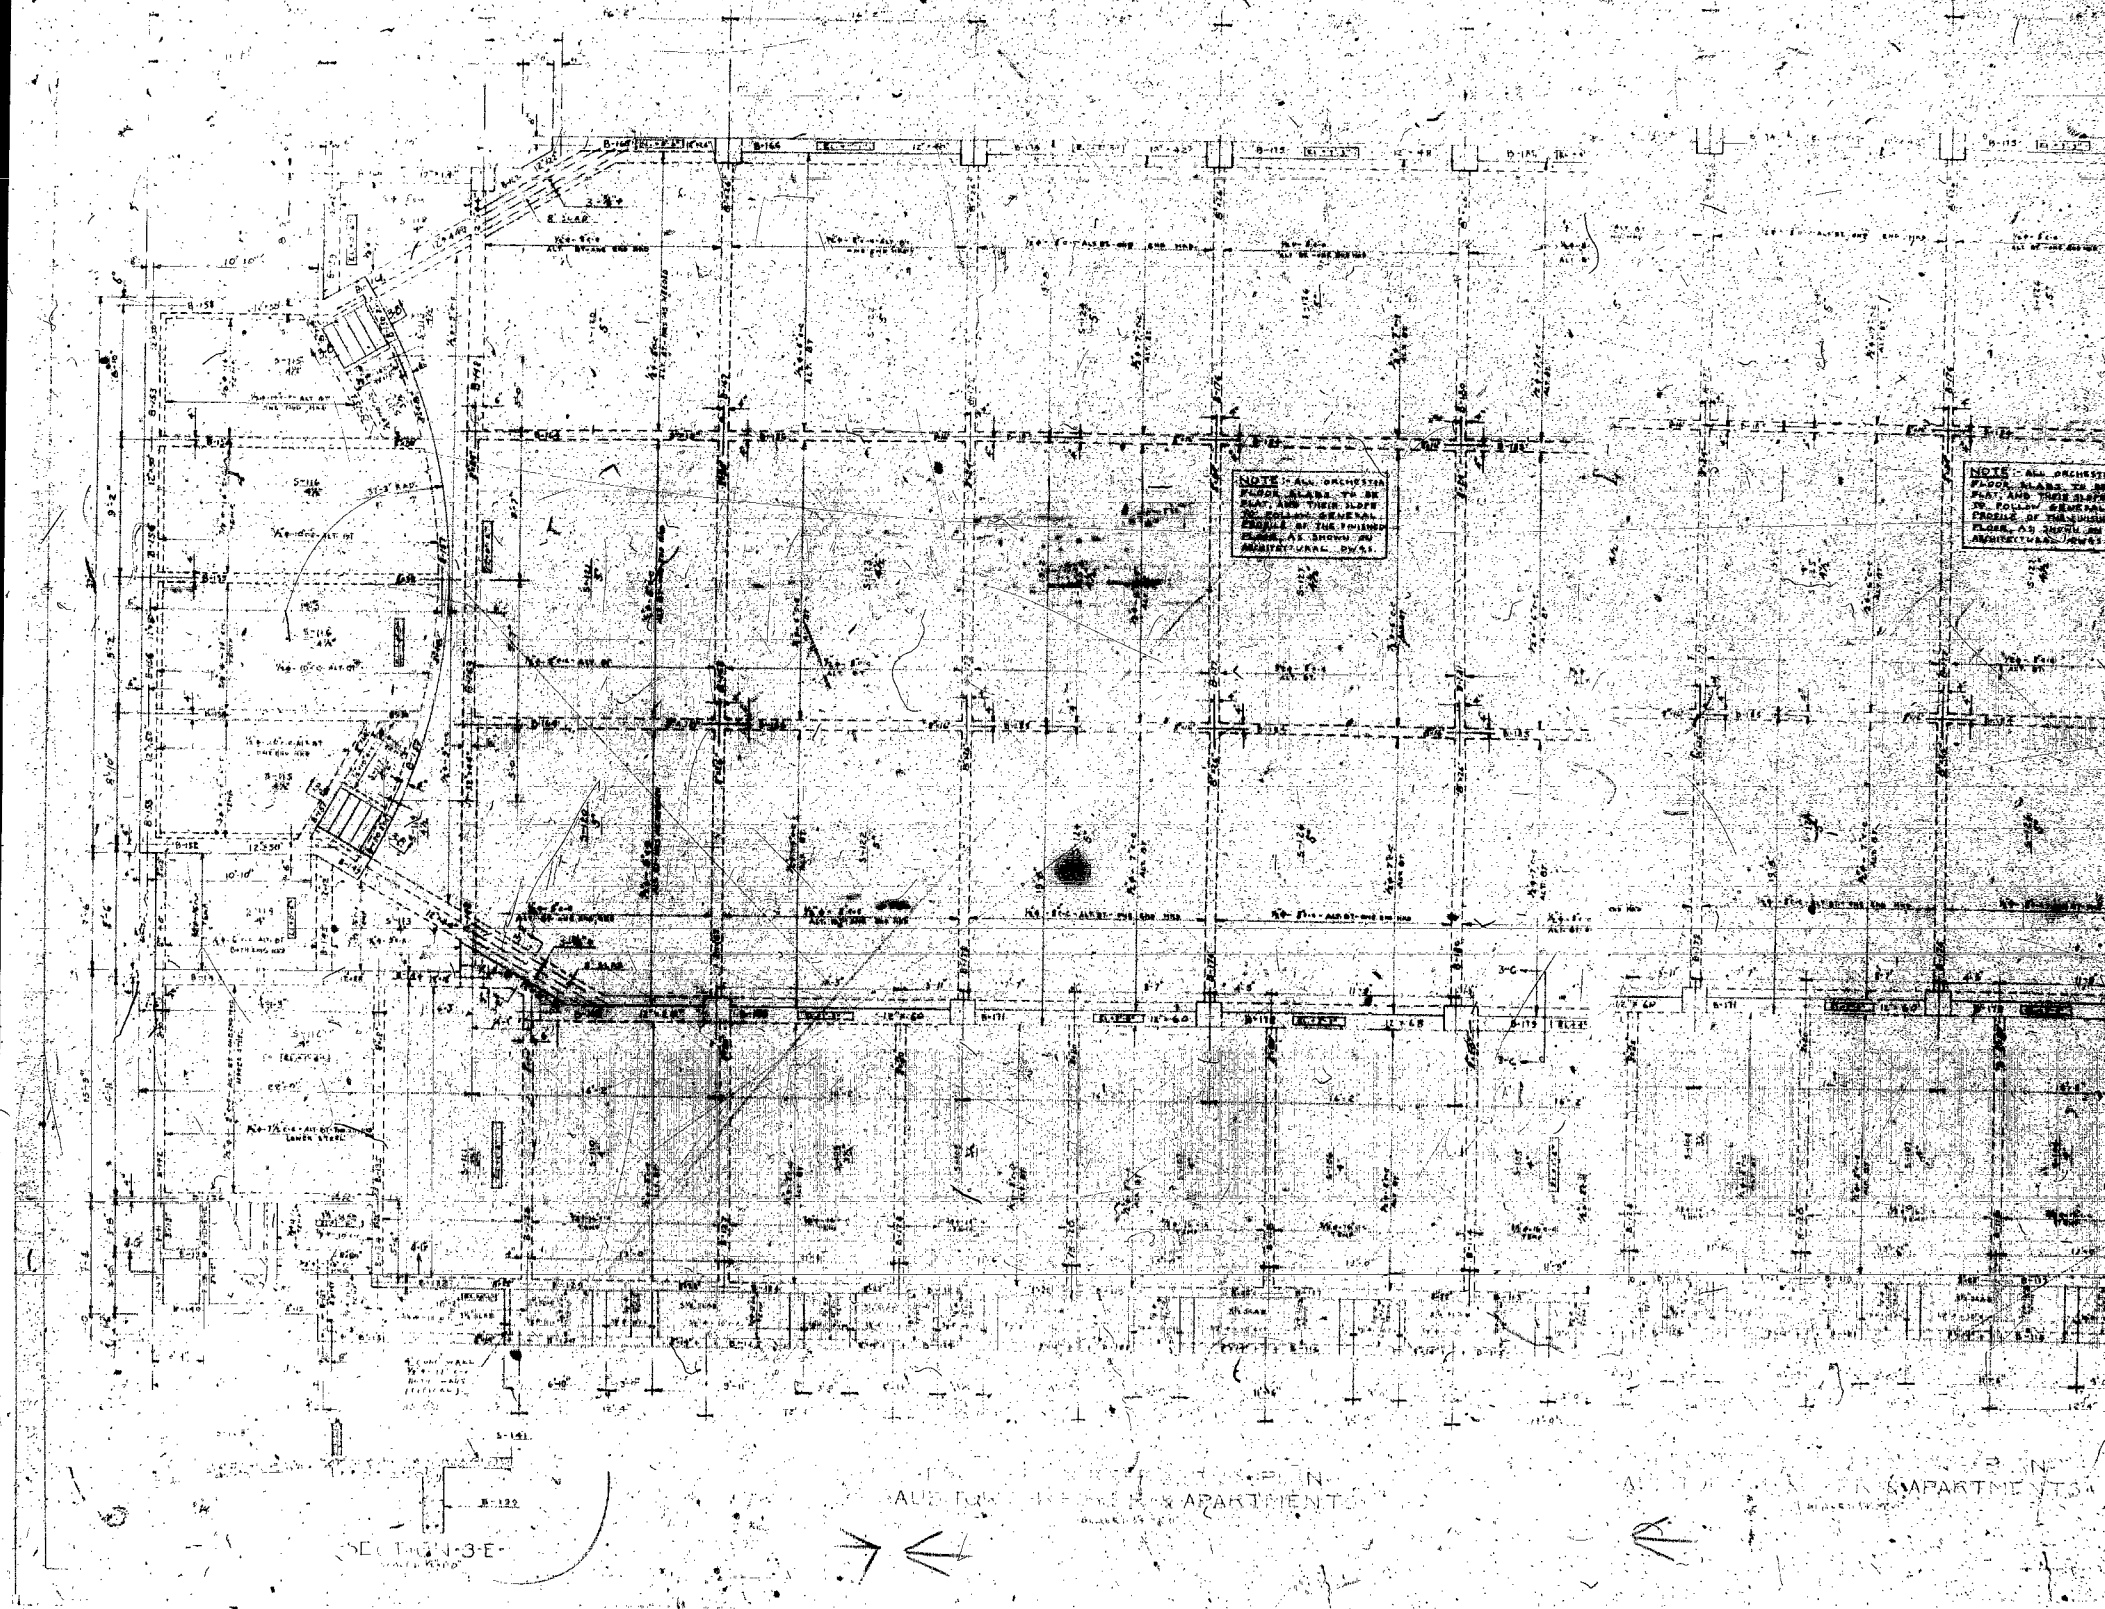


KODAK SAFETY FILM

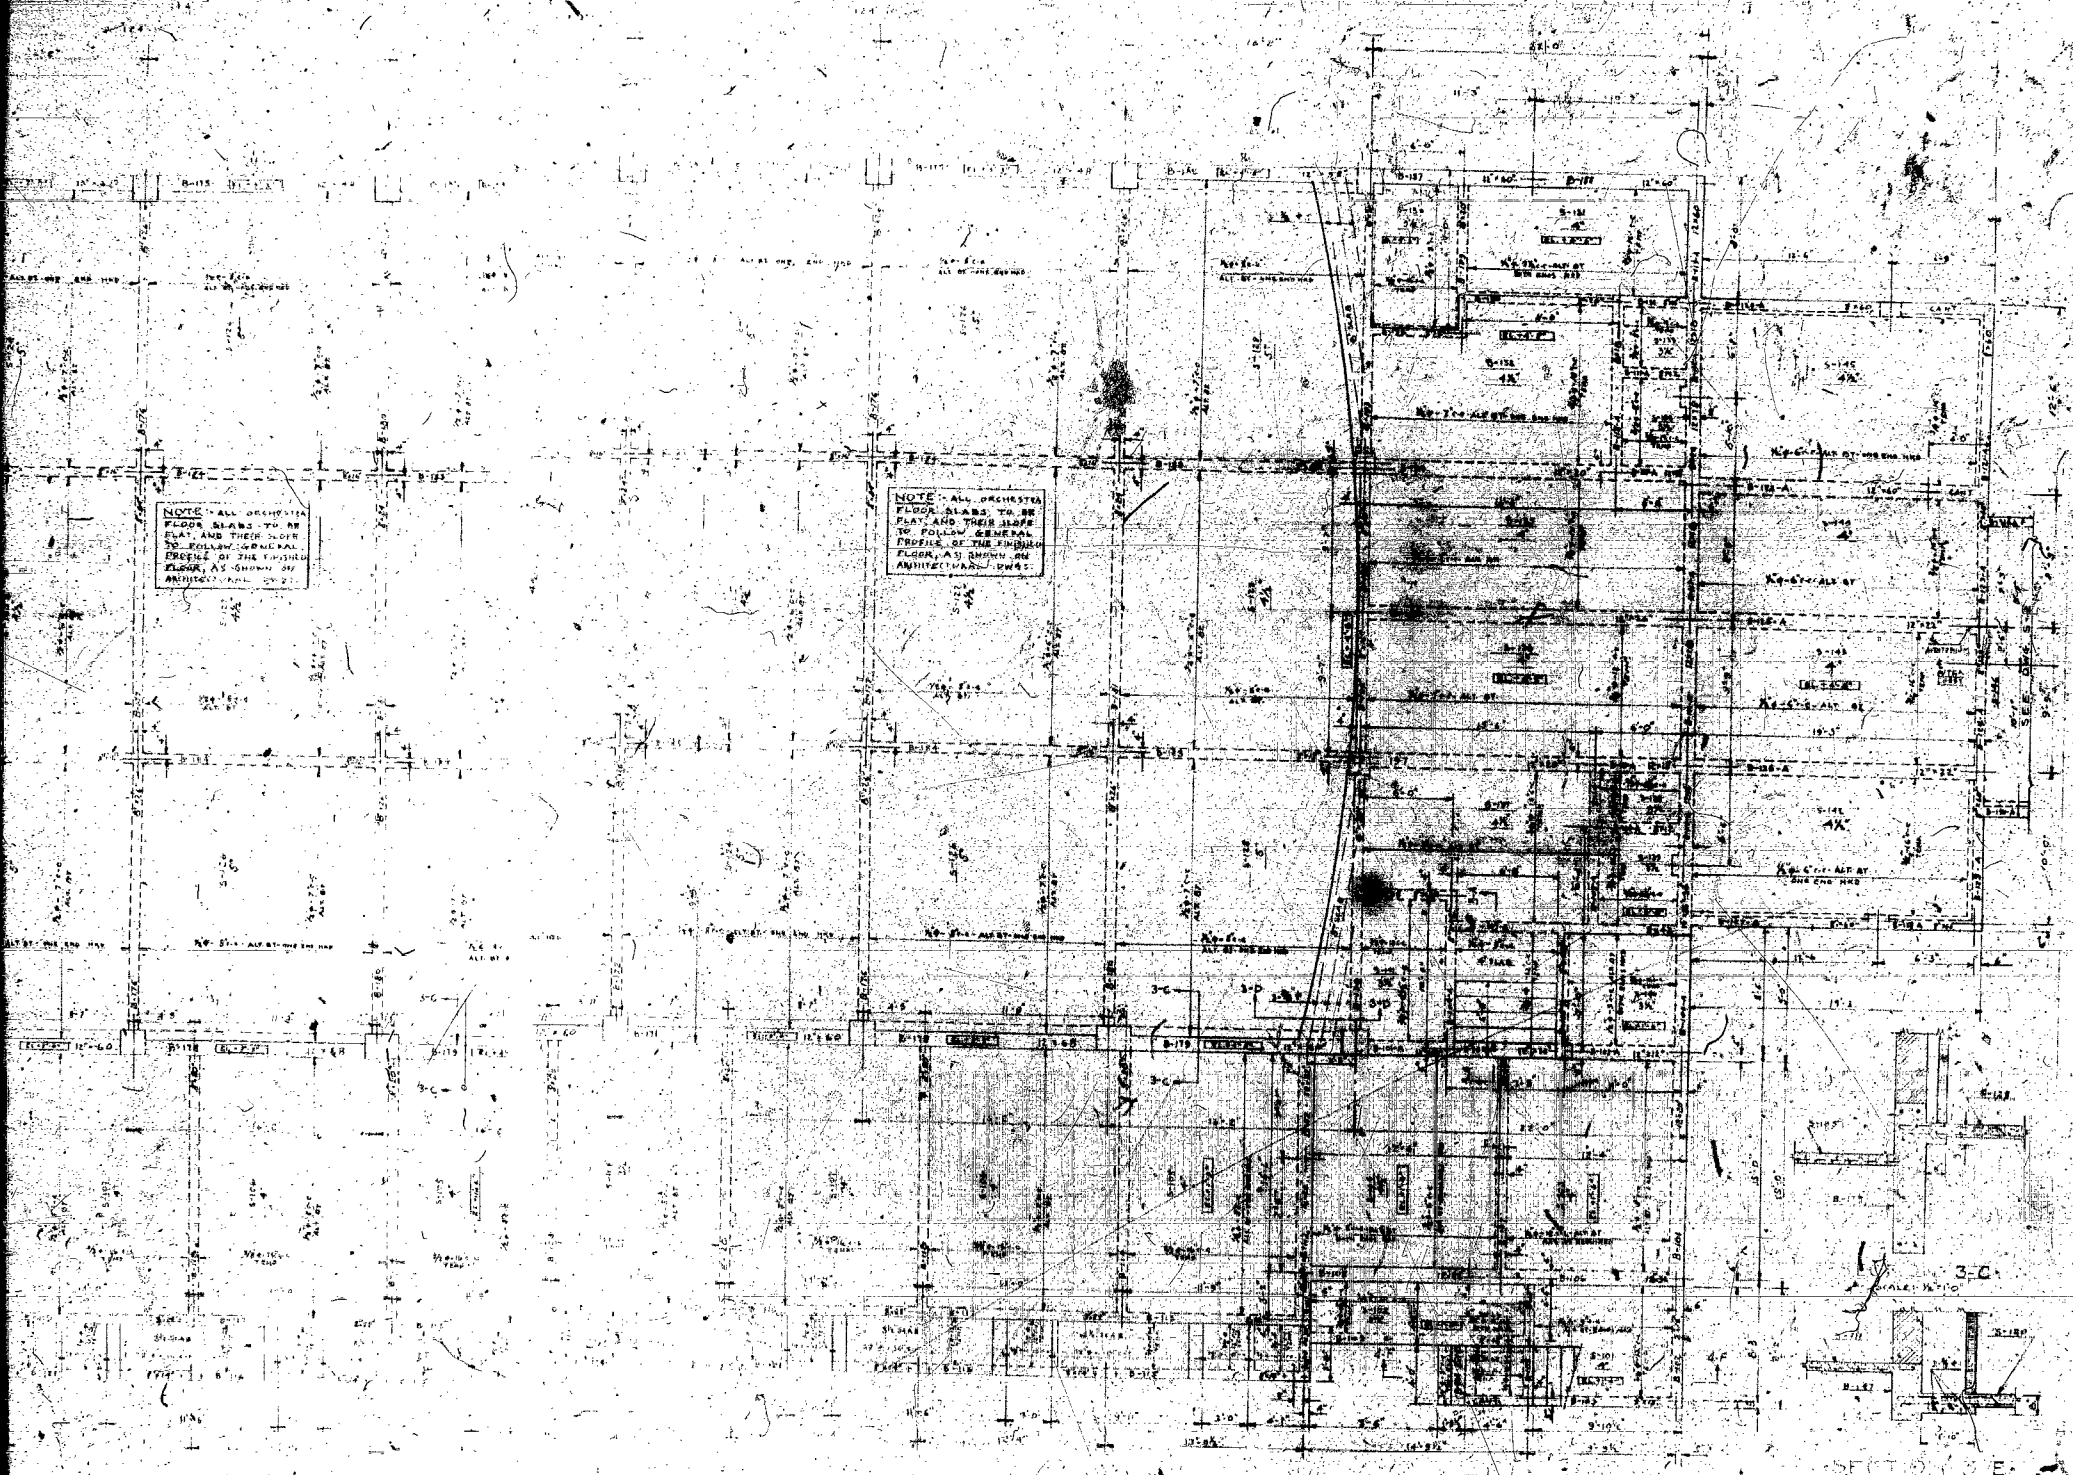


APARTMENTS

ALEXIS S. KONOFF	
CONTRACTOR	
VARIETY THEATRE	
DATE	1-2-44
SCALE	1/4" = 1'-0"

3'

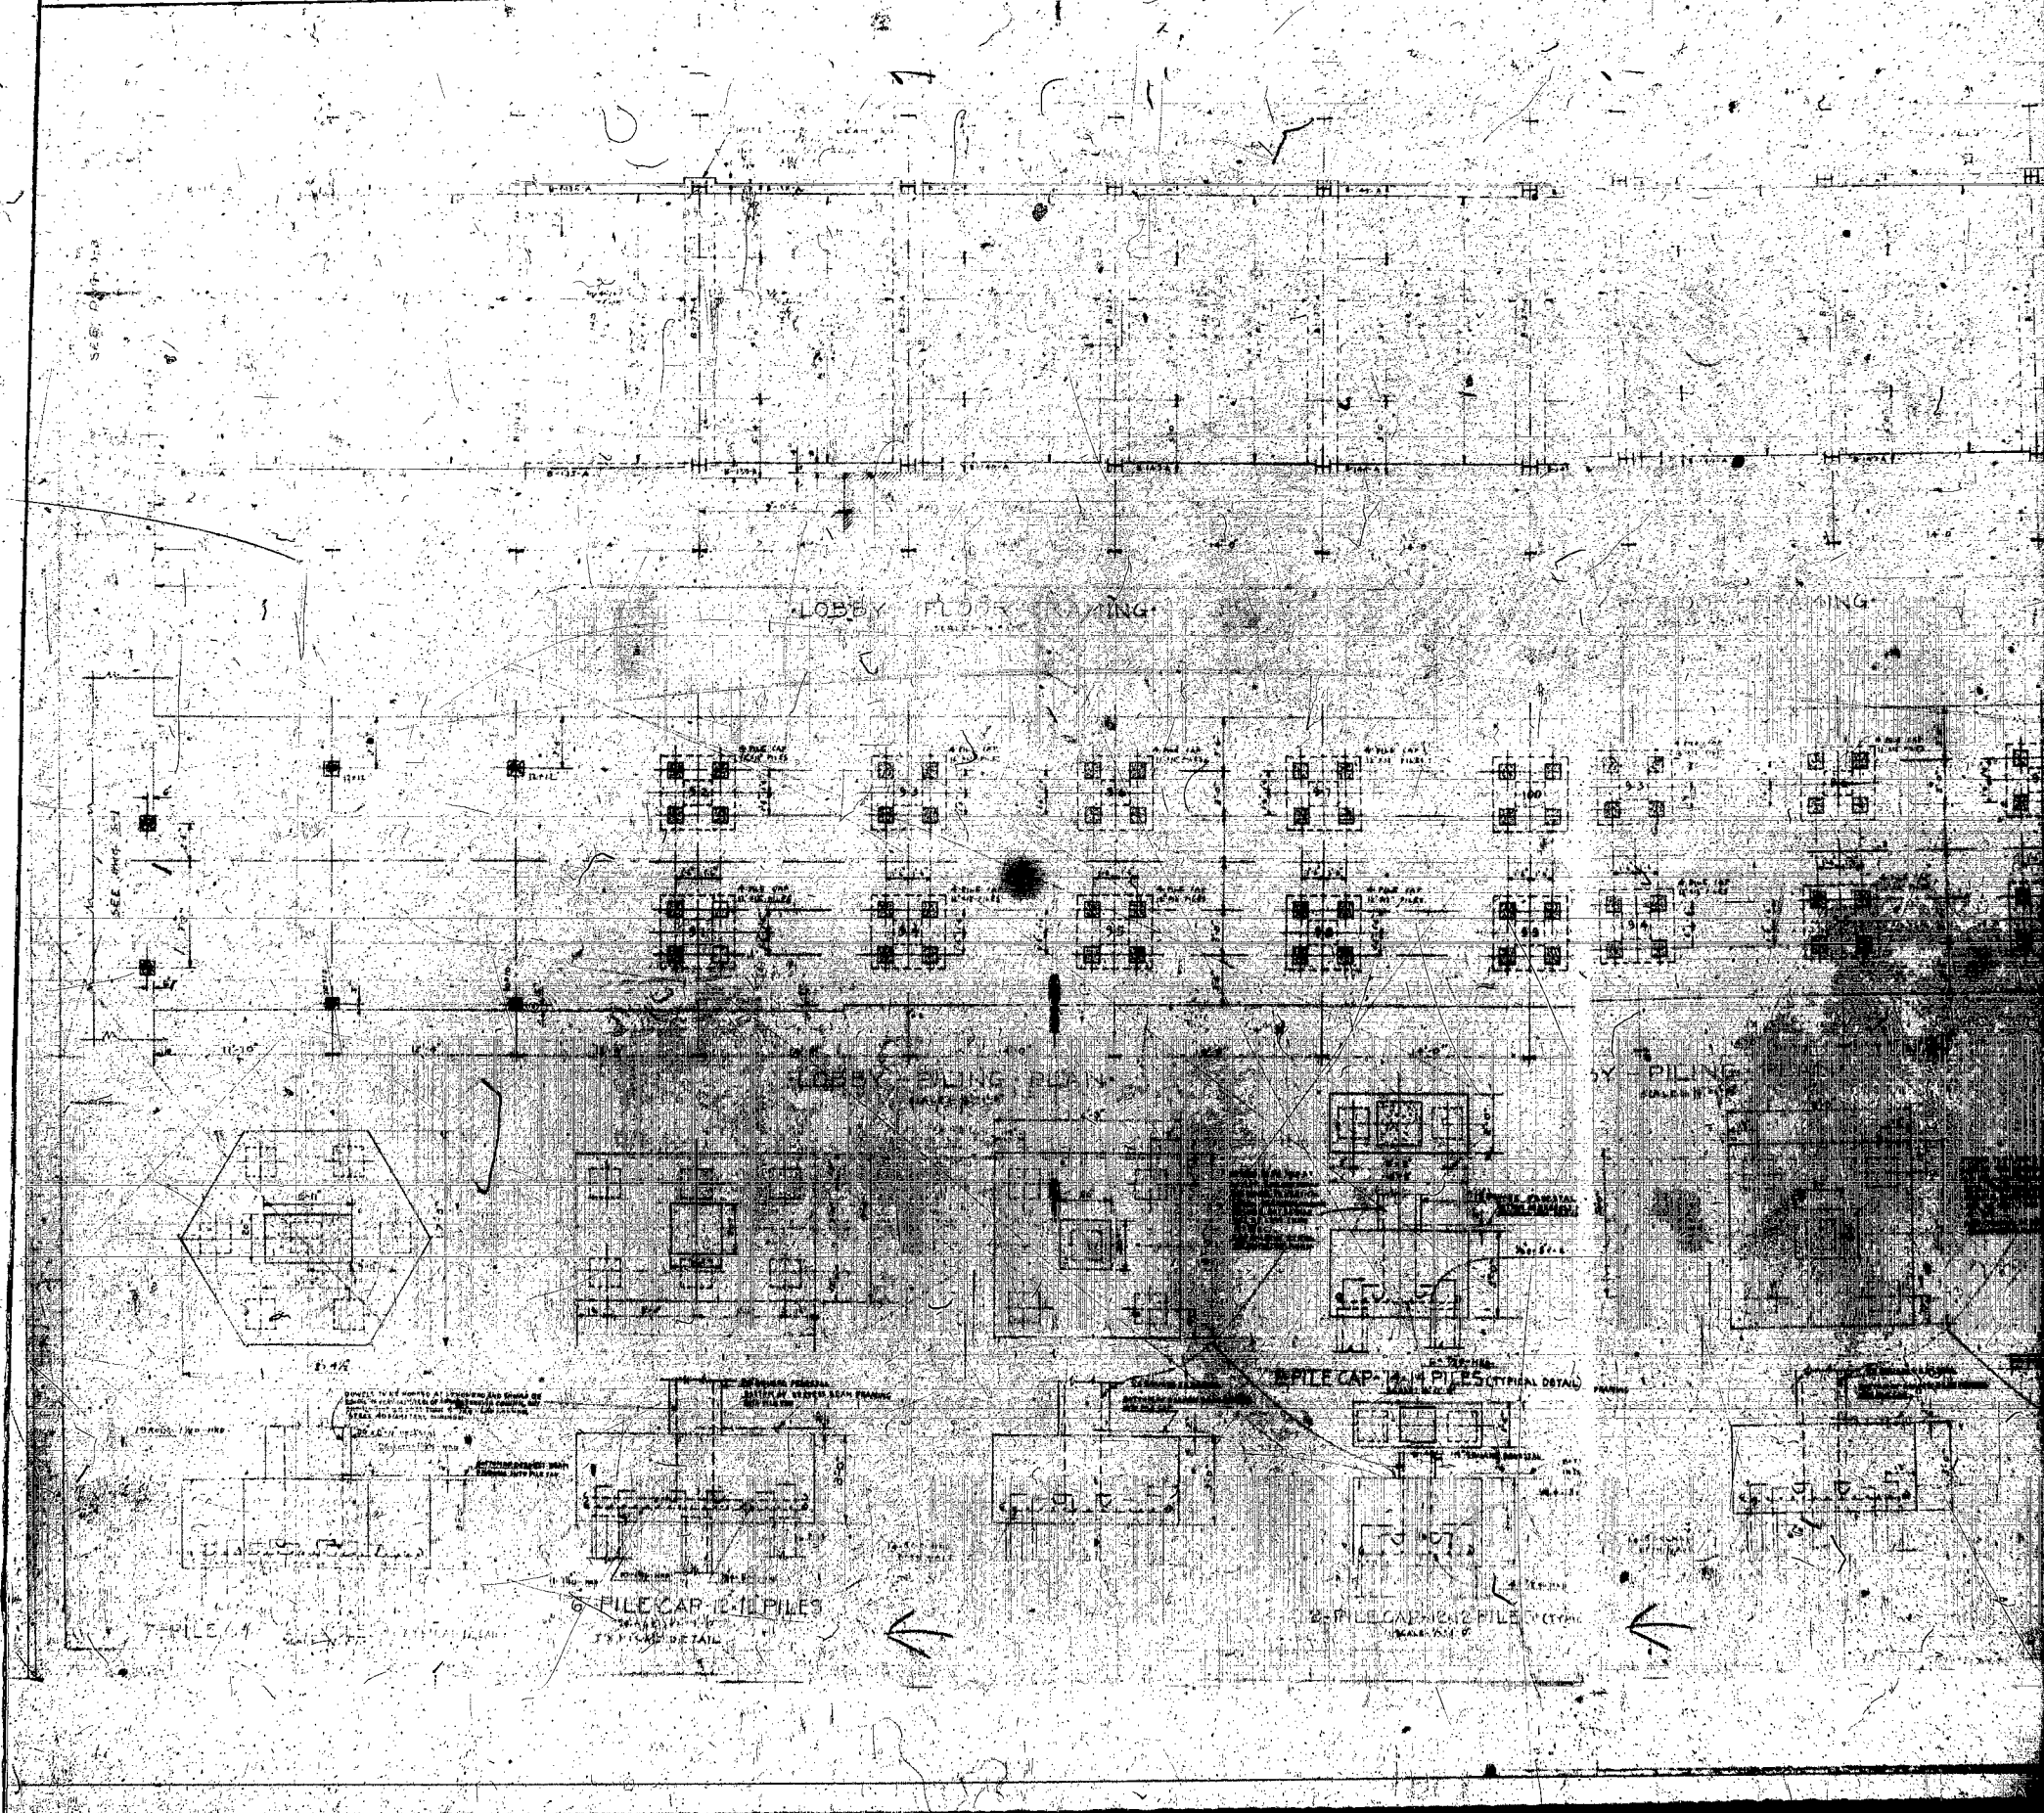

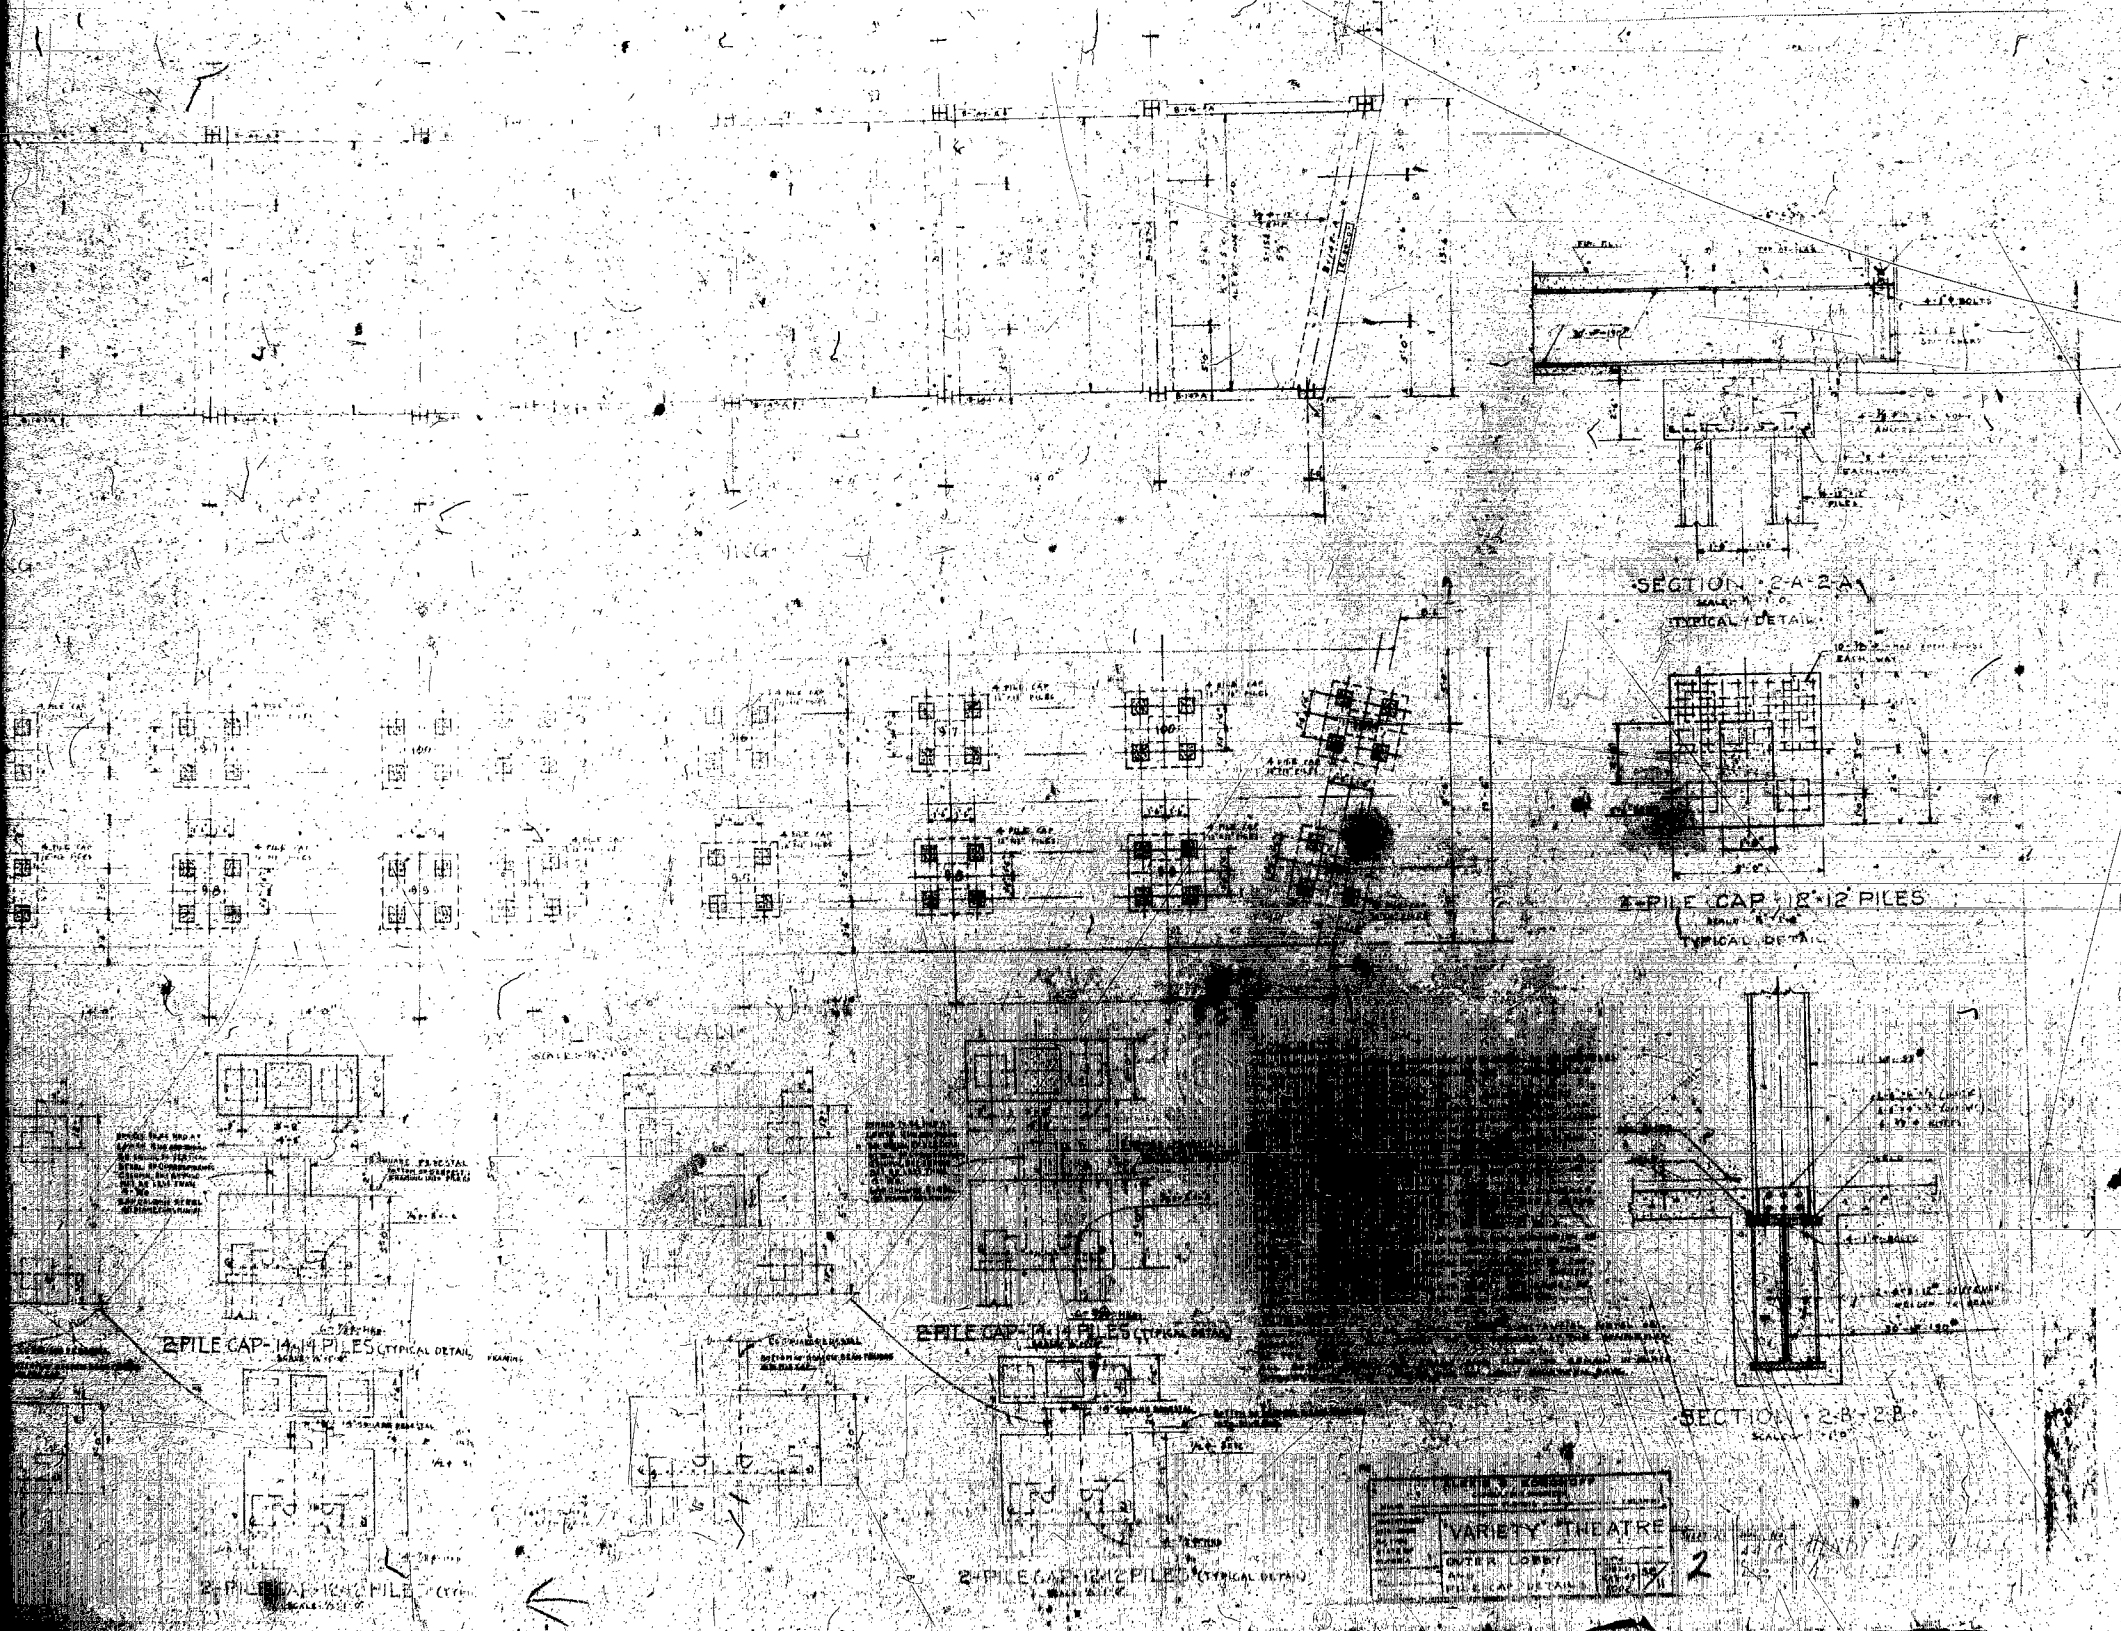

SECTION 2-A-2-A
SCALE: 1/4" = 1'-0"

2-PILE CAP-12-12 PILES
SCALE: 1/4" = 1'-0"


SECTION 2-B-2-B
SCALE: 1/4" = 1'-0"


2-PILE CAP-14-14 PILES
SCALE: 1/4" = 1'-0"

2-PILE CAP-14-14 PILES
SCALE: 1/4" = 1'-0"

2-PILE CAP-12-12 PILES
SCALE: 1/4" = 1'-0"

VARIETY THEATRE	
OWNER: LOBBY	NO. 2
ARCHITECT: [illegible]	DATE: [illegible]
ENGINEER: [illegible]	SCALE: 1/4" = 1'-0"

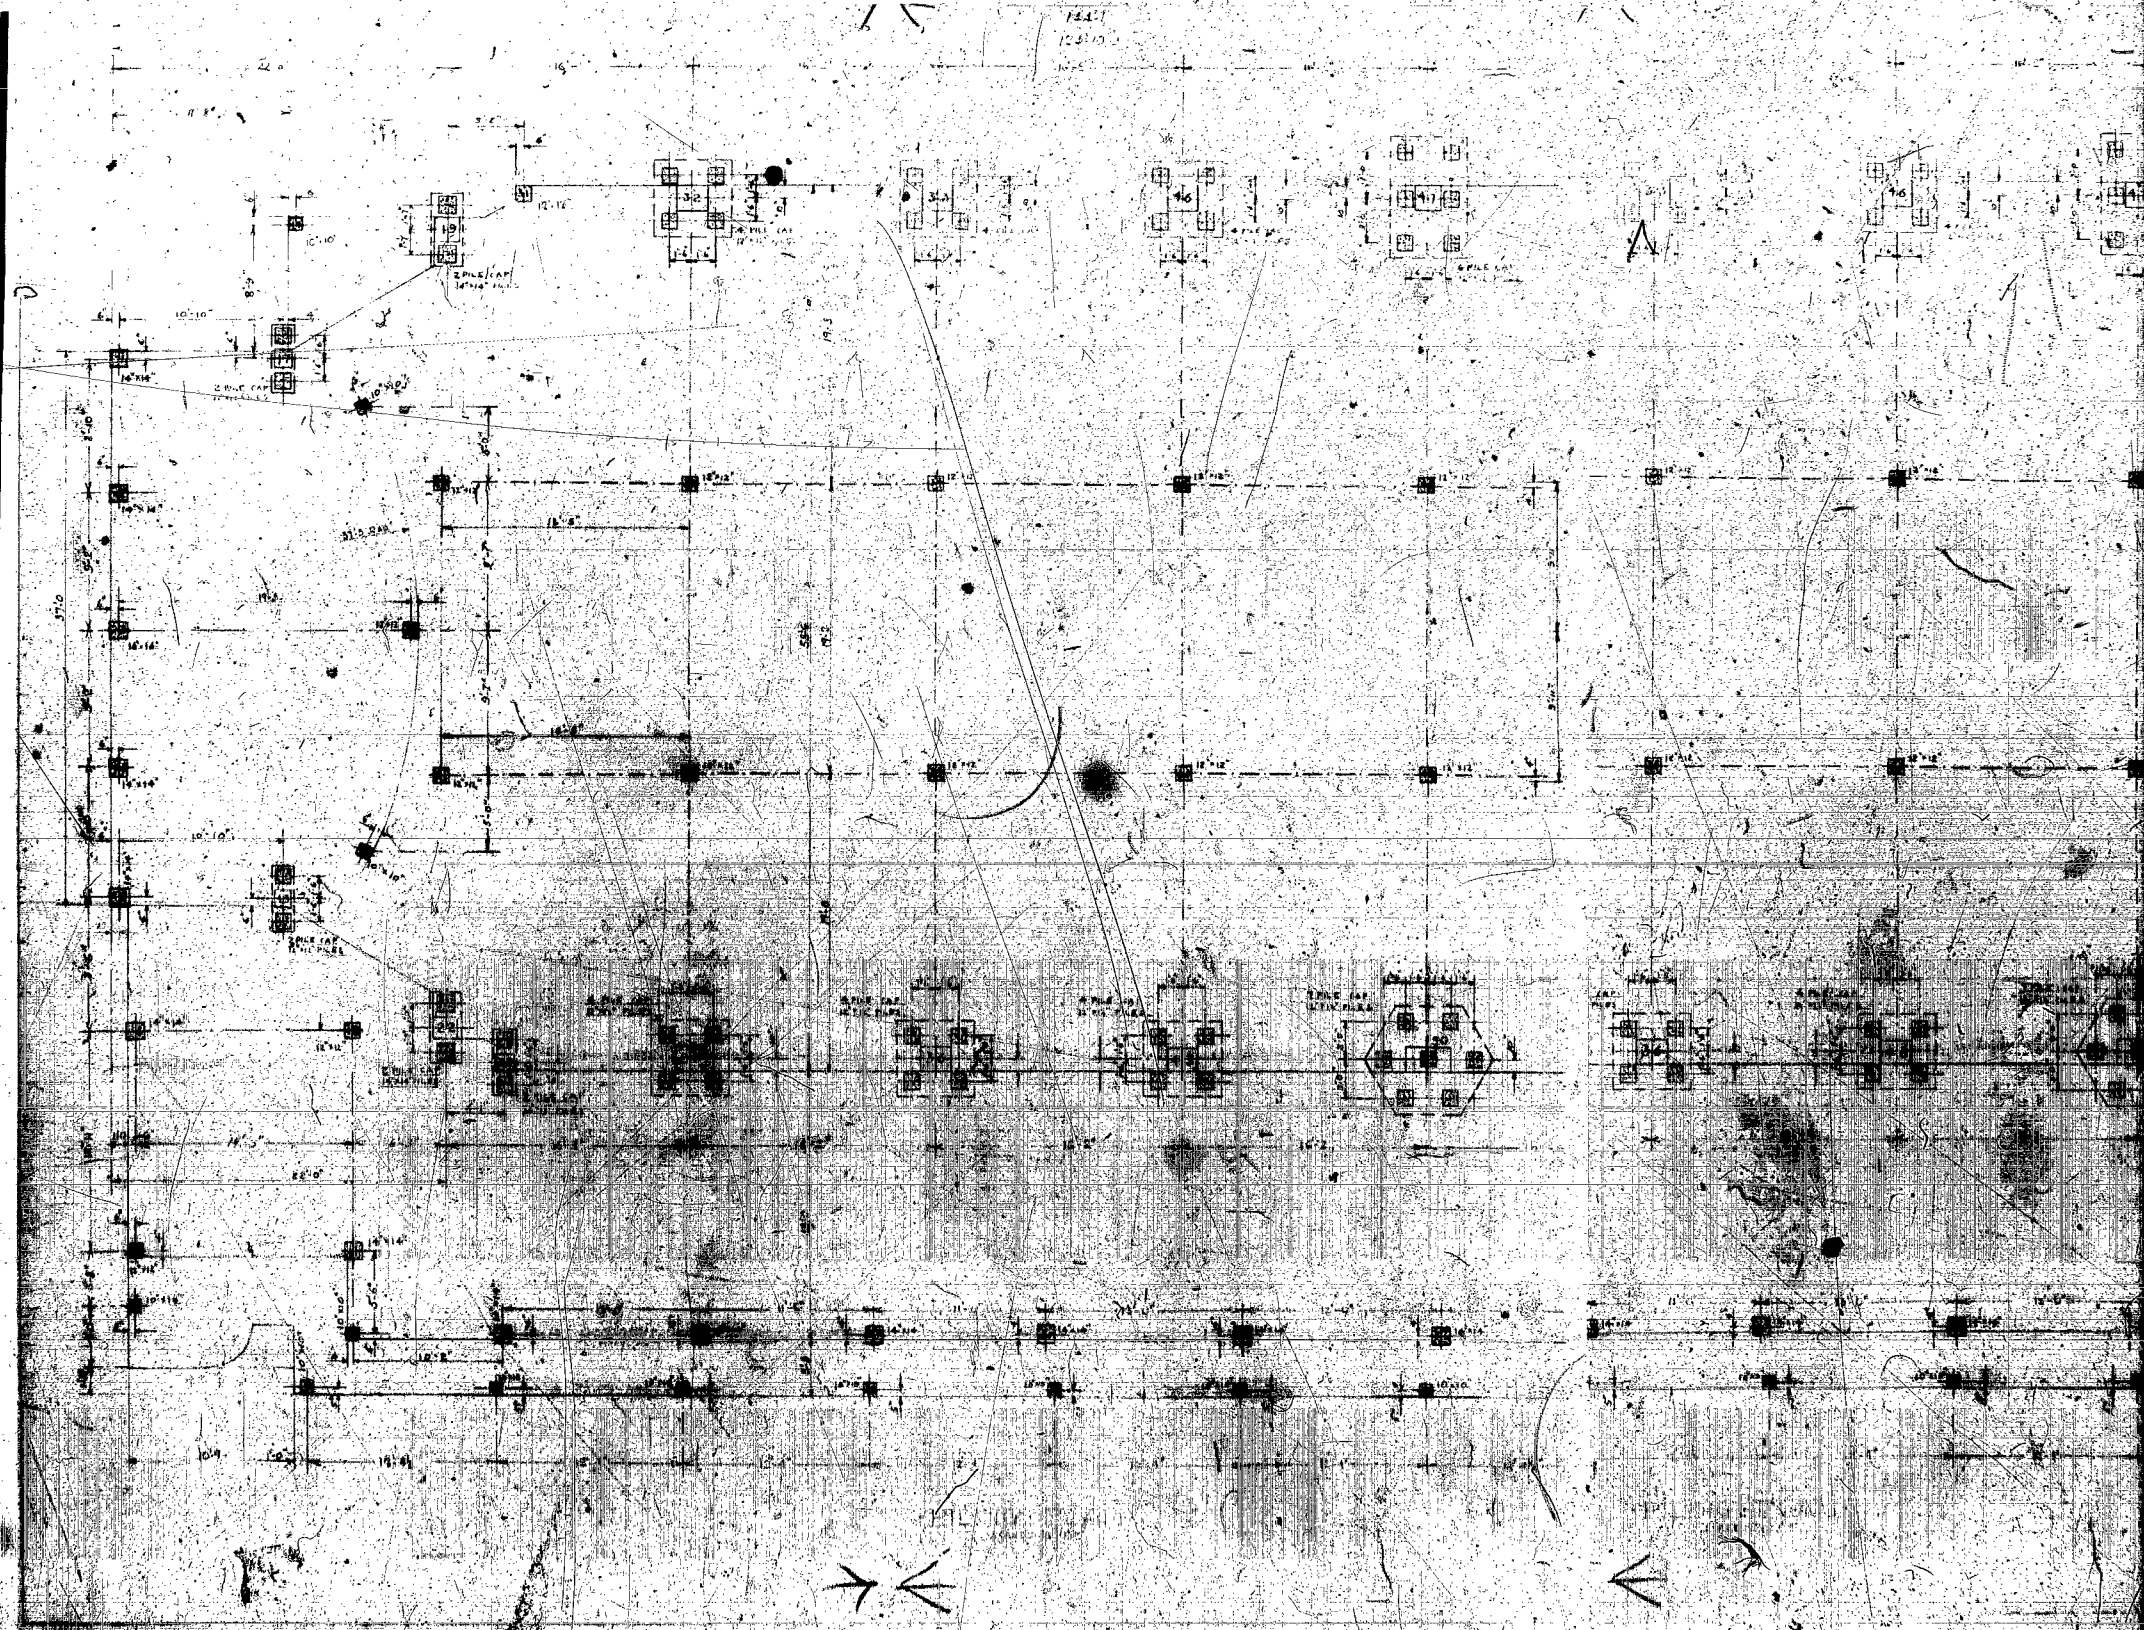


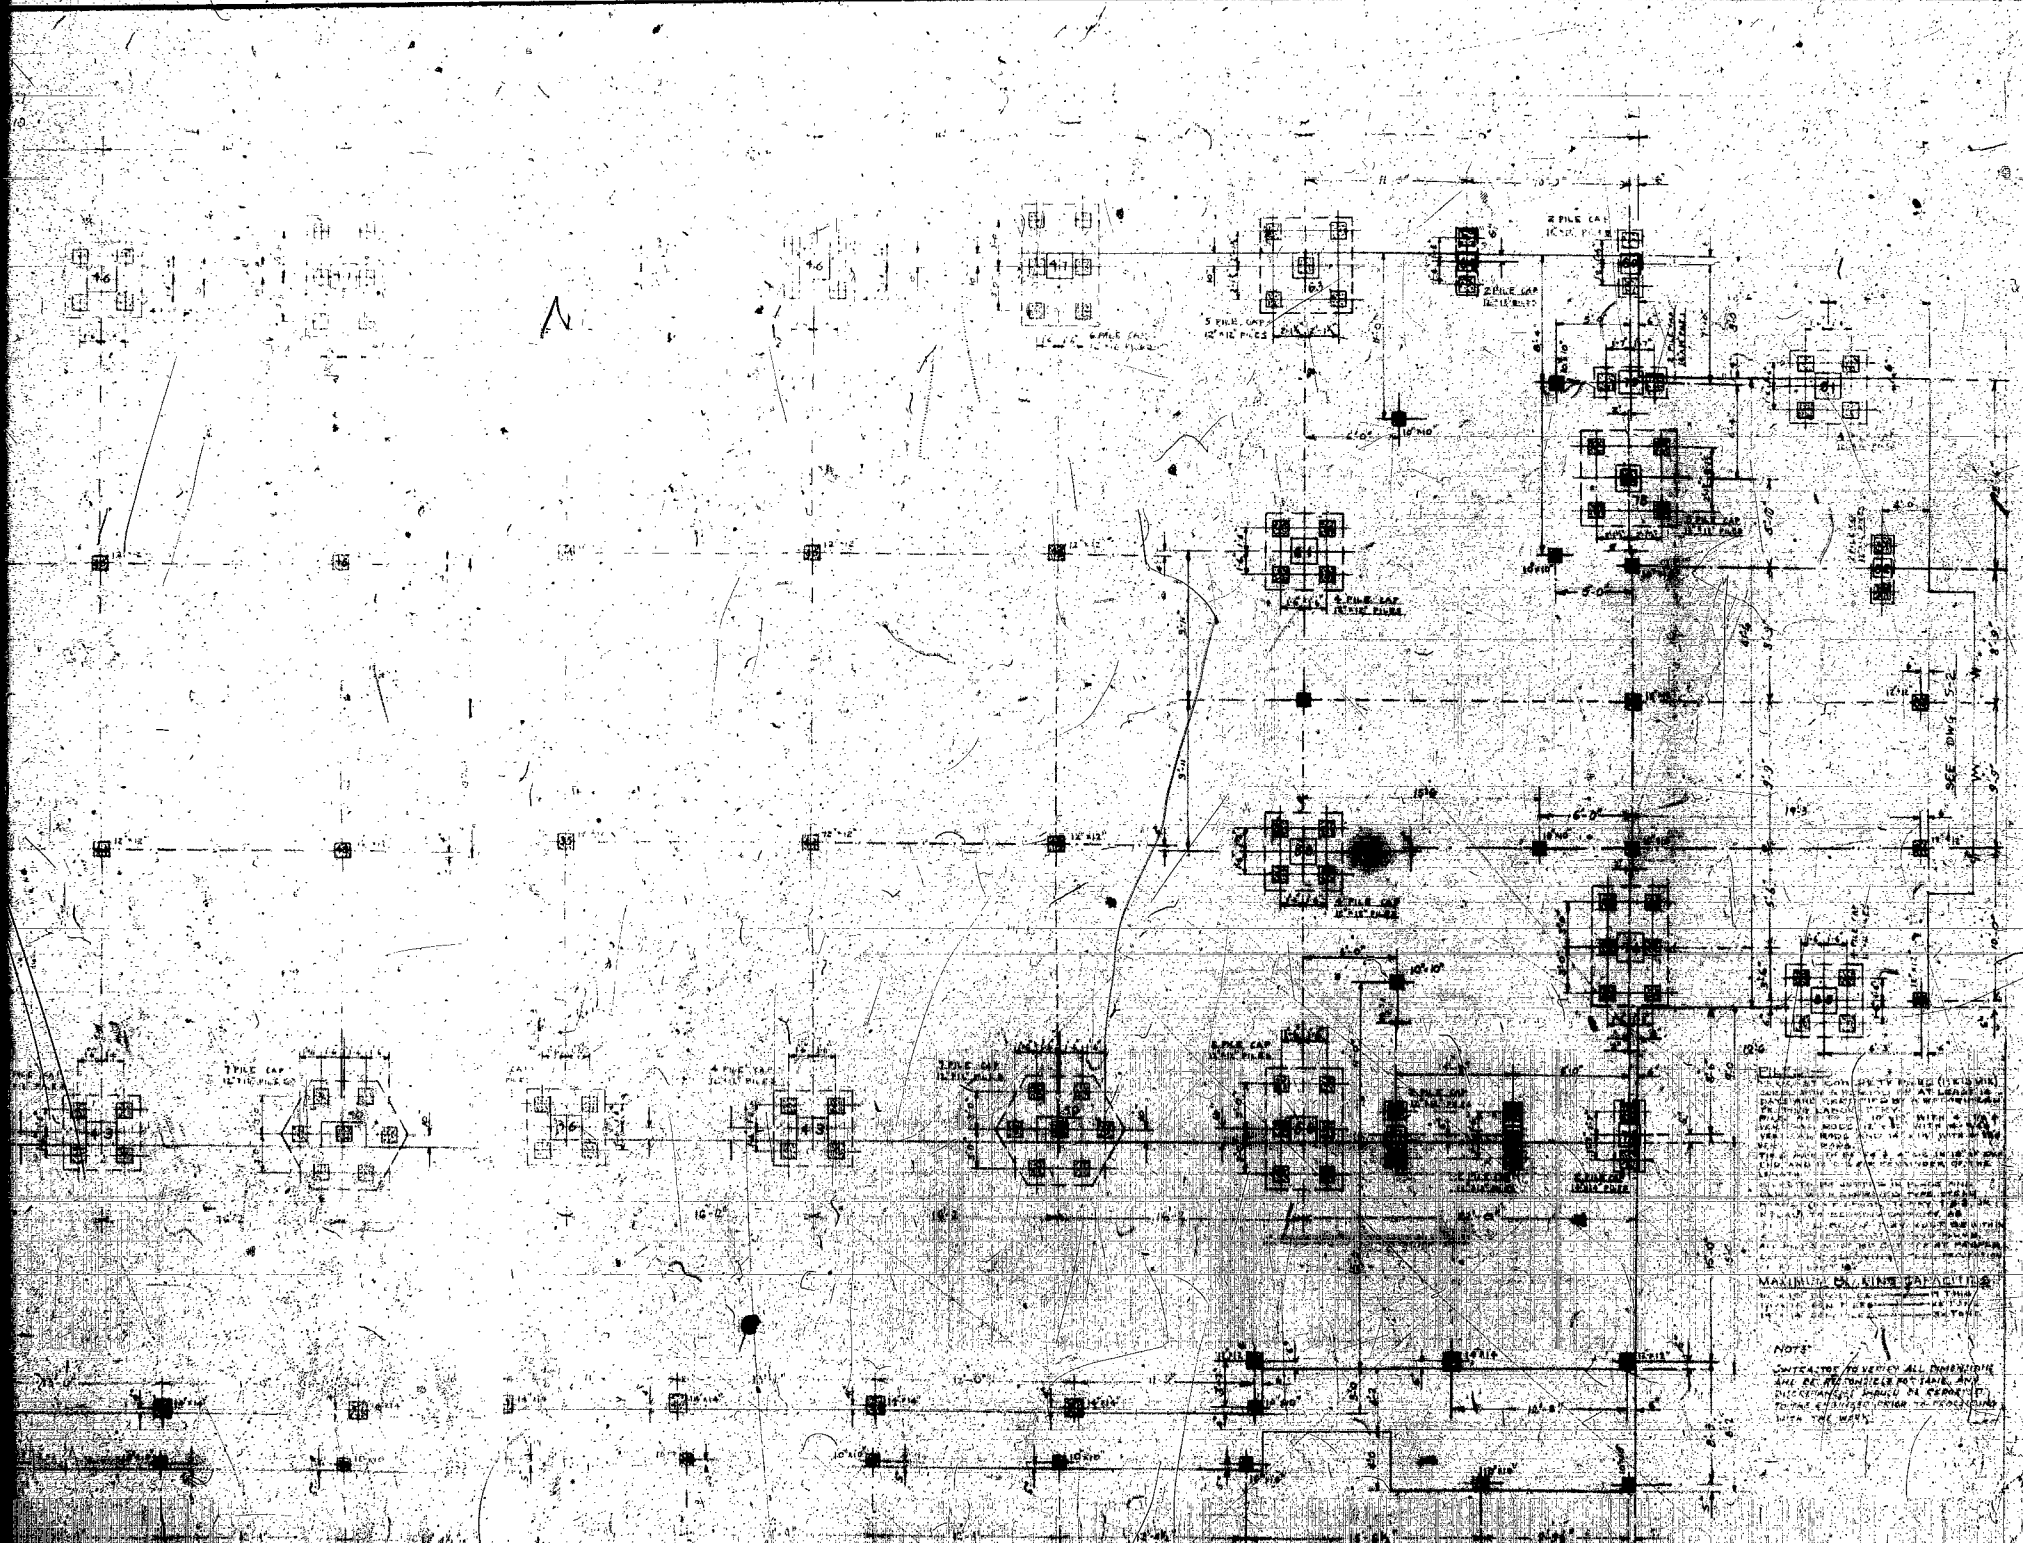

ALL DIMENSIONS SHOWN ON THIS PLAN
 ARE TO BE TAKEN AS SHOWN UNLESS
 OTHERWISE SPECIFIED.
 ALL WORK TO BE DONE IN ACCORDANCE
 WITH THE LATEST EDITIONS OF THE
 NATIONAL BUILDING CODES AND ALL
 LOCAL ORDINANCES AND REGULATIONS.
 THE ARCHITECT ASSUMES NO RESPONSIBILITY
 FOR THE ACCURACY OF THE DATA
 SUPPLIED BY THE CLIENT.
 ALL RIGHTS RESERVED.

NOTE:
 CONTRACTOR TO VERIFY ALL DIMENSIONS
 AND CONDITIONS ON SITE, AND
 TO BE RESPONSIBLE FOR ANY
 DISCREPANCIES BETWEEN THE DRAWING
 AND THE ACTUAL CONDITIONS.
 THE ARCHITECT ASSUMES NO RESPONSIBILITY
 FOR THE ACCURACY OF THE DATA
 SUPPLIED BY THE CLIENT.

ALVIN S. KORNBERG Architect	
Project Name VARIETY THEATRE	Date 1950
Drawing No. 110	Scale 1/8" = 1'-0"
Sheet No. 1	Total Sheets 3
Client MR. J. J. [illegible]	Address [illegible]

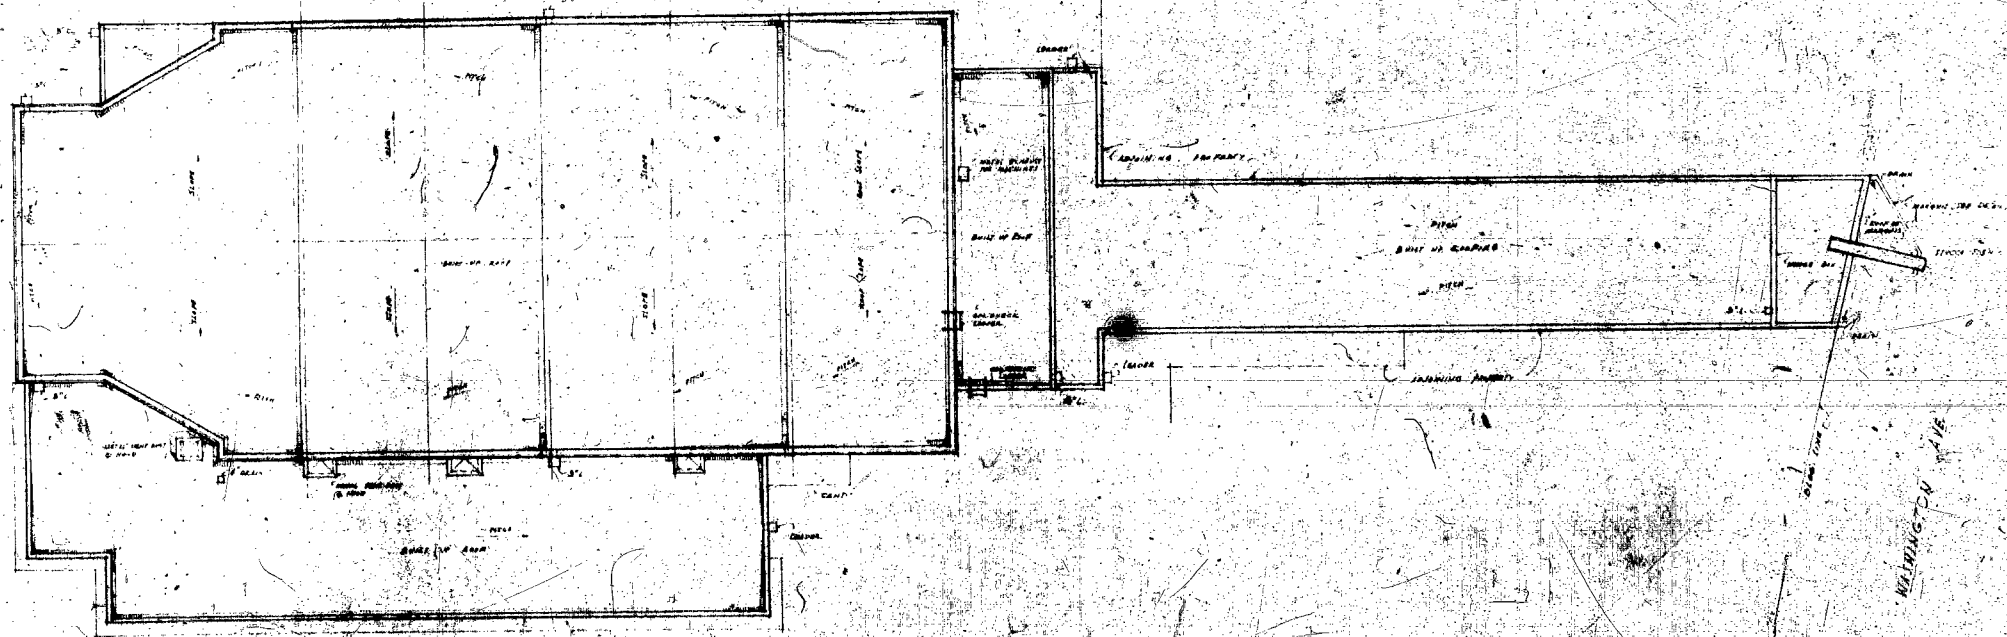

PLAN OF ROOF
SCALE 1/4" = 1'-0"

NO. 1	NO. 2	NO. 3	NO. 4	NO. 5	NO. 6	NO. 7	NO. 8	NO. 9	NO. 10

APPROVED: _____
 DATE: _____
 DRAWN BY: _____
 CHECKED BY: _____
 PROJECT: _____
 SHEET NO. 8