

DRAWING TITLE

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UNIT NUMBER	BLOWER SECTION							COOLING COIL													MANUFACTURER & MODEL								ACCESSORIES		REMARKS																																																																																																																																																																																																																																																																																																																																																																																																																																																																																																																																																																																																																																																																																																																																																																																															
	SUPPLY CFM	TOT. S.P.	O.A. CFM	FAN TYPE	HP	VOLT	Ø	ENT. DEG. °F	LEAVING DEG °F	AIR PRESS.	FACE VEL. (FT./MIN.)	TOTAL CAP. (MBH)	SENSIBLE CAP. (MBH)	CHILLED WATER	COIL CONSTRUCTION	FILTERS	FILTERS	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1- CONTRACTOR SHALL PROVIDE SUBMITTALS OF ALL A/C EQUIPMENT AND CONTROL VALVES TO ENGINEER FOR REVIEW BEFORE INSTALLATION

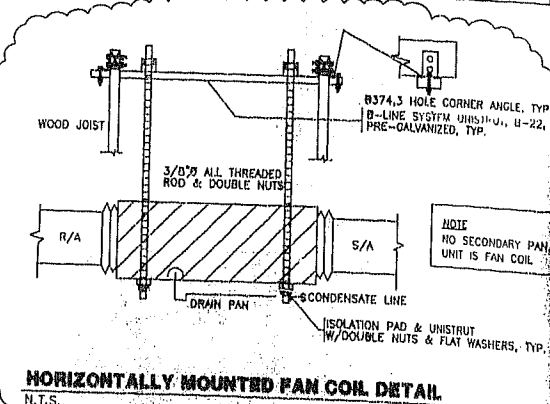
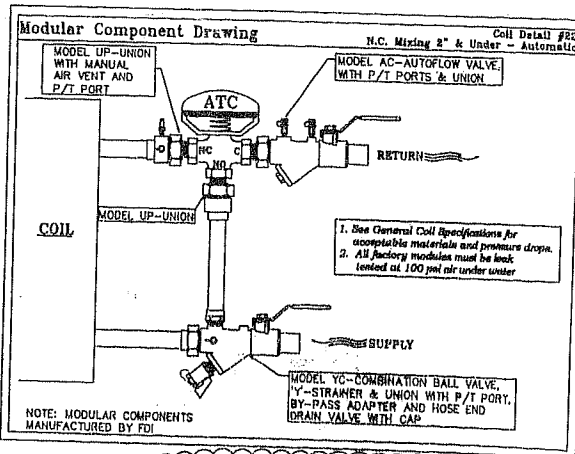
CHILLER SCHEDULE																										
CHILLER NUMBER	NOMINAL CAPACITY TONS	VOLTAGE/ PHASE	EVAPORATOR SECTION						CONDENSER SECTION										COMPRESSOR ELECTRIC DATA				MANUFACTURER & MODEL	REMARKS	ACCESSORIES	
			QUANTITY GPM	TEMP. ENTERING DEG. F	TEMP. LEAVING DEG. F	% GLYCOL MIXTURE	PRESSURE DROP PSI/FL H2O	NUMBER OF CIRCUITS	TEMP. ENTERING DEG. F	TEMP. LEAVING DEG. F	NUMBER OF ROWS/CIR	FINS PER INCH	FACE AREA	COND. FAN TYPE	COND. FAN QUANTITY	COND. FAN FLA	COMPRESSOR NUMBER									
																	MCA	MOPD	RLA	LRA						
CH-1	50	208V/3P	120	55	45	0%	6.5/15	2	95										171	247	152	476	CLIMA COOL MODEL MC2-50-A	1,647 lbs.		

PUMP SCHEDULE									
PUMP NO.	GPM	HEAD	HP	VOLTS/PHASE	MODEL	MANUFACTURER	IMPELLER	COMMENTS	
CWP-1,2	120	55 FT.	5.0	208V/3P	4382, 3x3/8	ARMSTRONG	7.76 IN.	DUPLEX PUMP ARRANGEMENT W/CONTROL FOR ALTERNATE USE	
CTP-1,2	150	55 FT.	5.0	208V/3P	4382, 3x3/8	ARMSTRONG	8.04 IN.	DUPLEX PUMP ARRANGEMENT W/CONTROL FOR ALTERNATE USE	




- 1- PROVIDE SUCTION GUIDE ARMSTRONG MODEL SG-33, 3 IN. INLET AND OUTLET SIZE.
- 2- PROVIDE FLOITEX ARMSTRONG MODEL FTV-2.5A-F, 2.5 IN. INLET & 3 IN. OUTLET SIZE.
- 3- PROVIDE EXPANSION TANK ARMSTRONG MODEL AX-40V.
- 4- PROVIDE A VORTEX AIR SEPARATOR ARMSTRONG MODEL VA-3.

FAN SCHEDULE						
FAN	CFM	S.P.	HP	VOLTS/PHASE	MODEL	ACCESSORIES
EF-1	50	0.1"	1/4	120V/1P	SP-5	GREENHECK

SUPPLY/RETURN AIR DIFFUSER SCHEDULE					
DIFFUSER	NECK SIZE	PATTERN	MANUFACTURER	CATALOG	COMMENTS
A			TITUS	300FL	16x6 SUPPLY REGISTER
B			TITUS	300FL	12x6 SUPPLY REGISTER
1			TITUS	350FL	18x6 RETURN REGISTER
2			TITUS	350FL	12x6 RETURN REGISTER



COOLING TOWER SCHEDULE									
UNIT DESIGNATION					CONDENSER SECTION				
LOCATION					COMPRESSOR ELECTRIC DATA				
TOWER TYPE					MANUFACTURER & MODEL				
NUMBER OF CELLS					REMARKS				
OPERATING WEIGHT, LBS.					ACCESSORIES				
NOMINAL CAPACITY, TONS									
WATER FLOW, GPM									
ENTERING/LEAVING WATER TEMP. °F									
CURRENT AIR TEMP. °F									
STATIC LIFT REQ'D FT H2O									
DRIVE									
NUMBER OF FANS									
FAN WHEEL TYPE & DIAMETER									
FAN MOTOR TYPE									
FAN MOTOR HP									
FAN MOTOR SPEED, RPM									
ELECTRICAL SERVICE #/H/V									
VIBRATION ISOLATOR TYPE (BY TOWER MFR.)									
MIN. STATIC DEFLECTION, IN.									
MANUFACTURER AND MODEL									
MODEL									

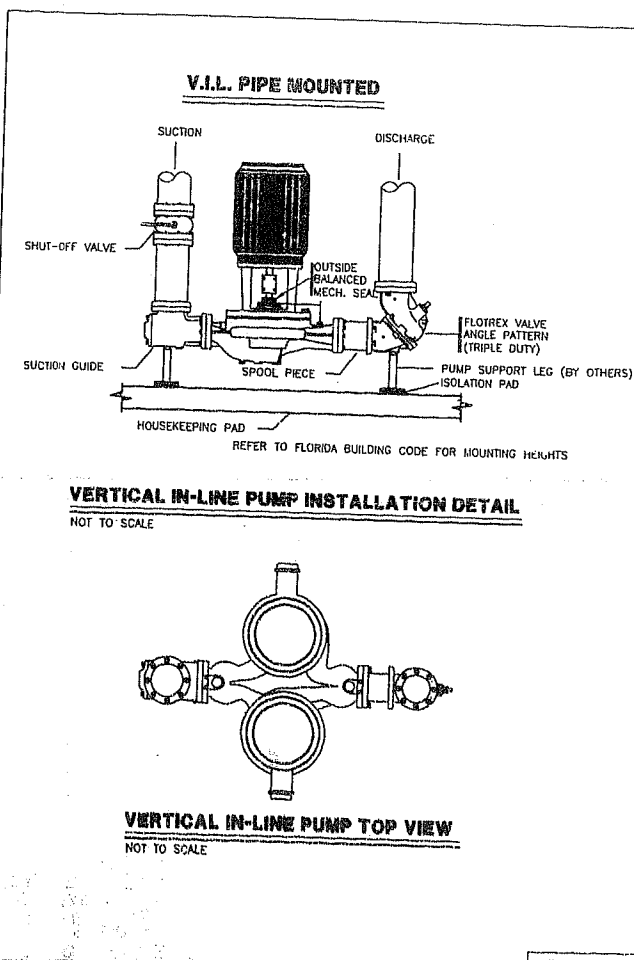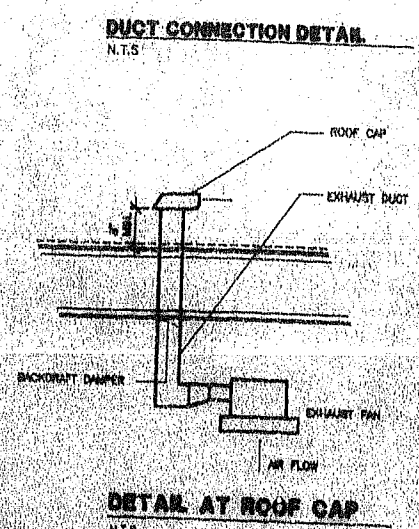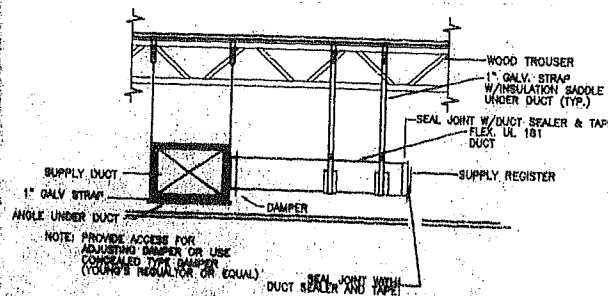

TYPICAL SPECIFICATIONS	
MODEL "AC-110" AIR PRE-CHARGED DAMPHORN EXPANSION TANK	
WORKING PRESSURE: 125 psig	
TANK SHALL BE PROVIDED WITH A HEAVY-DUTY BUTYL DIAPHRAGM	
A HOT SYSTEM CONNECTION, AN AIR CHARGING VALVE CONNECTION	
UPWARD FLOW VALVE SHALL BE ALSO PROVIDED TO FACILITATE	
ADJUSTING PRE-CHARGE PRESSURE, TO MEET THE ACTUAL SYSTEM	
CONDITIONS	

TYPICAL SPECIFICATIONS	
WORKING PRESSURE: 125 psig	
WORKING PRESSURE: 125 psig	

- ### GENERAL NOTES
- 1- SHALL INCLUDE ALL LABOR, EQUIPMENT AND PERFORMING ALL WORK IN CONNECTION WITH THE FURNISHING OF ALL MATERIALS, HEATING AND VENTILATION WORK AS SHOWN ON DRAWINGS HEREIN SPECIFIED AND/OR EQUAL EQUIPMENT FOR.
 - 2- MINOR PIPING AND INSULATION
 - 3- HORIZONTAL RUNS IN COPPER TYPE "L" WITH 1-1/2" FOAMGLASS INSULATION, RUN OUTS TO FAN COIL UNITS MUST BE SOFT COPPER
 - 4- 1" ARMAFLEX INSULATION, CONNECTIONS BETWEEN THE RUN AND THE SOFT COPPER HAVE VICTALIC CONNECTIONS.
 - 5- CONTRACTOR SHALL FURNISH A WRITTEN GUARANTEE COVERING ALL WORKMANSHIP AND MATERIALS FOR A PERIOD OF ONE YEAR FROM DATE OF ACCEPTANCE.
 - 6- CONTRACTOR SHALL PROVIDE POSITIVE MEANS FOR BALANCING EACH INDIVIDUAL AIR CONDITIONING SUPPLY AIR OUTLET, AS PER DRAWINGS AND DRAWINGS. SYSTEMS SHALL BE BALANCED AGAINST ACTUAL INSTALLED STATIC PRESSURE.
 - 7- BEFORE SUBMITTING HIS FINAL PROPOSAL, THE CONTRACTOR SHALL MAKE THE SITE OF THE PROPOSED WORK TO DETERMINE THE EXISTING CONDITIONS THAT MAY AFFECT HIS WORK AS HE WILL BE RESPONSIBLE FOR ANY ASSUMPTIONS MADE BY HIM IN REGARDS HERETO.
 - 8- IF APPARATUS, APPLIANCE, MATERIALS, WORK OR INCIDENTAL ACCESSORIES OR MINOR DETAILS NOT SHOWN BUT NECESSARY TO MAKE THE WORK COMPLETE AND PERFECT IN ALL RESPECTS AND LADY FOR OPERATION, EVEN IF NO PARTICULARLY SPECIFIED SHALL BE PROVIDED BY THE CONTRACTOR WITHOUT ANY ADDITIONAL CHARGE FOR THE OWNER.
 - 9- WORK
 - 10- DUCTWORK SHALL BE FIBERBOARD FOR INDOOR AIR CONDITIONED SUPPLY AND RETURN DUCTWORK AND METAL FOR EXHAUST, AND NON-CONDITIONED OUTSIDE.
 - 11- GLASS FIBER DUCTWORK SHALL BE TOWNS-CORNING? RECTANGULAR DUCT SYSTEM TYPE HD-FR OR EQUAL, 1-1/2" INSULATION R-8.5, CONFORMING TO APPLICATION MANUAL, PUB. # 5-01-2024 & DESIGN GUIDE, PUB. # 5-IN-2617.
 - 12- METAL DUCTS SHALL BE IN ACCORDANCE WITH THE LATEST ISSUE OF THE LOW VELOCITY DUCT CONSTRUCTION STANDARDS, PUBLISHED BY THE "SHEET METAL AND AIR CONDITIONED CONTRACTORS NATIONAL ASSOCIATION, INC." AND THE LATEST PUBLICATION OF GUIDE & DATA BOOK OF THE "AMERICAN SOCIETY OF HEATING, VENTILATING AND AIR CONDITIONING ENGINEERS".
 - 13- CONTRACTOR SHALL ASSUME RESPONSIBILITY FOR ALL COSTS INCURRED RESULTING FROM SUBSTITUTION OF EQUIPMENT AS WELL AS THE PERFORMANCE OF SUCH EQUIPMENT.
 - 14- VIBRATION ISOLATION
 - 15- PROVIDE SUPPORTS OR MOUNTS FOR ALL EQUIPMENT LOCATED WITHIN THE BUILDING STRUCTURE POWERED BY ONE HORSEPOWER OR LARGER MOTOR. FLEXIBLE PIPING CONNECTIONS SHALL BE PROVIDED FOR ALL PIPING CONNECTED TO EQUIPMENT MOUNTED OR SUPPORTED BY VIBRATION ISOLATORS.
 - 16- TESTS
 - 17- ALL TESTS SHALL BE PERFORMED AS REQUIRED DURING THE DIFFERENT STAGES OF WORK AND A FINAL 24 HOURS MINIMUM RUNNING TEST SHALL BE DONE AFTER ALL OTHER TESTS AND BALANCING OPERATIONS HAVE BEEN DONE.
 - 18- CONDENSATE PIPING
 - 19- CONDENSATE PIPING SHALL BE PVC SCHED. 40 EXCEPT IN RETURN AIR PLENUM SPACES WHERE COPPER PIPING MUST BE USED
 - 20- TEST AND BALANCE OF ALL EQUIPMENT SHALL BE PERFORMED BY AN INDEPENDENT TEST AND BALANCE COMPANY WITH A MINIMUM OF 5 YEARS EXPERIENCE IN PROJECTS OF THIS SIZE OR LARGER. THREE COPIES OF THE TEST AND BALANCE REPORT SHALL BE SUBMITTED TO THE ENGINEER FOR REVIEW.

TRAC DESIGN REQUIREMENTS	YES	NO
DUCT WORK DETECTOR		X
FIRE SUPPERS		X
SMOKE DAMPERS		X
SMOKE ENCLOSEURE		X
FIRE WHEE ROOF/FLOOR		X
CEILING ASSEMBLY		X
DUCT SUPPORT	X	
SMOKE CONTROL		X

DATE: 9/12/03

BY: [Signature]

PROJECT # 0304-053



ALISON SPEAR, A.I.A.
180 NE 38th St. SUITE 222, MIAMI, FL 33137
305-438-1200 fax 305-438-1221

PROJECT ARCHITECT

SEAL

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PROJECT TITLE

LIDO SPA HOTEL
EAST WING - RENOVATION
40 ISLAND AVENUE, MIAMI BEACH, FL 33139

DRAWING TITLE

EAST WING
H.V.A.C NOTES AND DETAILS

DRAWN BY: M.G.

CHECKED BY: R.J.M.

ISSUES

07/11/03

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AIR HANDLING UNIT SCHEDULE																											
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	SUPPLY CFM	TOT. S.P.	O.A. CFM	FAN TYPE	HP	VOLT	β	ENT. DEG. °F	LEAVING DEG. °F	AIR PRESS. DROP IN. W.G.	FACE VEL. (FT./MIN.)	TOTAL CAP. (MBH)	SENSIBLE CAP. (MBH)	CHILLED WATER		COIL CONSTRUCTION		FILTERS			P.D.M. BRANCH DIAMETER						
								D.B. W.B. D.B. W.B.	TYPE			ENT. TEMP.	LEAVING TEMP.	GPM	RINGS	FINS PER INCH	CIRCUIT TYPE	FILTER TYPE	FILTER AREA	FACE VELOCITY							
1	540	.25	50	FC	1/8	208	1	90.0	57.00	39.6	57.8	16.0	11.9	FW	45	55	3.0	3	—	—	TA	—	—	YORK MODEL 6YFHC-3	3/4"	PROVIDE WITH A 1.0 K.W. HEATER	HORIZONTAL CONCEALED

NOTE: CONTRACTOR SHALL PROVIDE SUBMITTALS OF ALL A/C EQUIPMENT AND CONTROL VALVES TO ENGINEER FOR REVIEW BEFORE INSTALLATION.



CHILLER SCHEDULE																											
CHILLER NUMBER	NOMINAL CAPACITY TONS	VOLTAGE/ PHASE	EVAPORATOR SECTION						CONDENSER SECTION						COMPRESSOR ELECTRIC DATA						MANUFACTURER & MODEL	REMARKS	ACCESSORIES				
			QUANTITY GPM	TEMP. ENTERING DEG. F	TEMP. LEAVING DEG. F	% GLYCOL MIXTURE	PRESSURE DROP P/100 FT. H2O	NUMBER OF CIRCUITS	TEMP. ENTERING DEG. F	TEMP. LEAVING DEG. F	NUMBER OF ROWS/CIR.	FINS PER INCH	FACE AREA	COND. FAN TYPE	COND. FAN QUANTITY	COND. FAN FLA	COMPRESSOR NUMBER										
																	MCA	MOPD	RLA	LRA							
CH-1	50	208V/3ø	120	55	45	0%	6.5/15	2	95												171	247	152	476	CLIMA COOL MODEL MC2-50-A		

PUMP SCHEDULE									
PUMP NO.	GPM	HEAD	HP	VOLTS/PHASE	MODEL	MANUFACTURER	IMPELLER	COMMENTS	
CWP-1,2	120	55 FT.	5.0	208V/3φ	4382, 3x3x8	ARMSTRONG	7.76 IN.	DUPLX PUMP ARRANGEMENT W/CONTROL FOR ALT. USE	
CIP-1,2	150	55 FT.	5.0	208V/3φ	4382, 3x3x8	ARMSTRONG	8.04 IN.	DUPLX PUMP ARRANGEMENT W/CONTROL FOR ALT. USE	

- 1- PROVIDE SUCTION GUIDE ARMSTRONG MODEL SG-33, 3 IN. INLET AND OUTLET SIZE
- 2- PROVIDE FLOREX ARMSTRONG MODEL FTV-2.5A-F, 2.5 IN. INLET & 3 IN. OUTLET SIZE
- 3- PROVIDE EXPANSION TANK ARMSTRONG MODEL AX-40V
- 4- PROVIDE A VORTEX AIR SEPARATOR ARMSTRONG MODEL VA-3.


FAN SCHEDULE						
FAN	CFM	S.P.	HP	VOLTS/PHASE	MODEL	ACCESSORIES
CF-1	80	0.1"	1/4	120V/1φ	SP-5	GREENHECK

SUPPLY/RETURN AIR DIFFUSER SCHEDULE					
DIFFUSER	NECK SIZE	PATTERN	MANUFACTURER	CATALOG	COMMENTS
A			TIUS	300FL	16x8 SUPPLY REGISTER
B			TIUS	300FL	12x6 SUPPLY REGISTER
1			TIUS	350FL	16x8 RETURN REGISTER
2			TIUS	350FL	12x6 RETURN REGISTER

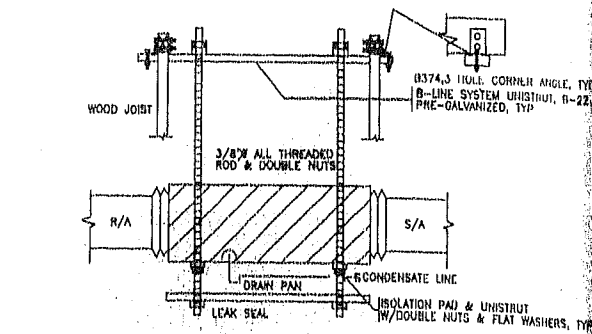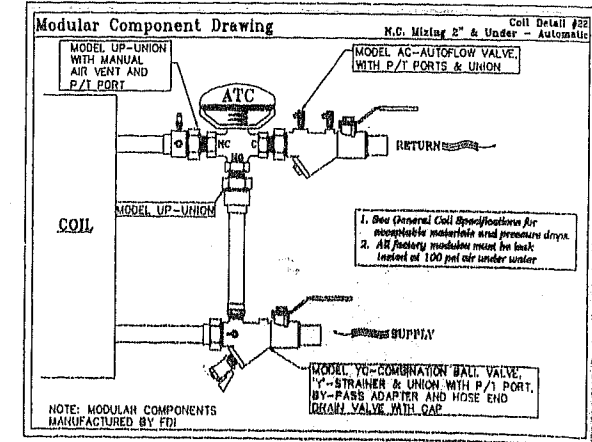


HORIZONTALLY MOUNTED AHU DETAIL
N.T.S.


COOLING TOWER SCHEDULE	
UNIT DESIGNATOR	
LOCATION	MECHANICAL ROOM
TOWER TYPE	SIDE DISCHARGE
NUMBER OF CELLS	1
OPERATING WEIGHT, LBS.	2948
NOMINAL CAPACITY, TONS	50
WATER FLOW, GPM	150
ENTERING/LEAVING WATER TEMP. °F	95/85
AMBIENT AIR TEMP. °F	-
STATIC LIFT REQ'D FT. H2O	7.89
DRIVE	-
NUMBER OF FANS	1
FAN WHEEL TYPE & DIAMETER	4 BLADES, 4 FT
FAN MOTOR TYPE	-
FAN MOTOR HP	2
FAN MOTOR SPEED, RPM	495
ELECTRICAL SERVICE	3/80/208
VIBRATION ISOLATOR TYPE (BY TOWER MFR.)	-
MIN. STATIC DEFLECTION, IN.	-
MANUFACTURER AND MODEL	WARLEY AQUATOWER
MODEL	494A

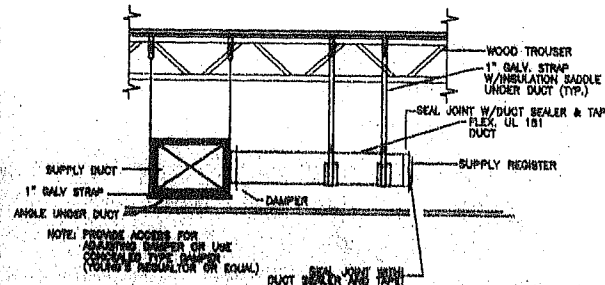


DUCT CONNECTION DETAIL
N.T.S.

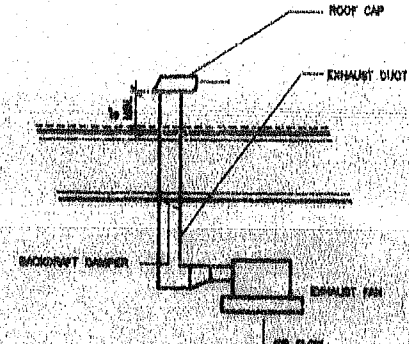

DETAIL AT ROOF CAP
N.T.S.

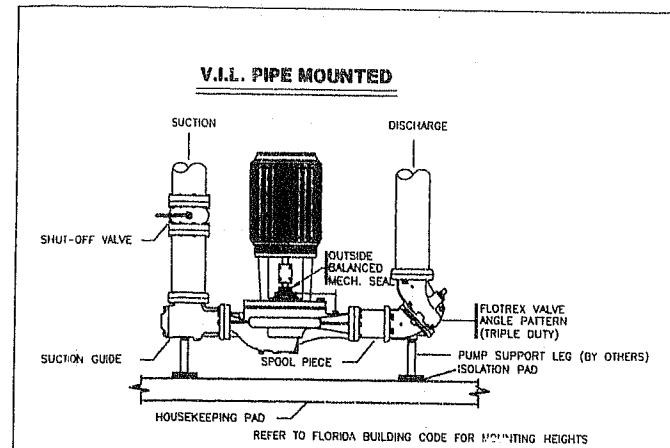

VERTICAL IN-LINE PUMP INSTALLATION DETAIL
NOT TO SCALE

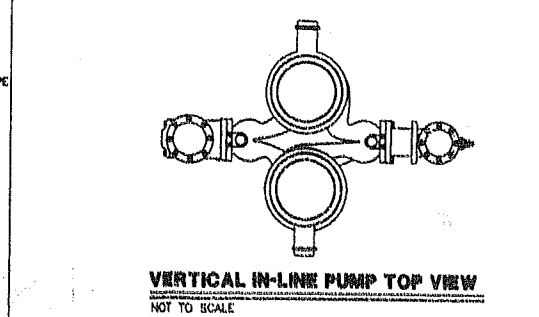

TYPICAL SPECIFICATIONS

CONDENSATE PIPING SHALL BE PVC SCHED. 40 EXCEPT IN RETURN AIR PLenums SPACES WHERE COPPER PIPING MUST BE USED

TYPICAL SPECIFICATIONS

CONDENSATE PIPING SHALL BE PVC SCHED. 40 EXCEPT IN RETURN AIR PLenums SPACES WHERE COPPER PIPING MUST BE USED

- ### GENERAL NOTES
1. ALL WORK SHALL INCLUDE ALL LABOR, EQUIPMENT AND PERFORMING ALL MATERIALS IN CONNECTION WITH THE FURNISHING OF ALL AIR CONDITIONING, HEATING AND VENTILATION WORK AS SHOWN ON DRAWINGS, HEREIN SPECIFIED AND/OR EQUAL EQUIPMENT FOR REMOVAL.
 2. WATER PIPING AND INSULATION SHALL BE COPPER TYPE "L" WITH 1-1/2" FOAMGLASS INSULATION. RUN OUTS TO FAN COIL UNITS MUST BE SOFT COPPER. 1/4" 1" ARMAFLEX INSULATION CONNECTIONS BETWEEN THE FAN RUN AND THE SOFT COPPER HAVE VITAJUG CONNECTIONS.
 3. CONTRACTOR SHALL FURNISH A WRITTEN GUARANTEE COVERING ALL MATERIALS AND MATERIALS FOR A PERIOD OF ONE YEAR FROM DATE OF ACCEPTANCE.
 4. CONTRACTOR SHALL PROVIDE POSITIVE MEANS FOR BALANCING EACH INDIVIDUAL AIR CONDITIONING SUPPLY AIR OUTLET, AS PER SCHEDULES AND DRAWING. SYSTEMS SHALL BE BALANCED AGAINST THE ACTUAL INSTALLED STATIC PRESSURE.
 5. BEFORE SUBMITTING HIS FINAL PROPOSAL, THE CONTRACTOR SHALL EXAMINE THE SITE OF THE PROPOSED WORK TO DETERMINE THE EXISTING CONDITIONS THAT MAY AFFECT HIS WORK AS HE WILL BE RESPONSIBLE FOR ANY ASSUMPTIONS MADE BY HIM IN REGARDS HERETO.
 6. ANY APPARATUS, APPLIANCE, MATERIALS, WORK OR INCIDENTAL ACCESSORIES OR MINOR DETAILS NOT SHOWN BUT NECESSARY TO MAKE THE WORK COMPLETE AND PERFECT IN ALL RESPECTS AND READY FOR OPERATION, EVEN IF NO PARTICULARLY SPECIFIED SHALL BE PROVIDED BY THE CONTRACTOR WITHOUT ANY ADDITIONAL EXPENSE FOR THE OWNER.
 7. CONTRACTOR SHALL ASSUME RESPONSIBILITY FOR ALL COSTS INCURRED RESULTING FROM SUBSTITUTION OF EQUIPMENT AS WELL AS THE PERFORMANCE OF SUCH EQUIPMENT.
 8. VIBRATION ISOLATION PROVIDE SUPPORTS OR MOUNTS FOR ALL EQUIPMENT LOCATED WITHIN THE BUILDING STRUCTURE POWERED BY ONE HORSEPOWER OR LARGER MOTOR. FLEXIBLE PIPING CONNECTIONS SHALL BE PROVIDED FOR ALL PIPING CONNECTED TO EQUIPMENT MOUNTED OR SUPPORTED BY VIBRATION ISOLATORS.
 9. TESTS ALL TESTS SHALL BE PERFORMED AS REQUIRED DURING THE DIFFERENT STAGES OF WORK AND A FINAL 24 HOURS MINIMUM RUNNING TEST SHALL BE DONE AFTER ALL OTHER TESTS AND BALANCING OPERATIONS HAVE BEEN DONE.
 10. CONDENSATE PIPING CONDENSATE PIPING SHALL BE PVC SCHED. 40 EXCEPT IN RETURN AIR PLenums SPACES WHERE COPPER PIPING MUST BE USED
 11. TEST AND BALANCE OF ALL EQUIPMENT SHALL BE PERFORMED BY AN INDEPENDENT TEST AND BALANCE COMPANY WITH A MINIMUM OF 5 YEARS EXPERIENCE IN PROJECTS OF THIS SIZE OR LARGER. THREE COPIES OF THE TEST AND BALANCE REPORT SHALL BE SUBMITTED TO THE ENGINEER FOR REVIEW.

OFFICE COPY
CITY OF MIAMI BEACH
APPROVED FOR PERMIT BY THE FOLLOWING:

BUILDING: _____
ZONING: _____
DRAWING: _____
CONCURRENCY: _____
PLUMBING: _____
ELECTRICAL: _____
MECHANICAL: _____
FIRE PREVENTION: _____
ENGINEERING: _____
PUBLIC WORKS: _____
STRUCTURAL: _____
ACCESSIBILITY: _____
ELEVATORS: _____

As per Florida Building Code Section 104.5.3
PROJECT REVIEWED FOR CODE COMPLIANCE

PREPARED BY:
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Professional Electrical/Mechanical Engineers

PROJECT ARCHITECT
ALISON SPEAR, A.I.A.
180 NE 39th St., Suite 222, Miami, FL 33137
305-438-1200 fax 305-438-1221

PROJECT TITLE
LIDO SPA HOTEL
EAST WING - RENOVATION
40 ISLAND AVENUE, MIAMI BEACH, FL 33139

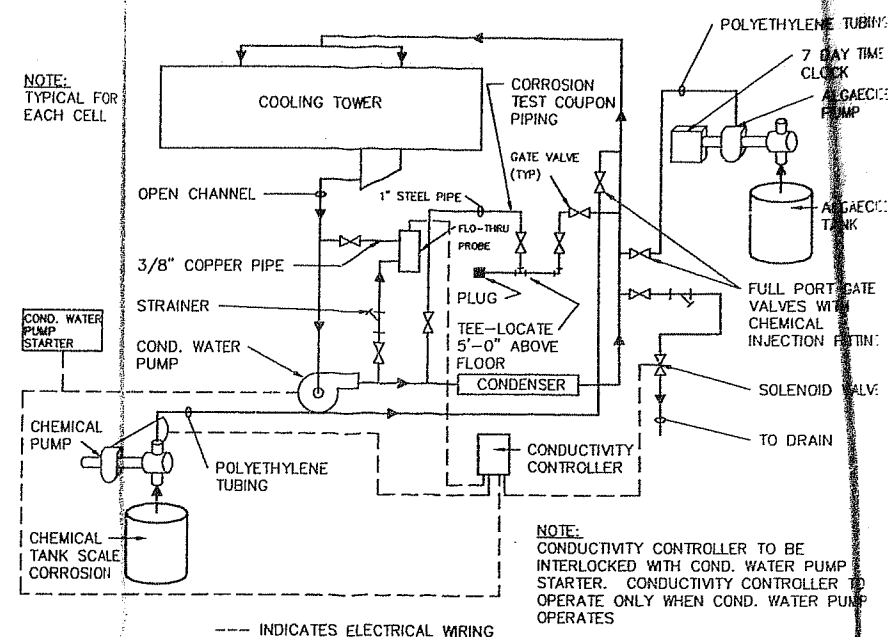
DRAWING TITLE
H.V.A.C NOTES AND DETAILS

DRAWN BY M.G.
CHECKED BY R.J.M.
ISSUES

SHEET NO.
M-2



- 1- PROVIDE BYPASS TYPE CHEMICAL FEEDER FOR CHILLED WATER SYSTEM AS MANUFACTURED BY WOODWARD 5.L.P
- 2- CHEMICALS SHALL BE EPA REGISTERED.
- 3- PROVIDE SUPPORT STAND
- 4- INSULATED SHOT FEEDER SUPPLY AND DISCHARGE LINES FOR A DISTANCE OF 6 FEET FROM THE CHILLED WATER LINE TAP.



WATER TREATMENT DIAGRAM

N.T.S.

ASHRAE STANDARD 62-1989 OUTSIDE AIR CALCULATIONS
Project # 0304-053

Date: 5/15/2003

Name: **LIDO SPA HOTEL/ EAST WING**

Address: 40 ISLAND AVENUE
MIAMI BEACH, FL. 33139

Application: **ROOM**

Area: 230 sq.ft.

Area factor: 100.00%

Occupancy: P/1000 sq.ft.

Total Occupancy: People

Outdoor Air 30 cfm/room

Total Outside Air: 30 cfm

OFFICE COPY
CITY OF MIAMI BEACH
APPROVED FOR PERMIT BY
THE FOLLOWING:

BUILDING: _____
ZONING: map 7-2/3 ✓
DRB/HPB: _____
CONCURRENCY: _____
PLUMBING: _____
ELECTRICAL: _____
MECHANICAL: SP
FIRE PREVENTION: _____
ENGINEERING: _____
PUBLIC WORKS: _____
STRUCTURAL: _____
ACCESSIBILITY: _____
ELEVATOR: _____

As per Florida Building Code Section 104.5.3
REVIEWED FOR CODE COMPLIANCE

PROJECT #: 0304-053
PREPARED BY:

UCI Engineering Inc.
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E-MAIL: uci@ucieng.com
R. J. MIRANDA PE NO. 35579
DAVID A. BELSKY PE NO. 37234
Professional Electrical/Mechanical
Engineers

PROJECT ARCHITECT

SEAL

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CT TITLE

LIDO SPA HOTEL
1000 LIDO AVENUE, MIAMI BEACH, FL 33139

EAST WING - RENOVATION
1000 LIDO AVENUE, MIAMI BEACH, FL 33139

DRAWING TITLE
EAST WING H.V.A.C NOTES AND DETAILS

DRAWN BY	M.G.
CHECKED BY	R.J.M.
ISSUES	

27/1/83 PERMIT JET

SHEET NO.

M-3

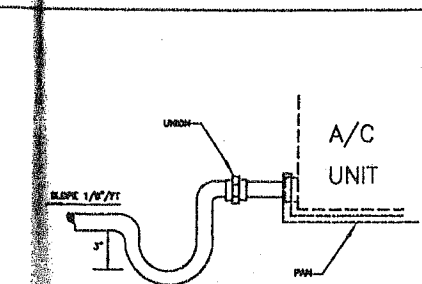
PLUMBING NOTES

1. THE CONTRACTOR SHALL VERIFY EXACT LOCATION AND SIZES OF ALL EXISTING LINES AND EXTEND AS REQUIRED.
2. NO JOINTS ALLOWED UNDER SLAB FOR WATER LINES.
3. SIZE AND GRADE HORIZONTAL DRAINAGE PIPING 2" AND SMALLER 1/4" AND 3" ABOVE 1/8" SLOPE PER FEET.
4. PROVIDE ANTI-SCALD VALVE TO THE BATH TUBS, SHOWERS, SINKS AND LAVATORIES.
5. CONDENSATE TRAP DETAIL NOT TO SCALE.
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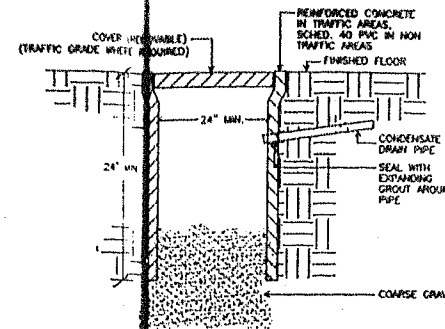
NOTE:
CONTRACTOR SHALL VERIFY EXACT LOCATION AND SIZES OF ALL EXISTING LINES AND EXTEND AS REQUIRED.

NO JOINTS ALLOWED UNDER SLAB FOR WATER LINES.
SIZE AND GRADE HORIZONTAL DRAINAGE PIPING 2" AND SMALLER 1/4" AND 3" ABOVE 1/8" SLOPE PER FEET.

PROVIDE ANTI-SCALD VALVE TO THE BATH TUBS, SHOWERS, SINKS AND LAVATORIES.




CONDENSATE TRAP DETAIL
NOT TO SCALE



DRYWELL DETAIL
NOT TO SCALE

PLUMBING LEGEND	
SYMBOL	DESCRIPTION
— CD —	CONDENSATE LINE
— FD —	FLOOR DRAIN
— AFF —	ABOVE FINISHED FLOOR

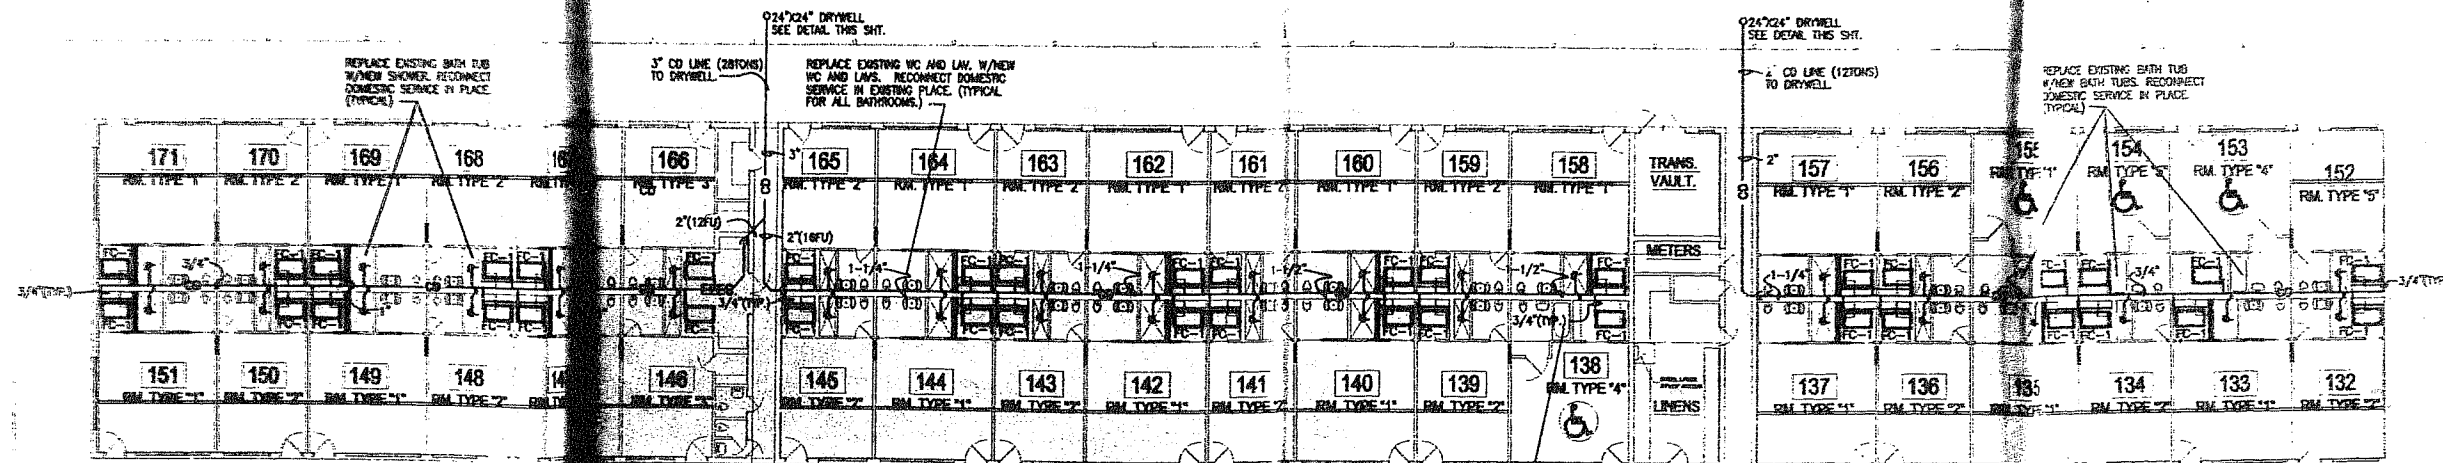NOTE:
PROVIDE FLOAT SWITCH IN PAN TO SHUT DOWN UNIT UPON ACTIVATION.



EAST WING PLUMBING FLOOR PLAN
SCALE: 1/8" = 1'-0"

2nd FLR. MECH. ROOM
SCALE: 1/8" = 1'-0"

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CITY OF MIAMI BEACH
APPROVED FOR PERMIT BY THE FOLLOWING:

BUILDING: _____
CONING: _____
DRB/HP: _____
CONCURRENCY: _____
PLUMBING: _____
ELECTRICAL: _____
MECHANICAL: _____
FIRE PREVENTION: _____
ENGINEERING: _____
PUBLIC WORKS: _____
STRUCTURAL: _____
ACCESSIBILITY: _____
ELEVATOR: _____

As per Florida Building Code Section 104.2
REVIEWED FOR CODE COMPLIANCE

PROJECT #: 0304-053
PREPARED BY:


UCI Engineering Inc.
13780 S.W. 56th Street, Suite 205
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Fax: (305) 383-8949
E-Mail: uci@ucieng.com
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Professional Electrical/Mechanical Engineers

ALISON SPEAR, A.I.A.
180 NE 38th St., Suite 222, Miami, FL 33137
305-438-1200 Fax 305-438-1221


LIDO SPA HOTEL
EAST WING - RENOVATION
40 ISLAND AVENUE, MIAMI BEACH, FL 33139

EAST WING
PLUMBING FLOOR PLAN

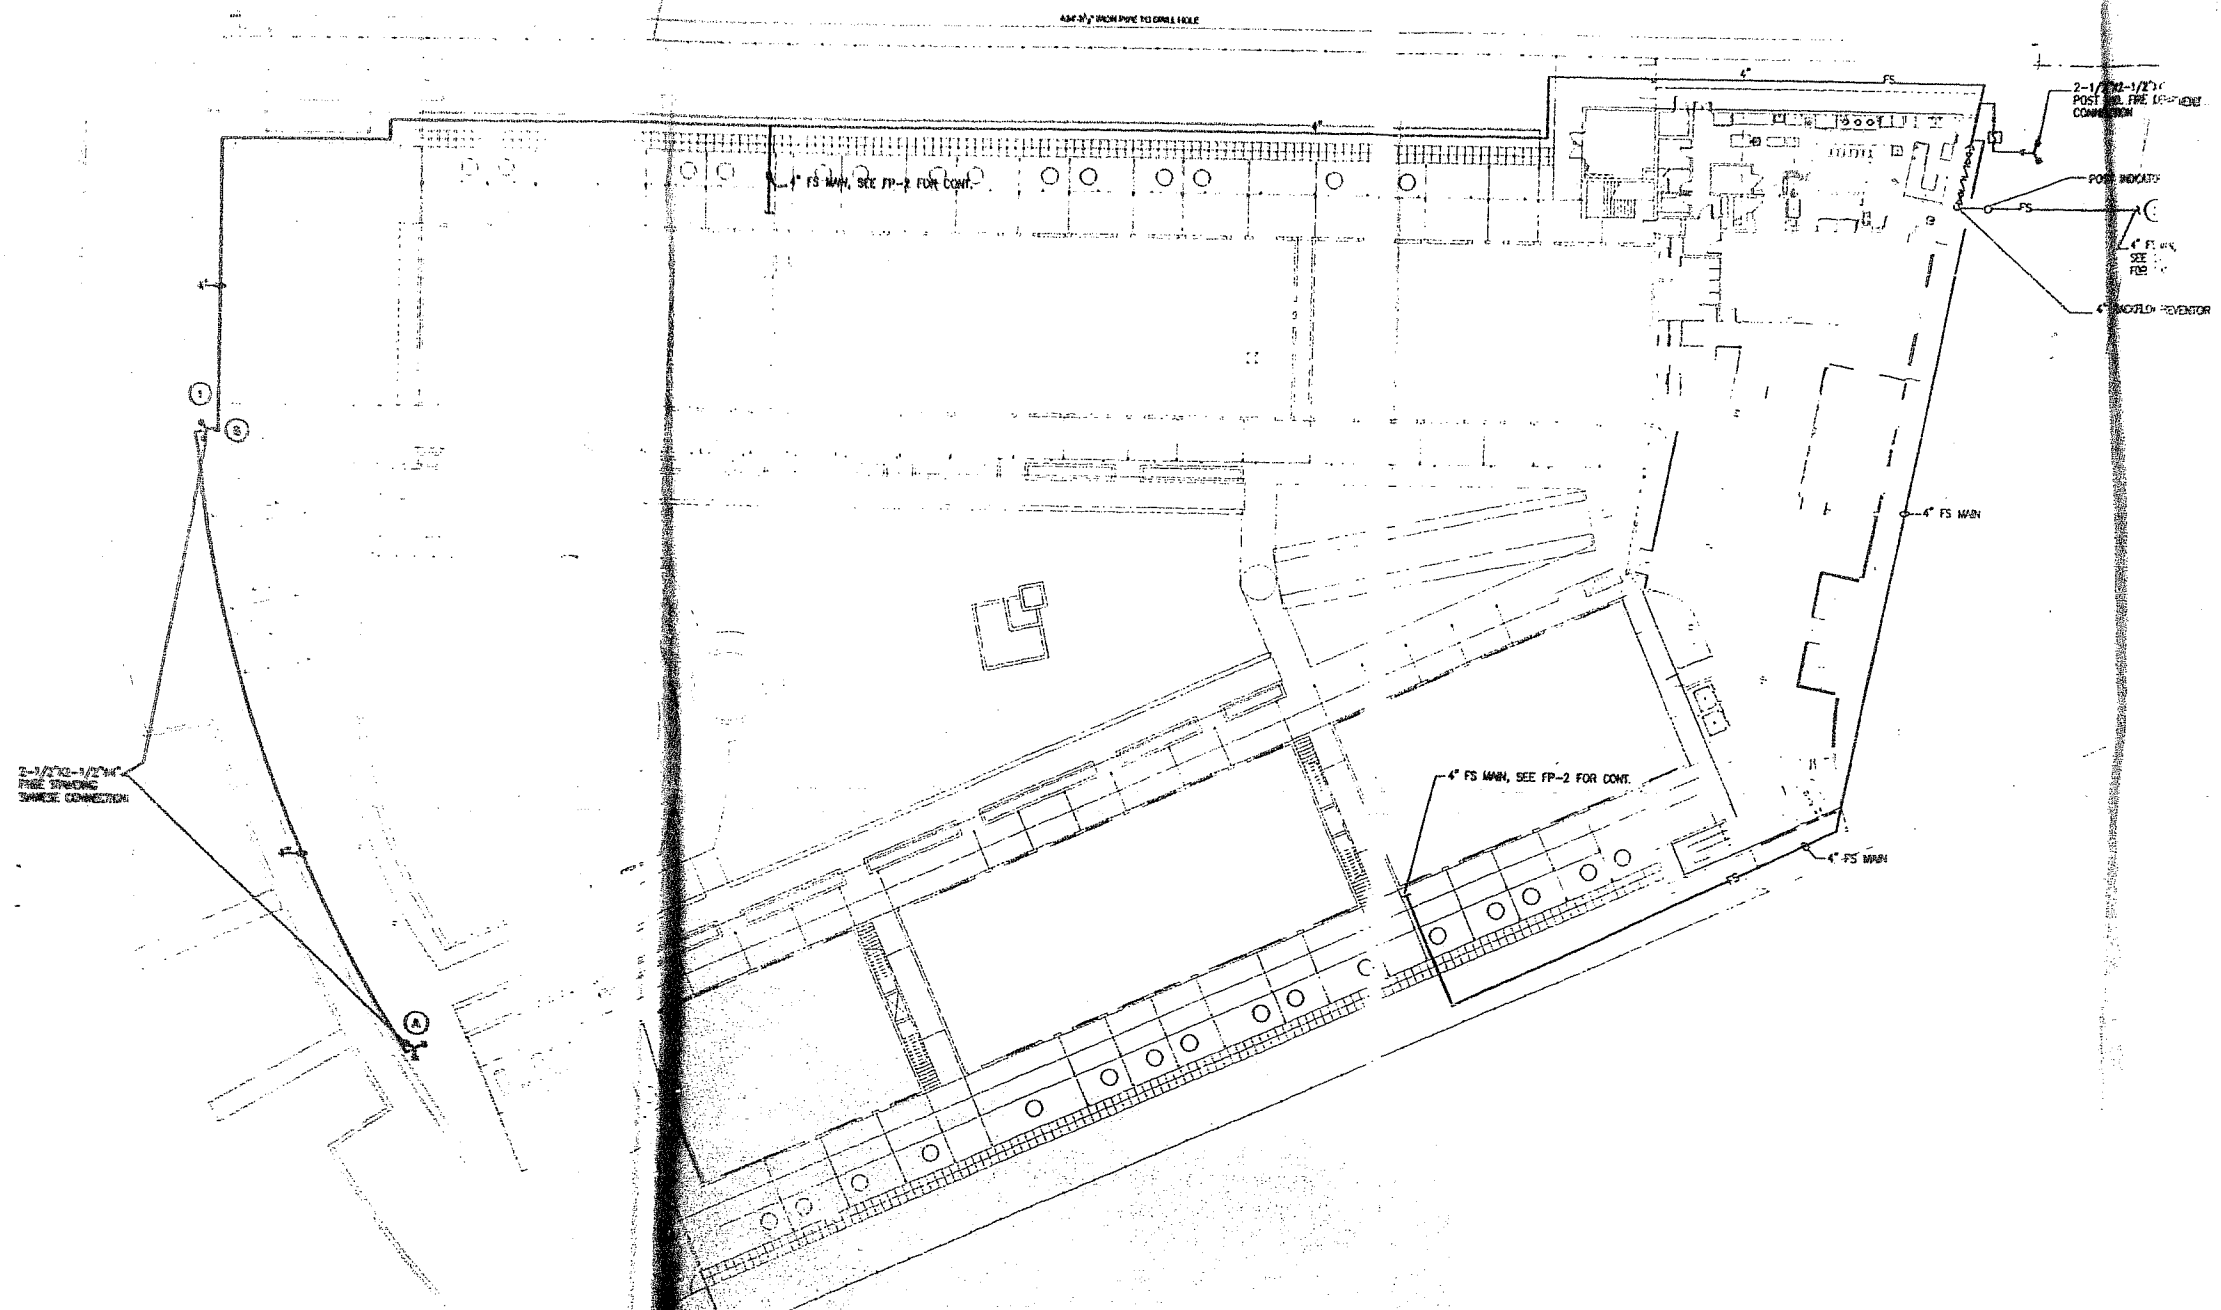SHEET NO.
P-1



SITE PLAN
SCALE: 1" = 20'-0"

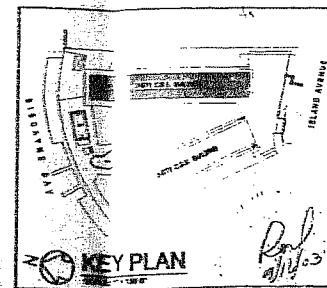

2 COPY
MIAMI BEACH
FOR PERMIT BY
CITY ENGINEERING

PROJECT #: 0304-053
PROPOSED BY:
12345 SW 10th Ave, Suite 200
Miami, FL 33137
Tel: (305) 555-1234
Fax: (305) 555-5678
Email: info@ucengineering.com
P.L. No. 00000000
David A. Barry, P.E., No. 00000
Professional Engineer and
Professional Engineer

PROJECT ARCHITECT

ALISON SPEAR, A.I.A.
180 NE 38th St., SUITE 222, MIAMI, FL 33137
305-438-1200 fax 305-438-1221

PROJECT TITLE

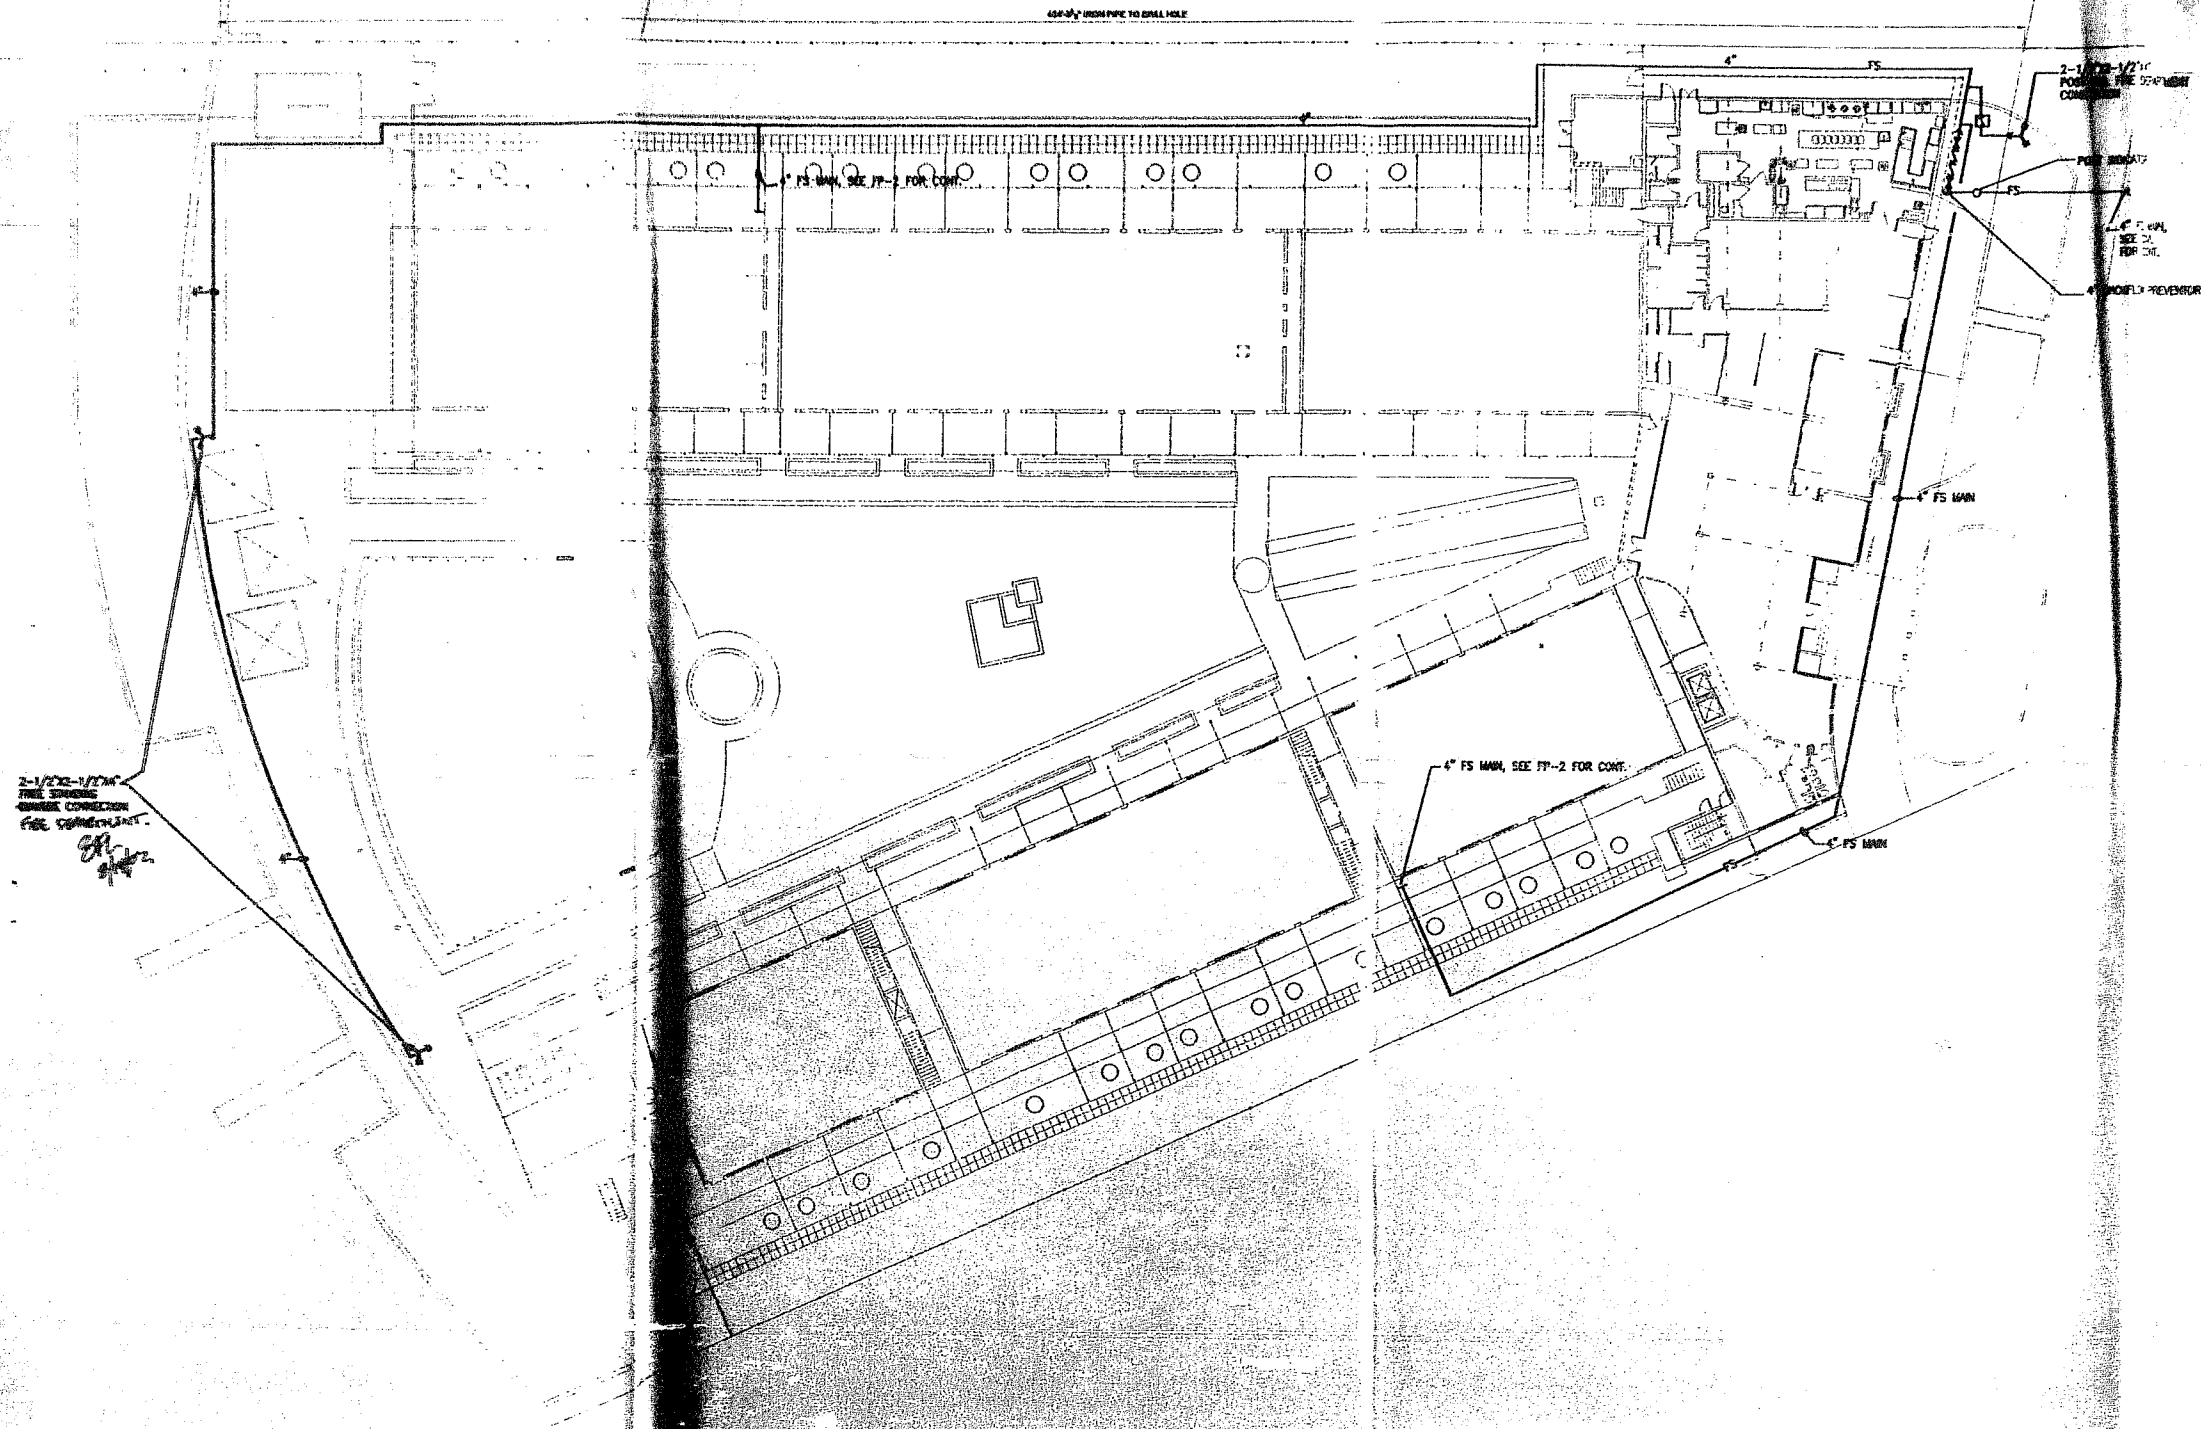
LIDO SPA HOTEL
EAST WING - RENOVATION
40 ISLAND AVENUE, MIAMI BEACH, FL 33139

DRAWING TITLE

SITE PLAN -
LOCATION SKETCH


DRAWN BY

FP-1



SITE PLAN
SCALE: 1"=50'-0"

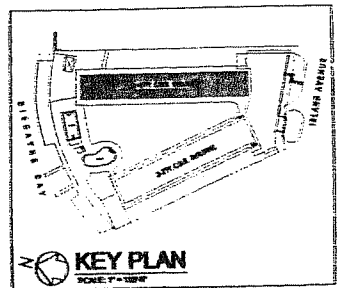PROJECT # 0004-003
PREPARED BY:
UCI Engineering Inc.
10000 S.W. 30th Ave., Suite 215
Miami, Florida 33157
P.O. Box 1000
Fax (305) 555-1000
S. J. [unclear] 35579
DAVID A. [unclear] NO. 37254
Professional Mechanical Engineer




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APPROVED FOR PERMIT BY
THE FOLLOWING:


BUILDING:	
ZONING:	107 7/16/03
DRAWING:	
CONCURRENCY:	
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FIRE PREVENTION:	
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PUBLIC WORKS:	
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ACCESSIBILITY:	
ELEVATOR:	

As per Florida Building Code Section 104.5.3
REVIEWED FOR CODE COMPLIANCE


PROJECT ARCHITECT	ALISON SPEAR, A.I.A. 180 NE 99th St., Suite 222, Miami, FL 33137 305-438-1200 Fax 305-438-1221																																		
DESIGNER	<i>[Signature]</i>																																		
PROJECT TITLE	LIDO SPA HOTEL EAST WING - RENOVATION 40 ISLAND AVENUE, MIAMI BEACH, FL 33139																																		
DRAWING TITLE	SITE PLAN - LOCATION SKETCH																																		
DRAWN BY	EJ																																		
CHECKED BY	RJM																																		
ISSUES	<table border="1"> <tr><th>NO.</th><th>DATE</th><th>DESCRIPTION</th></tr> <tr><td> </td><td> </td><td> </td></tr> <tr><td> </td><td> </td><td> </td></tr> <tr><td> </td><td> </td><td> </td></tr> <tr><td> </td><td> </td><td> </td></tr> <tr><td> </td><td> </td><td> </td></tr> <tr><td> </td><td> </td><td> </td></tr> <tr><td> </td><td> </td><td> </td></tr> <tr><td> </td><td> </td><td> </td></tr> <tr><td> </td><td> </td><td> </td></tr> <tr><td> </td><td> </td><td> </td></tr> </table>		NO.	DATE	DESCRIPTION																														
NO.	DATE	DESCRIPTION																																	
SHEET NO.	FP-1																																		

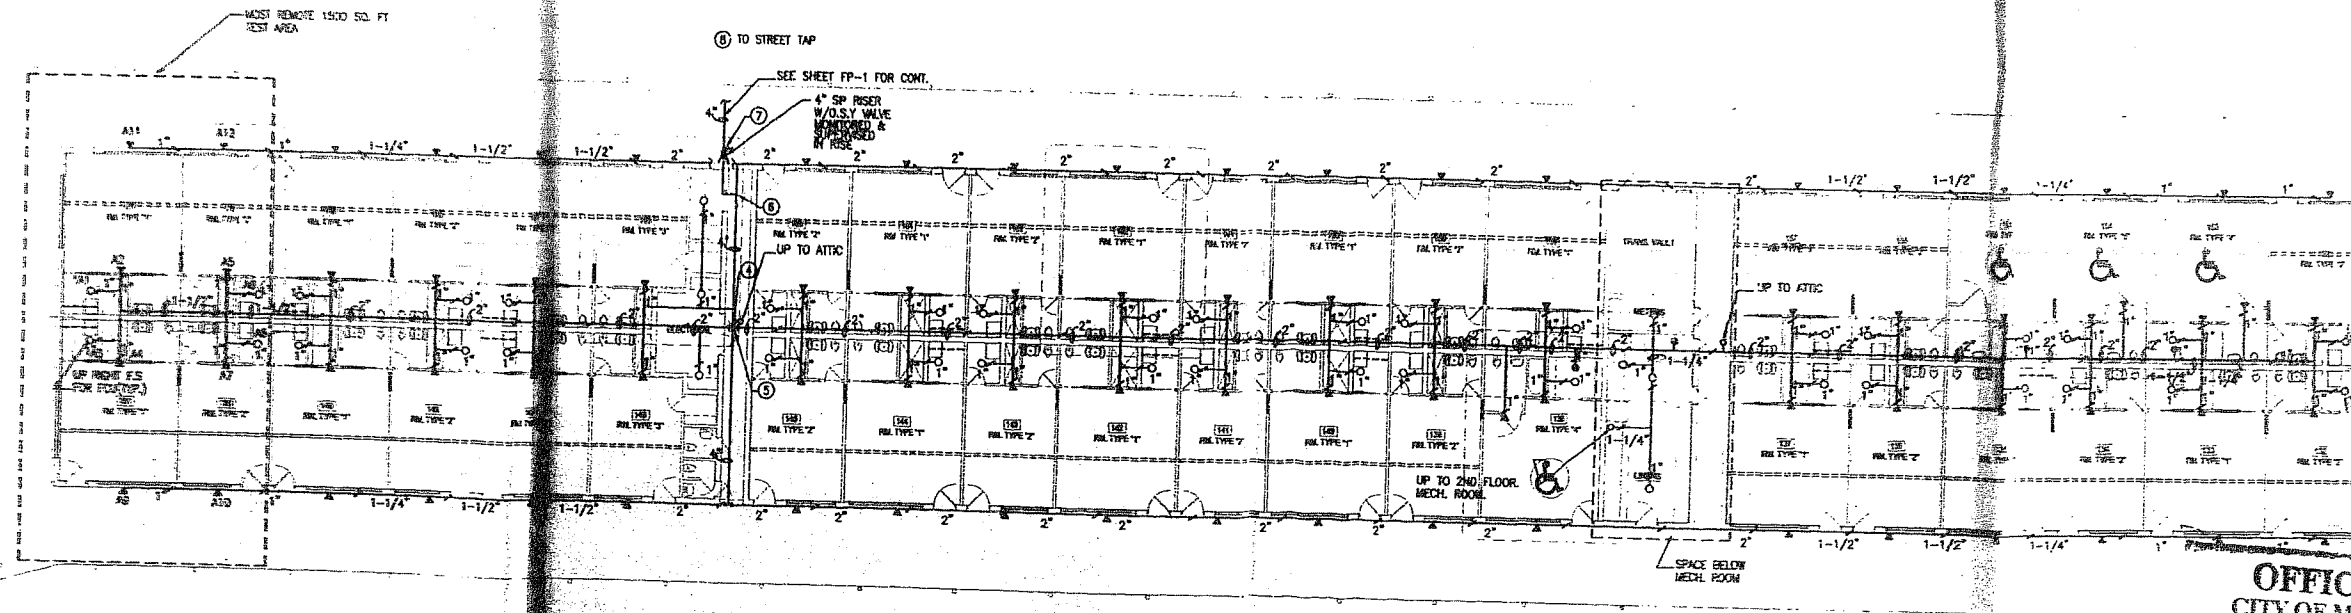

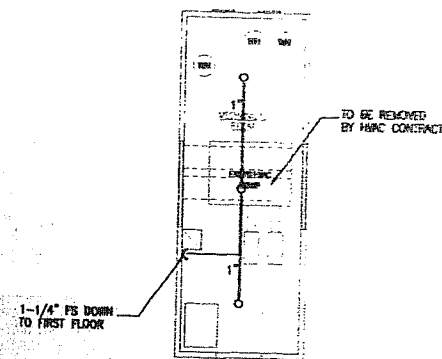EAST FIRE PROTECTION FLOOR PLAN
SCALE: 3/32"=1'-0"



2nd FLR. MECH. ROOM
SCALE: 3/32"=1'-0"

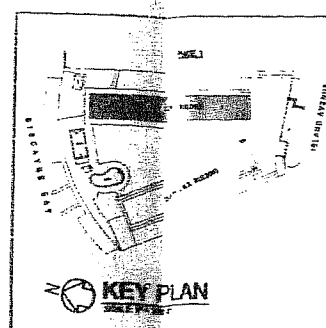

KEY PLAN
SCALE: 1/8"=1'-0"

OFFICE COPY
CITY OF MIAMI BEACH
APPROVED FOR PERMIT BY:
THE FOLLOWING:

BUILDING:	
ZONING:	
DRB/HPE:	
CONCURRENCY:	
PLUMBING:	
ELECTRICAL:	
MECHANICAL:	
FIRE PREVENTION:	
ENGINEERING:	
PUBLIC WORKS:	
STRUCTURAL:	
ACCESSIBILITY:	
ELEVATOR:	

As per Florida Building Code Section 104.5
REVIEWED FOR CODE COMPLIANCE
PROJECT #: 0304-053

Prepared by: **ucengineering**
From Vision to Reality

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Tel: (305) 555-0000
Fax: (305) 555-0000
Email: info@ucengineering.com
Web: www.ucengineering.com
David A. Boring P.E., No. 30710
Professional Electrical and
Mechanical Engineer

PROJECT ARCHITECT
ALISON SPEAR, A.I.A.
180 NE 36th St., Suite 222, Miami, FL 33137
305-438-1200 Fax 305-438-1221


PROJECT TITLE
LIDO SPA HOTEL
EAST WING - RENOVATION
40 ISLAND AVENUE, MIAMI BEACH, FL 33139

DRAWING TITLE
EAST WING
FIRE PROTECTION PLAN


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CHECKED BY **FLM**
ISSUES

SHEET NO.
FP-2


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EAST FIRE PROTECTION DOOR PLAN
SCALE: 3/8\"/>

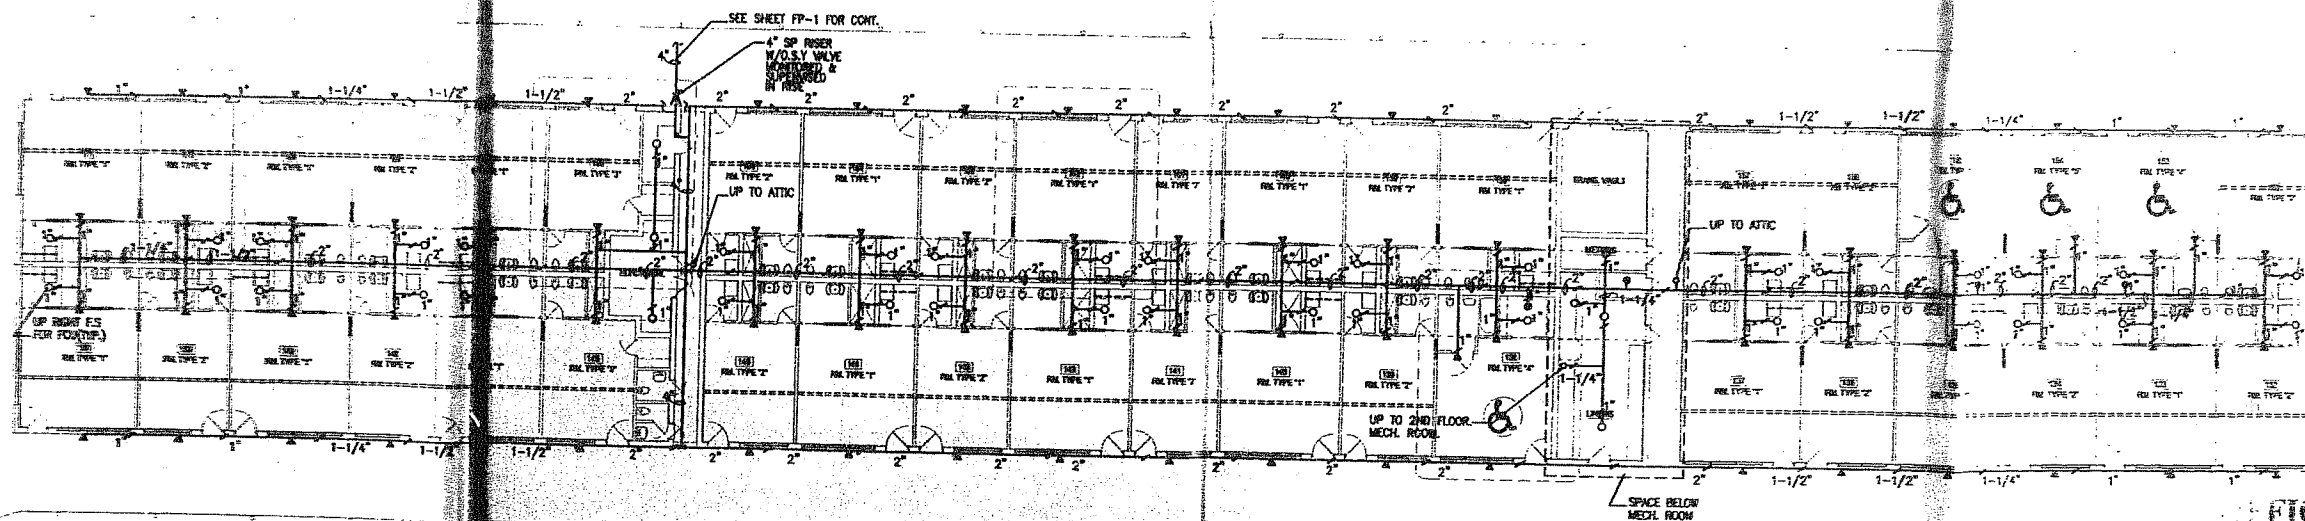

2nd FLR. MECH. ROOM
SCALE: 3/8\"/>

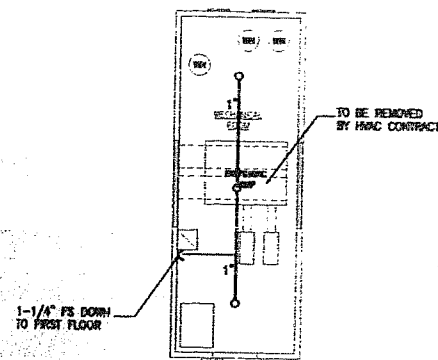

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CITY OF MIAMI BEACH
APPROVED FOR PERMIT BY
THE FOLLOWING:

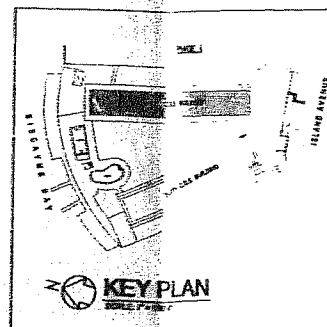BUILDING:	
ZONING:	
DR/HPB:	
CONCURRENCY:	
PLUMBING:	
ELECTRICAL:	
MECHANICAL:	
FIRE PREVENTION:	
ENGINEERING:	
PUBLIC WORKS:	
STRUCTURAL:	
ACCESSIBILITY:	
ELEVATOR:	

As per Florida Building Code Section 10-5.3
PROJECT NO. 10-5.3

PREPARED BY:
UCI Engineering Inc.
13780 S.W. 56th Street, Suite 215
Miami, Florida 33175
Tel: (305) 383-8999
Fax: (305) 383-3949
E-MAIL: uci@ucieng.com
R. J. MIRANDA PE NO. 35579
DAVID A. BELSKY PE NO. 37234
Professional Electrical/Mechanical Engineers

PROJECT ARCHITECT
ALISON SPEAR, A.I.A.
180 NE 98th St., SUITE 222, MIAMI, FL 33157
305-436-1200 Fax 305-436-1221

SEAL
[Signature]




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PROJECT TITLE
LIDO SPA HOTEL
EAST WING - RENOVATION
40 ISLAND AVENUE, MIAMI BEACH, FL 33139

DRAWING NO.
EAST WING
FIRE PROTECTION PLAN

DRAWN BY **EZ**
CHECKED BY **RJM**
ISSUES

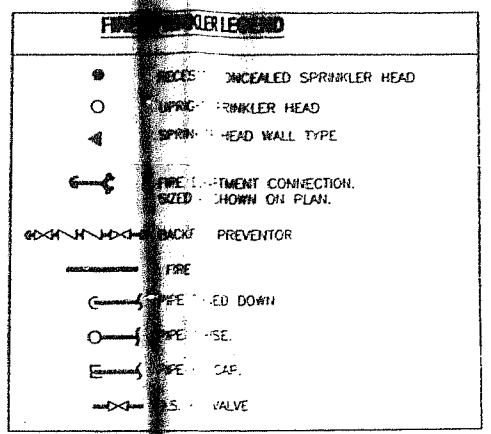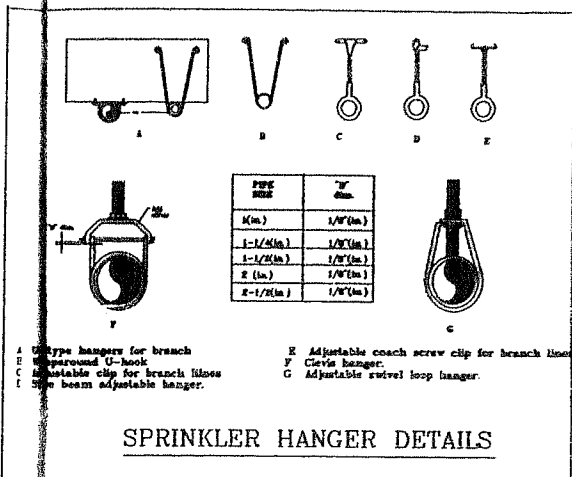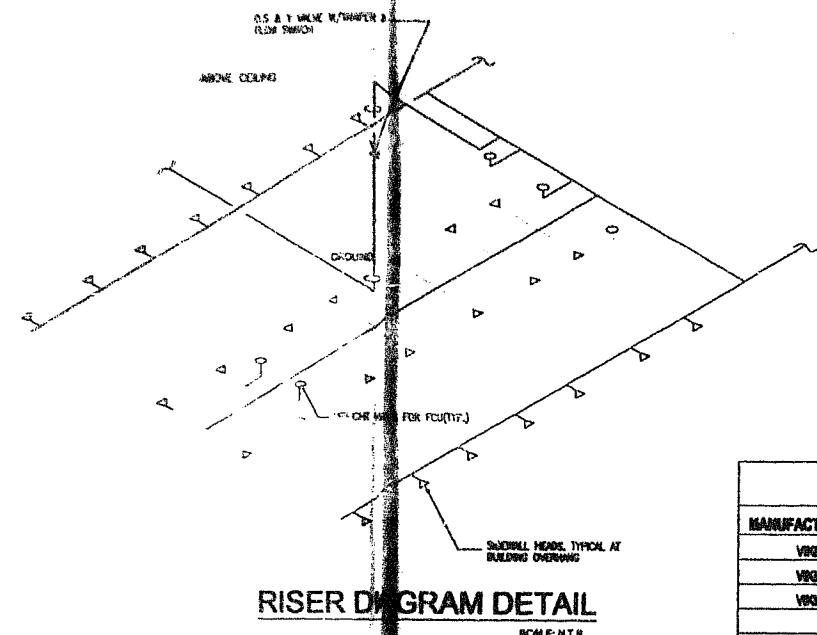SHEET NO.
FP-2



FIRE SPRINKLER SCHEDULE							
MANUFACTURER	STYLE	SIZE	GPM	PN	K	MODEL #	COMMENTS
VIKING	CONCEALED	1/2"			4.1	B-3	RESIDENTIAL CONCEALED
VIKING	SIDEWALL	1/2"	21	14.7	5.5	M	RES. MTD 4" 0" BEL. CEL.
VIKING	UPRIGHT	1/2"			7	5.5	EXPOSED EQUIPMENT COVERAGE

- FIRE SPRINKLER NOTES**
- ALL FIRE PROTECTION SYSTEM SHALL BE IN COMPLIANCE WITH THE LOCAL FIRE CODES AND ORDINANCES AND AS PER THE REQUIREMENTS.
 - MAKE ALL OFFSETS REQUIRED AS PER THE REQUIREMENTS.
 - CONTRACTOR SHALL COORDINATE WITH OTHER TRADES BEFORE INSTALLING SPRINKLER SYSTEM.
 - PROVIDE APPROVED FLOW AND TAMPING DOWN VALVES AT CONTROL VALVE LOCATIONS.
 - CONTRACTOR SHALL PROVIDE AND INSTALL TO THE OWNER AT LEAST (6) SPARE SPRINKLERS OF SAME TYPE AND TEMPERATURE RATINGS BEING INSTALLED.
 - SYSTEM IS DESIGNED FOR LIGHT AND MODERATE HAZARD OCCUPANCY.
 - INSTALL PIPING TIGHT TO STRUCTURE WHERE POSSIBLE.
 - SPRINKLER SYSTEM SHALL BE INSTALLED BY A STATE CERTIFIED FIRE SPRINKLER CONTRACTOR.
 - CONTRACTOR SHALL PROVIDE FLOODING PROTECTION AND SHOW ON SHOP DRAWING SUBMITTALS.
 - ALL SPRINKLER HEADS SHALL BE CHARGED AND PRESENT A NEAT AND BALANCED CEILING PATTERN.
 - SPRINKLER PIPING SHALL BE SCH 40 BLACK STEEL A.S.T.M. A 53 FOR ORDINARY HAZARD AND SCH 40S FOR LIGHT HAZARD.
 - SPRINKLER HEADS SHALL BE A MINIMUM OF 18" FROM ANY FLOOR OBSTRUCTION, SHELVES, OR CANNOTS.
 - SPRINKLERS NEXT TO COLUMNS SHALL BE 3 TIMES WIDTH OF COLUMN AWAY.
 - INSPECTOR'S TEST VALVE SHALL BE LOCATED 7'-0" A.F.F.
 - SHOP DRAWING PIPE SIZES TO BE PROBABILISTICALLY CALCULATED, SIGNED AND SEALED BY A FLORIDA REGISTERED ENGINEER AND SUBMITTED BY CONTRACTOR TO AUTHORITIES FOR REVIEW PRIOR TO THE INSTALLATION OF THE SYSTEM.
 - CONTRACTOR SHALL SECURE AND MAINTAIN ALL PERMITS, FEES, INSPECTIONS AND TESTS.

DETAILS AND NOTES

OFFICE COPY
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 APPROVED FOR PERMIT BY
 THE FOLLOWING:

BUILDING: _____
 ZONING: _____
 DRB/HPR: _____
 CONCURRENCY: _____
 PLUMBING: _____
 ELECTRICAL: _____
 MECHANICAL: _____
 FIRE PREVENTION: _____
 ENGINEERING: _____
 PUBLIC WORKS: _____
 STRUCTURAL: _____
 ACCESSIBILITY: _____
 ELEVATOR: _____

PROJECT # 0304-059 Florida Building Code Section 104.5
 PREPARED BY: REVIEWED FOR CODE COMPLIANCE

UCI Engineering Inc.
 13780 S.W. 58th Street, Suite 215
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 Fax: (305) 383-8149
 E-Mail: uci@ucieng.com
 D. J. MIRANDA P.E. No. 36578
 DAVID A. BELSKY P.E. No. 37234
 Professional Electrical/Mechanical Engineers

LIDO SPA HOTEL
EAST WING - RENOVATION
 40 ISLAND AVENUE, MIAMI BEACH, FL 33133

EAST WING
ATTIC AND RISER DIAGRAM

DRAWN BY: E.J.
CHECKED BY: R.J.M.
ISSUES

SHEET NO.
FP-3

ALISON SPEAR, A.I.A.
 180 NE 38th St., Suite 222, Miami, FL 33137
 305-438-1200 Fax 305-438-1221

Signature

SEAL OF DOCUMENT ENGINEER
 I, the undersigned, do hereby certify that I am a duly licensed Professional Engineer in the State of Florida, and that I am the author of the design and construction of the project described herein. I am not aware of any other person or persons who have participated in the design and construction of the project described herein.



	NOZZLE	VOCALD SPRINKLER HEAD
	APPROX	-ANKLER HEAD
	SPRINK	EAD WALL TYPE
	PIPE IN	MENT CONNECTION
	WAZED	DOWN ON PLAN.
	WALL	-PREVENTOR
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FIRE SPRINKLER SCHEDULE

MANUFACTURER	STYLE	SIZE	QTY	PSI	K	MODEL #	COMMENTS
WRNG	CONCEALED	1/2"			4.1	B-3	RESIDENTIAL CONCEALED
WRNG	SEMIHILL	1/2"	2	14.7	5.5	M	RESID. MED 4" X 6" BEL. CEE
WRNG	UPRIGHT	1/2"		7	5.5	MICROMATIC	EXP. FOR EQUIPMENT COVERAGE

FIRE SPREADER NOTES

- 1- ALL FIRE PROTECTION SYSTEM SHALL BE IN ACCORDANCE WITH THE LOCAL FIRE CODES AND ORDINANCES AND AS MAY BE REQUIRED BY REQUIREMENTS
- 2- MAKE ALL OFFSETS REQUIRED AS PER THE CONDITIONS
- 3- CONTRACTOR SHALL COORDINATE WITH ALL TRADES AND OTHER TRADES BEFORE INSTALLING SPRINKLER SYSTEM
- 4- PROVIDE APPROVED FLOW AND PRESSURE TAP AT CONTROL VALVE LOCATIONS
- 5- CONTRACTOR SHALL PROVIDE AND MAINTAIN TO THE OWNER AT LEAST (6) SPARE SPRINKLERS OF SAME TYPE AND RATING BEING INSTALLED
- 6- SYSTEM IS DESIGNED FOR LIGHT AND MODERATE HAZARD OCCUPANCY
- 7- INSTANT SPRING TIGHT TO STRUCTURE WHEN POSSIBLE
- 8- SPRINKLER SYSTEM SHALL BE INSTALLED IN ACCORDANCE WITH THE LATEST EDITION OF THE SPRINKLER CONTRACTOR
- 9- CONTRACTOR SHALL PROVIDE FLOW AND PRESSURE TAP AND SHOW ON SHOP DRAWING SUBMITTALS.
- 10- ALL SPRINKLER HEADS SHALL BE CORRECTLY PRESENT A NEAT AND BALANCED CEILING PATTERN.
- 11- SPRINKLER PIPING SHALL BE SCHEDULE 40 BLACK STEEL 1/2" & 3/4" FOR ORDINARY HAZARD AND SCHEDULE 80 FOR LIGHT HAZARD
- 12- SPRINKLER HEADS SHALL BE A MINIMUM OF 18" FROM ANY FLOOR OBSTRUCTION, SHELVES, OR CHIMNEYS
- 13- SPRINKLERS NEXT TO COLUMNS SHALL BE 12" MINIMUM WIDTH OF COLUMN AWAY
- 14- INSPECTORS TEST VALVE SHALL BE LOCATED 4' OFF
- 15- SHOP DRAWING PIPE SIZES TO BE DETERMINED BY A PROFESSIONALLY CALCULATED, SIGNED AND SEALED BY A LICENSED PROFESSIONAL ENGINEER AND SUBMITTED BY CONTRACTOR TO AUTHORITIES FOR REVIEW PRIOR TO THE INSTALLATION OF THE SYSTEM
- 16- CONTRACTOR SHALL SECURE AND PAY FOR ALL PERMITS, FEES, INSPECTIONS AND TESTS.

OFFICE COPY
CITY OF MIAMI BEACH
APPROVED FOR PERMIT BY
THE FOLLOWING:

BUILDING:
ZONING:
DRB/HFE:
CONCURRENCE:
PLUMBING:
ELECTRICAL:
MECHANICAL:
FIRE PREVENTION:
ENGINEERING:
PUBLIC WORKS:
STRUCTURAL:
ACCESSIBILITY:

PROJECT NUMBER: _____
PREPARED BY: _____ per Florida Building Code Section 104.5
TITLE: _____ COMPLIANCE

UCI Engineering Inc.
18750 S.W. 24th Street, Suite 215
Miami, Florida 33155
Fax (305) 552-5550
Fax (305) 552-5544
E-Mail: uci@uci.com
K. J. MIRANDA PE NO. 35677
DAVID A. BELLEF PE NO. 37234
Professional Electrical/Mechanical
Engineers

DRAWING TITLE

EAST WING
ATTIC AND RISER DIAGRAM

DRAWN BY E
 CHECKED BY J.L.
 12/1/83

SHEET 203

FP-3

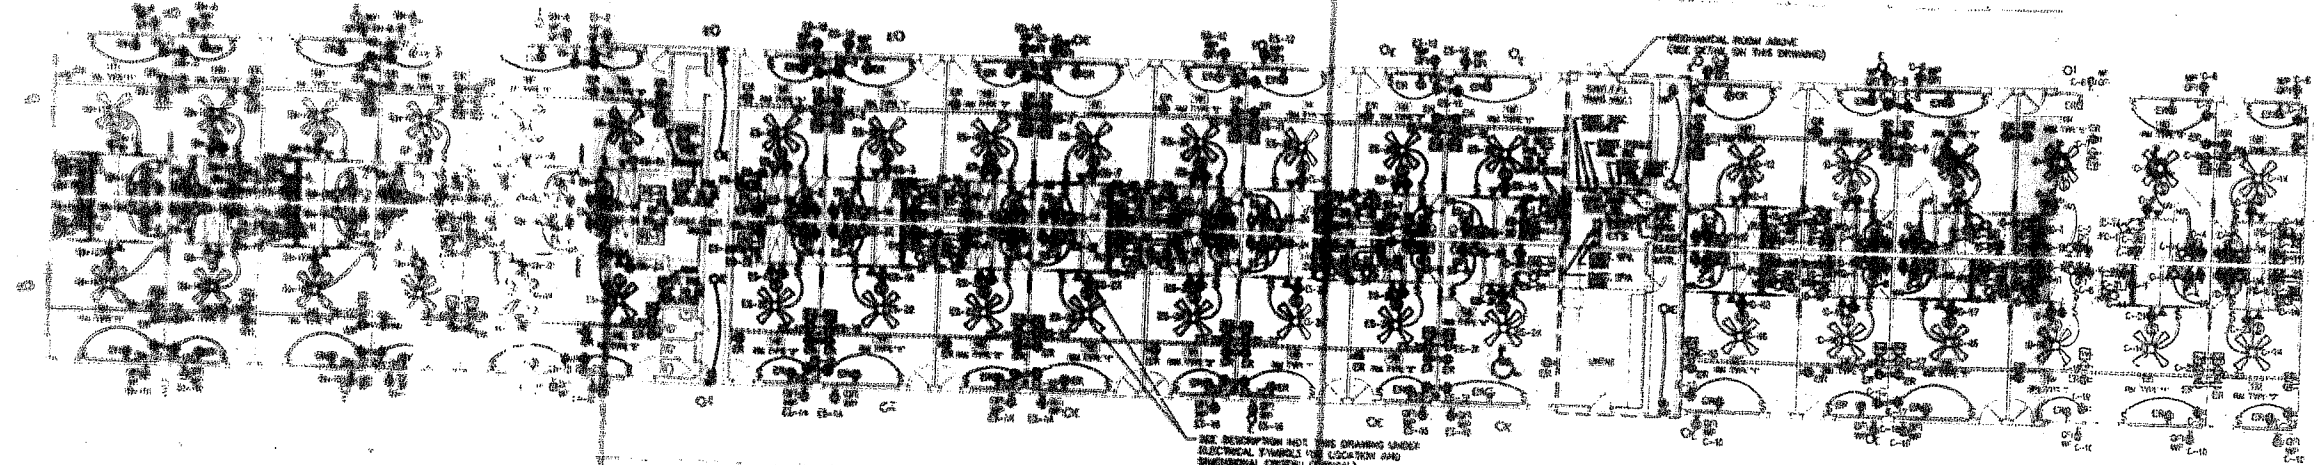
© 2000 Blackwell Science Ltd, *Journal of Internal Medicine* 247: 395–402

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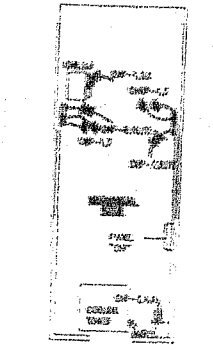
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LIDO SPA HOTEL
EAST WING - RENOVATION
10 ISLAND AVENUE, MIAMI BEACH, FL 33139

ALISON SPEAR, A.I.A.
160 N.W. 39th St., Suite 222, Miami, FL 33137
305.575.5000 Fax: 305.575.5024
www.alison-spear.com



EAST WING PROPOSED FLOOR PLAN



MECH. ROOM DETAIL

ELECTRICAL GENERAL NOTES

1. DRAWINGS ARE QUANTITATIVE. OWNER SHALL OBTAIN QUOTES FOR ALL MATERIALS AND LABOR. THE CONTRACTOR SHALL BE RESPONSIBLE FOR OBTAINING ALL NECESSARY PERMITS AND INSURANCE. THE CONTRACTOR SHALL BE RESPONSIBLE FOR OBTAINING ALL NECESSARY PERMITS AND INSURANCE.
2. ALL WORK SHALL BE DONE IN ACCORDANCE WITH THE LATEST E.C. CODES AND ALL LOCAL ORDINANCES.
3. ALL MATERIAL SHALL BE NEW AND SHALL BEAR UL LABELS. THE CONTRACTOR SHALL BE RESPONSIBLE FOR OBTAINING ALL NECESSARY PERMITS AND INSURANCE.
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11. THE CONTRACTOR SHALL BE RESPONSIBLE FOR OBTAINING ALL NECESSARY PERMITS AND INSURANCE.
12. ALL CONDUCTORS SHALL BE COPPER WITH THIN INSULATION.
13. ALL PANELS SHALL BE CLEARLY LABELED ON THE OUTSIDE FOR QUICK IDENTIFICATION. ALL CIRCUITS IN ALL PANELS SHALL BE IDENTIFIED BY NUMBER, DISCONNECT, BREAKER SIZE, NUMBER OF POLES AND BREAKER POSITION NUMBER. IN THE PANEL, THE PANEL SHALL CLEARLY BE IDENTIFIED BY THE INSIDE DOOR. THE PANEL SHALL BE IDENTIFIED BY THE INSIDE DOOR.
14. THE CONTRACTOR SHALL BE RESPONSIBLE FOR OBTAINING ALL NECESSARY PERMITS AND INSURANCE.
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26. THE CONTRACTOR SHALL BE RESPONSIBLE FOR OBTAINING ALL NECESSARY PERMITS AND INSURANCE.
27. ALL WORK SHALL BE PERFORMED BY A LICENSED ELECTRICAL CONTRACTOR IN A FIRST CLASS WORKMANLIKE MANNER. THE COMPLETE SYSTEM SHALL BE FULLY OPERATIVE. ACCEPTANCE BY ENGINEER/ARCHITECT MUST BE A CONDITION OF THE CONTRACT.
28. IT IS NOT THE INTENTION OF THESE DRAWINGS TO ESTABLISH LIGHTING LEVELS OF ANY KIND. THE NUMBER, STYLE AND LOCATION OF LIGHTING FIXTURES ARE DETERMINED BY THE ARCHITECT AND/OR THE OWNER. THE LIGHTING FIXTURE SCHEDULE IF APPEARING ON THESE DRAWINGS IS FOR INFORMATIONAL PURPOSES AND HAS BEEN DEVELOPED BY THE ARCHITECT AND/OR OWNER. FOR DETAILED QUESTIONS REGARDING LIGHTING FIXTURES CONTACT THE ARCHITECT OR OWNER.
29. EXISTING LIGHTING FIXTURES WHEN REUSED ARE TO BE REWIRING AND RECONNECTED. THE ARCHITECT AND/OR OWNER SHALL BE INFORMED OF AND SHALL APPROVE THE REUSE OF ALL REUSED LIGHT FIXTURES. ALL REUSED LIGHTING FIXTURES SHALL BE REPAIRED, CLEANED AND REPAIRED IF NECESSARY. ANY EXISTING LIGHTING FIXTURES BEYOND REPAIR SHALL BE REPLACED. ALL LIGHTING FIXTURES SHALL BE GUARANTEED FOR A PERIOD OF ONE YEAR.
30. IT IS THE CONTRACTOR'S RESPONSIBILITY TO ENSURE THAT ALL ELECTRICAL SERVICES TO MECHANICAL EQUIPMENT IS ACCORDING TO THE ELECTRICAL CODE. IN ADDITION, ALL MECHANICAL EQUIPMENT SUBSTITUTIONS ARE TO BE ACCOUNTED FOR PRIOR TO BID AND SHALL BE COORDINATED ELECTRICALLY.
31. FOR HVAC EQUIPMENT THE MECHANICAL CONTRACTOR SHALL PROVIDE THE SHOCK DETECTOR IF REQUIRED, AND THE ELECTRICAL CONTRACTOR SHALL INSTALL THE SHOCK DETECTOR.
32. THE ELECTRICAL CONTRACTOR SHALL COORDINATE WITH THE MECHANICAL CONTRACTOR FOR INSTALLATION OF ALL MECHANICAL CONTROLS.
33. IT IS THE RESPONSIBILITY OF THE CONTRACTOR TO FORWARD ANY SHOP DRAWINGS TO THE ARCHITECT/OWNER. SHOP DRAWINGS ARE NOT SOLICITED BY THE ENGINEER.
34. IT IS THE CONTRACTOR'S RESPONSIBILITY TO ENSURE THAT FIRE STOPPING MEASURES ARE PROVIDED PER LOCAL BUILDING DEPT. REQUIREMENTS. THE FIRE STOPPING MATERIAL AND ITS INSTALLATION SHALL BE APPROVED. ALL FIRE STOPPING MATERIAL SHALL BE NON WATER SOLUBLE.


LOAD DATA (208Y/120V - 3PH-4W SERVICE)

ADD. MAIL LOAD	
NEW PANEL "CH"	66,895 VA (230A)
LOADING MAIL LOAD	
NEW PANEL "DN"	26,502 VA
NEW PANEL "EN"	26,964 VA
NEW PANEL "C"	31,952 VA
NEW PANEL "EL"	17,988 VA
EXIST. OTHER LTC. LOAD	95,000 VA
TOTAL LTC. CONN. LOAD	200,336 VA (555 A)
TOTAL BDC. CONN. LOAD	286,591 VA (795 A)


ELECTRICAL SYMBOLS

- 1. DUPLEX RECEPTACLE, 20A, 120V GROUND TYPE, WALL MOUNT, 18" A.F.F. (OR 48" A.F.F. ABOVE SINK).
- 2. DUPLEX RECEPTACLE, 20A, 120V GROUND TYPE, WALL MOUNT, 18" A.F.F.
- 3. QUADRUPEX RECEPTACLE, 20A, 120V GROUND TYPE, WALL MOUNT, 18" A.F.F.
- 4. SAME AS ABOVE, BUT WEATHER PROOF.
- 5. SINGLE RECEPTACLE, 20A, 120V GROUND TYPE, WALL MOUNT.
- 6. TV OUTLET, WALL MOUNTED.
- 7. TELEPHONE OUTLET, WALL MOUNT.
- 8. LIGHTING SWITCH.
- 9. CEILING MOUNTED LIGHTING FIXTURE OUTLET.
- 10. WALL MOUNTED LIGHTING FIXTURE OUTLET.
- 11. PADDLE FAN.
- 12. 120V SMOKE DETECTOR WITH BATTERY PACK.
- 13. EXIT SIGN.
- 14. EMERGENCY BATTERY PACK.
- 15. ELECTRIC MOTOR.
- 16. EXISTING TO REMAIN.
- 17. EXISTING TO BE REPLACED.

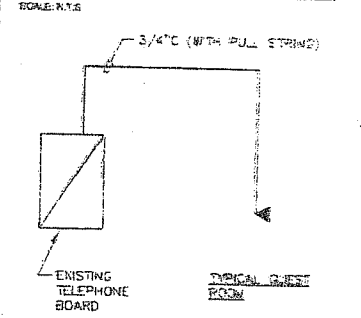CATV RISER DIAGRAM



TELEPH. RISER DIAGRAM

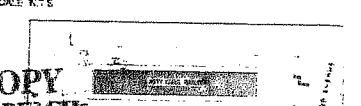

NOTICE COPY
CITY OF MIAMI BEACH
APPROVED FOR PERMIT BY
THE FOLLOWING:

ENGINEER: [Signature]
ARCHITECT: [Signature]
CONTRACTOR: [Signature]
PLUMBING: [Signature]
ELECTRICAL: [Signature]
MECHANICAL: [Signature]
FIRE PROTECTION: [Signature]
ELEVATOR: [Signature]
ACME: [Signature]
ELEVATOR: [Signature]

PROJECT # 2304-052
PREPARED BY:
BCI Engineering Inc.
1001 S.E. 10th Street, Suite 205
Miami, Florida 33135
(305) 355-0000
FAX (305) 355-2000
E-MAIL: bci@bcieng.com
B. J. BURGESS P.E. 20076
DAVID A. BURGESS P.E. 37180
Professional Electrical/Plumbing Engineers

PROJECT ARCHITECT
ALISON SPEAR, A.I.A.
180 NE 30th St., Suite 202 Miami, FL 33137
305-438-1200 Fax 305-438-1221

PROJECT TITLE
**LIDO SPA HOTEL
EAST WING - RENOVATION**
10 ISLAND AVENUE, MIAMI BEACH, FL 33139

DRAWING TITLE
**ELECTRICAL
FLOOR PLAN, RISERS,
NOTES AND SYMBOLS**

DRAWN BY: C.P.
CHECKED BY: R.J.M.
ISSUES

SHEET NO.
E-1

BO304D36
40 ISLAND AVE
"EAST WING"

MADE COUNTY DEPT. OF ENVIRONMENTAL
 PROTECTION
 WASHINGTON
 SEWER CAPACITY ALLOCATION
 DATE: 10/19/84
☐ APPROVED WITH CONDITIONS
 SEE LOWER SIGNED
 IN ALLOCATION NOT REQUIRED
 For John W. Anderson, P.E.
 District Manager
 Note: This approval is not a binding contract

DIRM Number: 2083-1003-1548-0047
 Contact Name: MR JEFF DELORT
 Contact Phone: (385)345-9649
 Cellio: 82-3233-004-0090
 Project Name: 7:00 PM T. HOTEL EAST WING
 Date Received: 18/03/2003
 Reviser Name: KIRK WONG

[illegible]



PERMIT #

B0304433

LIDO SPA HOTEL

40 ISLAND AVE, MIAMI BEACH, FL 33139

WEST WING - RENOVATION PHASE TWO OF CONSTRUCTION

DEVELOPMENT

HotelsAB

295 Lafayette Street, Suite 708, New York, NY 10012
phone: 646.792.6185 fax: 212.219.8027

PROJECT DESIGNER

SHAWN HAUSMAN DESIGN

1285 N. Crescent Mts. Blvd., Los Angeles, CA 90046
phone: 323.656.0898 fax: 323.650.4591

ARCHITECTURE

ALISON SPEAR, A.I.A.

180 NE 39th St., Suite 222, Miami, FL 33137
phone: 305.438.1200 fax: 305.438.1221

MECHANICAL / ELECTRICAL / PLUMBING

UCI ENGINEERING, INC.

13760 SW 56th Street, Suite 215
Miami, FL 33175
phone: 305-383-8989 fax: 305-383-9849

CONSTRUCTION

WAHAB CONSTRUCTION, INC.

818 SW 4th Avenue, Upstairs
Miami, FL 33130
phone: 305-854-8483 fax: 305-854-8490

CODE COMPLIANCE CONSULTANT

R.D. HALE, INC.

7382 Gary Avenue
Miami Beach, FL 33141
phone: 305-868-9650 fax: 305-868-9648

INDEX OF DRAWINGS

ARCHITECTURE

PROJECT NUMBER	PROJECT NAME
A-0.00	INDEX, GENERAL NOTES, SCOPE OF WORK & VICINITY MAP
A-0.01	SITE PLAN
A-1.00	PROPOSED FLOOR PLANS (FIRST & SECOND FLOOR)
A-1.01	PROPOSED ELEVATIONS
A-2.00	ROOM TYPE '1' - PLANS, ELEVATIONS & DETAILS
A-2.01	ROOM TYPE '2' - PLANS, ELEVATIONS & DETAILS
A-2.02	ROOM TYPE '3' - PLANS, ELEVATIONS & DETAILS
A-2.03	ROOM TYPE '4' - PLANS, ELEVATIONS & DETAILS
A-2.04	ROOM TYPE '5' - PLANS, ELEVATIONS & DETAILS
A-2.05	ROOM TYPE '6' - PLANS, ELEVATIONS & DETAILS
A-2.06	ROOM TYPE '7A' - PLANS, ELEVATIONS & DETAILS
A-3.00	ROOM TYPE - DETAILS
A-4.00	DOOR SCHEDULE
A-4.01	FINISH SCHEDULE

STRUCTURAL ENGINEERING

MECHANICAL & ELECTRICAL ENGINEERING

SCOPE OF WORK

THE SCOPE OF THE WORK INCLUDES THE RENOVATION OF THE ABOVE MENTIONED BUILDING COMPRISING OF: NEW FINISHES IN GUESTROOMS & BATHROOMS, REPLACEMENT OF FIXTURES IN BATHROOMS, NEW MECHANICAL SYSTEM AND LIFE SAFETY SYSTEM.

LEGAL DESCRIPTION

LEGAL DESCRIPTION:
LOTS 38, 40, 41, AND 42, OF 'AMENDED PLAT OF BELLE ISLE', ACCORDING TO THE PLAT THEREOF RECORDED IN PLAT BOOK 5 AT PAGE 11 OF THE PUBLIC RECORDS OF MIAMI-DADE COUNTY, FLORIDA, AND BEING SITUATED ON BELLE ISLAND, ON VENETIAN CAUSEWAY, WITHIN THE CITY LIMITS OF MIAMI BEACH, FLORIDA.

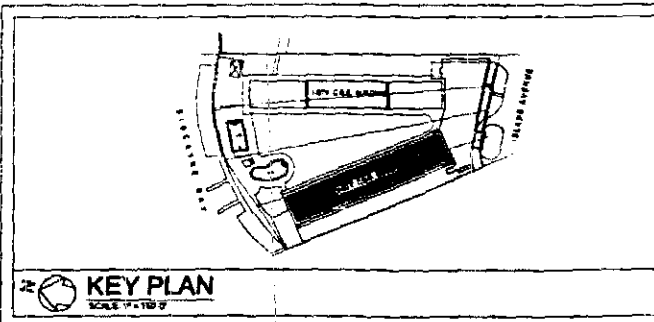
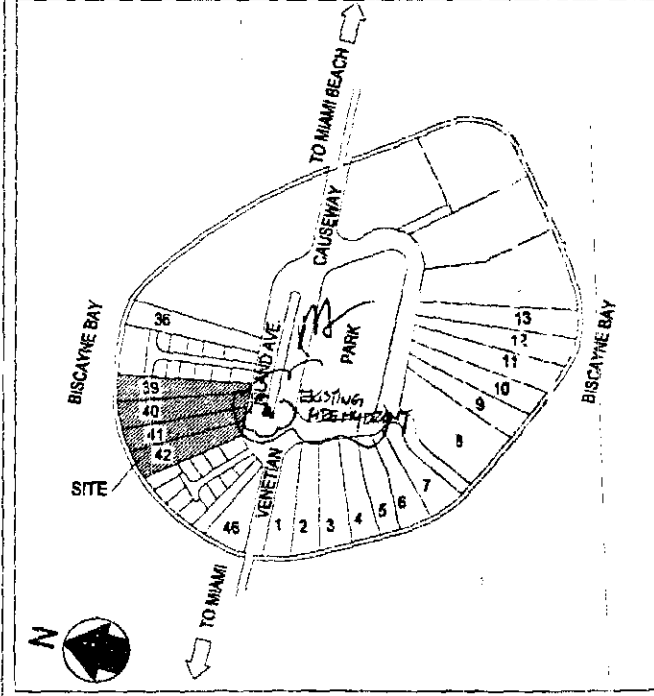
FOLIO NO.: 02-2233-004-0000

GENERAL NOTES


- ALL WORK LISTED ON THE CONSTRUCTION DOCUMENT NOTES AND SHOWN OR IMPLIED ON ALL DRAWINGS SHALL BE SUPPLIED AND INSTALLED BY THE GENERAL CONTRACTOR UNLESS OTHERWISE NOTED ON DRAWINGS. IT IS EXPECTED THAT THE GENERAL CONTRACTOR SHALL CLOSELY COORDINATE HIS WORK WITH THE WORK OF ALL SUBCONTRACTORS TO ASSURE ALL CONSTRUCTION SCHEDULES ARE MET.
- ALL WORK SHALL COMPLY WITH THE REGULATIONS THE GOVERNMENTAL AUTHORITIES HAVE JURISDICTION. THE CONSTRUCTION DOCUMENTS SHALL BE SUPPLEMENTAL TO ALL LAWS & CODES OF GOVERNMENTAL REGULATIONS RELATING TO BUILDINGS. ALL APPLICABLE REQUIREMENTS SPECIFIED IN THESE REGULATIONS SHALL BE FOLLOWED AS THOUGH SPECIALLY NOTED IN THE CONSTRUCTION DOCUMENTS. HOWEVER, THIS SHOULD NOT BE CONSTRUED TO MEAN THAT ANY REQUIREMENTS SET FORTH IN THE CONSTRUCTION DOCUMENTS CAN BE MODIFIED BECAUSE THEY ARE NOT SPECIALLY NOTED BY SUCH CODES OF LAWS.
- ALL DRAWINGS AND NOTES ARE COMPLEMENTARY AND WHAT IS CALLED FOR BY ANY WILL BE BINDING AS IF CALLED FOR BY ALL.
- THE CONTRACTOR SHALL NOTIFY THE ARCHITECT IMMEDIATELY IF HE OR SHE CANNOT COMPLY WITH ANY AND/OR ALL INCLUDED CONSTRUCTION DOCUMENTS.
- BEFORE COMMENCING ANY WORK, THE CONTRACTOR SHALL NOTIFY THE ARCHITECT OF ANY DISCREPANCIES BETWEEN THE DRAWINGS, THE CONSTRUCTION NOTES AND FIELD CONDITIONS.
- WHERE THE TERM 'APPROVED' OR 'APPROVED EQUAL' IS USED IN THE CONSTRUCTION NOTES, IT SHALL BE UNDERSTOOD THAT THE REFERENCE IS MADE TO THE RULING AND JUDGMENT OF AND PROPOSED SUBSTITUTE SHALL BE SUBMITTED TO THE ARCHITECT FOR REVIEW AND WRITTEN APPROVAL.
- THE GENERAL CONTRACTOR SHALL FURNISH THE ARCHITECT WITH PROGRESS SCHEDULES FOR ALL PHASES OF CONSTRUCTION.
- ALL CORRESPONDENCE TO PROFESSIONAL RELATED TO THIS PROJECT, AND TO THE CLIENT SHALL BE FORWARDED IN COPIES TO ALL PARTIES INVOLVED.
- THE GENERAL CONTRACTOR SHALL SUBMIT FOR APPROVAL ALL SHOP DRAWINGS, SCHEDULES AND FUTURE CUTS IN TRIPLICATE, ONE COPY IN SEPIA FORM. ALL DOCUMENTS MARKED 'APPROVED' SHALL SUPERSEDE THE ORIGINALS.
- ALL SHOP DRAWINGS SHALL BE FILED BY THE GENERAL CONTRACTOR. IN ADDITION, ALL ENGINEERING DRAWINGS SHALL BE FILED BY THE RESPECTIVE ENGINEERING CONTRACTOR.
- THE CHARACTER AND SCOPE OF THE WORK ARE ILLUSTRATED BY THE DRAWINGS LISTED. CONTRACTOR IS RESPONSIBLE FOR OBTAINING AND/OR REQUESTING ANY ADDITIONAL DETAIL DRAWINGS REQUIRED TO INTERPRET AND EXPLAIN THE CONSTRUCTION DOCUMENTS AND OTHER INFORMATION DEEMED NECESSARY TO PERFORM WORK. IT SHALL BE UNDERSTOOD THAT THIS ADDITIONAL DATA SHALL BE CONSIDERED AS FORMING A PART OF THESE NOTES AS THEY RELATE.
- THE USE OF THE WORDS 'SUPPLIED BY' OR 'PROVIDED', IN CONNECTION WITH ANY ITEM SPECIFIED IT IS INTENDED TO MEAN THAT SUCH ITEM SHALL BE FURNISHED, INSTALLED AND CONNECTED WHERE SO REQUIRED (UNLESS OTHERWISE NOTED).
- THE GENERAL CONTRACTOR SHALL BE RESPONSIBLE FOR THE SECURITY AND SAFETY OF THE CONSTRUCTION SITE UNTIL THE SPACE IS TURNED OVER TO THE CLIENT.
- THE GENERAL CONTRACTOR SHALL MAINTAIN A CURRENT AND COMPLETE SET OF CONSTRUCTION DRAWINGS ON THE CONSTRUCTION FLOOR DURING ALL PHASES OF CONSTRUCTION FOR USE BY ALL TRADES. A SET INDICATING AS-BUILT CONDITIONS SHALL BE FORWARDED TO THE ARCHITECT UPON PROJECT COMPLETION.
- UPON JOB COMPLETION, THE GENERAL CONTRACTOR SHALL SUBMIT CERTIFICATES OF INSPECTION FROM THE REQUIRED LOCAL AUTHORITIES AND OBTAIN CERTIFICATES OF COMPLETED INSPECTION.
- THE GENERAL CONTRACTOR SHALL PROVIDE ALL NECESSARY PROTECTION OF PUBLIC AREAS AND SHALL BE RESPONSIBLE FOR KEEPING THESE AREAS CLEAN AND FREE OF MATERIALS AT ALL TIMES.

17- Project EDC/MDM/MDM 30 FF ONLY/0000 21/01/00
2-01/01/00 20/01/00

VICINITY MAP



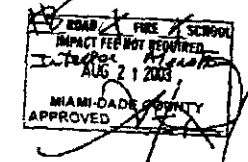NOTE: THE WEST WING SIDE OF
SEVERAL ADJACENT BUILDINGS FOR
THE PROJECT. REMAINING ALL NOTES
OF EXISTING, BUT CONSTRUCTION ONLY
ILLUSTRATIONS & WORK APPLICABLE
FACILITIES LOCATIONS WILL BE INDICATED
PLEASE TO FURNISH THE ARCHITECT OF THIS
PHASE



OFFICE COPY CITY OF MIAMI BEACH APPROVED FOR PERMIT BY THE FOLLOWING:

BUILDING: *[Signature]*
ZONING: *[Signature]*
DRB/HPB: *[Signature]*
CONCURRENCY: *[Signature]*
PLUMBING: *[Signature]*
ELECTRICAL: *[Signature]*
MECHANICAL: *[Signature]*
FIRE PREVENTION: *[Signature]*
ENGINEERING: *[Signature]*
PUBLIC WORKS: *[Signature]*
STRUCTURAL: *[Signature]*
ACCESSIBILITY: *[Signature]*
ELEVATOR: *[Signature]*

As per Florida Building Code Section 104.5.3
REVIEWED FOR CODE COMPLIANCE

PUBLIC WORKS
PLAN REVIEW NOTICE
Phone 305-438-7000 Fax 305-438-7008

THIS PLAN REVIEW CONSTITUTE APPROVAL FOR
OBTAINING BUILDING PERMITS ONLY.

All construction and/or use of equipment in the right-of-way and/or
encroachment, requires a separate Public Works Department review prior
to start of construction.

Permit Requirements: Proof of existing adjacent property conditions
(photos) and/or proof of sidewalk safety (photos)
(photos) and/or proof of sidewalk safety (photos)
(photos) and/or proof of sidewalk safety (photos)
(photos) and/or proof of sidewalk safety (photos)

Approved By: *[Signature]* 7/3/03

PROJECT ARCHITECT
ALISON SPEAR, A.I.A.
180 NE 39th St., Suite 222, Miami, FL 33137
305-438-1200 fax 305-438-1221

SEAL
[Signature]
7/3/03

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Architect.

PROJECT TITLE
**LIDO SPA HOTEL
WEST WING - RENOVATION**
40 ISLAND AVENUE, MIAMI BEACH, FL 33139

DRAWING TITLE
**DWG. INDEX, GENERAL
NOTES, LOCATION MAP**

DRAWN BY: B.F.L.
CHECKED BY: A.S.
ISSUED

SHEET NO.
A-0.00

FUTURE IMPROVEMENTS
UNDER SEPARATE PERMIT

4" NOMINAL WIDTH MEANS
OF EGRESS AS PER NFPA 101.7.2
MINIMUM

ALL EXISTING DOORS SHALL BE
PROVIDED WITH UL LISTED
OVERHEAD CLOSING DEVICES
AND SHALL ACCOMMODATE
WHEN FULLY OPEN A CLEAR
PASSAGE OF NO LESS THAN 18"

EAST WING RENOVATIONS
UNDER SEPARATE PERMIT

EMERGENCY LIGHTING AND EXIT DESIGNATION
TO BE PROVIDED AT ALL EXTERIOR AREAS AS
REQUIRED

4" NOMINAL WIDTH MEANS
OF EGRESS AS PER NFPA 101.7.2
MINIMUM

EXISTING 2" R. SEPARATION MIN.
TO BE MAINTAINED

ISLAND AVENUE
PUBLIC WAY

MAIN BUILDING RENOVATIONS
UNDER SEPARATE PERMIT

ACCESSIBLE ROUTE FROM SIDE WALK
TO GUESTROOMS:
NOTE:
ROUTE TO COMPLY WITH ALL REQUIREMENTS
FOR ACCESSIBLE ROUTE AS PER FBC 11-4.3,
INCLUDING 1/2" MAX. CHANGE IN LEVELS AT ALL DOORS

EXISTING PAIR OF 6" NOMINAL WIDTH DOORS
ARE SUFFICIENT FOR EXIT CAPACITY FOR THE SCOPE
OF THIS PHASE NEW EGRESS COMPONENTS WILL
BE ADDED AS NEEDED UNDER SEPARATE PERMIT.

ANY FUTURE SCOPE OF
WORK TO ACCOMMODATE
EMERGENCY VEHICULAR
ACCESS WILL BE DESCRIBED
UNDER SEPARATE PERMIT
NOT APPLICABLE TO THIS
PHASE OF THE PROJECT

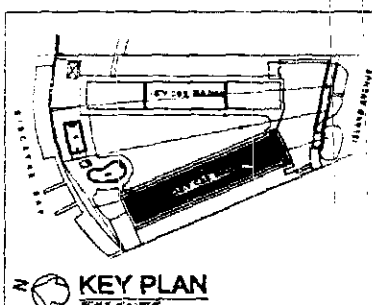
NOTE:
AS PER NFPA 13.5.5 FIRE JET ARE NOT REQUIRED FOR BUILDINGS
SET BACK LESS THAN 10 FEET FROM A PUBLIC ROAD NOR FOR
BUILDINGS MORE THAN 30 FEET IN HEIGHT AND SET BACK LESS
THAN 50 FEET FROM A PUBLIC ROAD

NOTE:
WITH THE EXCEPTION OF THE EXISTING ONE STORY R-1 MOTEL, ALL
OTHER OCCUPANCY LOADS, FACTORS, FLOWS & CLEAR NOMINAL
EGRESS WIDTHS ARE PROVIDED FOR REVIEW INFORMATION
ASSISTANCE ONLY. THE PURPOSE IS TO DEMONSTRATE THE SITE
SITE ELEMENT CAPACITY TO ACCOMMODATE THE ENTIRE PROJECT
WHEN COMPLETE


OFFICE COPY
CITY OF MIAMI BEACH
APPROVED FOR PERMIT BY
THE FOLLOWING:

BUILDING:
ZONING:
DRR/HB:
CONCURRENCY:
PLUMBING:
ELECTRICAL:
MECHANICAL:
FIRE PREVENTION:
ENGINEERING:
PUBLIC WORKS:
STRUCTURAL:
ACCESSIBILITY:

SCALE: 1" = 20'-0"



LIFE SAFETY PROGRAM SUMMARY			
	MOTEL	HOTEL	MOTEL
GENERAL	EXISTING R-1 MOTEL ONE STORY 13,200 SF	EXISTING R-1 MOTEL 2 STORY 11,100 SF	
TABLE 300	YES 13R UNPROTECTED TYPE V MAX 30 FT MAX 30 FT MAX 30 FT	YES 13R UNPROTECTED TYPE V MAX 30 FT MAX 30 FT MAX 30 FT	
CONCEALED SPACES	YES YES WOOD FRAMING EXISTING HVAC SUPPLY RETURN DUCTWORK YES 13R YES AS PER FBC 707	YES YES WOOD FRAMING EXISTING HVAC SUPPLY RETURN DUCTWORK YES 13R YES AS PER FBC 707	
TENANT SEPARATION	1-1R FBC 704.2.1 YES 13R AS PER FBC 220.2	1-1R FBC 704.2.1 YES 13R AS PER FBC 220.2	
ALARM / DETECTION	YES YES YES YES YES	YES YES YES YES YES	
PARKING	NA	NA	
SEPARATION OF HAZARDOUS AREAS	AS PER NFPA 101 20.3.2.2	AS PER NFPA 101 20.3.2.2	
DISCHARGE OF EXITS	150' TO PUBLIC WAY	150' TO PUBLIC WAY	
MEANS OF EGRESS	ILLUMINATION: INCLUDES EXTERIOR PATHWAYS	ILLUMINATION: INCLUDES EXTERIOR PATHWAYS	
EMERGENCY LIGHTING	NA	NA	
MARKING OF MEANS OF EGRESS	REQUIRED	REQUIRED	
VERTICAL OPENINGS	EXIST AS PER EXCEPTIONS 2 & 3 OF NFPA 101	EXIST AS PER EXCEPTIONS 2 & 3 OF NFPA 101	
INTERIOR WALL CEILING FINISH	CLASS A, B, OR C	CLASS A, B, OR C	
SMOKE ALARM	PROVIDED BY AN AUTOMATIC DETECTION SYSTEM IN ROOMS	PROVIDED BY AN AUTOMATIC DETECTION SYSTEM IN ROOMS	
PORTABLE FIRE EXTINGUISHERS	AS PER NFPA 101	AS PER NFPA 101	
SUPERVISION OF BUILDING SPACES (SMOKE BARRIERS)	NA	NA	
OPERATING FEATURES	NOT REQUIRED	NOT REQUIRED	
EMERGENCY INSTRUCTIONS FOR RESIDENTS OR GUESTS AS PER NFPA 101 20.3.4	REQUIRED	REQUIRED	

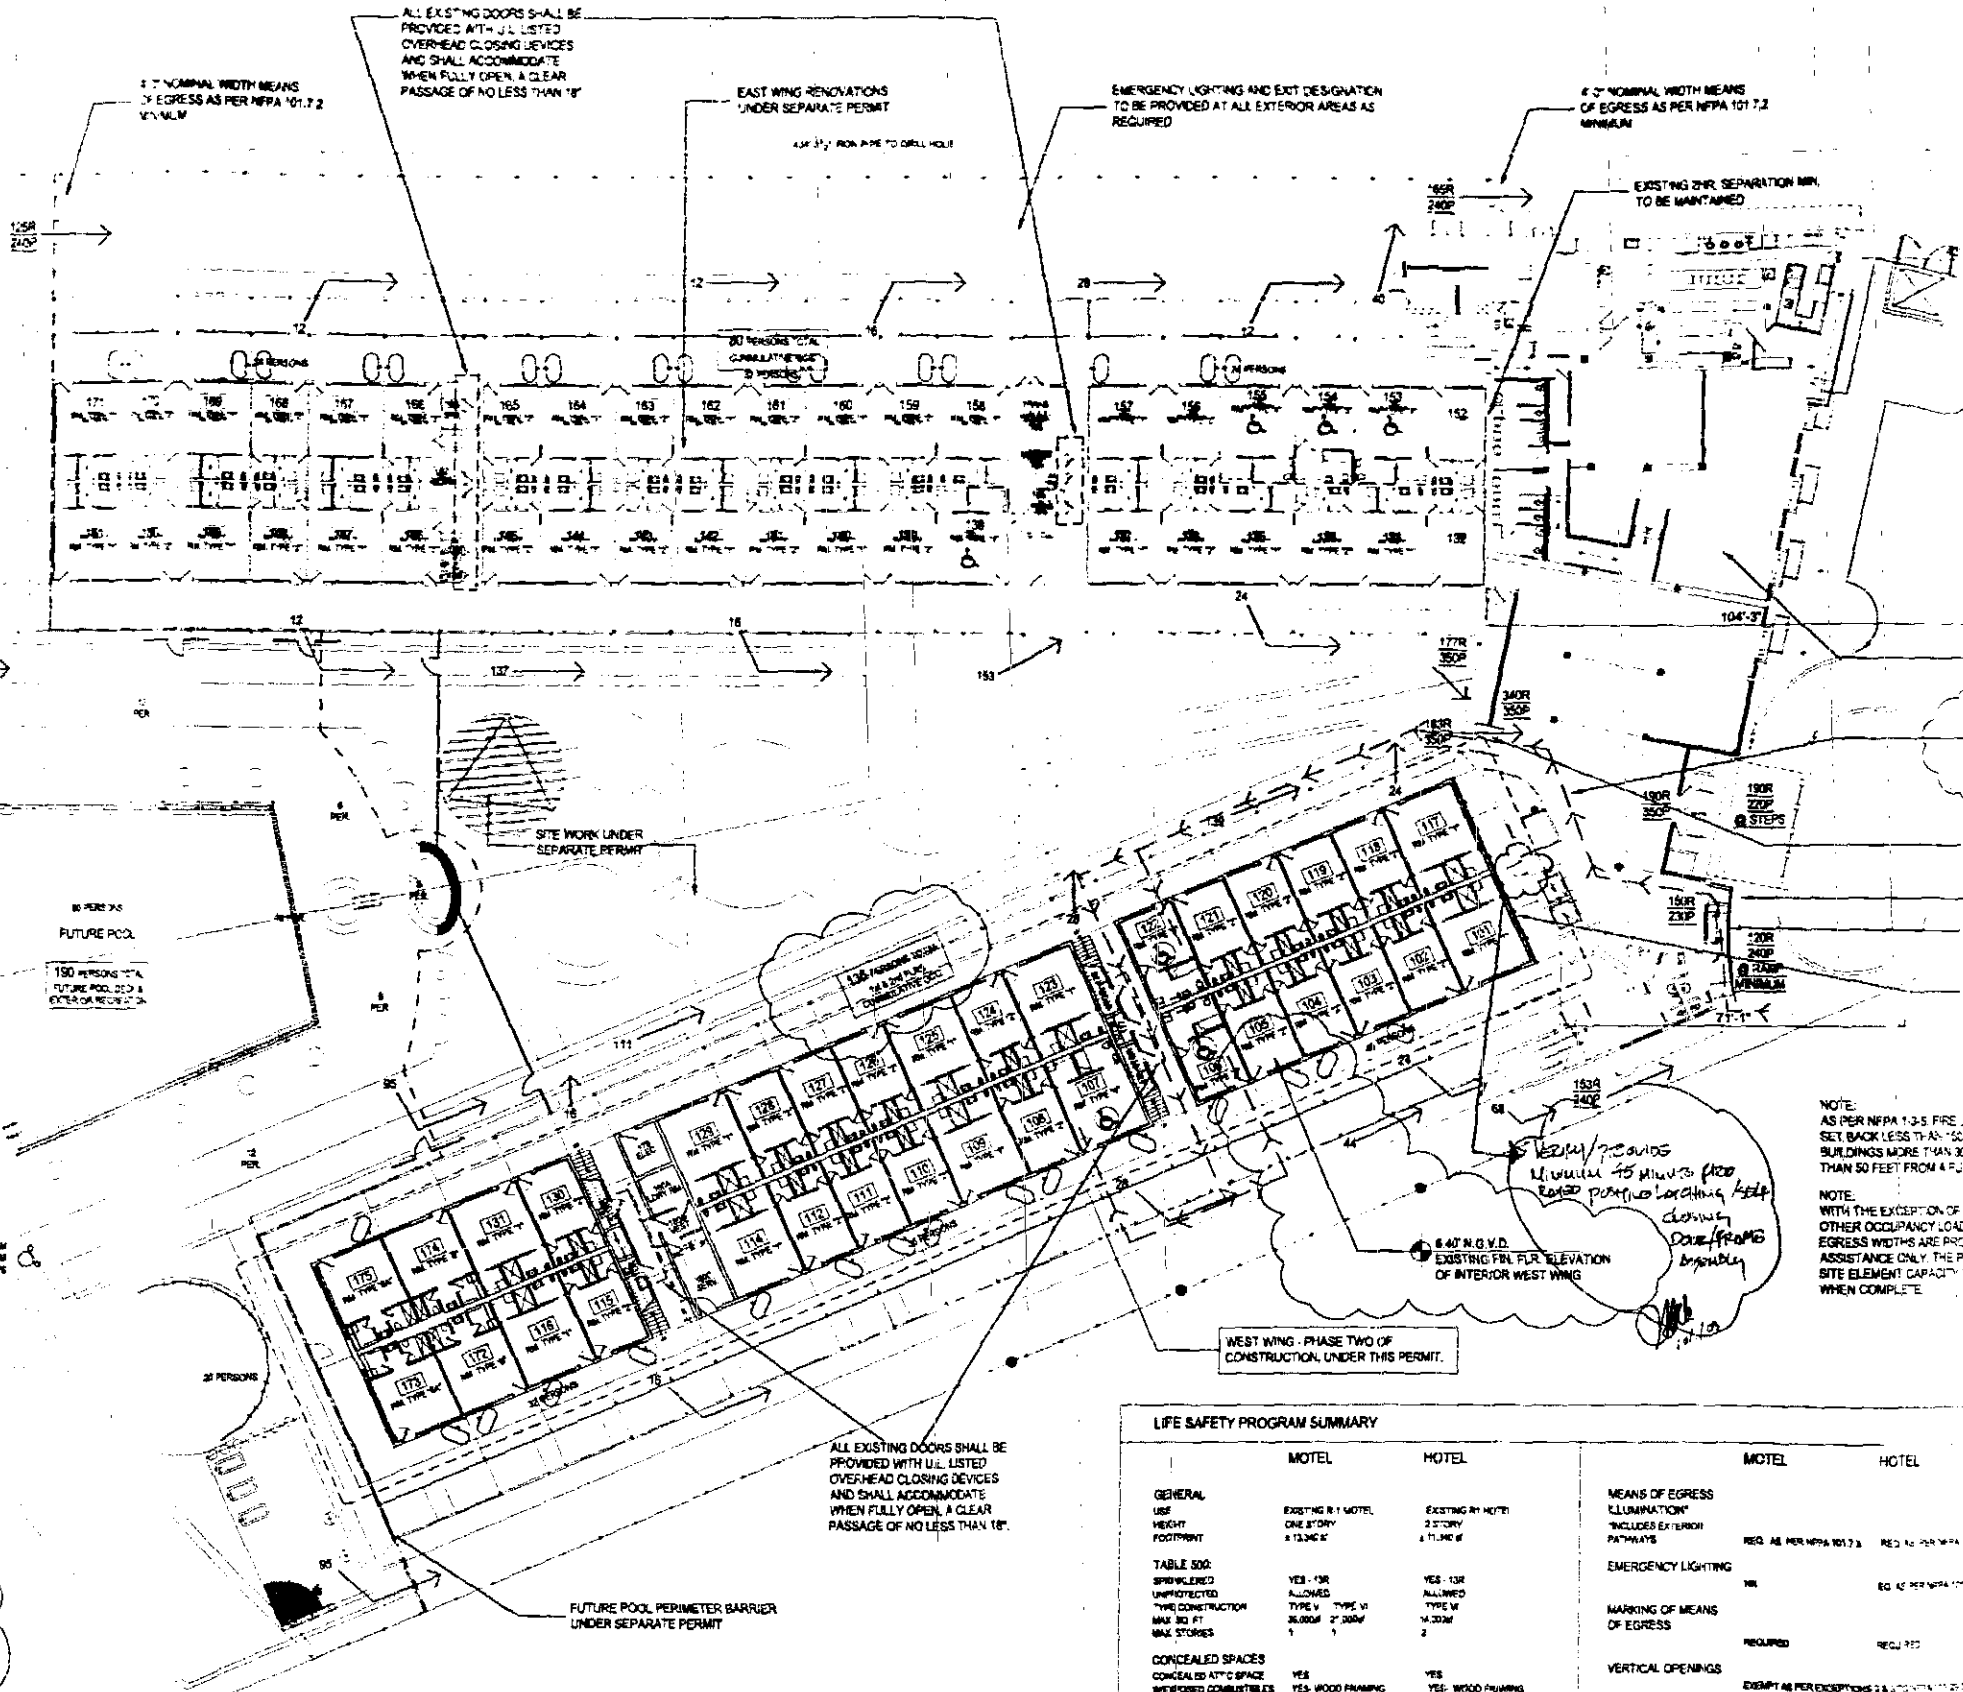

LIFE SAFETY NARRATIVE

ANALYSIS OF R-1 BUILDING REQUIREMENTS BY EXISTING HEIGHT AND EXISTING BUILDING AREA.

THE EAST (1) SINGLE STORY MOTEL SUMMARY: THE EXISTING 13-15,000 SQ. FT. / 10 UNIT MOTEL WING HAS AND WILL MAINTAIN DIRECT EXIT MEANS OF ESCAPE ACCESS TO THE EXTERIOR / OUTSIDE AT GRADE. FOR THIS PROJECT ALL EXISTING ATTIC CONCEALED SPACES ARE TO BE MAINTAINED IN ORDER TO ACCOMMODATE NEW ADDITIONAL / INDEPENDENT HVAC COMPONENTS FOR EACH ROOM / SUITE. THE EXISTING HVAC SYSTEM IS TO BE REMOVED IN ITS ENTIRETY, HOWEVER THE EXISTING CONCEALED SPACE IS TO BE SPRINKLERED AS PART OF AN ENGINEERED NFPA 13R SYSTEM THAT WILL INCLUDE THE MOTEL DWELLING UNITS IN ADDITION TO PROVIDING AUTOMATIC SPRINKLER PROTECTION FOR EACH UNIT'S EXTERIOR PRIVATE AREA AS SUCH AND ARE PERMITTED BY ALLOWABLE CHARACTERISTICS FOR SPRINKLERED TYPE V OR VI CONSTRUCTION. COMPARTMENTATION IS NOT REQUIRED.

AS PER TABLE 300: WHEN SPRINKLERED, EITHER TYPE V OR TYPE VI UNPROTECTED CONSTRUCTION PARAMETERS ARE ACCEPTABLE. WHERE EXISTING SPRINKLERED SPACES ARE PART OF THE TENANT SEPARATION IT IS CONSIDERED AS THE AIR SPACE PORTION OF THE ASSEMBLY.

REGARDING TENANT SEPARATION: (1) - ONE HOUR IS REQUIRED IN ANY CASE.

REGARDING CONSTRUCTION: (1) - WITH SPRINKLERS IN EITHER TYPE V OR TYPE VI CONSTRUCTION EXPOSED COMBUSTIBLES IN CONCEALED SPACES ARE ALLOWED.

NOTE: AS PER FBC 201-102.4 TYPE V AND TYPE VI CONSTRUCTION PARTITIONS

MEANS OF EGRESS / COMPONENTS

ALL MEANS OF EGRESS, INCLUDING THE EXISTING OPEN STAIRS ARE EXTERIOR MEANS OF EXIT ACCESS. MAXIMUM ALLOWABLE TRAVEL DISTANCE TO AN EXIT IS NEVER REACHED.

DOOR TO MULTIPLE REMOTE STAIRS FOR EXIT ACCESS AND LACK OF DEAD ENDS. PROTECTION OF THE EXISTING EXTERIOR STAIRS IS NOT REQUIRED.

PROTECTION OF OPENINGS BETWEEN THE INTERIOR OF THE DWELLING UNITS AND THE EXTERIOR MEANS OF EXIT ACCESS IS NOT REQUIRED.

SITE EMERGENCY ACCESS LINES

NOT REQUIRED.

ELEVATORS

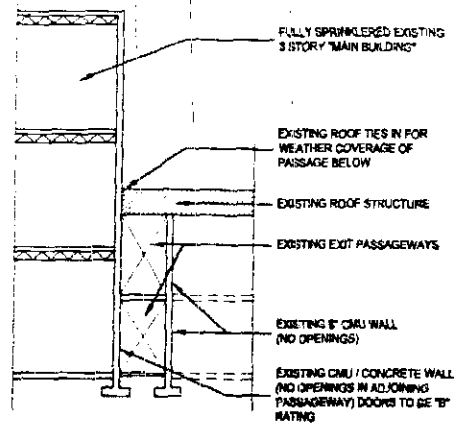
NOT APPLICABLE TO EXISTING HOTEL/MOTEL AS PART OF THIS SCOPE OF WORK.

DETECTION, ALARM, COMMUNICATIONS SYSTEM

NOT REQUIRED. HOWEVER, SEE MECHANICAL CHANGES FOR SMOKEFREE CHAMBER MONITORING/SUPERVISION DETAIL. THE 13R SYSTEM SHALL ALSO BE MONITORED/SUPERVISED.

MARINA / DOCK

CLASS 2 STANDPIPE REQUIRED. 100 GPM @ 30 MINUTES SUPPLY.



SCHEMATIC SECTION BETWEEN
MAIN BUILDING AND WEST WING

PROJECT ARCHITECT
ALISON SPEAR, A.I.A.
180 NE 39th St., Suite 222, Miami, FL 33137
305-438-1200 fax 305-438-1221

SEAL
ALISON SPEAR
8/27/07


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PROJECT TITLE
LIDO SPA HOTEL
WEST WING - RENOVATION
40 ISLAND AVENUE, MIAMI BEACH, FL 33139

DRAWING TITLE
SITE PLAN - LOCATION SKETCH

DRAWN BY: B.F.L.
CHECKED BY: A.S.
ISSUES

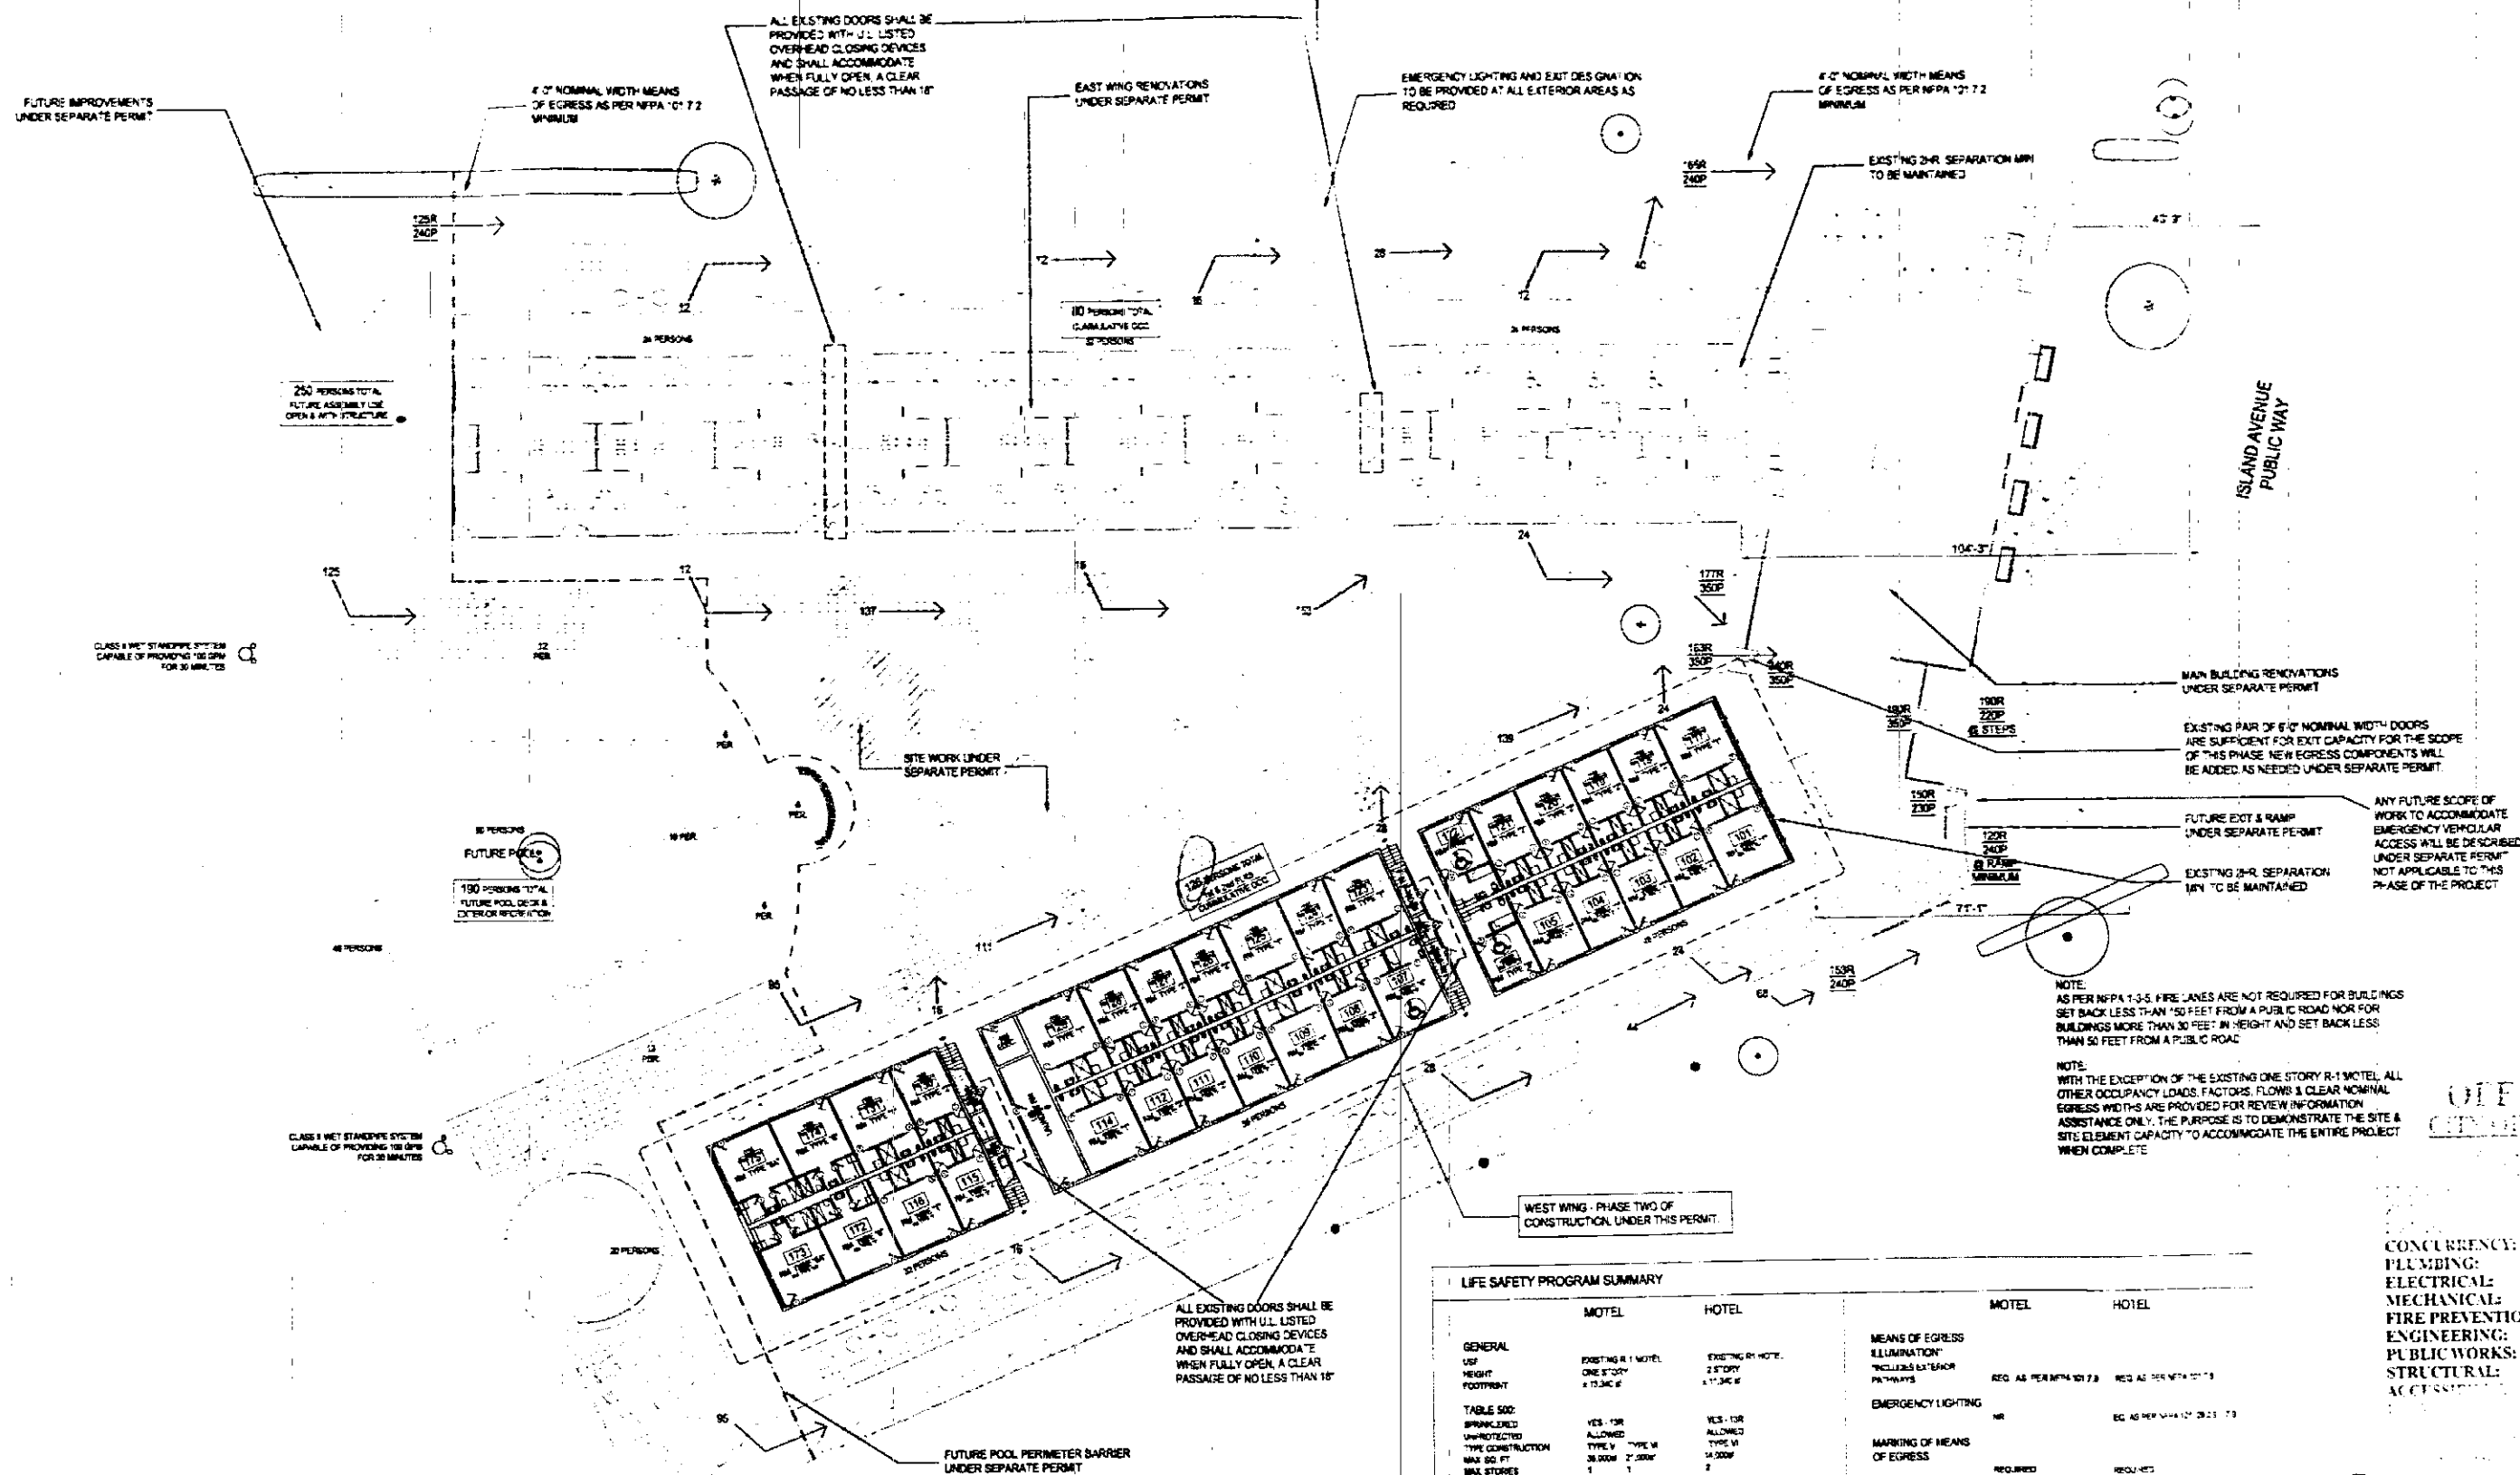SHEET NO.
A-0.01



LIFE SAFETY NARRATIVE

ANALYSIS OF R-1 BUILDING REQUIREMENTS BY EXISTING HEIGHT AND EXISTING BUILDING AREA

THE EAST (1) SINGLE STORY MOTEL SUMMARY: THE EXISTING AT-GRADE, SINGLE STORY, APPROXIMATELY 12,380 SQ. FT. / 40 UNIT MOTEL WING HAS AND WILL MAINTAIN DIRECT MEANS OF ESCAPE ACCESS TO THE EXTERIOR / OUTSIDE AT GRADE. FOR THIS PROJECT ALL EXISTING AT-GRADE CONCEALED SPACES ARE TO BE MAINTAINED IN ORDER TO ACCOMMODATE NEW INDIVIDUAL / INDEPENDENT HVAC COMPONENTS FOR EACH ROOM / SUITE. THE EXISTING HVAC SYSTEM IS TO BE REMOVED IN ITS ENTIRETY. HOWEVER THIS EXISTING CONCEALED SPACE IS TO BE SPRINKLERED AS PART OF AN ENGINEERED NFPA 13R SYSTEM THAT WILL INCLUDE THE MOTEL DWELLING UNITS IN ADDITION TO PROVIDING AUTOMATIC SPRINKLER PROTECTION FOR EACH UNIT'S EXTERIOR PRIVACY AREA. AS SUCH, AND AS PERMITTED BY ALLOWABLE CHANGING EXISTING FOR SPRINKLERED TYPE V OR V CONSTRUCTION, COMPARTMENTATION IS NOT REQUIRED.

AS PER TABLE 500: WHEN SPRINKLERED, EITHER TYPE V OR TYPE VI UNPROTECTED CONSTRUCTION PARAMETERS ARE ACCEPTABLE. WHERE EXISTING SPRINKLERED SPACES ARE PART OF THE TENANT SEPARATION IT IS CONSIDERED AS THE AIR SPACE PORTION OF THE ASSEMBLY.

REGARDING TENANT SEPARATION: (1) - ONE HOUR IS REQUIRED IN ANY CASE.

REGARDING COMBUSTIBLES IN CONCEALED SPACES: WITH SPRINKLERS IN EITHER TYPE V OR TYPE VI CONSTRUCTION EXPOSED COMBUSTIBLES IN CONCEALED SPACES ARE ALLOWED.

MEANS OF EGRESS / COMPONENTS
• ALL MEANS OF EGRESS, INCLUDING THE EXISTING OPEN STAIRS ARE EXTERIOR MEANS OF EXIT ACCESS. MAXIMUM ALLOWABLE TRAVEL DISTANCE TO AN EXIT IS NEVER REACHED.
• DUE TO MULTIPLE REMOTE STAIRS FOR EXIT ACCESS AND LACK OF DEAD ENDS, PROTECTION OF THE EXISTING EXTERIOR STAIRS IS NOT REQUIRED.
• PROTECTION OF OPENINGS BETWEEN THE INTERIOR OF THE DWELLING UNITS AND THE EXTERIOR MEANS OF EXIT ACCESS IS NOT REQUIRED.

SITE EMERGENCY ACCESS LAKES NOT REQUIRED.

ELEVATORS: NOT APPLICABLE TO EXISTING HOTEL/MOTEL AS PART OF THIS SCOPE OF WORK.


DETECTION, ALARM, COMMUNICATIONS SYSTEM NOT REQUIRED. HOWEVER, SEE MECHANICAL DRAWINGS FOR SMOKEFIRE DAMPER MONITORING/SUPERVISORY DETAIL. THE 13R SYSTEM SHALL ALSO BE MONITORED/SUPERVISED.

MARINA / DOCK CLASS B STANDPIPE REQUIRED: 100 GPM @ 30 MINUTES SUPPLY.

LIFE SAFETY PROGRAM SUMMARY

	MOTEL	HOTEL	MOTEL	HOTEL
GENERAL				
USE	EXISTING R-1 MOTEL	EXISTING R-1 MOTEL	MEANS OF EGRESS	
HEIGHT	ONE STORY	ONE STORY	INCLUDES EXISTING PATHTWAYS	REQ. AS PER NFPA 101 7.3
FOOTPRINT	17,300 SQ. FT.	17,300 SQ. FT.		REQ. AS PER NFPA 101 7.3
TABLE 500:			EMERGENCY LIGHTING	
SPRINKLERED	YES - 13R	YES - 13R	NR	REQ. AS PER NFPA 101 7.3
UNPROTECTED	ALLOWED	ALLOWED		
TYPE CONSTRUCTION	TYPE V	TYPE V	MARKING OF MEANS OF EGRESS	
MAX. SQ. FT.	36,000	36,000	REQUIRED	REQUIRED
WALL STORIES	1	1		
CONCEALED SPACES	YES	YES	VERTICAL OPENINGS	
CONCEALED ATTIC SPACE	YES	YES	EXEMPT AS PER EXCEPTIONS 2 & 3 TO TABLE 503.1	
WEAPONIZED COMBUSTIBLES	YES - WOOD FRAMING	YES - WOOD FRAMING	INTERIOR WALL	
USE	EXISTING HVAC SUPPLY RETURN DUCTWORK	EXISTING HVAC SUPPLY RETURN DUCTWORK	CEILING FINISH	CLASS A & B OR C
SPRINKLERED	YES - 13R	YES - 13R		CLASS A & B OR C
EXPOSED COMBUSTIBLES	YES AS PER	YES AS PER	SMOKE ALARM	
ALLOWED	REC 707	REC 707	PROVIDED BY AN AUTOMATIC DETECTION SYSTEM THROUGHOUT	REQUIRED
TENANT SEPARATION	1-HR. REC 707.2.1	1-HR. REC 707.2.1	PORTABLE FIRE EXTINGUISHERS	AS PER NFPA 10
BETWEEN UNITS	YES @ 100% AS PER REC 2006.2	YES @ 100% AS PER REC 2006.2		AS PER NFPA 10
DRAFT STOPS @ ATTIC			SUPERVISION OF BUILDING SPACES (SMOKE BARRIERS)	NR
ALARM / DETECTION				NR
COMMUNICATIONS	NR	NR	OPERATING FEATURES	
SEE MECHANICAL DRAWINGS FOR SMOKEFIRE DAMPER MONITORING/SUPERVISORY DETAIL			HOTEL EMERGENCY EMPLOYEE ONLY	REQUIRED
PARKING	NR	NR	EMERGENCY INSTRUCTIONS FOR RESIDENTS OR GUESTS	REQUIRED
SEPARATION OF HAZARDOUS AREAS	AS PER NFPA 101 20.3.2.2	AS PER NFPA 101 20.3.2.2		REQUIRED
CHANGE OF EXITS	150' TO PUBLIC WAY	150' TO PUBLIC WAY		

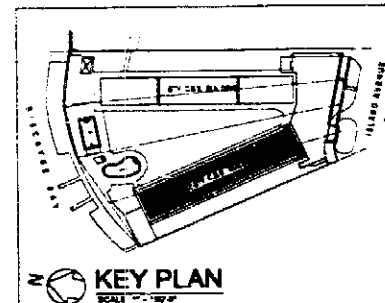SITE PLAN
SCALE: 1" = 20'-0"



PROJECT ARCHITECT
ALISON SPEAR, A.I.A.
180 NE 39th St., Suite 222, Miami, FL 33137
305-438-1200 fax 305-438-1221

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7-23-02

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PROJECT TITLE
LIDO SPA HOTEL
WEST WING - RENOVATION
40 ISLAND AVENUE, MIAMI BEACH, FL 33139

DRAWING TITLE
SITE PLAN
LOCATION SKETCH

DRAWN BY: B.F.L.
CHECKED BY: A.S.
ISSUES

07-23-02 PERMIT ISSUE

SHEET NO.

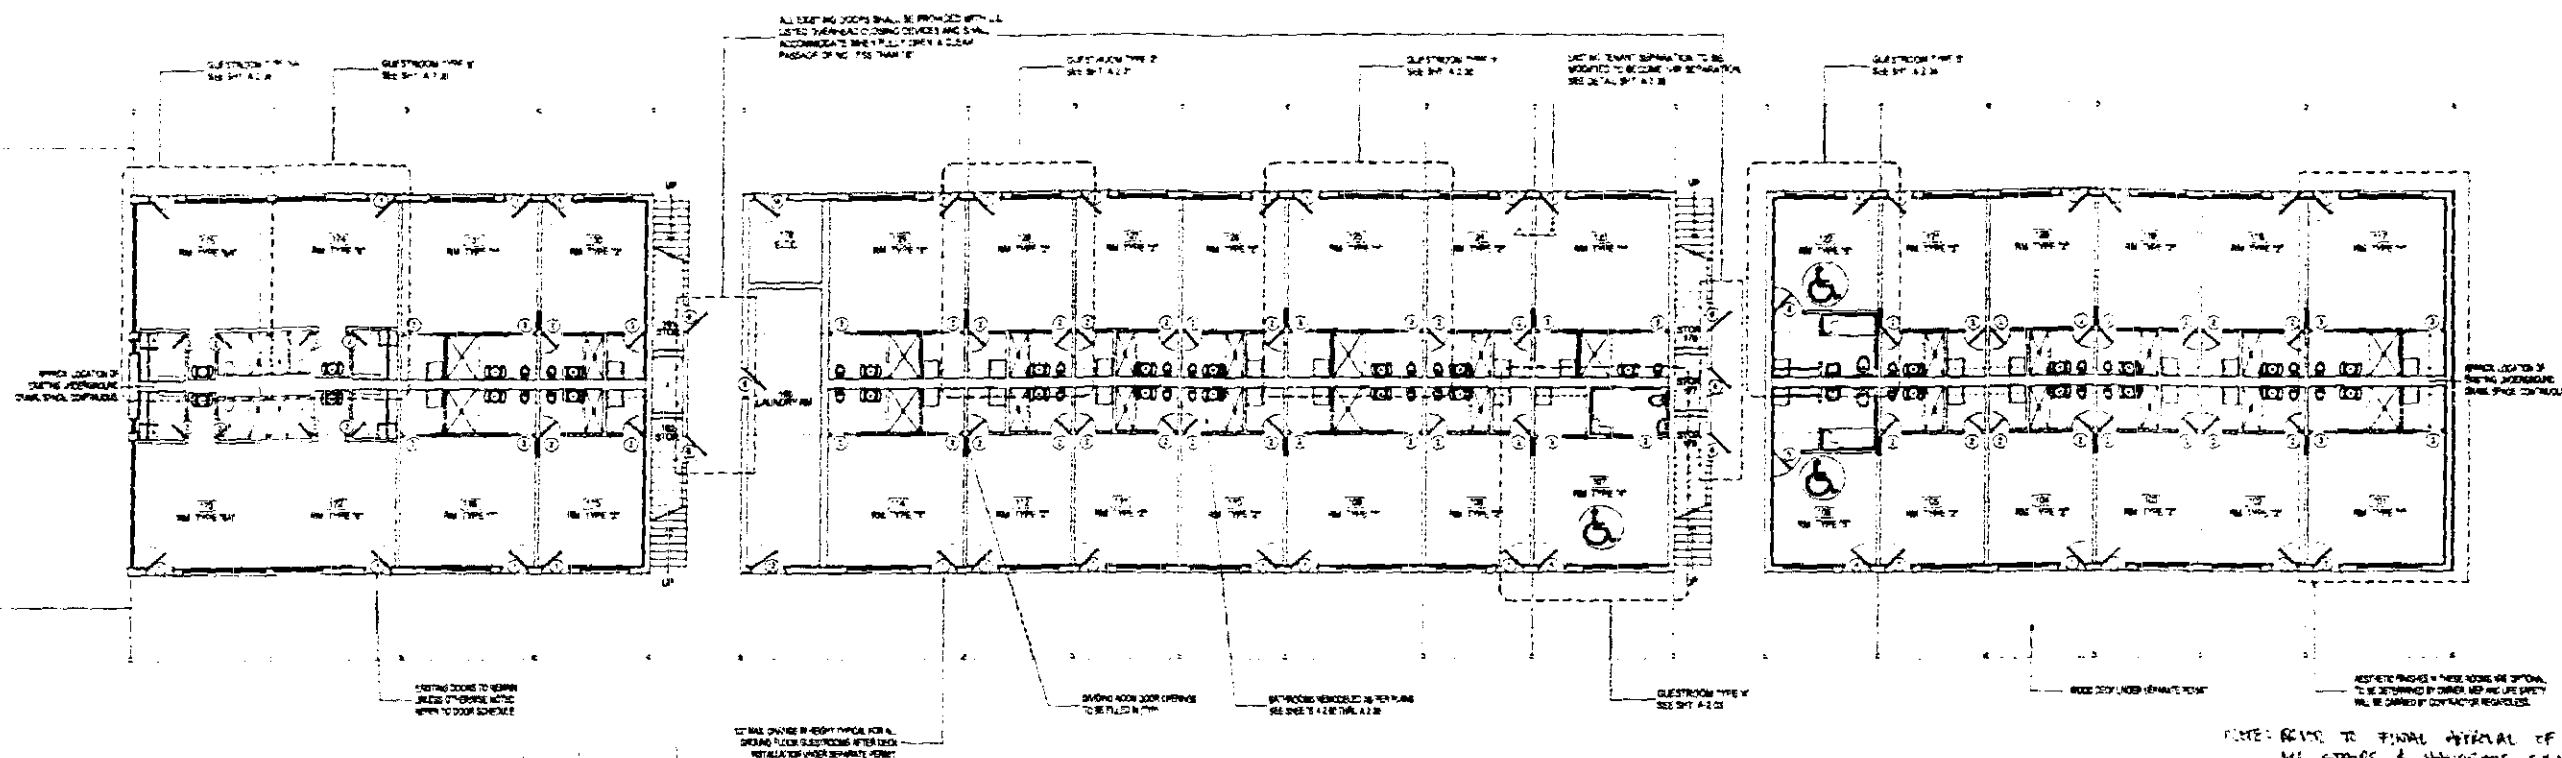
A-0.01

ACCESSIBLE TRANSPORT LOGGING


- A minimum number of sleeping accommodations shall be provided for persons with hearing impairments.
- In order to provide persons with disabilities a range of options equivalent to those available to other persons served by the facility, sleeping accommodations shall be provided for persons with disabilities in sleeping accommodations available to persons of the gender of persons having disabilities. Access to lavatories, restrooms, room hall, coin, automatic payphone, and the number of beds provided.
- Alternates to accessible units, sleeping rooms, or a person will be accommodated on the basis of at least one fully accessible unit for each 25 sleeping units, including at least one sleeping room or suite for each 25 sleeping rooms that comply with the requirements for visual alarms, notification devices, and telephones.

CURRENCY:
 PUMPING:
 ELECTRICAL:
 MECHANICAL:
 FIRE PREVENTION:
 ENGINEERING:
 PUBLIC WORKS:
 STRUCTURAL:
 ACCESSIBILITY:
 ELEVATOR:

SHEET NO.
A-0.03



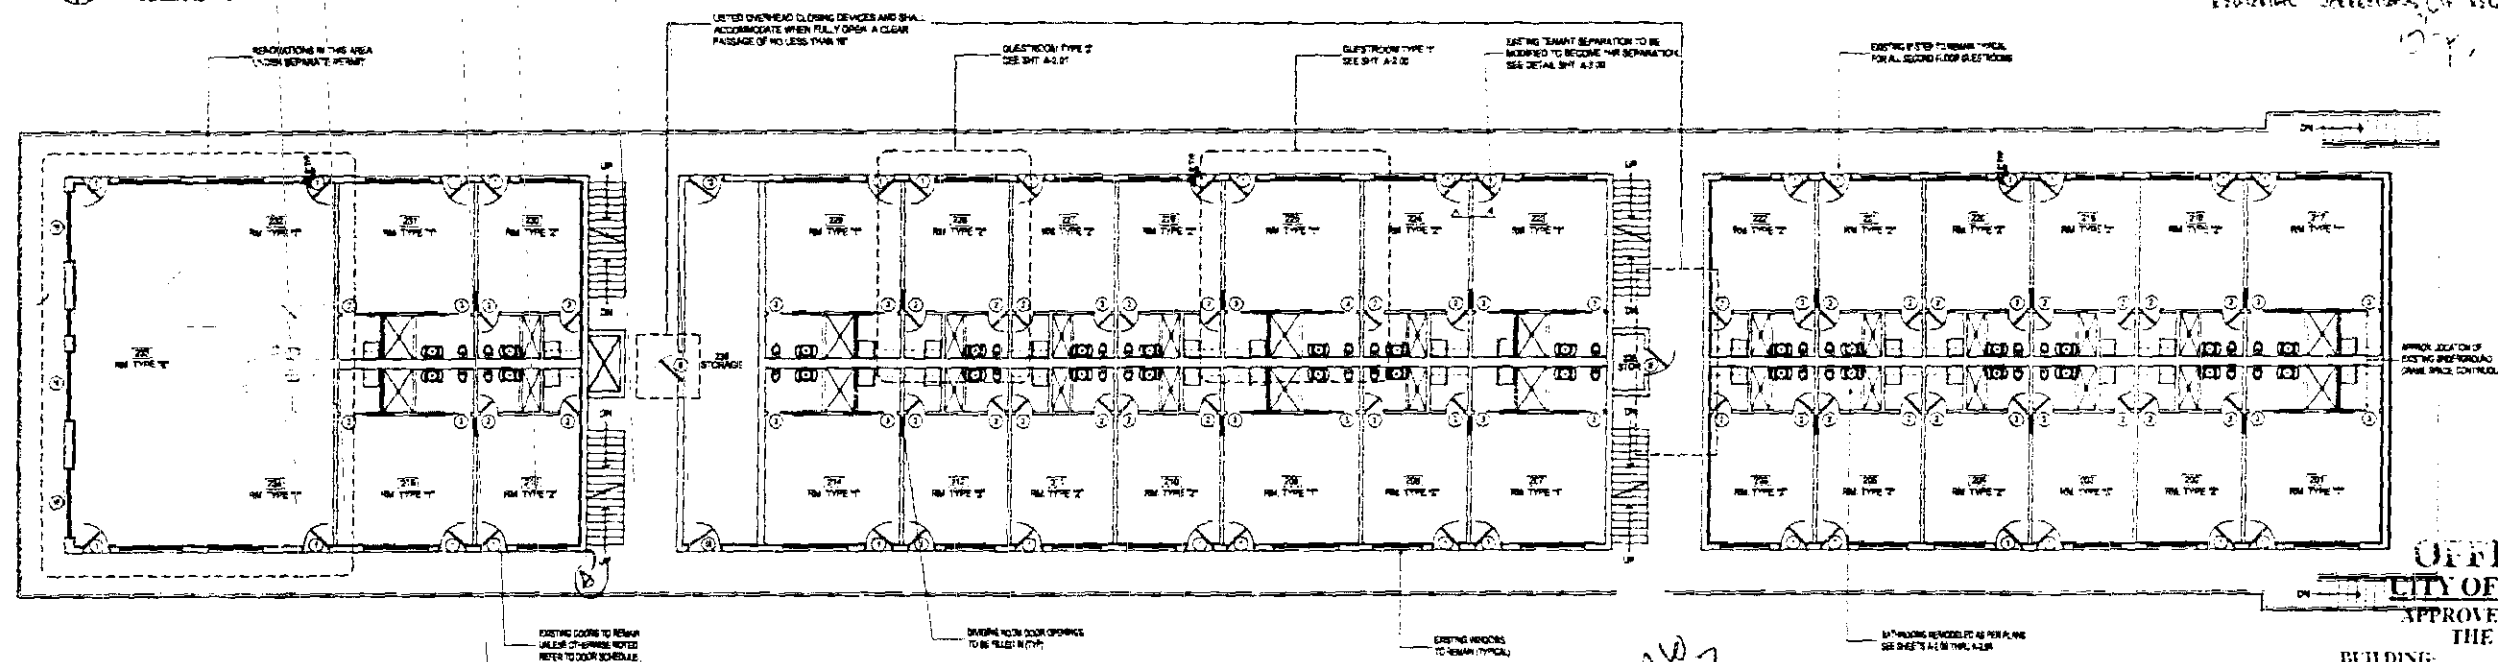
WEST WING - GROUND FLOOR - PROPOSED FLOOR PLAN
SCALE: 3/32" = 1'-0"




WEST WING - SECOND FLOOR - PROPOSED FLOOR PLAN
SCALE: 3/32" = 1'-0"

NOTE:
BOTH MOTEL AND HOTEL FACILITIES WILL BE FULLY
SPRINKLERED IN ACCORDANCE WITH NFPA 13R,
INCLUDING ALL GUESTROOMS, SUITES, EXISTING
CONCEALED ATTIC SPACES & GUESTROOM COVERED
TERRACES. SEE MEP DRAWINGS FOR DETAILS.

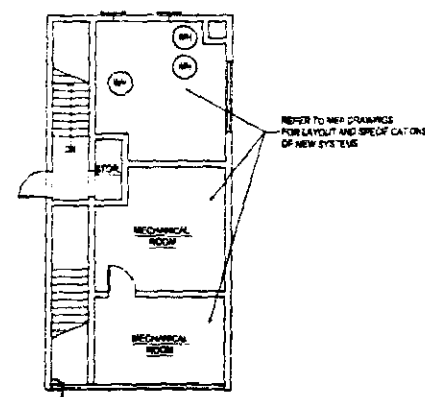NOTES:
1. NEW EXTERIOR DOORS REQUIRE MAIN CODE PRODUCT
APPROVAL - UNDER SEPARATE PERMIT.
2. NEW EXTERIOR DOORS REQUIRE LARGE IMPACT
RESISTANCE OR HURRICANE SHUTTERS - UNDER SEPARATE
PERMIT.



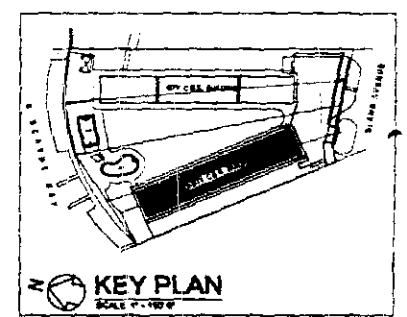3RD FLR. MECHANICAL ROOM
SCALE: 3/32" = 1'-0"



BUILDING:
ZONING:
ORB/HPR:
CONCURRENCY:
PLUMBING:
ELECTRICAL:
MECHANICAL:
FIRE PREVENTION:
ENGINEERING:
PUBLIC WORKS:
STRUCTURAL:
ACCESSIBILITY:
ELEVATOR:

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APPROVED FOR PERMIT BY
THE FOLLOWING:

PROJECT ARCHITECT
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180 NE 39th St., Suite 222, Miami, FL 33137
305-438-1200 fax 305-438-1221


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PROJECT TITLE
**LIDO SPA HOTEL
WEST WING - RENOVATION**
40 ISLAND AVENUE, MIAMI BEACH, FL 33139


DRAWING TITLE
**WEST WING
PROPOSED FLOOR PLANS**

DRAWN BY: B.F.L.
CHECKED BY: A.S.
ISSUES

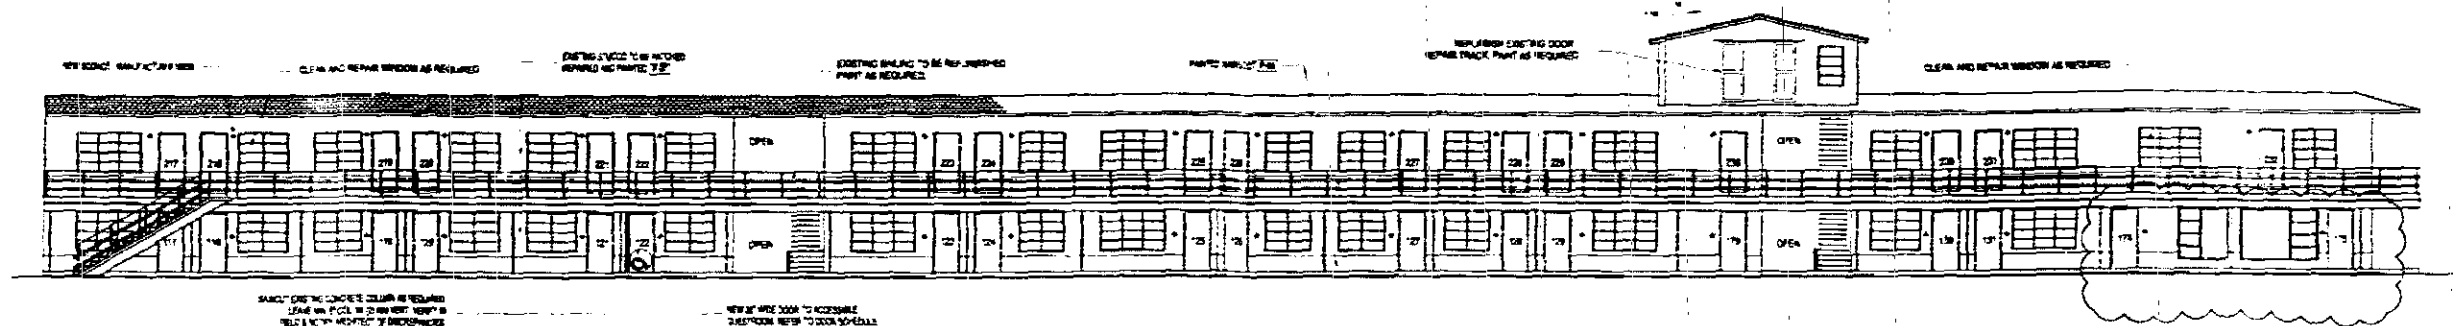
SHEET NO.
A-1.00



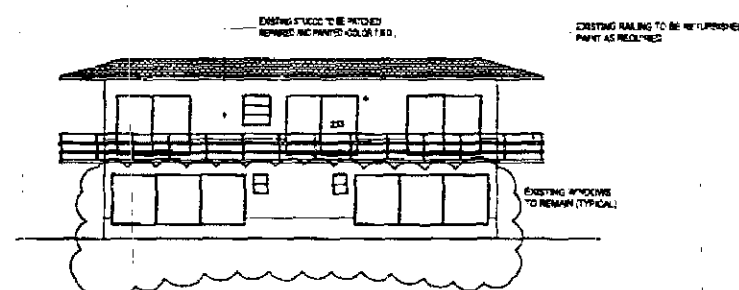
WEST WING - EAST ELEVATION (PROPOSED)
SCALE: 3/32" = 1'-0"



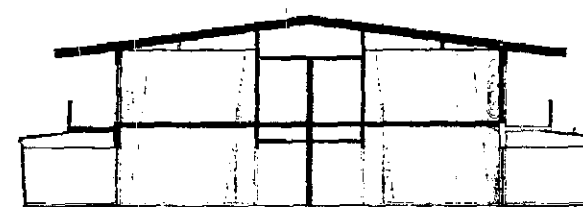WEST WING - NORTH ELEVATION (PROPOSED)
SCALE: 3/32" = 1'-0"



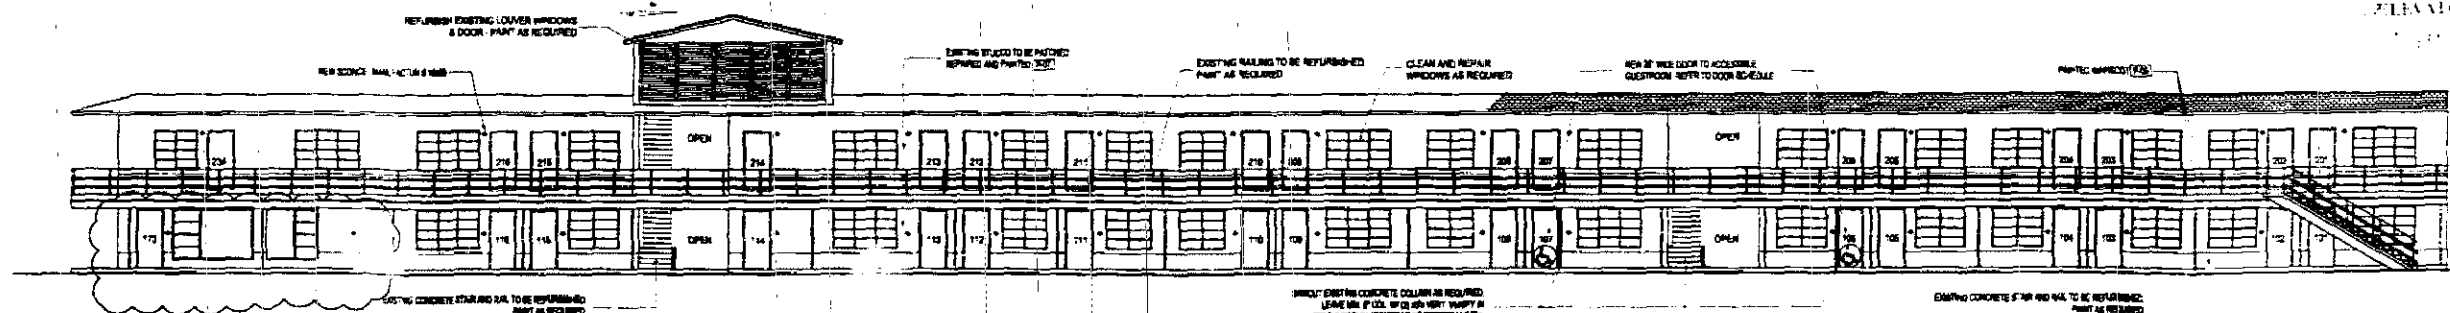WEST WING - SECTION "1"
SCALE: 3/32" = 1'-0"



WEST WING - WEST ELEVATION (PROPOSED)
SCALE: 3/32" = 1'-0"

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DRB/HPR:
CONCURRENCE:
PLUMBING:
ELECTRICAL:
MECHANICAL:
FIRE PREVENTION:
ENGINEERING:
PUBLIC WORKS:
STRUCTURAL:
ACCESSIBILITY:
ELEVATION:

PROJECT ARCHITECT

ALISON SPEAR, A.I.A.
180 NE 39th St., SUITE 222, MIAMI, FL 33137
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8-27-03
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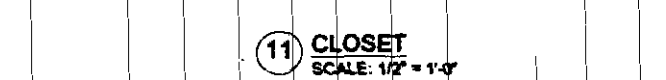
LIDO SPA HOTEL
WEST WING - RENOVATION
40 ISLAND AVENUE, MIAMI BEACH, FL 33139

DRAWING TITLE
WEST WING
PROPOSED ELEVATIONS

DRAWN BY: B.F.L.
CHECKED BY: A.S.
ISSUES
07-23-03 PERMIT ISSUE
08-27-03 REVISION BUILDING DEPT. COMMENTS

SHEET NO.

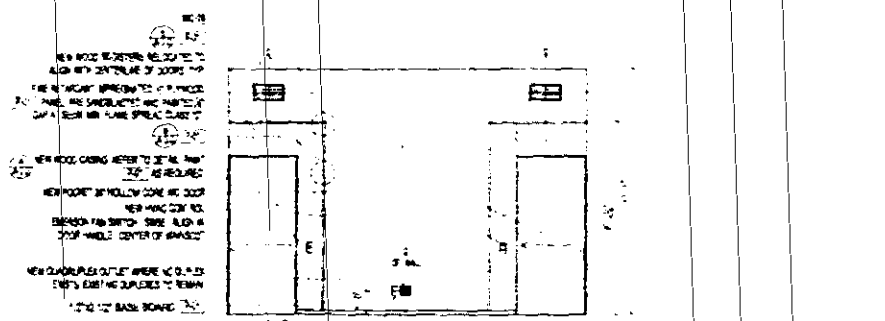
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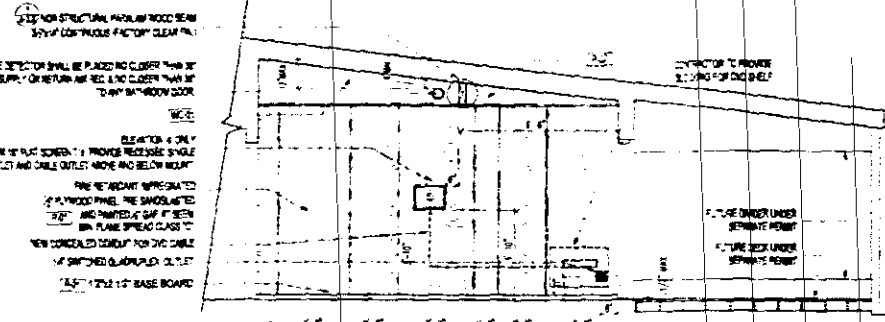
NOTES

1. OUTLET LOCATIONS IN THIS DRAWING ARE FOR DESIGN PURPOSES. ONLY THESE OUTLETS SHOULD BE SUPPLEMENTED AS REQUIRED BY ELECTRICAL ENGINEER'S DRAWINGS TO MEET F.B.C.'S REQUIREMENTS.
2. ALL NON-ESSENTIAL EXISTING OUTLETS SHOULD BE REPLACED WITH BLANK FACE PLATES (WHITE), HORIZONTAL, AT EXISTING HEIGHT.
3. NEW OUTLETS TO BE WHITE WITH WHITE COVER PLATES.
4. CONTRACTOR TO VERIFY LOCATION OF EXISTING OUTLETS AND NOTIFY ARCHITECT OF DISCREPANCIES.
5. NO DEMO ON THIS PERMIT.

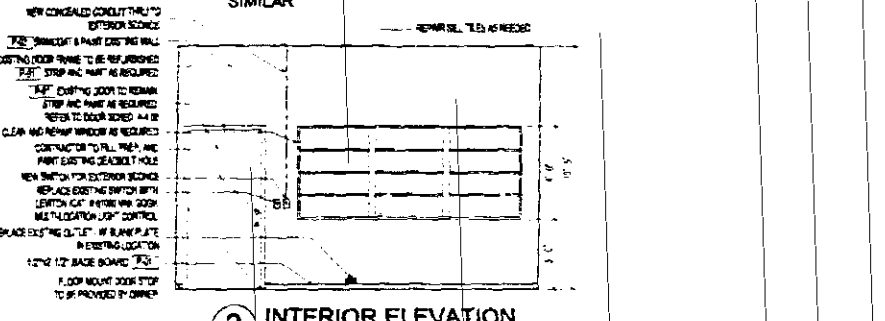
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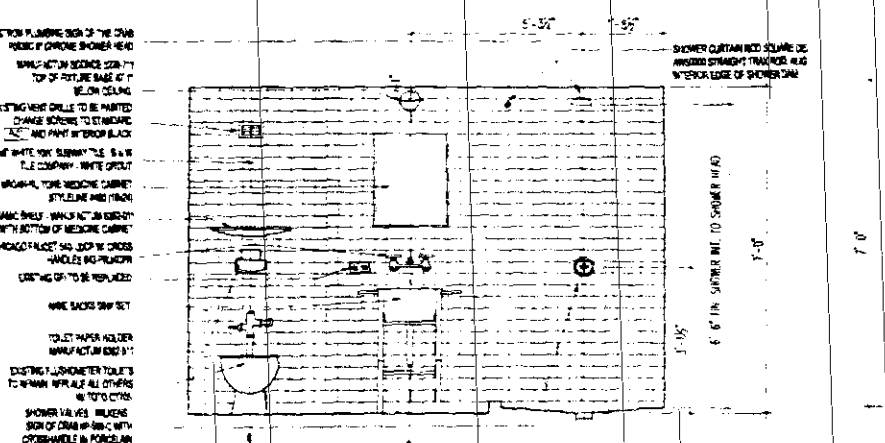
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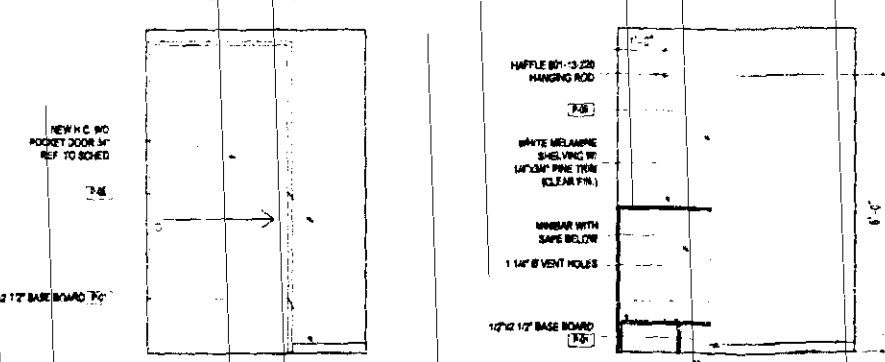
2 4 INTERIOR/EXTERIOR ELEVATION
SCALE: 1/4" = 1'-0"



3 INTERIOR ELEVATION
SCALE: 1/4" = 1'-0"

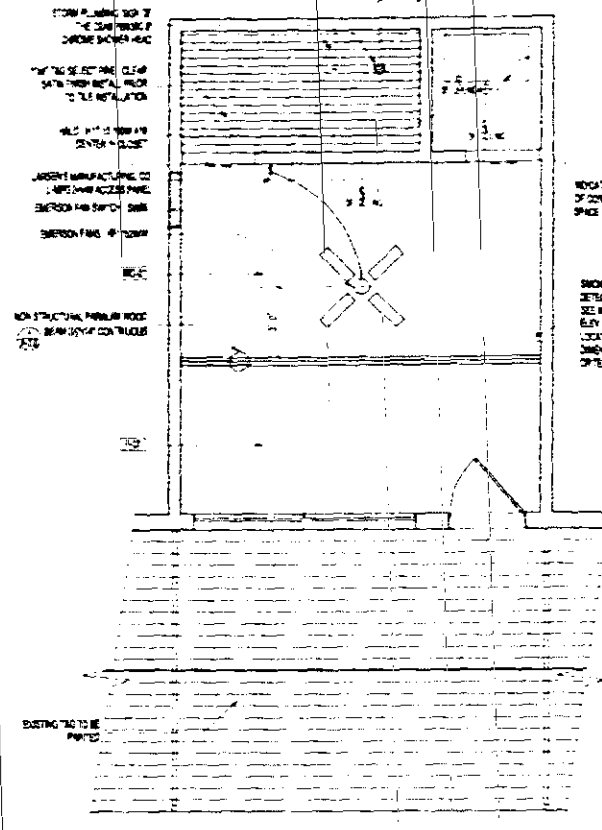


5 BATHROOM
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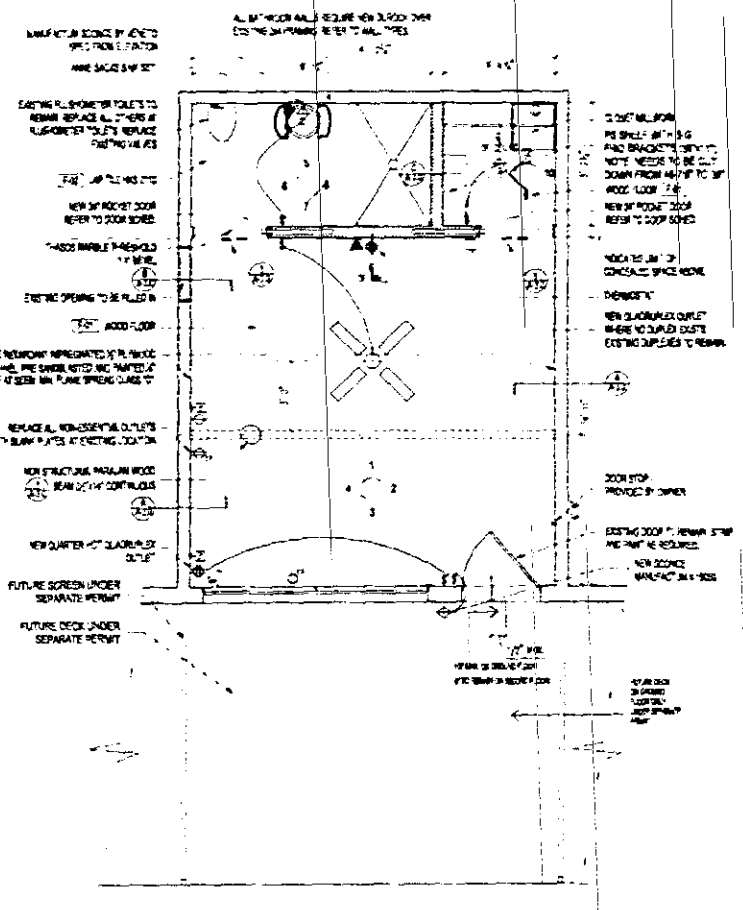


9 CLOSET
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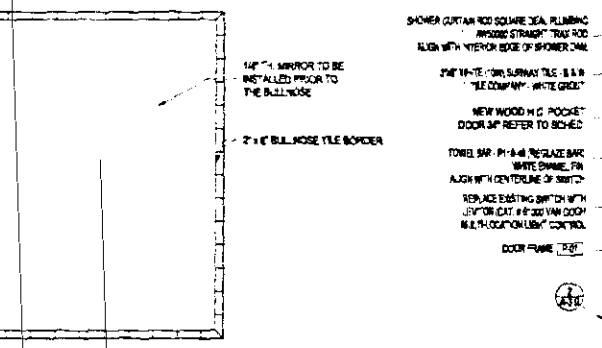
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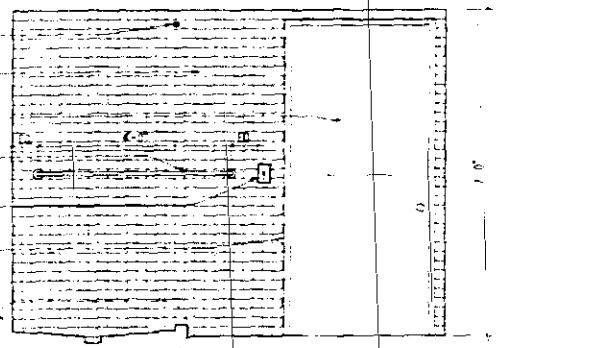
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SCALE: 1/4" = 1'-0"




FLOOR PLAN
SCALE: 1/4" = 1'-0"




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SCALE: 1/2" = 1'-0"



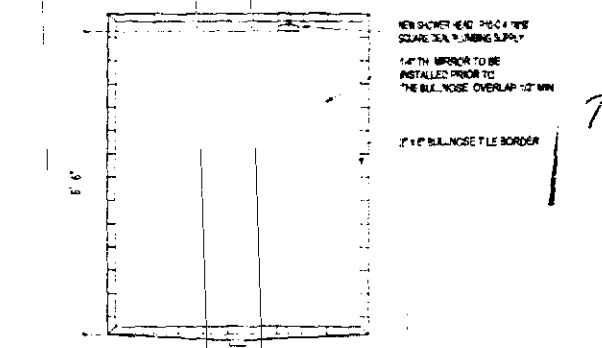
7 BATHROOM
SCALE: 1/2" = 1'-0"



8 BATHROOM
SCALE: 1/2" = 1'-0"

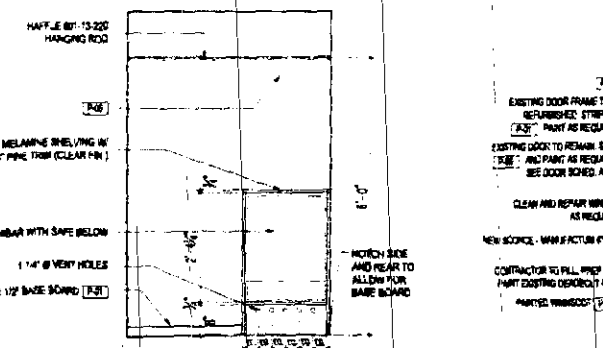

12 CLOSET
SCALE: 1/2" = 1'-0"

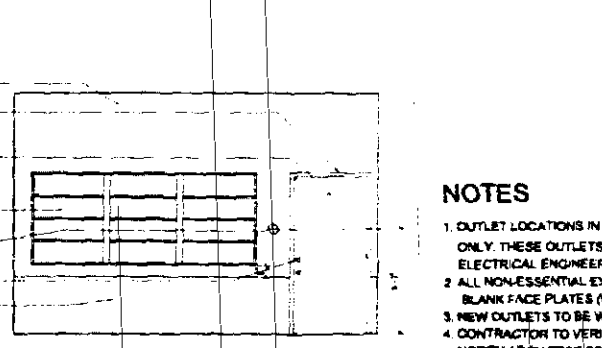

13 EXTERIOR ELEVATION
SCALE: 1/4" = 1'-0"

- NOTES**
1. OUTLET LOCATIONS IN THIS DRAWING ARE FOR DESIGN PURPOSES ONLY. THESE OUTLETS SHOULD BE SUPPLEMENTED AS REQUIRED BY ELECTRICAL ENGINEER'S DRAWINGS TO MEET F.B.C.'s REQUIREMENTS.
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 4. CONTRACTOR TO VERIFY LOCATION OF EXISTING OUTLETS AND NOTIFY ARCHITECT OF DISCREPANCIES.
 5. NO DEMO ON THIS PERMIT.

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PLUMBING:
ELECTRICAL:
MECHANICAL:
FIRE PREVENTION:
ENGINEERING:
PUBLIC WORKS:
STRUCTURAL:
ACCESSIBILITY:
ELEVATION:

PROJECT ARCHITECT
ALISON SPEAR, A.I.A.
100 NE 30th St., Suite 222, Miami, FL 33137
305-438-1200 Fax 305-438-1221

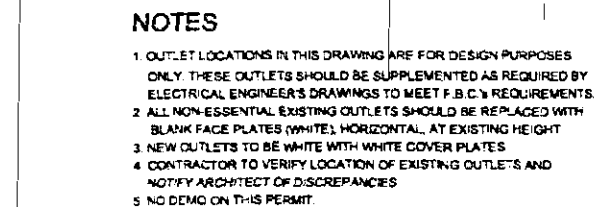
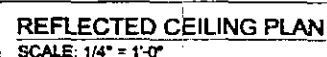
SEAL
Alison Spear
7226
ALISON SPEAR, AIA
AIA #106685

PROJECT TITLE
LIDO SPA HOTEL
WEST WING - RENOVATION
40 ISLAND AVENUE, MIAMI BEACH, FL 33139

DRAWING TITLE
TYPICAL ROOM TYPE "1"

DRAWN BY: B.F.L.
CHECKED BY: A.S.
ISSUES:
10/25/00 PERMIT ISSUE

SHEET NO.
A-2.00



ALISON SPEAR, A.I.A.
180 NE 39th St., Suite 222, Miami, FL 33137
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PROJECT ARCHITECT

SEAL

ALISON SPEAR, AIA
P#R 0016600

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**HOTEL
NOVATION**
11 BEACH, FL 33139

LIDO SPA H
EST WING - RE
ND AVENUE, MIAMI

PROJECT TITLE

PR	


ICAL ROOM TYPE "2"

DRAWING TITLE	TYPE	1


DRAWN BY		B.F.L.
CHECKED BY		A.S.
ISSUES		
07-23-03	PERMIT	ISSUE
08-27-03	REVISION 1 BLDG DEPT	CMTS

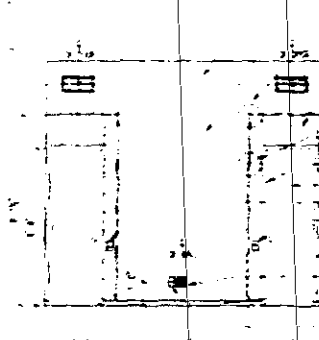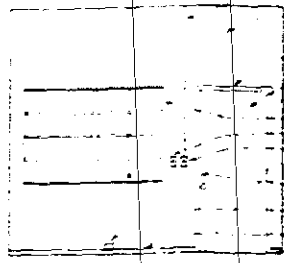SHEET NO

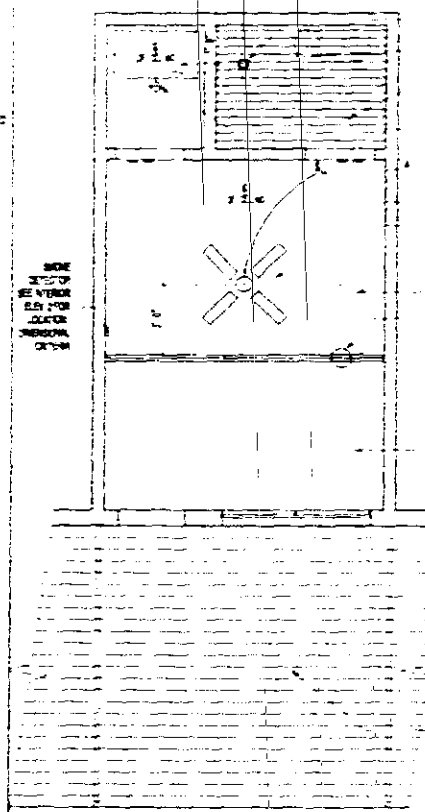
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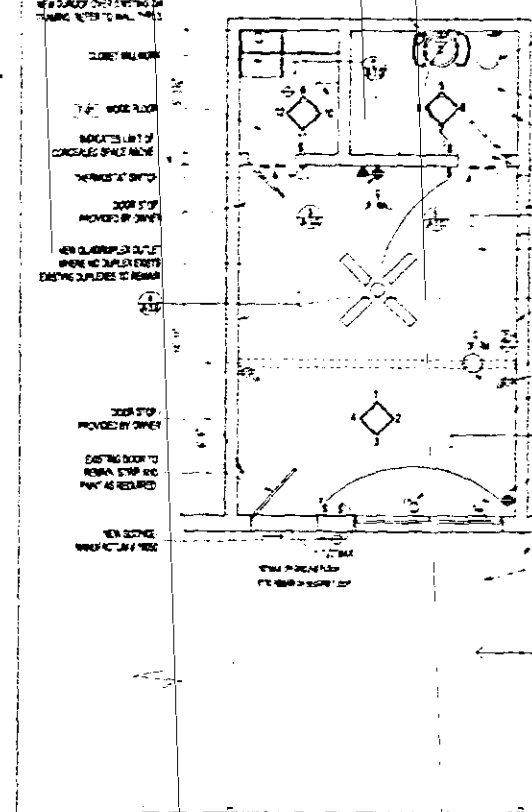
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SCALE: 1/4" = 1'-0"



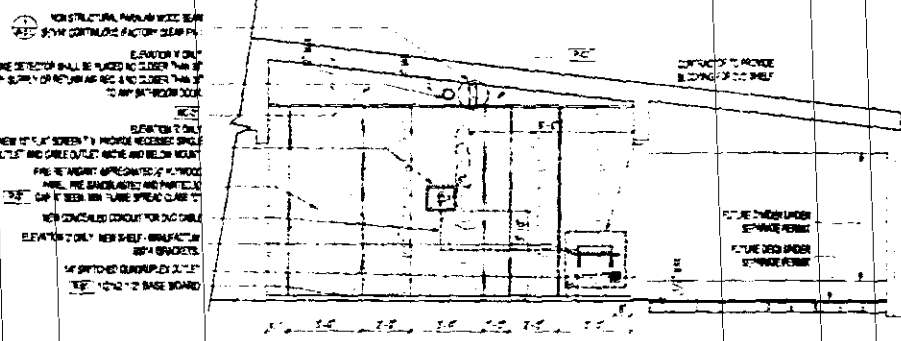
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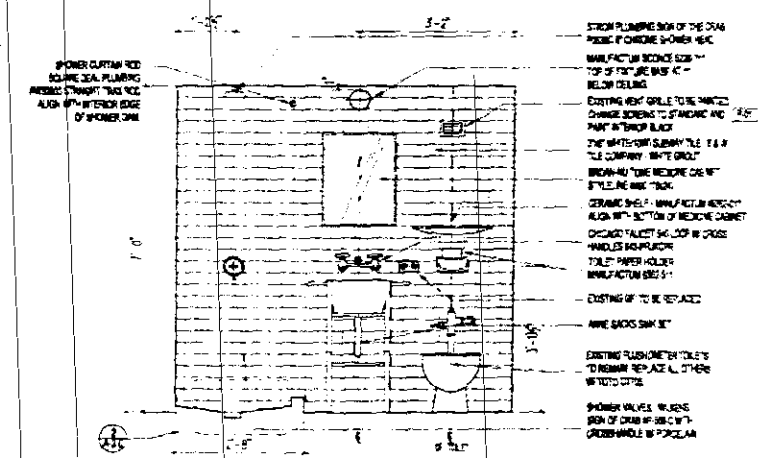
REFLECTED CEILING PLAN
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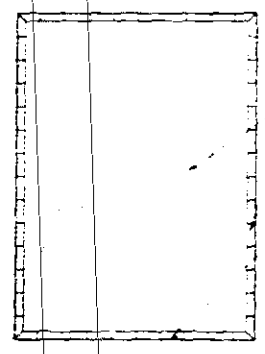
FLOOR PLAN
SCALE: 1/4" = 1'-0"



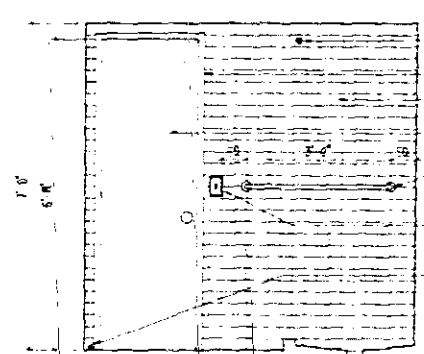
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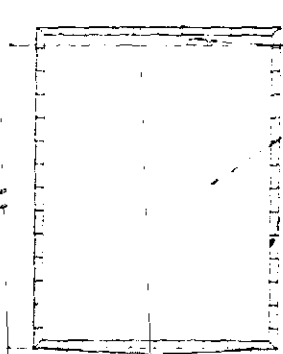
5 BATHROOM
SCALE: 1/2" = 1'-0"



6 BATHROOM
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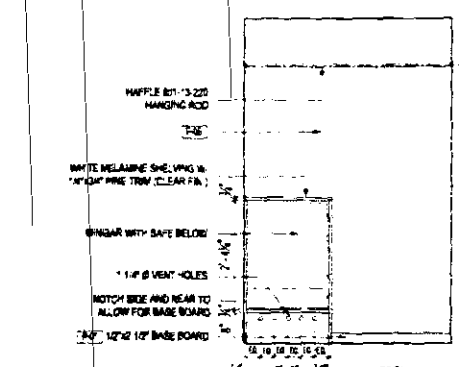


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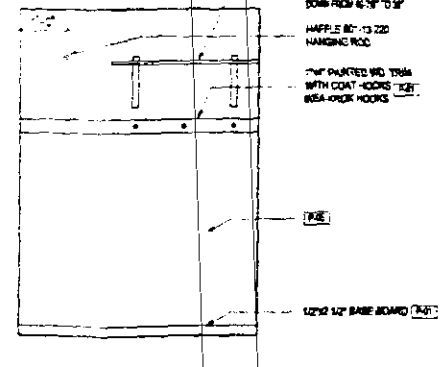


8 BATHROOM
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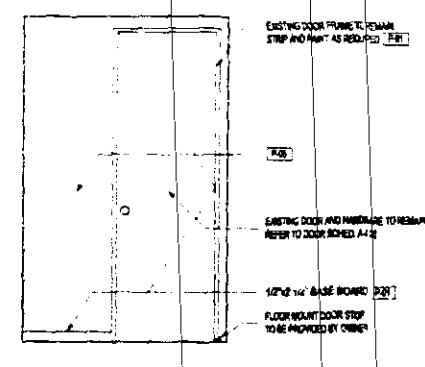
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 5. NO DEMO ON THIS PERMIT.



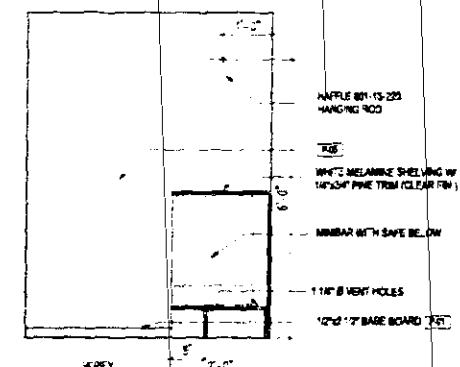
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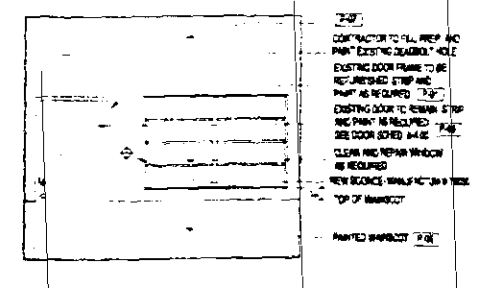
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SCALE: 1/2" = 1'-0"



11 CLOSET
SCALE: 1/2" = 1'-0"



12 CLOSET
SCALE: 1/2" = 1'-0"



13 EXTERIOR ELEVATION
SCALE: 1/4" = 1'-0"

CITY OF MIAMI
APPROVED FOR THE FOLLOWING:

BUILDING:
ZONING:
DRB/HPR:
CONCURRENCE:
PLUMBING:
ELECTRICAL:
MECHANICAL:
FIRE PREVENTION:
ENGINEERING:
PUBLIC WORKS:
STRUCTURAL:
ACCESSIBILITY:
FIELD:

ALISON SPEAR, A.I.A.
180 NE 39th St, Suite 222, Miami, FL 33137
305-438-1200 fax 305-438-1221














PROJECT ARCHITECT
ALISON SPEAR, AIA
AIA 000680

PROJECT TITLE
LIDO SPA HOTEL
WEST WING - RENOVATION
40 ISLAND AVENUE, MIAMI BEACH, FL 33139

DRAWING TITLE
TYPICAL ROOM
TYPE "2"

DRAWN BY		B.F.L.
CHECKED BY		A.S.
ISSUES		
7/25/01	Revision	

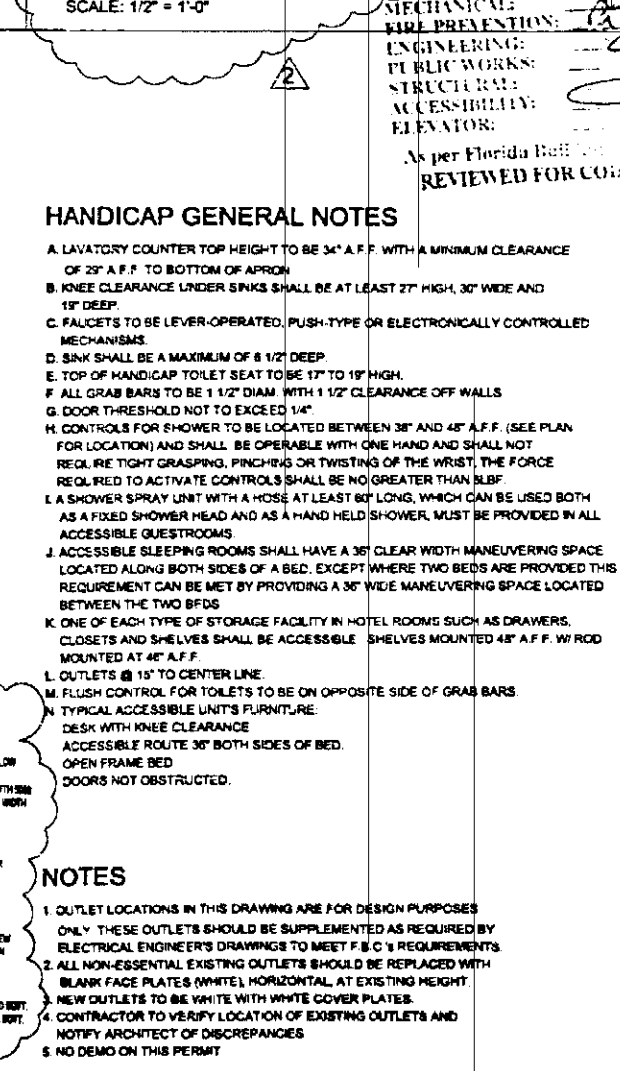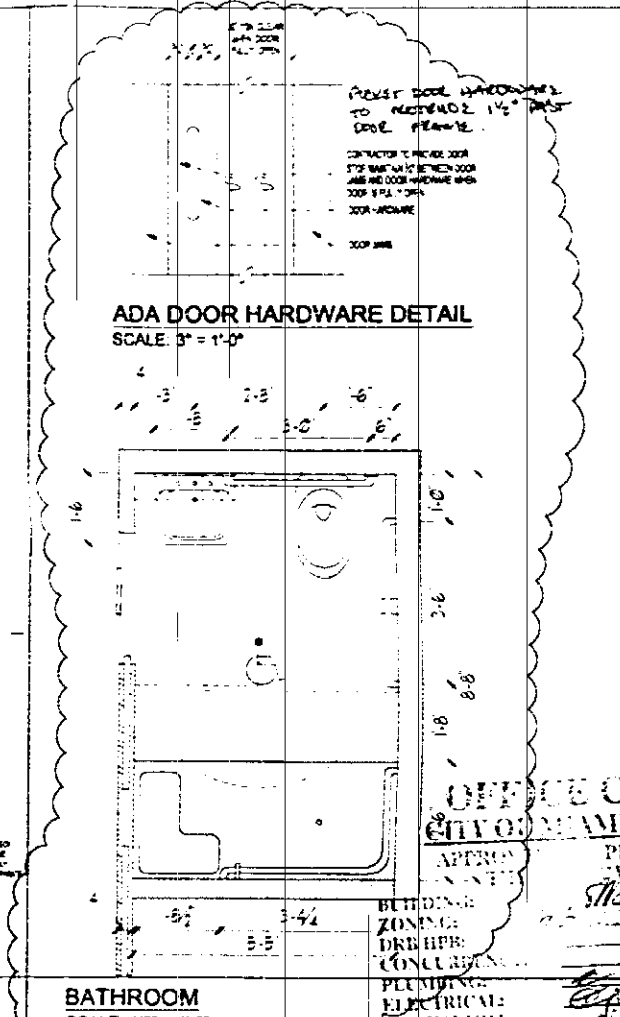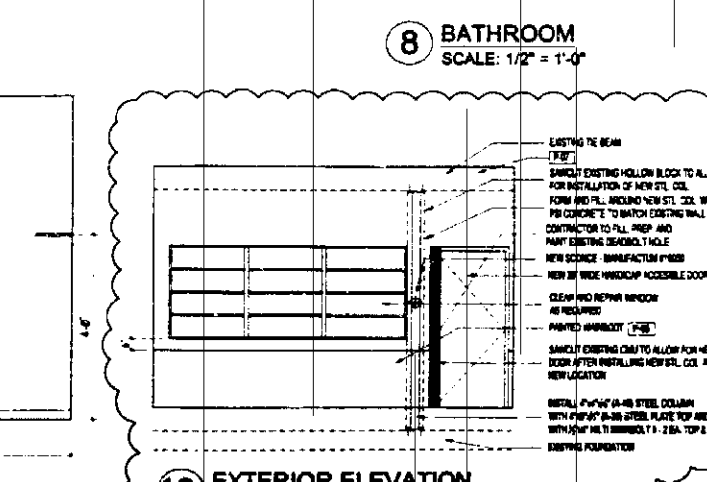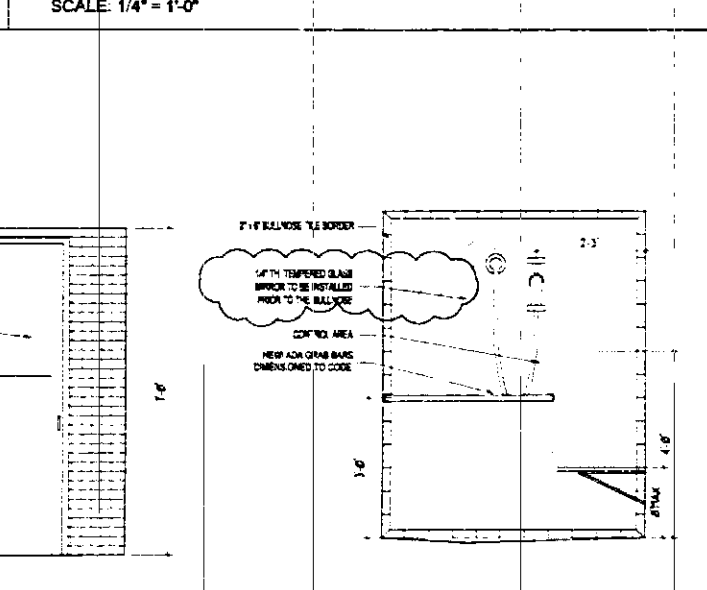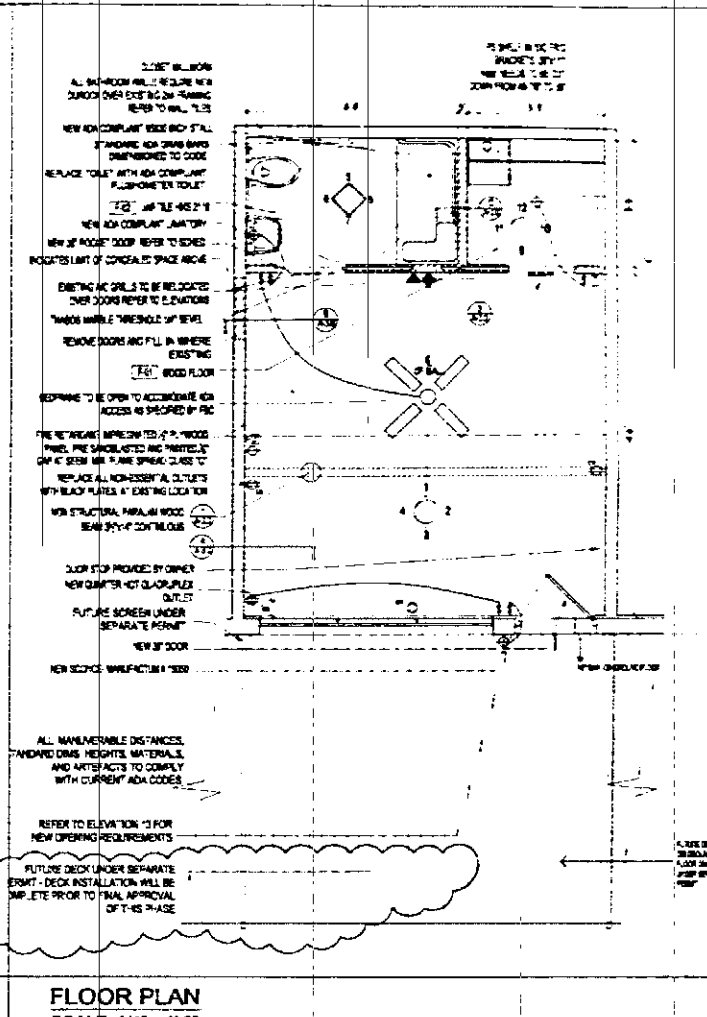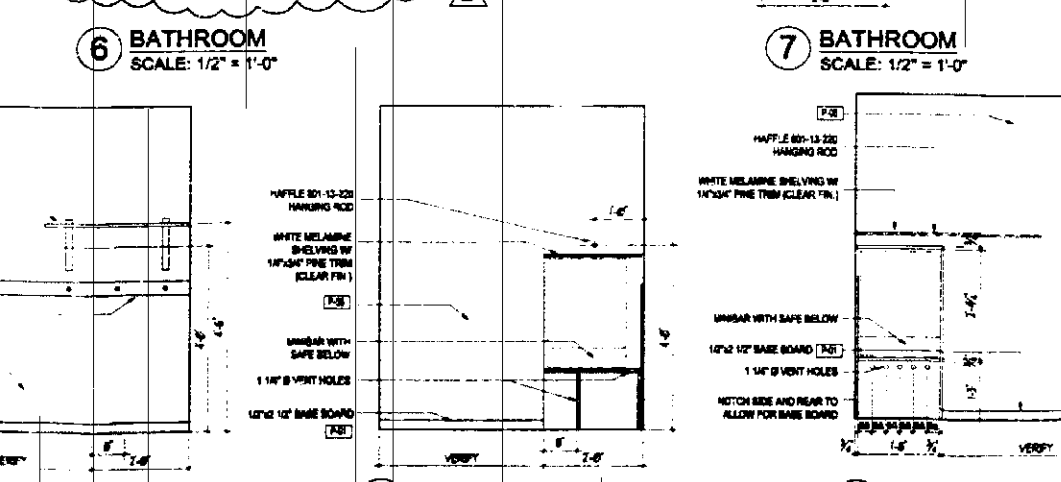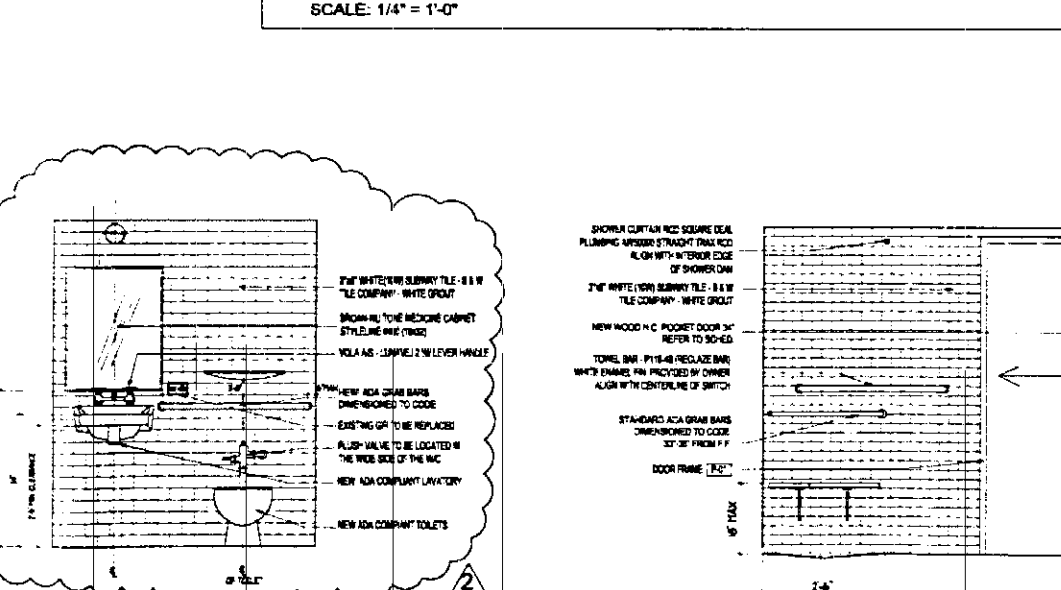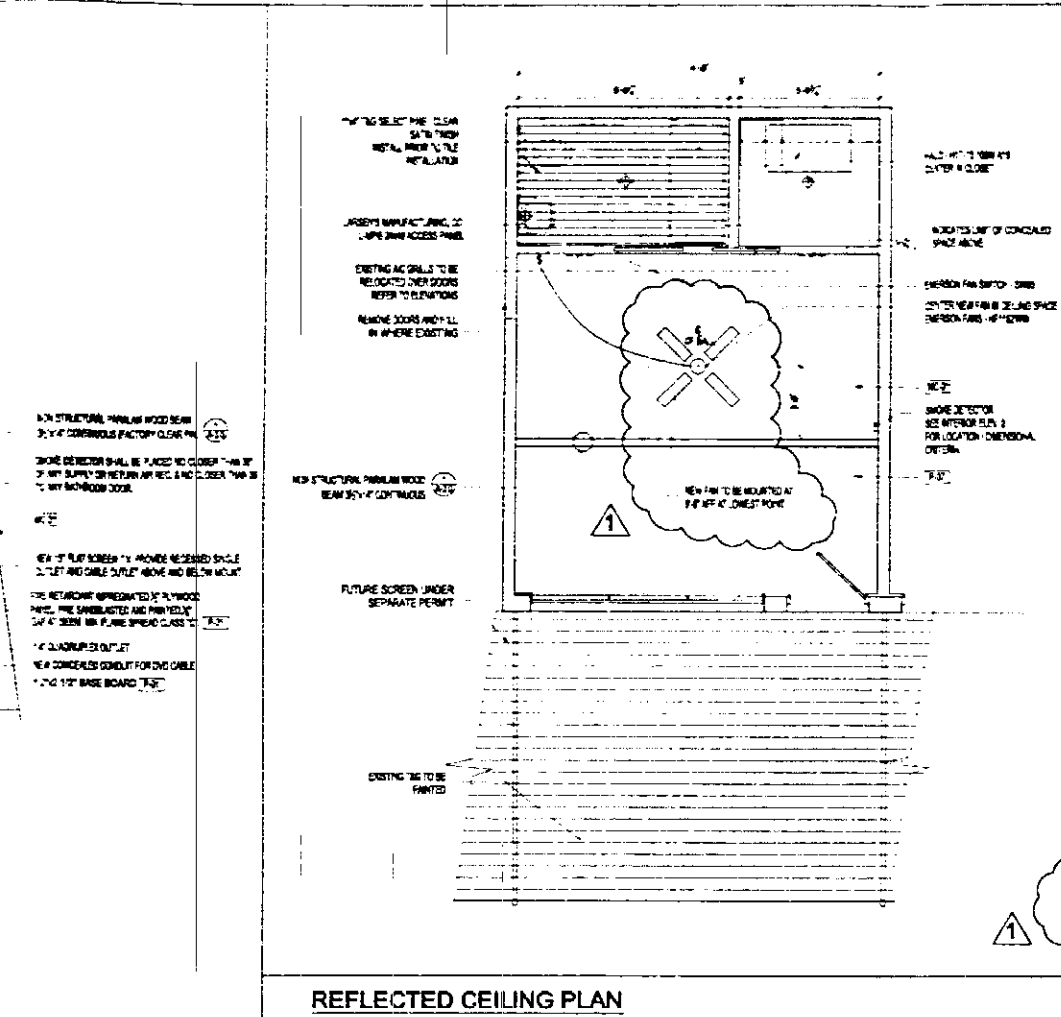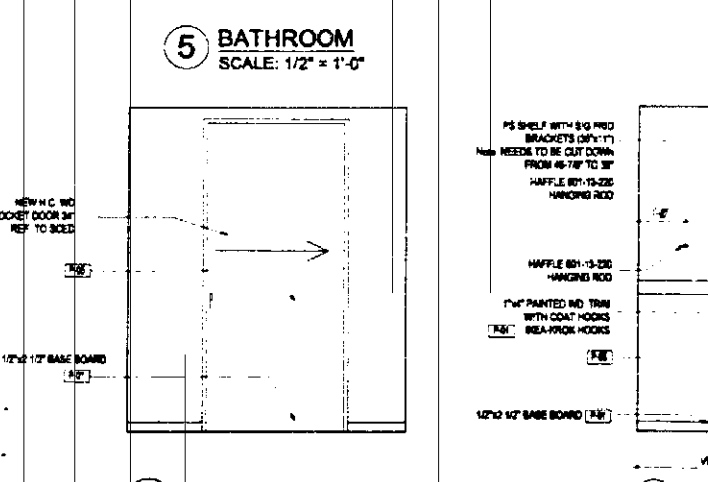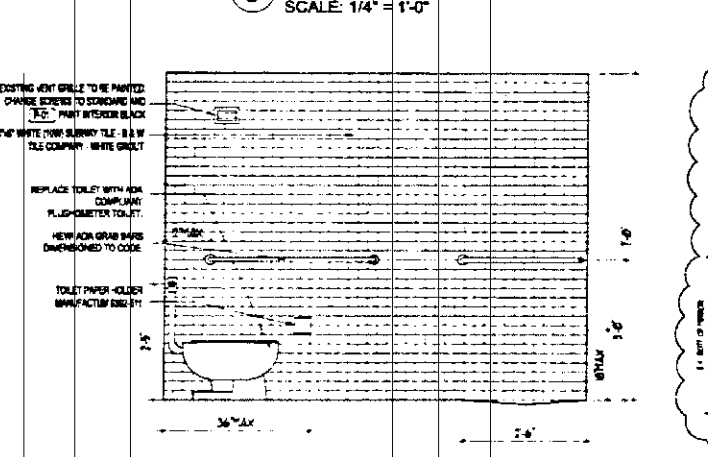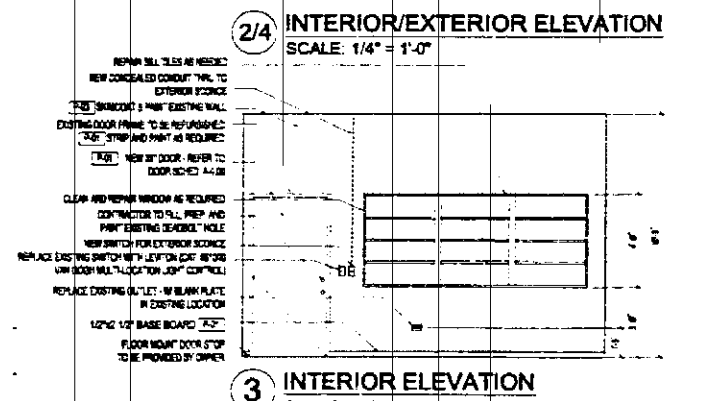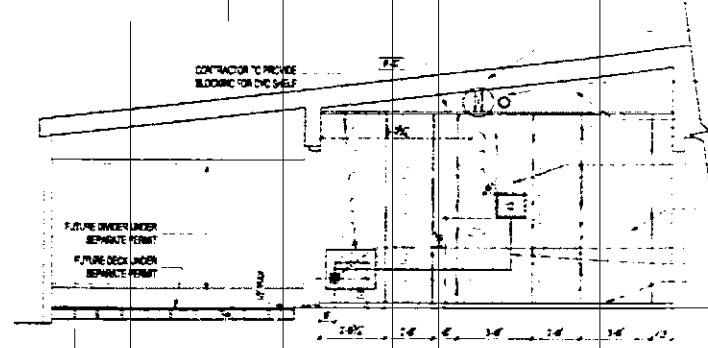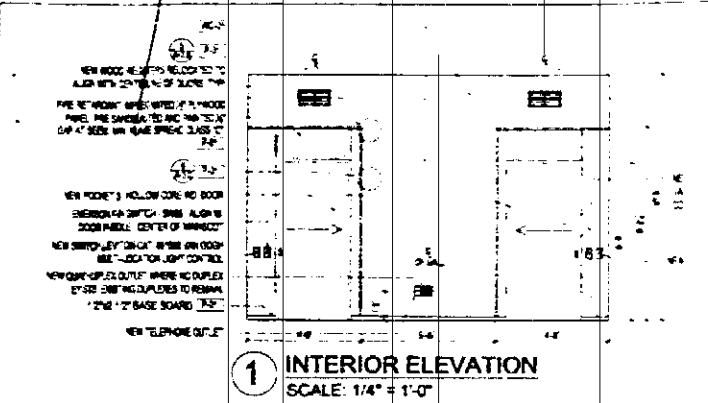SHEET NO.
A-2.01



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305-438-1200 fax 305-438-1221

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OWNER OF DOCUMENTS
LIDO SPA HOTEL
WEST WING - RENOVATION
40 ISLAND AVENUE, MIAMI BEACH, FL 33139

PERMIT BY
CITY OF MIAMI BEACH

DRAWN BY B.F.L.
CHECKED BY A.S.
ISSUES

REVISIONS

SHEET NO
A-2.03

HANDICAP GENERAL NOTES

- LAUNDRY COUNTER TOP HEIGHT TO BE 34" A.F.F. WITH A MINIMUM CLEARANCE OF 29" A.F.F. TO BOTTOM OF APRON.
- KNEE CLEARANCE UNDER SINKS SHALL BE AT LEAST 27" HIGH, 30" WIDE AND 19" DEEP.
- FAUCETS TO BE LEVER-OPERATED, PUSH-TYPE OR ELECTRONICALLY CONTROLLED.
- MECHANICALS SHALL BE A MAXIMUM OF 6 1/2" DEEP.
- TOP OF HANDICAP TOILET SEAT TO BE 17" TO 19" HIGH.
- ALL GRAB BARS TO BE 1 1/2" DIAM. WITH 1 1/2" CLEARANCE OFF WALLS.
- DOOR THRESHOLD NOT TO EXCEED 1/4".
- CONTROLS FOR SHOWER TO BE LOCATED BETWEEN 38" AND 48" A.F.F. (SEE PLAN FOR LOCATION) AND SHALL BE OPERABLE WITH ONE HAND AND SHALL NOT REQUIRE TIGHT GRASPING, PINCHING OR TWISTING OF THE WRIST. THE FORCE REQUIRED TO ACTIVATE CONTROLS SHALL BE NO GREATER THAN 15 LB.
- A SHOWER SPRAY UNIT WITH A HOSE AT LEAST 60" LONG, WHICH CAN BE USED BOTH AS A FIXED SHOWER HEAD AND AS A HAND HELD SHOWER, MUST BE PROVIDED IN ALL ACCESSIBLE BATHROOMS.
- ACCESSIBLE SLEEPING ROOMS SHALL HAVE A 36" CLEAR WIDTH MANEUVERING SPACE LOCATED ALONG BOTH SIDES OF A BED, EXCEPT WHERE TWO BEDS ARE PROVIDED THIS REQUIREMENT CAN BE MET BY PROVIDING A 36" WIDE MANEUVERING SPACE LOCATED BETWEEN THE TWO BEDS.
- ONE OF EACH TYPE OF STORAGE FACILITY IN HOTEL ROOMS SUCH AS DRAWERS, CLOSETS AND SHELVES SHALL BE ACCESSIBLE. SHELVES MOUNTED 48" A.F.F. W/ ROD MOUNTED AT 48" A.F.F.
- OUTLETS @ 15" TO CENTER LINE.
- FLUSH CONTROL FOR TOILETS TO BE ON OPPOSITE SIDE OF GRAB BARS.
- TYPICAL ACCESSIBLE UNITS FURNITURE.
- DESK WITH KNEE CLEARANCE.
- ACCESSIBLE ROUTE 36" BOTH SIDES OF BED.
- OPEN FRAME BED.
- DOORS NOT OBSTRUCTED.

NOTES

- OUTLET LOCATIONS IN THIS DRAWING ARE FOR DESIGN PURPOSES ONLY. THESE OUTLETS SHOULD BE SUPPLEMENTED AS REQUIRED BY ELECTRICAL ENGINEER'S DRAWINGS TO MEET F.B.C. REQUIREMENTS.
- ALL NON-ESSENTIAL EXISTING OUTLETS SHOULD BE REPLACED WITH BLANK FACE PLATES WHITE, HORIZONTAL, AT EXISTING HEIGHT.
- NEW OUTLETS TO BE WHITE WITH WHITE COVER PLATES.
- CONTRACTOR TO VERIFY LOCATION OF EXISTING OUTLETS AND NOTIFY ARCHITECT OF DISCREPANCIES.
- NO DEMO ON THIS PERMIT.

ALISON SPEAR, A.I.A.
180 NE 38th St, Suite 222, Miami, FL 33137
305-436-1200 fax 305-436-1221

PROJECT ARCHITECT
ALISON SPEAR, AIA
ARCH 001660

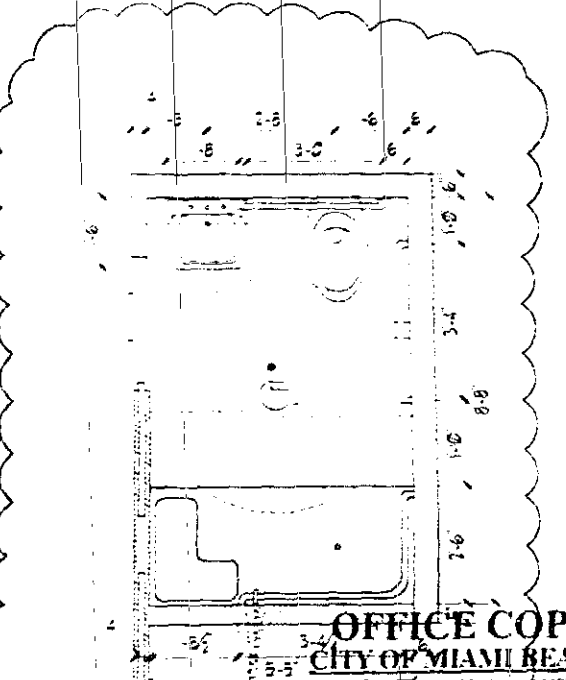
OWNER OF SOLARIS'S NOTICE
The undersigned, in consideration of the sum of \$10,000.00, the receipt of which is hereby acknowledged, do hereby certify that the undersigned is the owner of the property described in the foregoing and that the undersigned is the owner of the property described in the foregoing and that the undersigned is the owner of the property described in the foregoing.

PROJECT TITLE
LIDO SPA HOTEL
WEST WING - RENOVATION
40 ISLAND AVENUE, MIAMI BEACH, FL 33139

DRAWING TITLE
TYPICAL ROOM TYPE "A"

DRAWN BY
CHECKED BY
ISSUES

SHEET NO
A-2.03




BATHROOM
SCALE: 1/2" = 1'-0"


BUILDING:
ZONING:
DRYTYPE:
CONCURRENCE:
PLUMBING:
ELECTRICAL:
MECHANICAL:
FIRE PREVENTION:
ENGINEERING:
PUBLIC WORKS:
STRUCTURAL:
ACCESSIBILITY:
ELEVATOR:

HANDICAP GENERAL NOTES
As per Florida Building Code Section 10-1.3
A. LAVATORY COUNTER TOP HEIGHT TO BE 34" A.F.F. WITH A MINIMUM CLEARANCE OF 28" A.F.F. TO BOTTOM OF APRON.
B. KNEE CLEARANCE UNDER SINKS SHALL BE AT LEAST 27" HIGH, 30" WIDE AND 18" DEEP.
C. FAUCETS TO BE LEVER-OPERATED, PUSH-TYPE OR ELECTRONICALLY CONTROLLED MECHANISMS.
D. SINK SHALL BE A MAXIMUM OF 6 1/2" DEEP.
E. TOP OF HANDICAP TOILET SEAT TO BE 17" TO 18" HIGH.
F. ALL GRAB BARS TO BE 1 1/2" DIAM WITH 1 1/2" CLEARANCE OFF WALLS.
G. DOOR THRESHOLD NOT TO EXCEED 1/4".
H. CONTROLS FOR SHOWER TO BE LOCATED BETWEEN 38" AND 48" A.F.F. (SEE PLAN FOR LOCATION) AND SHALL BE OPERABLE WITH ONE HAND AND SHALL NOT REQUIRE TIGHT GRASPING, PINCHING OR TWISTING OF THE WRIST, THE FORCE REQUIRED TO ACTIVATE CONTROLS SHALL BE NO GREATER THAN 5 LB.F.
I. A SHOWER SPRAY UNIT WITH A HOSE AT LEAST 60" LONG, WHICH CAN BE USED BOTH AS A FIXED SHOWER HEAD AND AS A HAND HELD SHOWER, MUST BE PROVIDED IN ALL ACCESSIBLE GUESTROOMS.
J. ACCESSIBLE SLEEPING ROOMS SHALL HAVE A 36" CLEAR WIDTH MANEUVERING SPACE LOCATED ALONG BOTH SIDES OF A BED, EXCEPT WHERE TWO BEDS ARE PROVIDED THIS REQUIREMENT CAN BE MET BY PROVIDING A 36" WIDE MANEUVERING SPACE LOCATED BETWEEN THE TWO BEDS.
K. ONE OF EACH TYPE OF STORAGE FACILITY IN HOTEL ROOMS SUCH AS DRAWERS, CLOSETS AND SHELVES SHALL BE ACCESSIBLE. SHELVES MOUNTED 48" A.F.F. 16" ROD MOUNTED AT 48" A.F.F.
L. OUTLETS 3' 1/2" TO CENTER LINE.
M. FLUSH CONTROL FOR TOILETS TO BE ON OPPOSITE SIDE OF GRAB BARS.
N. TYPICAL ACCESSIBLE UNITS FURNITURE.
O. DESK WITH KNEE CLEARANCE.
P. ACCESSIBLE ROUTE 36" BOTH SIDES OF BED.
Q. OPEN FRAME BED.
R. DOORS NOT OBSTRUCTED.

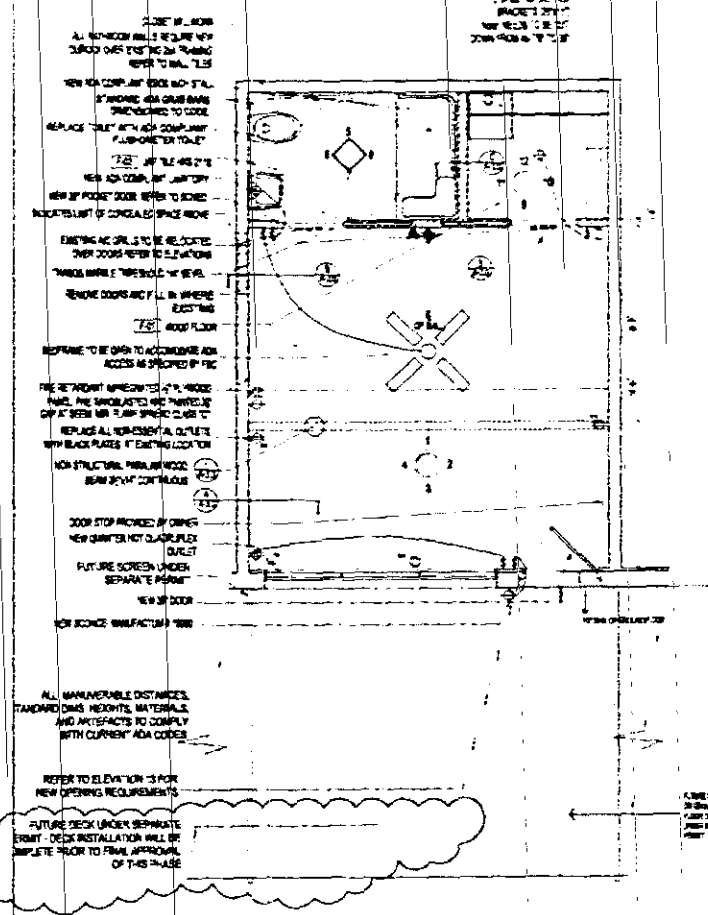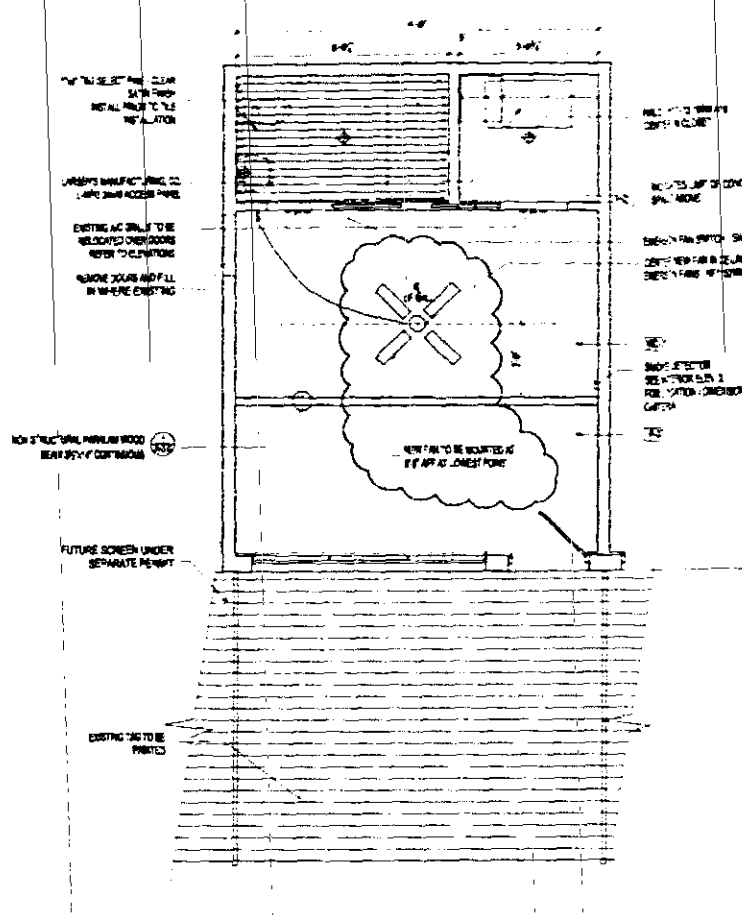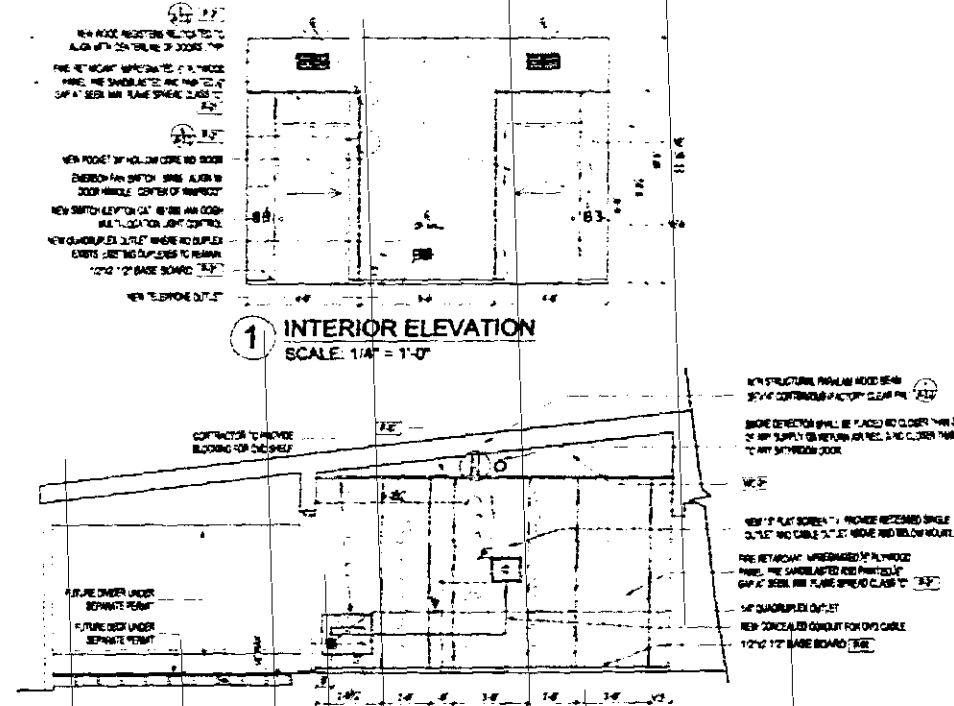
NOTES
1. OUTLET LOCATIONS IN THIS DRAWING ARE FOR DESIGN PURPOSES ONLY. THESE OUTLETS SHOULD BE SUPPLEMENTED AS REQUIRED BY ELECTRICAL ENGINEER'S DRAWINGS TO MEET F.B.C. REQUIREMENTS.
2. ALL NON-ESSENTIAL EXISTING OUTLETS SHOULD BE REPLACED WITH BLANK FACE PLATES (WHITE), HORIZONTAL, AT EXISTING HEIGHT.
3. NEW OUTLETS TO BE WHITE WITH WHITE COVER PLATES.
4. CONTRACTOR TO VERIFY LOCATION OF EXISTING OUTLETS AND NOTIFY ARCHITECT OF DISCREPANCIES.
5. NO DEMO ON THIS PERMIT.



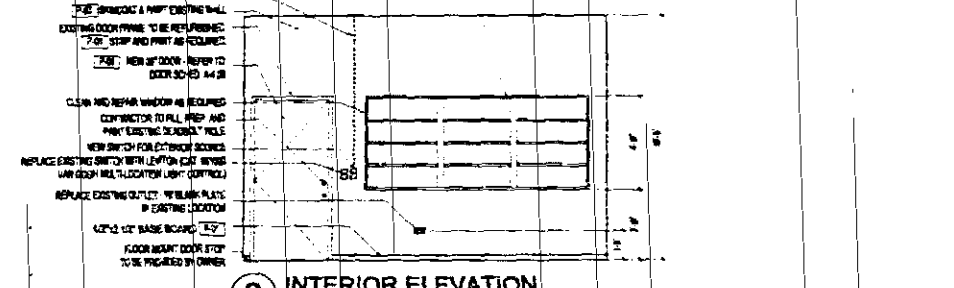
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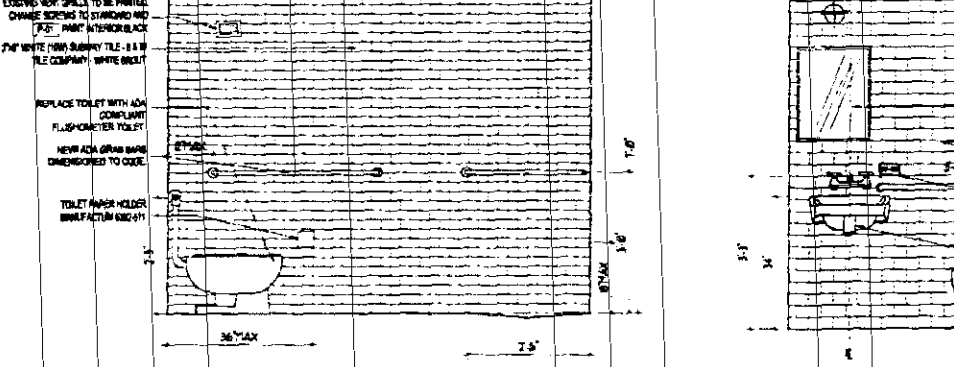
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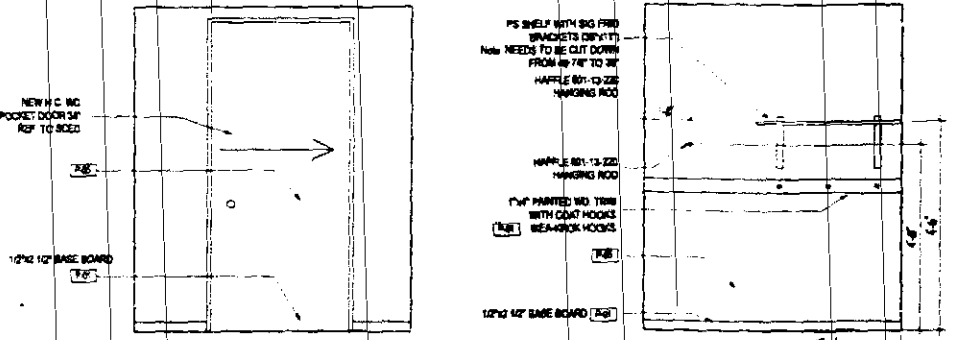
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SCALE: 1/4" = 1'-0"




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SCALE: 1/4" = 1'-0"



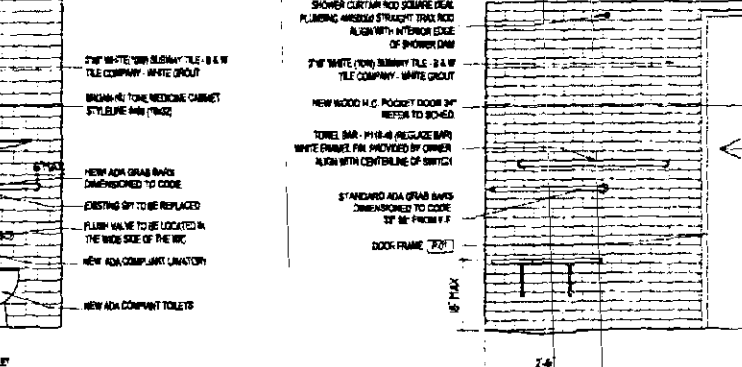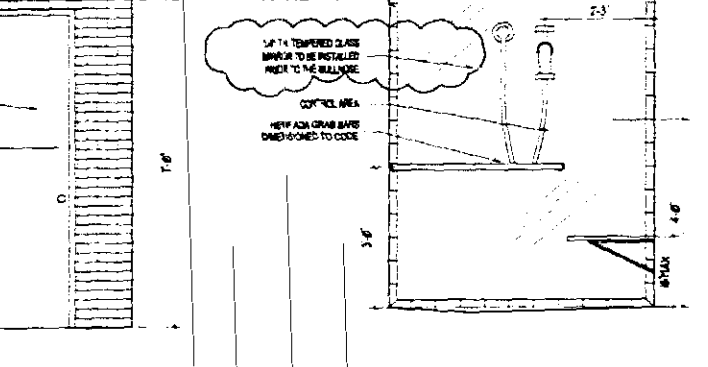
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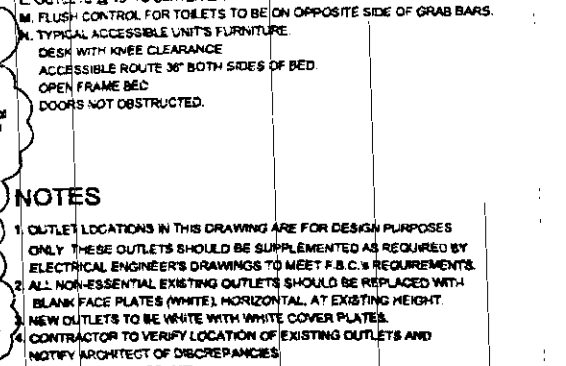
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SCALE: 1/2" = 1'-0"



6 BATHROOM
SCALE: 1/2" = 1'-0"



7 BATHROOM
SCALE: 1/2" = 1'-0"



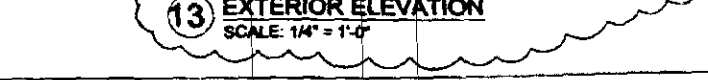
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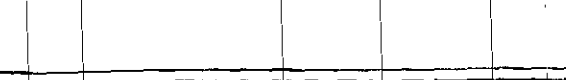
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SCALE: 1/2" = 1'-0"



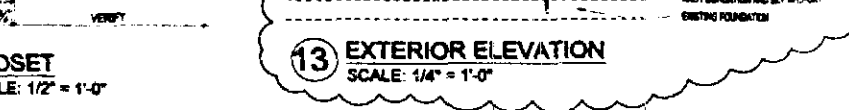
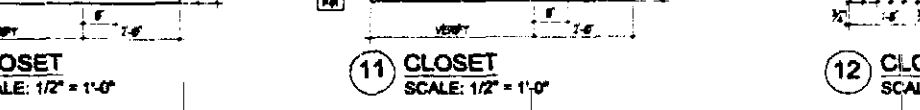
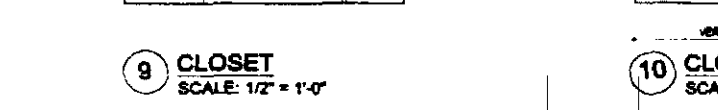
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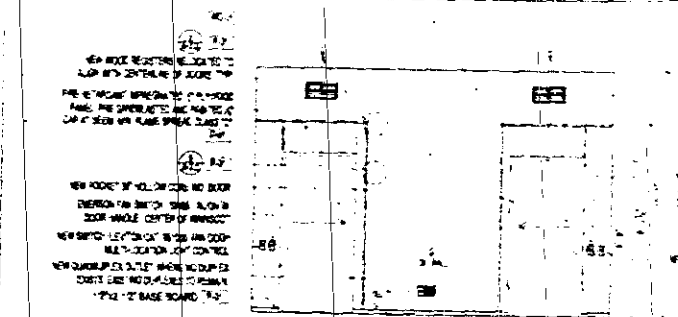
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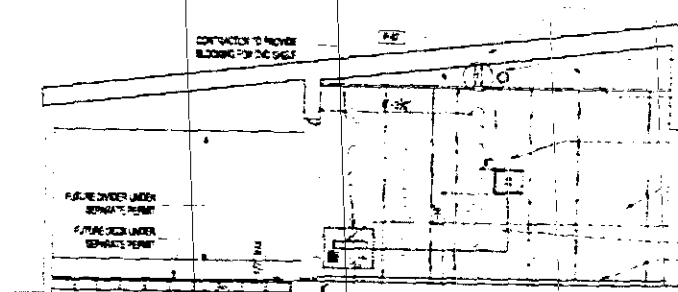
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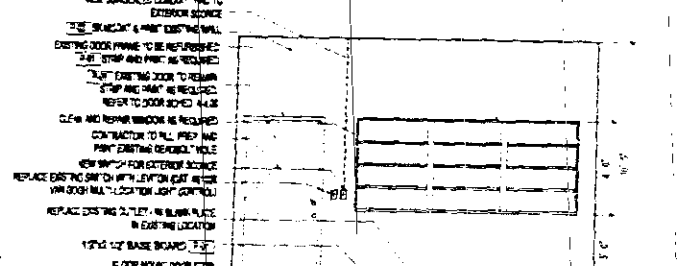
A-2.03



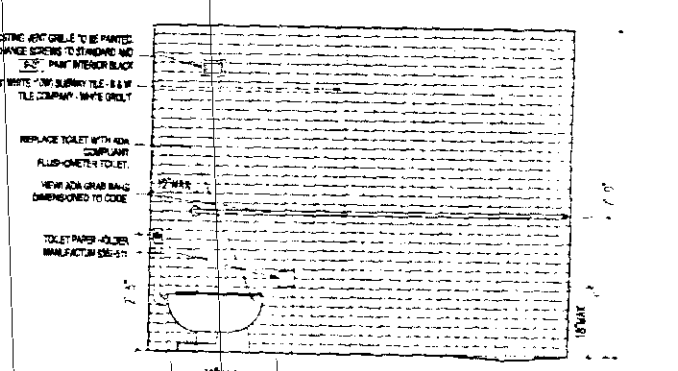
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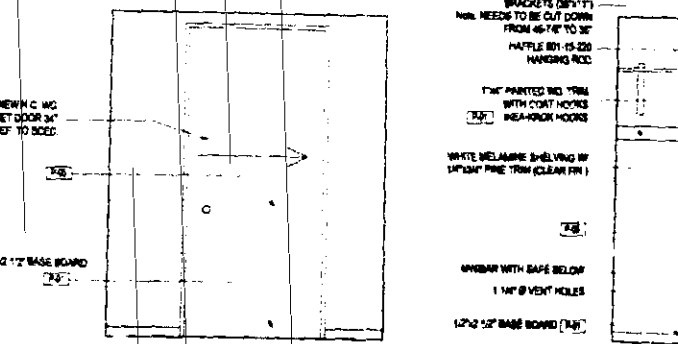
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SCALE: 1/4" = 1'-0"



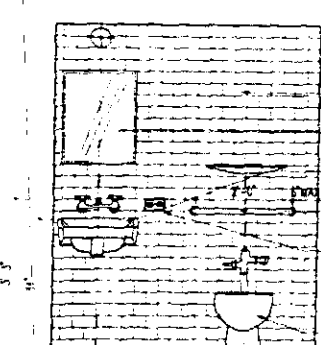
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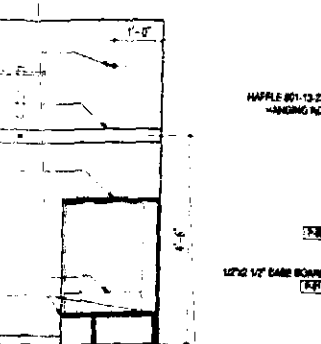
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SCALE: 1/2" = 1'-0"




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SCALE: 1/2" = 1'-0"




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SCALE: 1/2" = 1'-0"




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SCALE: 1/2" = 1'-0"

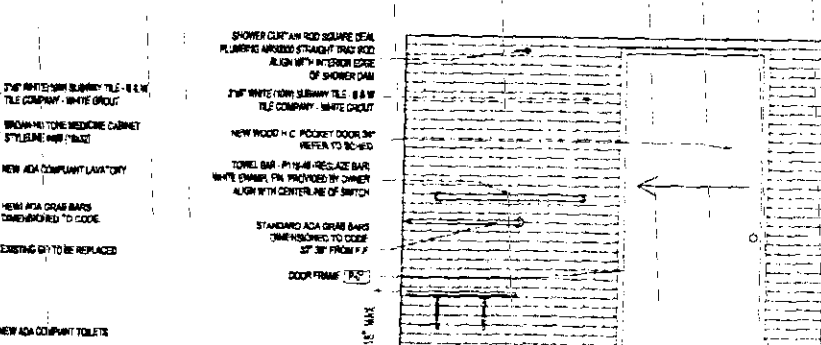


7 BATHROOM
SCALE: 1/2" = 1'-0"

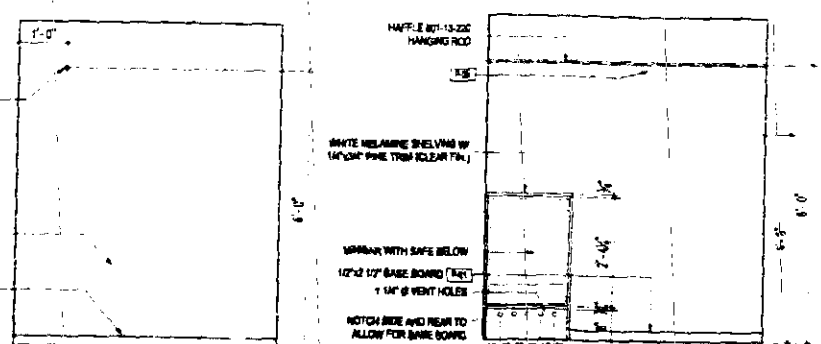

11 CLOSET
SCALE: 1/2" = 1'-0"

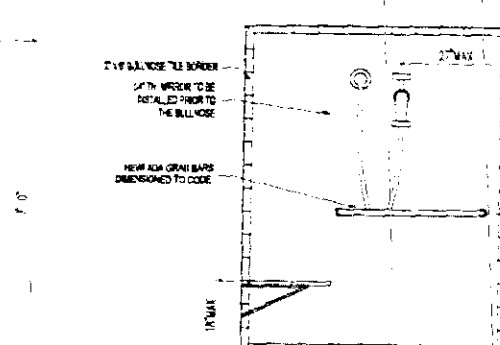

8 BATHROOM
SCALE: 1/2" = 1'-0"

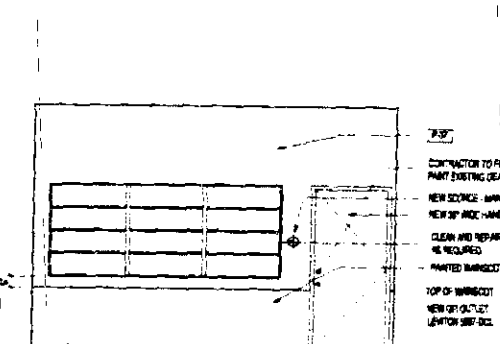

13 EXTERIOR ELEVATION
SCALE: 1/4" = 1'-0"

REFLECTED CEILING PLAN
SCALE: 1/4" = 1'-0"

FLOOR PLAN
SCALE: 1/4" = 1'-0"

HANDICAP GENERAL NOTES

- LAVATORY COUNTER TOP HEIGHT TO BE 34" A.F.F. WITH A MINIMUM CLEARANCE OF 29" A.F.F. TO BOTTOM OF APRON.
- KNEE CLEARANCE UNDER SINKS SHALL BE AT LEAST 27" HIGH, 30" WIDE AND 19" DEEP.
- FAUCETS TO BE LEVER-OPERATED, PUSH-TYPE OR ELECTRONICALLY CONTROLLED MECHANISMS.
- SINK SHALL BE A MAXIMUM OF 8 1/2" DEEP.
- TOP OF HANDICAP TOILET SEAT TO BE 17" TO 18" HIGH.
- IF ALL GRAB BARS TO BE 1 1/2" DIAM. WITH 1 1/2" CLEARANCE OFF WALLS.
- DOOR THRESHOLD NOT TO EXCEED 1/4".
- CONTROLS FOR SHOWER TO BE LOCATED BETWEEN 38" AND 48" A.F.F. (SEE PLAN FOR LOCATION) AND SHALL BE OPERABLE WITH ONE HAND AND SHALL NOT REQUIRE TIGHT GRASPING, PINCHING OR TWISTING OF THE WRIST. THE FORCE REQUIRED TO ACTIVATE CONTROLS SHALL BE NO GREATER THAN 5 LBS.
- A SHOWER SPRAY UNIT WITH A HOSE AT LEAST 60" LONG, WHICH CAN BE USED BOTH AS A FIXED SHOWER HEAD AND AS A HAND HELD SHOWER, MUST BE PROVIDED IN ALL ACCESSIBLE GUESTROOMS.
- ACCESSIBLE SLEEPING ROOMS SHALL HAVE A 36" CLEAR WIDTH MANEUVERING SPACE LOCATED ALONG BOTH SIDES OF A BED, EXCEPT WHERE TWO BEDS ARE PROVIDED THIS REQUIREMENT CAN BE MET BY PROVIDING A 36" WIDE MANEUVERING SPACE LOCATED BETWEEN THE TWO BEDS.
- ONE OF EACH TYPE OF STORAGE FACILITY IN HOTEL ROOMS SUCH AS DRAWERS, CLOSETS AND SHELVES SHALL BE ACCESSIBLE. SHELVES MOUNTED AT 48" A.F.F. MOUNTED AT 48" A.F.F.
- OUTLETS @ 15" TO CENTER LINE.
- FLUSH CONTROL FOR TOILETS TO BE ON OPPOSITE SIDE OF GRAB BARS.
- TYPICAL ACCESSIBLE UNITS FURNITURE:
- DESK WITH KNEE CLEARANCE
- ACCESSIBLE ROUTE 36" BOTH SIDES OF BED.
- OPEN FRAME BED
- DOORS NOT OBSTRUCTED.

NOTES

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- NEW OUTLETS TO BE WHITE WITH WHITE COVER PLATES.
- CONTRACTOR TO VERIFY LOCATION OF EXISTING OUTLETS AND NOTIFY ARCHITECT OF DISCREPANCIES.
- NO DEMO ON THIS PERMIT.

ALISON SPEAR, A.I.A.
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305-438-1200 Fax 305-438-1221

PROJECT ARCHITECT
Alison Spear
ALISON SPEAR, AIA
AIA 001860

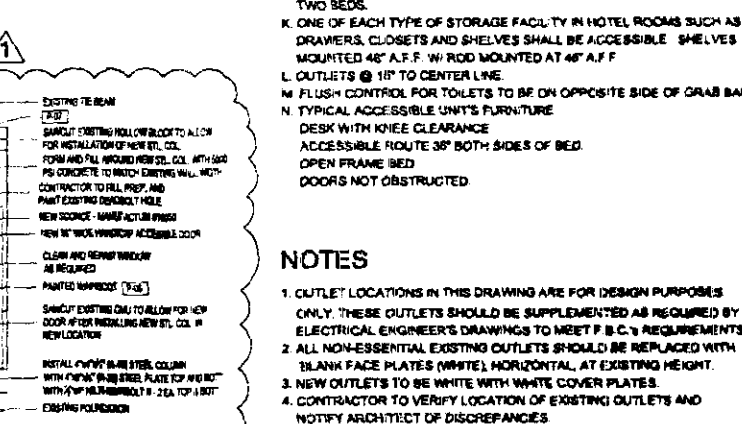
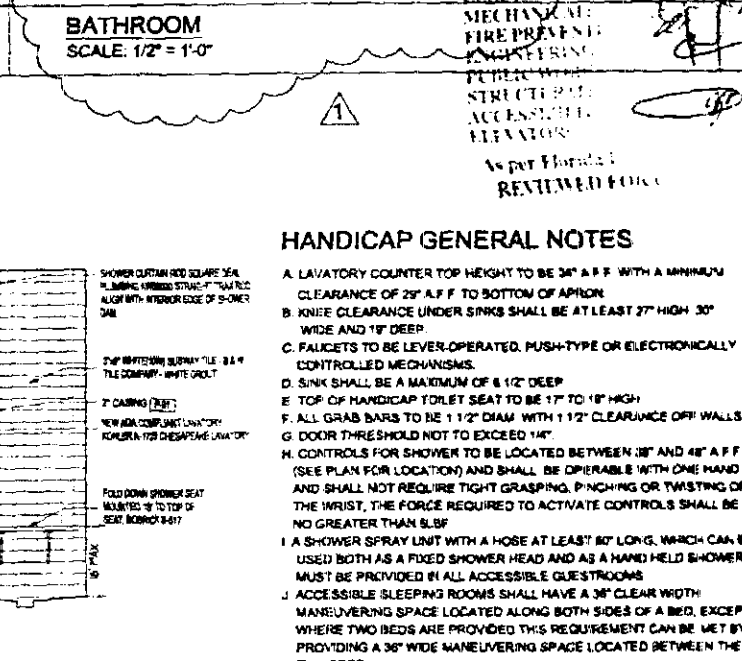
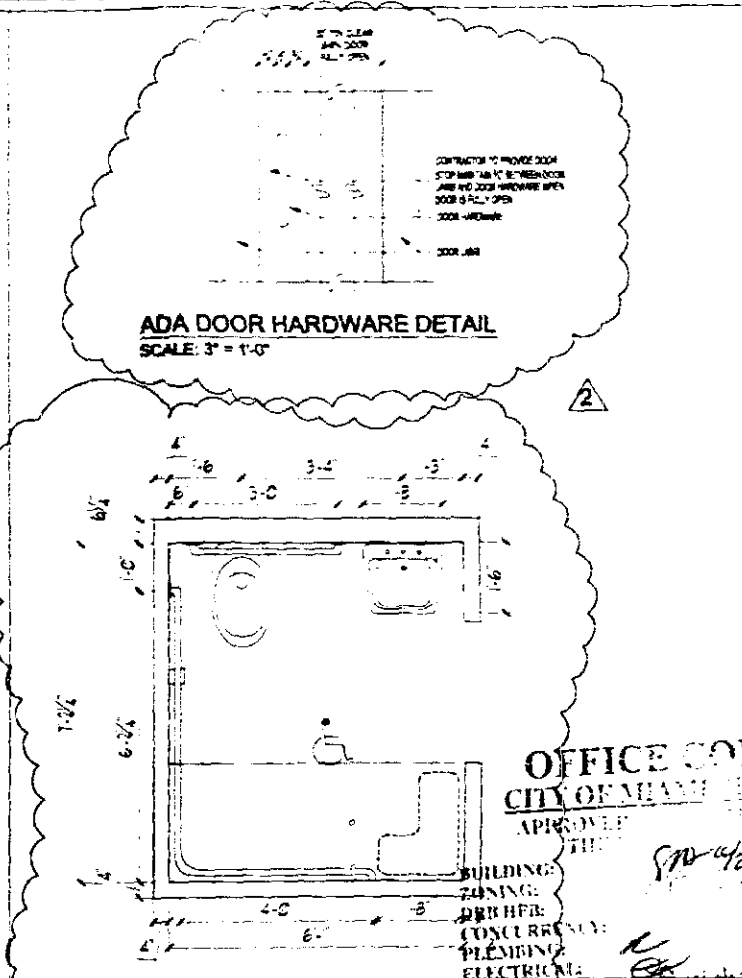
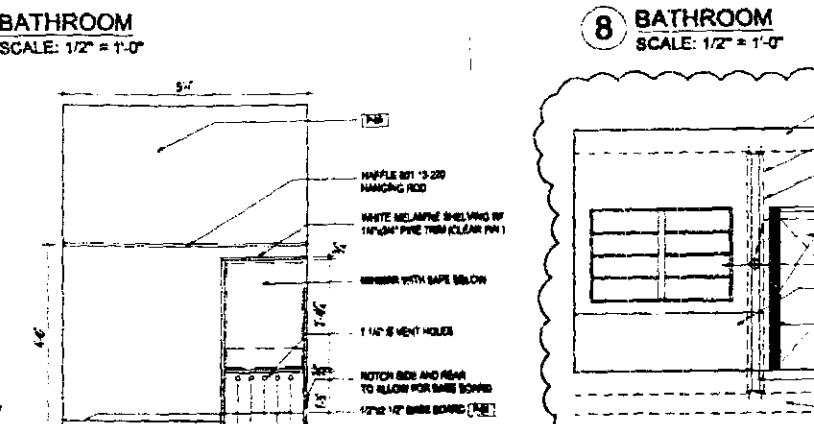
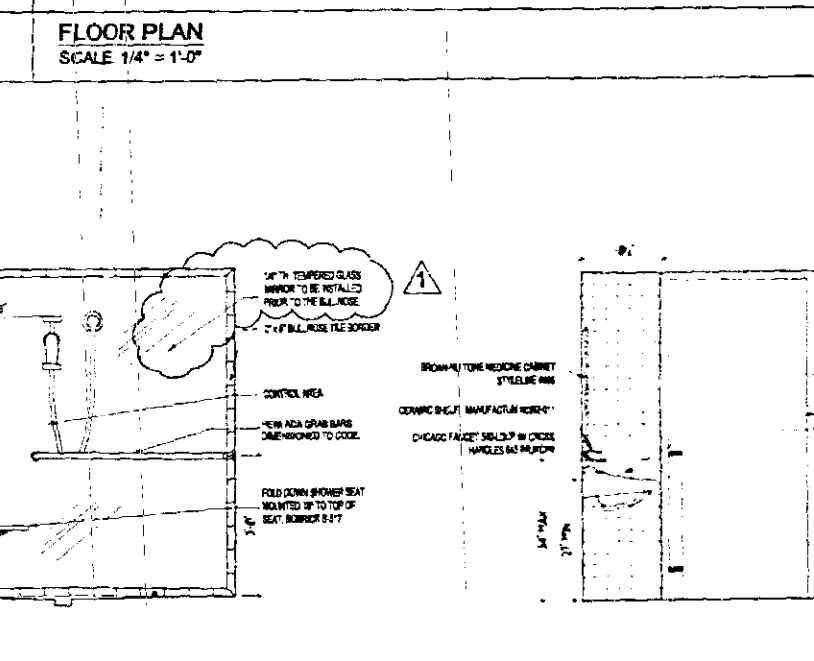
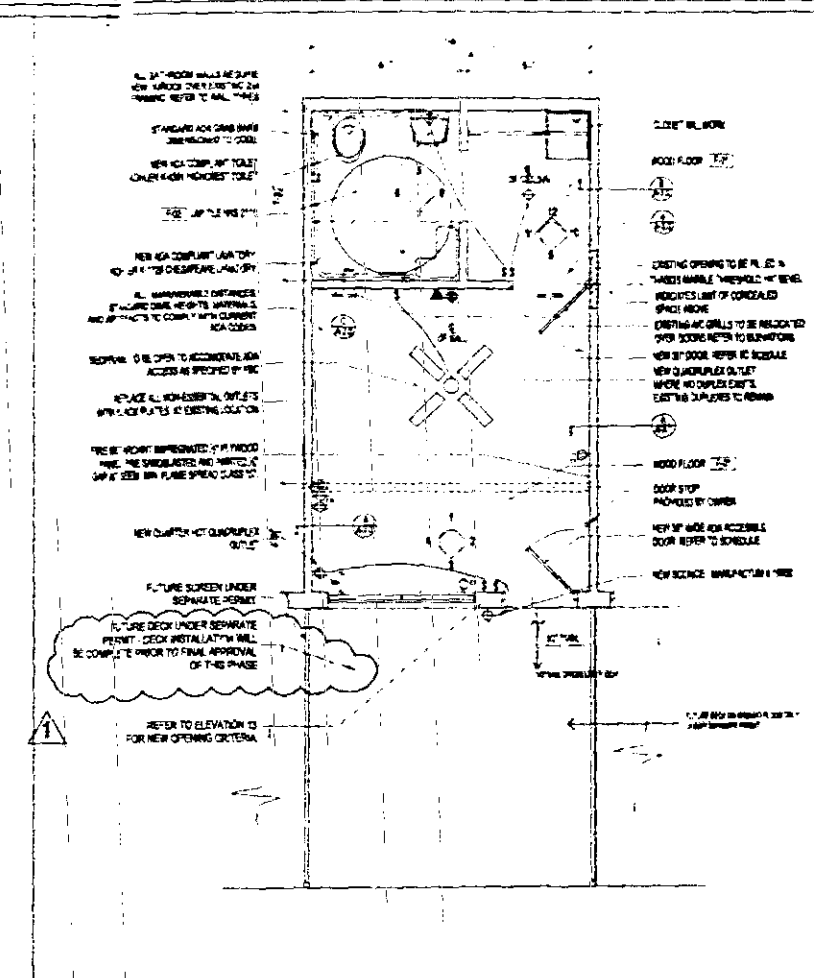
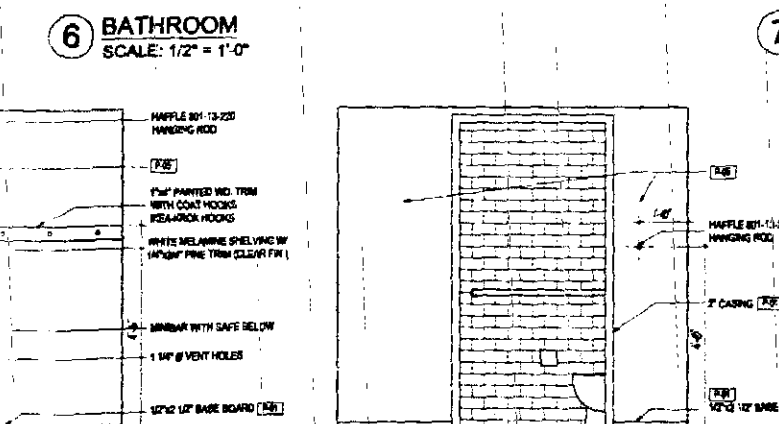
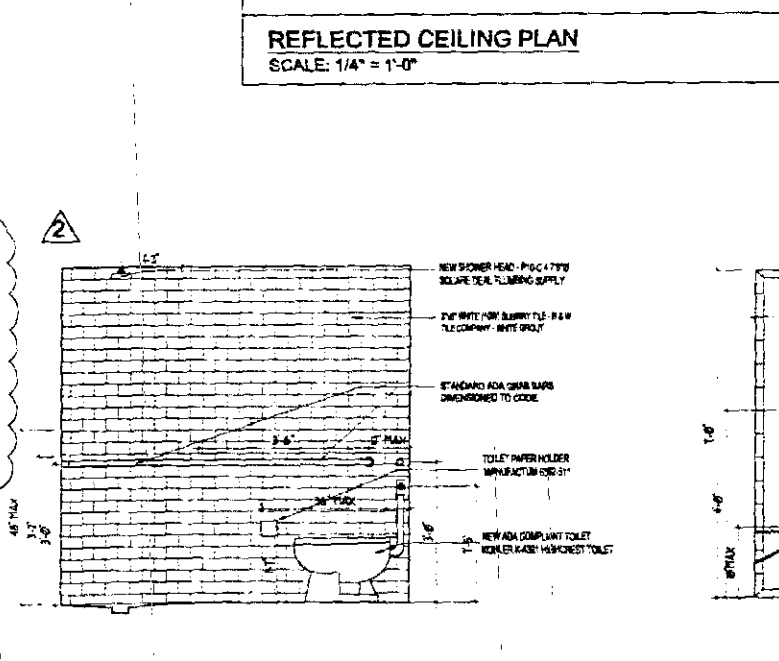
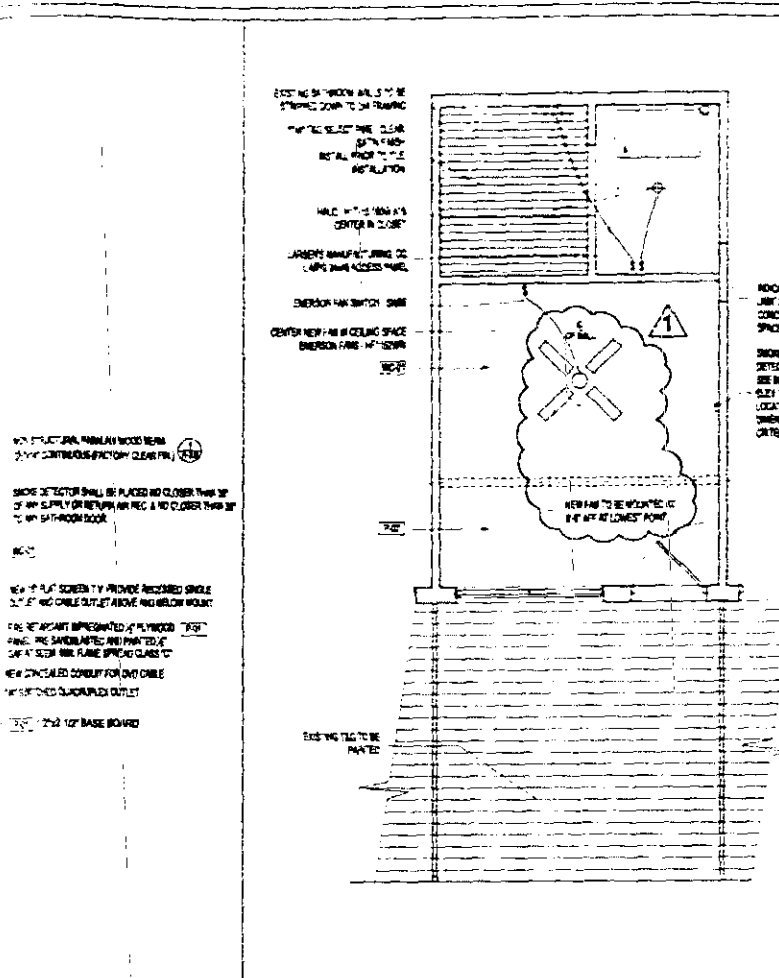
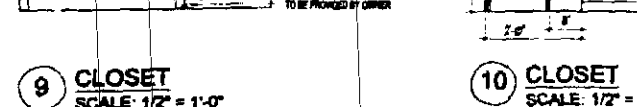
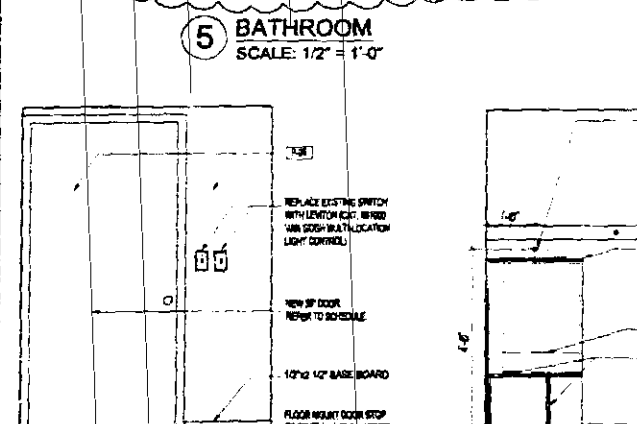
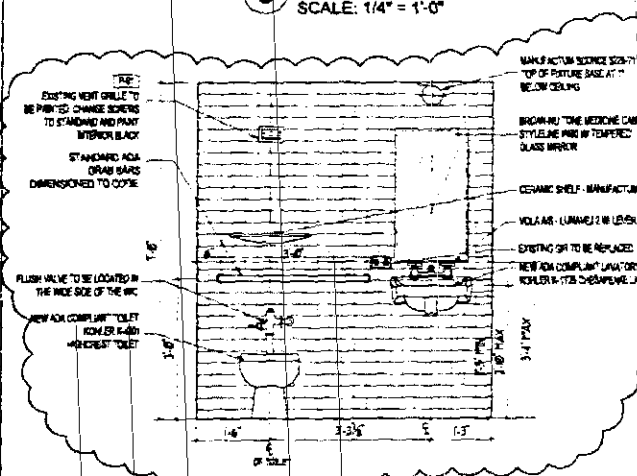
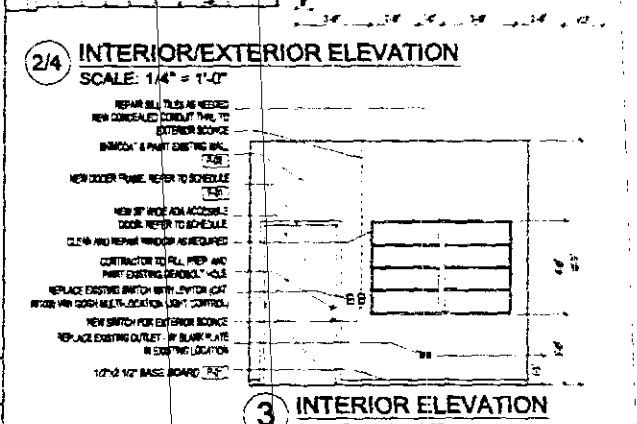
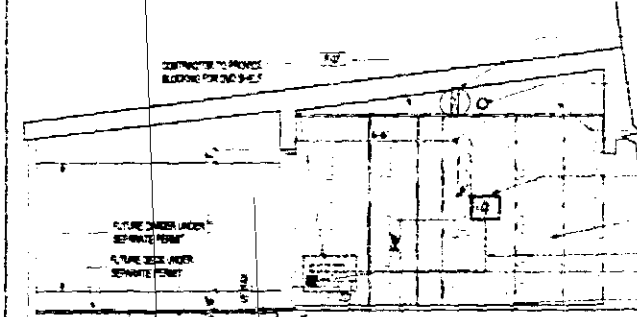
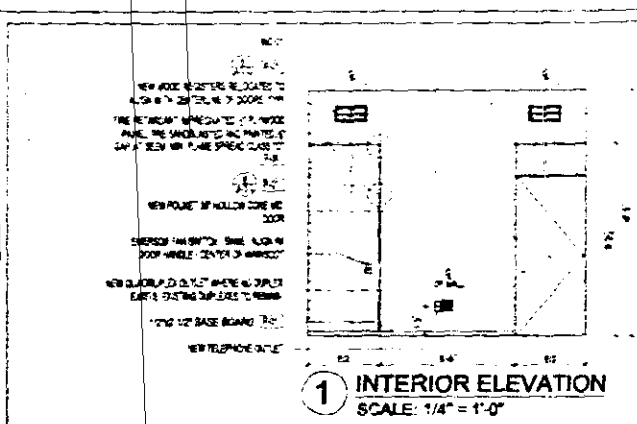
LIDO SPA HOTEL
WEST WING - RENOVATION
40 ISLAND AVENUE, MIAMI BEACH, FL 33139

TYPICAL ROOM
TYPE "A"

DRAWN BY B.F.L.
CHECKED BY A.S.
ISSUES

SHEET NO.

A-203



ADA DOOR HARDWARE DETAIL
SCALE: 3\"/>

BATHROOM
SCALE: 1/2\"/>

HANDICAP GENERAL NOTES

- LAVATORY COUNTER TOP HEIGHT TO BE 34\"/>

NOTES

1. OUTLET LOCATIONS IN THIS DRAWING ARE FOR DESIGN PURPOSES ONLY. THESE OUTLETS SHOULD BE SUPPLEMENTED AS REQUIRED BY ELECTRICAL ENGINEER'S DRAWINGS TO MEET F.B.C.'s REQUIREMENTS.
2. ALL NON-ESSENTIAL EXISTING OUTLETS SHOULD BE REPLACED WITH BLANK FACE PLATES (WHITE), HORIZONTAL, AT EXISTING HEIGHT.
3. NEW OUTLETS TO BE WHITE WITH WHITE COVER PLATES.
4. CONTRACTOR TO VERIFY LOCATION OF EXISTING OUTLETS AND NOTIFY ARCHITECT OF DISCREPANCIES.
5. NO DEMO ON THIS PERMIT.

ALISON SPEAR, A.I.A.
180 NE 38th St, Suite 222, Miami, FL 33137
305-436-1200 Fax 305-436-1221

PROJECT ARCHITECT
ALISON SPEAR, AIA
ASAP 10/18/00

OFFICE COPY
CITY OF MIAMI
APPROVED
DATE 10/18/00

BUILDING
ZONING
PLUMBING
ELECTRICAL
MECHANICAL
FIRE PREVENTION
PUBLISHED
STREET RULE
ACCESSIBILITY
ELEVATION
As per Florida
RETAINED FOR

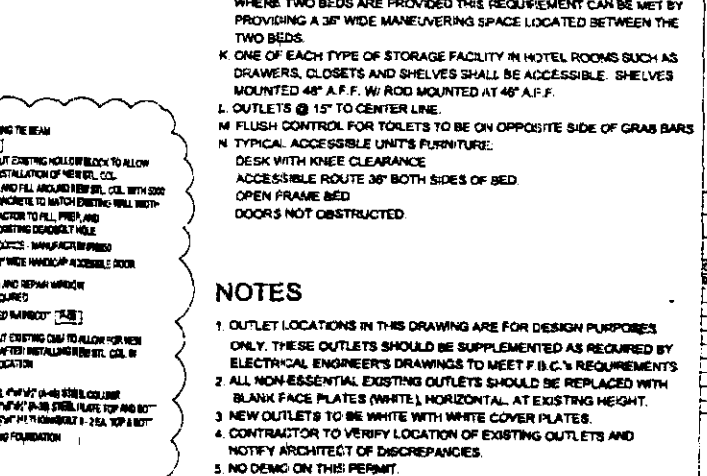
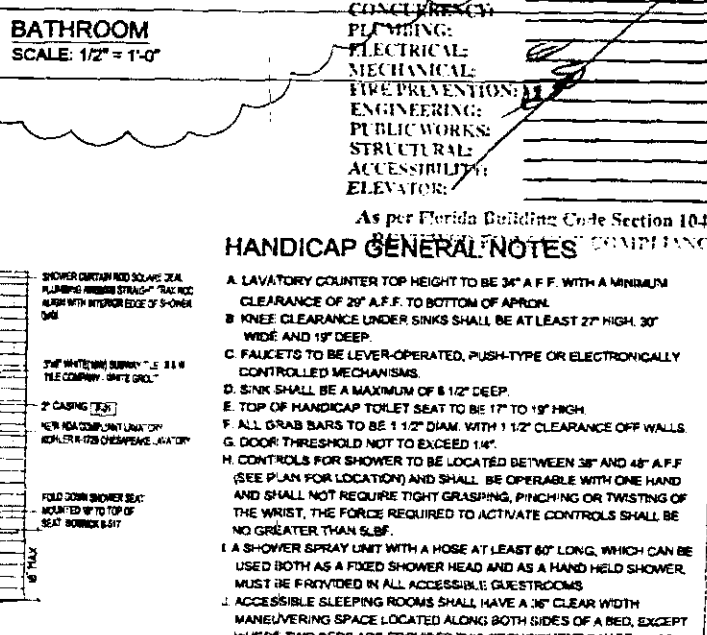
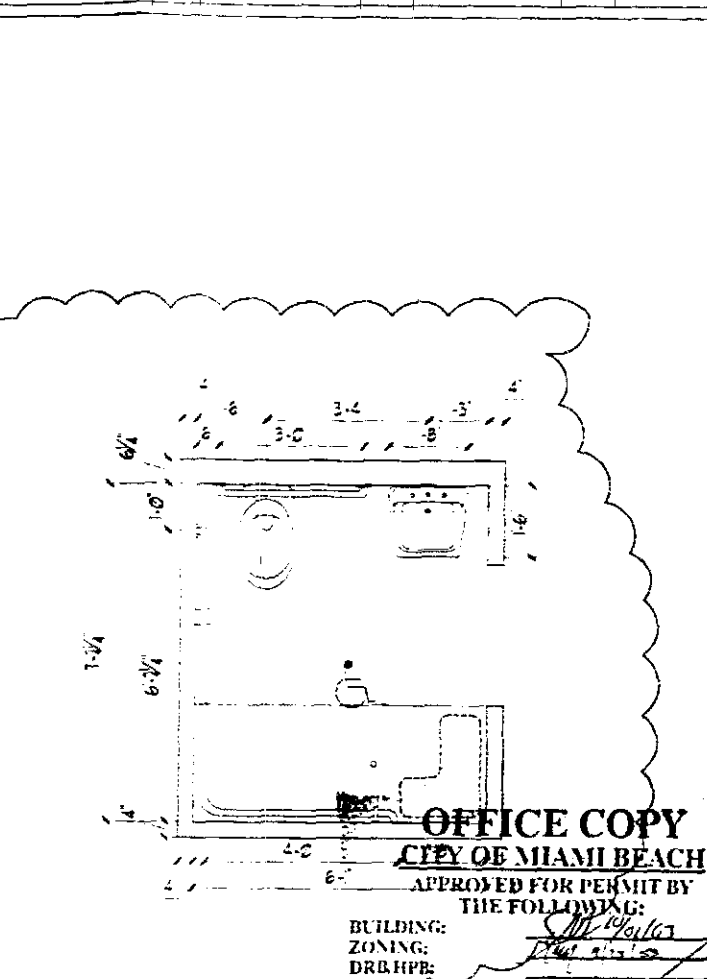
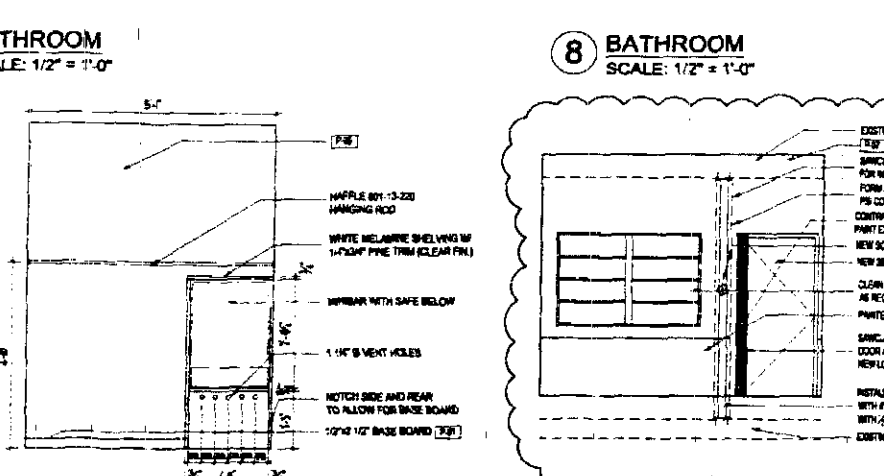
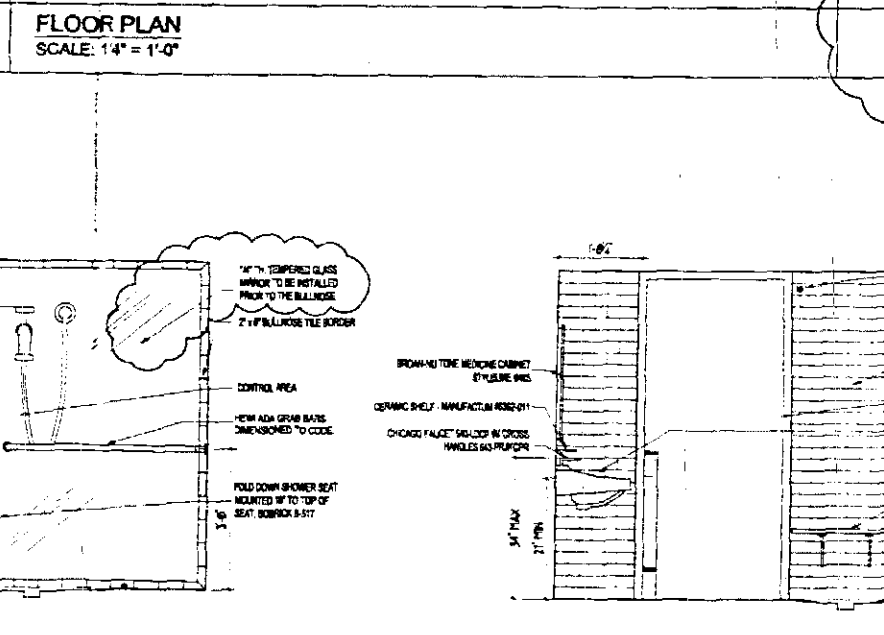
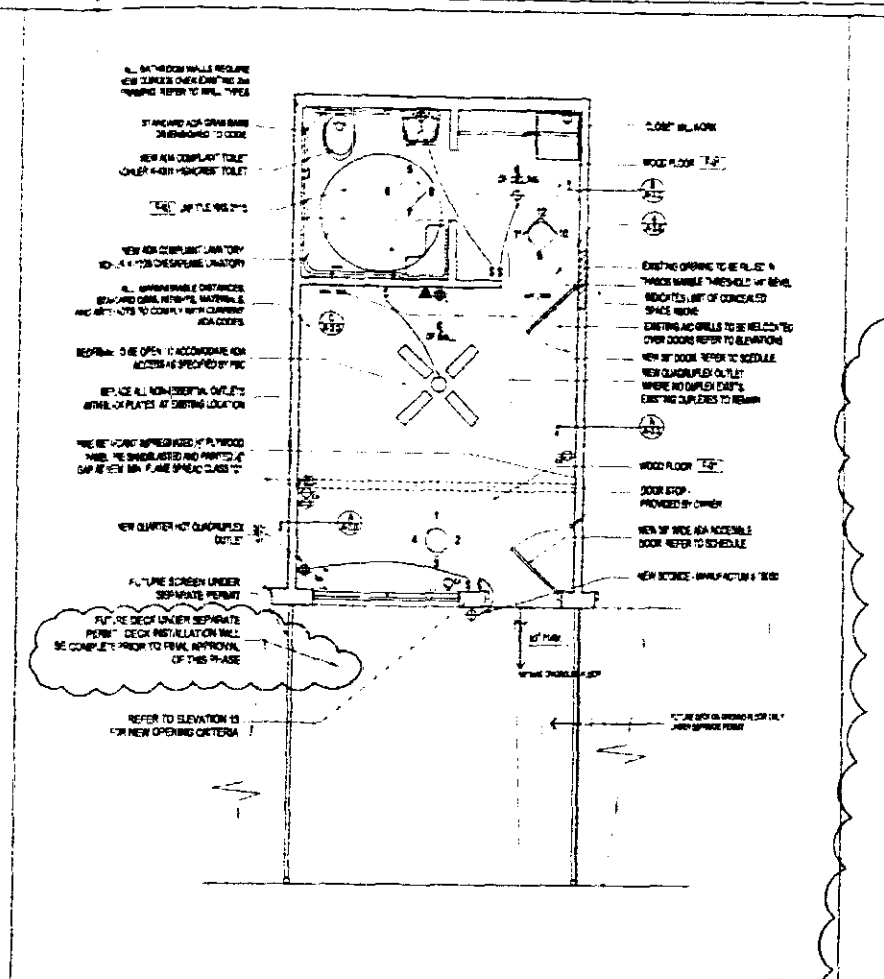
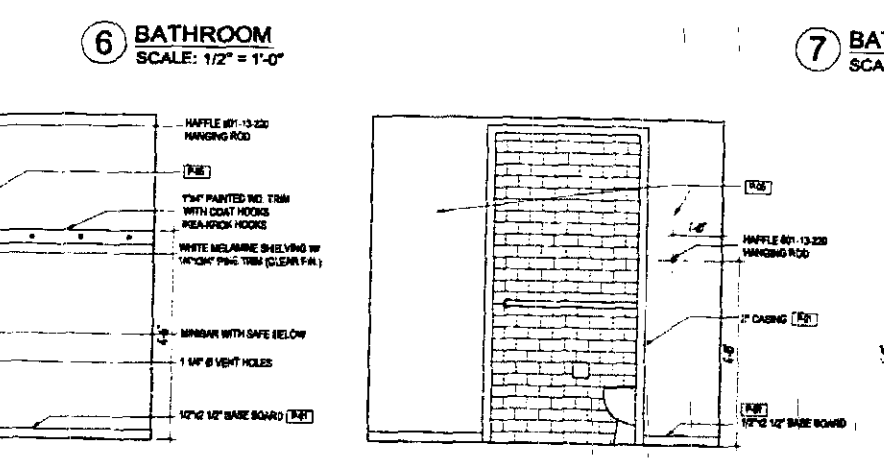
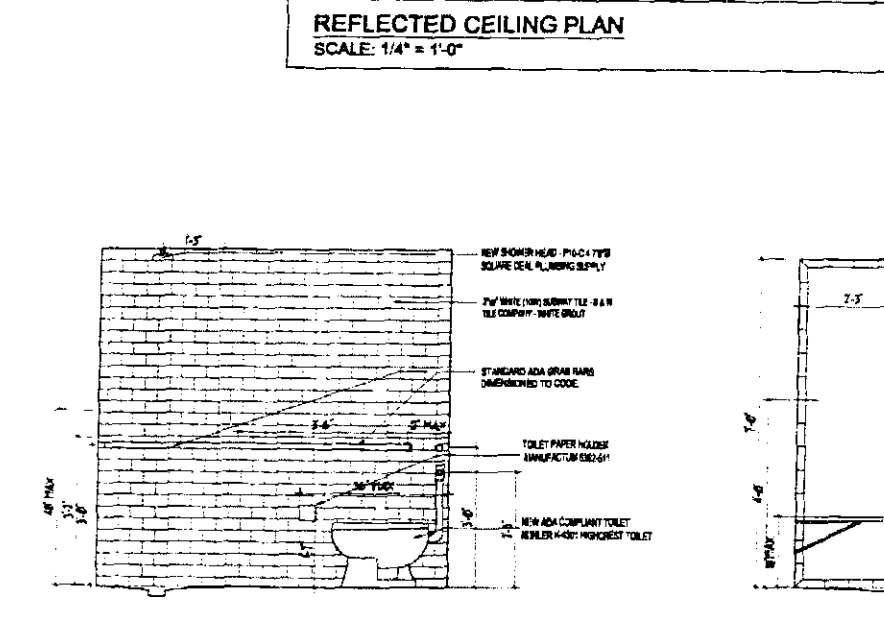
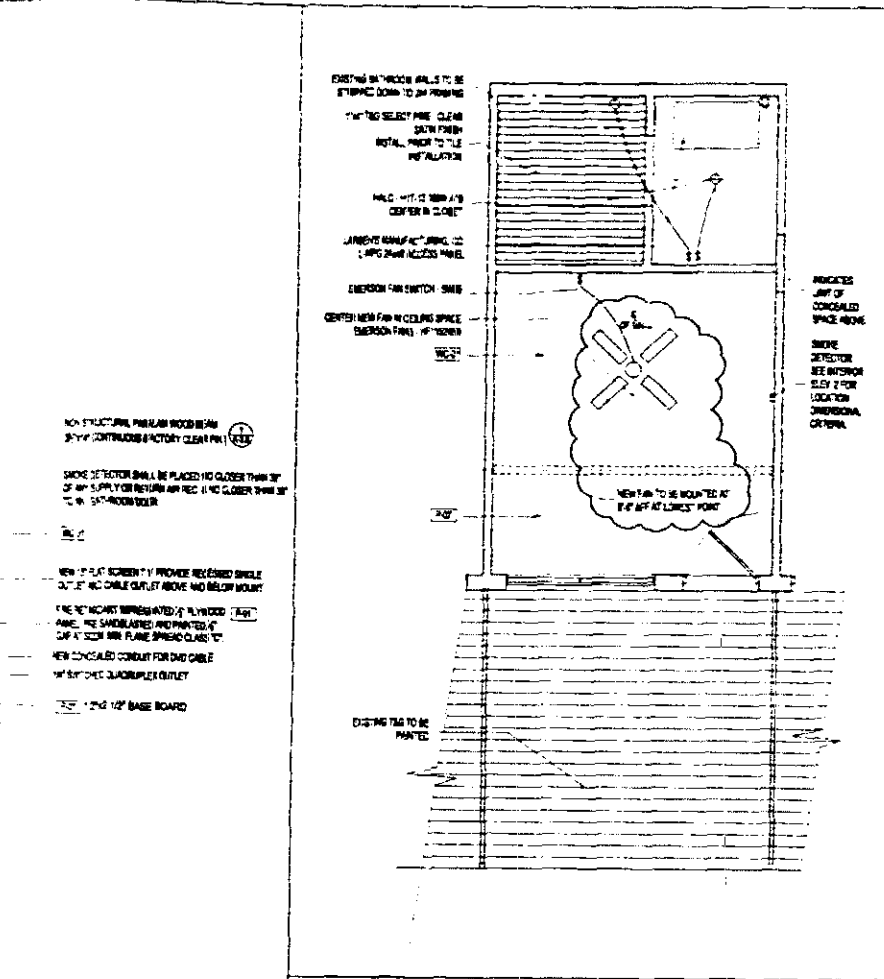
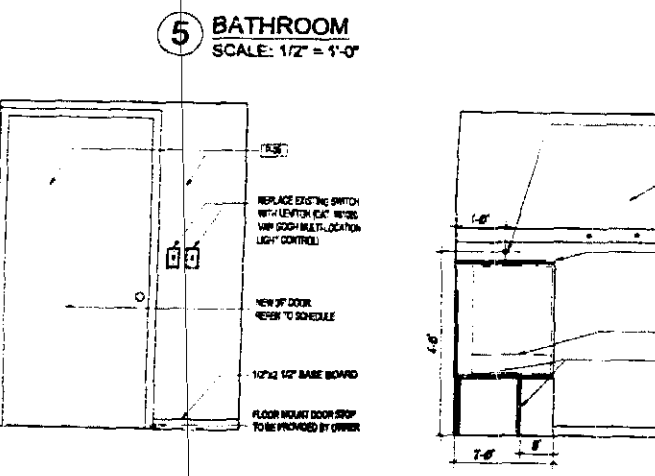
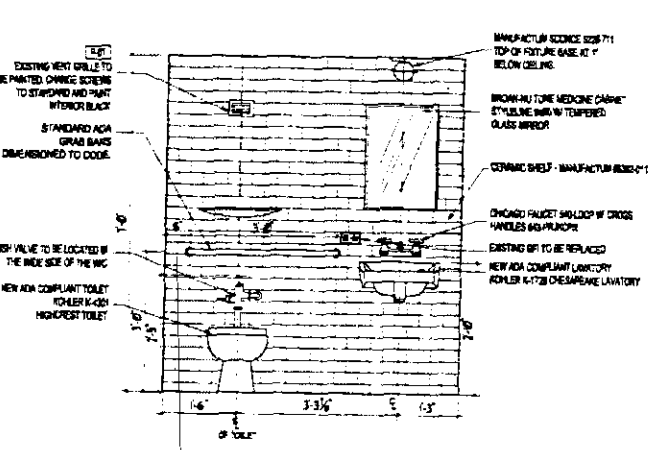
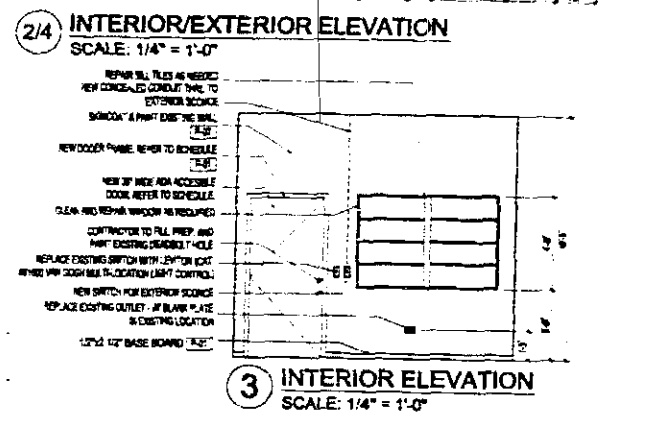
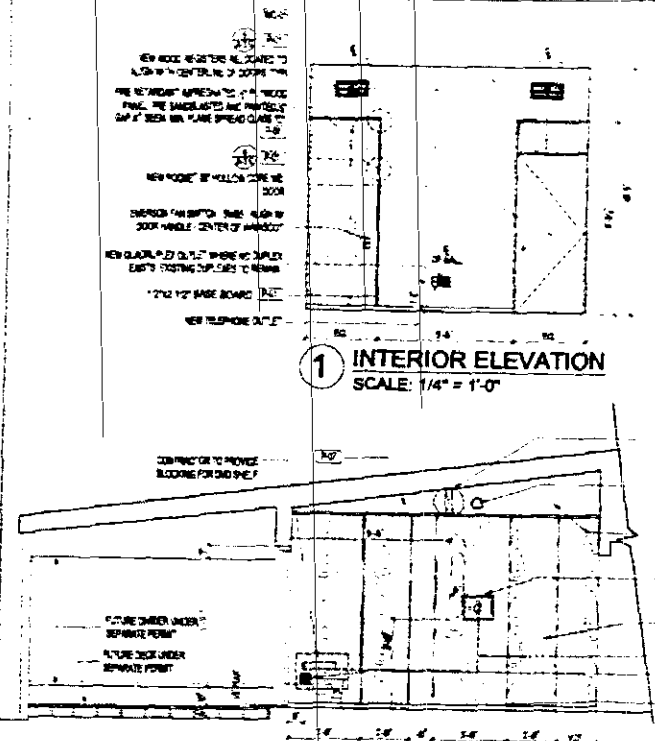
LIDO SPA HOTEL
WEST WING - RENOVATION
40 ISLAND AVENUE, MIAMI BEACH, FL 33139

PROJECT TITLE
TYPICAL ROOM
TYPE "5"

DRAWN BY B.F.L.
CHECKED BY A.S.

ISSUES
10/18/00 REVISION 1 BLDG DEPT. COMMENTS
10/18/00 REVISION 2 BLDG DEPT. COMMENTS

SHEET NO
A-2.04



HANDICAP GENERAL NOTES

- A. LAVATORY COUNTER TOP HEIGHT TO BE 34" A.F.F. WITH A MINIMUM CLEARANCE OF 27" A.F.F. TO BOTTOM OF APRON.
- B. KNEE CLEARANCE UNDER SINKS SHALL BE AT LEAST 27" HIGH, 30" WIDE AND 19" DEEP.
- C. FAUCETS TO BE LEVER-OPERATED, PUSH-TYPE OR ELECTRONICALLY CONTROLLED MECHANISMS.
- D. SINK SHALL BE A MAXIMUM OF 8 1/2" DEEP.
- E. TOP OF HANDICAP TOILET SEAT TO BE 17" TO 19" HIGH.
- F. ALL GRAB BARS TO BE 1 1/2" DIAM. WITH 1 1/2" CLEARANCE OFF WALLS.
- G. DOOR THRESHOLD NOT TO EXCEED 1/4".
- H. CONTROLS FOR SHOWER TO BE LOCATED BETWEEN 38" AND 48" A.F.F. (SEE PLAN FOR LOCATION) AND SHALL BE OPERABLE WITH ONE HAND AND SHALL NOT REQUIRE TIGHT GRASPING, PINCHING OR TWISTING OF THE WRIST. THE FORCE REQUIRED TO ACTIVATE CONTROLS SHALL BE NO GREATER THAN 5 LBS.
- I. A SHOWER SPRAY UNIT WITH A HOSE AT LEAST 60" LONG, WHICH CAN BE USED BOTH AS A FIXED SHOWER HEAD AND AS A HAND HELD SHOWER, MUST BE PROVIDED IN ALL ACCESSIBLE GUESTROOMS.
- J. ACCESSIBLE SLEEPING ROOMS SHALL HAVE A 36" CLEAR WITH MANEUVERING SPACE LOCATED ALONG BOTH SIDES OF A BED, EXCEPT WHERE TWO BEDS ARE PROVIDED THIS REQUIREMENT CAN BE MET BY PROVIDING A 36" WIDE MANEUVERING SPACE LOCATED BETWEEN THE TWO BEDS.
- K. ONE OF EACH TYPE OF STORAGE FACILITY IN HOTEL ROOMS SUCH AS DRAWERS, CLOSETS AND SHELVES SHALL BE ACCESSIBLE. SHELVES MOUNTED 48" A.F.F. W/ RAIL MOUNTED AT 48" A.F.F.
- L. OUTLETS @ 15" TO CENTER LINE.
- M. FLUSH CONTROL FOR TOILETS TO BE ON OPPOSITE SIDE OF GRAB BARS.
- N. TYPICAL ACCESSIBLE UNIT'S FURNITURE: DESK WITH KNEE CLEARANCE, ACCESSIBLE ROUTE 36" BOTH SIDES OF BED, OPEN FRAME BED, DOORS NOT OBSTRUCTED.

NOTES

1. OUTLET LOCATIONS IN THIS DRAWING ARE FOR DESIGN PURPOSES ONLY. THESE OUTLETS SHOULD BE SUPPLEMENTED AS REQUIRED BY ELECTRICAL ENGINEER'S DRAWINGS TO MEET F.B.C.'S REQUIREMENTS.
2. ALL NON-ESSENTIAL EXISTING OUTLETS SHOULD BE REPLACED WITH BLANK FACE PLATES (WHITE) HORIZONTAL, AT EXISTING HEIGHT.
3. NEW OUTLETS TO BE WHITE WITH WHITE COVER PLATES.
4. CONTRACTOR TO VERIFY LOCATION OF EXISTING OUTLETS AND NOTIFY ARCHITECT OF DISCREPANCIES.
5. NO DEMO ON THIS PERMIT.

ALISON SPEAR, A.I.A.
 180 NE 30th St, Suite 222, Miami, FL 33137
 305-438-1200 Fax: 305-438-1221

PROJECT ARCHITECT


LIDO SPA HOTEL
 WEST WING - RENOVATION
 40 ISLAND AVENUE, MIAMI BEACH, FL 33139

DRAWING TITLE


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DRAWN BY: B.F.L.
 CHECKED BY: A.S.
 ISSUES

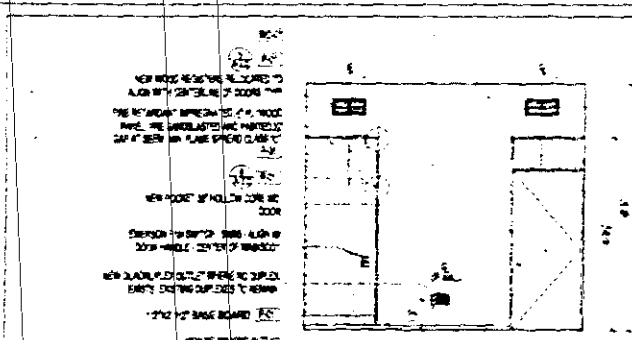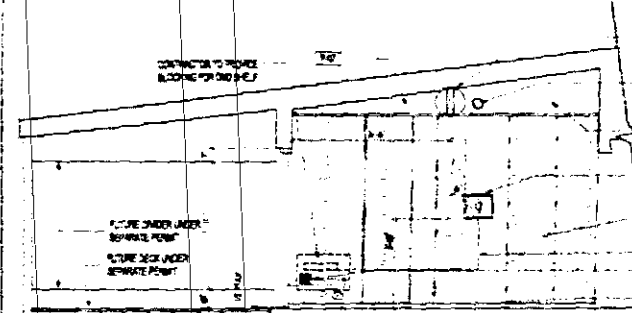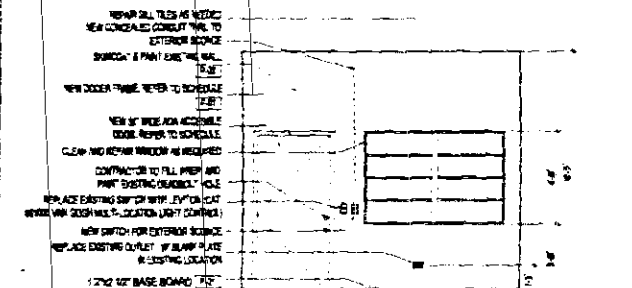
SHEET NO
A-2.04



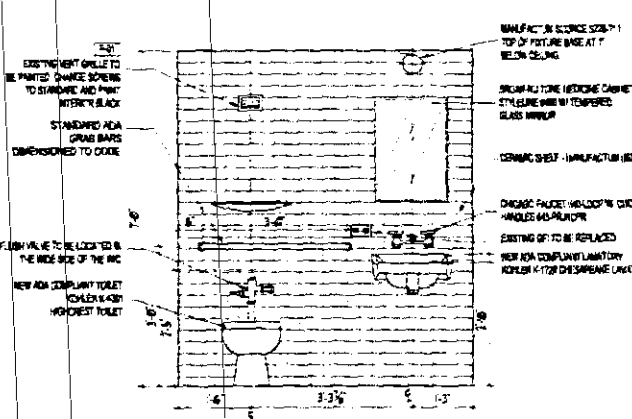
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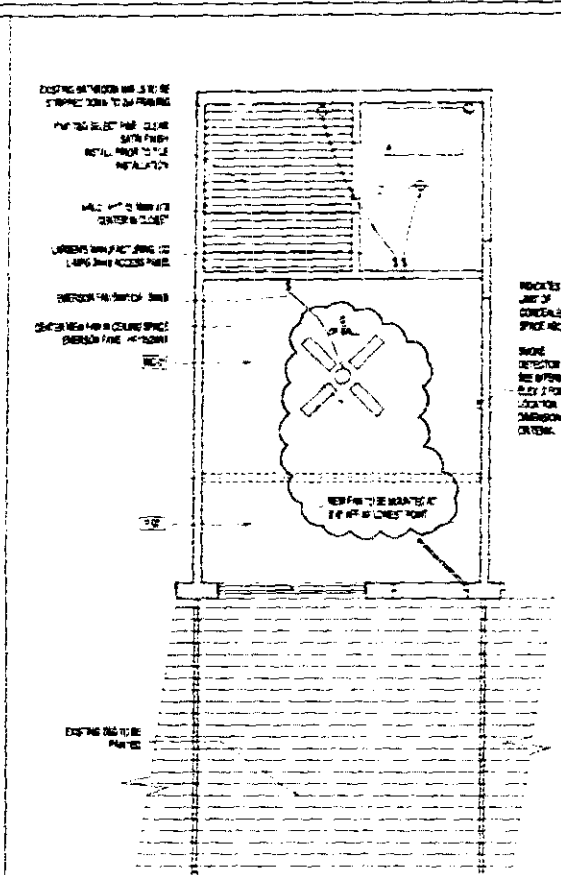
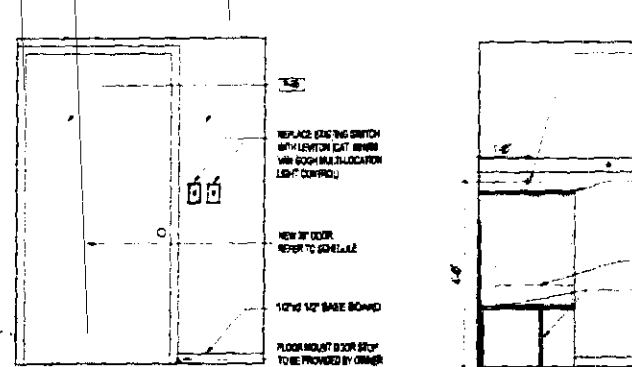
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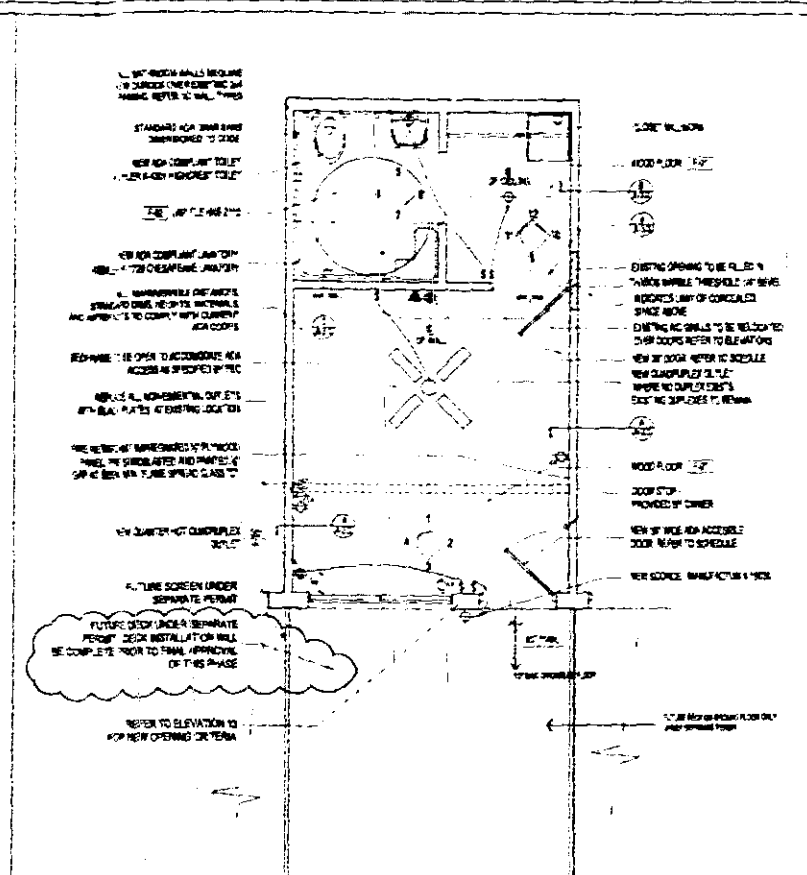
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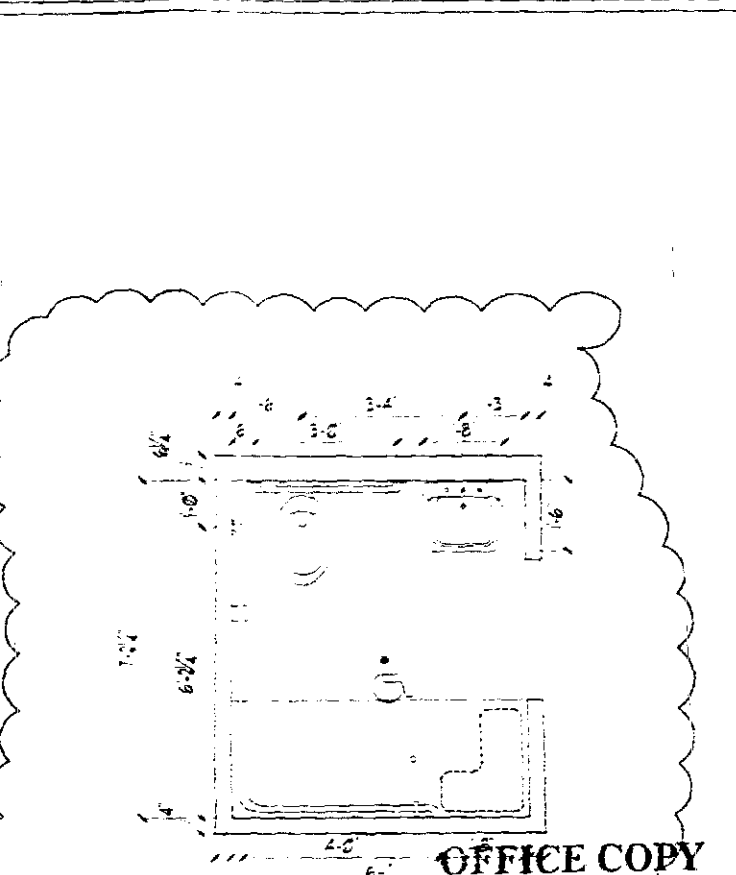
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SCALE: 1/2" = 1'-0"



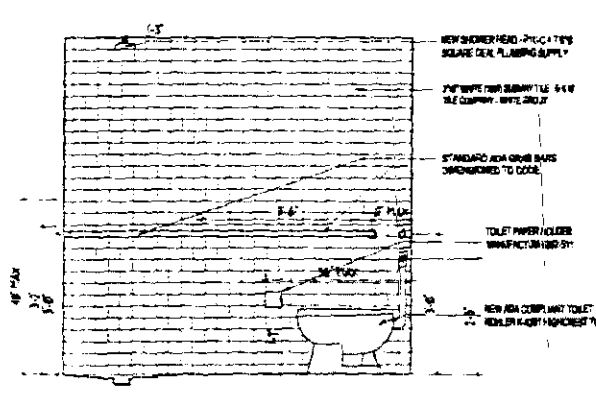
REFLECTED CEILING PLAN
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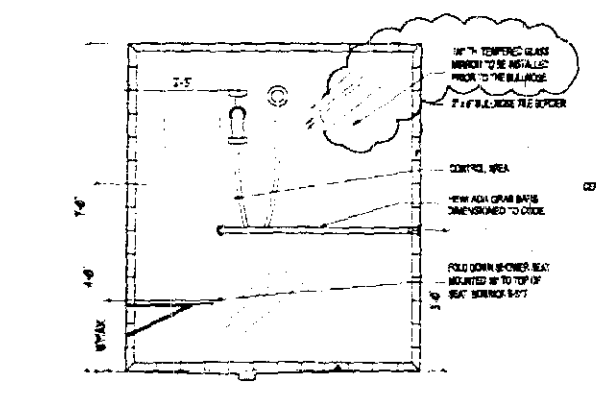
FLOOR PLAN
SCALE: 1/4" = 1'-0"




BATHROOM
SCALE: 1/2" = 1'-0"



6 BATHROOM
SCALE: 1/2" = 1'-0"



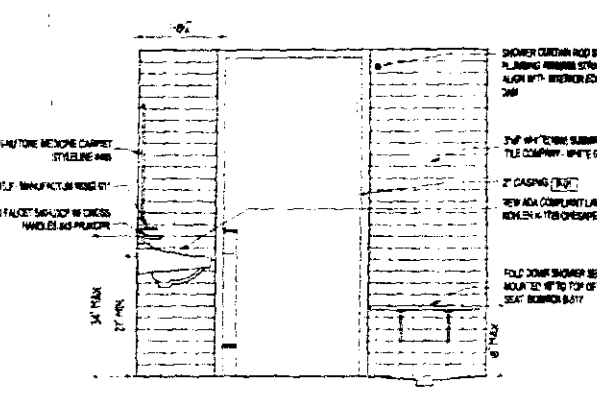7 BATHROOM
SCALE: 1/2" = 1'-0"



8 BATHROOM
SCALE: 1/2" = 1'-0"

- HANDICAP GENERAL NOTES**
- A LAVATORY COUNTER TOP HEIGHTS TO BE 34" A.F.F. WITH A MINIMUM CLEARANCE OF 27" A.F.F. TO BOTTOM OF APRON.
 - KNEE SPACE UNDER SINKS SHALL BE AT LEAST 27" HIGH, 30" WIDE AND 19" DEEP.
 - FAUCETS TO BE LEVER-OPERATED, PUSH-TYPE OR ELECTRONICALLY CONTROLLED MECHANISMS.
 - SINK SHALL BE A MAXIMUM OF 8 1/2" DEEP.
 - TOP OF HANDICAP TOILET SEAT TO BE 17" TO 19" HIGH.
 - ALL GRAB BARS TO BE 1 1/2" DIAM. WITH 1 1/2" CLEARANCE OFF WALLS.
 - DOOR THRESHOLD NOT TO EXCEED 1/4".
 - CONTROLS FOR SHOWER TO BE LOCATED BETWEEN 38" AND 48" A.F.F. (SEE PLAN FOR LOCATION) AND SHALL BE OPERABLE WITH ONE HAND AND SHALL NOT REQUIRE TIGHT GRASPING, PINCHING OR TWISTING OF THE WRIST. THE FORCE REQUIRED TO ACTIVATE CONTROLS SHALL BE NO GREATER THAN 5 LB.
 - A SHOWER SPRAY UNIT WITH A HOSE AT LEAST 60" LONG, WHICH CAN BE USED BOTH AS A FIXED SHOWER HEAD AND AS A HAND HELD SHOWER, MUST BE PROVIDED IN ALL ACCESSIBLE GUESTROOMS.
 - ACCESSIBLE SLEEPING ROOMS SHALL HAVE A 36" CLEAR WIDTH MANEUVERING SPACE LOCATED ALONG BOTH SIDES OF A BED, EXCEPT WHERE TWO BEDS ARE PROVIDED THIS REQUIREMENT CAN BE MET BY PROVIDING A 36" WIDE MANEUVERING SPACE LOCATED BETWEEN THE TWO BEDS.
 - ONE OF EACH TYPE OF STORAGE FACILITY IN HOTEL ROOMS SUCH AS DRAWERS, CLOSET, AND SHELVES SHALL BE ACCESSIBLE. SHELVES MOUNTED 48" A.F.F. IN ROOM MOUNTED AT 48" A.F.F.
 - OUTLETS @ 15" TO CENTER LINE.
 - FLUSH CONTROL FOR TOILETS TO BE ON OPPOSITE SIDE OF GRAB BARS.
 - TYPICAL ACCESSIBLE UNIT'S FURNITURE.
 - DESK WITH KNEE CLEARANCE.
 - ACCESSIBLE ROUTE 36" BOTH SIDES OF BED.
 - OPEN FRAME BED.
 - DOORS NOT OBSTRUCTED.

- NOTES**
1. OUTLET LOCATIONS IN THIS DRAWING ARE FOR DESIGN PURPOSES ONLY. THESE OUTLETS SHOULD BE SUPPLEMENTED AS REQUIRED BY ELECTRICAL ENGINEER'S DRAWINGS TO MEET ALL I.B.C. REQUIREMENTS.
 2. ALL NON-ESSENTIAL EXISTING OUTLETS SHOULD BE REPLACED WITH BLANK FACE PLATES (WHITE), HORIZONTAL, AT EXISTING HEIGHT.
 3. NEW OUTLETS TO BE WHITE WITH WHITE COVER PLATES.
 4. CONTRACTOR TO VERIFY LOCATION OF EXISTING OUTLETS AND NOTIFY ARCHITECT OF DISCREPANCIES.
 5. NO DEMO ON THIS PERMIT.

ALISON SPEAR, A.I.A.
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305-438-1200 Fax 305-438-1221

PROJECT ARCHITECT

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THE FOLLOWING:

BUILDING:
ZONING:
DRAFTER:
CONCURRENCY:
PLUMBING:
ELECTRICAL:
MECHANICAL:
FIRE PREVENTION:
ENGINEERING:
PUBLIC WORKS:
STRUCTURAL:
ACCESSIBILITY:
FIFTY-FIVE:

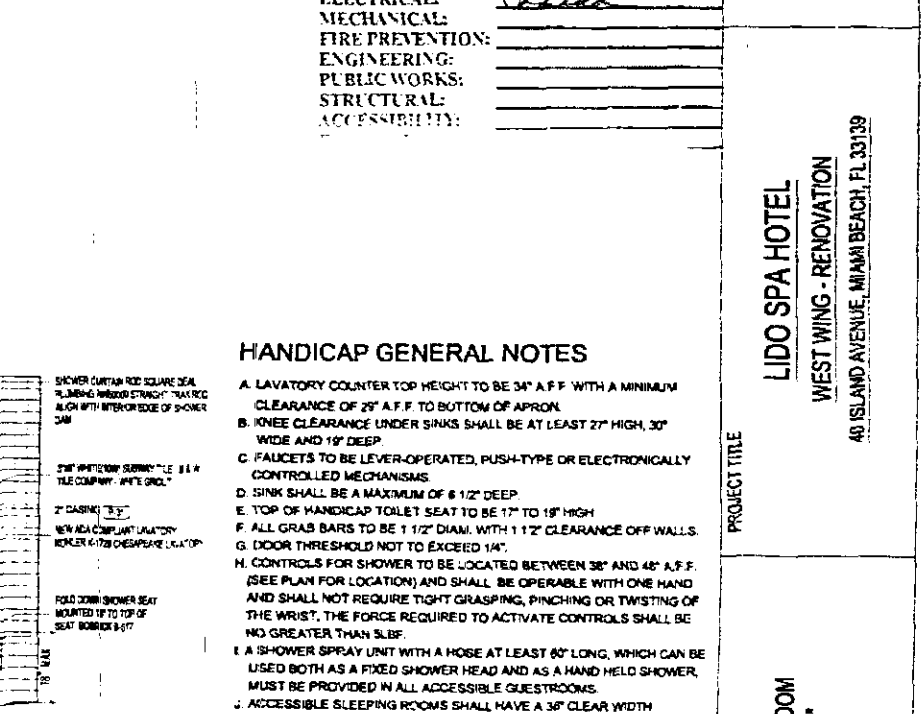
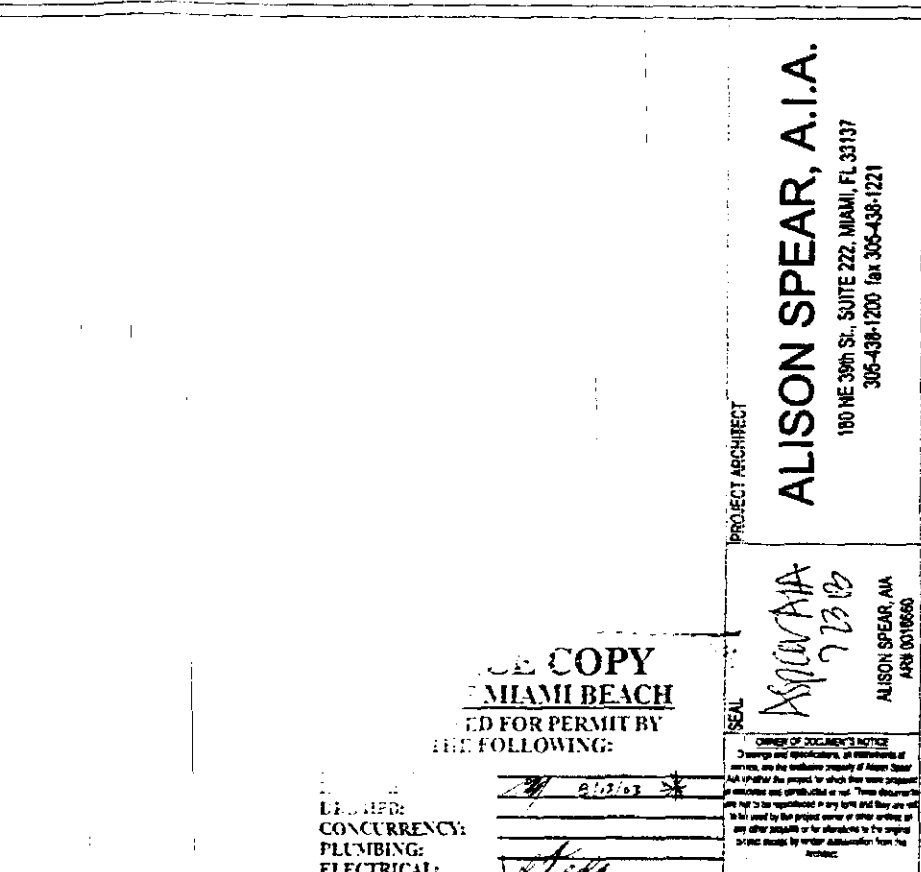
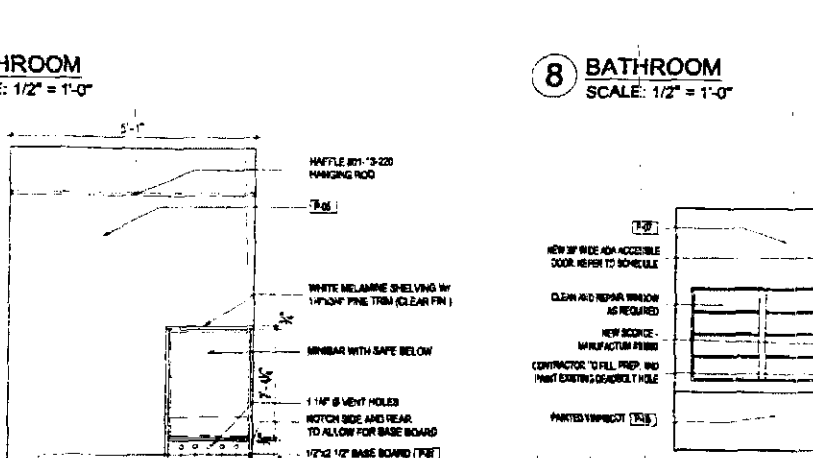
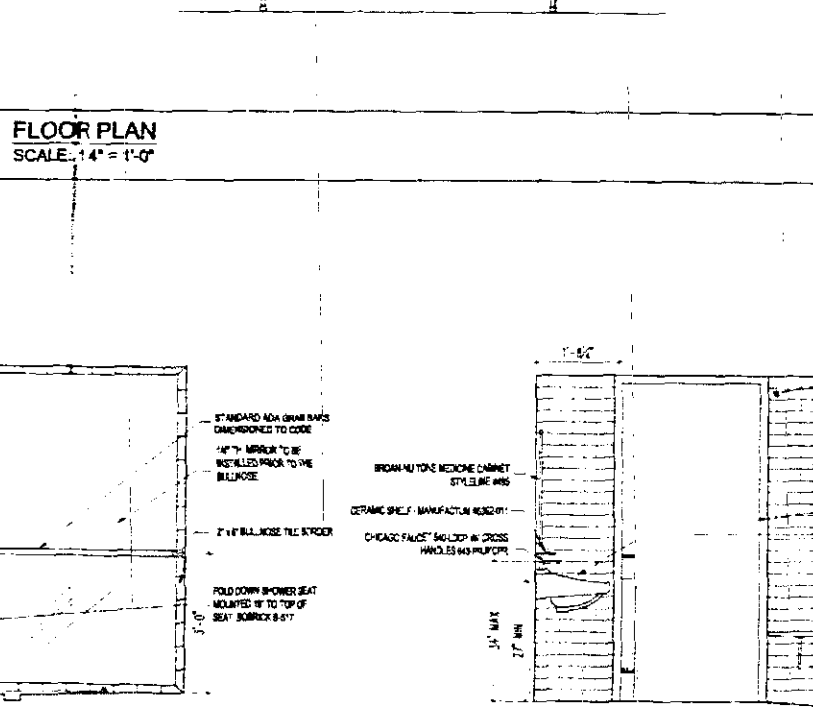
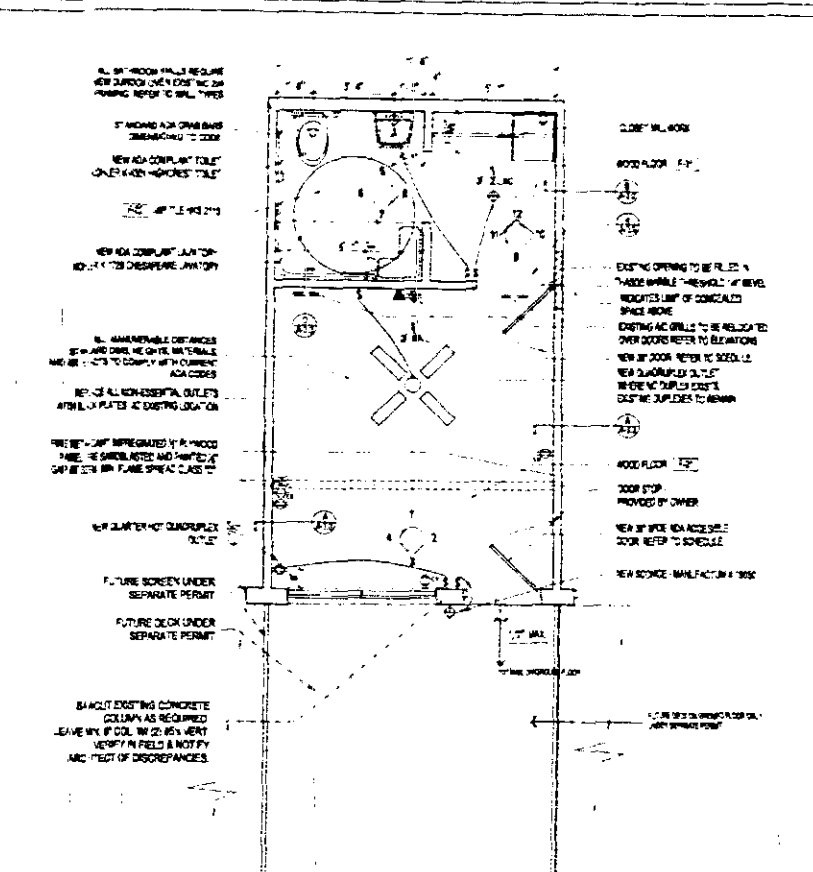
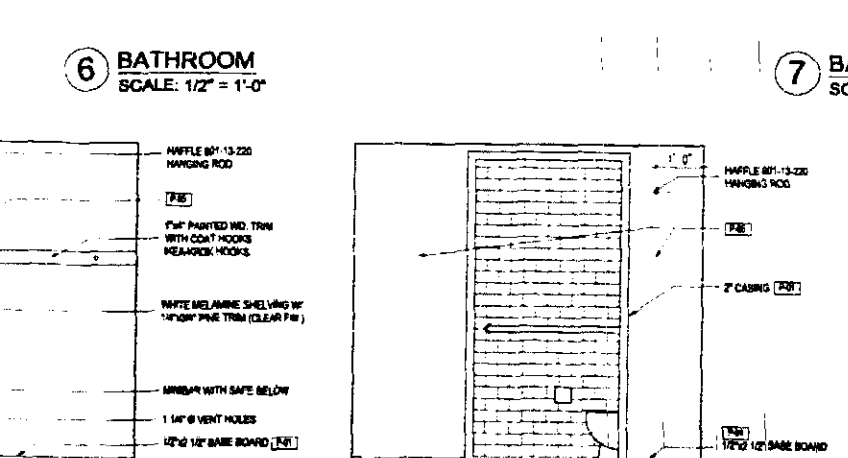
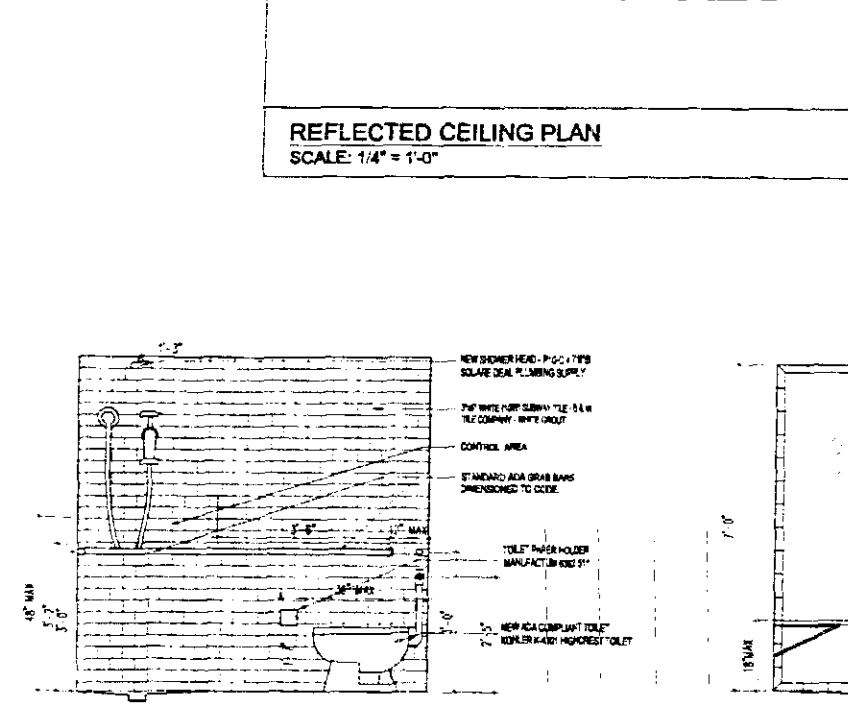
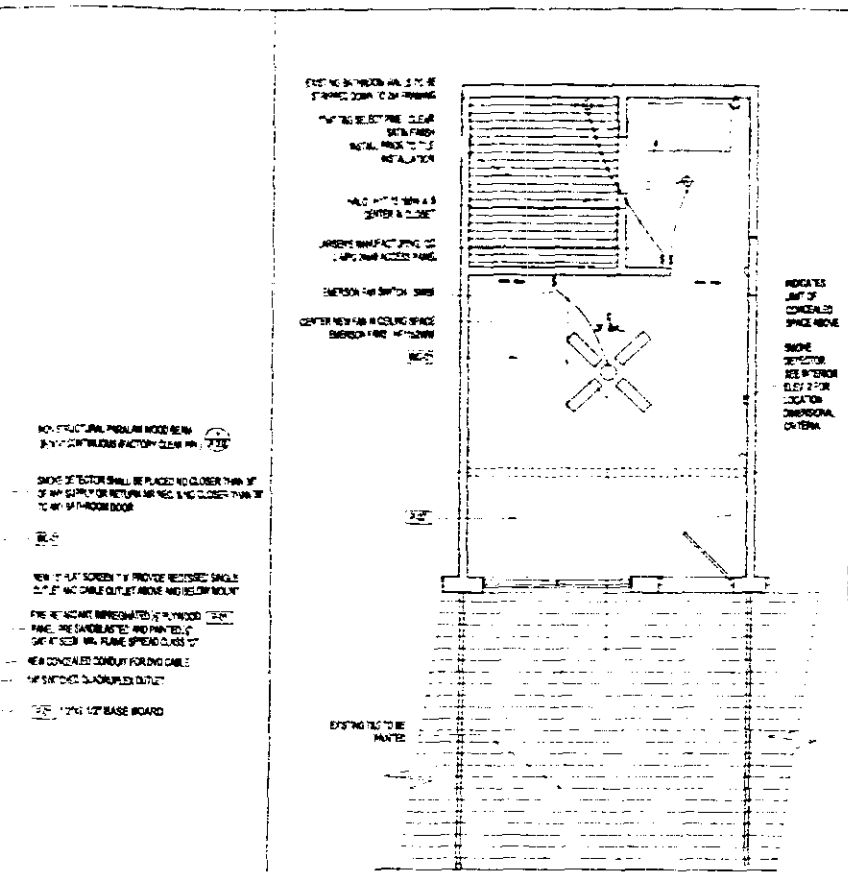
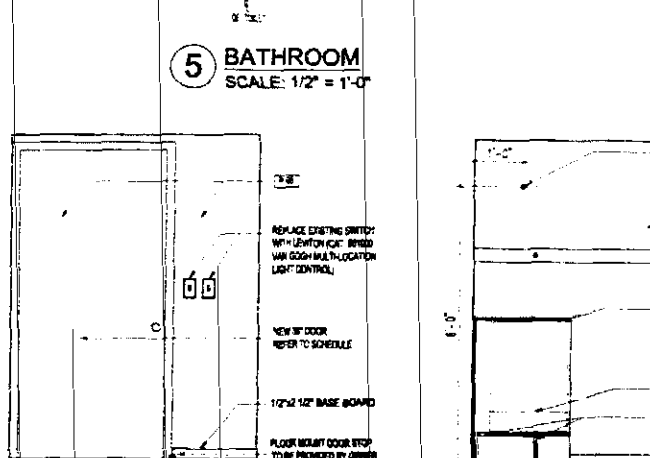
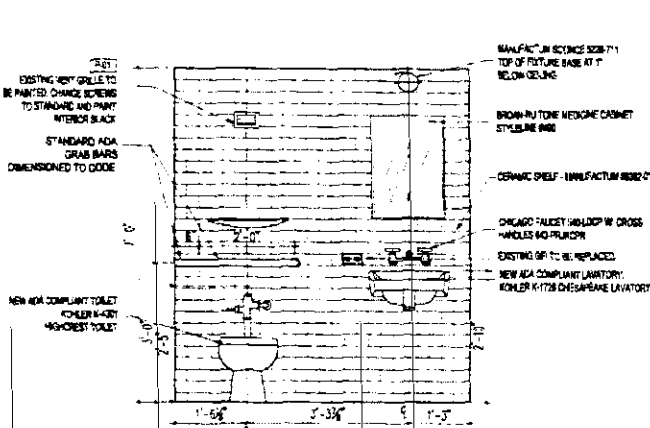
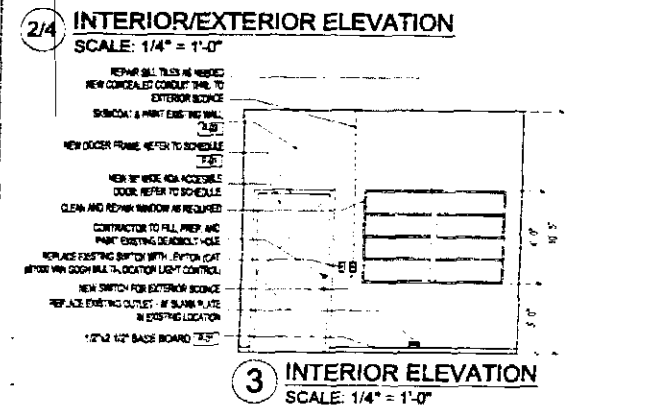
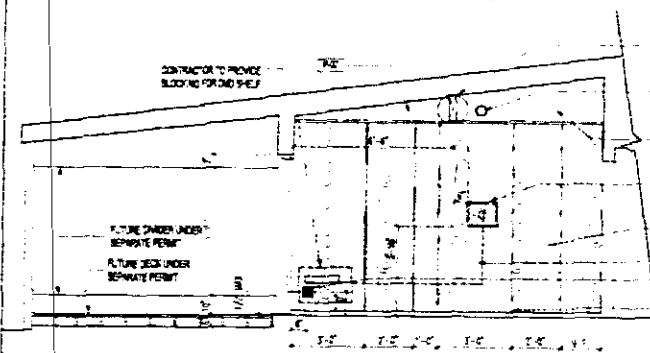
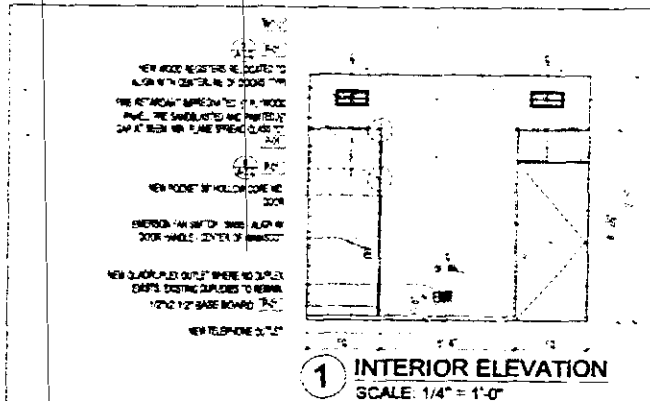
LIDO SPA HOTEL
WEST WING - RENOVATION
40 ISLAND AVENUE, MIAMI BEACH, FL 33139

PROJECT TITLE

TYPICAL ROOM
TYPE "5"

DRAWN BY B.F.L.
CHECKED BY A.S.
ISSUES

SHEET NO. 12 OF 24



HANDICAP GENERAL NOTES

- A. LAVATORY COUNTER TOP HEIGHT TO BE 34" A.F.F. WITH A MINIMUM CLEARANCE OF 25" A.F.F. TO BOTTOM OF APRON.
- B. KNEE CLEARANCE UNDER SINKS SHALL BE AT LEAST 27" HIGH, 30" WIDE AND 19" DEEP.
- C. FAUCETS TO BE LEVER-OPERATED, PUSH-TYPE OR ELECTRONICALLY CONTROLLED MECHANISMS.
- D. SINK SHALL BE A MAXIMUM OF 6 1/2" DEEP.
- E. TOP OF HANDICAP TOILET SEAT TO BE 17" TO 19" HIGH.
- F. ALL GRAB BARS TO BE 1 1/2" DIAM. WITH 1 1/2" CLEARANCE OFF WALLS.
- G. HAND GRIPS TO BE 1 1/2" TO 2" DEEDED 14".
- H. CONTROLS FOR SHOWER TO BE LOCATED BETWEEN 36" AND 48" A.F.F. (SEE PLAN FOR LOCATION), AND SHALL BE OPERABLE WITH ONE HAND AND SHALL NOT REQUIRE TIGHT GRASPING, PINCHING OR TWISTING OF THE WRIST, THE FORCE REQUIRED TO ACTIVATE CONTROLS SHALL BE NO GREATER THAN SLIP.
- I. A SHOWER SPRAY UNIT WITH A HOSE AT LEAST 60" LONG, WHICH CAN BE USED BOTH AS A FIXED SHOWER HEAD AND AS A HAND HELED SHOWER, MUST BE PROVIDED IN ALL ACCESSIBLE GUESTROOMS.
- J. ACCESSIBLE SLEEPING ROOMS SHALL HAVE A 36" CLEAR WIDTH MANEUVERING SPACE LOCATED ALONG BOTH SIDES OF A BED, EXCEPT TWO BEDS ARE PROVIDED THIS REQUIREMENT CAN BE MET BY PROVIDING A 36" WIDE MANEUVERING SPACE LOCATED BETWEEN THE TWO BEDS.
- K. ONE OF EACH TYPE OF STORAGE FACILITY 21 HOTEL ROOMS SUCH AS DRAWERS, CLOSETS AND SHELVES SHALL BE ACCESSIBLE. SHELVES MOUNTED 48" A.F.F. W/ ROD MOUNTED AT 46" A.F.F.
- L. OUTLETS @ 15" TO CENTER LINE.
- M. FLUSH CONTROL FOR TOILETS TO BE ON OPPOSITE SIDE OF GUEST BARS
- N. TYPE, ACCESSIBLE UNITS FURNITURE:
DESK WITH KNEE CLEARANCE
ACCESSIBLE ROOM 36" BOTH SIDES OF BED
OPEN FRAME BED
DOORS NOT OBSTRUCTED

NOTES

- NOTES
1. OUTLET LOCATIONS IN THIS DRAWING ARE FOR DESIGN PURPOSES ONLY. THESE OUTLETS SHOULD BE SUPPLEMENTED AS REQUIRED BY ELECTRICAL ENGINEERS DRAWINGS TO MEET F.B.C.'S REQUIREMENTS.
 2. ALL NON-ESSENTIAL EXISTING OUTLETS SHOULD BE REPLACED WITH BLANK FACE PLATES (WHITE), HORIZONTAL, AT EXISTING HEIGHT.
 3. NEW OUTLETS TO BE WHITE WITH WHITE COVER PLATES.
 4. CONTRACTOR TO VERIFY LOCATION OF EXISTING OUTLETS AND NOTIFY ARCHITECT OF DISCREPANCIES.
 5. NO DEMO ON THIS PERMIT.

ALISON SPEAR, A.I.A.
180 NE 39th St., SUITE 222, MIAMI, FL 33137
305-438-1200 fax 305-438-1221

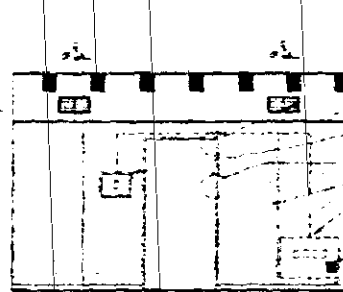
9126
ATM 01/18

TYPICAL ROOM
TYPE "S"

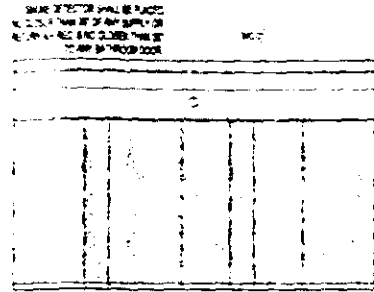
DRAWN BY _____
 CHECKED BY _____
 ISSUES _____

SHEET NO.

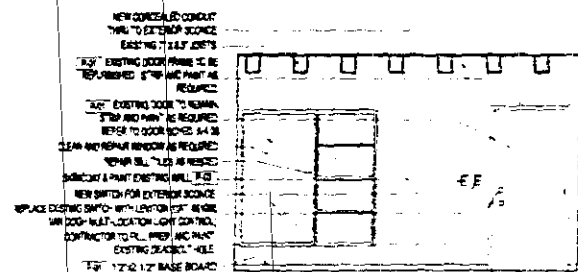
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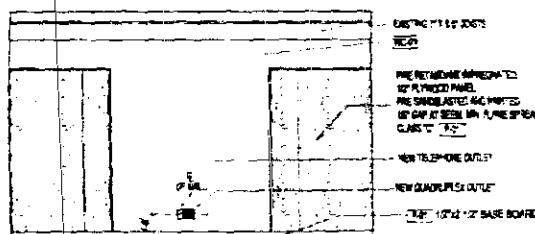
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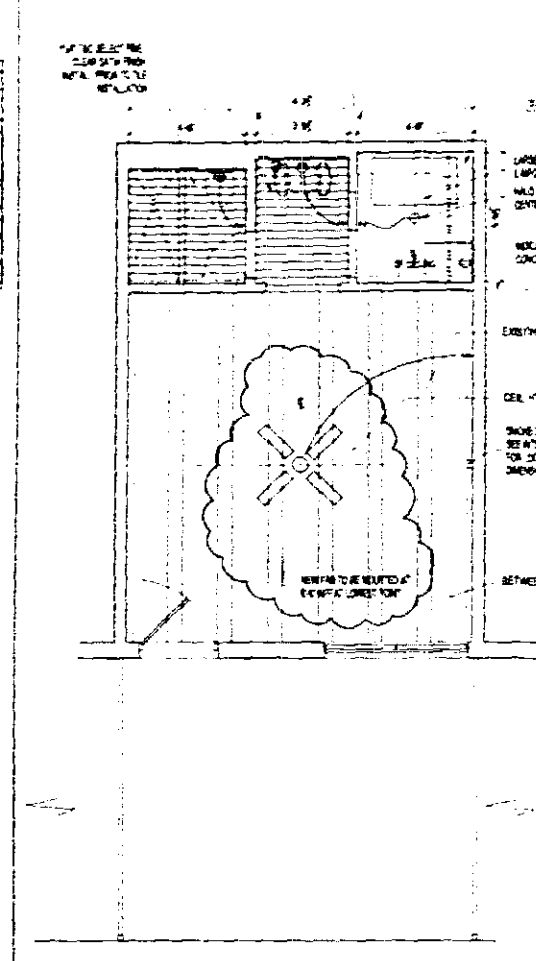
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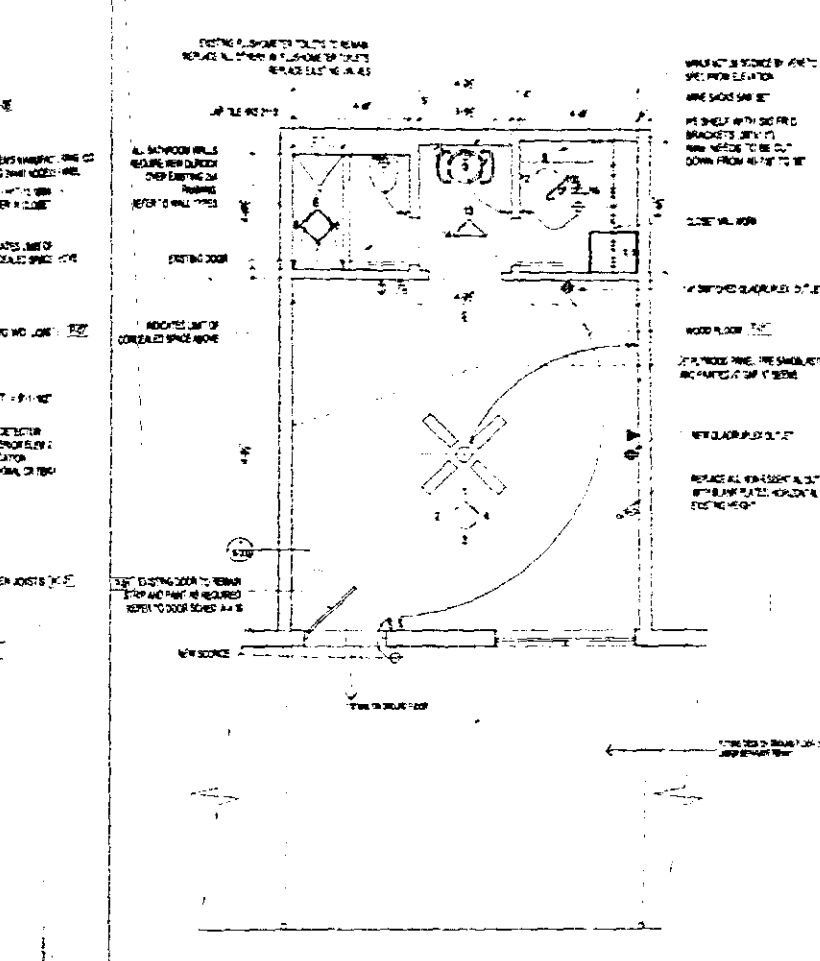
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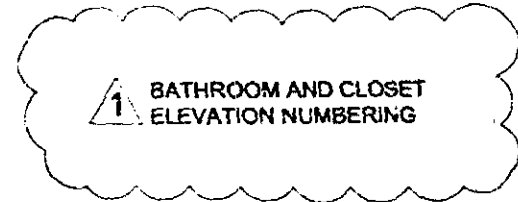
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REFLECTED CEILING PLAN
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PROPOSED FLOOR PLAN
SCALE: 1/4" = 1'-0"




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CONSTRUCTION
ELECTRICAL
MECHANICAL
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ENGINEERING
PUBLIC WORKS
STRUCTURAL
ACCESSIBILITY
ELEVATOR


As per Florida Building Code Section 104.5.3
FOR HATCHED PERMITTING

NOTES

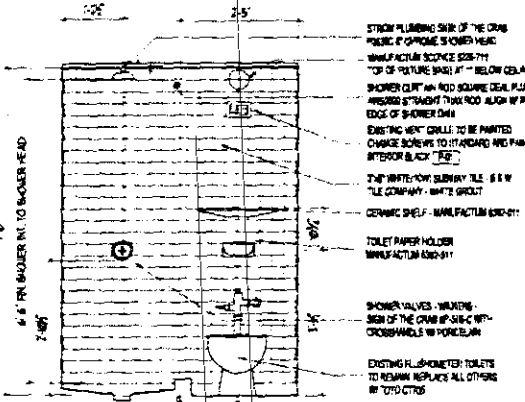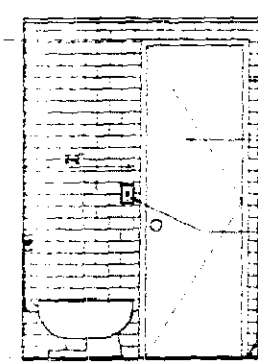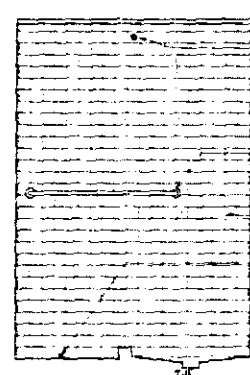
1. OUTLET LOCATIONS IN THIS DRAWING ARE FOR DESIGN PURPOSES ONLY. THESE OUTLETS SHOULD BE SUPPLEMENTED AS REQUIRED BY ELECTRICAL ENGINEER'S DRAWINGS TO MEET F.B.C. REQUIREMENTS.
2. ALL NON-ESSENTIAL EXISTING OUTLETS SHOULD BE REPLACED WITH BLANK FACE PLATES (WHITE) HORIZONTAL AT EXISTING HEIGHT.
3. NEW OUTLETS TO BE WHITE WITH WHITE COVER PLATES.
4. CONTRACTOR TO VERIFY LOCATION OF EXISTING OUTLETS AND NOTIFY ARCHITECT OF DISCREPANCIES.
5. NO DEMO ON THIS PERMIT.



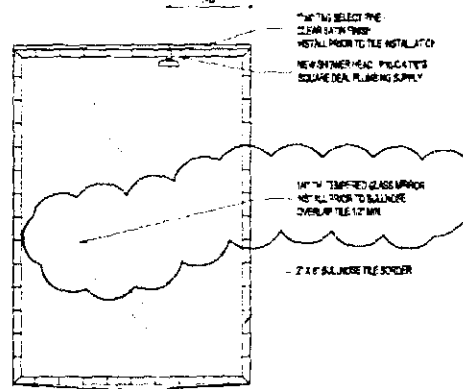
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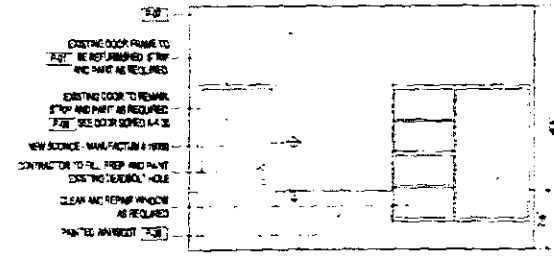
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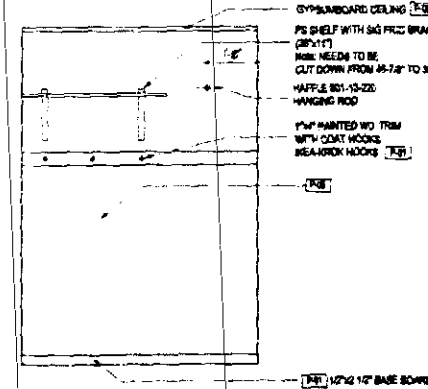
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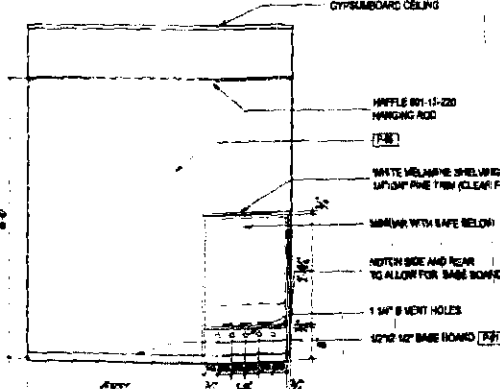
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SCALE: 1/2" = 1'-0"



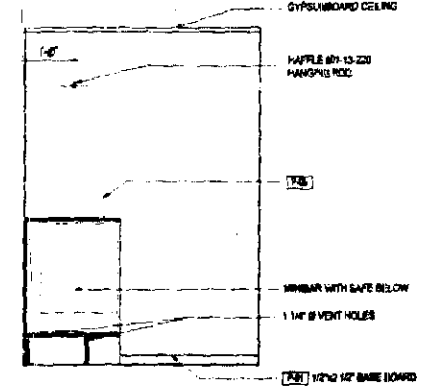
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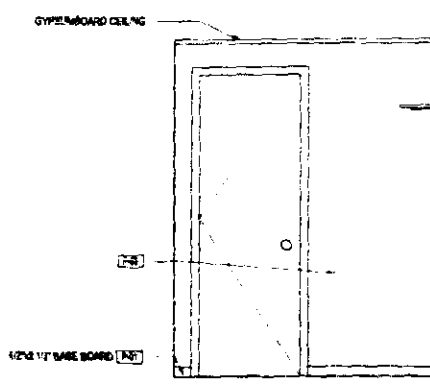
9 CLOSET
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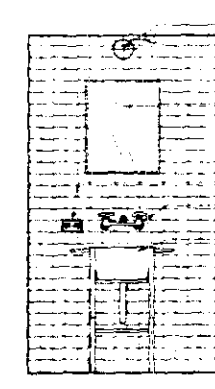
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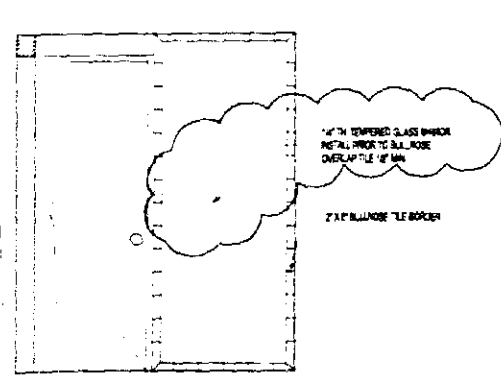
11 CLOSET
SCALE: 1/2" = 1'-0"



12 CLOSET
SCALE: 1/2" = 1'-0"



13 BATHROOM
SCALE: 1/2" = 1'-0"



14 BATHROOM
SCALE: 1/2" = 1'-0"

PROJECT ARCHITECT
ALISON SPEAR, A.I.A.
180 NE 39th St., Suite 222, Miami, FL 33137
305-438-1200 FAX 305-438-1221

SEAL
8-27-03
ALISON SPEAR, AIA
ARCHITECT

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ELEVATOR

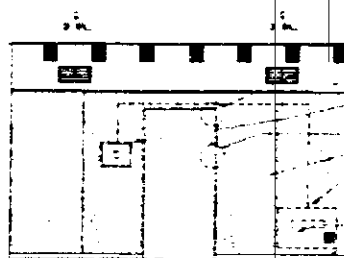
PROJECT TITLE
LIDO SPA HOTEL
WEST WING - RENOVATION
40 ISLAND AVENUE, MIAMI BEACH, FL 33139

DRAWING TITLE
TYPICAL ROOM
TYPE "B"


DRAWN BY
CHECKED BY
ISSUES

DATE
BY
REVISION


SHEET NO.
A-2.05



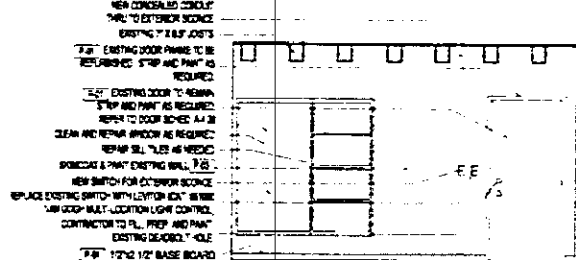
1 INTERIOR ELEVATION
SCALE: 1/4" = 1'-0"



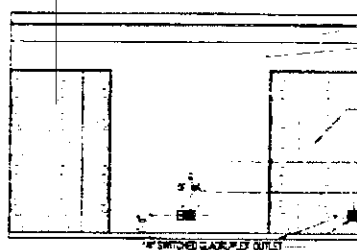
3 INTERIOR ELEVATION
SCALE: 1/4" = 1'-0"



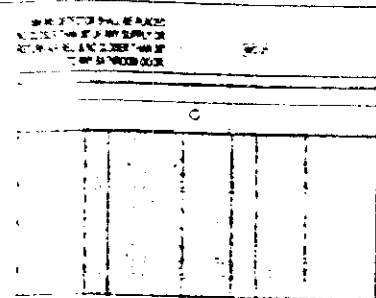
4 INTERIOR ELEVATION
SCALE: 1/4" = 1'-0"



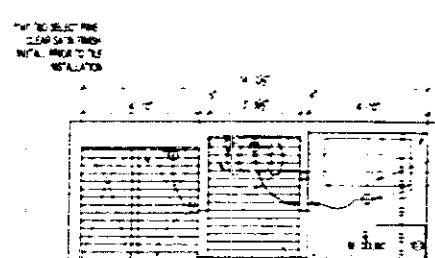2 INTERIOR ELEVATION
SCALE: 1/4" = 1'-0"



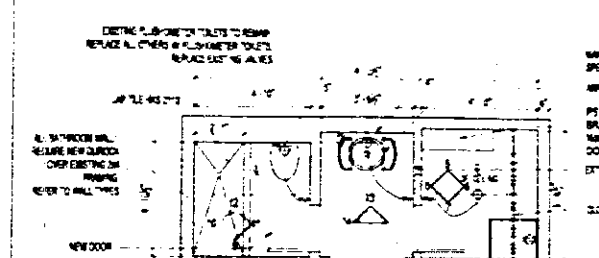
REFLECTED CEILING PLAN
SCALE: 1/4" = 1'-0"




PROPOSED FLOOR PLAN
SCALE: 1/4" = 1'-0"

NOTES


1. OUTLET LOCATIONS IN THIS DRAWING ARE FOR DESIGN PURPOSES ONLY. THESE OUTLETS SHOULD BE SUPPLEMENTED AS REQUIRED BY ELECTRICAL ENGINEERS' DRAWINGS TO MEET F.B.C.'S REQUIREMENTS.
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5. NO DEMO ON THIS PERMIT.

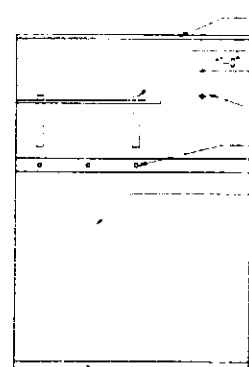


5 CLOSET
SCALE: 1/2" = 1'-0"

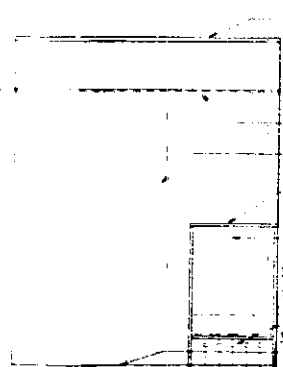


6 CLOSET
SCALE: 1/2" = 1'-0"

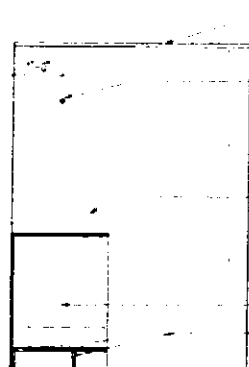


7 CLOSET
SCALE: 1/2" = 1'-0"

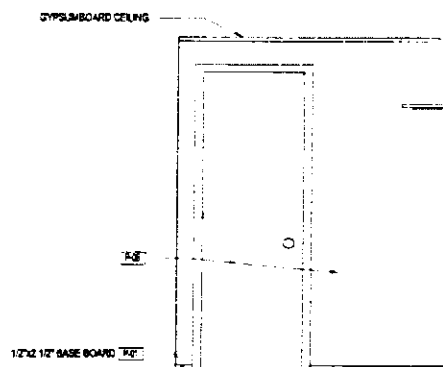


8 CLOSET
SCALE: 1/2" = 1'-0"

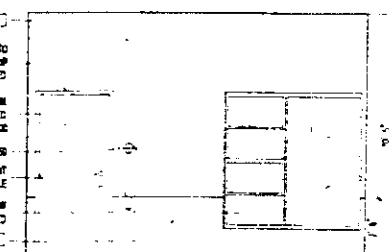

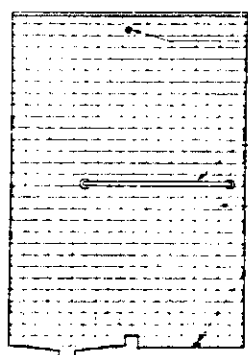
15 EXTERIOR ELEVATION
SCALE: 1/4" = 1'-0"




9 BATHROOM

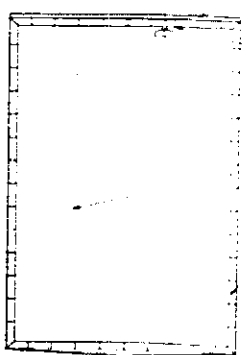


10 BATHROOM

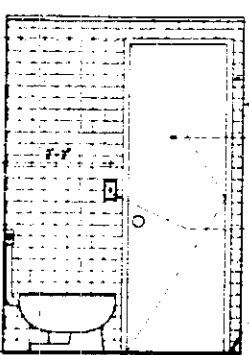


11 BATHROOM

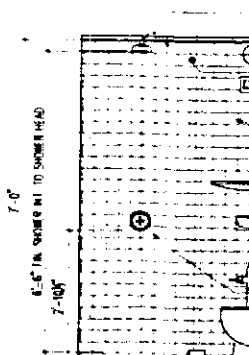


12 BATHROOM

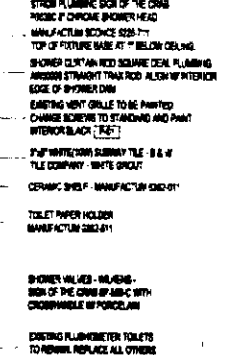

13 BATHROOM

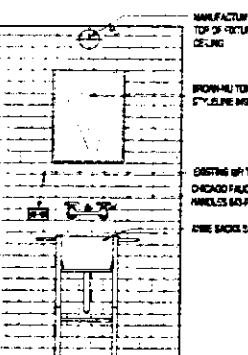

14 BATHROOM

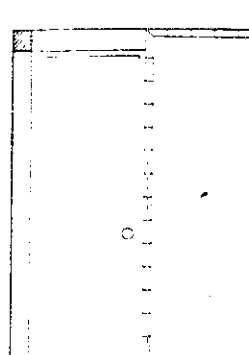

16 BATHROOM

ALISON SPEAR, A.I.A.

180 NE 39th St., Suite 222, Miami, FL 33137
305-438-1200 Fax 305-438-1221

PROJECT ARCHITECT

ALISON SPEAR, A.I.A.

ALISON SPEAR, A.I.A.

LIDO SPA HOTEL
WEST WING - RENOVATION
40 ISLAND AVENUE, MIAMI BEACH, FL 33139

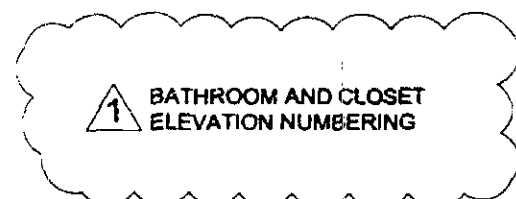
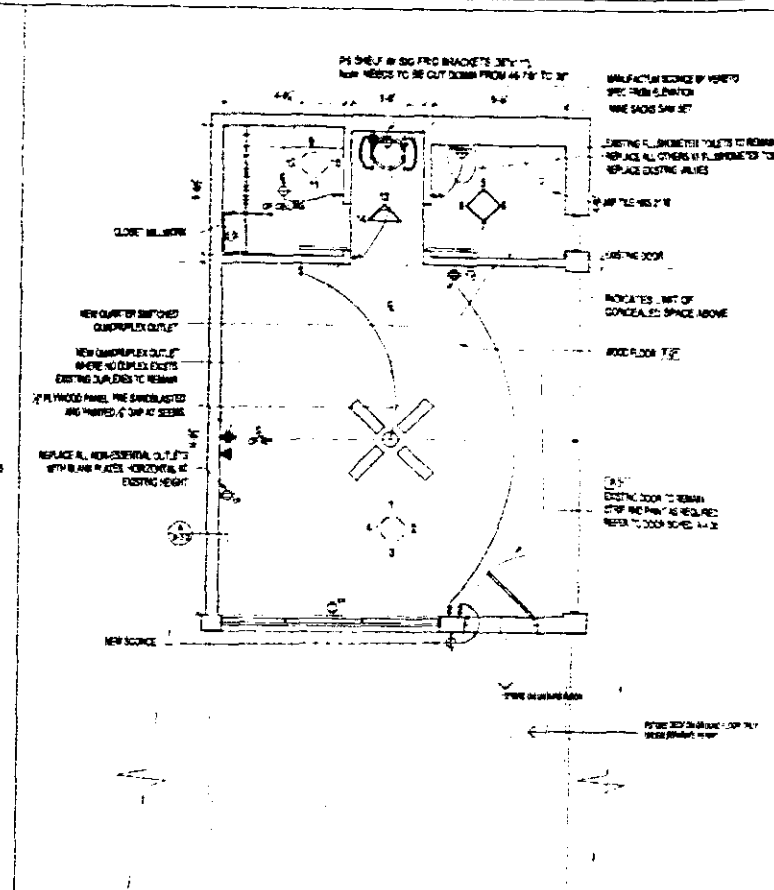
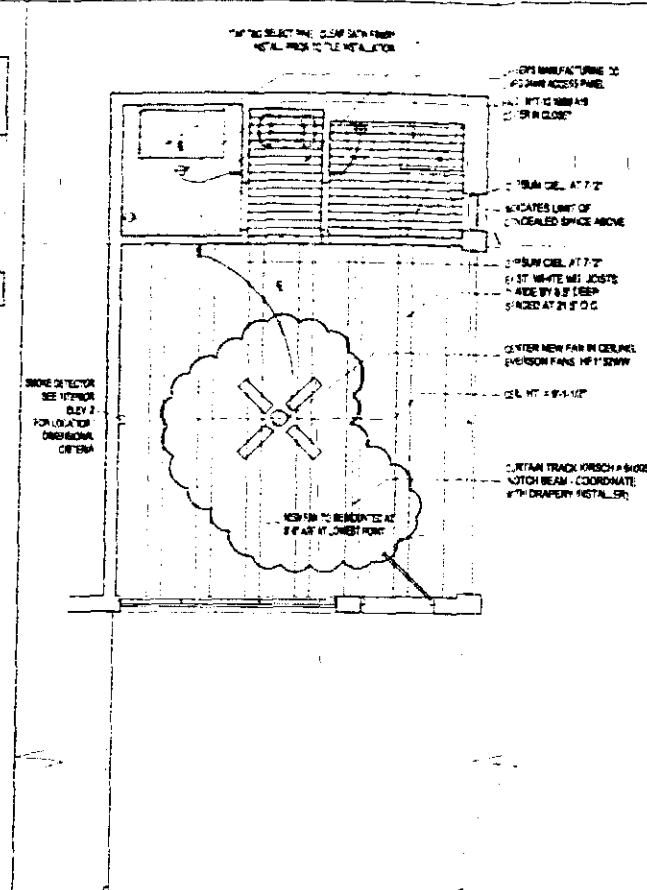
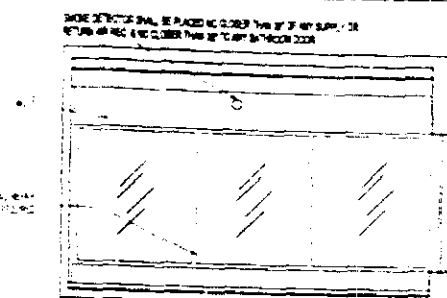
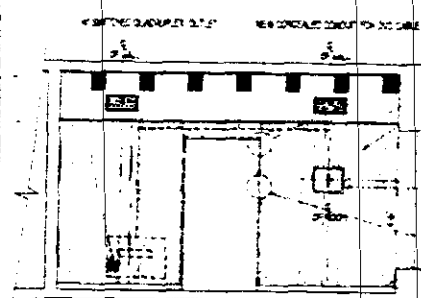
PROJECT TITLE

TYPICAL ROOM
TYPE "6"

DRAWN BY S.F.L.
CHECKED BY A.S.
ISSUES
PERMIT ISSUED

SHEET NO














A-2.05



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THE FOLLOWING:

As per Florida Building Code Section 104.5.2
REQUIRED FOR CODE COMPLIANCE.

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5. NO DEMO ON THIS PERMIT.

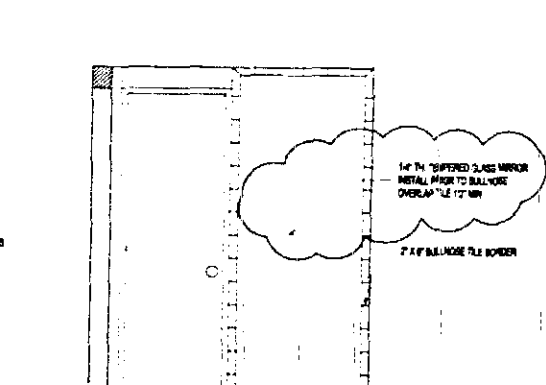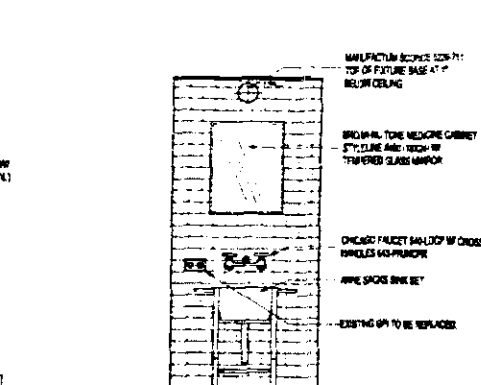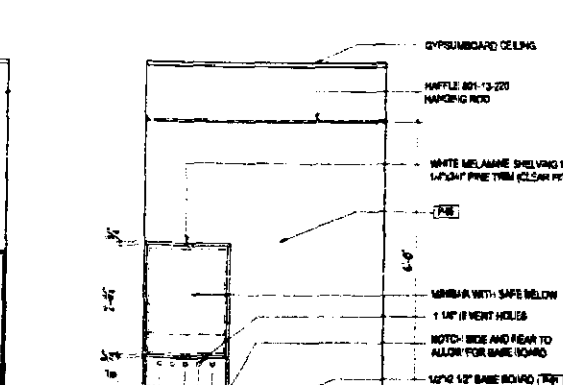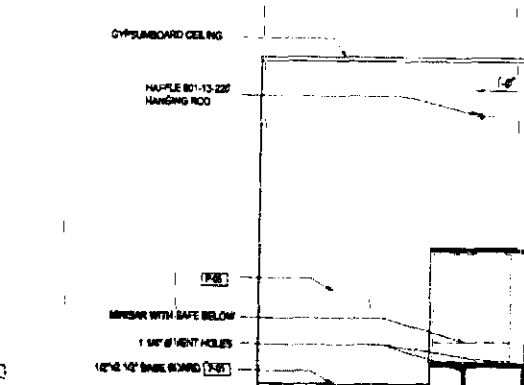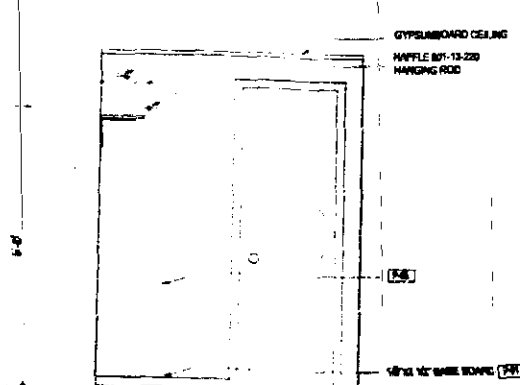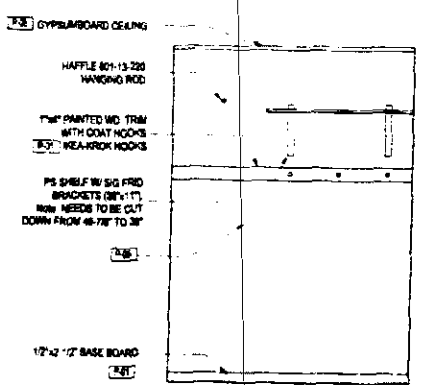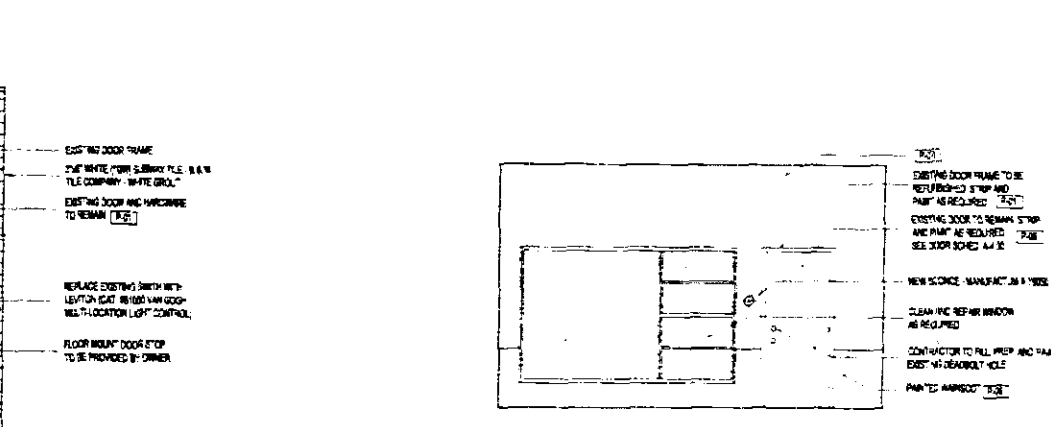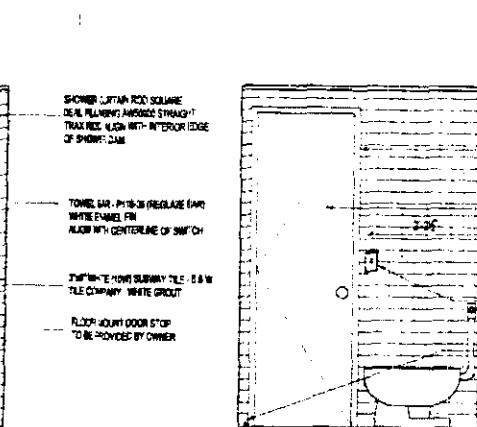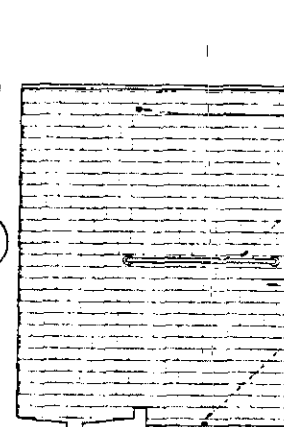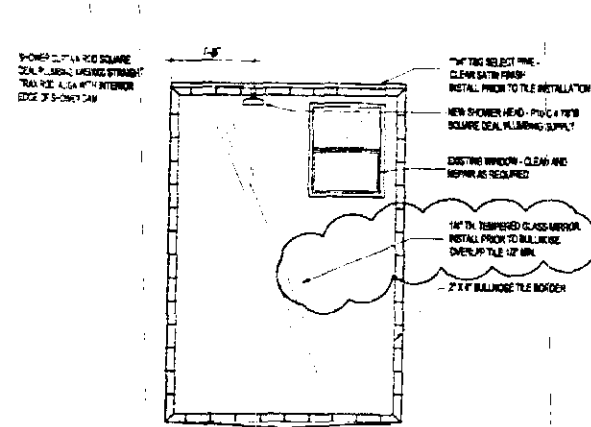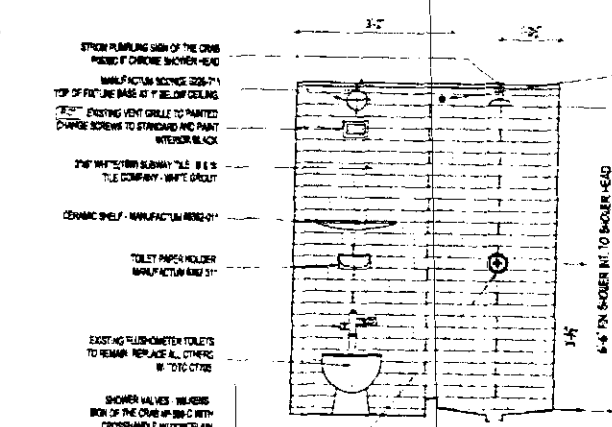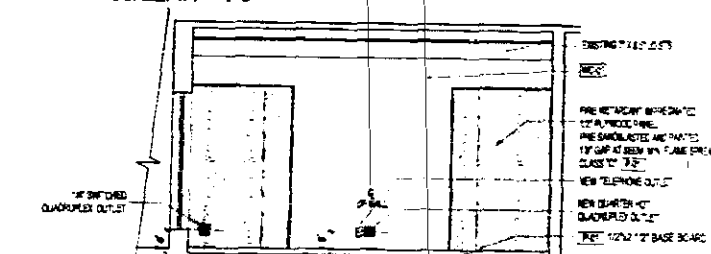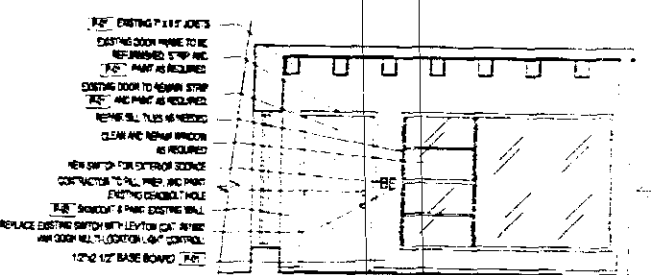

ECT ARCHITECT

ALISON SPEAR, A.I.A.

180 NE 39th St., SUITE 222 MIAMI, FL 33137
305-438-1200 fax 305-438-1221


SON SPEAR A/A
8-27-80
Spear A/A

LIDO SPA HOTEL
WEST WING - RENOVATION
10 ISLAND AVENUE, MIAMI BEACH, FL 33139


DRAWN BY	B.J.
CHECKED BY	A.
ISSUES	
07-23-03	PERMIT IS
08-27-03	REVISION: 4. IN THE DEPT. OF

SHEET NO.

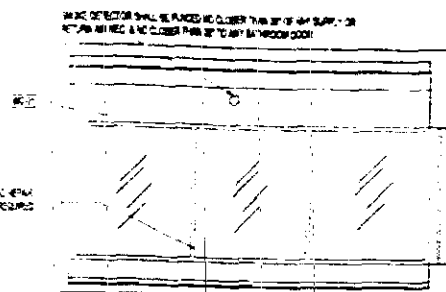A-2.06




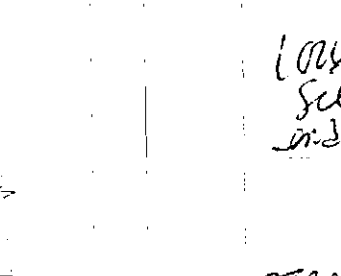2 INTERIOR ELEVATION
SCALE: 1/4" = 1'-0"




③ INTERIOR ELEVATION
SCALE: 1/4" = 1'-0"

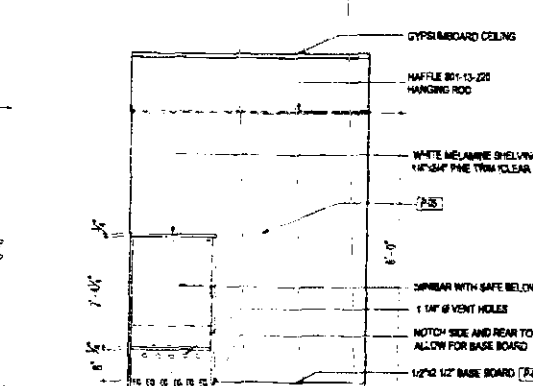
4 INTERIOR ELEVATION
SCALE: 1/4" = 1'-0"




5 CLOSET
SCALE: 1/2" = 1'-0"

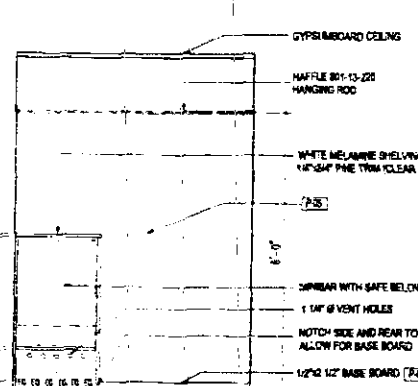

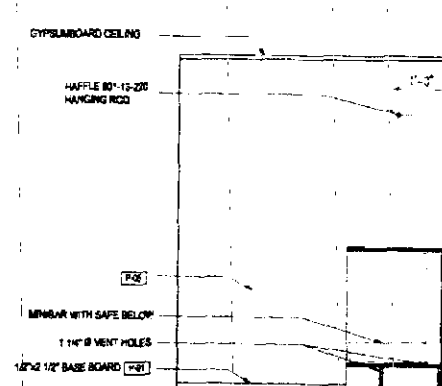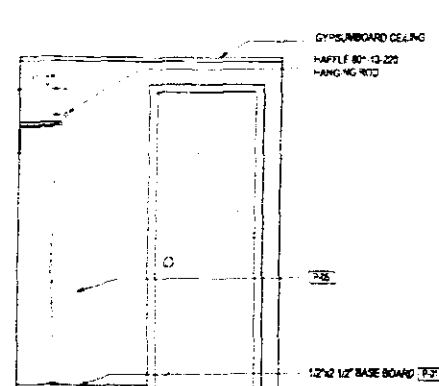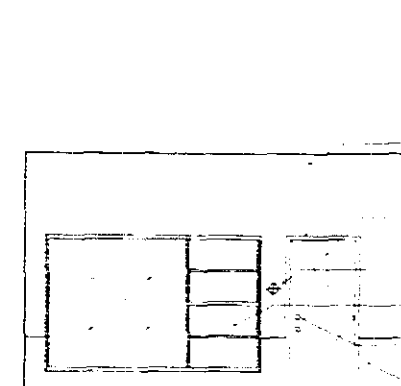
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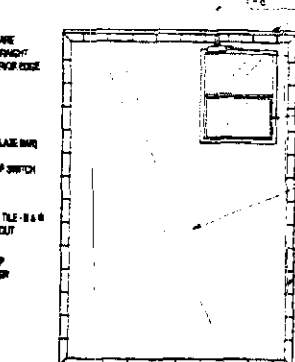
⑦ **CLOSET**
SCALE: 1/8" = 1'-0"




8 CLOSET




15 EXTERIOR ELEVATION
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BATHROOM



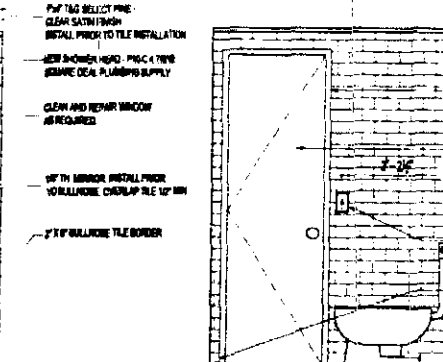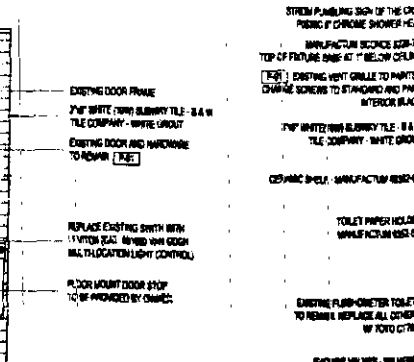BATHROOM



BATHROOM


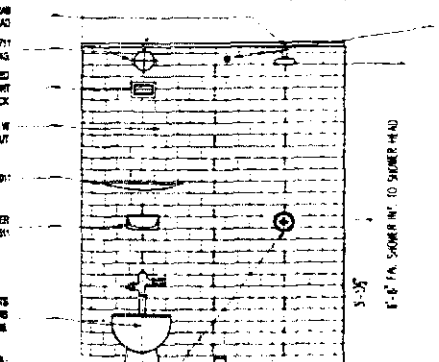


Diagram illustrating the components and measurement points for a window unit:

- MANUFACTURER RECOMMENDS TOP OF CURTAINS BASE AT 1" BELOW CEILING
- BROWLINE MEASURE TO STYLELINE (IRON / ROD)
- CHOOSE HANGERS AND HOOKS (HANGERS AND HOOKS)
- IRON SACKS DRINK SET
- SEWING GP. TO BE REPLACED

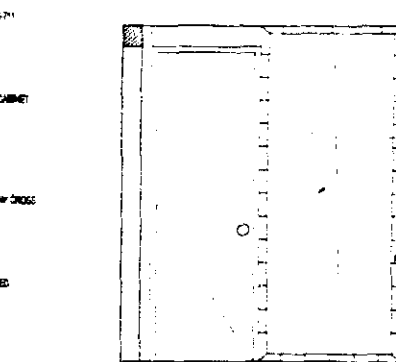 BATHROOMS



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ZONING:
 DRG HPB:
 CONCURRENCY:
 PLUMBING:
 ELECTRICAL:
 MECHANICAL:
 FIRE PREVENTION:
 ENGINEERING:
 PUBLIC WORKS:

PROJECT ARCHITECT

ALISON SPEAR, A.I.A.
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7.7305
L. J. CIV-MA
JULSON SPEAR, AIA
AR# 0016660

LIDO SPA HOTEL
WEST WING - RENOVATION
40 ISLAND AVENUE, MIAMI BEACH, FL 33139


PROJECT TITLE _____

TYPE
TYPICAL ROOM
TYPE "B-A"


DRAWN BY	B.F.L.
CHECKED BY	A.S.
ISSUES	

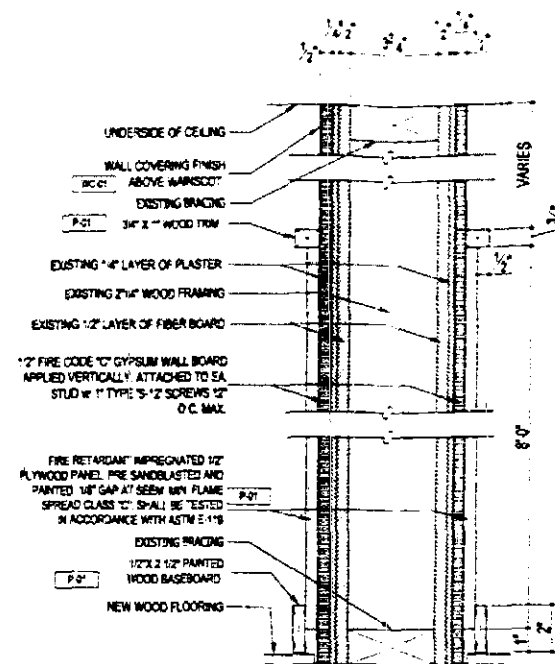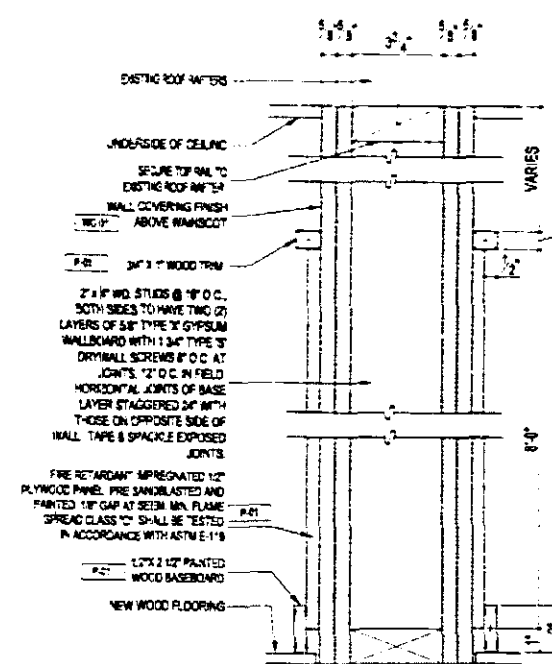SHEET NO.

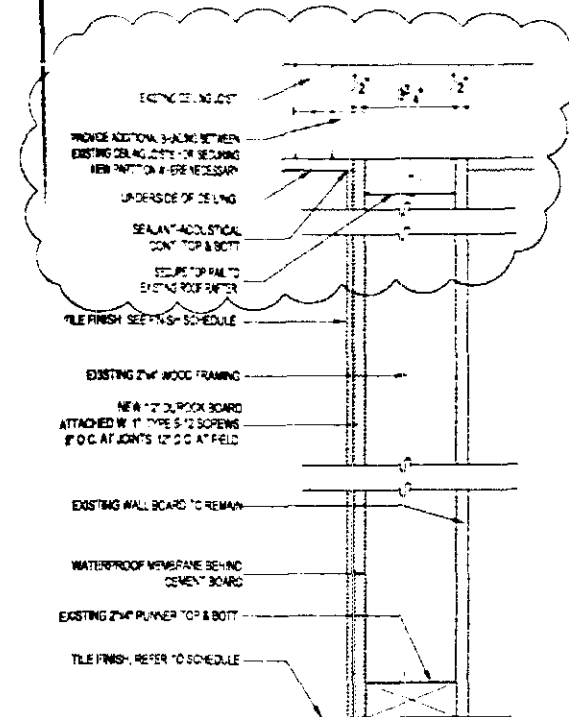
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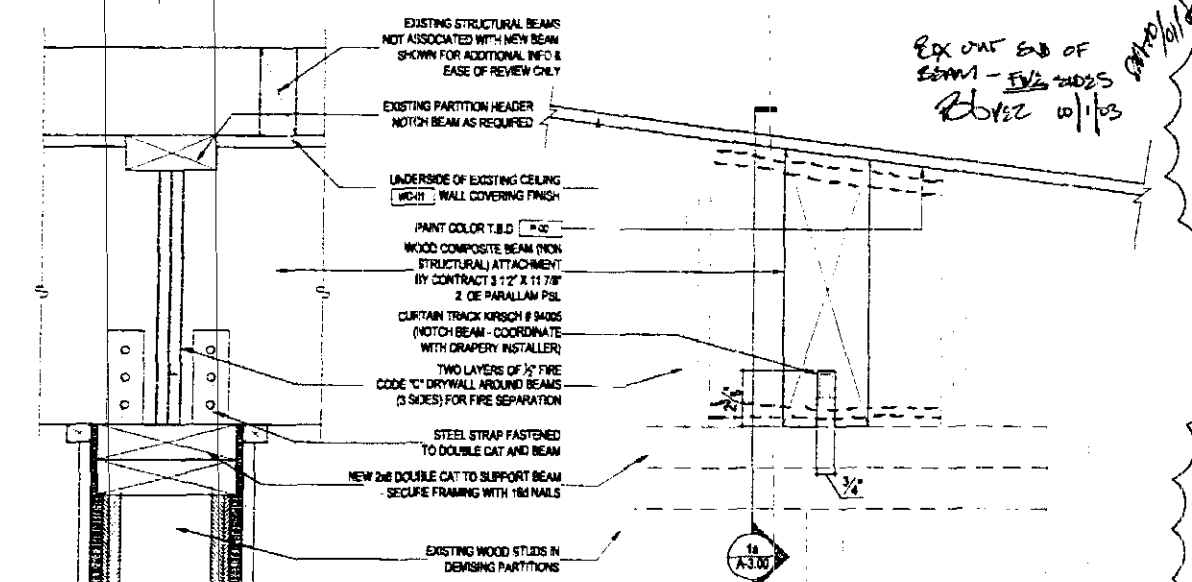
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SCALE: 3/4\"/>



B WALL SECTION
SCALE: 3/4\"/>

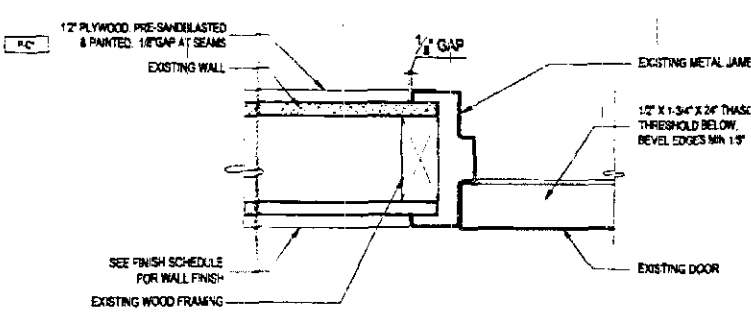


C WALL SECTION
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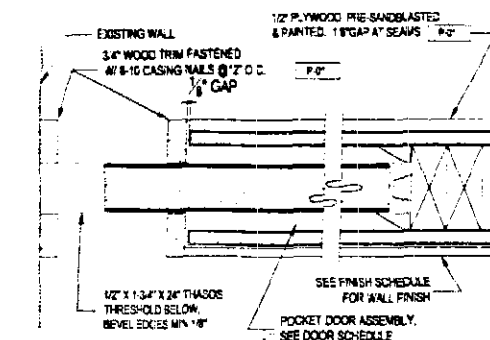


1a WOOD BEAM DETAIL
SCALE: 3/4\"/>

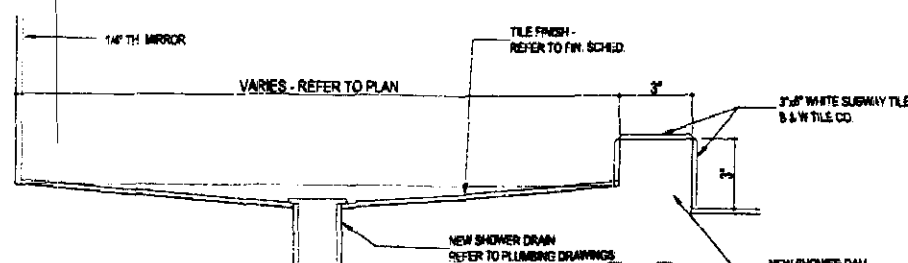
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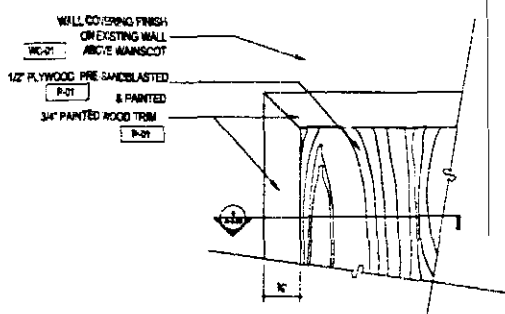
3 DOOR JAMB DETAIL
SCALE: 3/4\"/>




4 DOOR JAMB DETAIL
SCALE: 3/4\"/>



2 SHOWER FLOOR SECTION
SCALE: 3/4\"/>



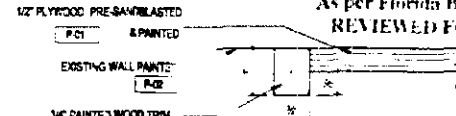5 DETAIL ELEVATION
SCALE: 6\"/>



6 DETAIL ELEVATION
SCALE: 6\"/>

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CITY OF MIAMI BEACH
APPROVED FOR PERMIT BY THE FOLLOWING:
BUILDING: *[Signature]*
ZONING: *[Signature]*
DRB/HPR: *[Signature]*
CONCURRENCY: *[Signature]*
PLUMBING: *[Signature]*
ELECTRICAL: *[Signature]*
MECHANICAL: *[Signature]*
FIRE PREVENTION: *[Signature]*
ENGINEERING: *[Signature]*
PUBLIC WORKS: *[Signature]*
STRUCTURAL: *[Signature]*
ACCESSIBILITY: *[Signature]*
ELEVATOR: *[Signature]*
As per Florida Building Code Section 104.5
REVIEWED FOR CODE COMPLIANCE

PROJECT ARCHITECT
ALISON SPEAR, A.I.A.
180 NE 39th St., Suite 222, Miami, FL 33137
305-438-1200 Fax 305-438-1221

SEAL
[Signature]
9/16/13

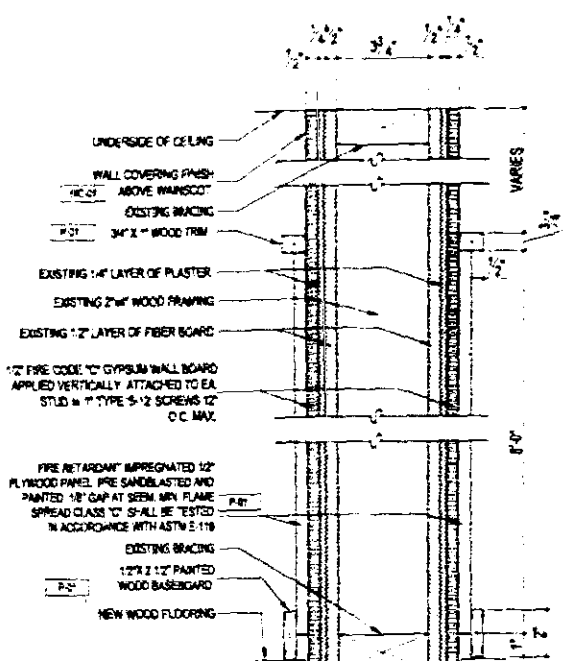
PROJECT TITLE
LIDO SPA HOTEL
WEST WING - RENOVATION
40 ISLAND AVENUE, MIAMI BEACH, FL 33139

DRAWING TITLE
TYPICAL ROOM DETAILS


DRAWN BY B.F.L.
CHECKED BY A.S.
ISSUES

PERMIT ISSUE
13 REV. SHOWN BLOCK DEPT. CHG.


SHEET NO.
A-3.00




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A-3.00 SCALE: 3/4" = 1'-0"

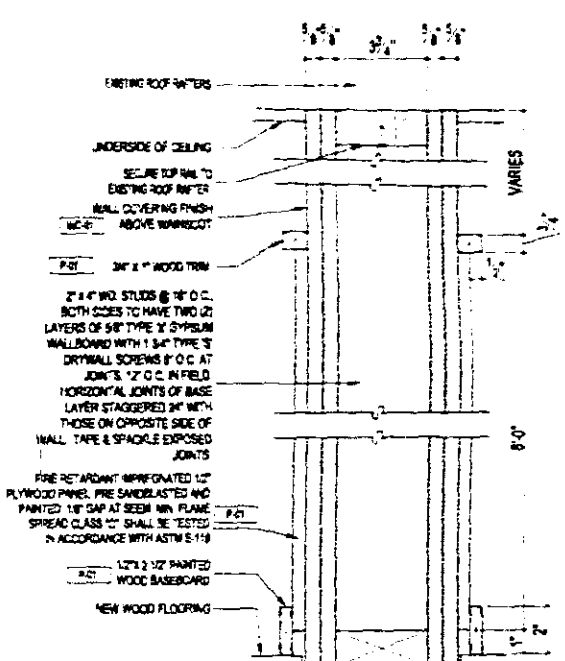

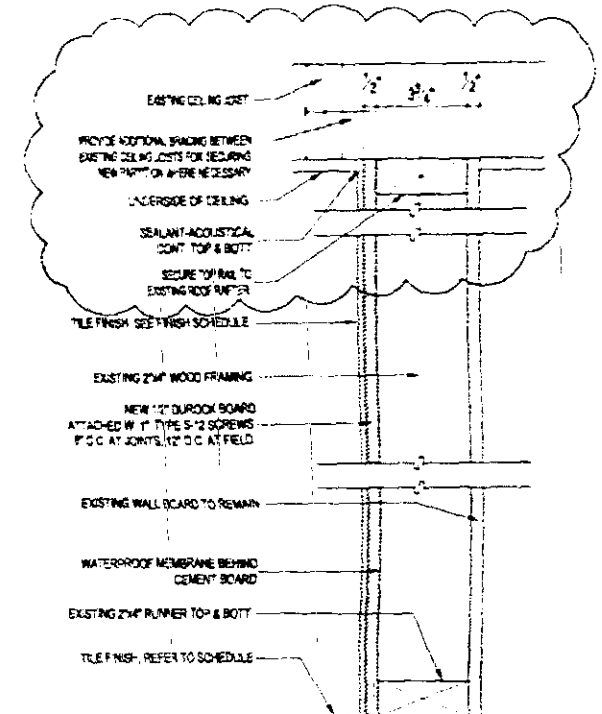B WALL SECTION
A-3.00 SCALE: 3/4" = 1'-0"




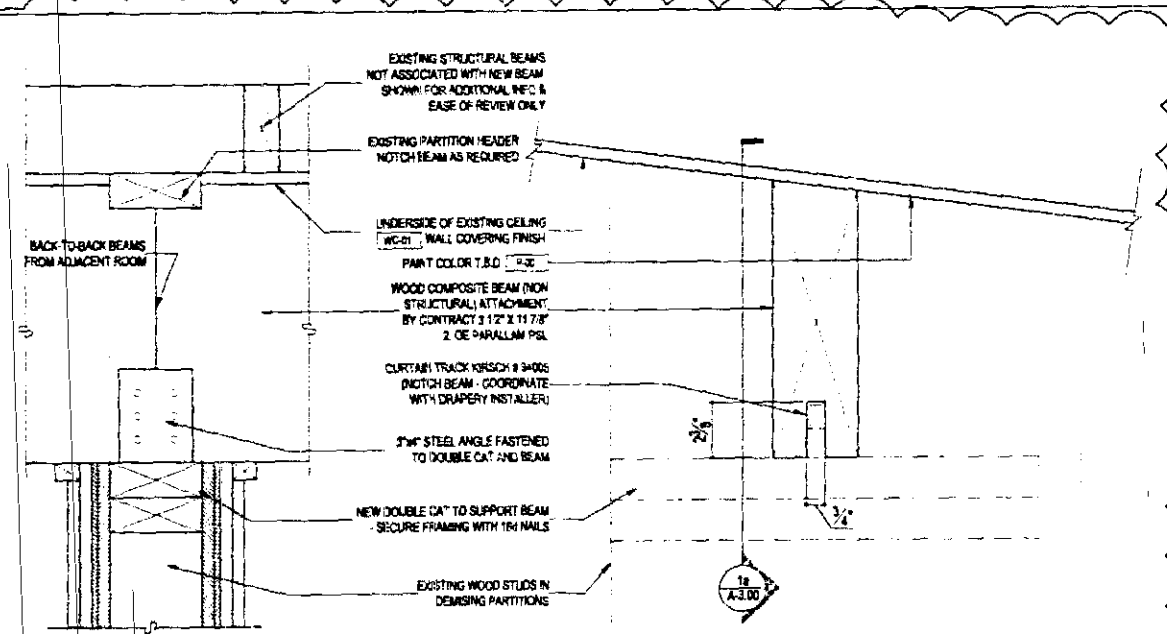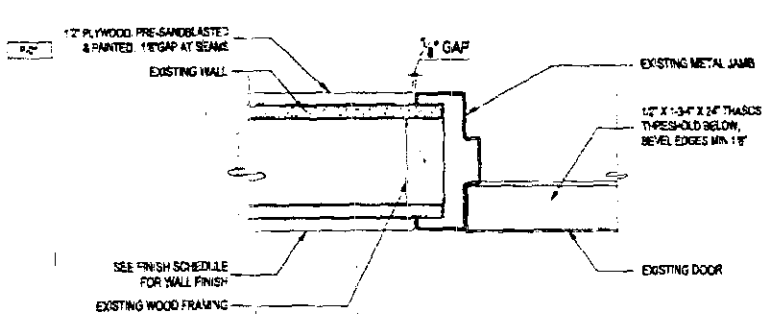C WALL SECTION
A-3.00 SCALE: 3/4" = 1'-0"

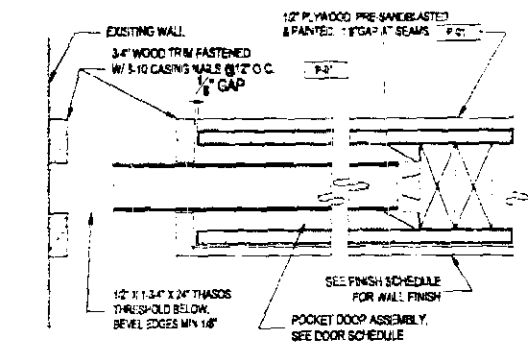


1a WOOD BEAM DETAIL
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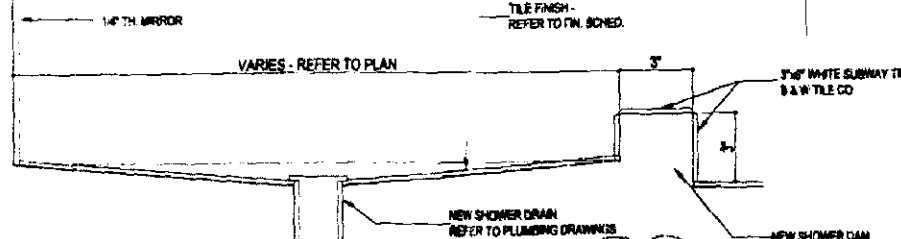
1 WOOD BEAM DETAIL
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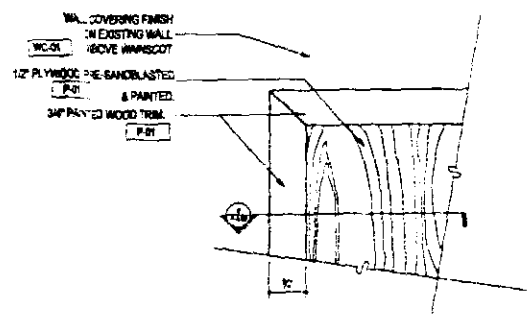
3 DOOR JAMB DETAIL
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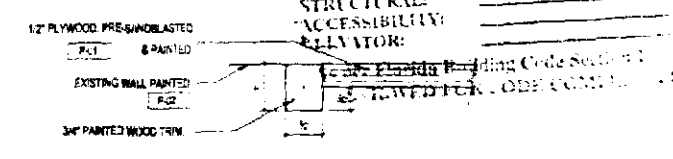
4 DOOR JAMB DETAIL
A-3.00 SCALE: 3/4" = 1'-0"



2 SHOWER FLOOR SECTION
A-3.00 SCALE: 3/4" = 1'-0"



5 DETAIL ELEVATION
A-3.00 SCALE: 6\"/>



6 DETAIL ELEVATION
A-3.00 SCALE: 6\"/>

CITY OF MIAMI BEACH
APPROVED FOR PERMIT BY THE FOLLOWING:

- BUILDING
- ZONING
- DR. H.P.B.
- CONCURRENCY
- PLUMBING
- ELECTRICAL
- MECHANICAL
- FIRE PREVENTION
- ENGINEERING
- PL. & E. WORKS
- STRUCTURAL
- ACCESSIBILITY
- ELEVATOR

PROJECT ARCHITECT
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SEAL
Alison Spear
8-27-03

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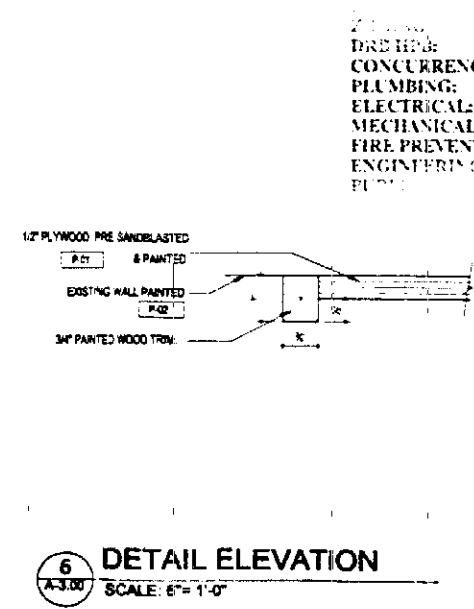
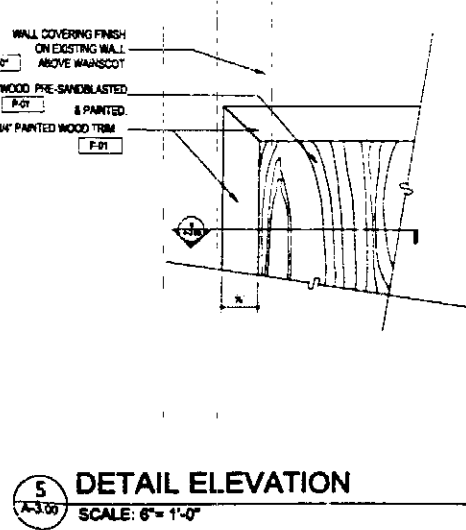
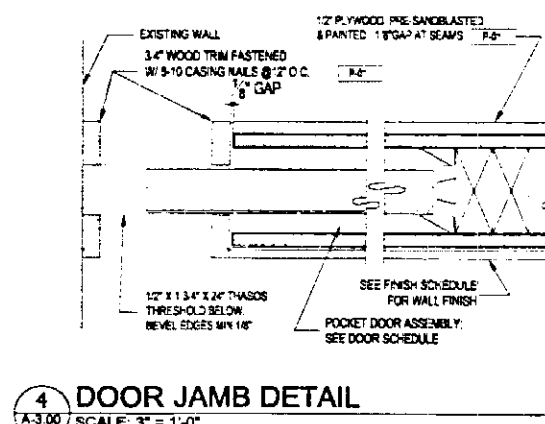
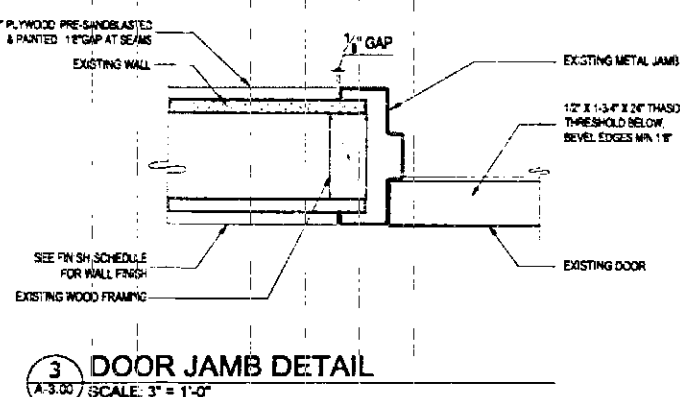
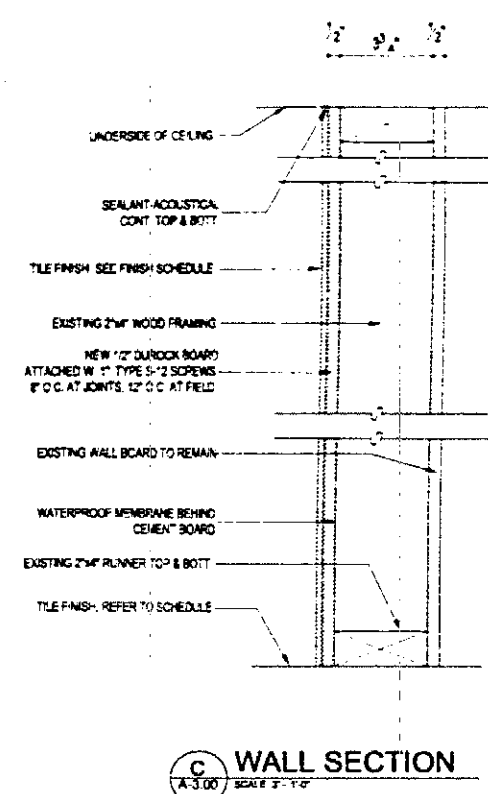
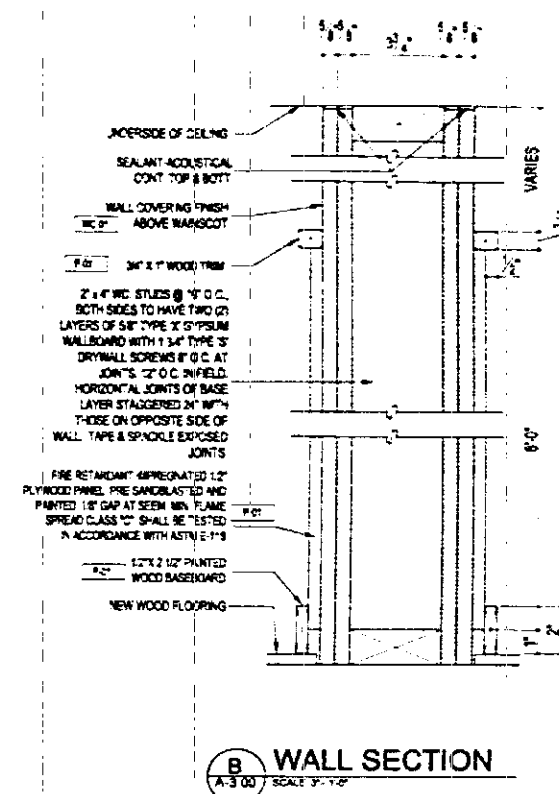
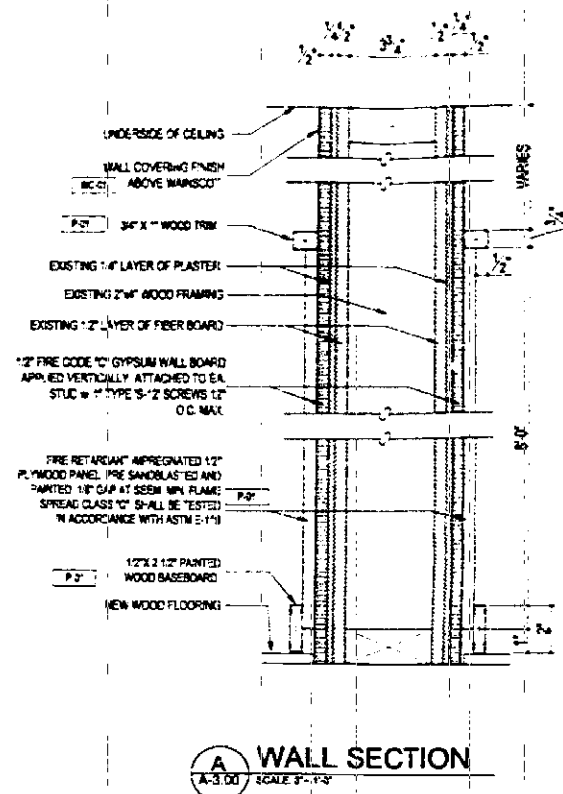
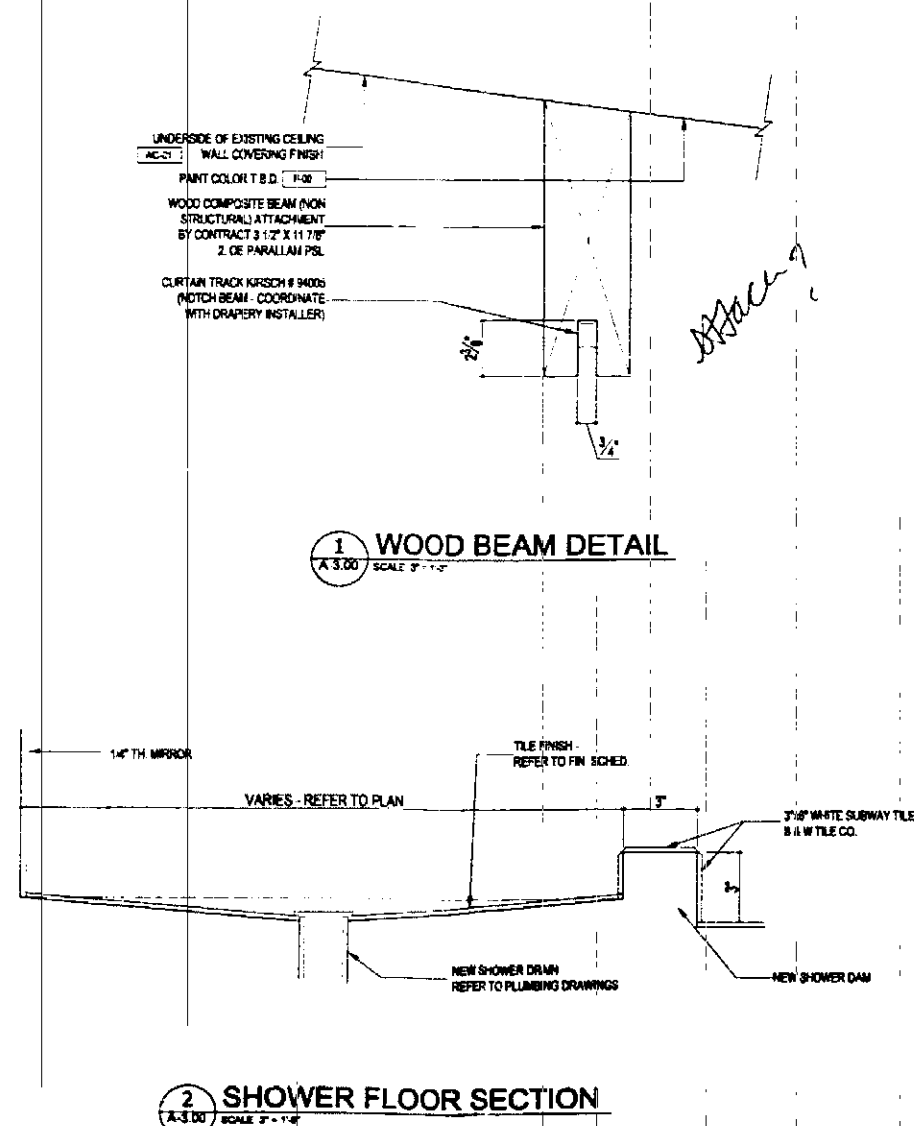
PROJECT TITLE
LIDO SPA HOTEL
WEST WING - RENOVATION
40 ISLAND AVENUE, MIAMI BEACH, FL 33139

DRAWING TITLE
TYPICAL ROOM DETAILS

DRAWN BY B.F.L.
CHECKED BY A.S.
ISSUES

01-23-03
02-27-03
03-27-03
04-27-03
05-27-03
06-27-03
07-27-03
08-27-03
09-27-03
10-27-03
11-27-03
12-27-03

SHEET NO.
A-3.00



2.1.1.1.1.1
DRO HUB
CONCURRENCY:
PLUMBING:
ELECTRICAL:
MECHANICAL:
FIRE PREVENTION:
ENGINEERING:
PLUMBING

PROJECT ARCHITECT
ALISON SPEAR, A.I.A.
180 NE 38th St., Suite 222, Miami, FL 33137
305-438-1200 fax 305-438-1221

PROJECT TITLE
LIDO SPA HOTEL
WEST WING - RENOVATION
40 ISLAND AVENUE, MIAMI BEACH, FL 33139

DRAWING TITLE
TYPICAL ROOM DETAILS

DRAWN BY B.F.L.
CHECKED BY A.S.
ISSUES
17-23-03 PERMIT ISSUE

SHEET NO.
A-3.00

ROOM FINISH SCHEDULE									
ROOM NAME	ROOM NO.	FINISH	FINISH	FINISH	FINISH	FINISH	FINISH	FINISH	FINISH
ROOM TYPE 1	101	WALL	CEILING	FLOOR	DOOR	DOOR	DOOR	DOOR	DOOR
ROOM TYPE 2	102	WALL	CEILING	FLOOR	DOOR	DOOR	DOOR	DOOR	DOOR
ROOM TYPE 3	103	WALL	CEILING	FLOOR	DOOR	DOOR	DOOR	DOOR	DOOR
ROOM TYPE 4	104	WALL	CEILING	FLOOR	DOOR	DOOR	DOOR	DOOR	DOOR
ROOM TYPE 5	105	WALL	CEILING	FLOOR	DOOR	DOOR	DOOR	DOOR	DOOR
ROOM TYPE 6	106	WALL	CEILING	FLOOR	DOOR	DOOR	DOOR	DOOR	DOOR
ROOM TYPE 7	107	WALL	CEILING	FLOOR	DOOR	DOOR	DOOR	DOOR	DOOR
ROOM TYPE 8	108	WALL	CEILING	FLOOR	DOOR	DOOR	DOOR	DOOR	DOOR
ROOM TYPE 9	109	WALL	CEILING	FLOOR	DOOR	DOOR	DOOR	DOOR	DOOR
ROOM TYPE 10	110	WALL	CEILING	FLOOR	DOOR	DOOR	DOOR	DOOR	DOOR

GA 6
78?

A FLUSH
B FLUSH-POCKET
C LOUVER

DOOR SCHEDULE									
DOOR NO.	LOCATION	TYPE	SIZE	FRAME	FINISH	REMARKS	CODE	DESCRIPTION	REMARKS
1	GUESTROOM ENTRANCE	A	3'0" x 7'0"	1'12"	W-3	J-3	1	1.2.5.16	
2	CLOSET BATHROOM	A	3'0" x 7'0"	1'12"	W-3	J-3	1	1.2.5.16	
3	CLOSET BATHROOM	B	3'0" x 7'0"	1'12"	W-3	J-3	1	1.2.5.16	
4	GUESTROOM ENTRANCE	A	3'0" x 7'0"	1'12"	W-3	J-3	1	1.2.5.16	
5	CLOSET BATHROOM	B	3'0" x 7'0"	1'12"	W-3	J-3	1	1.2.5.16	
6	CLOSET BATHROOM	C	3'0" x 7'0"	1'12"	W-3	J-3	1	1.2.5.16	
13	ROOMS 180, 238	C	3'0" x 7'0"	1'12"	W-3	J-3	1	1.2.5.16	
14	ROOMS 180, 238	C	3'0" x 7'0"	1'12"	W-3	J-3	1	1.2.5.16	
15	ROOMS 180, 238	C	3'0" x 7'0"	1'12"	W-3	J-3	1	1.2.5.16	
16	ROOMS 180, 238	C	3'0" x 7'0"	1'12"	W-3	J-3	1	1.2.5.16	

INTERIOR FINISH
Interior finish shall be in accordance with the following:
Class A interior finish shall be in accordance with the following:
Class B interior finish shall be in accordance with the following:
Class C interior finish shall be in accordance with the following:

Class A interior finish shall be in accordance with the following:
Class B interior finish shall be in accordance with the following:
Class C interior finish shall be in accordance with the following:

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Class C interior finish shall be in accordance with the following:

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Class C interior finish shall be in accordance with the following:

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Class B interior finish shall be in accordance with the following:
Class C interior finish shall be in accordance with the following:

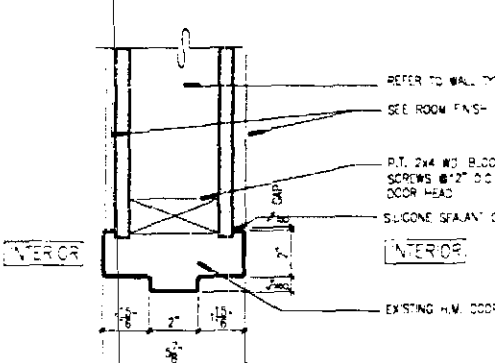
Class A interior finish shall be in accordance with the following:
Class B interior finish shall be in accordance with the following:
Class C interior finish shall be in accordance with the following:

Class A interior finish shall be in accordance with the following:
Class B interior finish shall be in accordance with the following:
Class C interior finish shall be in accordance with the following:

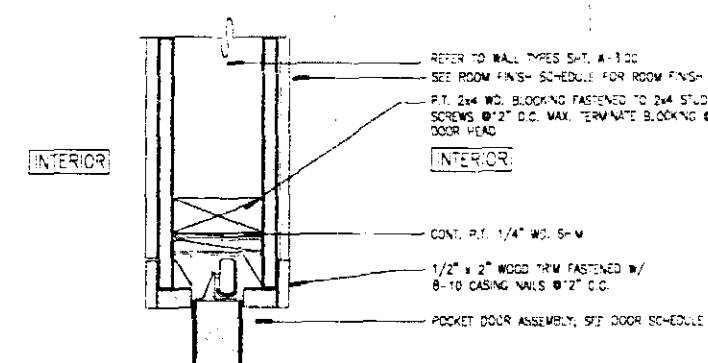
Class A interior finish shall be in accordance with the following:
Class B interior finish shall be in accordance with the following:
Class C interior finish shall be in accordance with the following:

Class A interior finish shall be in accordance with the following:
Class B interior finish shall be in accordance with the following:
Class C interior finish shall be in accordance with the following:

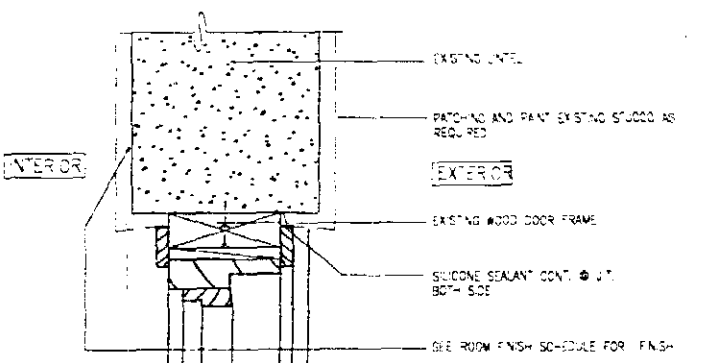
Class A interior finish shall be in accordance with the following:
Class B interior finish shall be in accordance with the following:
Class C interior finish shall be in accordance with the following:



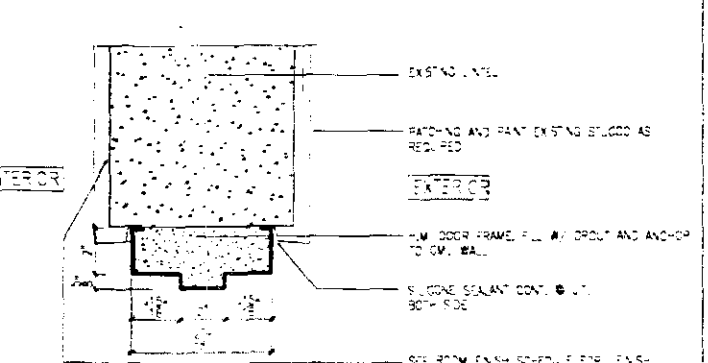
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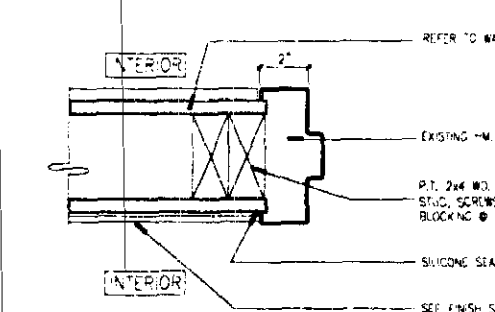
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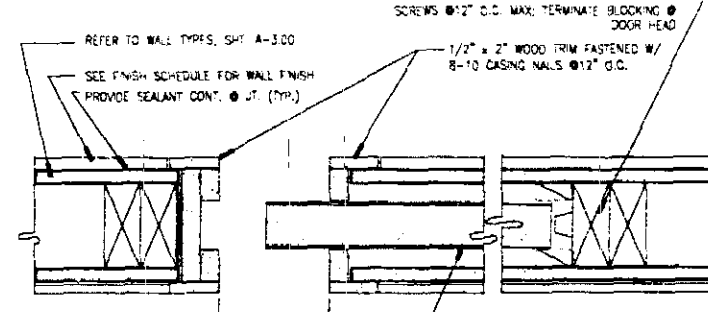
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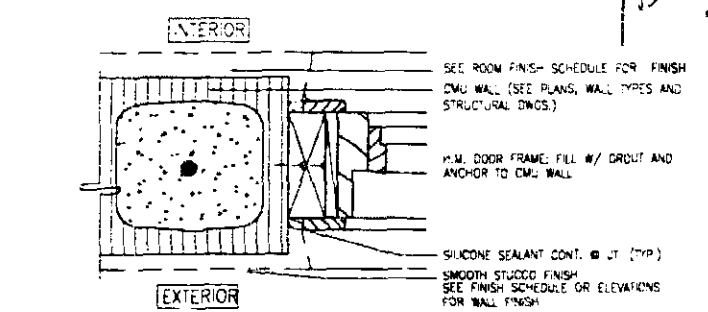
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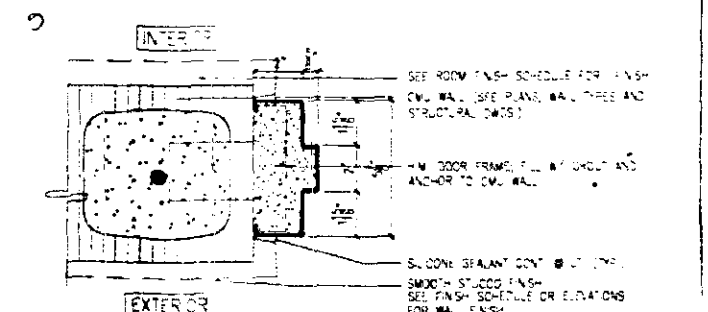
JAMB "J-1"



JAMB "J-2"



JAMB "J-3"



JAMB "J-4"

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305-438-1200 fax 305-438-1221

PROJECT ARCHITECT
ALISON SPEAR, AIA
AIA 0018660

CITY OF MIAMI BEACH
APPROVED FOR PERMIT BY
THE FOLLOWING:

BUILDING:
ZONING:
URB HBP:
CONCURRENCY:
PLUMBING:
ELECTRICAL:
MECHANICAL:
FIRE PREVENTION:
ENGINEERING:
PUBLIC WORKS:
STRUCTURAL:

PROJECT TITLE
LIDO SPA HOTEL
WEST WING - RENOVATION
40 ISLAND AVENUE, MIAMI BEACH, FL 33139

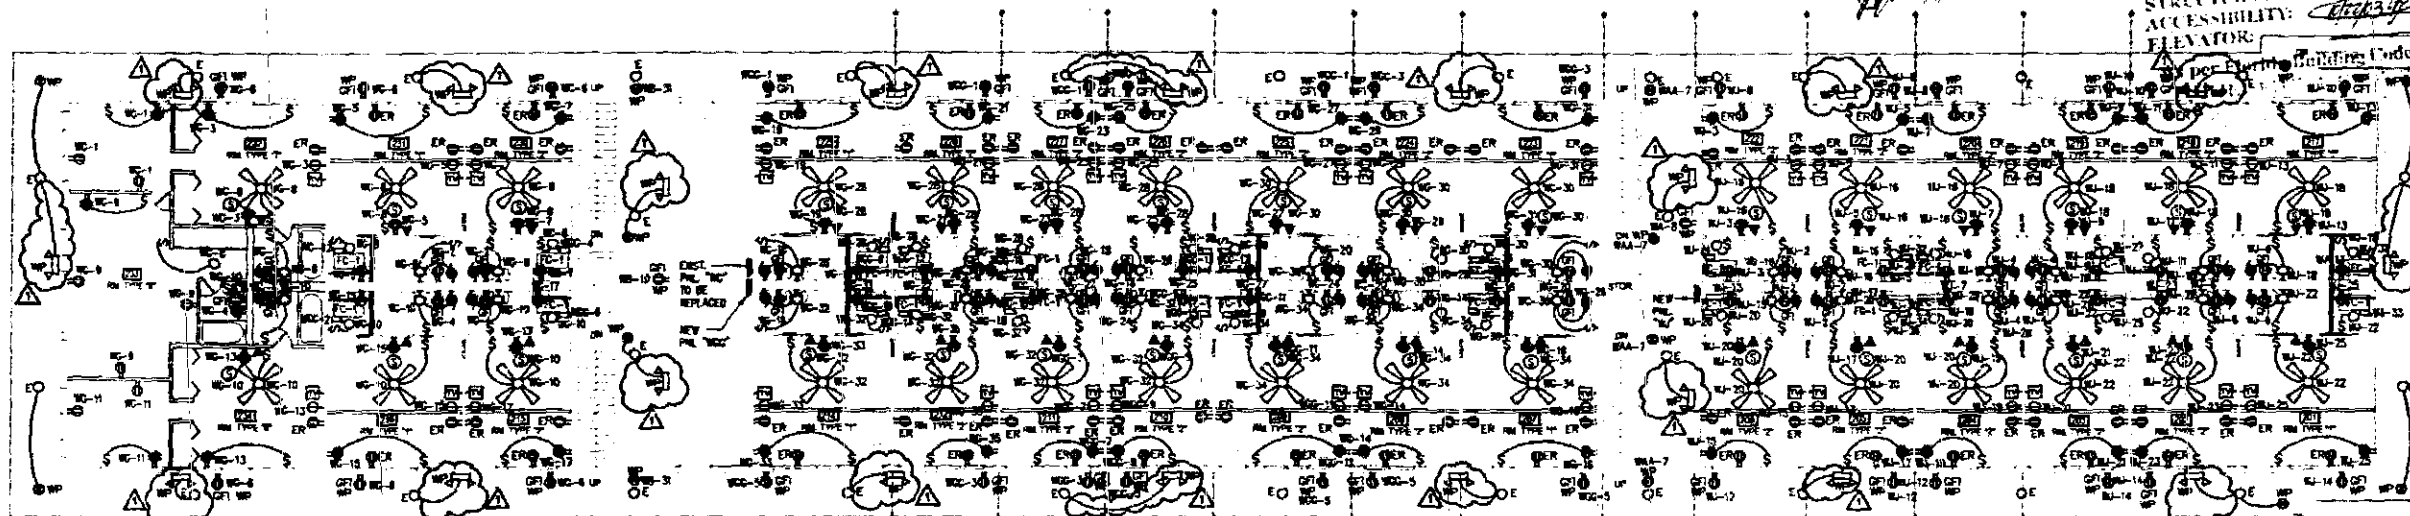
DRAWING TITLE
FINISH SCHEDULE,
DOOR SCHEDULE
& DETAILS

SHEET NO.
A-4.00

DRAWINGS ARE DIAGNOSTIC. DO NOT SCALE DRAWINGS FOR EXACT LOCATION OF EQUIPMENT. THESE DRAWINGS ARE NOT INTENDED TO SHOW EVERY MINOR DETAIL. HOWEVER, THE CONTRACTOR SHALL FURNISH AND INSTALL ALL ITEMS REQUIRED FOR A COMPLETE AND ACCEPTABLE WORKING INSTALLATION PER CODE.

-
- EXISTING MARKS
(1) BOA-SHUTTERED
TO BE REPLACED WITH
NEW DOOR PANELS
- CITY OF ALBANY
APPROVED FOR THE FOLLOWING
- REPLACE ALL EXISTING GENERAL USE MEDIAN SIGNS INSIDE GUEST ROOMS WITH BLANK PLATES HORIZONTAL AT EXISTING HEIGHTS

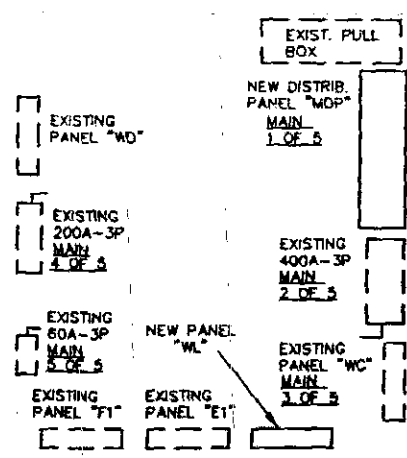
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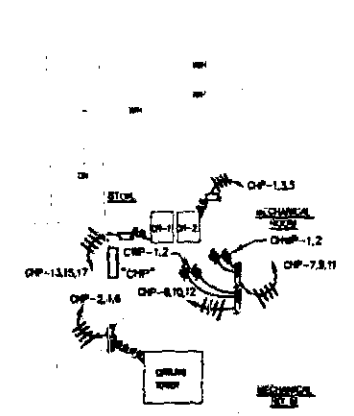
SCALE: 3/32" = 1'-0"

- ## ELECTRICAL SYMBOLS

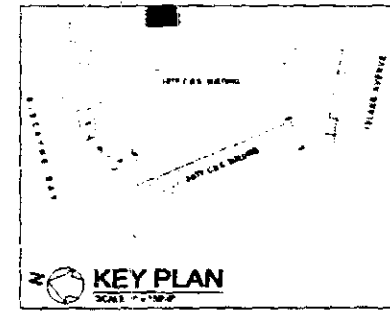
- DUPLX RECEPTACLE, 20A, 120V, GROUND. TYPE, WALL MTD., WITH GROUND FAULT INTERRUPT, 18" A.F.F. ABOVE A.F.F. ABOVE SWKS)
 - DUPLX RECEPTACLE, 20A, 120V, GROUND. TYPE, WALL MOUNTED, 18" A.F.F.
 - QUADRUPLX RECEPTACLE, 20A, 120V, GROUND. TYPE, WALL MTD., 18" A.F.F.
 - SAME AS ABOVE, BUT WEATHER PROOF
 - SINGLE RECEPTACLE, 20A, 120V, GROUND. TYPE, WALL MTD.
 - TV OUTLET, WALL MOUNTED
 - TELEPHONE OUTLET, WALL MTD.
 - LIGHTING SWITCH
 - CEILING MOUNTED LIGHTING FIXTURE OUTLET
 - WALL MOUNTED LIGHTING FIXTURE OUTLET
- PAIDOLF FAN**
- 120V SMOKE DETECTOR WITH BATTERY PACK
 - EXT. SIGN
 - EMERGENCY BATTERY PACK
 - ELECTRIC MOTOR
 - E EXISTING TO REMAIN
 - X EXISTING TO BE REPLACED



SCALE: 1/2"=1'-0"




WEST WING - 3RD FLR.



PROJ

PREPARED BY:

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Fax: (305) 383-9969
Email: uc@uciengeering.com
R.J. Miranda P.E. No. 35579
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Professional Electrical and
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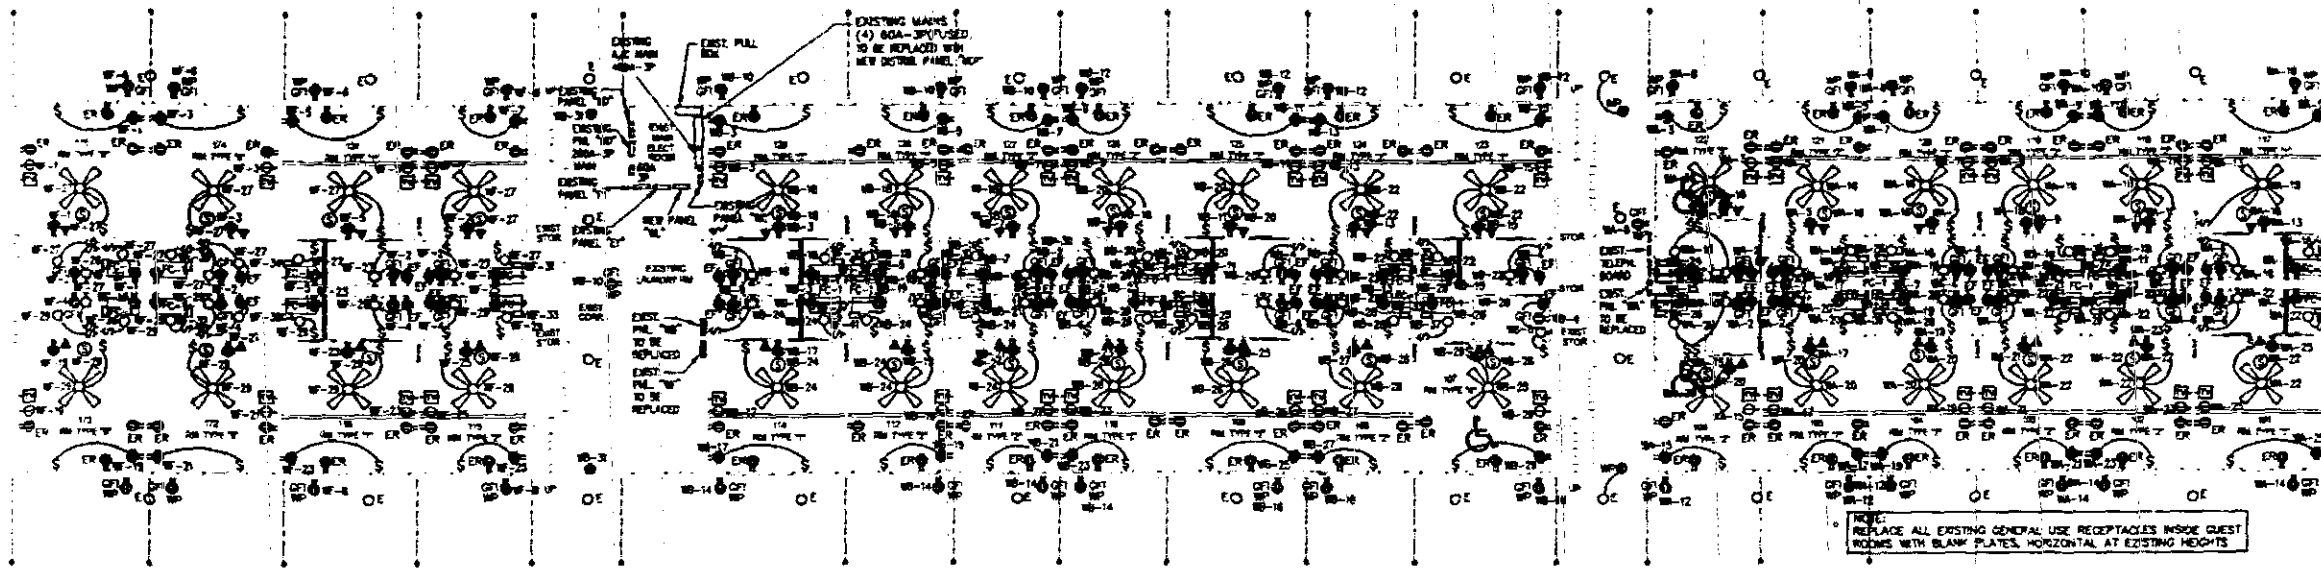
LIDO SPA HOTEL
WEST WING - RENOVATION
40 ISLAND AVENUE, MIAMI BEACH, FL 33139

**WEST WING
PROPOSED ELECTRICAL
FLOOR PLANS, NOTES
AND SYMBOLS**

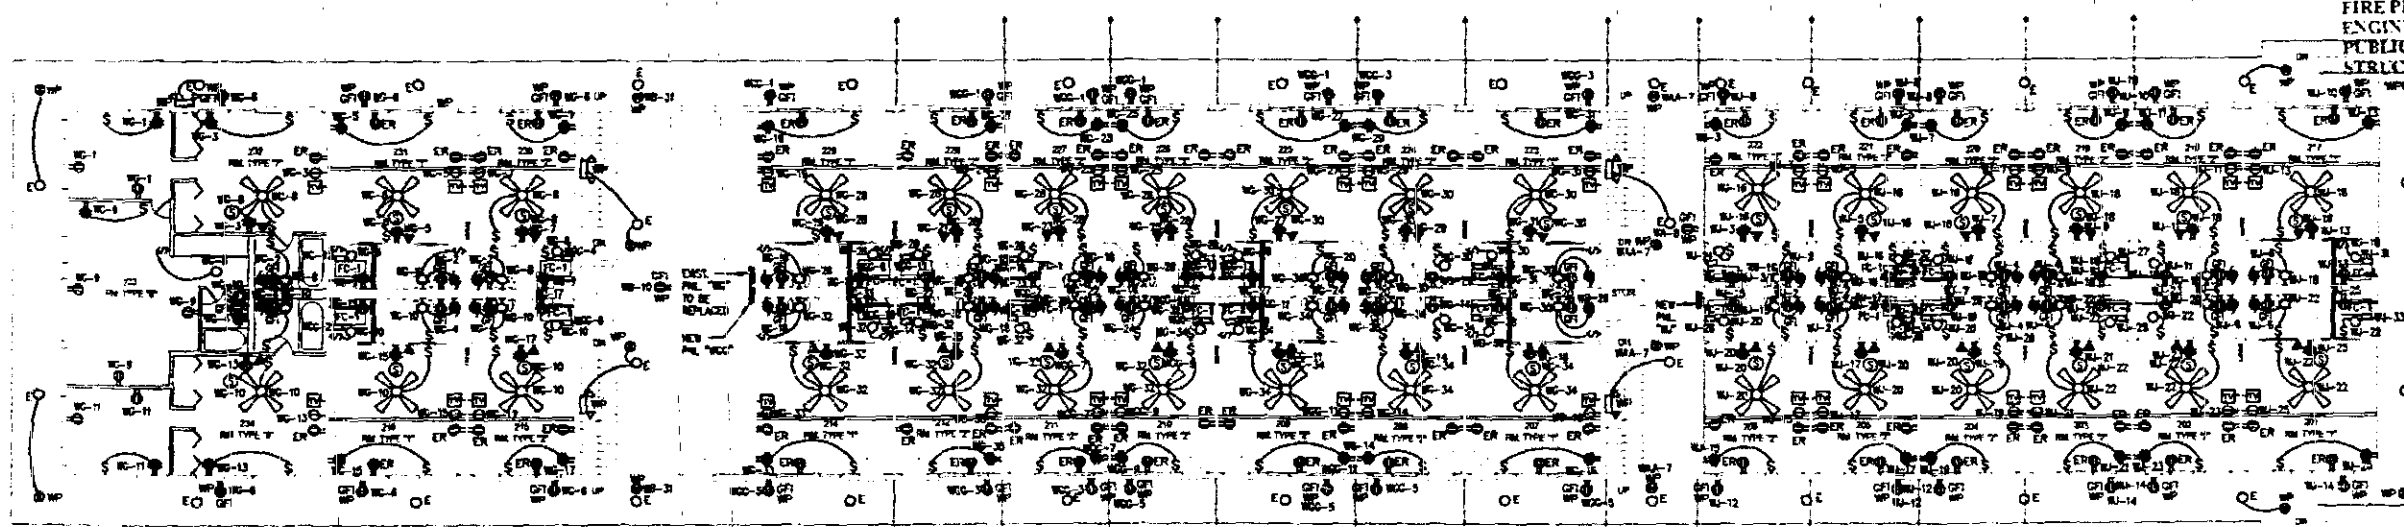
DRAWN BY C.P.
 CHECKED BY R.J.A.
 ISSUES
 13 ISSUE SA
 13 BLDG DPT CERM
 SHEET NO.
 E-1

ELECTRICAL GENERAL NOTES


1. DRAWINGS ARE DIAGRAMMATIC. DO NOT SCALE DRAWINGS FOR EXACT LOCATION OF EQUIPMENT. THESE DRAWINGS ARE NOT INTENDED TO SHOW EVERY MINOR DETAIL. HOWEVER, THE CONTRACTOR SHALL FURNISH AND INSTALL ALL ITEMS REQUIRED FOR A COMPLETE AND ACCEPTABLE WORKING INSTALLATION PER CODE.
2. ALL WORK SHALL BE DONE IN ACCORDANCE WITH THE LATEST EDITION OF THE NEC AND SHALL COMPLY WITH ALL LOCAL RULES AND ORDINANCES.
3. ALL MATERIAL SHALL BE NEW AND SHALL BEAR UL LABEL WHERE APPLICABLE. THE CONTRACTOR SHALL FURNISH ALL LABOR, MATERIALS AND EQUIPMENT FOR A COMPLETE INSTALLATION. ALL MOUNTING HARDWARE AND WIRING HARDWARE SHALL BE FURNISHED BY THE CONTRACTOR.
4. CIRCUITS SHOWN ON THESE PLANS ARE SYMBOLICALLY SHOWN TO SHOW PHYSICAL LOCATION OF CIRCUITS AND ROUTING OF CONDUITS TO SUIT JOB CONDITIONS. THE LOADS SHALL BE BALANCED THROUGHOUT. CONTRACTOR SHALL ENSURE THAT NEUTRAL WIRES AND EQUIPMENT GROUND WIRES ARE INSTALLED WHERE EVER APPLICABLE.
5. THE CONTRACTOR SHALL BE RESPONSIBLE FOR COORDINATING WITH THE POWER UTILITY TO OBTAIN TEMPORARY POWER DURING CONSTRUCTION. THE CONTRACTOR SHALL IMMEDIATELY CONTACT THE POWER UTILITY TO SCHEDULE INSTALLATION OF TEMPORARY POWER SO THAT CONSTRUCTION DELAYS ARE AVOIDED.
6. THE CONTRACTOR SHALL COORDINATE WITH THE POWER UTILITY TO OBTAIN PERMIT TO POWER IN ACCORDANCE WITH THE PERMITS. THE CONTRACTOR SHALL IMMEDIATELY CONTACT THE POWER UTILITY TO SCHEDULE THE INSTALLATION OF PERMANENT POWER SO THAT DELAYS ARE AVOIDED. IT IS THE CONTRACTOR'S RESPONSIBILITY TO CONTACT THE POWER UTILITY EARLY ON TO IDENTIFY ANY ISSUES AFFECTING PERMANENT POWER SERVICE AND TO WORK TOWARDS RESOLVING ANY ISSUES DELAYING INSTALLATION.
7. THE CONTRACTOR SHALL COORDINATE WITH THE TELEPHONE COMPANY TO OBTAIN PERMIT TO POWER IN ACCORDANCE WITH THE PERMITS. THE CONTRACTOR SHALL IMMEDIATELY CONTACT THE TELEPHONE COMPANY TO SCHEDULE INSTALLATION OF TELEPHONE SERVICE. IT IS THE CONTRACTOR'S RESPONSIBILITY TO CONTACT THE TELEPHONE COMPANY EARLY ON TO IDENTIFY ANY ISSUES AFFECTING TELEPHONE SERVICE AND TO WORK TOWARDS RESOLVING ANY ISSUES DELAYING INSTALLATION.
8. IF APPLICABLE, THE CONTRACTOR SHALL COORDINATE WITH THE CABLE TV COMPANY IN THE SAME MANNER AS DESCRIBED IN PARAGRAPHS 6 AND 7 FOR POWER AND TELEPHONE UTILITIES.
9. IF ANY OR ALL OF THE UTILITIES (ELECTRICAL, TELEPHONE, CATV) ARE EXISTING, THE CONTRACTOR SHALL BE RESPONSIBLE FOR BECOMING FAMILIAR WITH THE EXISTING SYSTEMS PRIOR TO BID. THE CONTRACTOR SHALL TRACE DOWN ALL CIRCUITS AND WIRING AND SHALL VERIFY THAT CAPACITY IS AVAILABLE FOR THE SCOPE OF THE PROJECT. THE CONTRACTOR SHALL FIELD INSPECT ALL EXISTING EQUIPMENT AND SHALL ENSURE THAT ALL RATINGS, FUSES, ENCLOSURES, ETC. ARE PROPER FOR THE SCOPE OF THE PROJECT. THE CONTRACTOR SHALL INSPECT ANY EQUIPMENT, WIRING ETC. THAT IS REQUESTED AND SHALL GUARANTEE THE PERFORMANCE OF SUCH EQUIPMENT FOR ONE YEAR. THE CONTRACTOR SHALL REPLACE ANY EQUIPMENT THAT IS DAMAGED OR IN POOR CONDITION. A LIST OF EQUIPMENT IDENTIFIED FOR REPLACEMENT SHALL BE PROVIDED TO THE OWNER (OR THE OWNER'S REPRESENTATIVE) AND THE ENGINEER PRIOR TO REPLACEMENT.
10. THE CONTRACTOR SHALL THOROUGHLY REVIEW THESE DRAWINGS AND SHALL VISIT AND BECOME FAMILIAR WITH THE JOB SITE AND ALL EXISTING CONDITIONS PRIOR TO BID. DISCREPANCIES OR PERCEIVED AMBIGUITIES SHALL BE DISCUSSED WITH THE ENGINEER PRIOR TO BID.
11. ELECTRICAL DESIGN IS BASED ON THE BEST AVAILABLE INFORMATION. THE CONTRACTOR SHALL REVIEW MANUFACTURER DATA AND MANUFACTURER SUPPLIED LITERATURE FOR ALL EQUIPMENT PRIOR TO BID. THE CONTRACTOR SHALL CHECK ALL ELECTRICAL WIRING, INCLUDING VOLTAGE, PHASE AND RATING OF THE PANELS, SHALL BE CLEARLY IDENTIFIED ON THE INSIDE DOOR. THE CONTRACTOR SHALL PROVIDE ALL NECESSARY INFORMATION NEEDED TO SATISFY THAT LIFE SAFETY SYSTEMS ARE TO LOCAL CODE ACCEPTANCE.
12. ALL CONDUCTORS SHALL BE COPPER WITH THIN INSULATION.
13. ALL PANELS SHALL BE CLEARLY LABELED ON THE OUTSIDE FOR QUICK IDENTIFICATION. ALL CIRCUITS IN ALL PANELS SHALL BE CLEARLY IDENTIFIED AND SHALL APPEAR WITH COMPLETE INFORMATION (DESCRIPTION OF CIRCUIT, BREAKER SIZE, NUMBER OF POLES AND BREAKER POSITION) ON THE REAR OF THE PANEL. IN ADDITION, THE VOLTAGE, PHASE AND RATING OF THE PANEL SHALL BE CLEARLY IDENTIFIED ON THE INSIDE DOOR. THE CONTRACTOR SHALL PROVIDE ALL NECESSARY INFORMATION NEEDED TO SATISFY THAT LIFE SAFETY SYSTEMS ARE TO LOCAL CODE ACCEPTANCE.
14. PLANS SHOWING AS-BUILT CHANGES SHALL BE DELIVERED TO THE OWNER'S REPRESENTATIVE UPON COMPLETION OF WORK.
15. IT IS THE RESPONSIBILITY OF THE CONTRACTOR TO MAKE THIS INSTALLATION IN COMPLIANCE WITH ALL FIRE PREVENTION CODES. THE CONTRACTOR SHALL COORDINATE WITH THE FIRE DEPARTMENT AND THE FIRE INSURANCE COMPANY PRIOR TO BID. THE CONTRACTOR SHALL COORDINATE WITH THE FIRE DEPARTMENT AND THE FIRE INSURANCE COMPANY PRIOR TO BID.
16. ALL SERVICE ENTRANCE EQUIPMENT IS TO BE RATED AT 100,000 ATC UNLESS OTHERWISE NOTED. TO PROVIDE SERVICE ENTRANCE EQUIPMENT WITH LOWER RATINGS THE CONTRACTOR SHALL PROVIDE IN WRITING INFORMATION FROM THE POWER UTILITY VERIFYING THAT CALCULATED FAULT CURRENTS ARE AT AN ACCEPTABLE LEVEL TO ACCOMMODATE THE LOWER RATED EQUIPMENT. IF SERVICE ENTRANCE EQUIPMENT IS EXISTING, THE CONTRACTOR SHALL VERIFY THAT ATC RATINGS OF EXISTING EQUIPMENT ARE PROPER. THE CONTRACTOR SHALL COORDINATE WITH THE POWER UTILITY AND THE ENGINEER PRIOR TO BID.
17. ALL OUTSIDE EQUIPMENT, OUTLETS, LIGHTING FIXTURES, ENCLOSURES, ETC. SHALL BE WEATHERPROOF.
18. THE CONTRACTOR SHALL PROVIDE ALL REQUIRED CONNECTIONS FOR ALL OTHER TRADES.
19. THE CONTRACTOR SHALL OBTAIN ALL PERMITS FOR WORK UNDER THIS CONTRACT.
20. THE NUMBER, EXACT LOCATION AND MOUNTING HEIGHTS OF ALL OUTLETS, LIGHTS AND ELECTRICAL FIXTURES SHALL BE DETERMINED BY THE OWNER AND ARCHITECT. THE CONTRACTOR SHALL VERIFY ALL NUMBERS AND LOCATIONS WITH ARCHITECT AND OWNER PRIOR TO BID AND TO INSTALLATION.
21. THE CONTRACTOR SHALL PROVIDE ROUTING FOR ALL FLOOR MOUNTED OUTLETS AND OTHER LOADS AND CONNECTIONS NOT REACHING ACCESSIBLE VIA WALL OR CEILING. THE CONTRACTOR SHALL COORDINATE WITH ARCHITECT AND OWNER TO DETERMINE THE METHOD TO SERVE SUCH LOADS (I.E. TRENCHING, CORE AND BORING, POWER POLE, ETC.) PRIOR TO BID.
22. ALL RACEWAYS AND PIPES PLACED IN OR THROUGH ANY CONCRETE SLAB SHALL BE SPACED A MINIMUM OF THREE DIAMETERS OF THE LARGEST CONDUIT OR PIPE OF ANY OTHER SERVICE.
23. ALL RACEWAYS UNDERGROUND AND/OR LARGER THAN 2 INCHES IN DIAMETER SHALL BE GALVANIZED RIGID STEEL. PVC SCH 40 WILL BE ACCEPTABLE IF APPROVED BY LOCAL REGULATIONS CONTRACTOR TO VERIFY. ALL OTHER RACEWAYS 2" AND SMALLER IN DIAMETER MAY BE ENT.
24. OUTLET BOXES SHALL BE PRESSED STEEL IN DRY LOCATIONS AND CAST ALLOY WITH THREADED NUTS IN WET OR DAMP LOCATIONS.
25. DISCONNECT SWITCHES SHALL BE HORSEPOWER RATED, HEAVY DUTY, QUICK MAKE, QUICK BREAK. IN NEMA 1 OR NEMA 3R ENCLOSURES AS REQUIRED BY EXPOSURE.
26. THE ELECTRICAL SYSTEM SHALL BE COMPLETELY AND EFFECTIVELY GROUNDING PER REQUIREMENTS AND STATE AND LOCAL CODE REQUIREMENTS.



WEST WING - GROUND FLOOR - PROPOSED FLOOR PLAN



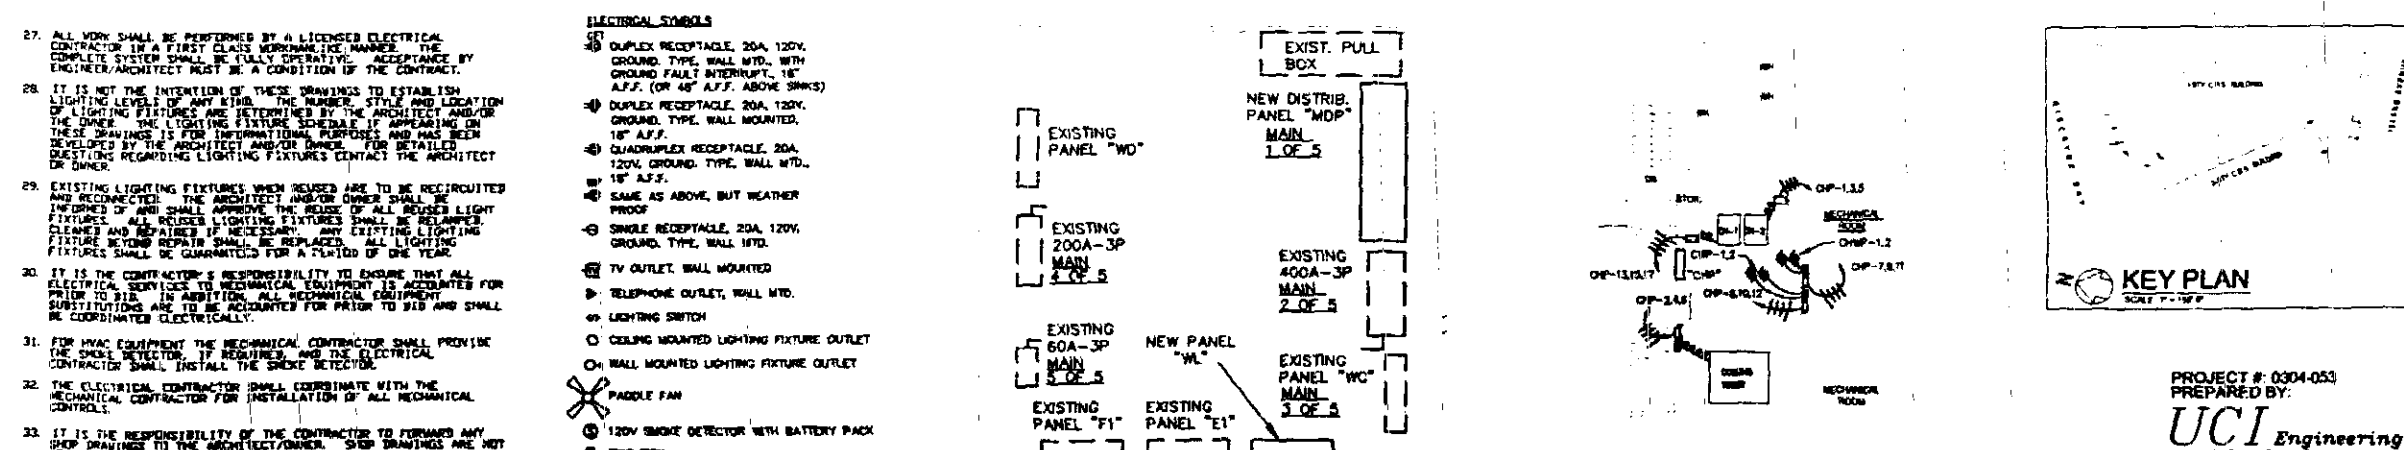WEST WING - SECOND FLOOR - PROPOSED FLOOR PLAN



WEST WING ELECT. ROOM

WEST WING - 3RD FLR.

BUILDING:
ZONING:
DRB/HPR:
CONCURRENCE:
PLUMBING:
ELECTRICAL:
MECHANICAL:
FIRE PREVENTION:
ENGINEERING:
PUBLIC WORKS:
STRUCTURAL:

APPROVED FOR PERMIT BY THE FOLLOWING:

ALISON SPEAR, A.I.A.
180 NE 38th St., SUITE 222, MIAMI, FL 33137
305-438-1200 fax 305-438-1221

LIDO SPA HOTEL
WEST WING - RENOVATION
40 ISLAND AVENUE, MIAMI BEACH, FL 33139

WEST WING
PROPOSED ELECTRICAL
FLOOR PLANS, NOTES
AND SYMBOLS

DRAWN BY C.P.
CHECKED BY R.J.M.
ISSUES

SHEET NO.

E-1

PROJECT # 0304-053
PREPARED BY:
UCI Engineering Inc.
13780 S.W. 31st Street, Suite 216
Miami, Florida 33175
Tel: (305) 382-8888
Fax: (305) 382-8888
E-MAIL: uci@ucieng.com
A. MIRANDA P.E. NO. 35579
DAVID A. BELSKY P.E. NO. 37239
Professional Electrical/Mechanical

NEW ELECTRICAL PANEL SCHEDULE "WA"										
TYPE		AQ. GE	14,000 AIC		MAINS		M.L.O.			
MOUNTING: FLUSH						BUS RATING:		125 AMP		
LOCATION: GROUND FLOOR CORRIDOR - SOUTH SIDE						VOLTAGE:		208Y/120V-3PHASE-4W		
DESCRIPTION	WIRE & COND. SIZE	LOAD (V.A.)	POLE TRIP	Ckt No.	A B C	Ckt No.	POLE TRIP	LOAD (V.A.)	WIRE & COND. SIZE	DESCRIPTION
EXIST. ICE MACH.	EXISTING	800	20	1		2	20	720	#12 - 1/2"	RMS. BATH GFI REC.
ROOM 122 RECEPT.	#12 - 1/2"	1,080	20	3		4	20	720	#12 - 1/2"	RMS. BATH GFI REC.
ROOM 121 RECEPT.	#12 - 1/2"	1,080	20	5		6	20	720	#12 - 1/2"	RMS. BATH GFI REC.
ROOM 120 RECEPT.	#12 - 1/2"	1,080	20	7		9	20	720	#12 - 1/2"	EXTER. GFI REC.
ROOM 119 RECEPT.	#12 - 1/2"	1,080	20	9		10	20	540	#12 - 1/2"	EXTER. GFI REC.
ROOM 118 RECEPT.	#12 - 1/2"	1,080	20	11		12	20	720	#12 - 1/2"	EXTER. GFI REC.
ROOM 117 RECEPT.	#12 - 1/2"	1,080	20	13		14	20	540	#12 - 1/2"	EXTER. GFI REC.
ROOM 106 RECEPT.	#12 - 1/2"	1,080	20	15		16	20	900	#12 - 1/2"	ROOMS. LIGHTS
ROOM 105 RECEPT.	#12 - 1/2"	1,080	20	17		18	20	900	#12 - 1/2"	ROOMS. LIGHTS
ROOM 104 RECEPT.	#12 - 1/2"	1,080	20	19		20	20	900	#12 - 1/2"	ROOMS. LIGHTS
ROOM 103 RECEPT.	#12 - 1/2"	1,080	20	21		22	20	900	#12 - 1/2"	ROOMS. LIGHTS
ROOM 102 RECEPT.	#12 - 1/2"	1,080	20	23		24	20	1,350	#12 - 1/2"	FC-1
ROOM 101 RECEPT.	#12 - 1/2"	1,080	20	25		26	20	1,350	#12 - 1/2"	FC-1
FC-1	#12 - 1/2"	1,350	20	27		28	20	1,350	#12 - 1/2"	FC-1
FC-1	#12 - 1/2"	1,350	20	29		30	20	1,350	#12 - 1/2"	FC-1
FC-1	#12 - 1/2"	1,350	20	31		32	20	1,350	#12 - 1/2"	FC-1
FC-1	#12 - 1/2"	1,350	20	33		34	20	1,350	#12 - 1/2"	FC-1
SPACE				35		36	20	1,350	#12 - 1/2"	FC-1
SPACE				37		38	20	1,350	#12 - 1/2"	FC-1
SPACE				39		40				SPACE
SPACE				41		42				SPACE

GENERAL LIGHTING AND RECEPTABLES LOAD = 21,780 VA

DEMAND LOAD FOR GENERAL LIGHTING AND RECEPTABLES (TABLE 220-11, N.E.C.)

FIRST 20,000 VA @ 50% = 10,000 VA

1,780 VA @ 40% = 712 VA

TOTAL DEM. LOAD = 10,712 VA

OTHER LOAD = 16,200 VA

TOTAL CONN. LOAD = 26,912 VA

TOTAL LOAD: 26,912 VA

AMPS: 75

NEW ELECTRICAL PANEL SCHEDULE "WF"											
TYPE: AQ, GE		14,000 AIC		MAINS BUS RATING:		M.L.O.					
MOUNTING: FLUSH						225 AMP					
LOCATION: GROUND FLOOR CORRIDOR - SOUTH SIDE						208Y/120V-3PHASE-4W					
DESCRIPTION	WIRE & COND. SIZE	LOAD (V.A.)	POLE TRIP	CKT. No.	A	B	C	POLE TRIP	LOAD (V.A.)	WIRE & COND. SIZE	DESCRIPTION
ROOM 175 RECEPT.	#12 - 1/2"	1,080	20	1				2	20	#12 - 1/2"	RMS. BATH GFI REC.
ROOM 174 RECEPT.	#12 - 1/2"	1,080	20	3				4	20	#12 - 1/2"	RMS. BATH GFI REC.
ROOM 131 RECEPT.	#12 - 1/2"	1,080	20	5				6	20	#12 - 1/2"	EXTER. GFI REC.
EXIST. DRYER #3	EXISTING	1,000	20	7				8	20	#12 - 1/2"	EXTER. GFI REC.
ROOM 119 RECEPT.	#12 - 1/2"	1,080	20	9				10	20	1,000	EXISTING
ROOM 118 RECEPT.	#12 - 1/2"	1,080	20	11				12	20	#12 - 1/2"	EXTER. GFI REC.
EXIST. WASHER #3	EXISTING	3,000	20	13				14	3		
			20	15				16		3,000	EXISTING
			20	17				18	20		
ROOM 173 RECEPT.	#12 - 1/2"	1,080	20	19				20	3		
ROOM 172 RECEPT.	#12 - 1/2"	1,080	20	21				22		3,000	EXISTING
ROOM 116 RECEPT.	#12 - 1/2"	1,080	20	23				24	20		
ROOM 115 RECEPT.	#12 - 1/2"	1,080	20	25				26	20	1,350	#12 - 1/2"
ROOMS LIGHTS	#12 - 1/2"	1,200	20	27				28	20	1,350	#12 - 1/2"
ROOMS LIGHTS	#12 - 1/2"	1,200	20	29				30	20	1,350	#12 - 1/2"
FC-1	#12 - 1/2"	1,350	20	31				32	20	1,350	#12 - 1/2"
FC-1	#12 - 1/2"	1,350	20	33				34	20	1,350	#12 - 1/2"
FC-1	#12 - 1/2"	1,350	20	35				36	20	1,350	#12 - 1/2"
FC-1	#12 - 1/2"	1,350	20	37				38			SPACE
FC-1	#12 - 1/2"	1,350	20	39				40			SPACE
FC-1	#12 - 1/2"	1,350	20	41				42			SPACE
TOTAL LOAD:										35,900 VA	
DEMAND LOAD:										99.72	
GENERAL LIGHTING AND RECEPTABLES LOAD = 15,000 VA											
DEMAND LOAD FOR GENERAL LIGHTING AND RECEPTABLES (TABLE 220-11, N.E.C.)											
15,000 VA @ 50% = 7,500 VA											
OTHER LOAD = 28,400 VA											
TOTAL CONN. LOAD = 35,900 VA											

NEW ELECTRICAL PANEL SCHEDULE "CHP"										
TYPE	CCB, GE		65,000 A.I.C.			MAINS : 350 AMP MAIN CIRCUIT BREAKER				
MOUNTING	SURFACE					BUS RATING : 400 AMP				
LOCATION	MECHANICAL ROOM					VOLTAGE : 208Y/120V-3PHASE-4WIRE-5/				
DESCRIPTION	WIRE & COND. SIZE	LOAD (V.A.)	POLE TRIP	CT. No.	A B C	CT. No.	POLE TRIP	LOAD (V.A.)	WIRE & COND. SIZE	DESCRIPTION
CHILLER #1	#3 IN 1-1/4"	24,840	3	1		2	3	6,300	#10 - 3/4"	COOLING TOWER (5H
				3		4				
				5		6	30			
CHWP-1,2 (2) 7-1/2 HP	#4 IN 1-1/4"	18,216	3	7		8	3	18,216	#4 IN 1-1/4"	CHWP-1,2 (2) 7-1/2
				9		10				
				11		12	80			
CHILLER #2	#3 IN 1-1/4"	24,840	3	13		14				SPACE
				15		16				
				17		18				
TOTAL LOAD: 92,412 V										
AMPS. 257										

NEW ELECTRICAL PANEL SCHEDULE "WG"

TYPE	AQ. GE	14,000 AIC	MAINS	M.L.O.		
MOUNTING: FLUSH			BUS RATING: 225 AMP	225 AMP		
LOCATION: SECOND FLOOR - NORTH SIDE			VOLTAGE: 208Y/120V-3PHASE-4W			
DESCRIPTION	WIRE & COND. SIZE	LOAD (V.A.)	POLE	CT. NO.	A B C	DESCRIPTION
ROOM 232 RECEPT.	#12 - 1/2"	720	1	2		RMS. BATH GFI REC.
ROOM 232 RECEPT.	#12 - 1/2"	720	1	3		RMS. BATH GFI REC.
ROOM 231 RECEPT.	#12 - 1/2"	1,080	1	5		EXTER. GFI REC.
ROOM 230 RECEPT.	#12 - 1/2"	1,080	1	7		ROOMS. LIGHTS
ROOM 233 RECEPT.	#12 - 1/2"	1,080	1	9		ROOMS. LIGHTS
ROOM 234 RECEPT.	#12 - 1/2"	1,080	1	11		SPARE
ROOM 234 RECEPT.	#12 - 1/2"	1,080	1	13		ROOM 208 RECEPT.
ROOM 216 RECEPT.	#12 - 1/2"	1,080	1	15		ROOM 207 RECEPT.
ROOM 215 RECEPT.	#12 - 1/2"	1,080	1	17		RMS. BATH GFI REC.
ROOM 229 RECEPT.	#12 - 1/2"	1,080	1	19		RMS. BATH GFI REC.
ROOM 228 RECEPT.	#12 - 1/2"	1,080	1	21		RMS. BATH GFI REC.
ROOM 227 RECEPT.	#12 - 1/2"	1,080	1	23		RMS. BATH GFI REC.
ROOM 226 RECEPT.	#12 - 1/2"	1,080	1	25		RMS. BATH GFI REC.
ROOM 225 RECEPT.	#12 - 1/2"	1,080	1	27		ROOMS. LIGHTS
ROOM 224 RECEPT.	#12 - 1/2"	1,080	1	29		ROOMS. LIGHTS
ROOM 223 RECEPT.	#12 - 1/2"	1,080	1	31		ROOMS. LIGHTS
ROOM 214 RECEPT.	#12 - 1/2"	1,080	1	33		FC-1
ROOM 212 RECEPT.	#12 - 1/2"	1,080	1	35		FC-1
PANEL "WG"	#4 IN 1-1/4"	20,250	3	37		SPACE
				39		SPACE
				41		SPACE
				42		SPACE

GENERAL LIGHTING AND RECEPTABLES LOAD = 37,440 VA
 DEMAND LOAD FOR GENERAL LIGHTING AND RECEPTABLES (TABLE 220-11, N.E.C.)
 FIRST 20,000 VA @ 50% = 10,000 VA
 17,440 VA @ 40% = 6,976 VA
 TOTAL DEM. LOAD = 16,976 VA
 OTHER LOAD = 20,250 VA
 TOTAL CONN. LOAD = 37,226 VA

TOTAL LOAD: 37,226 VA
 AMPS: 103.4

NEW ELECTRICAL PANEL SCHEDULE "WGG"

TYPE: AQ, GE			14,000 AIC			MAINS: M.L.O.			125 AMP			
MOUNTING: FLUSH						BUS RATING:			208Y/120V-3PHASE-4W			
LOCATION: SECOND FLOOR - NORTH SIDE						VOLTAGE:						
DESCRIPTION	WIRE & COND. SIZE	LOAD (V.A.)	POLE TRIP	CT. NO.	A	B	C	CKT. No.	POLE TRIP	LOAD (V.A.)	WIRE & COND. SIZE	DESCRIPTION
EXT. GFI REC.	#12 - 1/2"	720	1	20	1			2	1	1,350	#12 - 1/2"	FC-1
EXT. GFI REC.	#12 - 1/2"	720	1	20	3			4	1	1,350	#12 - 1/2"	FC-1
EXT. GFI REC.	#12 - 1/2"	720	1	20	5			6	1	1,350	#12 - 1/2"	FC-1
ROOM 211 RECEPT.	#12 - 1/2"	1,080	1	20	7			8	1	1,350	#12 - 1/2"	FC-1
ROOM 210 RECEPT.	#12 - 1/2"	1,080	1	20	9			10	1	1,350	#12 - 1/2"	FC-1
ROOM 209 RECEPT.	#12 - 1/2"	1,080	1	20	11			12	1	1,350	#12 - 1/2"	FC-1
FC-1	#12 - 1/2"	1,350	1	20	13			14	1	1,350	#12 - 1/2"	FC-1
FC-1	#12 - 1/2"	1,350	1	20	15			16	1	1,350	#12 - 1/2"	FC-1
FC-1	#12 - 1/2"	1,350	1	20	17			18	1	1,350	#12 - 1/2"	FC-1
FC-1	#12 - 1/2"	1,350	1	20	19			20				SPACE
SPACE					21			22				SPACE
SPACE					23			24				SPACE

GENERAL LIGHTING AND RECEPTABLES LOAD = 5,400 VA

DEMAND LOAD FOR GENERAL LIGHTING AND RECEPTABLES (TABLE 220-11, N.E.C.)

5,400 VA @ 50% = 2,700 VA

OTHER LOAD = 17,550 VA

TOTAL CONN. LOAD = 20,250 VA

TOTAL LOAD: 20,250 VA

AMPS: 56.25

NEW ELECTRICAL PANEL SCHEDULE "MDP"										
TYPE : CCB, GE			22,000 AIC			MAINS : 500 AMP M.C.B.				
MOUNTING : SURFACE						BUS RATING : 600 AMP				
LOCATION : ELECTRICAL ROOM						VOLTAGE : 208Y/120V-3PHASE-4W				
DESCRIPTION	WIRE & COND. SIZE	LOAD (V.A.)	POLE TRIP	CKT. No.	A B C	CKT. No.	POLE TRIP	LOAD (V.A.)	WIRE & COND. SIZE	DESCRIPTION
PANEL "WA"	#3 IN 1-1/4"	26,912	3	1		2	3	21,028	#4 IN 1-1/4"	PANEL "WB"
				3		4				
				5		6	80			
PANEL "WF"	#1 IN 1-1/2"	35,900	3	7		8	3	37,226	#1 IN 1-1/2"	PANEL "WG"
				9		10				
				11		12	125			
PANEL "W"	#4 IN 1-1/4"	24,716	3	13		14	3	17,190	#3 IN 1-1/4"	PANEL "WL"
				15		16				
				17		18	80			
SPACE				19		20				SPACE
				21		22				
				23		24				
GENERAL LIGHTING AND RECEPTABLES LOAD = 124,580 VA										
DEMAND LOAD FOR GENERAL LIGHTING AND RECEPTABLES (TABLE 220-11, N.E.C.)										
20,000 VA @ 50% = 10,000 VA										
80,000 VA @ 40% = 32,000 VA										
24,580 VA @ 30% = 7,374 VA										
TOTAL LOAD = 49,374 VA										
OTHER LOAD = 102,260 VA										
TOTAL CONN. LOAD = 151,520 VA										
TOTAL LOAD AMPS:								152,960 VA 425		⚠

NEW ELECTRICAL PANEL SCHEDULE "WB"

TYPE: MOUNTING: FLUSH
 LOCATION: GROUND FLOOR LAUNDRY - NORTH SIDE
 14,000 AIC

MAINS BUS RATING: 225 AMP
 VOLTAGE: 208Y/120V-3PHASE-4W
 M.L.O.

DESCRIPTION	WIRE & COND. SIZE	LOAD (V.A.)	POLE	CT. NO.	A	B	C	DESCRIPTION
EXIST. ICE MACH.	EXISTING	800	1	2				RMS. BATH GFI REC.
ROOM 129 RECEPT.	#12 - 1/2"	1,080	1	3				RMS. BATH GFI REC.
ROOM 128 RECEPT.	#12 - 1/2"	1,080	1	5				RMS. BATH GFI REC.
ROOM 127 RECEPT.	#12 - 1/2"	1,080	1	7				RMS. BATH GFI REC.
ROOM 126 RECEPT.	#12 - 1/2"	1,080	1	9				EXTER. GFI REC.
ROOM 125 RECEPT.	#12 - 1/2"	1,080	1	11				EXTER. GFI REC.
ROOM 124 RECEPT.	#12 - 1/2"	1,080	1	13				EXTER. GFI REC.
ROOM 123 RECEPT.	#12 - 1/2"	1,080	1	15				EXTER. GFI REC.
ROOM 114 RECEPT.	#12 - 1/2"	1,080	1	17				ROOMS. LIGHTS
ROOM 113 RECEPT.	#12 - 1/2"	1,080	1	19				ROOMS. LIGHTS
ROOM 111 RECEPT.	#12 - 1/2"	1,080	1	21				ROOMS. LIGHTS
ROOM 110 RECEPT.	#12 - 1/2"	1,080	1	23				ROOMS. LIGHTS
ROOM 109 RECEPT.	#12 - 1/2"	1,080	1	25				ROOMS. LIGHTS
ROOM 108 RECEPT.	#12 - 1/2"	1,080	1	27				ROOMS. LIGHTS
ROOM 107 RECEPT.	#12 - 1/2"	1,080	1	29				FC-1
SPACE				31				FC-1
SPACE				33				FC-1
SPACE				35				FC-1
SPACE				37				FC-1
SPACE				39				FC-1
SPACE				41				FC-1
SPACE				42				SPACE

GENERAL LIGHTING AND RECEPTABLES LOAD = 27,320 VA

DEMAND LOAD FOR GENERAL LIGHTING AND RECEPTABLES (TABLE 220-11, N.E.C.)

FIRST 20,000 VA @ 50% = 10,000 VA

7,320 VA @ 40% = 2,928 VA

TOTAL DEM. LOAD = 12,928 VA

OTHER LOAD = 8,100 VA

TOTAL CONN. LOAD = 21,028 VA

TOTAL LOAD: 21,028 VA

Amps. 58.41

TYPE	AQ. GE	14,000 AIC	MAINS	M.L.O.
MOUNTING: FLUSH			BUS RATING: 225 AMP	225 AMP
LOCATION: SECOND FLOOR CORRIDOR - SOUTH SIDE			VOLTAGE: 208Y/120V-3PHASE-4W	
DESCRIPTION	WIRE & COND. SIZE	LOAD (V.A.)	POLE	CT

TYPE	AQ. GE	14,000 AIC	MAINS	M.L.O.
MOUNTING: FLUSH			BUS RATING: 225 AMP	225 AMP
LOCATION: GROUND FLOOR CORRIDOR - SOUTH SIDE			VOLTAGE: 208Y/120V-3PHASE-4W	
DESCRIPTION	WIRE & COND. SIZE	LOAD (V.A.)	POLE	CT. NO.
EXIST. ICE MACH. EXISTING	800	1,080	1	1
ROOM 122 RECEPTS	#12 - 1/2"	1,080	20	3
ROOM 120 RECEPTS	#12 - 1/2"	1,080	20	5
ROOM 119 RECEPTS	#12 - 1/2"	1,080	20	7
ROOM 118 RECEPTS	#12 - 1/2"	1,080	20	9
ROOM 117 RECEPTS	#12 - 1/2"	1,080	20	11
ROOM 106 RECEPTS	#12 - 1/2"	1,080	20	13
ROOM 105 RECEPTS	#12 - 1/2"	1,080	20	15
ROOM 104 RECEPTS	#12 - 1/2"	1,080	20	17
ROOM 103 RECEPTS	#12 - 1/2"	1,080	20	19
ROOM 102 RECEPTS	#12 - 1/2"	1,080	20	21
ROOM 101 RECEPTS	#12 - 1/2"	1,080	20	23
FC-1	#12 - 1/2"	1,350	20	25
FC-1	#12 - 1/2"	1,350	20	27
FC-1	#12 - 1/2"	1,350	20	29
FC-1	#12 - 1/2"	1,350	20	31
FC-1	#12 - 1/2"	1,350	20	33
SPACE				35
SPACE				37
SPACE				39
SPACE				41
GENERAL LIGHTING AND RECEPTABLES LOAD = 21,780 VA				
DEMAND LOAD FOR GENERAL LIGHTING AND RECEPTABLES (TABLE 220-11, N.E.C.)				
FIRST 20,000 VA @ 50% = 10,000 VA				
1,780 VA @ 40% = 712 VA				
TOTAL DEM. LOAD = 10,712 VA				
OTHER LOAD = 16,200 VA				
TOTAL CONN. LOAD = 26,912 VA				
TOTAL LOAD: 26,912 VA				
AMPS: 75				

TYPE	AQ. GE	14,000 AIC	MAINS	M.L.O.
MOUNTING: FLUSH			BUS RATING: 225 AMP	225 AMP
LOCATION: GROUND FLOOR CORRIDOR - SOUTH SIDE			VOLTAGE: 208Y/120V-3PHASE-4W	
DESCRIPTION	WIRE & COND. SIZE	LOAD (V.A.)	POLE	CT. NO.
ROOM 175 RECEPTS	#12 - 1/2"	1,080	20	1
ROOM 174 RECEPTS	#12 - 1/2"	1,080	20	3
ROOM 173 RECEPTS	#12 - 1/2"	1,080	20	5
EXIST. DRYER #3	EXISTING	1,000	20	7
ROOM 119 RECEPTS	#12 - 1/2"	1,080	20	9
ROOM 118 RECEPTS	#12 - 1/2"	1,080	20	11
EXIST. WASHER #3	EXISTING	3,000	20	13
ROOM 172 RECEPTS	#12 - 1/2"	1,080	20	15
ROOM 171 RECEPTS	#12 - 1/2"	1,080	20	17
ROOM 170 RECEPTS	#12 - 1/2"	1,080	20	19
ROOM 169 RECEPTS	#12 - 1/2"	1,080	20	21
ROOM 168 RECEPTS	#12 - 1/2"	1,080	20	23
ROOM 167 RECEPTS	#12 - 1/2"	1,080	20	25
ROOMS LIGHTS	#12 - 1/2"	1,200	20	27
ROOMS LIGHTS	#12 - 1/2"	1,200	20	29
FC-1	#12 - 1/2"	1,350	20	31
FC-1	#12 - 1/2"	1,350	20	33
FC-1	#12 - 1/2"	1,350	20	35
FC-1	#12 - 1/2"	1,350	20	37
FC-1	#12 - 1/2"	1,350	20	39
FC-1	#12 - 1/2"	1,350	20	41
SPACE				43
SPACE				45
SPACE				47
SPACE				49
SPACE				51
GENERAL LIGHTING AND RECEPTABLES LOAD = 15,000 VA				
DEMAND LOAD FOR GENERAL LIGHTING AND RECEPTABLES (TABLE 220-11, N.E.C.)				
15,000 VA @ 50% = 7,500 VA				
OTHER LOAD = 28,400 VA				
TOTAL CONN. LOAD = 35,900 VA				
TOTAL LOAD: 35,900 VA				
AMPS: 99.72				

TYPE	AQ. GE	65,000 A.I.C.	MAINS	M.L.O.
MOUNTING: SURFACE			BUS RATING: 550 AMP	550 AMP
LOCATION: MECHANICAL ROOM			VOLTAGE: 208Y/120V-3PHASE-4WIRE-S/N	
DESCRIPTION	WIRE & COND. SIZE	LOAD (V.A.)	POLE	CT. NO.
CHILLER #1	#3 IN 1-1/4"	24,840	3	1
CHWP-1,2 (2) 7-1/2 HP	#4 IN 1-1/4"	18,216	3	5
CHILLER #2	#3 IN 1-1/4"	24,840	3	9
SPACE				13
SPACE				15
SPACE				17
GENERAL LIGHTING AND RECEPTABLES LOAD = 15,000 VA				
DEMAND LOAD FOR GENERAL LIGHTING AND RECEPTABLES (TABLE 220-11, N.E.C.)				
15,000 VA @ 50% = 7,500 VA				
OTHER LOAD = 28,400 VA				
TOTAL CONN. LOAD = 35,900 VA				
TOTAL LOAD: 92,412 VA				
AMPS: 257				

TYPE	AQ. GE	14,000 AIC	MAINS	M.L.O.
MOUNTING: FLUSH			BUS RATING: 225 AMP	225 AMP
LOCATION: SECOND FLOOR - NORTH SIDE			VOLTAGE: 208Y/120V-3PHASE-4W	
DESCRIPTION	WIRE & COND. SIZE	LOAD (V.A.)	POLE	CT. NO.
ROOM 232 RECEPTS	#12 - 1/2"	1,080	20	1
ROOM 231 RECEPTS	#12 - 1/2"	1,080	20	3
ROOM 230 RECEPTS	#12 - 1/2"	1,080	20	5
ROOM 229 RECEPTS	#12 - 1/2"	1,080	20	7
ROOM 228 RECEPTS	#12 - 1/2"	1,080	20	9
ROOM 227 RECEPTS	#12 - 1/2"	1,080	20	11
ROOM 226 RECEPTS	#12 - 1/2"	1,080	20	13
ROOM 225 RECEPTS	#12 - 1/2"	1,080	20	15
ROOM 224 RECEPTS	#12 - 1/2"	1,080	20	17
ROOM 223 RECEPTS	#12 - 1/2"	1,080	20	19
ROOM 222 RECEPTS	#12 - 1/2"	1,080	20	21
ROOM 221 RECEPTS	#12 - 1/2"	1,080	20	23
ROOM 220 RECEPTS	#12 - 1/2"	1,080	20	25
ROOM 219 RECEPTS	#12 - 1/2"	1,080	20	27
ROOM 218 RECEPTS	#12 - 1/2"	1,080	20	29
ROOM 217 RECEPTS	#12 - 1/2"	1,080	20	31
ROOM 216 RECEPTS	#12 - 1/2"	1,080	20	33
ROOM 215 RECEPTS	#12 - 1/2"	1,080	20	35
ROOM 214 RECEPTS	#12 - 1/2"	1,080	20	37
ROOM 213 RECEPTS	#12 - 1/2"	1,080	20	39
PANEL "WQ"	#4 IN 1-1/4"	20,250	3	41
GENERAL LIGHTING AND RECEPTABLES LOAD = 37,440 VA				
DEMAND LOAD FOR GENERAL LIGHTING AND RECEPTABLES (TABLE 220-11, N.E.C.)				
FIRST 20,000 VA @ 50% = 10,000 VA				
17,440 VA @ 40% = 6,976 VA				
TOTAL DEM. LOAD = 16,976 VA				
OTHER LOAD = 20,250 VA				
TOTAL CONN. LOAD = 37,226 VA				
TOTAL LOAD: 37,226 VA				
AMPS: 103.4				

TYPE	AQ. GE	14,000 AIC	MAINS	M.L.O.
MOUNTING: FLUSH			BUS RATING: 225 AMP	225 AMP
LOCATION: SECOND FLOOR - NORTH SIDE			VOLTAGE: 208Y/120V-3PHASE-4W	
DESCRIPTION	WIRE & COND. SIZE	LOAD (V.A.)	POLE	CT. NO.
EXT. GFI REC.	#12 - 1/2"	720	20	1
EXT. GFI REC.	#12 - 1/2"	720	20	3
EXT. GFI REC.	#12 - 1/2"	720	20	5
ROOM 211 RECEPTS	#12 - 1/2"	1,080	20	7
ROOM 210 RECEPTS	#12 - 1/2"	1,080	20	9
ROOM 209 RECEPTS	#12 - 1/2"	1,080	20	11
FC-1	#12 - 1/2"	1,350	20	13
FC-1	#12 - 1/2"	1,350	20	15
FC-1	#12 - 1/2"	1,350	20	17
FC-1	#12 - 1/2"	1,350	20	19
SPACE				21
SPACE				23
GENERAL LIGHTING AND RECEPTABLES LOAD = 5,400 VA				
DEMAND LOAD FOR GENERAL LIGHTING AND RECEPTABLES (TABLE 220-11, N.E.C.)				
5,400 VA @ 50% = 2,700 VA				
OTHER LOAD = 17,550 VA				
TOTAL CONN. LOAD = 20,250 VA				
TOTAL LOAD: 20,250 VA				
AMPS: 56.25				

TYPE	AQ. GE	22,000 AIC	MAINS	M.L.O.
MOUNTING: SURFACE			BUS RATING: 500 AMP	500 AMP
LOCATION: ELECTRICAL ROOM			VOLTAGE: 208Y/120V-3PHASE-4W	
DESCRIPTION	WIRE & COND. SIZE	LOAD (V.A.)	POLE	CT. NO.
PANEL "WA"	#3 IN 1-1/4"	26,912	3	1
PANEL "WF"	#1 IN 1-1/2"	35,900	3	5
PANEL "WQ"	#4 IN 1-1/4"	20,250	3	9
SPACE				13
SPACE				15
SPACE				17
SPACE				19
SPACE				21
SPACE				23
GENERAL LIGHTING AND RECEPTABLES LOAD = 124,580 VA				
DEMAND LOAD FOR GENERAL LIGHTING AND RECEPTABLES (TABLE 220-11, N.E.C.)				
20,000 VA @ 50% = 10,000 VA				
80,000 VA @ 40% = 32,000 VA				
24,580 VA @ 30% = 7,374 VA				
TOTAL LOAD = 49,374 VA				
OTHER LOAD = 102,206 VA				
TOTAL CONN. LOAD = 151,520 VA				
TOTAL LOAD: 151,520 VA				
AMPS: 421				


TYPE	AQ. GE	14,000 AIC	MAINS	M.L.O.
MOUNTING: FLUSH			BUS RATING: 225 AMP	225 AMP
LOCATION: GROUND FLOOR LAUNDRY - NORTH SIDE			VOLTAGE: 208Y/120V-3PHASE-4W	
DESCRIPTION	WIRE & COND. SIZE	LOAD (V.A.)	POLE	CT. NO.
EXIST. ICE MACH. EXISTING	800	1,080	1	1
ROOM 129 RECEPTS	#12 - 1/2"	1,080	20	3
ROOM 128 RECEPTS	#12 - 1/2"	1,080	20	5
ROOM 127 RECEPTS	#12 - 1/2"	1,080	20	7
ROOM 126 RECEPTS	#12 - 1/2"	1,080	20	9
ROOM 125 RECEPTS	#12 - 1/2"	1,080	20	11
ROOM 124 RECEPTS	#12 - 1/2"	1,080	20	13
ROOM 123 RECEPTS	#12 - 1/2"	1,080	20	15
ROOM 122 RECEPTS	#12 - 1/2"	1,080	20	17
ROOM 121 RECEPTS	#12 - 1/2"	1,080	20	19
ROOM 120 RECEPTS	#12 - 1/2"	1,080	20	21
ROOM 119 RECEPTS	#12 - 1/2"	1,080	20	23
ROOM 118 RECEPTS	#12 - 1/2"	1,080	20	25
ROOM 117 RECEPTS	#12 - 1/2"	1,080	20	27
ROOM 116 RECEPTS	#12 - 1/2"	1,080	20	29
ROOM 115 RECEPTS	#12 - 1/2"	1,080	20	31
ROOM 114 RECEPTS	#12 - 1/2"	1,080	20	33
ROOM 113 RECEPTS	#12 - 1/2"	1,080	20	35
ROOM 112 RECEPTS	#12 - 1/2"	1,080	20	37
ROOM 111 RECEPTS	#12 - 1/2"	1,080	20	39
ROOM 110 RECEPTS	#12 - 1/2"	1,080	20	41
ROOM 109 RECEPTS	#12 - 1/2"	1,080	20	43
ROOM 108 RECEPTS	#12 - 1/2"	1,080	20	45
ROOM 107 RECEPTS	#12 - 1/2"	1,080	20	47
SPACE				49
SPACE				51
SPACE				53
SPACE				55
SPACE				57
SPACE				59
SPACE				61
GENERAL LIGHTING AND RECEPTABLES LOAD = 27,320 VA				
DEMAND LOAD FOR GENERAL LIGHTING AND RECEPTABLES (TABLE 220-11, N.E.C.)				
FIRST 20,000 VA @ 50% = 10,000 VA				
7,320 VA @ 40% = 2,928 VA				
TOTAL DEM. LOAD = 12,928 VA				
OTHER LOAD = 8,100 VA				
TOTAL CONN. LOAD = 21,028 VA				
TOTAL LOAD: 21,028 VA				
AMPS: 56.41				

NEW ELECTRICAL PANEL SCHEDULE "WJ"												
TYPE : AQ. GE			14,000 AIC			MAINS : M.L.O.						
MOUNTING : FLUSH						225 AMP						
LOCATION : SECOND FLOOR CORRIDOR - SOUTH SIDE						VOLTAGE : 208Y/120V-3PHASE-4W						
DESCRIPTION	WIRE & COND. SIZE	LOAD (V.A.)	POLE TRIP	CKT. NO.	A	B	C	CKT. NO.	POLE TRIP	LOAD (V.A.)	WIRE & COND. SIZE	DESCRIPTION
EXIST. ICE MACH. EXISTING		800	1	1				2	1	720	#12 - 1/2"	RMS. BATH GFI REC.
ROOM 122 RECEPTS	#12 - 1/2"	1,080	20	3				4	1	720	#12 - 1/2"	RMS. BATH GFI REC.
ROOM 121 RECEPTS	#12 - 1/2"	1,080	20	5				5	1	720	#12 - 1/2"	RMS. BATH GFI REC.
ROOM 120 RECEPTS	#12 - 1/2"	1,080	20	7				8	1	720	#12 - 1/2"	EXTER. GFI REC.
ROOM 119 RECEPTS	#12 - 1/2"	1,080	20	9				10	1	540	#12 - 1/2"	EXTER. GFI REC.
ROOM 118 RECEPTS	#12 - 1/2"	1,080	20	11				12	1	720	#12 - 1/2"	EXTER. GFI REC.
ROOM 117 RECEPTS	#12 - 1/2"	1,080	20	13				14	1	540	#12 - 1/2"	EXTER. GFI REC.
ROOM 116 RECEPTS	#12 - 1/2"	1,080	20	15				16	1	900	#12 - 1/2"	ROOMS. LIGHTS
ROOM 115 RECEPTS	#12 - 1/2"	1,080	20	17				18	1	900	#12 - 1/2"	ROOMS. LIGHTS
ROOM 114 RECEPTS	#12 - 1/2"	1,080	20	19				20	1	900	#12 - 1/2"	ROOMS. LIGHTS
ROOM 113 RECEPTS	#12 - 1/2"	1,080	20	21				22	1	900	#12 - 1/2"	ROOMS. LIGHTS
ROOM 112 RECEPTS	#12 - 1/2"	1,080	20	23				24	1	1,350	#12 - 1/2"	FC-1
ROOM 111 RECEPTS	#12 - 1/2"	1,080	20	25				26	1	1,350	#12 - 1/2"	FC-1
FC-1	#12 - 1/2"	1,080	20	27				28	1	1,350	#12 - 1/2"	FC-1
FC-1	#12 - 1/2"	1,080	20	29				30	1	1,350	#12 - 1/2"	FC-1
FC-1	#12 - 1/2"	1,080	20	31				32	1	1,350	#12 - 1/2"	FC-1
FC-1	#12 - 1/2"	1,080	20	33				34	1	1,350	#12 - 1/2"	FC-1
SPACE				35				36				SPACE
SPACE				37				38				SPACE
SPACE				39				40				SPACE
SPACE				41				42				SPACE

GENERAL LIGHTING AND RECEPTABLES LOAD = 21,040 VA	TOTAL LOAD:	24,716 VA
DEMAND LOAD FOR GENERAL LIGHTING AND RECEPTABLES (TABLE 220-11, N.E.C.)	AMPS:	69
FIRST 20,000 VA @ 50% = 10,000 VA		
3,040 VA @ 40% = 1,216 VA		
TOTAL DEM. LOAD = 11,216 VA		
OTHER LOAD = 13,500 VA		
TOTAL CONN. LOAD = 24,716 VA		


APPROVED FOR THE FOLLOWING BUILDING:

NEW ELECTRICAL PANEL SCHEDULE "WL"									
TYPE	NO.	DESCRIPTION	WIRE & CONDUIT SIZE	LOAD (VA)	TRIP	NO.	DESCRIPTION	WIRE & CONDUIT SIZE	LOAD (VA)
LANDSCAPE LIGHTS	#10 - 1/2"	420	1	20	1	LANDSCAPE LIGHTS	#10 - 1/2"	420	1
LANDSCAPE LIGHTS	#10 - 1/2"	420	1	20	3	LANDSCAPE LIGHTS	#10 - 1/2"	420	1
LANDSCAPE LIGHTS	#10 - 1/2"	380	1	20	5	LANDSCAPE LIGHTS	#10 - 1/2"	380	1
LANDSCAPE LIGHTS	#10 - 1/2"	350	1	20	7	LANDSCAPE LIGHTS	#10 - 1/2"	350	1
LANDSCAPE LIGHTS	#10 - 1/2"	480	1	20	9	LANDSCAPE LIGHTS	#10 - 1/2"	480	1
LANDSCAPE LIGHTS	#10 - 1/2"	840	1	20	11	LANDSCAPE LIGHTS	#10 - 1/2"	840	1
LANDSCAPE LIGHTS	#10 - 1/2"	840	1	20	13	LANDSCAPE LIGHTS	#10 - 1/2"	840	1
LANDSCAPE LIGHTS	#10 - 1/2"	1,020	1	20	15	LANDSCAPE LIGHTS	#10 - 1/2"	1,020	1
LANDSCAPE LIGHTS	#10 - 1/2"	150	1	20	17	LANDSCAPE LIGHTS	#10 - 1/2"	150	1
LANDSCAPE LIGHTS	#10 - 1/2"	795	1	20	19	LANDSCAPE LIGHTS	#10 - 1/2"	795	1
LANDSCAPE LIGHTS	#10 - 1/2"	795	1	20	21	LANDSCAPE LIGHTS	#10 - 1/2"	795	1
LANDSCAPE LIGHTS	#10 - 1/2"	1,020	1	20	23	LANDSCAPE LIGHTS	#10 - 1/2"	1,020	1
LANDSCAPE LIGHTS	#10 - 1/2"	1,020	1	20	25	LANDSCAPE LIGHTS	#10 - 1/2"	1,020	1
SPACE					27	SPACE			
SPACE					29	SPACE			
SPACE					31	SPACE			
SPACE					33	SPACE			
SPACE					35	SPACE			
SPACE					37	SPACE			
SPACE					39	SPACE			
SPACE					41	SPACE			
* CONTROLLED BY PHOTOCELL THROUGH LIGHTING CONTACTOR									
TOTAL LOAD: 15,810 VA AMPS: 43.92									

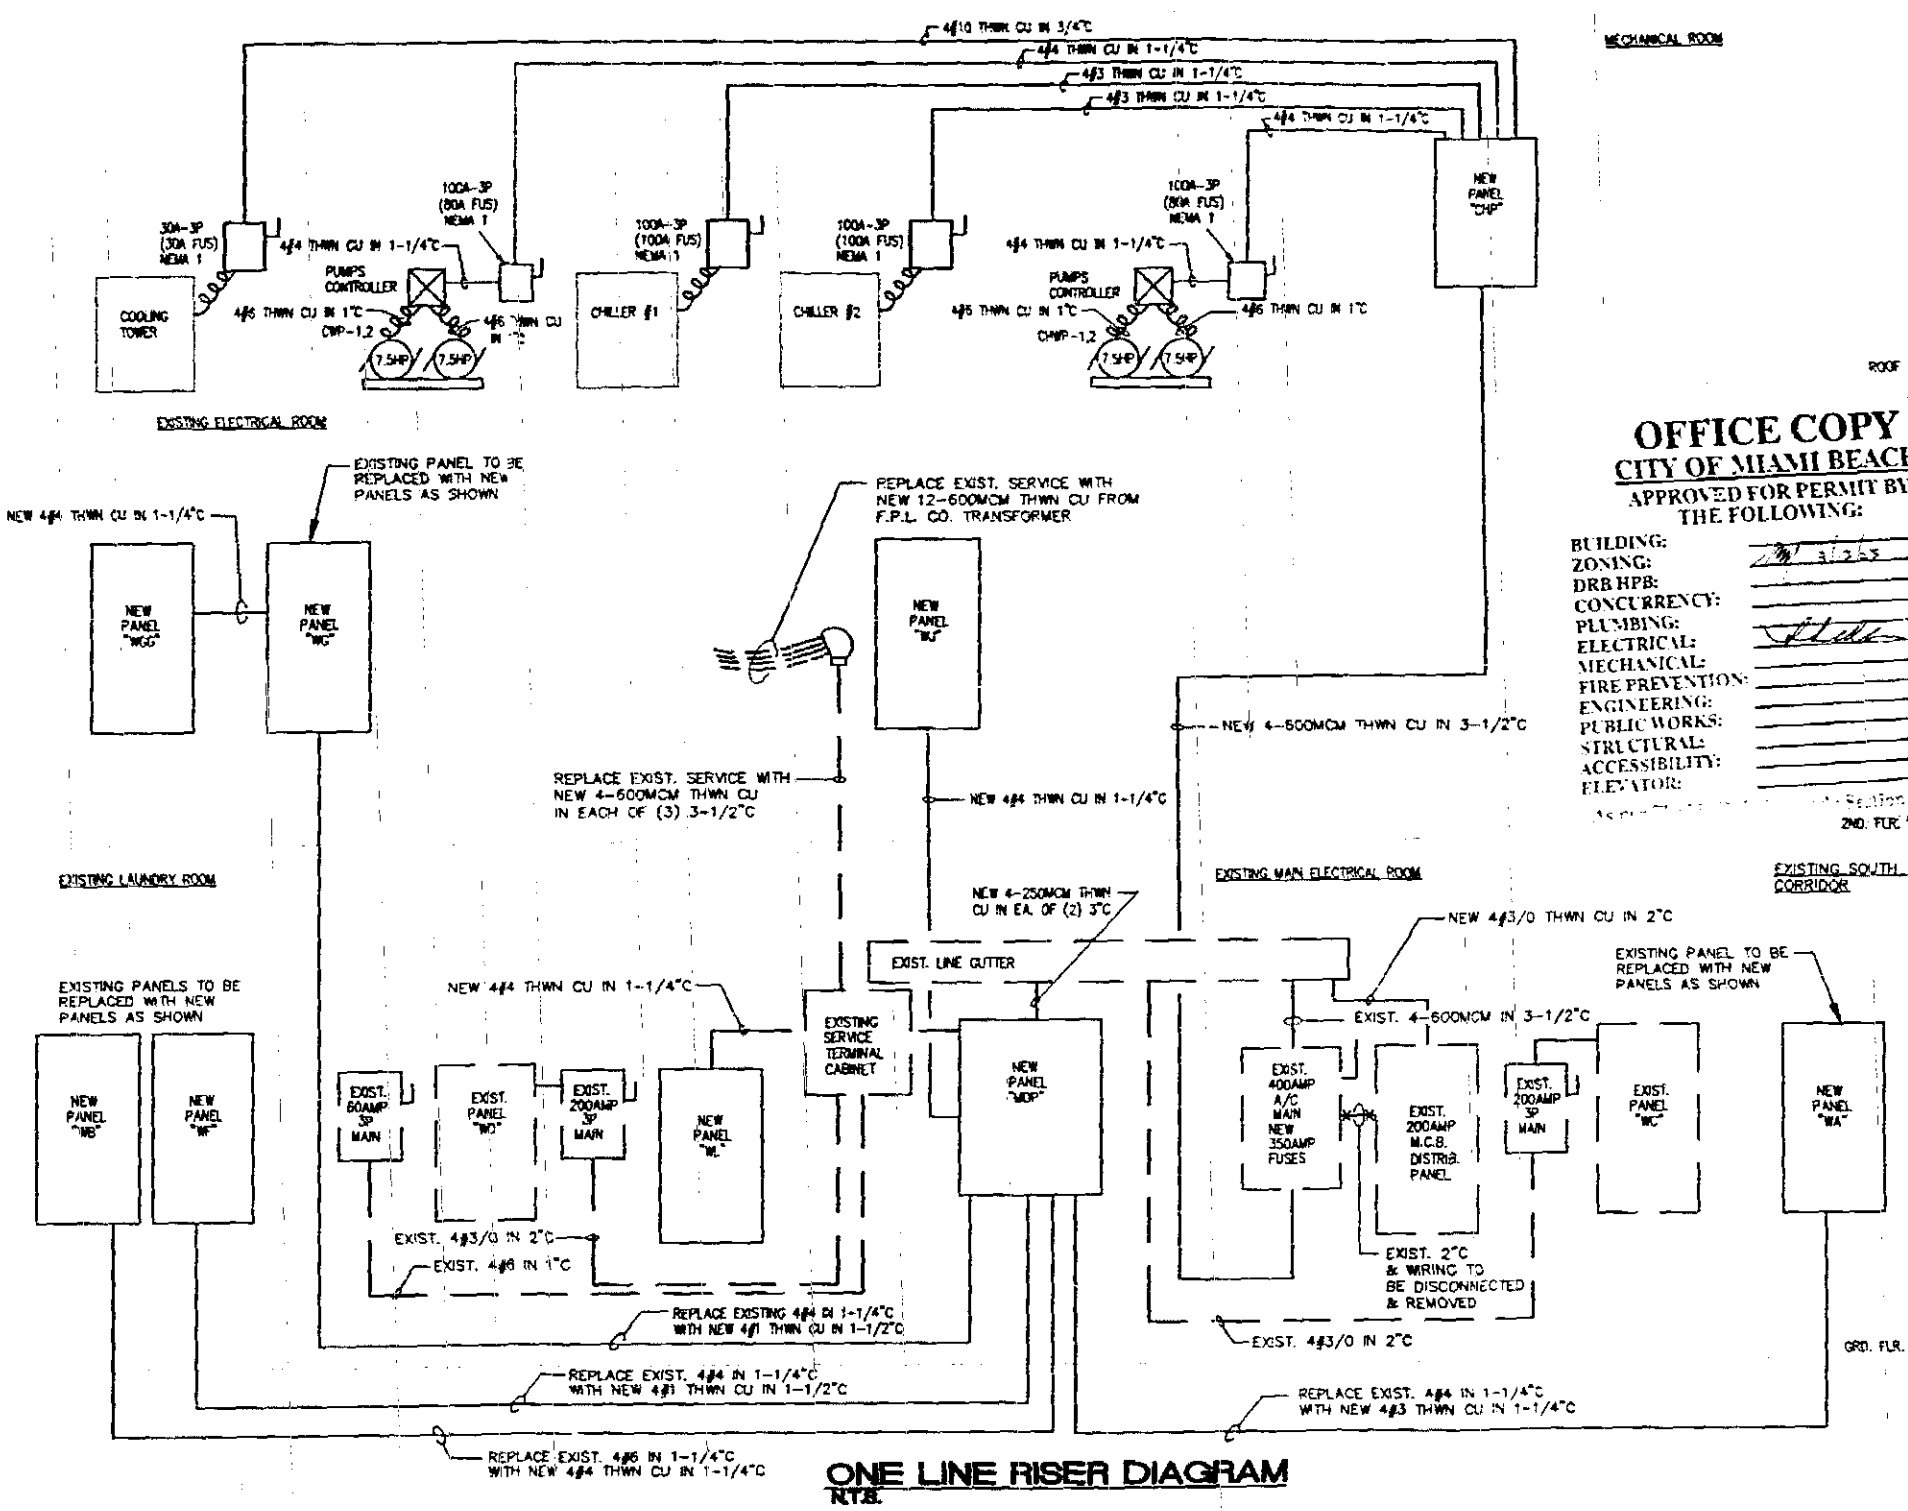

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THE FOLLOWING:

BUILDING:
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MECHANICAL:
FIRE PREVENTION:
ENGINEERING:
PUBLIC WORKS:
STRUCTURAL:
ACCESSIBILITY:
ELEVATOR:

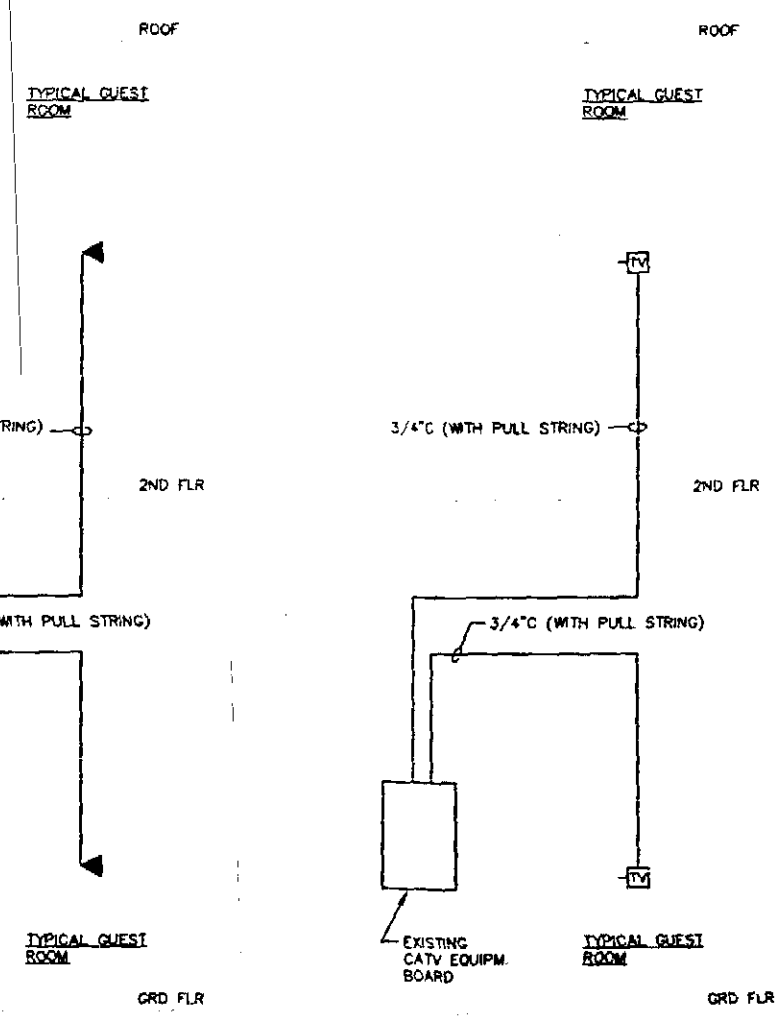

TELEPHONE RISER DIAGRAM
SCALE: N.T.S.

CATV RISER DIAGRAM
SCALE: N.T.S.

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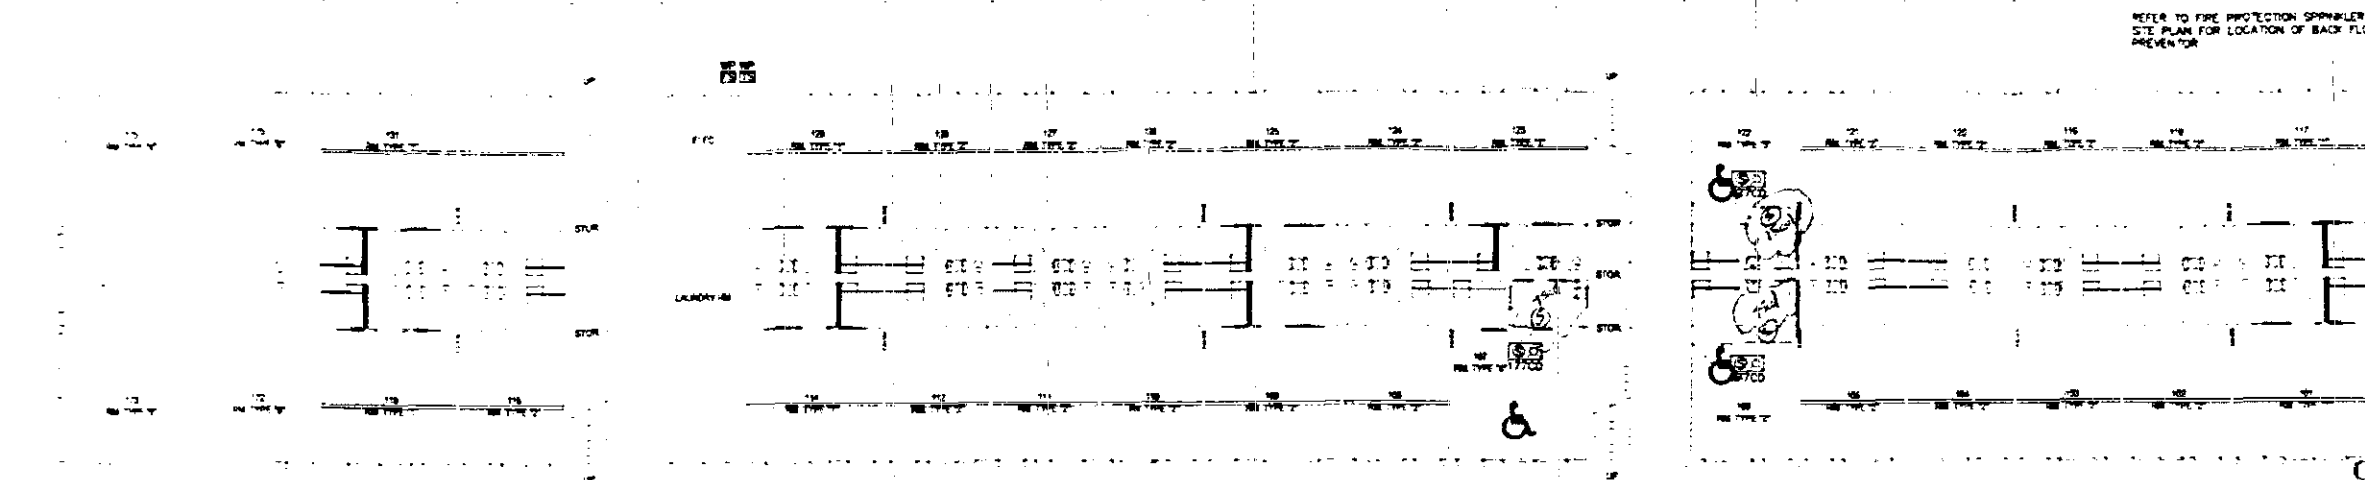
PROJECT TITLE
**LIDO SPA HOTEL
WEST WING - RENOVATION**
40 ISLAND AVENUE, MIAMI BEACH, FL 33139

DRAWING TITLE
**WEST WING
RISER DIAGRAMS**


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CHECKED BY: R.J.M.
ISSUES

SHEET NO.
E-3


PROJECT #: 0304-063
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R. J. MIRANDA PE NO. 36570
DAVID A. BRESSETT PE NO. 37234
Professional Electrical/Mechanical Engineers



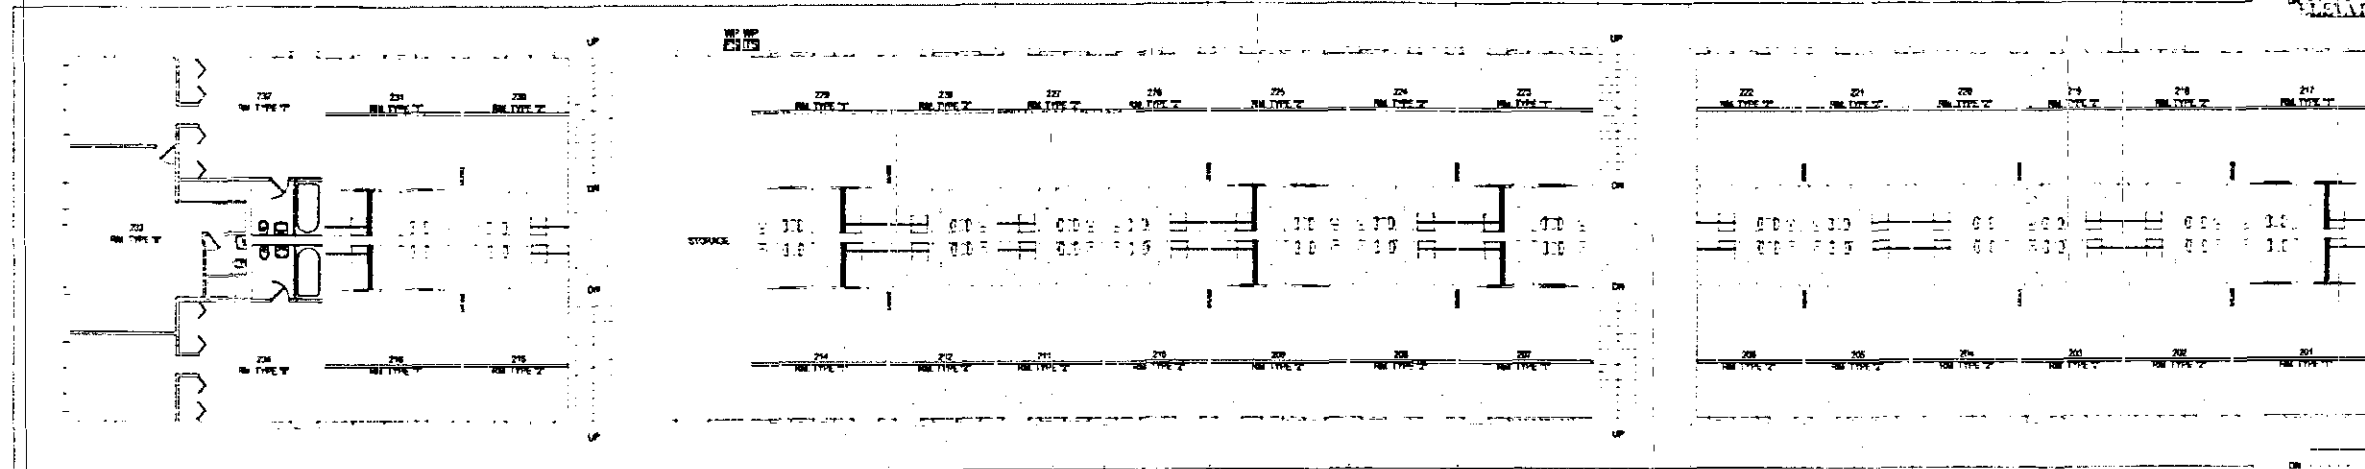WEST WING - GROUND FLOOR - PROPOSED FLOOR PLAN
SCALE 1/8"=1'-0"



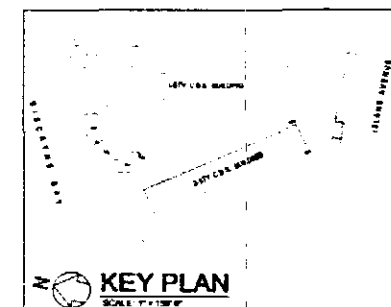WEST WING - SECOND FLOOR - PROPOSED FLOOR PLAN
SCALE 1/8"=1'-0"



PROJECT # 0304-053
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DRE HPR:
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MECHANICAL:
FIRE PREVENTION:
ENGINEERING:
PUBLIC WORKS:
STRUCTURAL:
ACCESSIBILITY:

[Signatures and stamps for various departments]


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305-438-1200 fax 305-438-1221

PROJECT TITLE
LIDO SPA HOTEL
WEST WING - RENOVATION
40 ISLAND AVENUE, MIAMI BEACH, FL 33139

DRAWING TITLE
WEST WING
PROPOSED FIRE ALARM
FLOOR PLANS

DRAWN BY C.P.
CHECKED BY R.J.M.
ISSUES

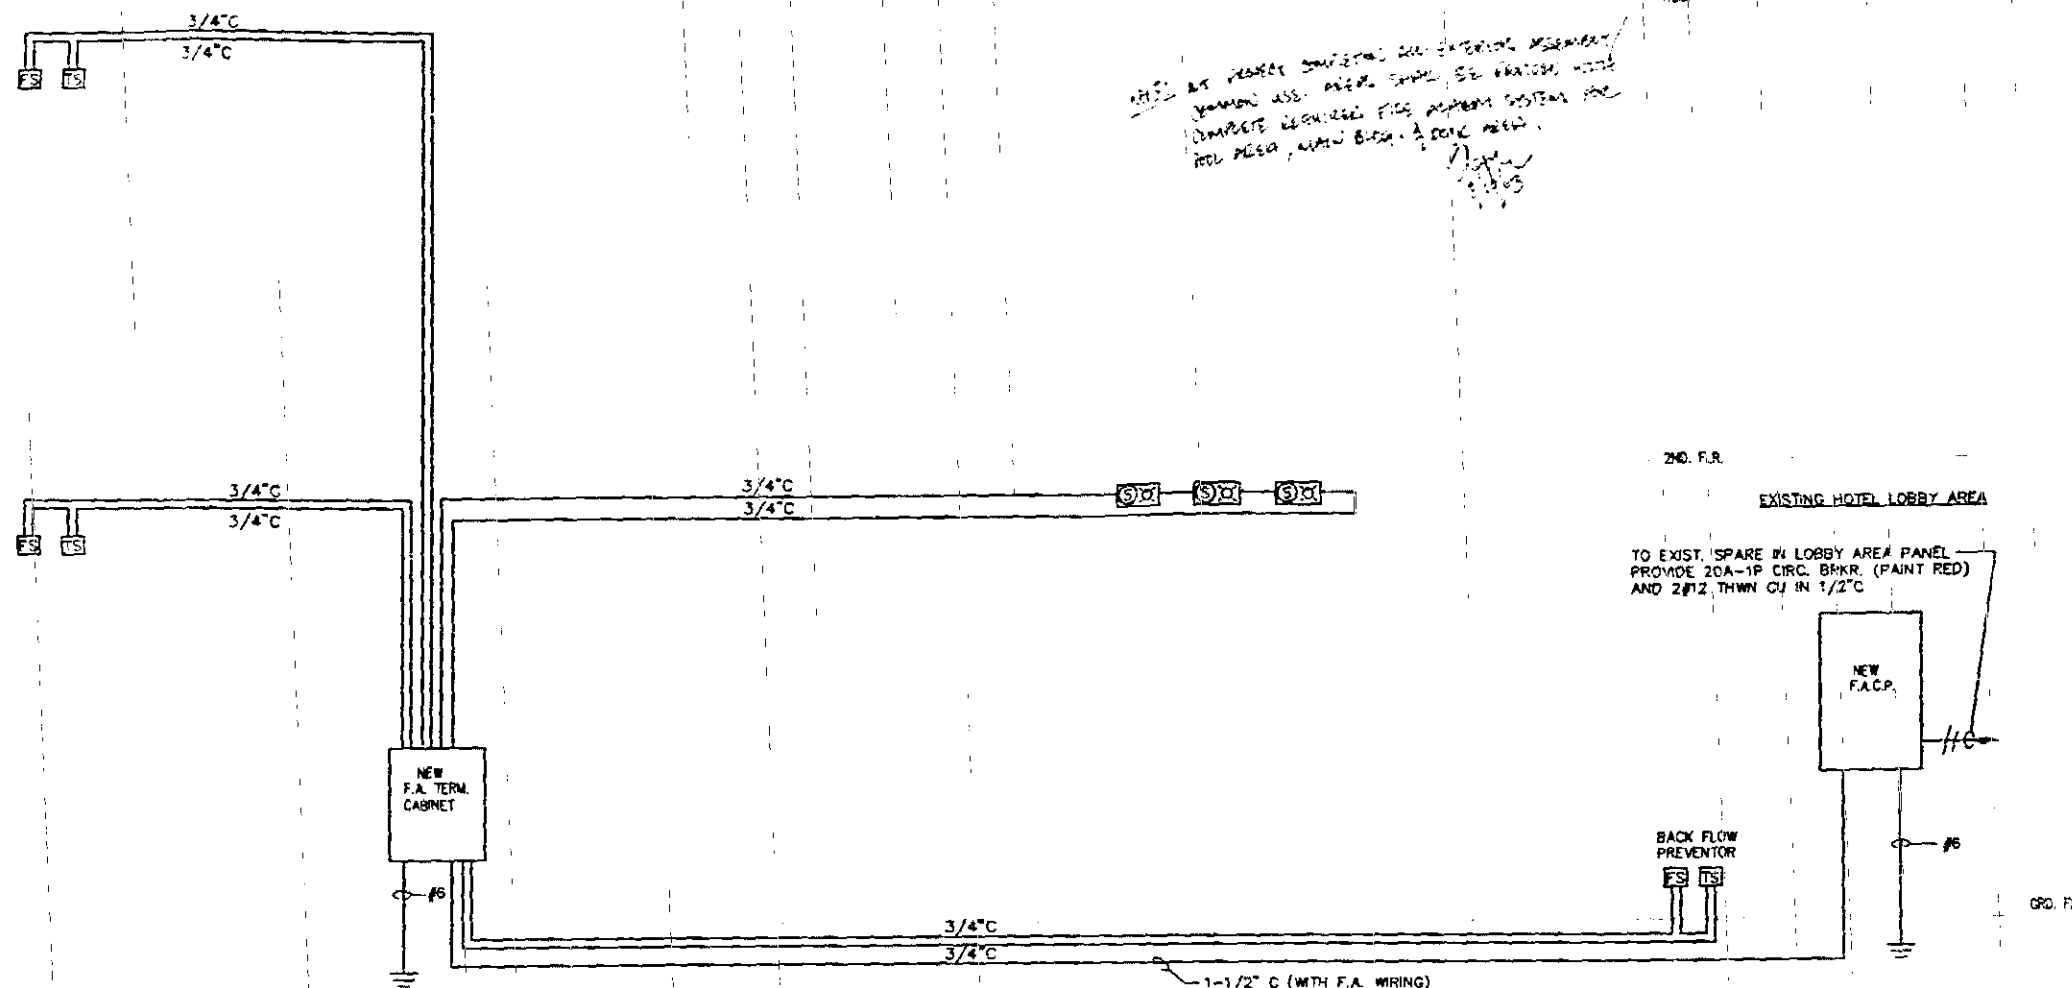SHEET NO.
FA-1



THIS AT PEOPLE CONSIDER THE EXISTING WIRING
 WIRING ASS. WITH THE NEW FACP. THE
 COMPLETE WIRING FOR THE FACP SYSTEM FOR
 THE NEW FACP. A NEW FACP.

SYMB.	DESCRIPTION	MANUF.	CAT NO.
	120V SMOKE DETECTOR AND STROBE DEVICE H.C. GUEST ROOMS	NOTIFIER	SC24177 STROBE STROBE
	F.A. CONTROL PANEL	NOTIFIER	9123 SMOKE DETECTOR WITH BATTERY PACK
	SINGLE UNIT SMOKE DETECTOR, CONNECTED TO 120V KITCHEN OR BATHROOM LIGHTS CIRCUIT	NOTIFIER	SFP-1024 WITH BOOSTER TYPE FCPS-2456
	FLOW SWITCH	NOTIFIER	9123 WITH BATTERY PACK
	TAMPER SWITCH	NOTIFIER	

FIRE ALARM RISER DIAGRAM N.T.A.

FIRE ALARM WIRING LEGEND

INITIATING DEVICES - 16-2 TSP
 SIGNAL DEVICES - 2#14 THHN
 POWER - 2#14 THHN

ITEM	DESCRIPTION	STANDBY CURRENT PER UNIT (AMPS)	QTY	TOTAL STANDBY CURRENT (AMPS)	ALARM CURRENT PER UNIT (AMPS)	TOTAL ALARM CURRENT (AMPS)
A	F.A.C.P.	0.2000	1	0.2000	0.2000	0.2000
B	ANNUNCIATOR	0.2000	1	0.2000	0.2000	0.2000
C	STROBES	0.0000	8	0.0000	0.0750	0.7000
				TOTAL SYST STANDBY CURRENT	0.4000	TOTAL SYST ALARM CURRENT
						1.1000
	REQUIRED STANDBY CURRENT	HOURS	X	AMP		AMP-HOURS
		24		0.4000		9.6
	REQUIRED ALARM CURRENT	30180 HOURS	X	AMP		AMP-HOURS
		0.0000		1.1000		0.000
	TOTAL REQUIRED CURRENT (AMP-HOURS)	REQUIRED STANDBY CURRENT		REQUIRED ALARM CURRENT		TOTAL REQUIRED AMP-HOURS
		9.600		0.000		9.600

NOTE: BATTERY CALCULATIONS INCLUDE 4 STROBES FOR EAST WING AND 2 SPARE STROBES FOR FUTURE

FIRE ALARM NOTES

- 1) THE FIRE ALARM SYSTEM IS U.L. LISTED AS POWER LIMITED & OF THE GENERAL ALARM TYPE PER NFPA 72. ALL EQUIPMENT IS U.L. LISTED FOR ITS INTENDED USE.
- 2) THE FIRE ALARM PANEL IS PROVIDED WITH STANDBY BATTERY PER NFPA 72 WITH 24 HOURS STANDBY AND 5 MINUTES ALARM. SHOULD LOSS OF NORMAL 120VAC OPERATING POWER OCCUR, THE FIRE ALARM PANEL WILL AUTOMATICALLY TRANSFER TO THE STANDBY BATTERY.
- 3) A BREAK IN ANY FIELD WIRING OR GROUNDING OF ANY CONDUCTOR WILL RESULT IN THE ACTIVATION OF THE FIRE ALARM PANEL TROUBLE BUZZER, WHICH CAN BE SILENCED BY OPERATING THE "TROUBLE SILENCE" BUTTON ON THE FIRE ALARM PANEL.
- 4) POWER UP AND POWER DOWN OF THE FIRE ALARM PANEL MUST BE DONE IN THE PROPER SEQUENCE:
 POWER DOWN: DISCONNECT BATTERY AND THEN TURN OFF THE AC POWER AT THE BREAKER.
 POWER UP: TURN ON THE AC POWER AT THE BREAKER AND THEN CONNECT THE BATTERY.
 NOTE: DO NOT DISCONNECT THE AC POWER FEED FROM THE TERMINAL BLOCK TO DISCONNECT POWER.
 5) THE 120VAC POWER FEED FROM THE FIRE PANEL AND BOOSTER POWER SUPPLIES MUST BE FROM A DEDICATED EMERGENCY PANEL BREAKER, AND THE BREAKER MUST BE IDENTIFIED THAT IT IS FOR THE FIRE ALARM SYSTEM.

PROJECT # 0004-053
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7/14/03

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 FIRE PREVENTION:
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 UTILITY:

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PROJECT TITLE
**LIDO SPA HOTEL
 WEST WING - RENOVATION**
 40 ISLAND AVENUE, MIAMI BEACH, FL 33139




DRAWING TITLE
**WEST WING
 FIRE ALARM RISER, NOTES
 AND SYMBOLS**

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 CHECKED BY: R.J.M.
 ISSUES

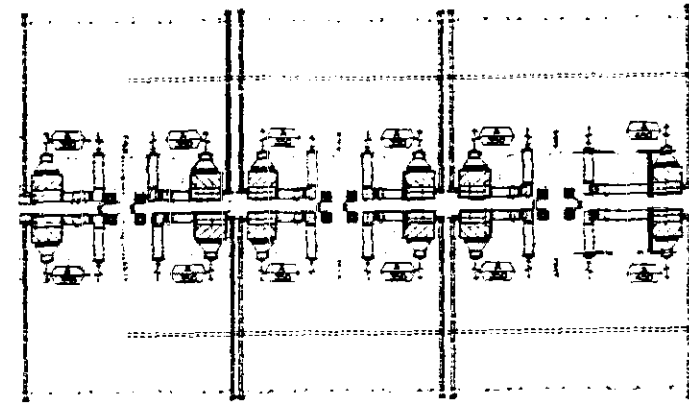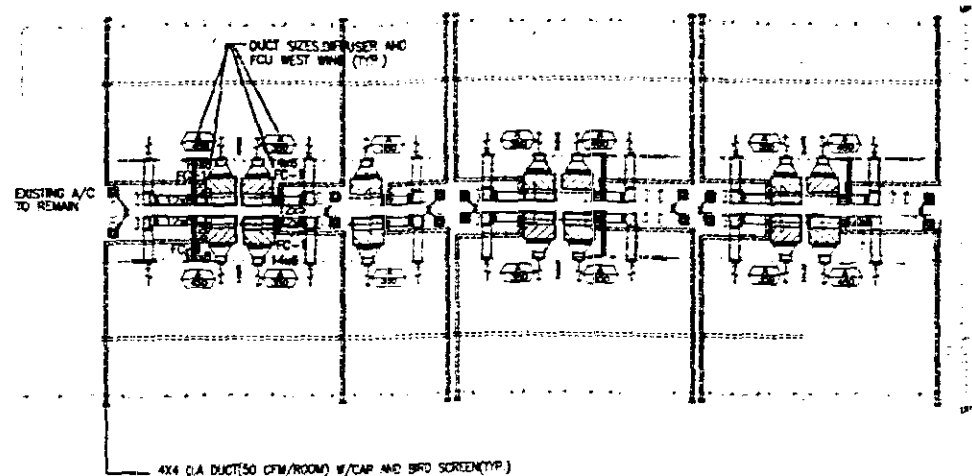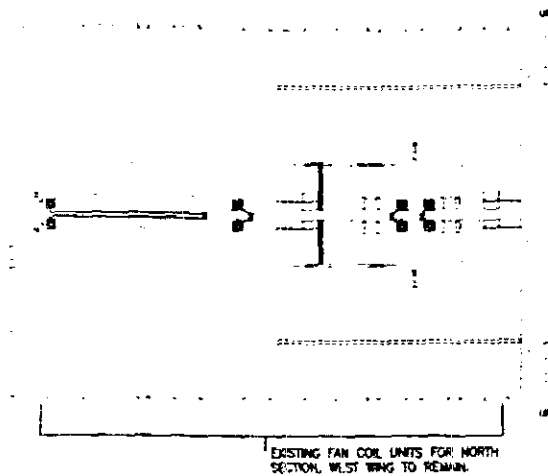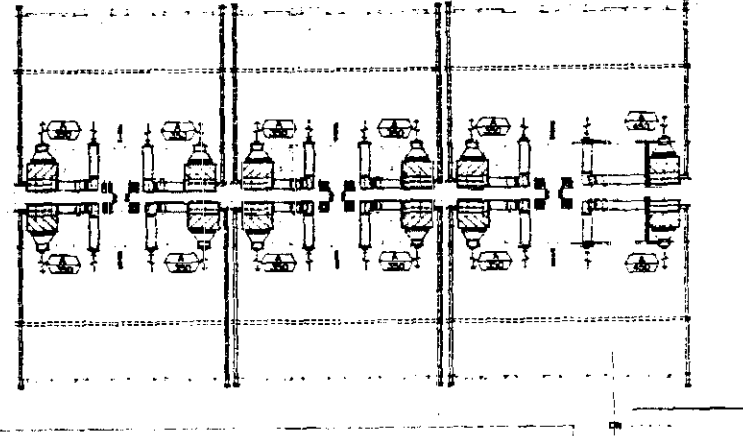
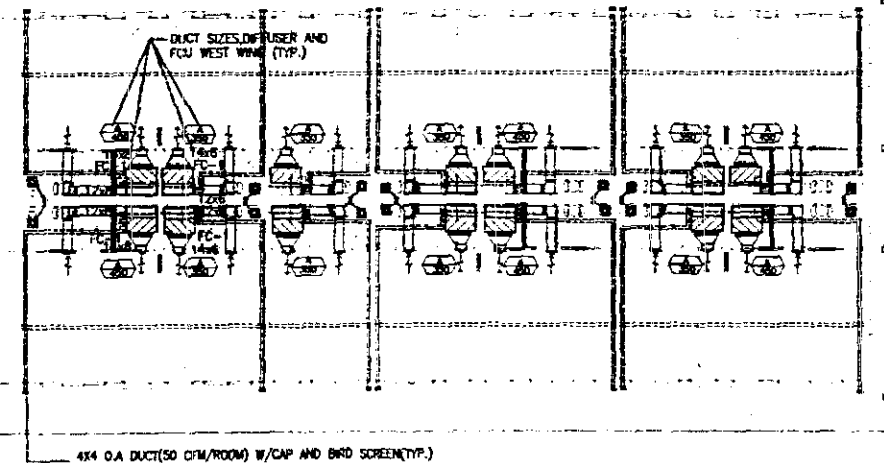
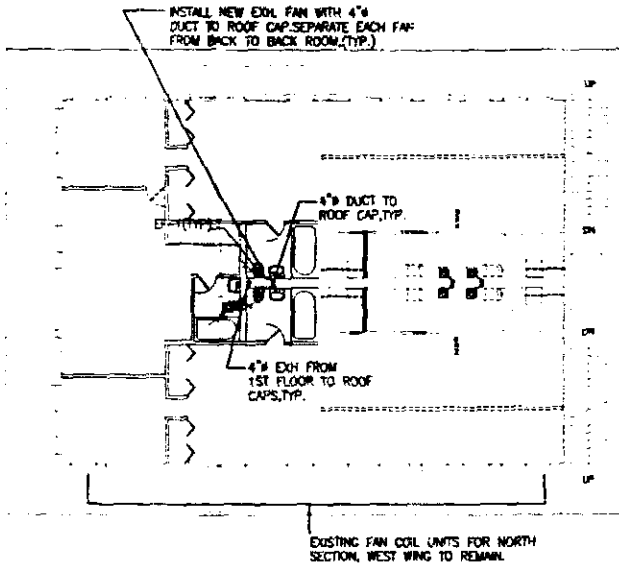
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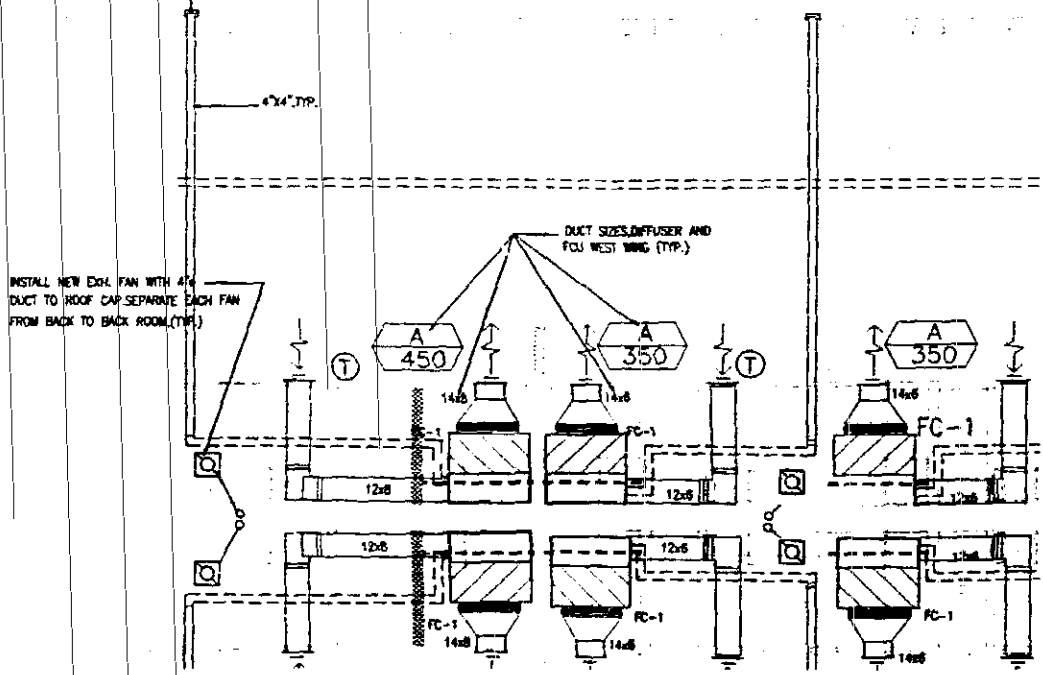
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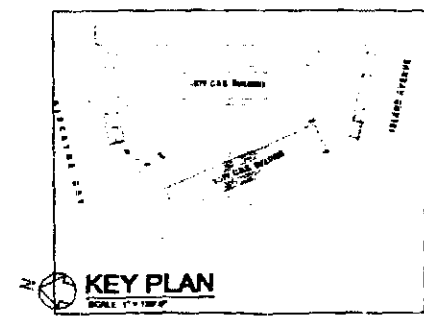
WEST WING - GROUND FLOOR - FLOOR PLAN
SCALE: 3/32"=1'-0"



WEST WING - SECOND FLOOR - FLOOR PLAN
SCALE: 3/32"=1'-0"



WEST WING - H.V.A.C. (TYP.)
SCALE: 1/4"=1'-0"



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- ELECTRICAL: _____
- MECHANICAL: _____
- FIRE PREVENTION: _____
- ENGINEERING: _____
- PUBLIC WORKS: _____
- STRUCTURAL: _____
- ACCESSIBILITY: _____

PROJECT #: 0304-053
PREPARED BY:
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Professional Electrical/Mechanical Engineers

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180 NE 38th St., Suite 222, Miami, FL 33137
305-438-1200 Fax 305-438-1221


SEAL
[Signature]
I, the undersigned, being a duly licensed Professional Engineer in the State of Florida, do hereby certify that I am the author of the design and specification herein, and that I am a duly licensed Professional Engineer in the State of Florida, and that I am not providing any other services to the project which may conflict with the duties of a Professional Engineer in the State of Florida.

PROJECT TITLE
LIDO SPA HOTEL
WEST WING - RENOVATION
40 ISLAND AVENUE, MIAMI BEACH, FL 33139

DRAWING TITLE
WEST WING
H.V.A.C FLOOR PLANS


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ISSUES

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M-1

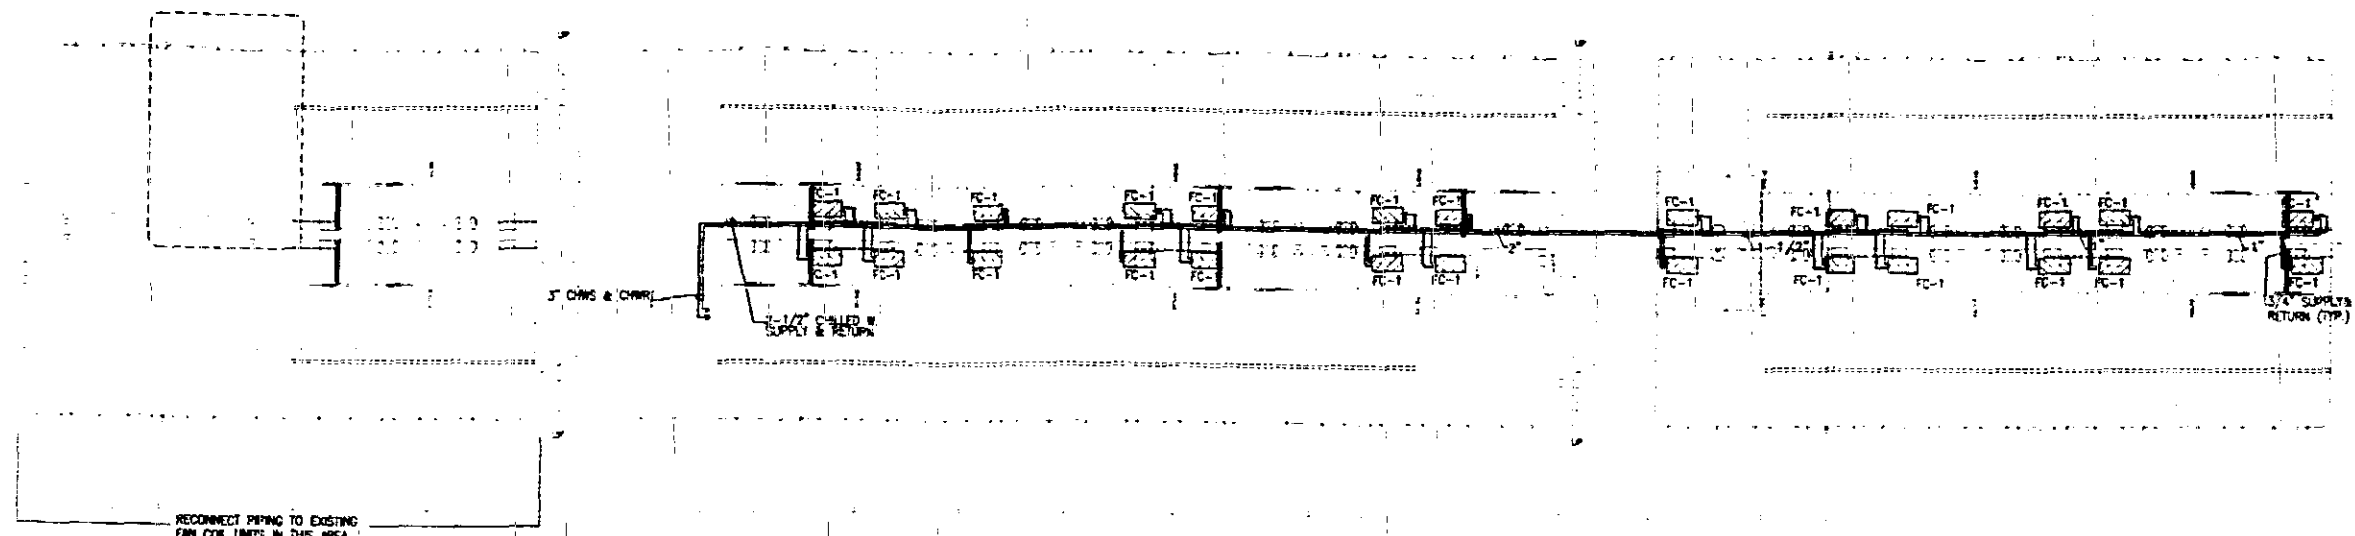


WEST WING - GROUND FLOOR - PIPING FLOOR PLAN

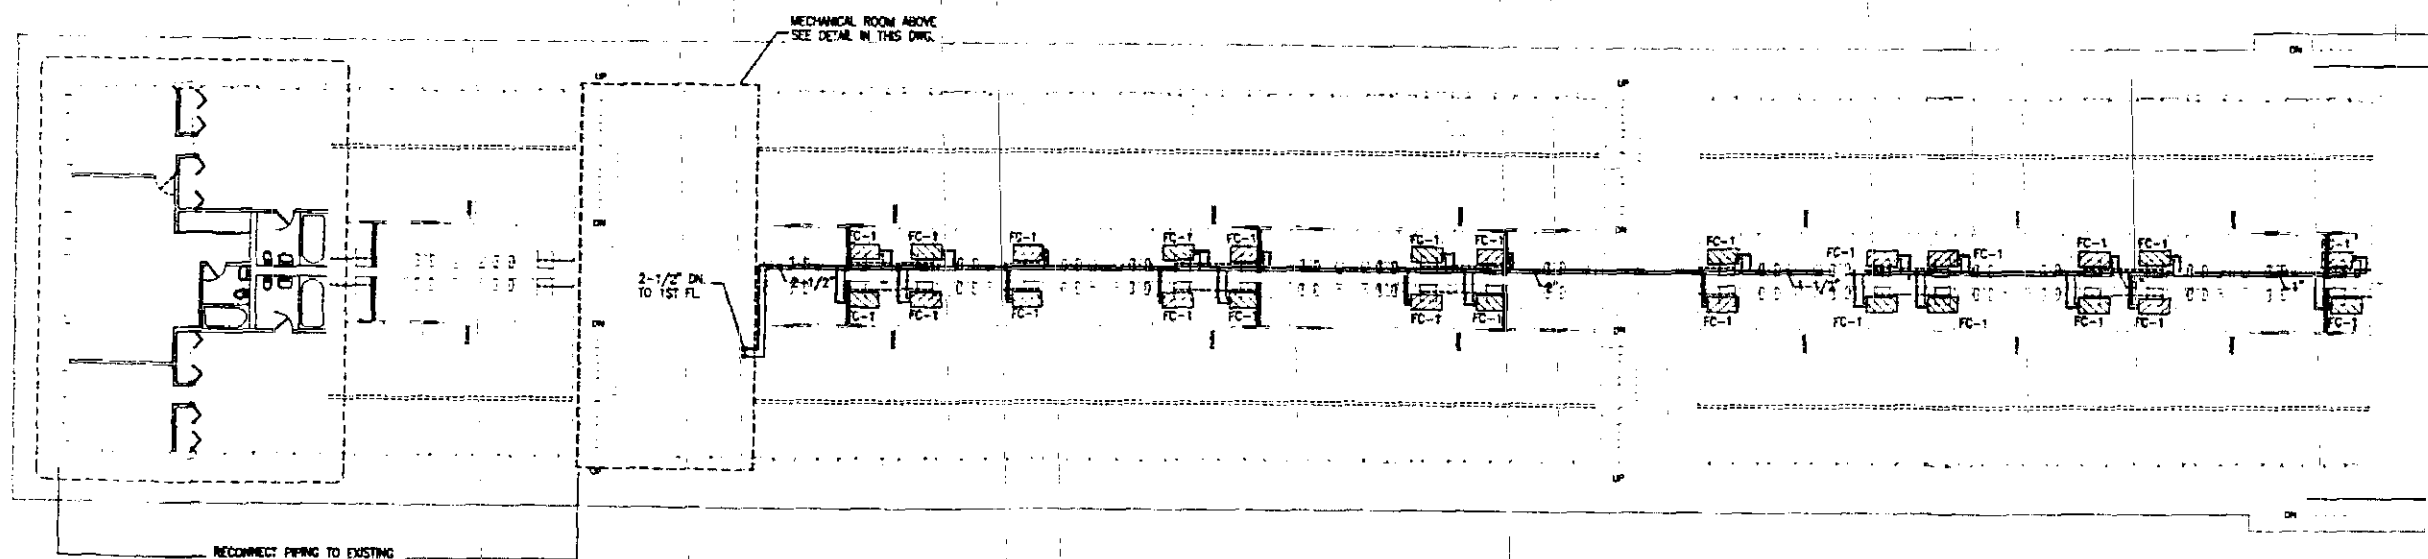SCALE: 3/32" = 1'-0"




WEST WING - SECOND FLOOR - PIPING FLOOR PLAN

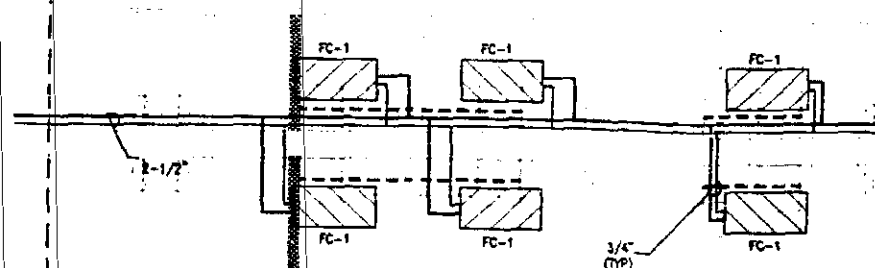SCALE: 3/32" = 1'-0"




WEST WING - PIPING FLOOR PLAN (TYP.)

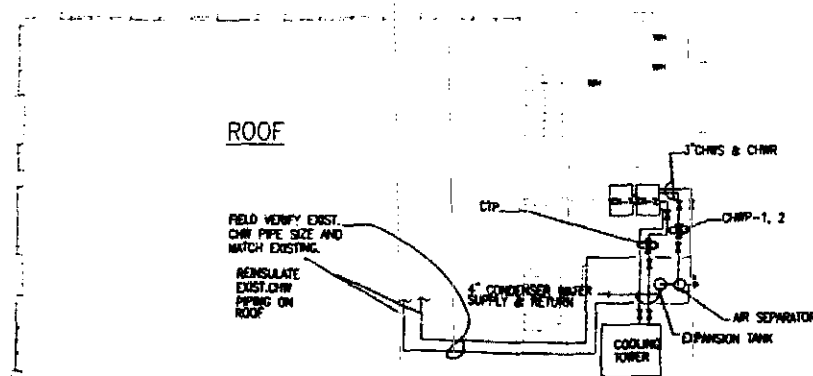SCALE: 1/4" = 1'-0"



3RD FLR. MECHANICAL ROOM

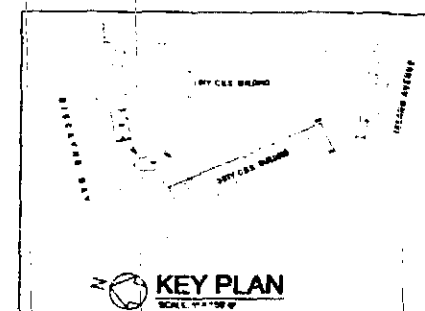SCALE: 3/32" = 1'-0"



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BUILDING:
ZONING:
DRB/HFB:
CONCURRENCY:
PLUMBING:
ELECTRICAL:
MECHANICAL:
FIRE PREVENTION:
ENGINEERING:
PUBLIC WORKS:
STRUCTURAL:
ACCESSIBILITY:
ELEVATOR:

PROJECT #: 0304-053
PREPARED BY:

UCI Engineering Inc.
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Fax: (305) 383-8949
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SEAL
[Signature]
7/14/03

NOTICE OF DOCUMENTS NOTICE
Changes and specifications in
drawings and specifications are
the property of Alison Spear. All drawings
are project for which they were prepared
and shall not be used for any other project
without the written authorization of the
architect.

PROJECT TITLE
LIDO SPA HOTEL
WEST WING - RENOVATION
40 ISLAND AVENUE, MIAMI BEACH, FL 33139

DRAWING TITLE
WEST WING
H.V.A.C PIPING FLOOR PLANS

DRAWN BY
CHECKED BY
ISSUES

SHEET NO.
M-1A

AIR HANDLING UNIT SCHEDULE																										
UNIT NUMBER	FLOWER SECTION										COOLING COIL												MANUFACTURER & MODEL	DRIP PAN BRAND DRAIN DIA	ACCESSORIES	REMARKS
	SUPPLY CFM	TOT. SP.	OA CFM	FAN TYPE	HP	FLTR. #	ENT. DEG.	LEAVING DEG.	WATER PRESS.	FACE W.C. (FT./MIN.)	TOTAL CAP. (THERM.)	DESIGNABLE CAP. (THERM.)	CHILLED WATER		COIL CONSTRUCTION		COIL TYPE	FLTR. TYPE	FLTR. AREA	FACE W.C.						
													TYPE	TEMP.	INCHES	FEET					INCHES	FEET				
CH-1	540	25	50	EC	1/2	2	55	55	10.0	1.0	18.0	11.0	FW	AS	35	3.0	3	1.0	CLMA COOL. MODEL 200-30-A	HORIZONTAL CONCEALED						

NOTE: CONTRACTOR SHALL PROVIDE SUBMITTALS OF ALL A/C EQUIPMENT AND CONTROL VALVES TO ENGINEER FOR REVIEW BEFORE INSTALLATION.



CHILLER SCHEDULE																										
CHILLER NUMBER	NOMINAL CAPACITY TONS	VOLTAGE/ PHASE	EVAPORATOR SECTION										CONDENSER SECTION							COMPRESSOR ELECTRIC DATA				MANUFACTURER & MODEL	REMARKS	ACCESSORIES
			QUANTITY OF COILS	TEMP. ENTERING DEG. F.	TEMP. LEAVING DEG. F.	COND. PRESS. PSIG	COND. FLOW GPM	COND. FAN TYPE	COND. FAN HP	COND. FAN SPEED RPM	COND. FAN TYPE	COND. FAN HP	COND. FAN SPEED RPM	MCA	MOPD	RLA	LPA									
CH-1	30	208V/3P	145	55	45	25	52.15	2	95									78	112	69	447	CUMM COOL MODELAC2-30-A				
			</																							

PUMP SCHEDULE										REMARKS	ACCESSORIES
PUMP NO.	CFM	HEAD	HP	VOLTAZ/PHASE	MODEL	MANUFACTURER	WATER	TEMP.	COMMENTS		
CH-1.2	145	70 FT	7.5	208V/3P	ALM2-6-4-10	ARMSTRONG	1/2 IN.	55	2-1/2 IN. SUPPLY PUMP ARRANGEMENT		
CH-1.2	145	70 FT	7.5	208V/3P	ALM2-6-4-10	ARMSTRONG	1/2 IN.	55	2-1/2 IN. RETURN PUMP ARRANGEMENT		





- 1- PROVIDE SUCTON GUIDE ARMSTRONG MODEL 50-44 4IN. INLET AND OUTLET SIZE
- 2- PROVIDE FLOTREX ARMSTRONG MODEL F7N-3A-F 2.5 IN. INLET & 3IN. OUTLET SIZE
- 3- PROVIDE EXPANSION TANK ARMSTRONG MODEL 5A-150
- 4- PROVIDE A VORTEX AIR SEPARATOR ARMSTRONG MODEL 10-4

FAN SCHEDULE									
FAN	CFM	SP.	HP	VOLTS/PHASE	MODEL	WTR	TEMP.	ACCESSORIES	
EF-1	50	0.1"	1/4	120V/1P	SP-5		GREENHILL		

SUPPLY/RETURN AIR DIFFUSER SCHEDULE						
DIFFUSER	NECK	SIG.	PATERN	MANUFACTURER	CATALOG	COMMENTS
A				TRUS	300PL	12-6 SUPPLY REGISTER
B				TRUS	300PL	12-6 SUPPLY REGISTER
1				TRUS	300PL	6-6 RETURN REGISTER
2				TRUS	300PL	6-6 RETURN REGISTER

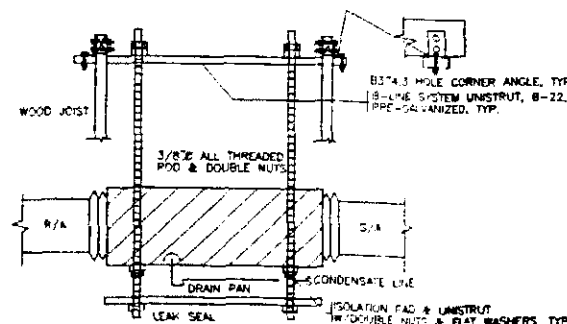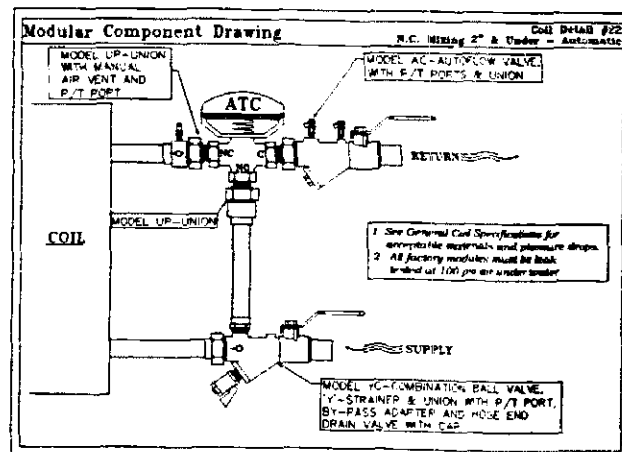

COOLING TOWER SCHEDULE									
UNIT DESIGNATION		-							
LOCATION		MECHANICAL ROOM							
TOWER TYPE		SIDE DISCHARGE							
NUMBER OF CELLS		1							
OPERATING HEIGHT, LBS.		2948							
NOMINAL CAPACITY, TONS		60							
WATER FLOW, GPM		100							
ENTERING/LEAVING WATER TEMP. °F		95/85							
AMBIENT AIR TEMP. °F		-							
STATIC LIFT REQ'D FT. H ₂ O		7.99							
DRIVE		-							
NUMBER OF FANS		1							
FAN WHEEL TYPE & DIAMETER		4 BLADES, 4 FT							
FAN MOTOR TYPE		-							
FAN MOTOR HP		5							
FAN MOTOR SPEED, RPM		678							
ELECTRICAL SERVICE		#12/1V							
VIBRATION ISOLATION TYPE (BT TOWER WFR)		-							
MIN. STATIC DEFLECTION, IN.		-							
MANUFACTURER AND MODEL		MARLEY AQUATOWER							
MODEL		494C							

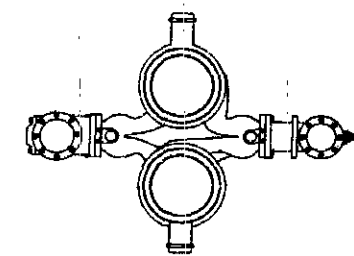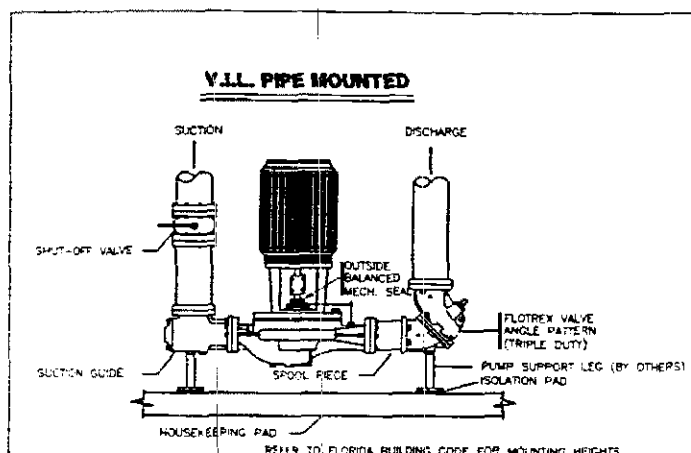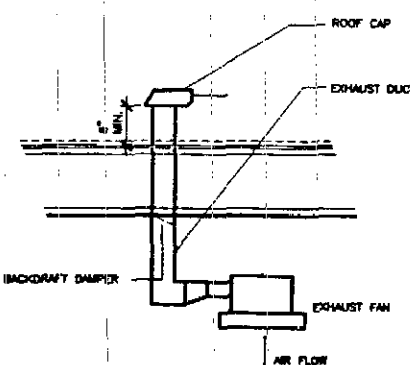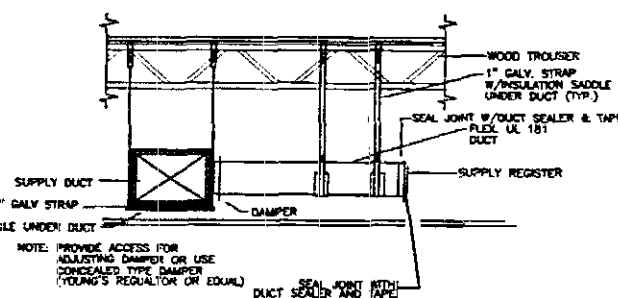

TYPICAL SPECIFICATIONS

MODEL "X" 1/2" ASME, PRE-CHARGED DAPNORUM EXPANSION TANK

WORKING PRESSURE: 125PSIG

TANK SHALL BE PROVIDED WITH A HEAVY-DUTY BUTYL DAPNORUM TANK SHALL BE PROVIDED WITH A RING BASE LIFTING RINGS, AND A RPT SYSTEM CONNECTION. AN AIR CHARGING VALVE CONNECTION (STANDARD FIRE VALVE) SHALL BE ALSO PROVIDED TO FACILITATE ADJUSTING PRE-CHARGE PRESSURE TO MEET THE ACTUAL SYSTEM CONDITIONS

TYPICAL SPECIFICATIONS

VORTEX AIR SEPARATOR - VALVE MODEL

WORKING PRESSURE: 30PSI

180 ° F.M.

GENERAL NOTES

- 1- SCOPE OF WORK: WORK SHALL INCLUDE ALL LABOR EQUIPMENT AND MATERIALS FOR THE INSTALLATION OF ALL OPERATING MECHANICAL EQUIPMENT WITH THE EXCEPT OF ALL MECHANICAL, HEATING AND VENTILATION WORK AS SHOWN ON DRAWINGS HEREIN SPECIFIED AND/OR EQUAL EQUIPMENT FOR APPROVAL.
- 2- CHILLED WATER PIPING AND INSULATION: WORK HORIZONTAL PIPING IN CONCRETE TYPE "C" WITH 1-1/2" FOMGLASS INSULATION PIPING TO FAN COIL UNITS MUST BE SOFT COVER WITH 1" ARMEX INSULATION CONNECTIONS BETWEEN THE WORK PIPING AND THE 5" COILS HAVE METALLIC CONNECTIONS.
- 3- GUARANTEE: CONTRACTOR SHALL PROVIDE A WRITTEN GUARANTEE COVERING ALL WORKMANSHIP AND MATERIALS FOR A PERIOD OF ONE YEAR FROM DATE OF ACCEPTANCE.
- 4- CONTRACTOR SHALL PROVIDE POSITIVE MEANS FOR BALANCING EACH MECHANICAL AIR CONDITIONING SUPPLY AIR OUTLET, AS PER SCHEDULES AND DRAWINGS. SYSTEMS SHALL BE BALANCED AGAINST THE ACTUAL INSTALLED STATIC PRESSURE.
- 5- BEFORE SUBMITTING HIS FINAL PROPOSAL, THE CONTRACTOR SHALL EXAMINE THE SITE OF THE PROPOSED WORK TO DETERMINE THE EXISTING CONDITIONS THAT MAY AFFECT HIS WORK AS HE WILL BE RESPONSIBLE FOR ANY ASSUMPTIONS MADE BY HIM IN REGARDS THEREOF.
- 6- ANY APPARATUS, APPLIANCE, MATERIALS, WORK OR INCIDENTAL ACCESSORIES OF WHICH DETAILS NOT SHOWN BUT NECESSARY TO MAKE THE WORK COMPLETE AND PERFECT IN ALL RESPECTS AND READY FOR OPERATION, EVEN IF NO PARTICULARLY SPECIFIED SHALL BE PROVIDED BY THE CONTRACTOR WITHOUT ANY ADDITIONAL EXPENSE FOR THE OWNER.
- 7- DUCTWORK: 1) DUCTWORK SHALL BE PREPARED FOR ROOF OR AIR CONDITIONED SUPPLY AND RETURN DUCTWORK AND METAL FOR EXHAUST AND NON-CONDITIONED OUTSIDE. 2) CLASS FIBER DUCTWORK SHALL BE 100% NON-FLAMMABLE RECTANGULAR DUCT SYSTEM TYPE "UL-181" OR EQUAL, 1-1/2" INSULATION P-I-E-S, CONFORMING TO APPLICATION MANUAL PUE # 5-01-2024 & DESIGN GUIDE PUE # 5-01-2024. 3) METAL DUCTS SHALL BE IN ACCORDANCE WITH THE LATEST ISSUE OF THE LOW-VOLUTY DUCT CONSTRUCTION STANDARDS, PUBLISHED BY THE "DUCT METAL AND AIR CONDITIONED CONTRACTORS NATIONAL ASSOCIATION, INC." AND THE LATEST PUBLICATION OF GUIDE & DATA BOOK OF THE "AMERICAN SOCIETY OF HEATING, VENTILATING AND AIR CONDITIONING ENGINEERS".
- 8- CONTRACTOR SHALL ASSUME RESPONSIBILITY FOR ALL COSTS INCURRED RESULTING FROM SUBSTITUTION OF EQUIPMENT AS WELL AS THE PERFORMANCE OF SUCH EQUIPMENT.
- 9- VIBRATION ISOLATION: PROVIDE SUPPORTS OR MOUNTS FOR ALL EQUIPMENT LOCATED WITHIN THE BUILDING STRUCTURE POWERED BY ONE HORSEPOWER OR LARGER WITH FLEXIBLE PIPING CONNECTIONS SHALL BE PROVIDED FOR ALL PIPING CONNECTED TO EQUIPMENT MOUNTED OR SUPPORTED BY VIBRATION ISOLATORS.
- 10- TESTS: ALL TESTS SHALL BE PERFORMED AS REQUIRED DURING THE DIFFERENT STAGES OF WORK AND A FINAL 24 HOURS MINIMUM RUNNING TEST SHALL BE DONE AFTER ALL OTHER TESTS AND BALANCING OPERATIONS HAVE BEEN DONE.
- 11- CONDENSATE PIPING: CONDENSATE PIPING SHALL BE PVC SCHED. 40 EXCEPT IN RETURN AIR PLenums SPACES WHERE COPPER PIPING MUST BE USED.
- 12- TEST AND BALANCE: OF ALL EQUIPMENT SHALL BE PERFORMED BY AN INDEPENDENT TEST AND BALANCE COMPANY WITH A MINIMUM OF 5 YEARS EXPERIENCE IN PROJECTS OF THIS SIZE OR LARGER. THREE COPIES OF THE TEST AND BALANCE REPORT SHALL BE SUBMITTED TO THE ENGINEER FOR REVIEW.

HVAC DESIGN REQUIREMENTS	YES	NO
DUCT SMOKE DETECTOR		X
FIRE DAMPERS		X
SMOKE DAMPERS		X
FIRE RATED ENCLOSURE		X
FIRE RATED ROOF/FLOOR		X
CEILING ASSEMBLY		X
FIRE STOPPING	X	
SMOKE CONTROLS		X

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CITY OF MIAMI BEACH
APPROVED FOR PERMIT BY
THE FOLLOWING:

BUILDING:
ZONING:
DR/HRP:
CONCURRENCY:
PLUMBING:
ELECTRICAL:
FIRE PREVENTION:
ENGINEERING:
PUBLIC WORKS:
STRUCTURAL:
ACCESSIBILITY:
ELEVATOR:

PROJECT #: 0304-053
PREPARED BY:

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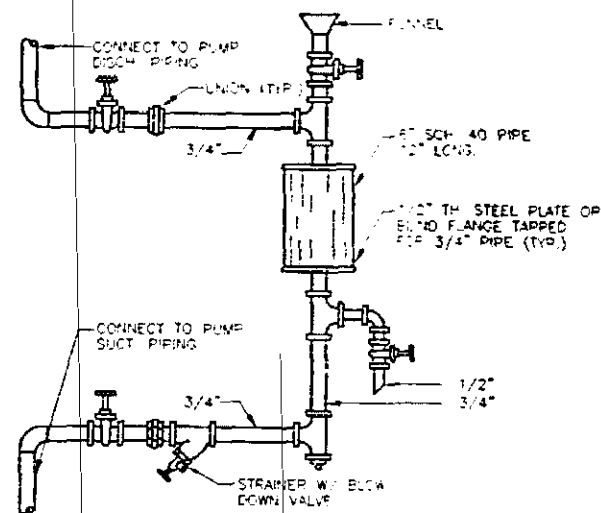
PROJECT TITLE
LIDO SPA HOTEL
WEST WING - RENOVATION
40 ISLAND AVENUE, MIAMI BEACH, FL 33139

DRAWING TITLE
WEST WING
H.V.A.C. NOTES AND DETAILS

DRAWN BY: M.G.
CHECKED BY: R.J.M.
ISSUES

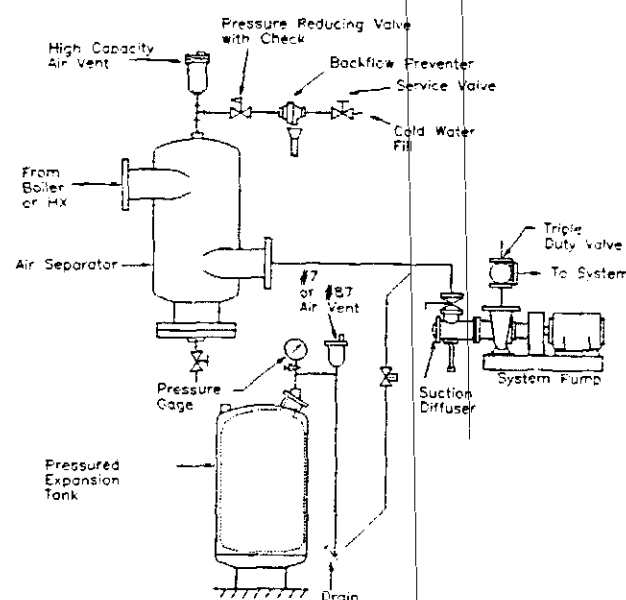
SHEET NO.

M-2




CHEMICAL FEEDER DETAIL
N.T.S.

- 1- PROVIDE BYPASS TYPE CHEMICAL FEEDER FOR CHILLED WATER SYSTEM AS MANUFACTURED BY MOBILE SLP
- 2- CHEMICALS SHALL BE E.P.A. REGISTERED.
- 3- PROVIDE SUPPORT STAND
- 4- INSULATED SHOT FEEDER SUPPLY AND DISCHARGE LINES FOR A DISTANCE OF 6 FEET FROM THE CHILLED WATER LINE TAP.



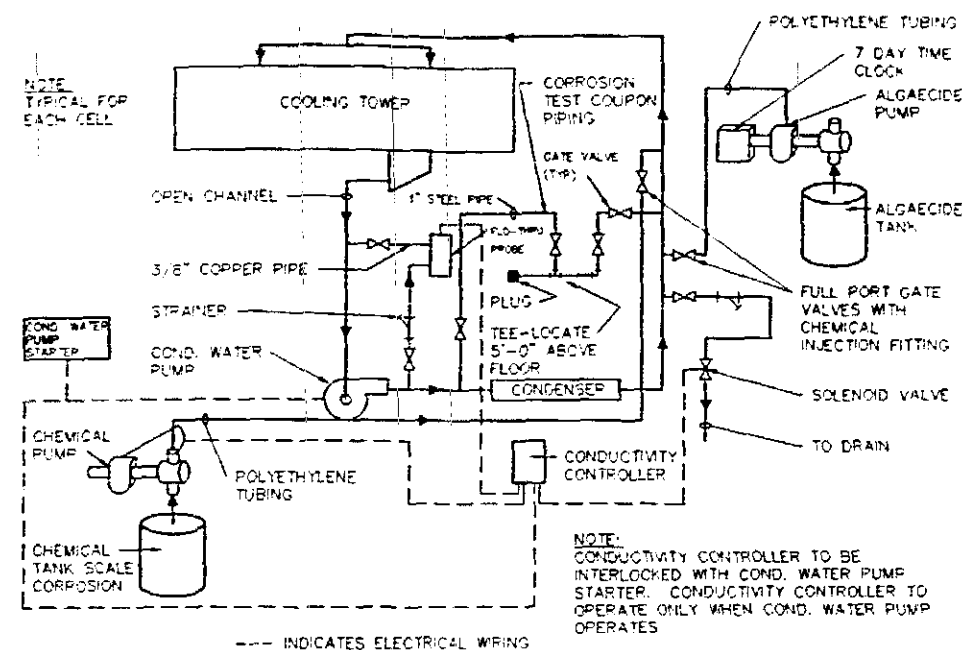EXPANSION TANK & AIR SEPARATOR INSTALLATION
N.T.S.



WATER TREATMENT DIAGRAM
N.T.S.

Project # **ASHRAE STANDARD 62-1989 OUTSIDE AIR CALCULATIONS**
0304-053

Date: **5/15/2003**

Name: **LIDO SPA HOTEL/ WEST WING**

Address: **40 ISLAND AVENUE**
MIAMI BEACH, FL. 33139

Application: **ROOM**

Area: **230** sq. ft. Area factor: **100.00%**

Occupancy: **P/1000** sq. ft. Total Occupancy: **People**

Outdoor Air: **30** cfm/room Total Outside Air: **30** cfm

OFFICE OF THE
CITY OF MIAMI
APPROVED FOR PERMIT
THE FOLLOWING:

BUILDING: **201/2/3/3**
ZONING: **201/2/3/3**
DRB HPB: **201/2/3/3**
CONCURRENCY: **201/2/3/3**
PLUMBING: **201/2/3/3**
ELECTRICAL: **201/2/3/3**
MECHANICAL: **201/2/3/3**
FIRE PREVENTION: **201/2/3/3**
ENGINEERING: **201/2/3/3**
PUBLIC WORKS: **201/2/3/3**
STRUCTURAL: **201/2/3/3**
ACCESSIBILITY: **201/2/3/3**
ELEVATOR: **201/2/3/3**

PROJECT #: 0304-053
PREPARED BY:

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SEAL
[Signature]

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LIDO SPA HOTEL
WEST WING - RENOVATION
40 ISLAND AVENUE, MIAMI BEACH, FL 33139

DRAWING TITLE
WEST WING
H.V.A.C NOTES AND DETAILS

DRAWN BY **E2**
CHECKED BY **RJM**
ISSUES

01-11-03 PERMIT SET

SHEET NO.

M-3

Typical Specifications

Series 4382 Close Coupled Vertical In-Line Pump

Tag No.	Service	Location	Size	Motor	Mfr Speed	Electric
CT-1.2			4x4x10	7.5 hp	1800 rpm	60/3/208

Supply and install as shown on the plans and specifications, Armstrong Series 4382 close coupled type Vertical In-Line centrifugal pumping unit. The cast casing with equal size suction and discharge flanges, having separate tapped flush line and pressure gauge connections, shall incorporate two readily split, single stage centrifugal pumps. Each pump shall have a cast bronze dynamically balanced impeller, bronze shaft sleeve and inside type single spring mechanical seal. Each pump shall be complete with a factory furnished flush and vent line. Each driving motor shall be an industry standard vertical solid shaft, squirrel cage induction type, built to NEMA standards (Premium Efficiency motors may be specified). The motor shall have drip proof enclosure and be suitable for a 60 Hz 3 Ph 208 Volts power supply. The inlet and outlet ports on the casing shall be at least one size larger than the single pump size, so that both units may operate in parallel with no loss of single pump efficiency. Each port shall be fitted with a stainless steel isolation valve that allow the units to operate in parallel, or standby, yet may be used to isolate one pumping unit for servicing or removal, with the other pump still operating.

Typical Specifications

Series 4382 Close Coupled Vertical In-Line Pump

Tag No.	Service	Location	Size	Motor	Mfr Speed	Electric
CW-1.2			4x4x10	7.5 hp	1800 rpm	60/3/208

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Typical Specifications

Suction Guides

Furnish and install on the suction of each pump, an Armstrong Suction Guide with Cast Iron Body, Outlet Guide Valves, Removable Stainless Steel Strainer and Fine Mesh Start-up Strainer. The mechanical contractor shall inspect the Strainer prior to start-up of pump and shall remove the Fine Mesh Brass Strainer after a short running period. Space shall be provided for removal of Strainer and connection of blowdown valve.

Typical Specifications

Flanged Flo-Trex Combination Valves

Furnish and install on the discharge side of each pump an Armstrong Model FTV Flo-Trex Combination Valve incorporating three functions in one body: tight shut-off, spring-closure type silent non-stem check and flow measurement/throttling.

Valve body shall be cast iron with 125 psi ANSI flanged ends. The body shall have two 1/2" NPT connections on each side of the valve seat. Two connections to have brass pressure and temperature metering ports, with Nerdol check valves and gasketed caps. Two other connections to be supplied with brass drain plugs. Metering ports are to be interchangeable with drain ports to allow for measurement flexibility when installed in tight locations.

The valve disc shall be bronze plug disc type with high impact engineered resin seat to ensure tight shut-off and silent check valve operation.

The valve stem shall be stainless steel with flat surfaces provided for adjustment with open end wrench.

The valve shall be selected and installed in accordance with the manufacturer's instructions and be suitable for the pressure and temperature encountered.

Insulation (2X" - 6")

Each valve shall be furnished with a pre-formed removable PVC insulation jacket to meet ASTM D 1784/Class 14253-C, MEA #7-57, ASTM-E-84, and ASTM-138 with a flame spread rating of 25 or less and a smoke development rating of 50 or less. There will be provided sufficient mineral fiberglass insulation to meet ASHRAE 90.1-1989 specifications in operating conditions with maximum Fluid Design Operating Temperature Range of 141-200°F and Mean Rating Temperature of 125°F.

Typical Specifications

Tag No. ET-1W

Diaphragm Expansion Tanks - Series "AX-V"

Furnish and install as shown on the plans, Armstrong Model "AX-15V" ASME Pre-charged Diaphragm Expansion Tank, stamped 125 PSI working pressure. Tank shall be supplied with a heavy-duty butyl diaphragm. Tank shall be provided with a ring base, lifting rings, and a NPT system connection. An air charging valve connection (standard the valve) shall be also provided to facilitate adjusting pre-charge pressure, to meet the actual system conditions.

Typical Specifications

Tag No. AS-1W

Vortex Air Separator - VA Model (less system strainer)

Furnish and install as shown on plans, an Armstrong air separator with tangential nozzles. The Vortex Air Separator model VA-4 shall be designed and constructed in accordance with Section VIII, Division 1 of the ASME Boiler and Pressure Vessel Code, and shall be fitted with an NPT vent connection to facilitate installation of piping to connect a compression tank or an air vent to the air separator. An NPT tapping shall be provided on the bottom of the air separator to facilitate blow-down. The unit will operate for an input flow rate value of 180 ugm, a working pressure of 30 psi and a working temperature of 55 °F.

NOTE: Sizes 2", 2 1/2" and 3" shall have a cast iron body with NPT connections, while sizes 4"-24" shall have a fabricated steel body with flanged connections.

OFFICE COPY

CITY OF MIAMI BEACH
APPROVED FOR PERMIT BY
THE FOLLOWING:

BUILDING: _____
ZONING: _____
DRB/HFB: _____
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PLUMBING: _____
ELECTRICAL: _____
MECHANICAL: _____
FIRE PREVENTION: _____
ENGINEERING: _____
PUBLIC WORKS: _____
STRUCTURAL: _____
ACCESSIBILITY: _____
ENVIRONMENTAL: _____

PROJECT #: 0304-053
PREPARED BY:

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SEAL
7/14/13

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PROJECT TITLE
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WEST WING - RENOVATION
40 ISLAND AVENUE, MIAMI BEACH, FL 33139


DRAWING TITLE
WEST WING
H.V.A.C NOTES AND DETAILS

DRAWN BY: M.G.
CHECKED BY: R.J.M.
ISSUES


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SHEET NO.

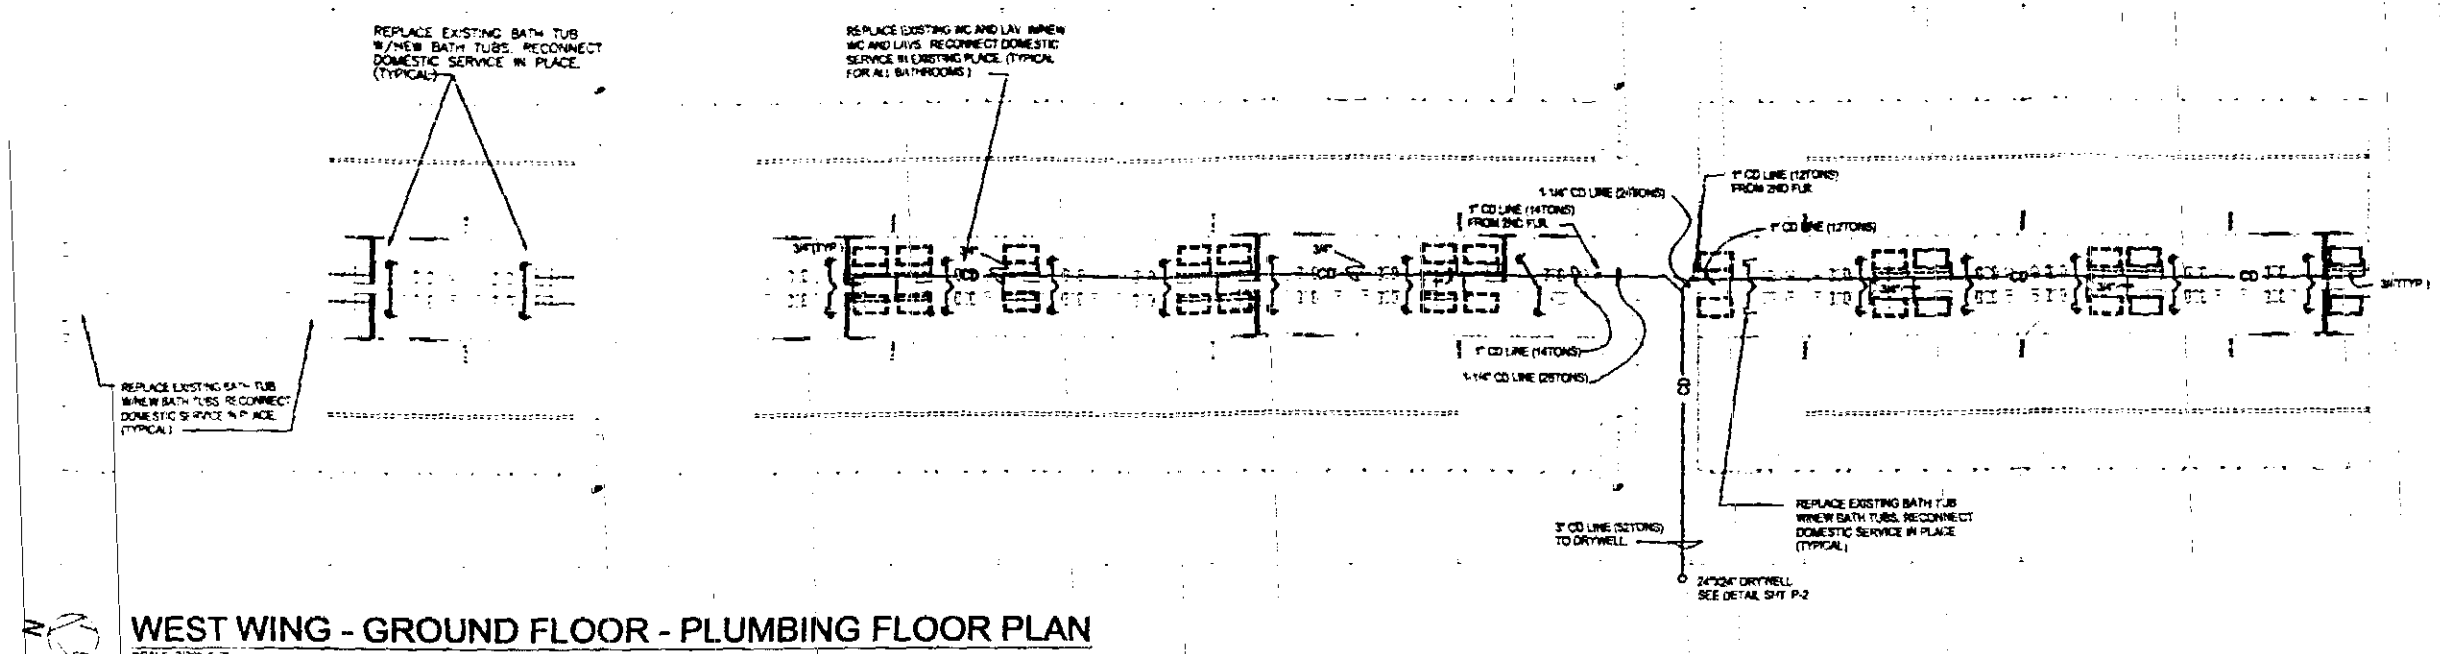
M-4



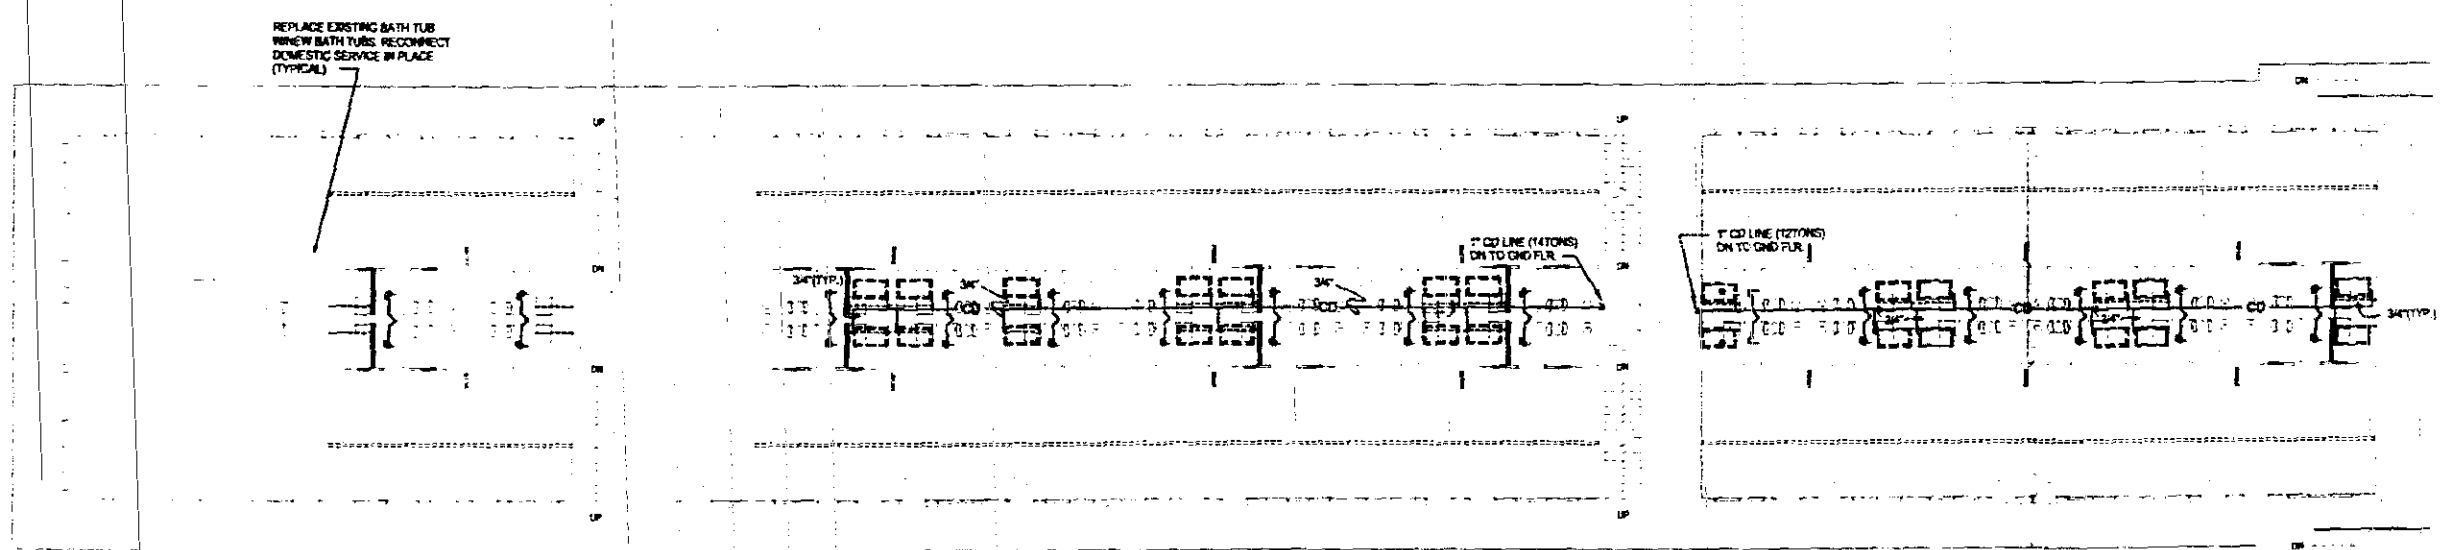
WEST WING - GROUND FLOOR - PLUMBING FLOOR PLAN
SCALE: 3/32" = 1'-0"



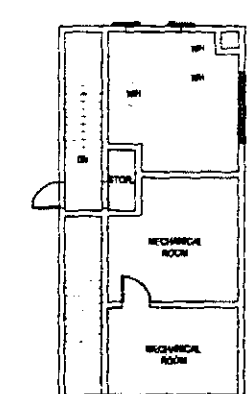WEST WING - SECOND FLOOR - PLUMBING FLOOR PLAN
SCALE: 3/32" = 1'-0"



WEST WING - 3RD FLR.

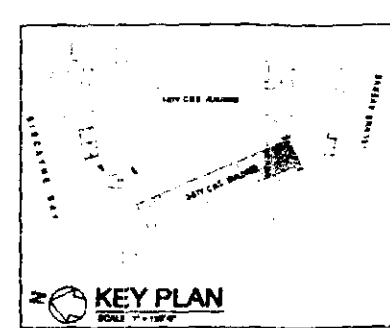

KEY PLAN

OFFICE COPY
CITY OF MIAMI BEACH
APPROVED FOR PERMIT BY
THE FOLLOWING:

BUILDING:	
ZONING:	
DRB HPR:	
CONCURRENCY:	
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Professional Electrical, Mechanical
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SEAL
DATE: 8/17/03
2/14/03

PROJECT TITLE
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WEST WING - RENOVATION
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DRAWING TITLE
WEST WING
PLUMBING FLOOR PLANS

DRAWN BY I.B.
CHECKED BY R.J.M.
ISSUES
SHEET NO.
P-1

NOTE:

CONTRACTOR SHALL VERIFY EXACT LOCATION AND SIZES OF ALL EXISTING LINES AND EXTEND AS REQUIRED.

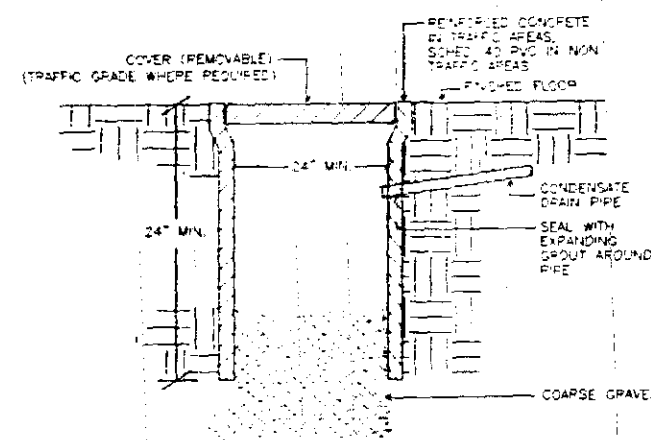
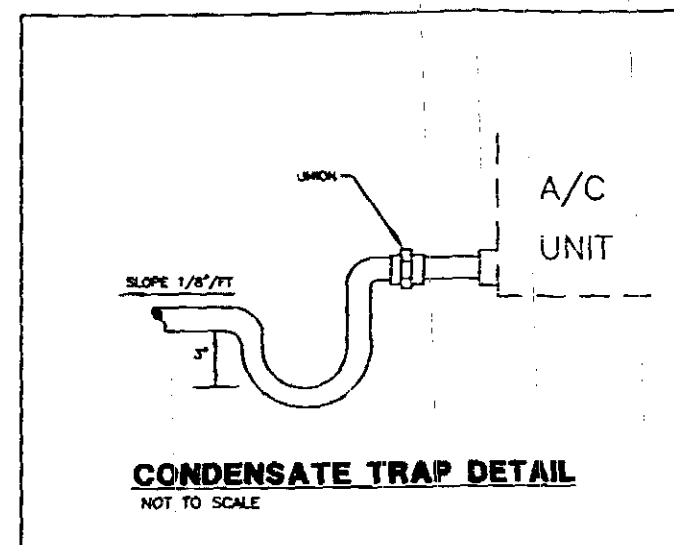
NO JOINTS ALLOWED UNDER SLAB FOR WATER LINES.

SIZE AND GRADE HORIZONTAL DRAINAGE PIPING 2" AND SMALLER 1/4" AND 3" ABOVE 1/8" SLOPE PER FOOT.

PROVIDE ANTI-SCALD VALVE TO THE BATH TUBS, SHOWERS, SINKS AND LAVATORIES.

PLUMBING NOTES

- 1- THE SPECIFICATIONS AND DRAWINGS ARE EXTENDED TO THE WORK ONLY AS A BASIS UPON WHICH THE CONTRACTOR SHALL OBTAIN A CONTRACT FOR THE DEMOLITION WORK OF THE PRESENT FLOOR SLAB SYSTEM AS INDICATED ON THE PLANS.
- 2- THE CONTRACTOR SHALL COORDINATE HIS WORK OR ADJUST SAME TO THAT OF OTHER TRADES, IN ORDER THAT CONFLICTS IN SPACE LOCATIONS DO NOT OCCUR.
- 3- THE WORK UNDER THIS CONTRACT SHALL BE PERFORMED SIMULTANEOUSLY WITH WORK OF OTHER TRADES, SO AS TO NOT DELAY THE OVERALL PROGRESS OF THE WORK.
- 4- THE CONTRACTOR SHALL VISIT THE PREMISES AND COMPARE SAME WITH THE DRAWINGS AND SPECIFICATIONS AND SATISFY HIMSELF OF THE CONDITIONS EXISTING AT THE BUILDING BEFORE DELIVERY OF HIS PROPOSAL. NO ADDITIONAL ALLOWANCE WILL BE MADE TO THE CONTRACTOR DUE TO HIS NEGLIGENCE OR FAILURE TO COMPLY WITH THE SPECIFIED REQUIREMENTS.
- 5- DEMOLITION OF EXISTING PLUMBING WORK SHALL BE PERFORMED AND COMPLETED UNDER THIS SECTION OF THE WORK.
- 6- REMOVE/RELOCATE EXISTING PIPING NOT REQUIRED, OR IN CONFLICT WITH NEW CONSTRUCTION INCLUDING DRAINAGE, WATER, FIRE SPRINKLERS, AND SATISFY CODE REQUIREMENTS FOR PROHIBITED DEAD ENDS. REMOVE/RELOCATE SPRINKLER HEADS TO SUIT NEW ARCHITECTURAL LAYOUT.
- 7- MATERIALS SHALL BE ALL NEW AND AS FOLLOWS:
 - A) DRAINAGE PIPING: NO HUB CAST IRON, STD 301 OR PVC-DWV, SCH 40.
 - B) WATER PIPING: TYPE K COPPER, PIPES COATED WITH ASPHALT & SLEEVES (BELOW GROUND); TYPE L OR M COPPER (ABOVE GROUND).
 - C) A/C CONDENSATE DRAIN: PVC SCH 40, EXCEPT IN PLENUM AREAS, WHERE SHALL BE COPPER.
 - D) PLUMBING FIXTURES: AMERICAN STANDARD, KOHLER, CRANE OR EQUAL.
 - E) GAS PIPING: BLACK IRON, SCHEDULE 40.
- 8- CAP EXISTING HOT/COLD WATER, WASTE, VENT, AND SOIL PIPING AT A POINT THAT DOES NOT INTERFERE WITH NEW CONSTRUCTION, (E.G. BELOW FINISHED FLOOR, BEHIND FINISHED WALLS, OR ABOVE FINISHED CEILING).
- 9- THE WORK SHALL INCLUDE THE FURNISHING OF ALL MATERIALS, CUTTINGS, EXTENSIONS, CONNECTIONS, REPAIRING, ADAPTING, AND OTHER WORK INCIDENTAL THERETO, TOGETHER WITH SUCH TEMPORARY CONNECTIONS AS MAY BE REQUIRED.
- 10- EXISTING FIXTURES, MATERIALS AND EQUIPMENT TO BE REMOVED SHALL BE SALVAGED OR DISPOSED OF AS DIRECTED BY THE OWNER.
- 11- ANY WORK NOT SHOWN ON THE DRAWINGS OR SPECIFICALLY MENTIONED IN THE SPECIFICATIONS BUT CONSIDERED NECESSARY FOR THE COMPLETION OF THE WORK IN PROPER MANNER SHALL BE PROVIDED BY THIS CONTRACTOR WITHOUT ADDITIONAL CHARGE.
- 12- CONTRACTOR SHALL DO HIS OWN CUTTING AND REMOVAL OF ALL HIS RELATED WORK IN ALL LOCATIONS WHERE REQUIRED, EXCEPT WHERE OTHERWISE SHOWN ON THE DRAWINGS.
- 13- DO NOT SCALE THIS LAYOUT. CONTRACTOR SHALL VERIFY EXACT LOCATION OF ALL PIPES.



DRYWELL DETAIL
NO SCALE

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CITY OF MIAMI
APPROVED FOR PERMIT
THE FOLLOWING:

BUILDING: _____
ZONING: _____
DREHP: _____
CONCURRENCY: _____
PLUMBING: _____
ELECTRICAL: _____
MECHANICAL: _____
FIRE PREVENTION: _____
ENGINEERING: _____
PUBLIC WORKS: _____
STRUCTURAL: _____
ACCESSIBILITY: _____

PROJECT #: 0304-053
PREPARED BY:

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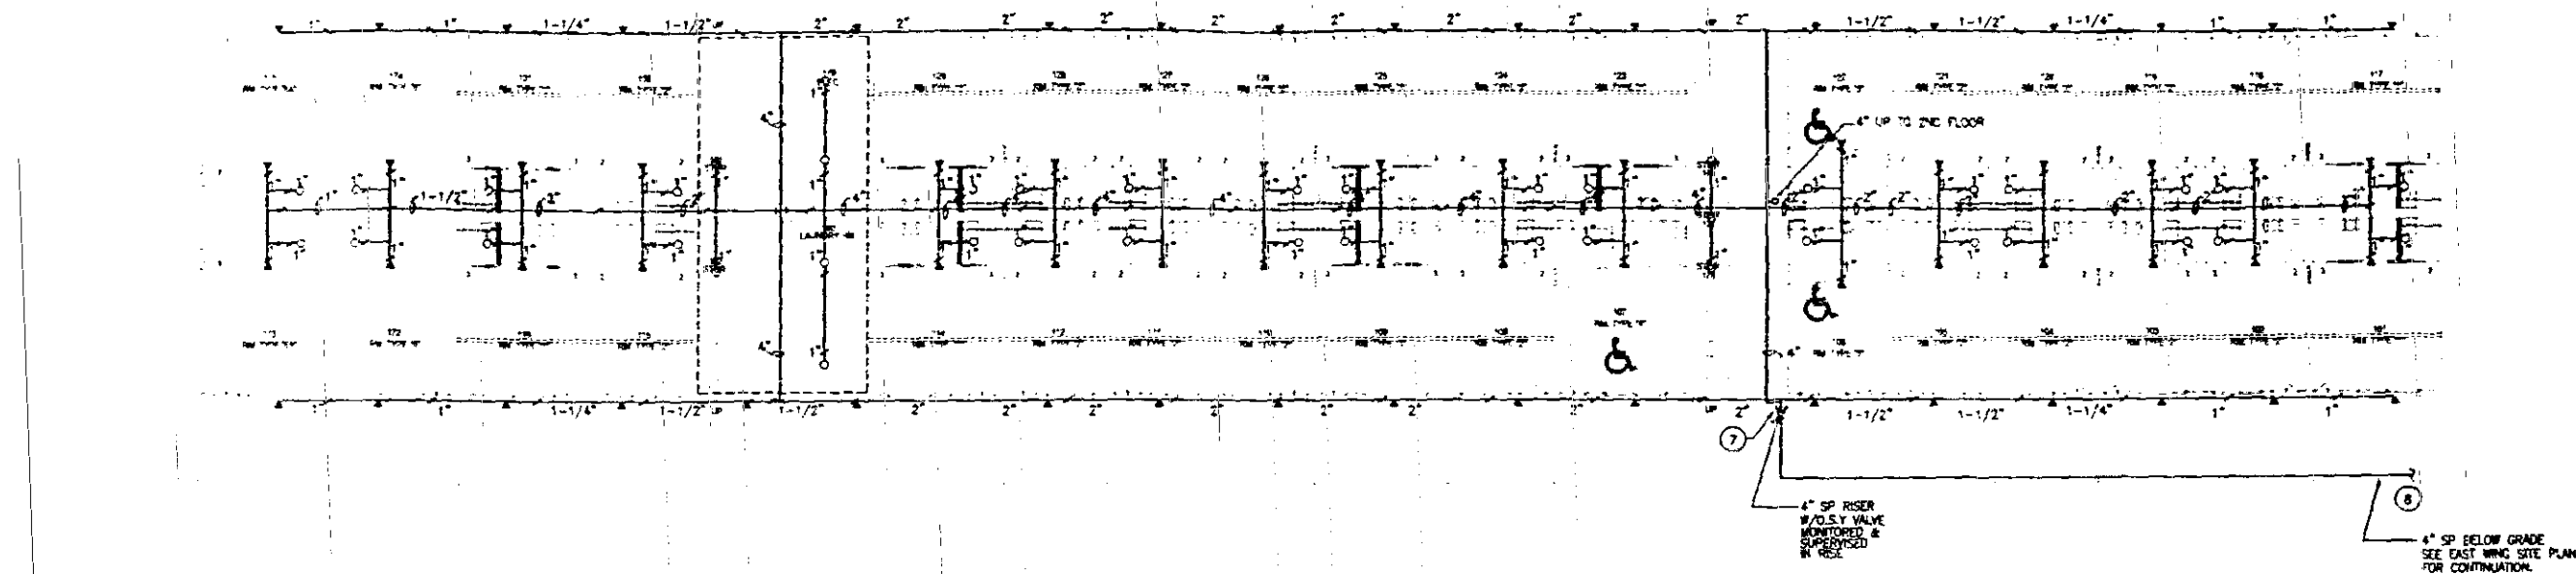
PROJECT TITLE
LIDO SPA HOTEL
WEST WING - RENOVATION
40 ISLAND AVENUE, MIAMI BEACH, FL 33139

DRAWING TITLE
WEST WING
PLUMBING NOTES

DRAWN BY I.B.
CHECKED BY R.J.M.
ISSUES

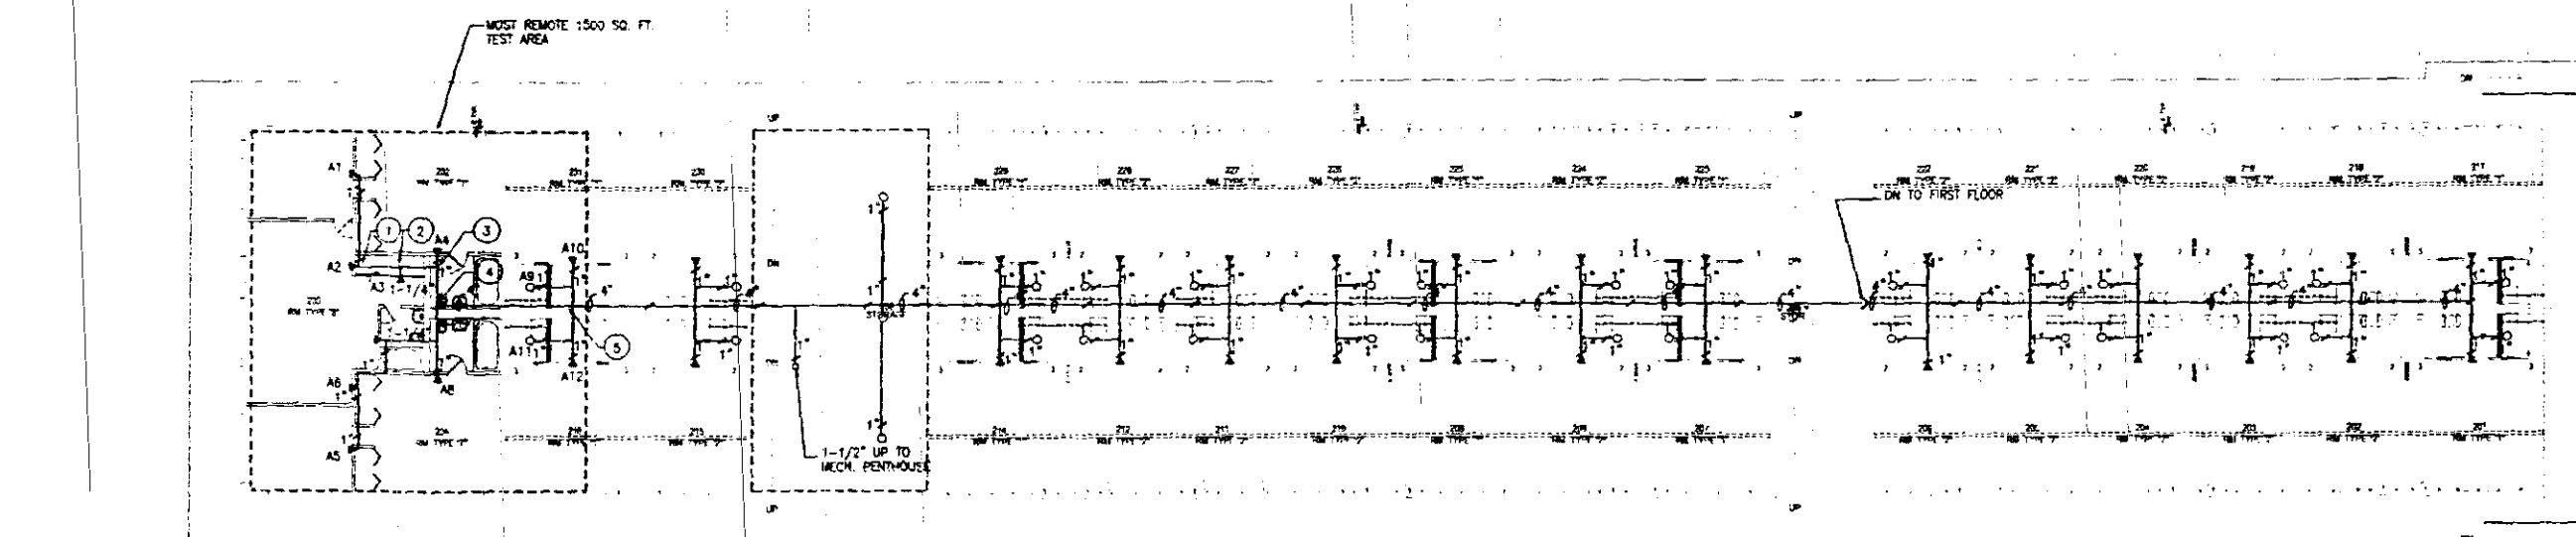
SHEET NO.

P-2




WEST WING - GROUND FLOOR - FIRE PROTECTION FLOOR PLAN

SCALE: 3/32"=1'-0"




WEST WING - SECOND FLOOR - FIRE PROTECTION FLOOR PLAN

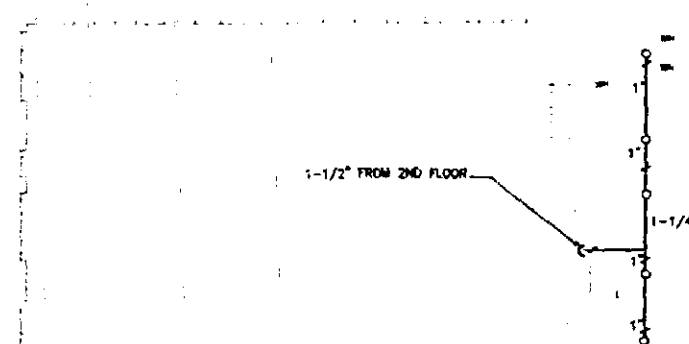SCALE: 3/32"=1'-0"



3RD FLR. MECHANICAL ROOM

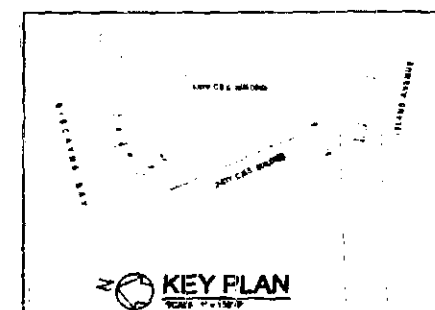SCALE: 3/32"=1'-0"



KEY PLAN

SCALE: 3/32"=1'-0"

OFFICE COPY
CITY OF MIAMI BEACH
APPROVED FOR PERMIT BY
THE FOLLOWING:

BUILDING:
ZONING:
DRAINAGE:
CONCRETE:
PLUMBING:
ELECTRICAL:
MECHANICAL:
FIRE PREVENTION:
ENGINEERING:
PUBLIC WORKS:
STRUCTURAL:
ACCESSIBILITY:
ELEVATOR:

As per Florida Building Code Section 104.4
FOR REVIEW FOR CODE COMPLIANCE
PROJECT #: 0304-053



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PROJECT TITLE
LIDO SPA HOTEL
WEST WING - RENOVATION
40 ISLAND AVENUE, MIAMI BEACH, FL 33139

DRAWING TYPE
WEST WING
FIRE PROTECTION
FLOOR PLAN

DRAWN BY E.S.
CHECKED BY R.J.M.
ISSUES

SHEET NO.
FP-1