





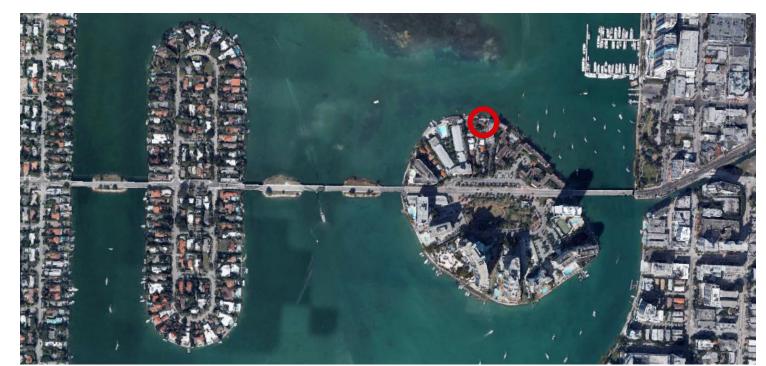

AERIAL VIEW OF VENETIAN ISLANDS



AERIAL VIEW OF BELLE ISLE AERIA

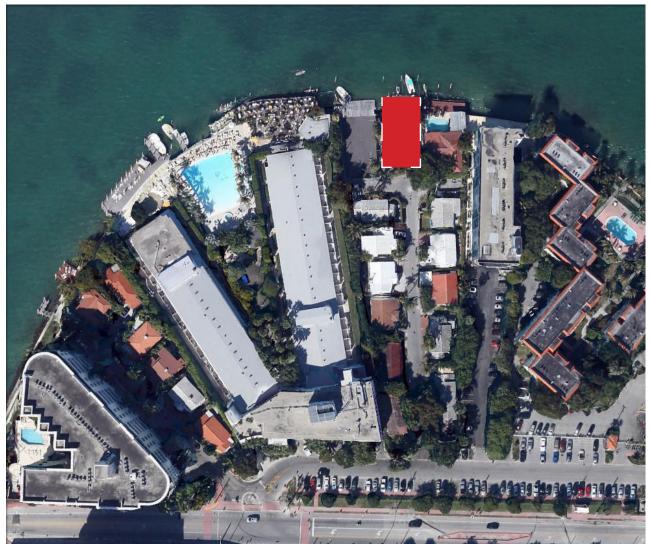

AERIAL VIEW OF SITE



6 FARREY LANE - ACROSS THE STREET



7 FARREY LANE - NEXT DOOR




9 / 10 FARREY LANE



10 FARREY LANE

L



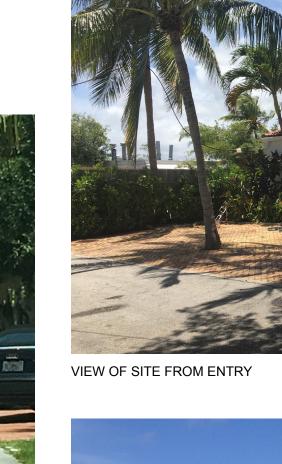



VIEW OF DOCK FROM BAY




VIEW OF SITE ALONG FARREY STREET

79.95' (R) 81.50' (M 110.00 BISCAYNE 83.331 FARREY LANE 10.00 LOT AREA 4,590 sq. ft. 0.11 acres

LOCATION SKETCH SCALE: NTS

AS-BUILT SURVEY

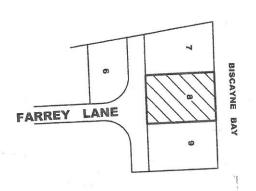

No.	NAME	DIAMETER	SPAN	HEIGHT
1	COCONUT PALM	0.8'	7'	27'
2	COCONUT PALM	0.8'	7'	27'
3	COCONUT PALM	0.8'	7'	27'
4	COCONUT PALM	0.8"	7'	27'
5	BLACK OLIVE TREE	3' -	50'	35'
6	BIRD OF PARADISE	0.9'	10'	12'
7	CHRISTMAS PALM	0.45'	10'	17'
8	CHRISTMAS PALM	0.45'	10'	17'

Property Address: 8 Farrey Lane, Miami Beach, FL. 33139

Legal Description: Lot 8 of SECOND SECTION BELLE ISLE VILLAS, according to the Plat thereof, as recorded in Plat Book 42, Page 100, of the Public Records of Miami-Dade County, Florida.

SWK=SIDEWALK, CBS=CONCRETE BLOCK STRUCTURE, CLF=CHAIN LINK FENCE, PL=PROPERTY LINE, DUE=DRAINAGE UTILITY EASEMENT, IP=IRON PIPE F=FOUND, A/C=AIR CONDITIONER PAD, P/C=PROPERTY CORNER. D/H=DRILLED HOLE, WF=WOODEN FENCE, RES=RESIDENCE, CL-CLEAR, RB=REBAF. UE=UTILITY EASEMENT, CONC=CONCRETE SLAB, RW-RIGHT OF WAY, DE=DRAINAGE EASEMENT, C/L=CENTER LINE, O=DIAMTER, TYP=TYPICAL M=MEASURED. R=RECORDED, ENCR=ENCROACHMENT, COMP=COMPUTER, ASH=ASPHALT, N/D=NAIL & DISC, S=SET, FEE=FINISH FLOOR ELEVATION O/S=OFFSET, P/P=POWER POLE. OHP=OVERHEAD POWERLINE, WM=WA TER METER

ELEVATION BASED ON LOC. # 3245 SE

ELV. 7.86 TYPE OF SURVEY: BOUNDARY SURVEY CBM# D-169

SURVEYOR'S NOTES: 1) OWNERSHIP SUBJECT TO OPINION OF TITLE. 2) NOT VALID WITHOUT THE SIGNATURE AND RAISED SEAL OF A FLORIDA LICENSED SURVEYOR AND MAPPER. 3) THE SURVEY DEPICTED HERE IS NOT COVERED BY PROFESSIONAL LIABILITY INSURANCE. 4) LEGAL DESCRIPTION PROVIDED BY CLIENT. 5) UNDERGROUND ENCROACHMENTS NOT LOCATED. 6) ELEVATIONS ARE BASED ON NATIONAL GEODETIC VERTICAL DATUM OF 1929. 7) OWNERSHIP OF FENCES ARE UNKNOWN. 8) THERE MAY BE ADDITIONAL RESTRICTIONS NOT SHOWN ON THIS SURVEY THAT MAY BE FOUND IN THE PUBLIC RECORDS OF THIS COUNTY. 9) CONTACT THE APPROPRIATE AUTHORITY PRIOR TO ANY DESIGN WORK FOR BUILDING AND ZONING INFORMATION. 10) EXAMINATION OF THE ABSTRACT OF TITLE WILL HAVE TO BE MADE TO DETERMINE RECORDED INSTRUMENTS, IF ANY, AFFECTING THIS PROPERTY.

Additions or deletions to survey maps or reports by other than the signing party or parties is prohibited without written consent of the signing party or parties.

BEARINGS WHEN SHOWN ARE REFERRED TO AN ASSUMED VALUE OF SAID PB 42 PAGE 100

thereon meets the minimum technical requirements adopted by the STATE OF FLORIDA Board of Land Surveyors pursuant to Section 472.027 Florida

There are no encroachments, overlaps, easements appearing on the plat or visible easements other than as shown hereon

> ADIS N. NUNEZ REGISTERED LAND SURVEYOR STATE OF FLORIDA #5924


SINCE 1987 BLANCO SURVEYORS INC.

Engineers • Land Surveyors • Planners • LB # 0007059 555 NORTH SHORE DRIVE

MIAMI BEACH, FL 33141

(305) 865-1200 Email: blancosurveyorsinc@yahoo.com Fax: (305) 865-7810


FLOOD ZONE:	AE	SUFFIX: L	DATE	9/11/09	BASE:	9'
PANEL: 0317		COMMUNITY#	120651			
DATE:	SCALE:	DWN. BY:	JOB No	15 000		
11/20/15	1" = 20'	F. Blanco		15-983		

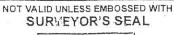



8/10/16 REVISED: FOR TREES

RHODES RESIDENCE - INTERIOR

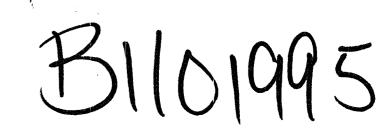





PROJECT LOCATION

SCOPE OF WORK

ALTERATION LEVEL II

- PAINT INTERIOR
- 2. RELOCATE KITCHEN
- 3. NEW KITCHEN CABINETS, APPLIANCES, ELECT. OUTLETS, FIXTURES AND PLUMBING.
- 4. CHANGE EXISTING KITCHEN TO PANTRY
- 5. CHANGE EXISTING STORAGE TO WINE CLOSET
- 6. REMOVE EXISTING FRENCH DOOR AND ENCLOSE EXISTING FRENCH DOOR OPENING IN OFFICE AREA
- 7. REMOVE EXISTING FLOORING AND ADD NEW WOOD FLOORING IN KITCHEN AREA.

APPLICABLE CODES & REGULATIONS.

- JURISDICTION: MIAMI BEACH, FL.
- 1. 2007 FLORIDA BUILDING CODE (FBC)
- 2. 2007 FLORIDA PLUMBING CODE (FPC).
- 3. 2008 NATIONAL ELECTRIC CODE (NEC)
- 4. 2007 FLORIDA STATE ACCESSIBILITY CODE.

Rhodes Residence 8 Farrey Lane MAMI BEACH, FL. 33139

DRAWN BY :

R. FALLS

REVISIONS:

SCALE: 1':1/4"

DATE: 01/5/2011

PUBLIC WORKS

PLAN REVIEW NOTICE

Phone 305-673-7080 Fax 305-673-7028

48 HOURS PRIOR TO EXCAVATING

THIS PLAN REVIEW CONSTITUTES APPROVAL FOR OBTAINING BUILDING PERMITS ONLY.

All construction and/or use of equipment in the right-of-way and/or

easements, requires a separate Public Works Department permit prior


Permit Requirements: Proof of existing sidewalk/swale area conditions (pictures) and/or posting of sidewalk/roadway bonds

OFFICE COPY

CITY OF MIANTI BEACH
APPROVED FOR PERMIT BY
THE FOLLOWING:


BUILDING:
ZONING:
DRB/HPB:
CONCURRENCY:
PLUMBING:
ELECTRICAL:
MECHANICAL:
MIRE PREVENTION:
ENGINZERING:
PUBLIC WORKS:

ELEVATOR:

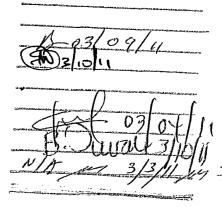


CONTAINS:


COVER SHEET

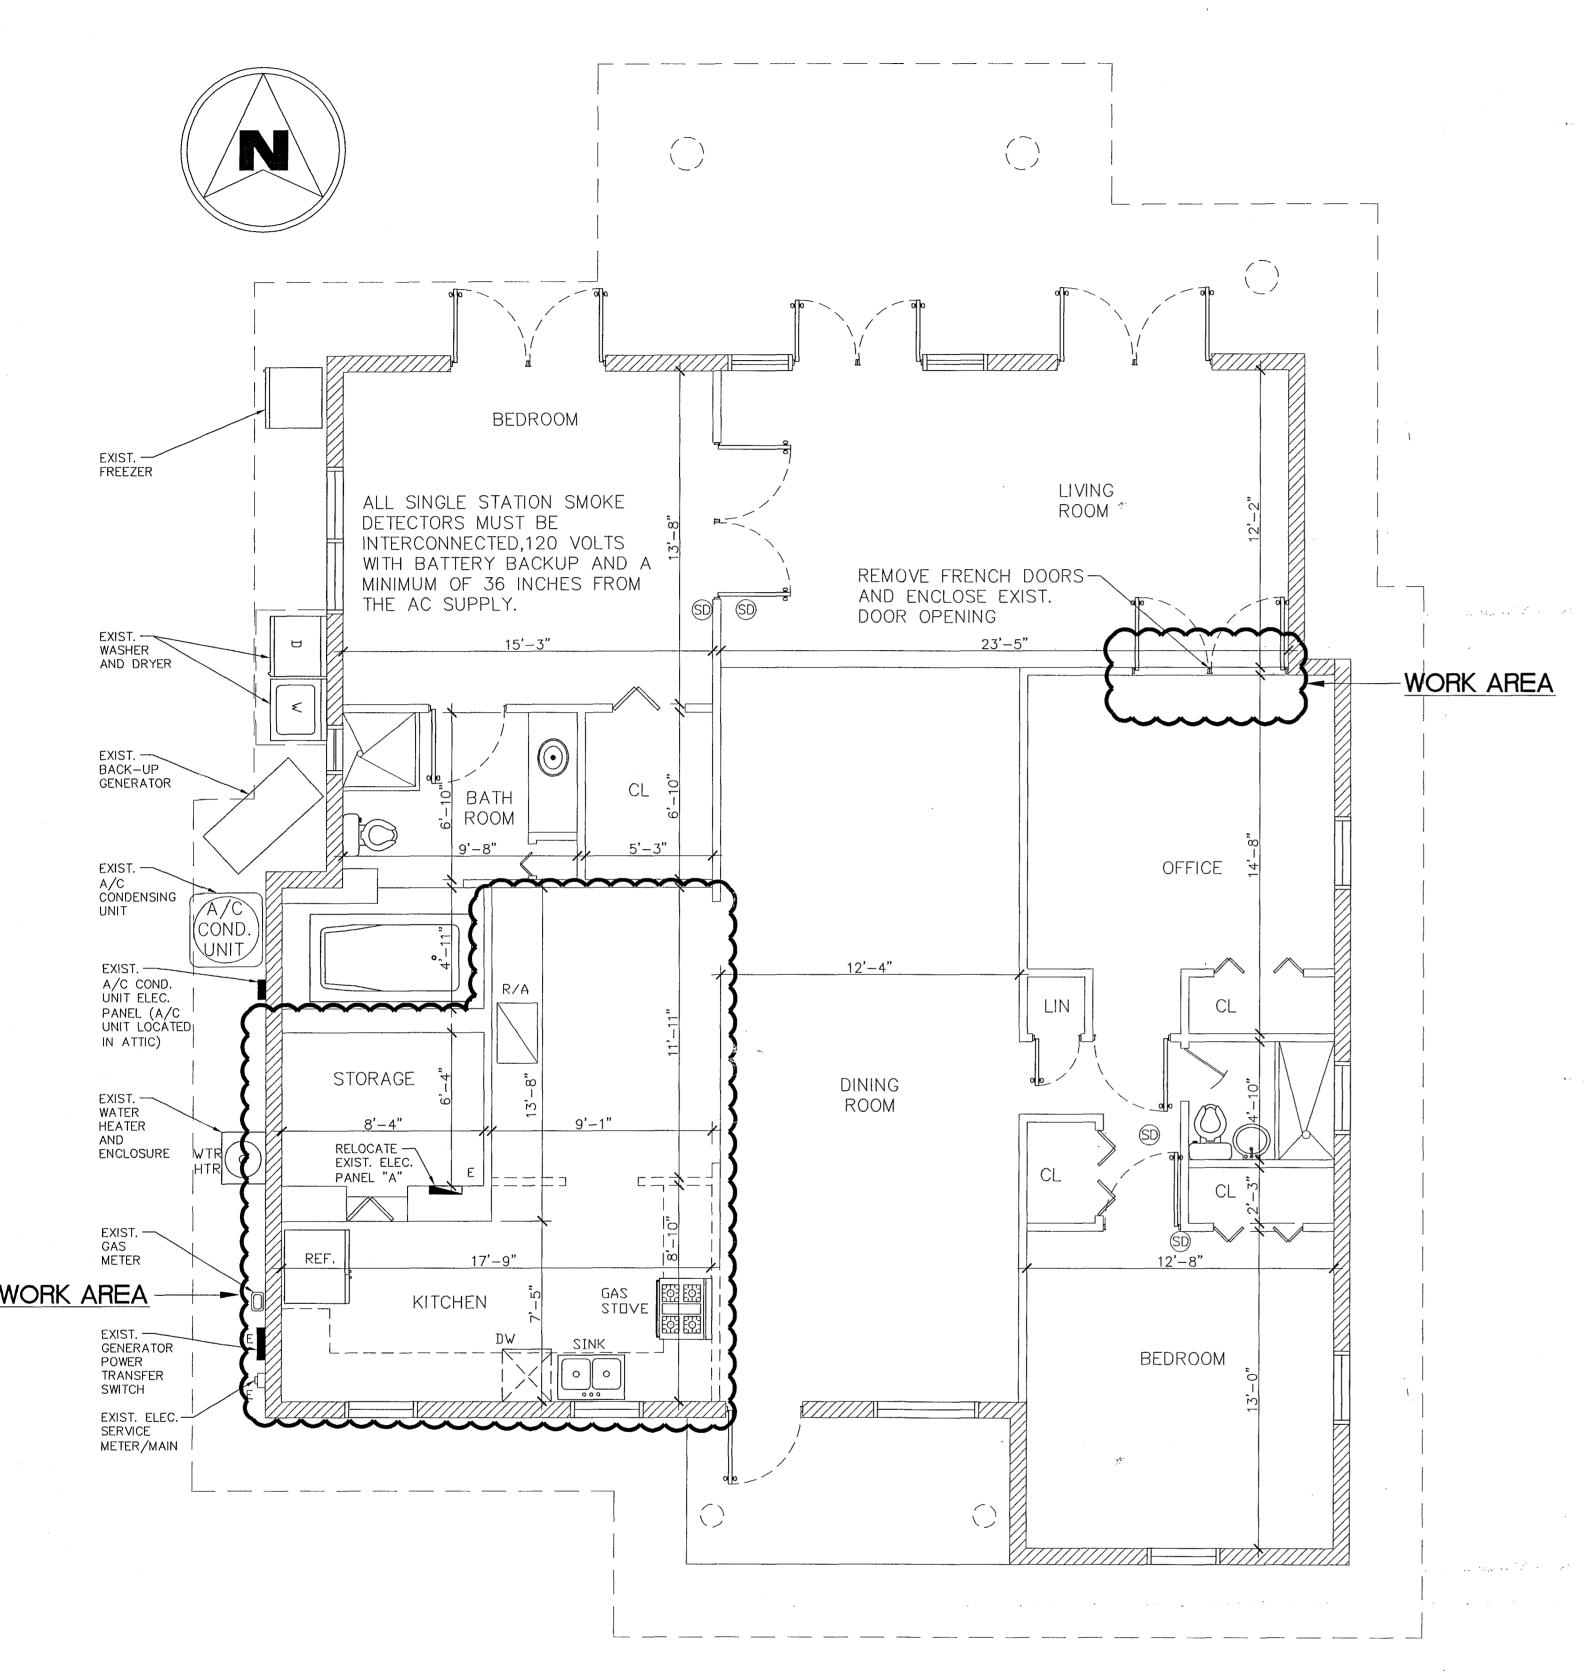


EXISTING PLAN
SCALE: 1/4"=1'-0"

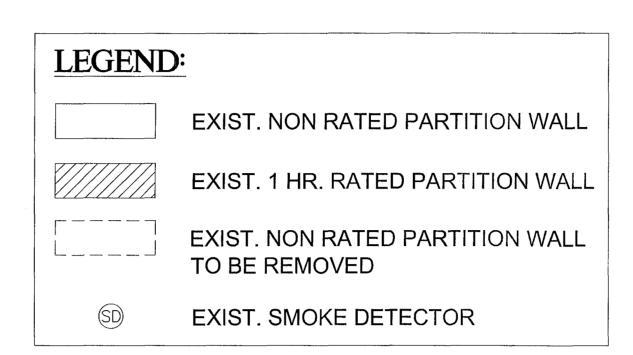


Rhodes Residence 8 Farrey Lane MAMI BEACH, FEE: 33139 DRAWN BY R. FALLS **REVISIONS:** SCALE: 1':1/4" DATE: 01/5/2011 CONTAINS: **EXISTING** INTERIOR PLAN

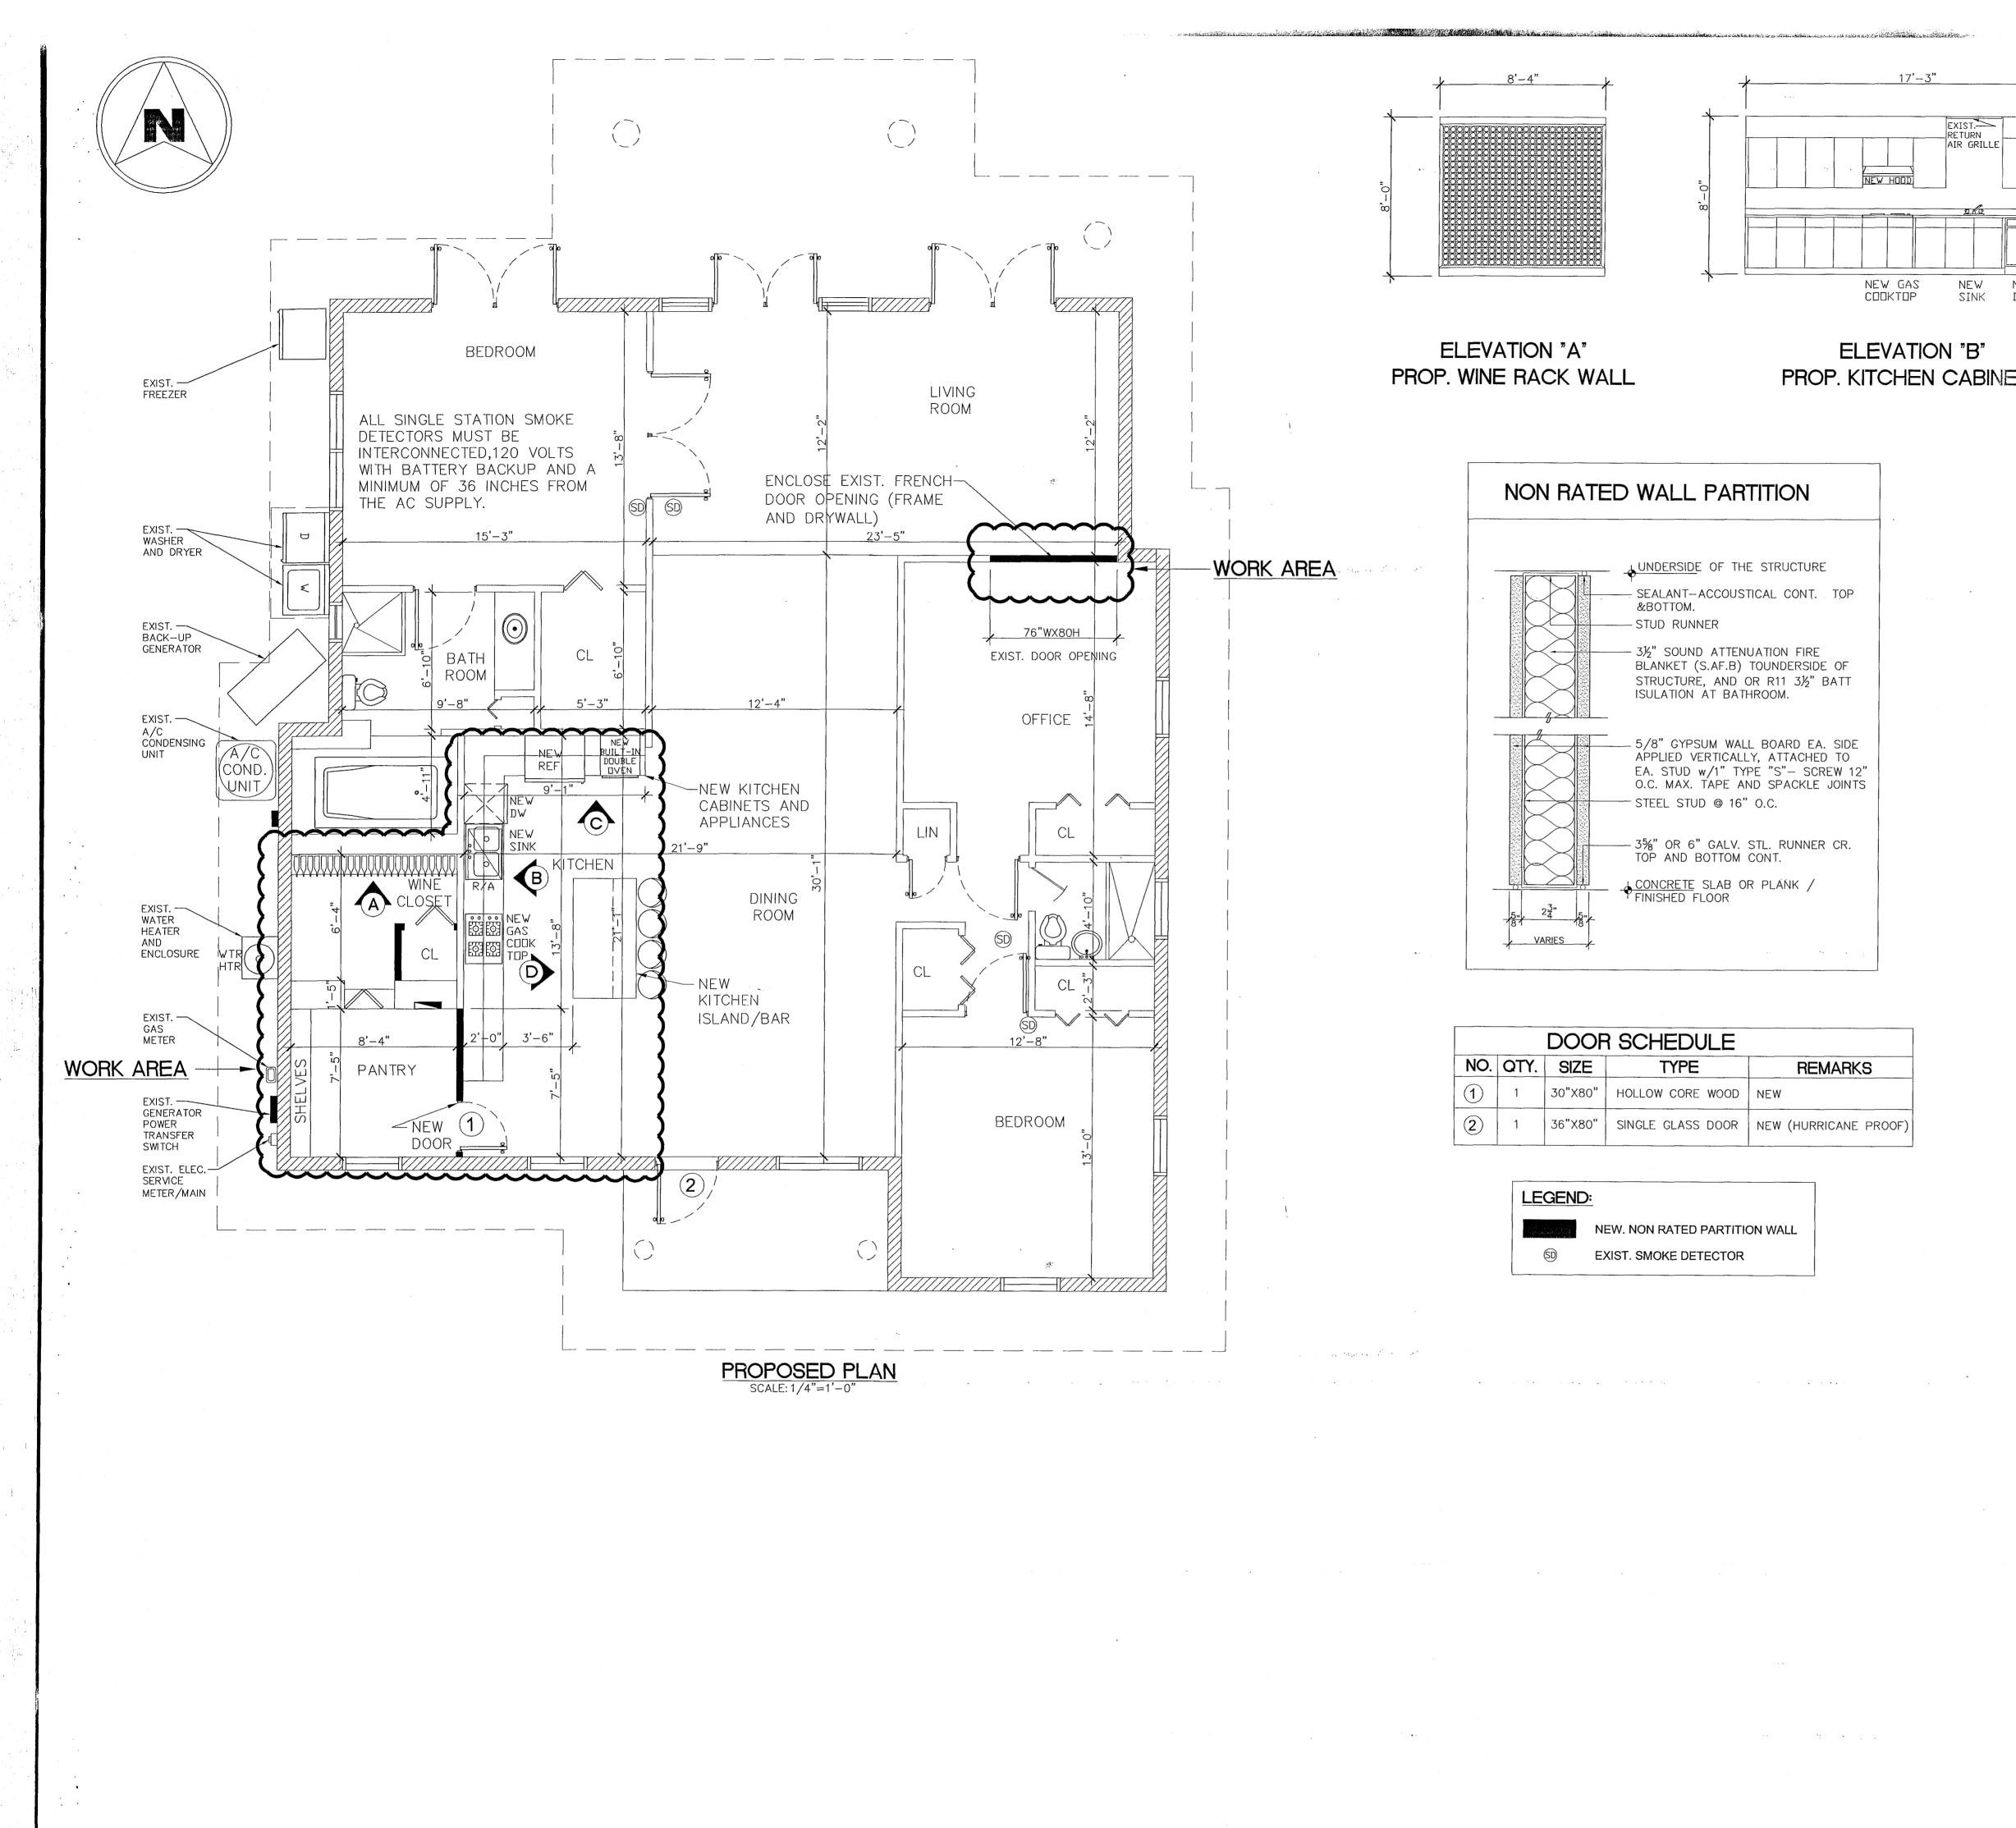


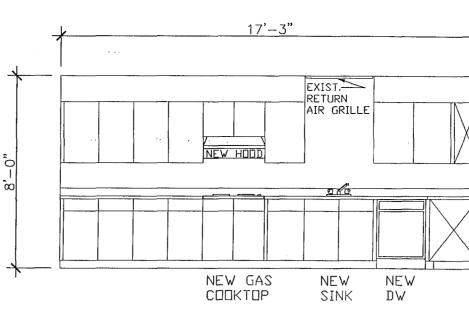

PROP. KITCHEN CABINETS

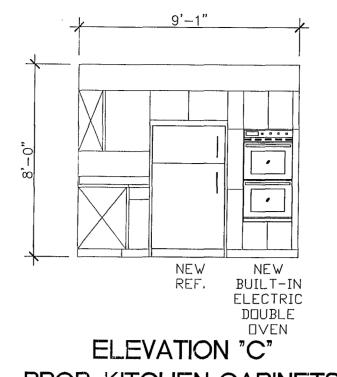

PROP. KITCHEN CABINETS

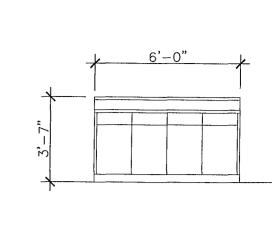

ELEVATION "C" PROP. KITCHEN ISLAND / BAR

DINING


ROOM

NEW WOOD FLOOR TO

MATCH

EXISTING



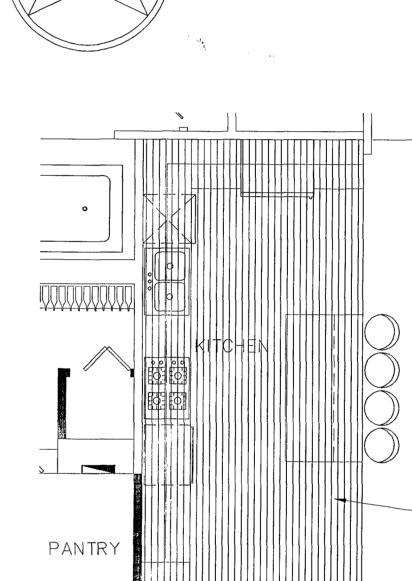


R. FALLS **REVISIONS:** SCALE: 1':1/4" DATE: 01/5/2011

DRAWN BY:

Rhodes Residence 8 Farrey Lane MAMEBEAGH, FL. 33139

CONTAINS:

PROPOSED INTERIOR PLAN

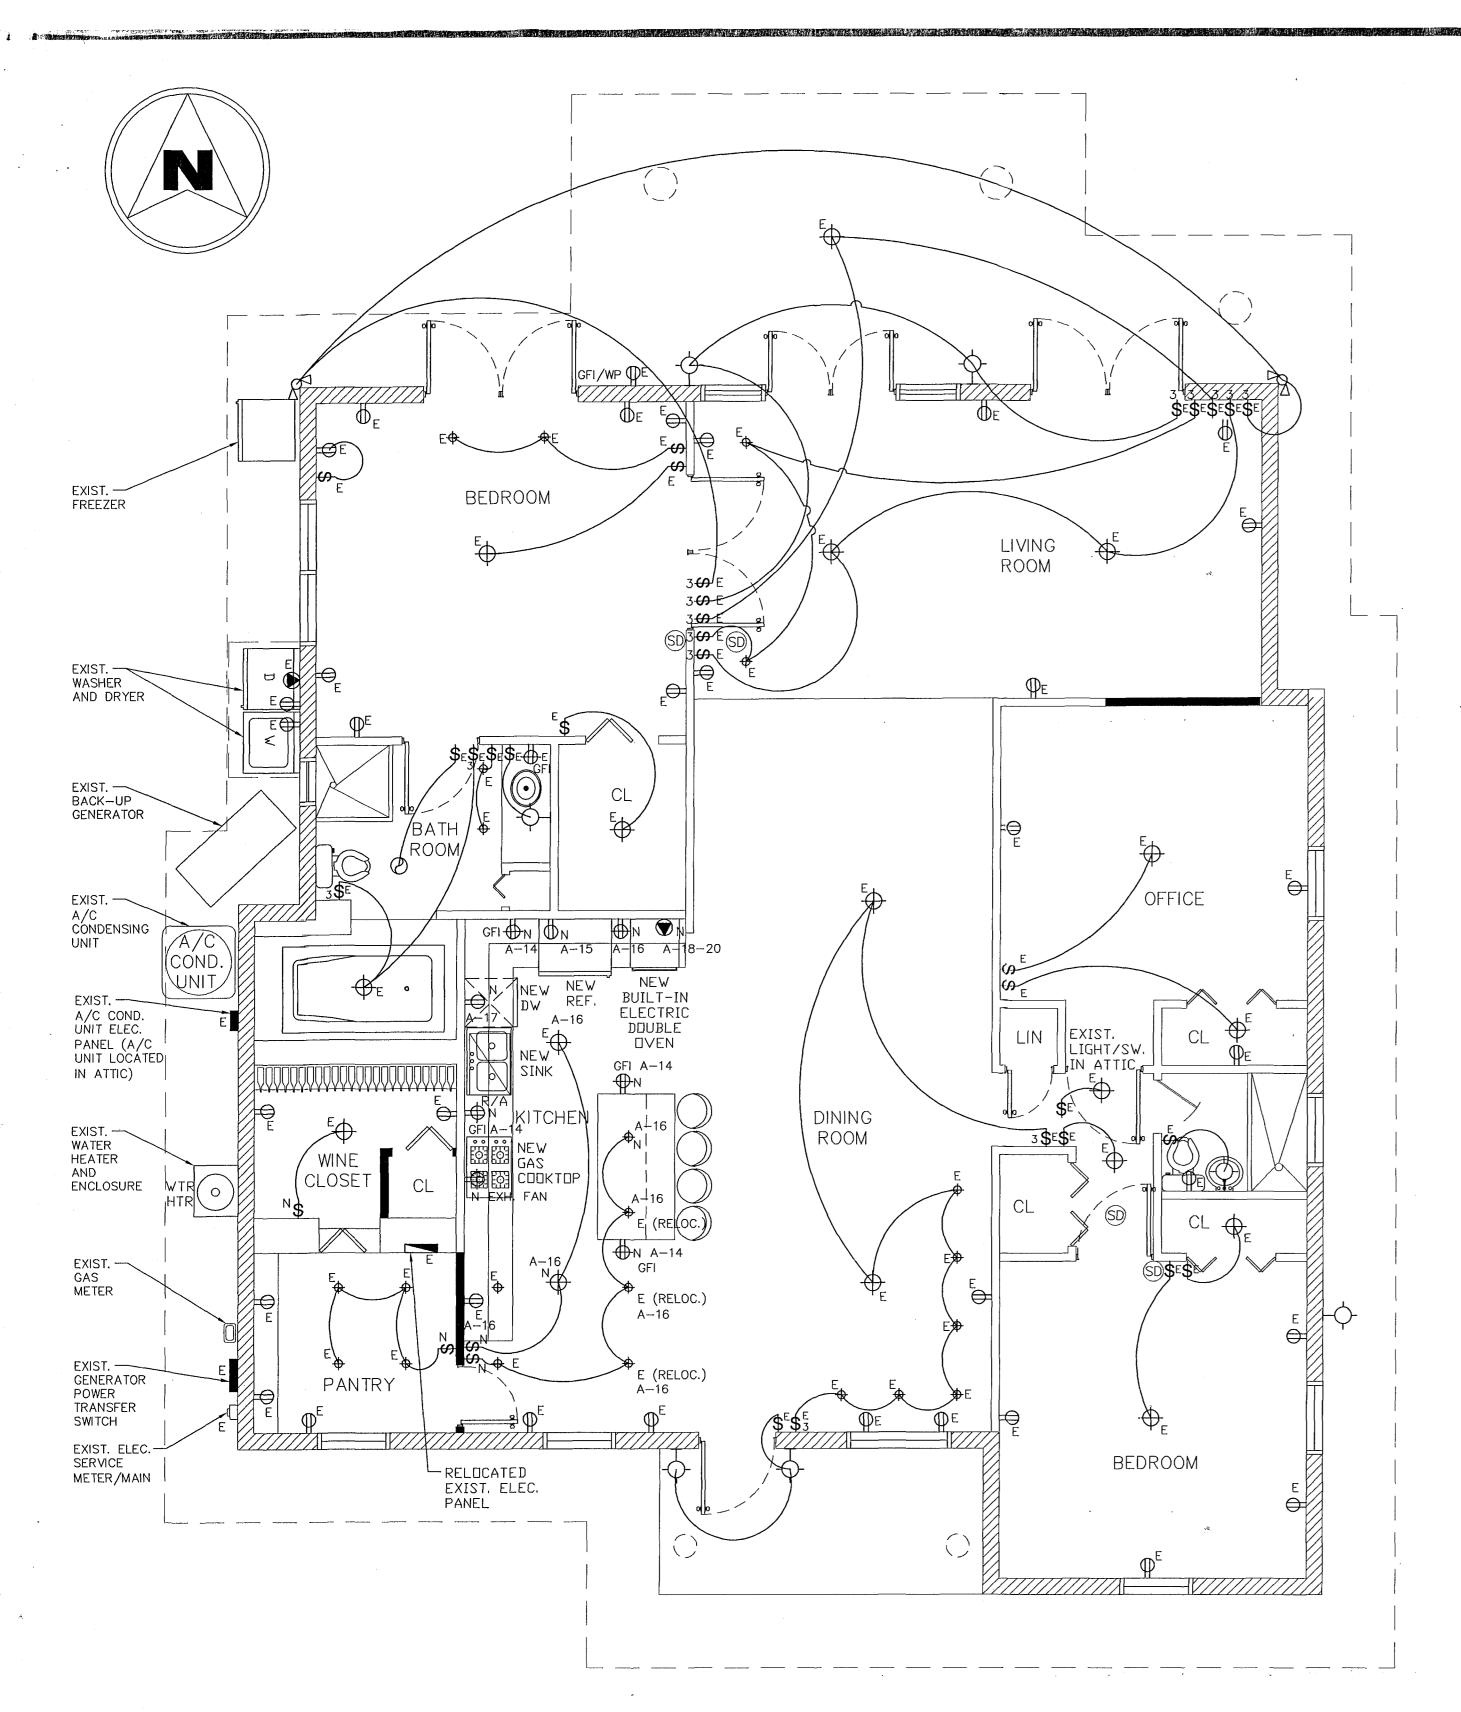

PROPOSED ELECTRICAL PLAN

ELECTRICAL NOTES:

1. PROVIDE APPROVED FIRE STOPPING MATERIALS AT ALL PENETRATIONS THROUGH FIRE RATED WALLS TO PREVENT THE PASSAGE OF SMOKE, FIRE, TOXIC GAS OR WATER THROUGH THE PENETRATION EITHER BEFORE, DURING OR AFTER A FIRE.

2. ALL LIGHT FIXTURES WILL BE PROVIDED BY THE OWNER.

3. PROVIDED ARC-FAULT CIRCUIT INTERRUPTER TYPE BREAKER FOR ALL ADDED OUTLETS. AS PER NEC 2008 SECTION 210-12. ALL ADDED RECEPTACLES TO BE TAMPER RESISTANT AS PER NEC 2008 SECTION 406.11.

4. ALL SINGLE STATION SMOKE DETECTORS MUST BE INTERCONNECTED, 120 VOLTS WITH BATTERY BACKUP AND A MINIMUM OF 36 INCHES FROM THE AC SUPPLY.

							MAIN BUS: 200 AMPS				
MOUNTING: SURFACE PANEL A NEUTRAL: FULL POLES: 20 MAINS: MLO											
POL	.ES:	. 20		CHALLEN			20 (20-40)	INS: .C			
				MODEL #	3 T	YPE 1	A.I	ک			***************************************
LDAD	TRIP	CDN-	WIRE	REMARKS	СКТ	CKT	REMARKS	WIRE	CON-	TRIP	LOAD
K.V.A	POLE	TIUD			NO	NO			DUIT	POLE	K.V.A
0.5	20-1	1/2	12	LIV. RM. OUTLETS	1	2	A/C	6	3/4	50-2	7.5
1.5	15-2	1/2	12	OUTSIDE WASHER/	3	4					
				FREEZER	5	6	MASTER BDRM/BDRM	12	1/2	20-1	1.5
5.0	20-1	1/2	12	DRYER	7	8	MASTER BDRM	12	1/2	20-1	1.5
					9	10	OUTSIDE JET SKI LIFT	12	1/2	20-1	0.5
0.5	20-1	1/2	12	LIGHTS AND RECEPT.	11	12	BATHROOM GFI REC.	12	1/2	20-1	0.5
0.5	20-2	1/2	12	LIGHTS AND RECEPT.	13	14	SMALL APPLIANCES	12	1/2	20-1	1.5
1.2	20-1	1/2	12	REFRIGERATOR	15	16	SMALL APPLIANCES	12	1/2	20-1	1.5
1.2	20-2	1/2	12	DISHWASHER	17	18	BUILT-IN DOUBLE OVEN	10	1/2	30-2	5.0
0.5	20-1	1/2	12	LIGHTS AND RECEPT.	19	20					
10.9											
_	AIR CONDITIONING LOAD										
						>		22.000			
	mı	DCT 1	0 1/1/	Λ ΛΤ 1009			RAL LIGHTING LOAD = $\frac{1}{2}$	-			
•FIRST 10 KVA AT 100% 10,000 VA •REST 12,900 VA AT 40% 5,160 VA											
							SUB TOTAL = 1	-			
• AHU AT 100% = 7,500 VA											
i trije er	. : :	÷*					TΩΤΔ1 ~ 1	22 RR() VΔ		
TOTAL = 22,660 VA											

GENERAL ELECTRICAL NOTES

A. GENERAL PROVISIONS

- 1. THE WORK SHALL CONSIST OF FURNISHING LABOR, EQUIPMENT, AND MATERIALS TO PROVIDE THE COMPLETE INTERGRATED AND PROPER FUNCTIONS SYSTEMS AS SHOWN ON THE DRAWINGS.
- 2. ALL WORK SHALL BE DONE IN CONFORMANCE WITH THE LATEST EDITION OF THE NATIONAL ELECTRICAL CODE, ALL APPLICABLE FEDERAL, STATE AND LOCAL REGULATIONS AND ORDINANCES.
- 3. ALL EQUIPMENT AND MATERIALS PROVIDED SHALL BE NEW AND IN CONFORMANCE WITH APPLICABLE PROVISIONS OF NEMA, ANSI, U.L., ETC.
- 4. THE ELECTRICAL CONTRACTOR SHALL COORDINATE HIS WORK WITH THAT OF OTHER TRADES SO AS TO AVOID
- 5. THE DRAWINGS ARE DIAGRAMMATIC AND INDICATE GENERAL LAYOUT OF ELECTRICAL SYSTEMS. FIELD VERIFICATIONS OF DIMENSIONS IS DIRECTED.
- 6. SECURE PERMITS AND INSPECTIONS REQUIRED BY STATE AND LOCAL LAWS AND ORDINANCES.
- 7. UPON COMPLETION OF THE WORK, FURNISH TO THE OWNER CERTIFICATES OF FINAL INSPECTIONS AND APPROVALS FROM AUTHORITIES HAVING JURISDICTION. B. RACEWAYS

1. NOT IN USE.

- 2. MINIMUM CONDUIT SIZE SHALL BE 1/2' TRADE SIZE.
- 3. USE FLEXIBLE CONDUIT FOR SHORT FINAL CONNECTIONS TO VIBRATING EQUIPMENT SUCH AS MOTORS AND TRANSFORMERS. LIQUID-TIGHT FLEXIBLE CONDUIT SHALL BE USED IN DAMP AND WET LOCATIONS.
- 4. EXPOSED CONDUITS SHALL BE RUN PARALLEL TO BUILDING LINES.
- 5. DO NOT INSTALL CONDUITS LARGER THAN 1/3 THE SLAB THICKNESS IN CONCRETE SLABS.
- 6. PROVIDE APPROVED FIRE STOPPING MATERIALS AT ALL PENETRATIONS THROUGH FIRE RATED FLOORS AND WALLS TO PREVENT THE PASSAGE OF SMOKE, FIRE, TOXIC GAS OR WATER THROUGH THE PENETRATION EITHER BEFORE, DURING OR AFTER A FIRE, AS REQUIRED BY ARTICLE 300-21 OF THE N.E.C.
- 7. PROVIDE CABLE SUPPORTS IN ACCORDANCE WITH ARTICLE 300 OF THE N.E.C.
- 8. PROVIDE EXPANSION FITTINGS IN CONDUIT STRUCTURAL EXPANSION JOINTS.

C. CONDUCTORS

- 1. ALL WIRING SHALL BE COPPER.
- 2. CONDUCTORS SHALL BE RATED 600V. WITH TYPE THWN INSULATION.
- 3. WIRES SIZE #10 AWG AND SMALLER SHALL BE SOLID CONDUCTOR. WIRES SIZE #8 AND LARGER SHALL BE STRANDED. 4. MINIMUM CONDUCTORS SIZE SHALL BE #14 AWG.

D. <u>LIGHTING</u> <u>PANELS</u>

- 1. PROVIDE LIGHTING AND RECEPTACLES PANELS AS INDICATED ON THE PLANS AND AS SPECIFIED HEREIN. ALL PANELS SHALL BE DEAD FRONT, CIRCUIT BREAKER TYPE AND SHALL BEAR THE U.L. LABEL AS WELL AS MEET ALL APPLICABLE NEMA REQUIREMENTS.
- 2. ALL PANELS SHALL HAVE TYPEWRITTEN CIRCUITS DIRECTORIES MOUNTED INSIDE OF DOOR.
- 3. PANELS SHALL BE SUITABLE FOR THE SERVICE RATING INDICATED ON THE PANEL SCHEDULES.
- 4. ALL BREAKERS SHALL BE FULL SPACE, INDIVIDUAL FRAME TYPE. NO "PIGGY BACK" OR TANDEM BREAKERS WILL BE PERMITTED.

E. SAFETY SWITCHES

- 1. SAFETY SWITCHES SHALL BE HEAVY DUTY TYPE FUSIBLE OR NON-FUSIBLE WITH POLES, AMPERE AND SERVICES RATINGS AS INDICATED ON THE PLANS. LUGS SHALL BE U.L. LISTED FOR CU. -AL.
- 2. ENCLOSURES FOR SAFETY SWITCHES SHALL BE NEMA 1, EXCEPT FOR SWITCHES MARKED "WP" (WEATHERPROOF) SHALL BE NEMA 3R.
- 1. ALL FUSES SHALL HAVE A 200,000 AMP RMS SYMETRICAL RATING UNLESS OTHERWISE NOTED.
- 2. FUSES RATED 0 TO 600 AMPS SHALL BE AS FOLLOW: a) CIRCUIT BREAKER PANEL PROTECTION-U.L. CLASS RK-1, DUAL ELEMENT(BUSSMANN "LOW PEAK" OR EQUAL). b) MOTOR CIRCUIT PROTECTION-U.L. CLASS RK-5, DUAL ELEMENT (BUSSMANN "FUSETRON" OR EQUAL).
- 3. FUSES RATED 601 AMPS OR LARGER SHALL BE U.L. CLASS L TIME DELAY (BUSSMANN "HI-CAP" OR EQUAL).

G. <u>SITE VISIT</u>

1. BEFORE SUBMITTING A BID THE CONTRACTOR SHALL VISIT THE SITE AND DETERMINE CONDITIONS AT THE SITE AND ALL EXISTING STRUCTURES IN ORDER TO BECOME FAMILIAR WITH EXISTING CONDITIONS AND ELECTRICAL SYSTEMS WHICH WILL IN ANY WAY AFFECT THE WORK REQUIRED UNDER THE CONTRACT. THE CONTRACTOR SHALL INFORM THE ENGINEER IN WRITING OF ANY DISCREPANCIES FOUND DURING SAID SITE VISIT. NO SUBSEQUENT INCREASE IN CONTRACT COST WILL BE ALLOWED FOR ADDITIONAL WORK REQUIRED BECAUSE OF CONTRACTOR'S FAILURE TO FULFILL THIS REQUIREMENT.

SYMBOL LEGEND

- RECESSED DOWNLIGHT.
- WALL MOUNTED LIGHT FIXTURE
- -()- SURFACE MOUNTED LIGHT FIXTURE.
- **()** CHANDELIER.
- DUPLEX RECEPT. NEMA 5-20R (18" A.F.F.TO CENTER)
- DUPLEX RECEPT. MOUNTED ABOVE COUNTER NEMA 5-20R
- QUADRUPLEX RECEPT. NEMA 5-20R.
- QUADRUPLEX RECEPT. FLOOR MOUNTED. NEMA 5-20R.
- () SINGLE RECEPT. NEMA 5-20R (18" A.F.F.TO CENTER)
- SPECIAL RECEPT. RATED AS NOTED. PANELBOARD (6'-0" AFF TO TOP)
- FPL ELECTRICAL METER.
- COMPUTER OUTLET (18" A.F.F. TO CENTER)

- MULTIPLE STATION SMOKE DETECTOR POWERED 120V AND PROVIDED WITH BATTERY BACKUP.
- CARBON MONOXIDE DETECTOR POWERED 120v AND PROVIDED WITH BATTERY BACKUP.
- CEILING MOUNTED EXHAUST FAN


FUSIBLE DISCONNECT SWITCH POLES, AMPS AND FUSES AS SHOWN NF INDICATES NON-FUSED

- MOTOR (1 PHASE)
- JUNCTION BOX
- SINGLE POLE SWITCH 20 AMP (48" A.F.F.TO CENTER)
- THREE WAY SWITCH (48" A.F.F. TO CENTER) DIMMER SWITCH (48" A.F.F. TO CENTER)

NOTE: ALL SYMBOLS MAY NOT BE USED.

ELECTRICAL SUBMARKS

- EXIST. ELECTRICAL DEVICE
- NEW ELECTRICAL DEVICE
- ER EXISTING ELECTRICAL DEVICE TO BE REMOVED
- R EXISTING ELECTRICAL DEVICE TO BE RELOCATED WL RATED FOR WET LOCATIONS
- GFI GROUND FAULT INTERRUPTER
- WP WEATHER PROOF

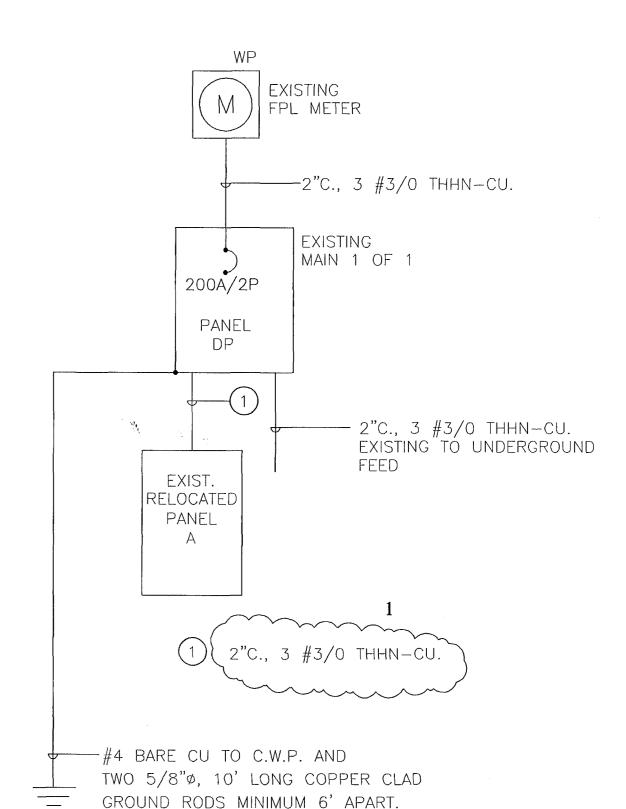

ONE LINE DIAGRAM

T DRAWN BY R. FALLS

REVISIONS:

REVISIONS 03/09/2011


J

S

SCALE: 1':1/4" DATE: 01/17/2011 EC0002054 OMARUILAR JOSE T. VAN GALLO
MOTO SINN # DREADZE
HERPERES: LOUIS 103 23
DETERMINENT PROPERTY DESCRIPTION OF THE PROPERTY DESC

CONTAINS:

PROPOSED INTERIOR ELECTRICAL PLAN

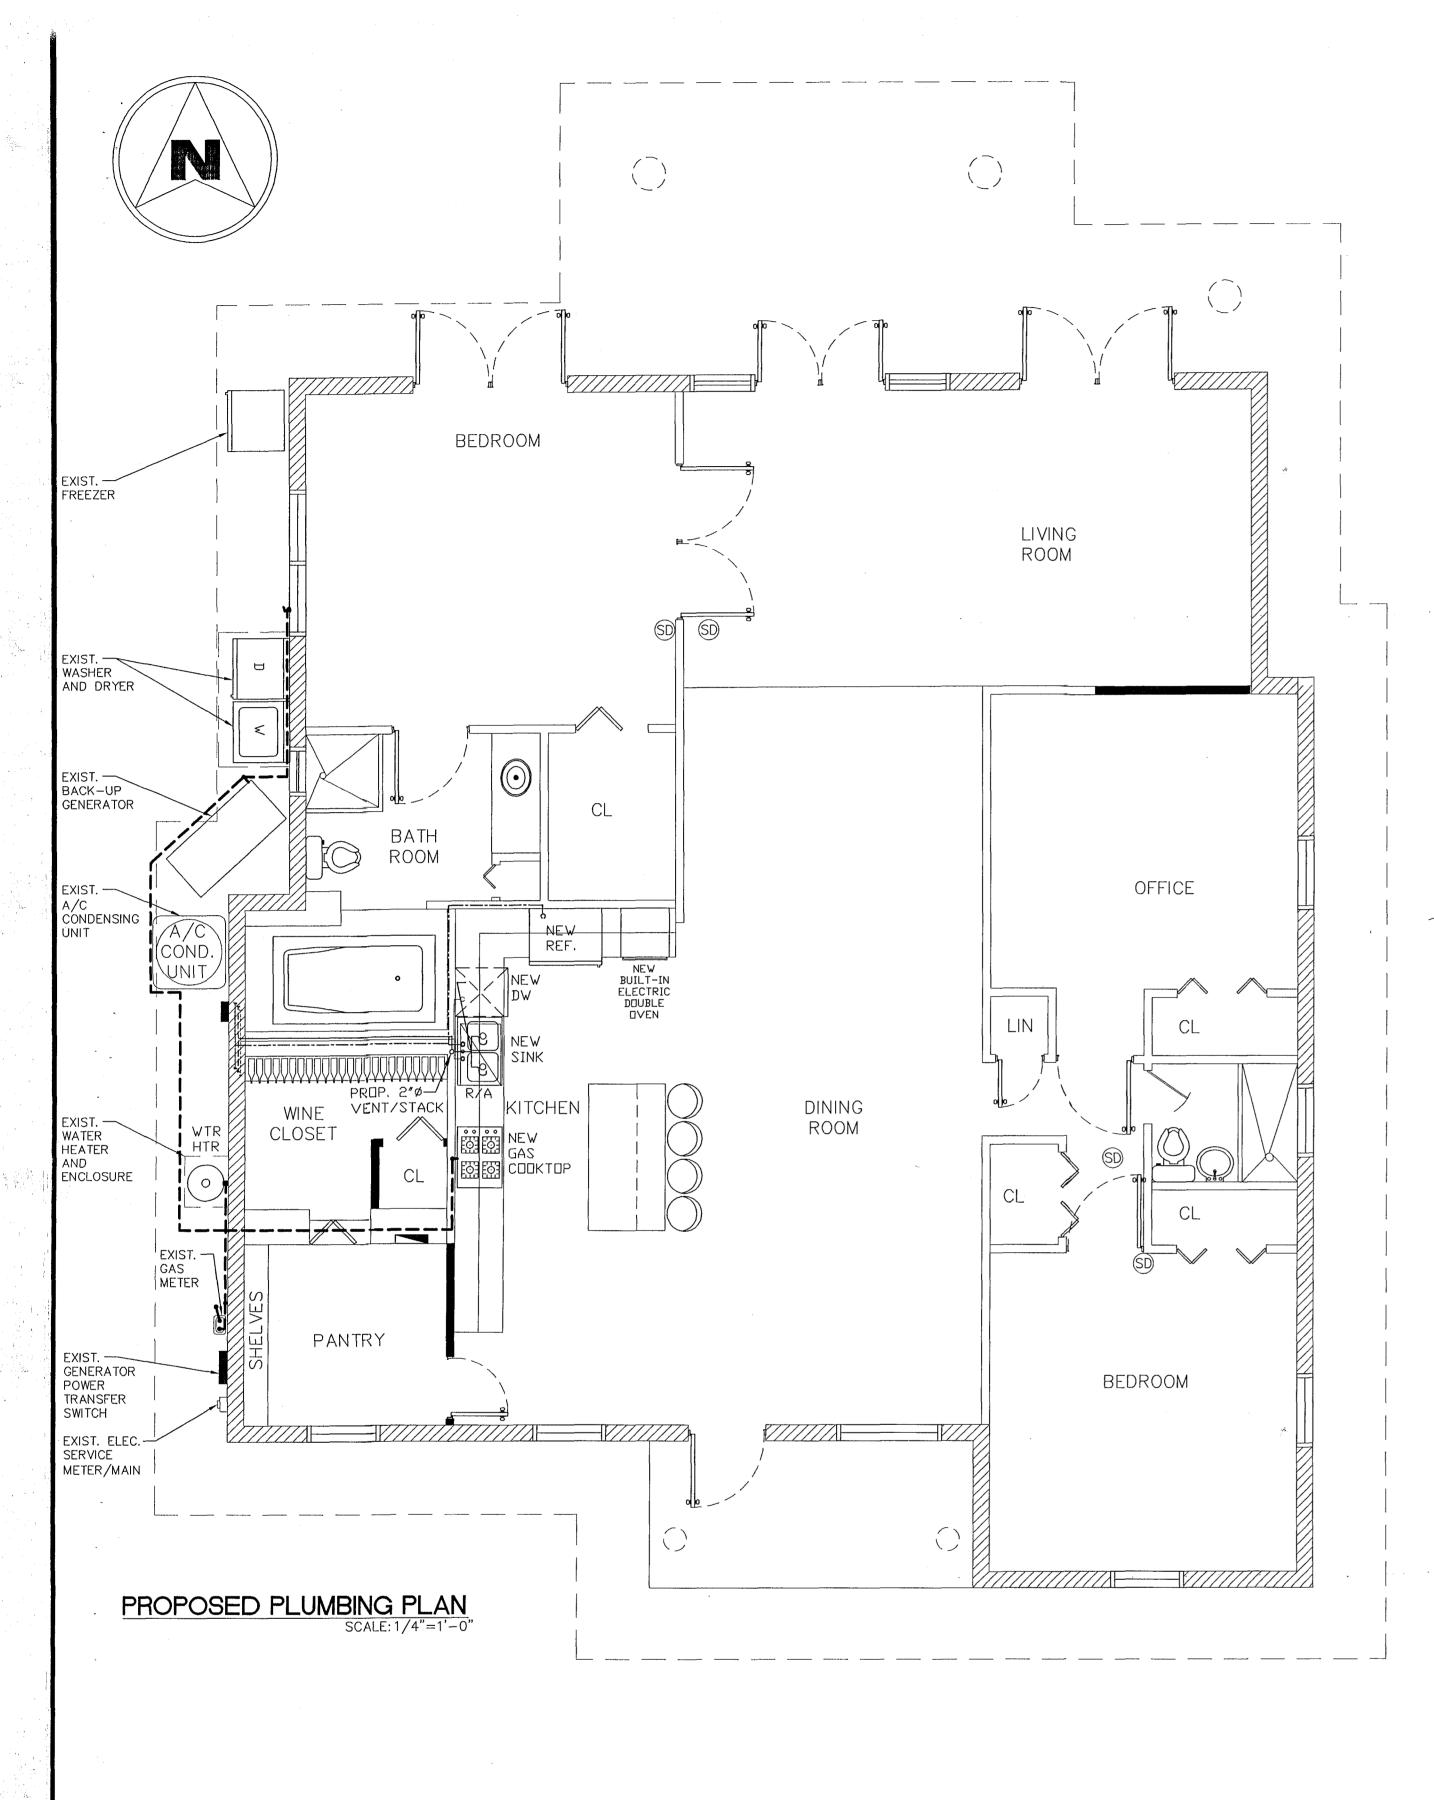

GAS NOTES:

TABLE 604.4 MAXIMUM FLOW RATES AND CONSUMPTION FOR PLUMBING FIXTURES,FIXTURE FITTINGS AND APPLIANCES				
PLUMBING FIXTURE OR FIXTURE FITTING	PLUMBING FIXTURE OR FIXTURE FITTING MAXIMUM FLOW RATE			
-LAVATORY FAUCET	1.0 GPM AT 60 PSI			
SINK FAUCET	1.0 GPM AT 60 PSI			

1.5 GPM AT 80 PSI

1.28 GALLONS PER FLUSHING CYCLE

NOTE: THE MAXIMUM WATER CONSUMPTION FLOW RATES AND QUANTITIES FOR ALL PLUMBING FIXTURES, FIXTURE, FITTINGS AND APPLIANCES SHALL BE IN ACCORDANCE WITH TABLE 604.4 EFFECTIVE JANUARY 1, 2009

-SHOWER-HEAD-


1. PROVIDE SHUT OFF AND PRESSURE REGULATOR VALVE AT EACH APPLIANCE.

2. GAS WATER HEATER CONSUMPTION IS 75,000 BTU'S, GAS COOKTOP CONSUMPTION IS 40,000 BTU'S (REPLACES EXIST. GAS RANGE 65,000 BTU'S), GAS GENERATOR CONSUMPTION IS 245,000 BTU'S (USED ONLY DURING POWER OUTAGE) FOR A TOTAL CONSUMPTION OF 360,000 BTU'S OF NATURAL GAS.

3. LONGEST DISTANCE TO FURTHEST APPLIANCE IS 66'-0".


4. GAS LINES SIZED USING TABLE 402.4(5) OF THE FBC FUEL GAS — 2007

5. GAS PIPING SHALL BE BLACK STEEL SCHEDULE 40 PIPE CONFORMING TO ASTM 53. STEEL THREADED FITTINGS.

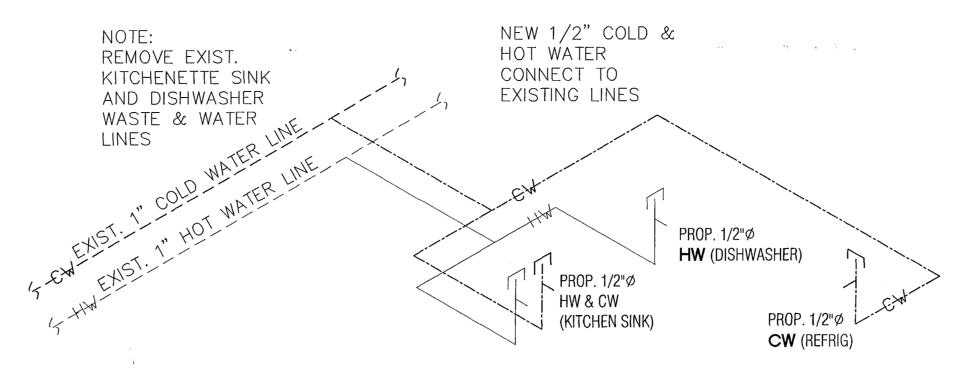


NOTE:
REMOVE EXIST. SINK,
DISHWASHER AND
REFRIG. & WATER
LINES

PLUMBING WATER RISER DIAGRAM

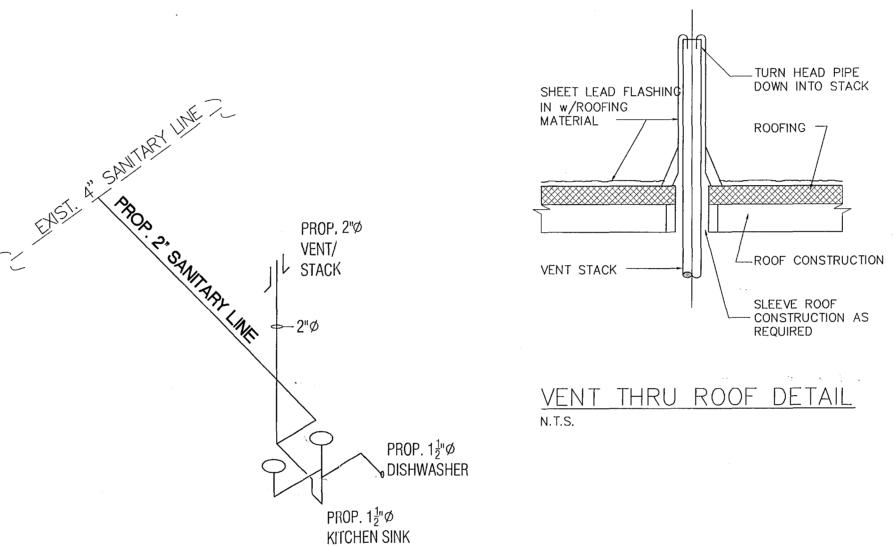

PLUMBING SANITARY RISER DIAGRAM

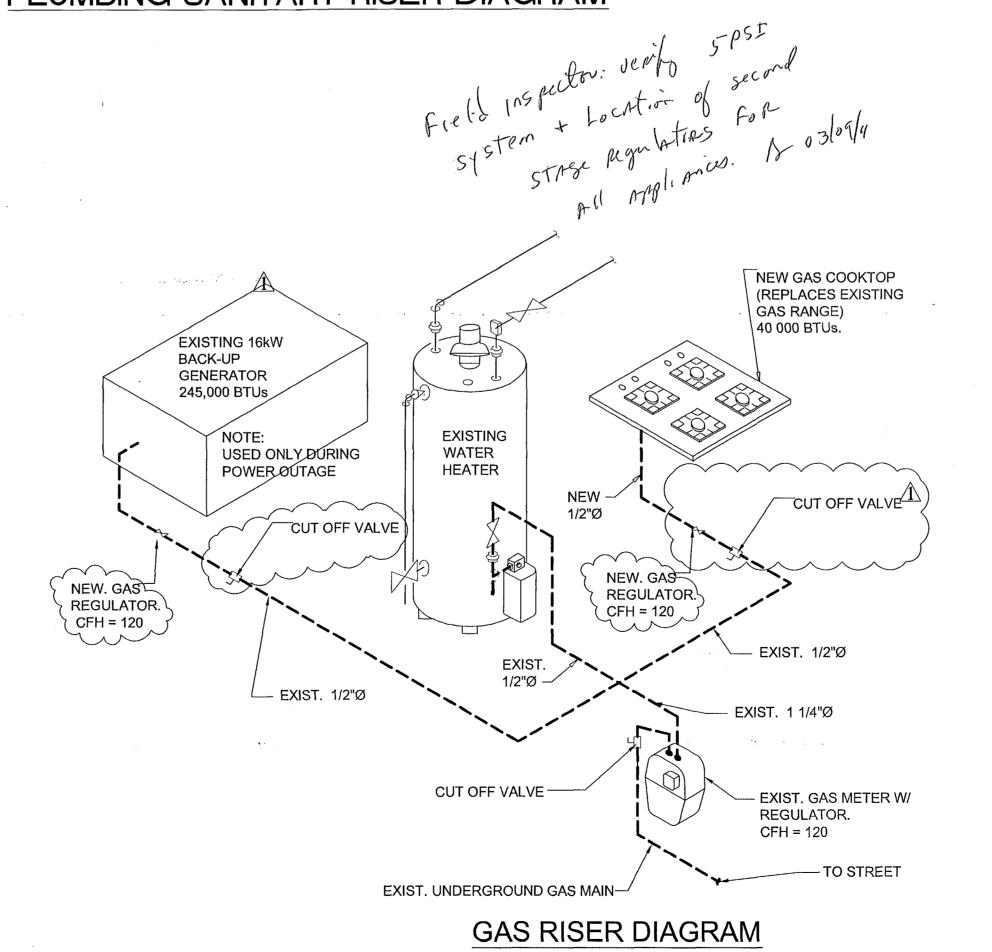

GENERAL PLUMBING NOTES

- ALL WORK TO BE IN ACCORDANCE WITH THE FLORIDA BUILDING CODE 2007, ASME CODE AND AGA REQUIREMENTS AND ALL OTHER APLICABLE CODES.
- 2 CONTRACTOR SHALL VISIT THE JOB SITE AND THOROUGHLY FAMILIARLIZE HIMSELF WITH ALL EXISTING CONDITIONS.
- 3 ALL MATERIALS SHALL BE NEW
- 4 ALL WORK SHALL BE PERFORMED BY A LICENSED PLUMBING CONTRACTOR IN A FIRST CLASS WORKMANLIKE MANNER. THE COMPLETED SYSTEM SHALL BE FULLY OPERATIVE.
- ALL EXCAVATION AND BACKFILL AS REQUIRED FOR THIS PHASE OF CONSTRUCTION SHALL BE A PART OF THIS CONTRACT.
- REQUIRED INSURANCE SHALL BE PROVIDED BY THE CONTRACTOR FOR PROTECTION AGAINST PUBLIC LIABILITY AND PROPERTY DAMAGE FOR THE DURATION OF THE WORK.
- CONTRACTOR SHALL SECURE AND PAY ALL PERMITS, FEES, INSPECTION AND TEST.
- DRAWINGS ARE DIAGRAMMATIC. DO NOT SCALE FOR EXACT LOCATION OF FIXTURES, PIPING, EQUIPMENT, ETC.
- ALL WORK SHALL BE COORDINATED WITH OTHER TRADES TO AVOID INTERFERENCE WITH THE PROGRESS OF CONSTRUCTION, REPORT ANY DISCREPANCY TO ENGINEER/ARCHITECT PRIOR TO BEGINNING CONSTRUCTION.
- VERIFY LOCATION, SIZE, INVERTS AND ALL EXISTING UTILITIES PRIOR TO BEGINNING CONSTRUCTION. ADVISE ENGINEER OF ANY DESCREPANCIES.
- WATER PIPING SHALL BE TYPE "L" COPPER FOR 2" AND UNDER AND TYPE "K" COPPER FOR 2 1/2" AND ABOVE. ALL UNDERGROUND WATER PIPING SHALL BE TYPE "K" COPPER.
- SOIL, WASTE, VENT AND RAIN WATER PIPING SHALL BE SCHEDULE 40 PVC PIPE AND BELOW GROUND SHALL BE OF THE HUB AND SPIGOT TYPE.
- 13 ALL FIXTURES MUST BE PROVIDED WITH READILY ACCESSIBLE STOPS AND MARKED ACCESS PANELS.
- 14 FURNISH AND INSTALL APPROVED AIR CHAMBERS AT EACH PLUMBING FIXTURE AND P.D.I. APPROVED SHOCK ARRESTORS ON MAIN LINES OR RISERS
- 15 DIELECTRIC COUPLINGS ARE REQUIRED BETWEEN ALL DISSIMILAR METAL IN PIPING AND EQUIPMENT CONNECTIONS.
- 16 ISOLATE COPPER PIPE FROM HANGER OR SUPPORT WITH ISOLATOR PAD (HAIR FELT LINING) SUPER STRUT MODEL C/15/16.
- ALL RATED FLOOR AND WALL PENETRATIONS (NO PVC) SHALL HAVE FIRE, SMOKE AND WATER STOPS BY FILLING VOIDS BETWEEN PIPE AND WALL/FLOOR SLEEVES WITH FIRE RATED FOAM, CHASE TECHNOLOGY CORP. —CIC PR 855 OR 3M, CP—25 CAULKING OR 303 PUTTY, TO ACHIEVE SAME RATING AS WALLS OR FLOORS.
- 18 CONTRACTOR SHALL GAURANTEE ALL MATERIALS AND WORKMANSHIP FREE FROM DEFECTS FOR A PERIOD OF NOT LESS THAN (1) YEAR FROM DATE FOR ACCEPTANCE. CORRECTION OF ANY DEFECTS SHALL BE COMPLETED WITHOUT ADDITIONAL CHARGE AND SHALL INCLUDE REPLACEMENT OR REPAIR OF ANY OTHER PHASE OF THE INSTALLATION WHICH MAY HAVE BEEN DAMAGED.
- PROVIDE ACCESS PANELS FOR ALL CONCEALED VALVES AND ALL WATER HAMMER ARRESTORS. ACCESS PANELS IN RATED WALLS MUST MAINTAIN THE SAME RATING. ALL ACCESS PANELS MUST MATCH THE FINISH OF THE WALL IN WHICH IT IS INSTALLED..
- CONTRACTOR SHALL PROVIDE COMBINATION COVER PLATE AND CLEANOUT PLUG FOR ALL WALL CLEANOUTS JOSAM 58890 SERIES.
- 21 PLUMBING FIXTURESSHALL COMPLY WITH REFERENCED STANDARDS AS PER FBC PLBG 406 THROUGH 421.

PLUMBIN	PLUMBING FIXTURE SCHEDULE					
DESCRIPTION	WASTE	CW	HW	FU		
WATER CLOSET	3"	1/2"	•	4		
-TUBS	. 2"	1/2"	1/2"	2		
-LAVS	1-1/2"	1/2"	1/2"	1		
KIT. SINK	1-1/2"	1/2"	1/2"	2		
WASHING MACHINE	2"	1/2"	1/2"	4		
DISHWASHER	1-1/2"	•	1/2"	2		

SLOPE OF	HORIZ. DRAINAGE PIPE		
SIZE (INCHES)	MINIMUM SLOPE (INCH PER FOOT)		
2 1/2 OR LESS	1/4		
3 TO 6	1/8		
8 OR LARGER	1/16		
TABLE 704.1 OF THE FLORIDA PLUMBING CODE 2007			

The second

12-03/09/11

Rhodes Residence 8 Farrey Lane MIAMI BEACH, FL. 33139

DRAWN BY:

R. FALLS

REVISIONS:

REVISIONS 03/04/2011

SCALE: 1':1/4"

DATE: 01/17/2011

,,,,,

CONTAINS:

PROPOSED INTERIOR PLUMBING

PLAN

OFFICE COPY
CITY OF MIAMI BEACH
APPROVED FOR PERMIT BY

THE POLICY ON BERMIT!
BUILDING:
BUIL

BUILDING: ZON: 10: DRB, 1:10: CONCORD , 1:10


03/09/

MEC FIRE PRE-ENGINEERING: PUBLIC WORKS: STRUCTURAL: ELEVATOR:

Chan /03/19/1 B) mall 3/10/1

RHODES RESIDENCE



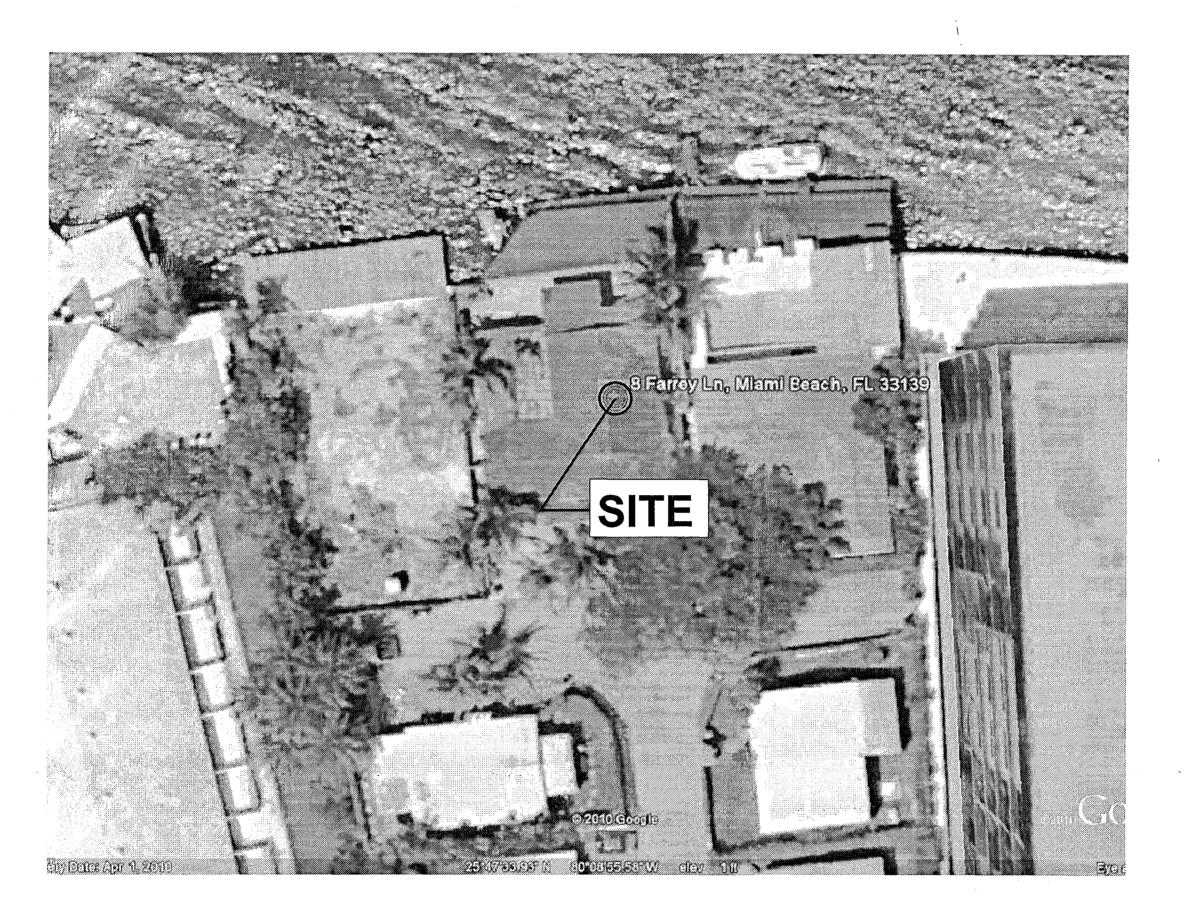

PROJECT LOCATION

SCOPE OF WORK

ALTERATION LEVEL II

. REPLACE WINDOWS & EXTERIOR DOORS AS PER PLAN.

NOTE:

NO MECHANICAL, ELECTRICAL OR PLUMBING WORK TO BE PERFORMED WITHIN THIS PERMIT.

APPLICABLE CODES & REGULATIONS.

JURISDICTION: MIAMI BEACH, FL.

1. 2007 FLORIDA BUILDING CODE (FBC).

2. 2007 FLORIDA STATE ACCESSIBILITY CODE.

Rhodes Residence 8 Farrey Lane MIAMI BEACH, FL. 33139

DRAWN BY:

C.PEREIRA

REVISIONS:

DATE: 01/5/2011

HUAN HEMEMMOTICE PUAN HEMEMMOTICE RUBLIC WORKS

THIS PLAN REVIEW CONSTITUTES APPROVAL FOR OBTAINING BUILDING PERMITS ONLY.

Il construction and/or use of equipment in the right-of-way and ements, requires a separate Public Works Department permit to start of construction.

Permit Requirements: Proof of existing sidewalk/swale area conditions (pictures) and/or posting of sidewalk/roadway bonds (Public Works Inspection of the right-of-way will be required prior to final sign-off on the C.C. / C.O., or the release of bonds.)

Approved/Reviewed By: Dale: 02.74/

31101840


OFFICE COPY
CITY OF MIAWI BEACH
APPROVED FOR PERMIT BY
THE FOLLOWINGS


BUILDING:
ZONING:
ZONING:
DRB/HPB:
CONCURRENCY:
PLUMBING:
ELECTRICAL:
MECHANICAL:
MECHANICAL:
FILE FREVENTION:
DUST LEEING:
FILE PO WORKS:
STRUCTURAL:

CONTAINS:

COVER SHEET

PAGE: # **A-0**

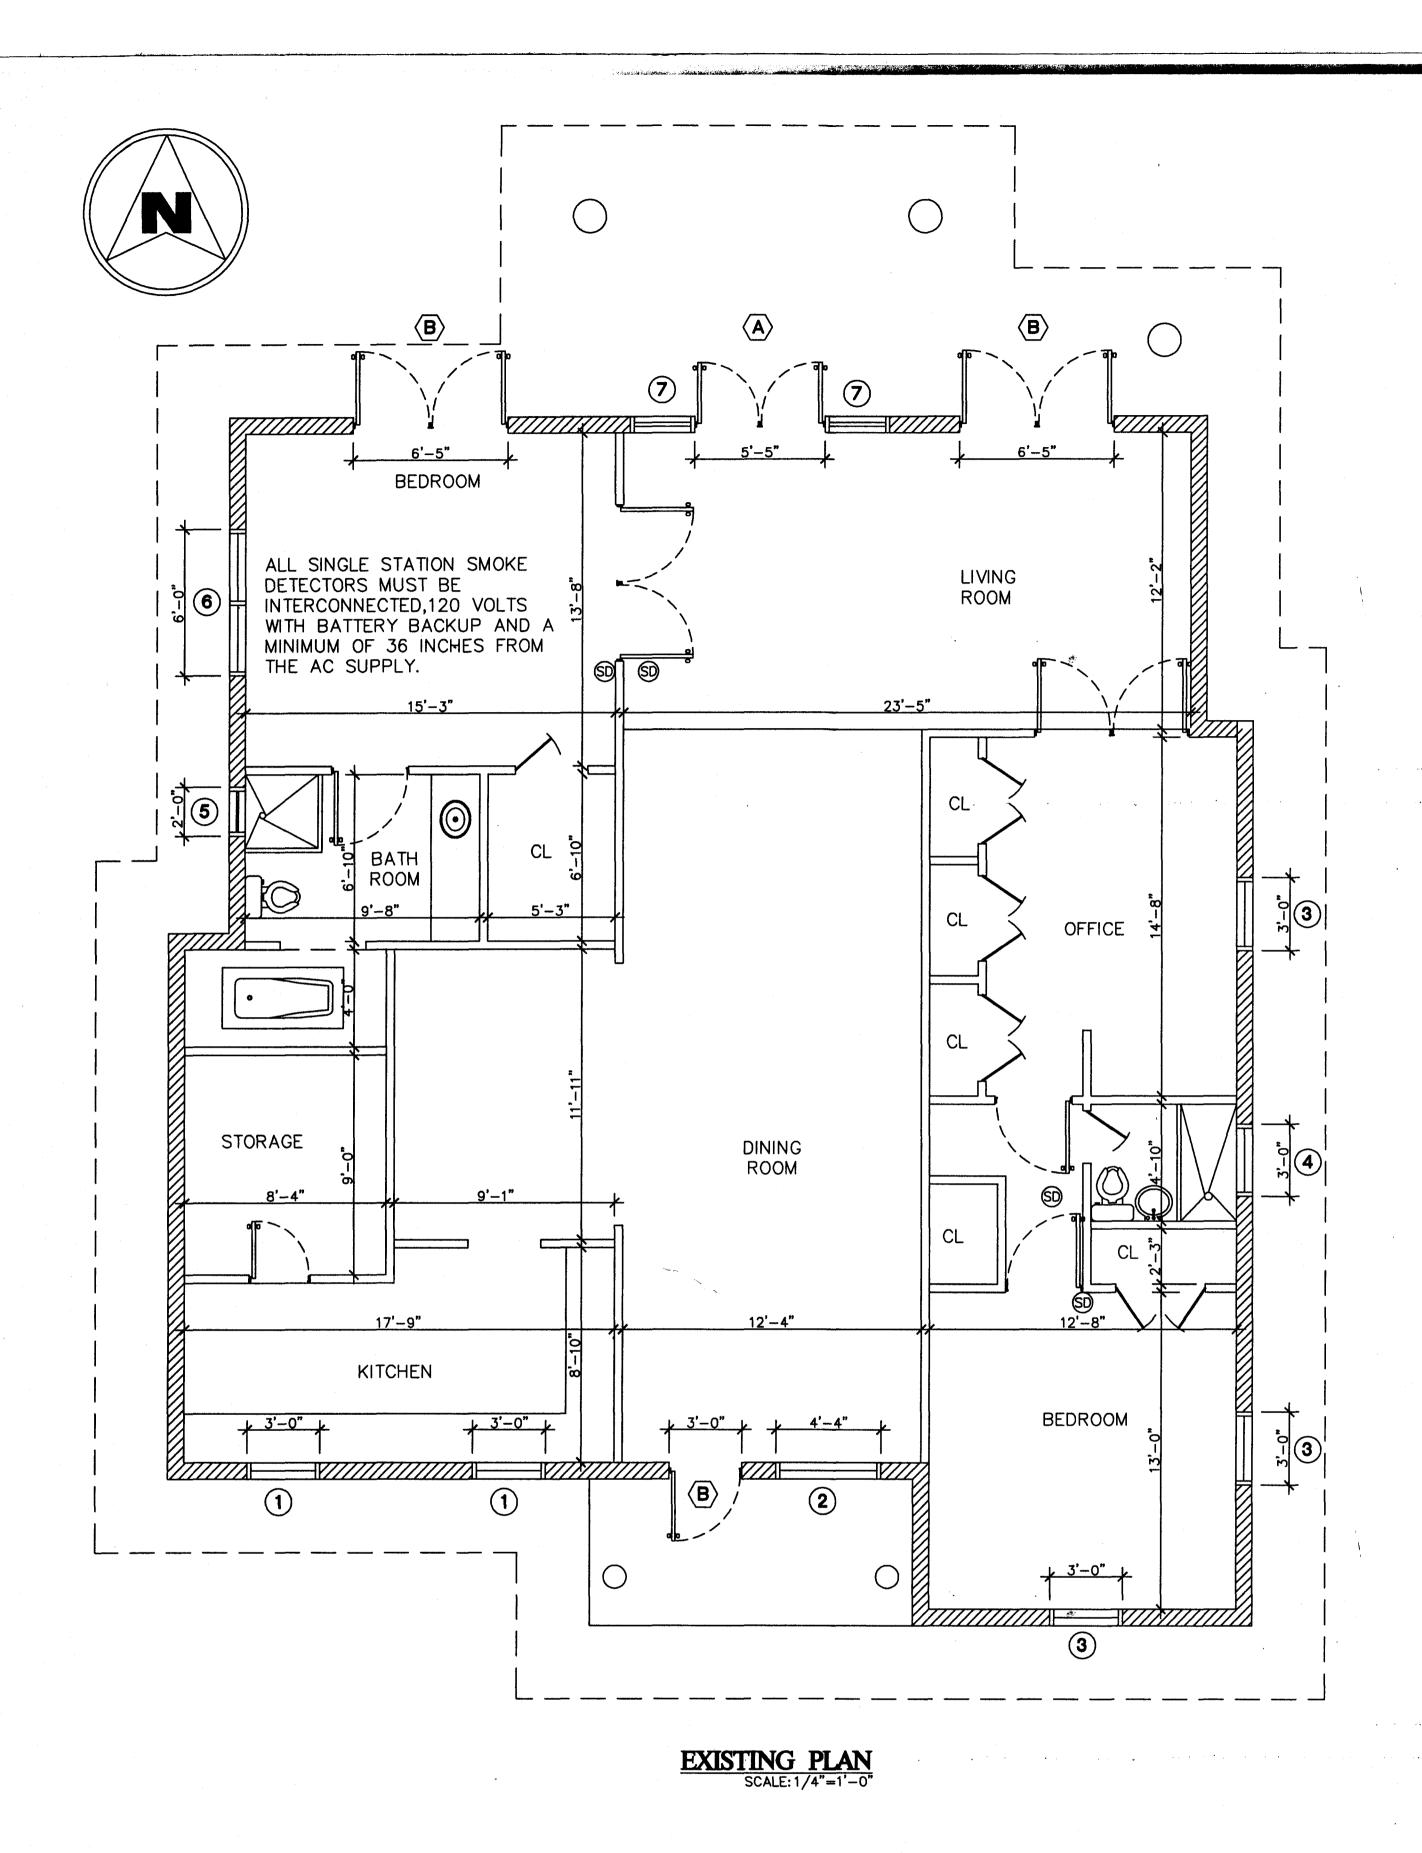

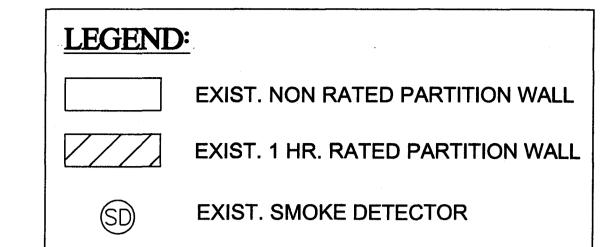

FLC	FLOOR WINDOW SCHEDULE						
WINDOW NUMBER	SIZE	SPECIFICATION					
(2)	36" × 38"	EXISTING					
(1)	52″ × 50″	EXISTING					
3 (3)	36" × 50"	EXISTING					
4 (1)	36" × 17"	EXISTING					
(5) (1)	24" × 24"	EXISTING					
6 (1)	72" × 48"	EXISTING					
7 (2)	34" × 80"	EXISTING					


	DOOR SCHEDULE					
DOOR NUMBER	SIZE	SPECIFICATION				
(A) (2)	80″ X 31″	EXISTING				
B (5)	80″ X 36″	EXISTING				


DRAWN BY 3 C.PEREURA

REVISIONS:

SCALE: 1:3/8° DATE: 01/5/2011

CONTAINS: EXISTING WINDOWS/DOORS PLAN

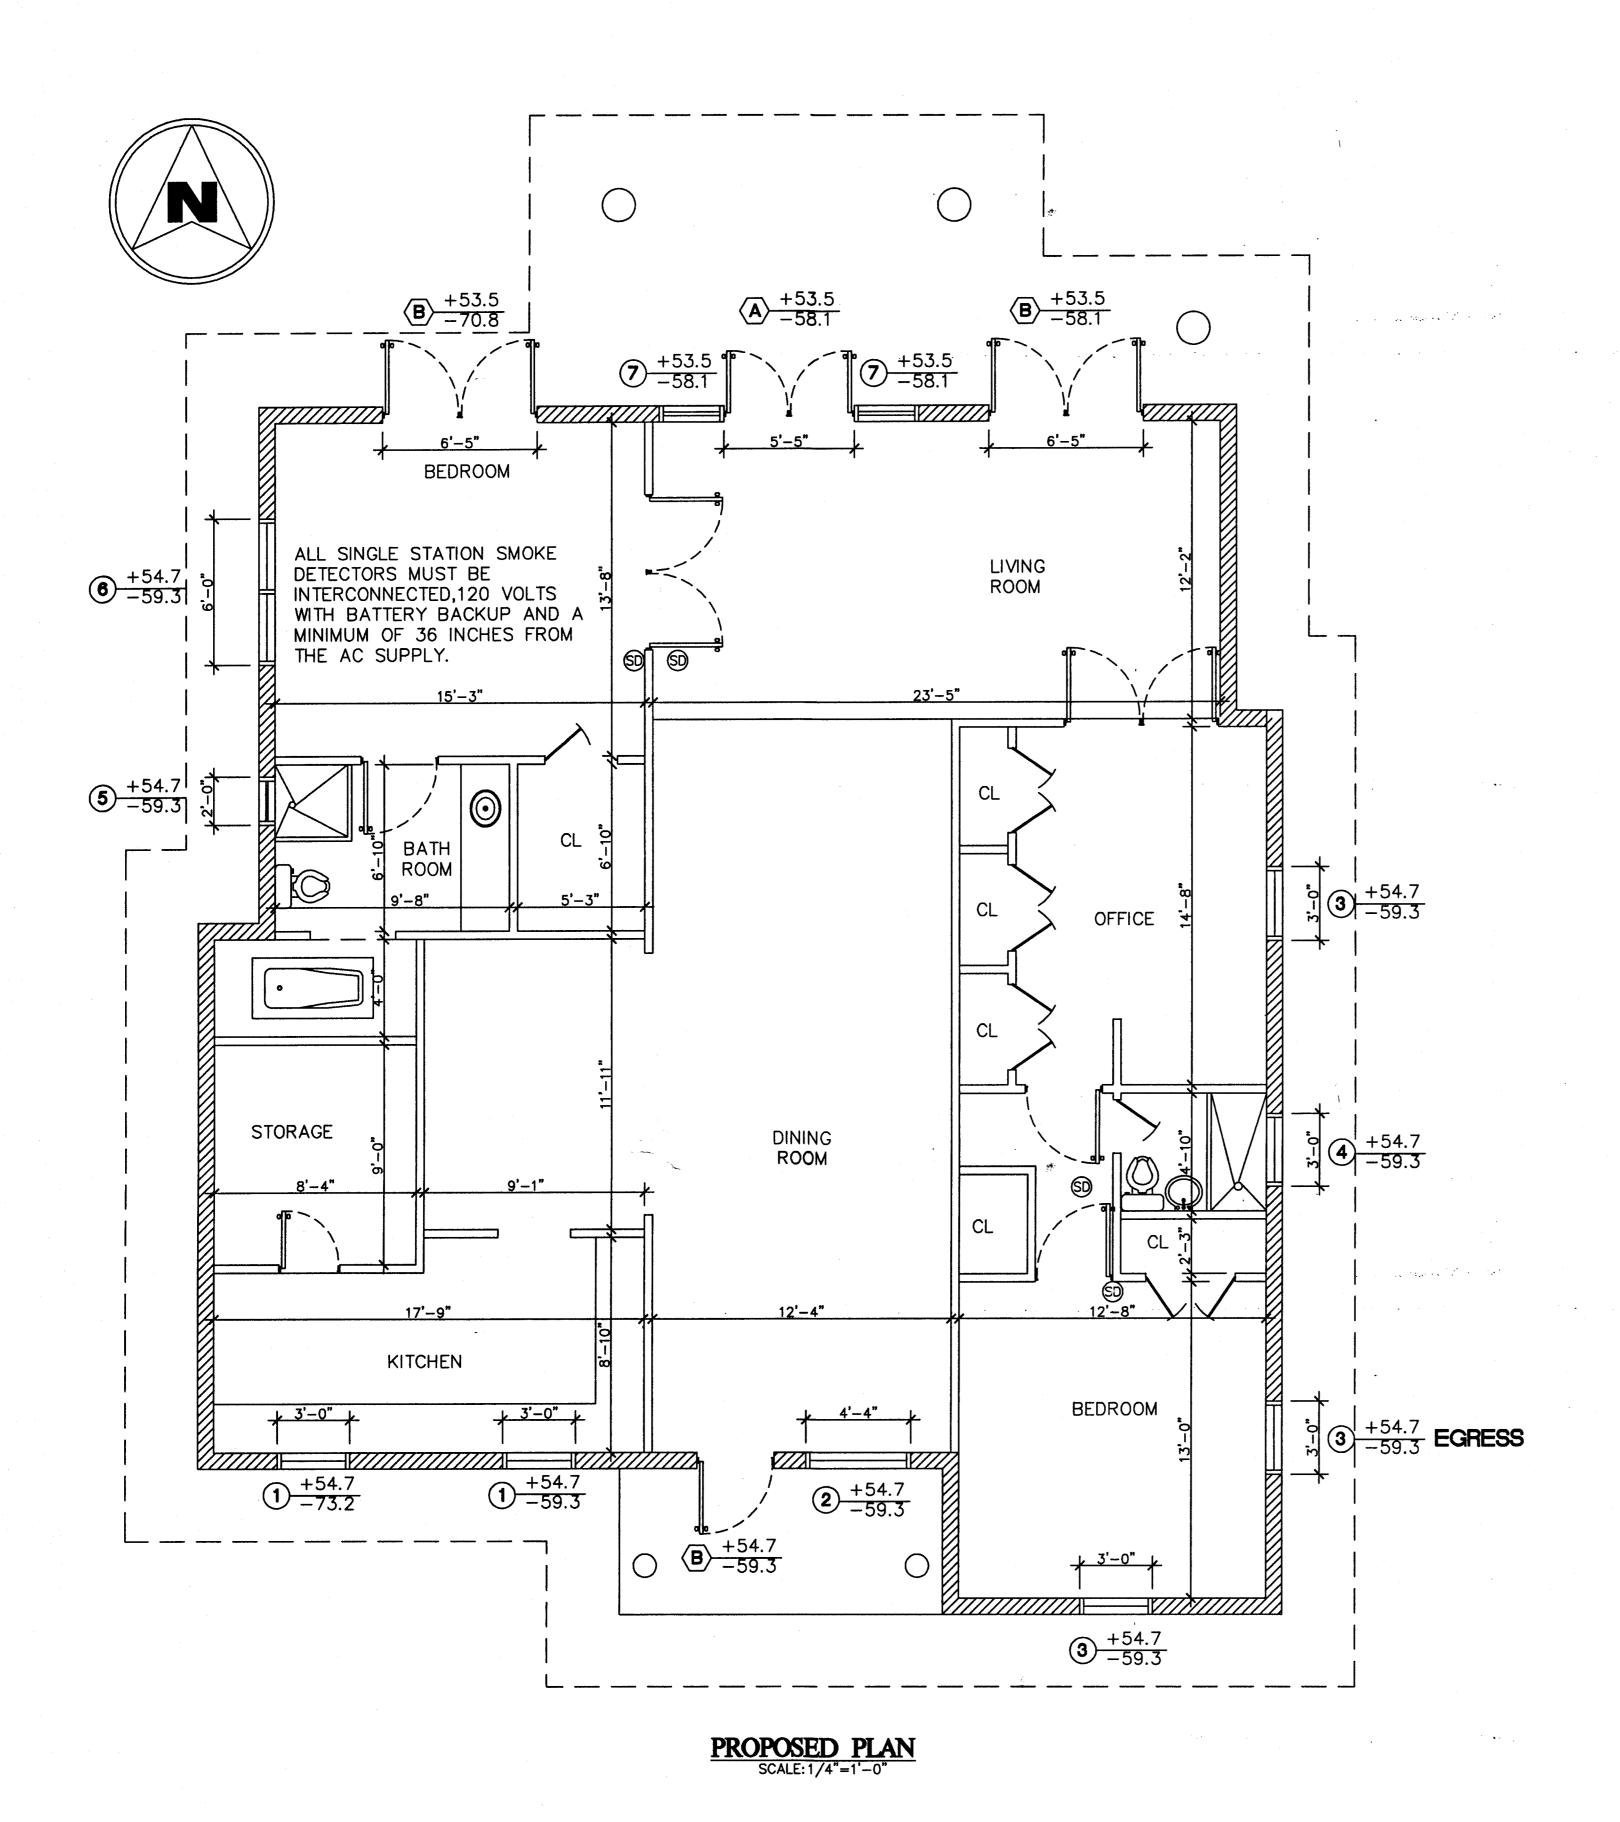


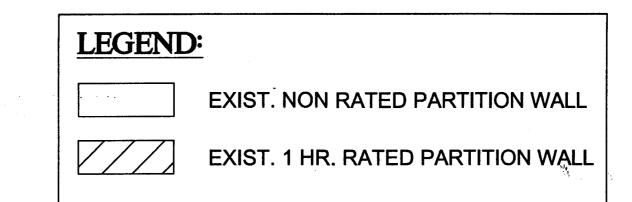

FLOOR WINDOW SCHEDULE				
WINDOW NUMBER	SIZE	SPECIFICATION		
(2)	36" × 38"	NEW (NOA No 08-0117.11)		
2 (1)	52" × 50"	NEW (NOA No 08-0117.11)		
3 (3)	36" × 50"	NEW (NOA No 08-0117.11)		
4 (1)	36" × 17"	NEW (N□A No 08-0117.11)		
(5) (1)	24" × 24"	NEW (N□A No 08-0117,11)		
6 (1)	72" × 48"	NEW (N□A No 08-0117.11)		
7 (2)	34" × 80"	NEW (NOA No 07-0629.10)		


	EDULE	
DOOR NUMBER	SIZE	SPECIFICATION
(2)	80″ X 31″	NEW (N□A No 07-0629.10)
B (5)	80″ X 36″	NEW (NOA No 07-0629.10)

and the contraction of the contract The contraction of the contraction

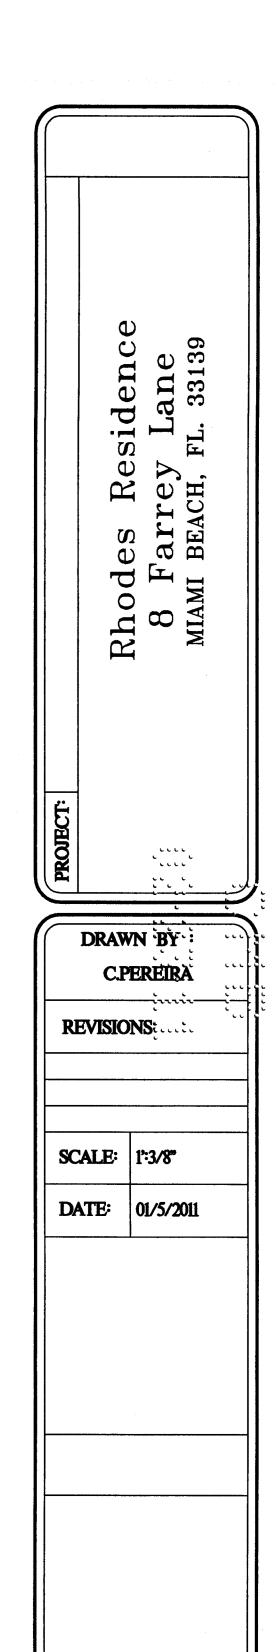


PROPOSED WINDOWS/DOORS PLAN

A-2

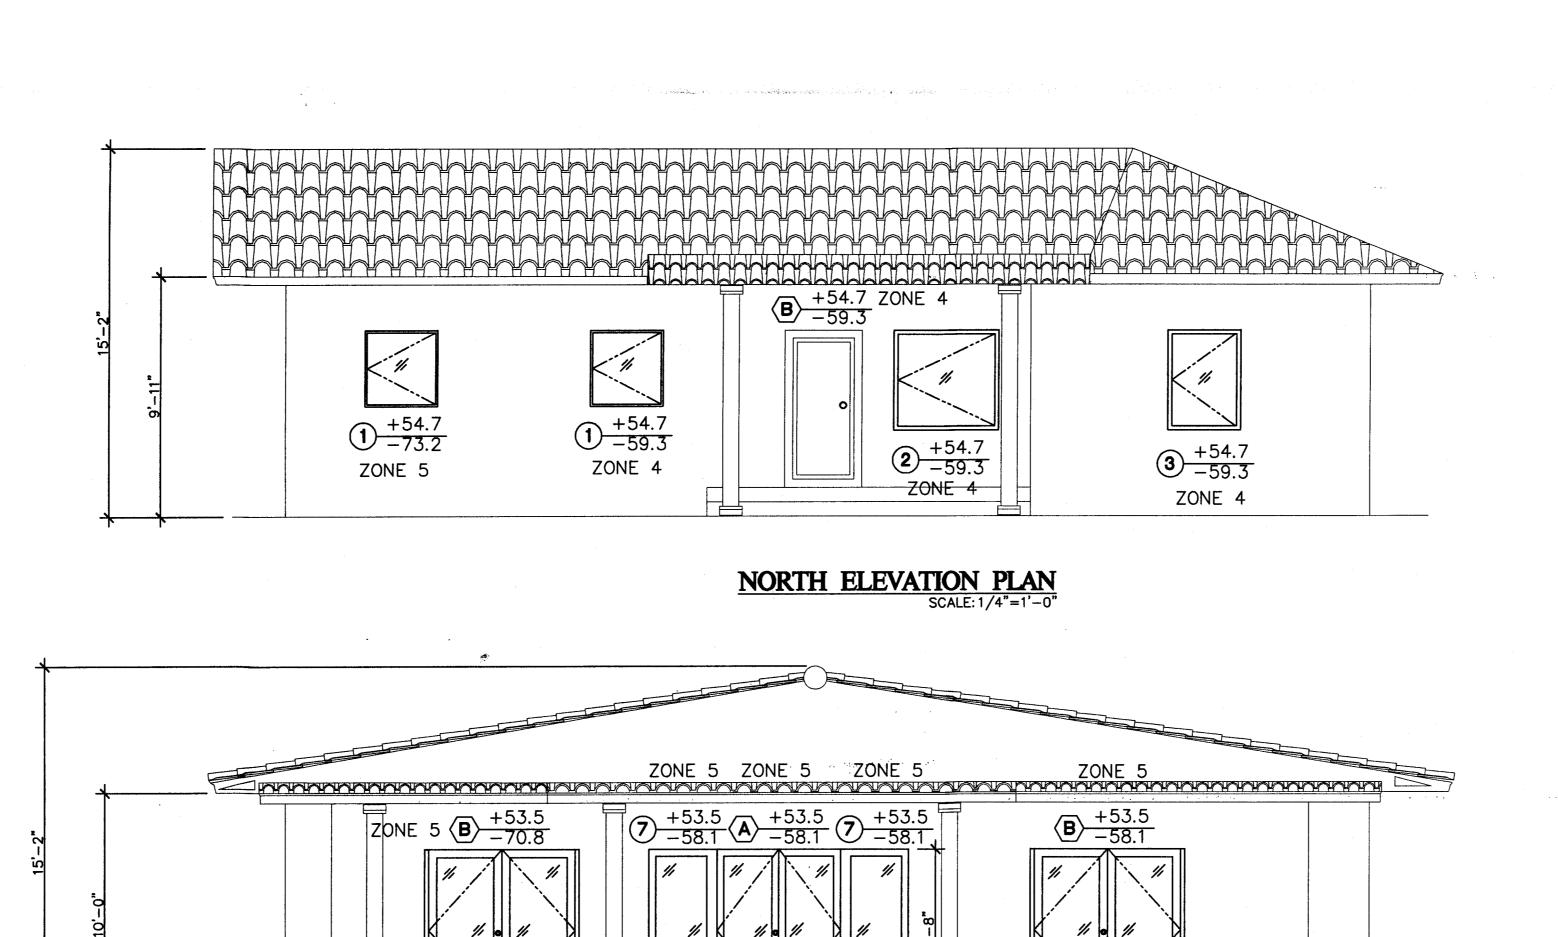


SOUTH ELEVATION PLAN
SCALE: 1/4"=1'-0"

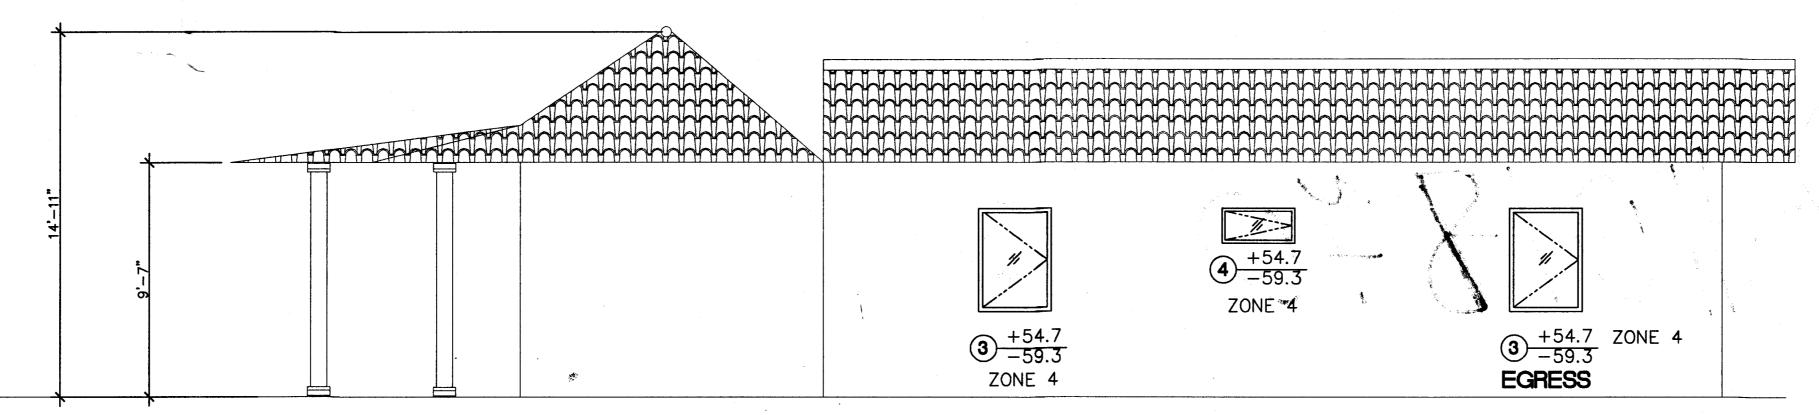

WEST ELEVATION PLAN
SCALE: 1/4"=1'-0"

and the control of the first of the control of the

Land All Market March 1885

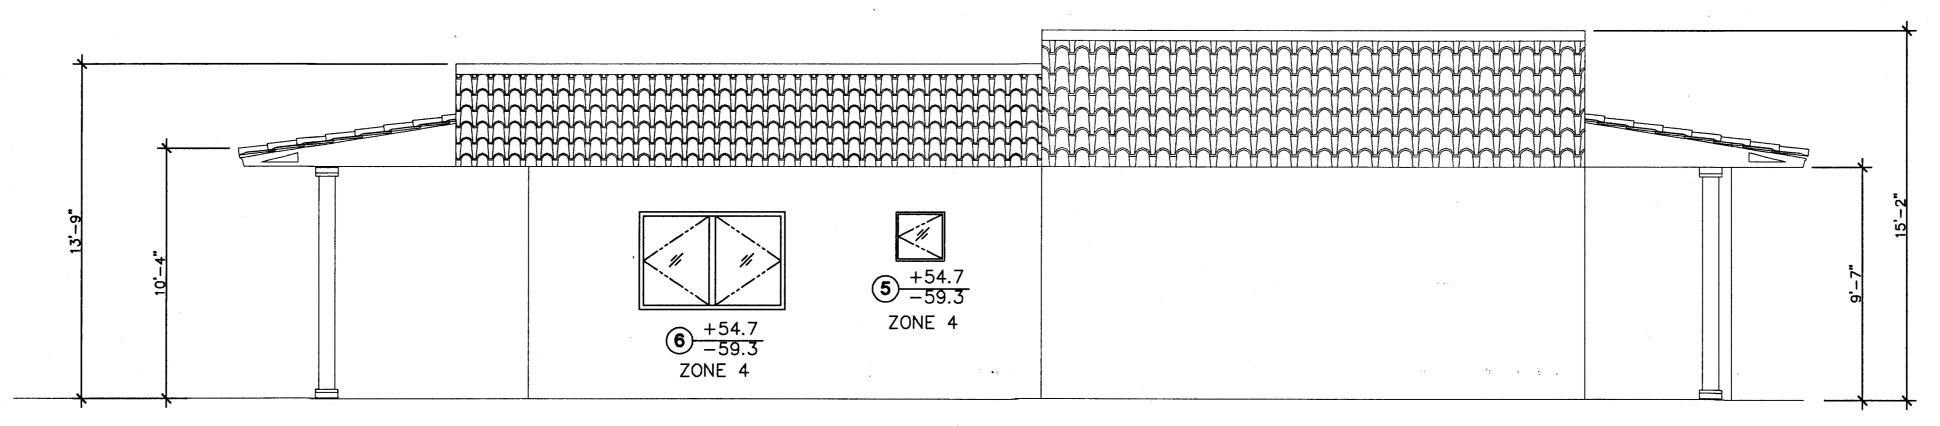

EAST ELEVATION PLAN
SCALE: 1/4"=1'-0"

Rhodes Residence
8 Farrey Lane

DRAWN BY ELLE

C.PEREIRACLEE

REVISIONS:

SCALE: 1/4*-1'

DATE: 01/5/2011

CONTAINS:

PROPOSED WINDOWS/DOORS ELEVATIONS

A-

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0/10/870

OFFICE COPY
CITY OF MIAMI BEACH
APPROVED FOR PERMIT BY
THE FOLLOWING:
DRB/HPB:
CONCURRENCY:
PLUMBING:
ELECTRICAL:
MECHANICAL:
FIRE PREVENTION:
ENGINEERING:
PUBLIC WORKS:
STRUCTURAL:
ELEVATOR:

PLITY OF MIAMI BEACH

APPROVED FOR PERMIT BY

THE PERMIT BY

THE FOLLOWING:

APPROVED FOR PERMIT BY

THE PERMIT B

GENERAL DEMOLITION NOTES

- General Demolition Notes:

 Demolition requires PULL removal of existing building, structural system including piles, terraces, etc
 Provide a detailed sequence of demolition and removal work to ensure uninterrupted progress of client's on-≼ite operation.
- - Cualifications:

 -Provide staff responsible for demolition work fully experienced in this type of work.

 -Provide equipment of suitable type, in good working condition, and operated by skilled mechanics.

 -Perform work in a safe and cautious manner to avoid accidents or property damage,

 Reference Standards: comply with all codes and regulations regarding demolition work.

- Reference Standards: comply with all codes and regulations regarding demolition work.

 Performance:

 Prevent damage to adjoining structure during demolition.

 Prevent damage to electrical wires, underground cables, telephone, water, and sewer lines during demolition.

 Adjust and Clean:

 Remove any demolition materials, debris, and rubbish from the site immediately on completion of demolition work.

 Do not permit any accumulation of debris and disposed materials on site.

 Transport all demolition materials without spillage on streets.

- Leave site neat and orderly on completion of demolition work. Job Conditions:
- Adjacent structures to the demolition areas will be in use
- Client assumes no responsibility for actual condition of structures to be demolished.
- Use of explosives will not be permitted. Traffic:
- nduct demolition operations and removal of debris to ensure minimum interference with roads, streets, walks, and other adjacent occupied

- Conduct demolition operations and removal of debris to ensure minimum interference with roads, streets, walks, and other adjacent occupied and used facilities.
 Do not close or obstruct streets, walks, or other occupied or used facilities without permission from authorities having jurisdiction.
 Provide alternate routes around closed or obstructed traffic ways if required by governing regulations.
 Ensure safe passage of persons around area of demolition. Conduct operations to prevent damage to adjacent buildings, structures, and other facilities and injury to persons.
- Promptly repair damage caused to adjacent finishes, structures to remain or facilities by demolition operations.
- Utilities should be provided to stay in service and protect against damage during demolition operations.
 - Do not Interrupt existing or temporary utilities serving occupied or used facilities, except when authorized in writing by authorities having jurisdiction. Provide temporary services

- jurisdiction, Provide temporary services
 during interruptions to existing utilities, as acceptable to governing authorities.
 Do not start demolition work until utility disconnections have been completed and verified in writing.
 Execution:
 Pollution controls: limit dust and dirt rishing and scattering in the air. Comply with governing regulations pertaining to environmental protection.
 Do not use weter when it may create hazardous or objectionable conditions such as flooding and pollution.
 Clean adjacent structures and Improvements of dust, dirt, and devise caused by demolition operations. Return adjacent areas to
- condition existing prior to start of work.
- Locate demolition equipment throughout structure and remove materials, so as to not impose excessive loads.
- Salvaged Materials:
- Materials for reuse (if any) are to be removed carefully, stored and protected as directed by the client to avoid damage - Except for Items Indicated to be retained as client's property, other removed and salvaged materials not indicated for reuse shall become

- Except for Items Indicated to be retained as client's property, other removed and salvaged materials not indicated for reuse shall becond Contractor's property and removed from the site with further disposition at Contractor's option.

 Storage or sale of removed Items will not be permitted on site.

 Vermin Contrott. If made necessary by the demolition Contractor's work, employ a certified, licensed exterminator and treat the entire area of building demolition and removal in accordance with governing health regulations for rodent and insect control.

 Disposal of demolished and excess materials:

 Remove daily from site accumulated debts, rubblsh, and other material resulting form demolition operations.

 Burning of combustible materials from demolished structures will not be permitted on site.

 Transport materials removed from demolished structures at a legal disposal area off site without spillage

 Do not permit any accumulation of debts and disposed materials on site.

 Leave site neat and orderly on completion of demolition work.

 Site Cleaning:

- Leave site neat and orderly on completion of demolition work.

 Site Clearing:

 Site Preparation/Top Soil:

 Before starting excavation Work, strip all existing sod and organically-rich soil within excavation area suitable for topsoil.

 Adequately protect from damage all existing trees and site improvements indicated to remain and as directed by Architect and Landscape Architect; restore or replace to
- approved condition if damaged.
- Planting: - Relocate all existing plants indicated to be saved to new locations approved by Architect and Landscape Architect
- Replant using best methods possible to guarantee survival of plant specimens. See Landscape Architecture Drawings.
- Assume full responsibility and warn operators of heavy equipment and other workers not to harm plantings which are designated to be saved.
- Assume full responsibility and warn operators of heavy equipment and other workers not to harm plantings which are designated to Stee Cleaning.
 Clean and remove by cutting and hauling all remaining trees and follage as designated.
 Level all dirt and earth piles and backfill holes resulting from excavations for dearing and grubbing work.
 Leave site level with natural existing grades or as noted on drawings and elevations after removal of topsoil and organic materials.
 Eave site hand-raked and free of stones, sitcks, trash, and other debris.
- General: Refer to Structural Drawings for additional soils criteria and requirements.
 Excavation:
 Excavation: o.
- Make excavations sufficiently large to permit placing and removal of forms, installation of waterproofing, damp proofing, and utilities; Make excavations sufficiently large to permit placing and removal of forms, installation of waterproofing, damp proofing, and utilities; and to allow inspection.
 For all areas under proposed building, thoroughly compact exposed surfaces of existing soils as indicated in Structural Drawings.
 Notify Architect when excavations have reached proper levels to receive work to be installed.
 Install work only after excavations and soil conditions have been inspected and approved.
 Classification of Excavation:
 Only one class of excavation is recognized for this Project, 'Unclassified', and includes all kinds of materials encountered during work.
 All costs of excavating all materials encountered are considered part of this Project and no extras are acceptable.
 Excavation for Footing:
 Found bottoms of footing on rock or firm understructure at elevations indicated or as shown.

- Found bottoms of footing on rock or firm understructure at elevations indicated or as shown.
- Sub grade of footing shall be leveled and free of loose rock, dirt, debris, and standing water before acceptance for placing concrete.

 Use vibratory plate compactor at all footing excavations to achieve minimum soil density as indicated on Structural Drawings.
- Excess Excavation: - Do not perform excavation below bottom face of footings or below graded indicated on Drawings, unless directed by both Architect
- and Structural Engineer in writing.

 -If Contractor, without authorization, excavates more than shown on Drawings, refill such excess excavation with 2500 psl concrete or with approved compacted material as directed by both Architect and Structural Engineer.

- Employ geotechnical engineer to monitor all compaction and filling operations and obtain Statement of Compilance from engineer at completion of soil preparation.

 Fill materials: Provide general fill, obtained from excavation on site, if acceptable, or from borrow sources.

 Porous Fill/Sapor Barriers: Provide continuous 6 mill polyethylene vapor barrier under all slabs on grade.

- Placing:
 Place fill materials in horizontal loose layers to produce uniform thickness of material.
- Hace III materials in horizontal loose layers to produce uniform truckness of material.
 Start placement in deepest area and progress approximately parallel to fishbated grade.
 Thickness of layers before compaction: 8 in. for cohesion less soils; do not use cohesive soils.
 Do not place III material on areas where free water is standing or on surfaces which have not been approved.
 Compact to min. 100 percent product density.
 Adjacent Existing Structures:
 Monitor adjacent existing structures for any signs of settlement distress throughout filling and compaction operations.
 Stop all operations if any distress is visible and report to Architect for resolution.


- Refer to structural drawings.
- Contractor to employ a geotechnical engineer to certify pling.
 Contractor to employ a surveyor to certify location of piles and provide pile log.
- Soli in eartherit.

 Refer to structural drawings.

 Contractor to employ geotechnical engineer for certification of soli compaction
- ravements: Refer to Division 4 for paving
- Landscaping: Refer to Architecture and ClvII drawings
- Disposal of Excess Material and Cleanup:

 Unless otherwise directed, all material gotten from excavations and not required for backfilling, filling, or grading becomes
- property of Contractor, t to be removed from site and legally disposed of by Contractor.
- Remove all debris and other undestrable material from property.

 When work is complete, remove all surplus materials and other items of equipment from premises.

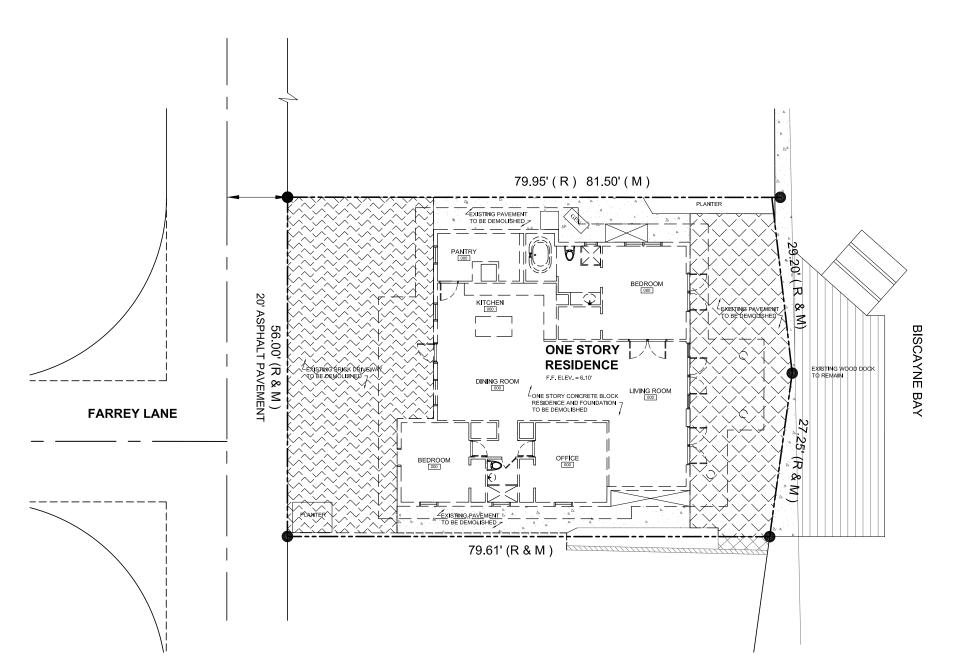

08.12.16 DATE: AS NOTED SCALE: REVISIONS

DEMOLITION PLAN

DEMOLITION PLAN

SCALE: 1/8"=1'-0"