NEW TOWNHOMES ADDITION & HISTORIC RENOVATION OF EXISTING BUILDING FOR:

EUCLID 1610 Inc.

1610 EUCLID AVENUE MIAMI BEACH FL 33139

CLIENT CONTACT: MAURIZIO CAVALIERI (786)-201-1110

HPB FILE#:

PRELIMINARY SUBMITTAL

PROJECT TEAM

PROJECT RENDERING

ARCHITECT OF RECORD: **SKLAR**chitecture

2310 HOLLYWOOD BLVD. HOLLYWOOD, FL 33020 www.sklarchitect.com TEL - (954) 925-9292 FAX - (954) 925-6292

OWNER:

PRESIDENT: Maurizio Cavalie

LANDSCAPE ARCHITECT:

CIVIL ENGINEER:

STRUCTURAL ENGINEER:

MEP ENGINEER:



LOCATION MAP

SCOPE OF WORK

- Complete interior demolition of original 2 ories Building A in order to accommodate 12 wo stories townhomes. (about 6,534 sq. ft. total)

2 – Demolition of the west portion of existing building C (today connect with Building B)

4 – Reconfiguration for remodeling of Building B (about 4,305 sq. ft. total)

LEGAL DESCRIPTION

THIS PROPERTY IS DESCRIBED AS:

LINCOLN SUP PB 9-69 LOT 3 & N1/2 LOT 2 BLK 50 A LOT SIZE 75.000 X 150

FOLIO: 02-3234-002-0410



N SCALE: N.T.S.

CODE ANALYSIS / PROJECT DATA DRAWING INDEX

ARCHITECTURAL COVER
ZONING LEGEND TABLE
FLOOR AREA CALCULATIONS
UNIT AREA CALCULATIONS
SITE ANALYSIS EXISTING BUILDING FRONT IMAGES EXISTING BUILDING FRONT IMA EXISTING BUILDING A IMAGES EXISTING BUILDING B IMAGES EXISTING BUILDING C IMAGES EXISTING BUILDING C IMAGES EXISTING BUILDING C IMAGES EXISTING BUILDING C. IMAGES
PROPOSED RENDERINGS
PROPOSED RENDERINGS
EXISTING/DEMOS ITE PLAN
PROPOSED SITE PLAN
PROPOSED SITE PLAN
BUILDING A EXISTING/PROPOSED FIRST FLOOR PLAN
BUILDING A EXISTING/PROPOSED FIRST FLOOR PLAN BUILDING A EXISTING/PROPOSED SECOND FLOOR PLAN BUILDING A EXISTING/PROPOSED ROOF PLAN BUILDING A EXISTING/PROPOSED ELEVATIONS BUILDING A EXISTING/PROPOSED ELEVATIONS BUILDING A EXISTING/PROPOSED BELEVATIONS BUILDING B EXISTING/PROPOSED FIRST FLOOR PLAN BUILDING B EXISTING/PROPOSED FROST FLOOR PLAN BUILDING B EXISTING/PROPOSED REOF PLAN BUILDING B EXISTING/PROPOSED ELEVATIONS BUILDING B EXISTING/PROPOSED ELEVATIONS BUILDING C EXISTING/PROPOSED FIRST FLOOR PLAN BUILDING C EXISTING/PROPOSED FIRST FLOOR PLAN BUILDING C PROPOSED UPPER/ROOF PLANS BUILDING C EXISTING/PROPOSED FIRST FLOOR PLAN BUILDING C EXISTING/PROPOSED FIRST FLOOR PLAN BUILDING C EXISTING/PROPOSED FIRST FLOOR PLAN BUILDING C EXISTING/PROPOSED FIRST FLOOR PLANS BUILDING C EXISTING PROPOSED FIRST FLOOR PLANS BUILDING C EXISTING ELEVATIONS BUILDING A EXISTING/PROPOSED ROOF PLAN BUILDING C PROPOSED UPPER/ROOF BUILDING C EXISTING ELEVATIONS BUILDING C PROPOSED ELEVATIONS EAST ELEVATION LANDSCAPE PLAN LANDSCAPE PLAN GROUND FLOOR SHORING

GROUND FLOOR SHORING SECTIONS

SH2.0 SH3.0

CONSTRUCTION TYPE PLANS SHALL COMPLY WITH THE FOLLOWING: FLORIDA BUILDING CODE (2014) FLORIDA BUILDING CODE - RESIDENTIAL (2014) FFPC NFPA 101 2012 ED NFPA 72 2012 ED NFPA 13 2012 ED RENOVATION OF (2) 2-STORY EXISTING BUILDINGS AND (1) NEW 3-STORY TOWNHOUS R-2 OCCUPANCY R-2 OCCUPANCY
EXISTING BLDG A MIXED CONRETE WOOD
EXISTING BLDG B ALL CONCRETE
NEW CONSTRUCTION ALL CONCRETE
TYPE III-B CONSTRUCTION ALLOWABLE HEIGHT AND BUILDING AREA (TABLE 503)
GROUP TYPE ALLOWED FIRE RESISTANCE RATING REQUIREMENTS FOR BLDG ELEMENT (TABLE 601) TYPE III-B STRUCTURAL FRAME BEARING WALLS (EXT.& INT) NONBEARING WALLS & PARTITIONS FLOOR CONSTRUCTION ROOF CONSTRUCTION 0 HR 2 HR EXT. & 0 HR INT. 0 HR 0 HR 0 HR MAX. AREA OF EXTERIOR WALL OPENINGS (TABLE 704.8)

		NING LEGEND	
	REQUIREMENTS	EXISTING	PROPOSED
ZONING:	RM-1	RM-1	RM-1
HISTORICAL DISTRICT:	FLAMINGO PARK LOCAL DISTRICT		
ADDRESS:	1610 EUCLID AVE MAMI BEACH, FL 33139		
FOLIO NUMBER:	02-3234-002-0410		
YEAR CONSTRUCTED:	BLDG A 2 STORY CONSTRUCTED IN 1926 (TO BI BLDG B 2 STORY CONSTRUCTED IN 1967 NOT E BLDG C 1 STORY CONSTRUCTED IN 1955 NOT I	IE RENOVATED). DESIGNATED WITH HISTORIC VALUE (TO BE RENOVATED). DESIGNATED WITH HISTORIC VALUE (TO BE DEMOLISHED).	
BASE FLOOD ELEVATION:	8' NGVD	EXISTING BLDG A 6.19" NGVD EXISTING EXISTING BLDG B 6.21" NGVD EXISTING EXISTING BLDG C 6.21" NGVD EXISTING	RENOVATED BLDG A 6.19' (NO CHANGE) RENOVATED BLDG B 6.21'(NO CHANGE) NEW BLDG C 8.00' NGVD
ADJUSTED GRADE (FLOOD +GRADE/2):	N/A		
GRADE VALUE IN NGVD	N/A		
CENTER OF SIDEWALK OR PROVIDED BY PW:			
LOT WIDTH LOT DEPTH: LOT AREA:	75 FT 150 FT 11,250 SQ. FT.		
LOT AREA:		EXISTING BLDG A: 206 SQFT	DEPONITED BY DO. 4: 407 DOET
MINIMUM UNIT SIZE:	550 SF (NEW) 400 SF (REHABILITATED)	EXISTING BLDG A: 208 SQFT EXISTING BLDG A: 208 SQFT EXISTING BLDG C (RESIDENCE): 1150 SQFT	RENOVATED BLDG A: 497 SQFT RENOVATED BLDG B: 348 SQFT * NEW BLDG C: 1,014 SQSF
AVERAGE UNIT SIZE:	800 SF (NEW) 550 SF (REHABILITATED)	EXISTING BLDG A: 323 SQFT	RENOVATED BLDG A: 516 SQFT **
	300 SF (REHABILITATED)	EXISTING BLDG B: 469 SQFT EXISTING BLDG C (RESIDENCE): 1150 SQFT	RENOVATED BLDG B: 529 SQFT *** NEW BLDG C: 1,076 SQFT
FAR	1.25 MAX 1.25 X 11,250 SF = 14,063 SF MAX	EXISTING BLDG A: 6,533 SQ. FT. EXISTING BLDG B: 3,182 SQ. FT. EXISTING BLDG C: 1,150 SQ. FT. TOTAL: 10,865 SQ. FT.	RENOVATED BLDG A: 6,533 SQ. FT. RENOVATED BLDG B: 3,182 SQ. FT. NEW BLDG C: 4,305 SQ. FTG. TOTAL: 14,020 SQ. FT.
HEIGHT: T/O FLAT ROOF			RENOVATED BLDG A: 27'-6"FT
HEIGHT: TIO FLAT ROOF MID POINT TIO SLOPED ROOF TAKEN FROM FLOOD ELEVATION	IF EXISTING STRUCTURE IS TWO STORIES OR HIGHER, THE PROPOSED ADDITION SHALL NOT EXCEED 3 STORIES AND 35FT.	EXISTING BLDG A: 27'-6"FT EXISTING BLDG B: 22"-6"FT EXISTING BLDG C: 13"-0"FT	RENOVATED BLDG A: 27-6"FT RENOVATED BLDG B: 28"-8"FT NEW BLDG C: 34"-0"FT
NUMBER OF STORIES:	MAX 3 STORIES (35FT)	(2) STORY EXISITING BLDG A (2) STORY EXISITING BLDG B (1) STORY EXISITING BLDG C	(2) STORY RENOVATED BLDG A (2) STORY RENOVATED BLDG B (3) STORY NEW BLDG C
GROSS SQ FOOTAGE (FOOTPRINT):		EXISTING BLDG A: 3,267 SQ, FT. EXISTING BLDG B: 1,591 SQ, FT. EXISTING BLDG C: 1,150 SQ, FT.	RENOVATED BLDG A: 3,267 SQ, FT. RENOVATED BLDG B: 1,591 SQ, FT. NEW BLDG C: 1435 SQ, FT.
NUMBER OF RESIDENTIAL UNITS:		EXISTING BLDG A: 16 UNITS EXISTING BLDG B: 6 UNITS EXISTING BLDG C: 1 UNIT TOTAL: 23 UNITS	RENOVATEO BLDG A: 12 UNITS RENOVATEO BLDG B: 6 UNITS NEW BLDG C: 4 UNITS TOTAL: 22 UNITS
OCCUPANCY LOAD:	FOR R-2 200 PER SQ.FT.	FOR R-2 200 PER SQ.FT. BLDG 8-3.184 SD. FT./200=32.7 OCCUPANTS BLDG 8-3.184 SD. FT./200=152.7 OCCUPANTS BLDG 8-3.184 SD. FT./200=152.0 COUPANTS TOTAL: TOTAL:	
PEDESTAL:			
FRONT SETBACK (EAST):	20'-0"	EXISTING BLDG A: 14.81' EXISTING BLDG B: 19.91'	EXISTING BLDG A: 14.81' (NO CHANGE) EXISTING BLDG B: 19.91' (NO CHANGE)
SIDE SETBACK (NORTH):	7.6"	EXISTING BLDG A: 3.14° EXISTING BLDG C: 2.65°	EXISTING BLDG A: 3.14' (NO CHANGE) NEW BLDG C: 7'-6"
SIDE SETBACK (SOUTH):	T-5"	EXISTING BLDG B: 4.91' EXISTING BLDG C: 4.91'	EXISTING BLDG B: 4.91' NEW BLDG C: 7'-6"
REAR SETBACK (WEST):	10% X 150"= 15"-0" 10% of but depth	10% X 150°= 15°-0" 10% of bit dapth EXSTING BLDG C: 4.95 (AVERAGE) 4.85 (NORTH END) 5.05 (SCUITH END)	
PARKING:			
	45	T	Т
PARKING DISTRICT:	1.5 per unit 1.5 x 12 units (EXISTING bidg A) = 18 1.5 x 6 units (EXISTING bidg B) = 9 1.5 x 4 units (NEW bidg C) = 6 TOTAL: 33	8 PARKING SPACES (TO BE REMOVED)	NO PARKING PROVIDED. IMPACT FEE WILL BE PAID AT TIME OF PERMIT
	NEW REQUIRED: 6		
LOADING ZONES AND TRASH COLLECTION AREAS:	N/A	1	1

***BUILDING & AVERAGE UNIT SIZE VARIANCE REQUEST: 32 5F VARIANCE REQUEST (346 5F MIN. UNIT SIZE)

***BUILDING & AVERAGE UNIT SIZE VARIANCE REQUEST: 32 5F VARIANCE REQUEST (346 5F MIN. UNIT SIZE)

***BUILDING & AVERAGE UNIT SIZE VARIANCE REQUEST: 21 5F VARIANCE REQUEST (529 5F AVERG. UNIT SIZE)

****NEW BLDG C REAR SETBACK VARIANCE REQUEST: 10 FT VARIANCE REQUEST (5 FT FROM PROPERTY LINE)

SKLAR chitecture TEL - (954) 925-9292 FAX - (954) 925-6292 BEACH MIAMI AVE.

EUCLID 1610 NEW TOWNHOMES & HISTORY
THREEGO INC. 11
1610 Euclid Avenue,
Monni Beach FL 33139

□ REVIEW SET
□ PRELIMINARY
□ NOT FOR CONSTRUCTION
□ DRY RUN PERMIT SET
□ PERMIT SET
□ BID SET
□ FINAL SUBMITTAL

DRAWN BY: Author CHECKED BY: ARI SKLAR

Ao.c

DATE: 03-29-16

ZONING LEGEND			
	REQUIREMENTS	EXISTING	PROPOSED
ZONING:	RM-1	RM-1	RM-1
HISTORICAL DISTRICT:	FLAMINGO PARK LOCAL DISTRIC	T .	
ADDRESS:	1610 EUCLID AVE MIAMI BEACH,	FL 33139	
EOLIO NILIMPED:	02-3234-002-0410		
FOLIO NUMBER: YEAR CONSTRUCTED:	BLDG A 2 STORY CONSTRUCTED IN 1926 (TO BE RENOVATED).		
TEAR GONGINGOTED.	BLDG B 2 STORY CONSTRUCTE	D IN 1926 (10 BE RENOVATED). D IN 1967 NOT DESIGNATED WITH HISTOR D IN 1955 NOT DESIGNATED WITH HISTOR	
BASE FLOOD ELEVATION:	8' NGVD	EXISTING BLDG A 6.19' NGVD EXISTING EXISTING BLDG B 6.21' NGVD EXISTING EXISTING BLDG C 6.21' NGVD EXISTING	RENOVATED BLDG A 6.19' (NO CHANGE RENOVATED BLDG B 6.21'(NO CHANGE NEW BLDG C 8.00' NGVD
ADJUSTED GRADE (FLOOD +GRADE/2):	N/A		
GRADE VALUE IN NGVD (CENTER OF SIDEWALK OR PROVIDED BY PW:	N/A		
LOT WIDTH:	75 FT		
LOT DEPTH: LOT AREA:	150 FT 11,250 SQ. FT.		
MINIMUM UNIT SIZE:	550 SF (NEW) 400 SF (REHABILITATED)	EXISTING BLDG A: 206 SQFT EXISTING BLDG B: 311 SQFT EXISTING BLDG C (RESIDENCE): 1150 SQFT	RENOVATED BLDG A: 497 SQFT RENOVATED BLDG B: 348 SQFT * NEW BLDG C: 1,014 SQSF
AVERAGE UNIT SIZE:	800 SF (NEW) 550 SF (REHABILITATED)	EXISTING BLDG A: 323 SQFT EXISTING BLDG B: 469 SQFT EXISTING BLDG C (RESIDENCE): 1150 SQFT	RENOVATED BLDG A: 516 SQFT ** RENOVATED BLDG B: 529 SQFT *** NEW BLDG C: 1,076 SQFT
FAR:	1.25 MAX 1.25 X 11,250 SF = 14,063 SF MAX	EXISTING BLDG A: 6,533 SQ. FT. EXISTING BLDG B: 3,182 SQ. FT. EXISTING BLDG C: 1,150 SQ. FT. TOTAL: 10,865 SQ. FT.	RENOVATED BLDG A: 6,533 SQ. FT. RENOVATED BLDG B: 3,182 SQ. FT. NEW BLDG C: 4,305 SQ. FTG. TOTAL: 14,020 SQ. FT.
HEIGHT:T/O FLAT ROOF MID POINT T/O SLOPED ROOF TAKEN FROM FLOOD ELEVATION	IF EXISTING STRUCTURE IS TWO STORIES OR HIGHER, THE PROPOSED ADDITION SHALL NOT EXCEED 3 STORIES AND 35FT.	EXISTING BLDG A: 27"-6"FT EXISTING BLDG B: 22"-8"FT EXISTING BLDG C: 13"-0"FT	RENOVATED BLDG A: 27'-6"FT RENOVATED BLDG B: 28"-8"FT NEW BLDG C: 34"-0"FT
NUMBER OF STORIES:	MAX 3 STORIES (35FT)	(2) STORY EXISITING BLDG A (2) STORY EXISITING BLDG B (1) STORY EXISITING BLDG C	(2) STORY RENOVATED BLDG A (2) STORY RENOVATED BLDG B (3) STORY NEW BLDG C
GROSS SQ FOOTAGE (FOOTPRINT):		EXISTING BLDG A: 3,267 SQ. FT. EXISTING BLDG B: 1,591 SQ. FT. EXISTING BLDG C: 1,150 SQ. FT.	RENOVATED BLDG A: 3,267 SQ. FT. RENOVATED BLDG B: 1,591 SQ. FT. NEW BLDG C: 1435 SQ. FT.
NUMBER OF RESIDENTIAL UNITS:		EXISTING BLDG A: 16 UNITS EXISTING BLDG B: 6 UNITS EXISTING BLDG C: 1 UNIT TOTAL: 23 UNITS	RENOVATED BLDG A: 12 UNITS RENOVATED BLDG B: 6 UNITS NEW BLDG C: 4 UNITS TOTAL: 22 UNITS
OCCUPANCY LOAD:	FOR R-2 200 PER SQ.FT. BLDG A: 6,553 SQ. FT. / 200= 32.7 (BLDG B: 3,184 SQ. FT./200= 15.92 (BLDG C: 4,305 SQ. FT./200= 21.52 (TOTAL:		DCCUPANTS
PEDESTAL:			
FRONT SETBACK (EAST):	20'-0"	EXISTING BLDG A: 14.81' EXISTING BLDG B: 19.91'	EXISTING BLDG A: 14.81' (NO CHANGE) EXISTING BLDG B: 19.91' (NO CHANGE)
SIDE SETBACK (NORTH):	7'-6"	EXISTING BLDG A: 3.14' EXISTING BLDG C: 2.65'	EXISTING BLDG A: 3.14' (NO CHANGE) NEW BLDG C: 7'-6"
SIDE SETBACK (SOUTH):	7'-6"	EXISTING BLDG B: 4.91' EXISTING BLDG C: 4.91'	EXISTING BLDG B: 4.91' NEW BLDG C: 7'-6"
REAR SETBACK (WEST):	10% X 150'= 15'-0" 10% of lot depth	EXISTING BLDG C: 4.95' (AVERAGE) 4.85' (NORTH END) 5.05' (SOUTH END)	NEW BLDG C: 5'- 0" ****
PARKING:			
PARKING DISTRICT:	1.5 per unit	8 PARKING SPACES	NO PARKING PROVIDED.
PARAMEDISTRICT.	1.5 x 12 units (EXISTING bldg A) = 1.5 x 6 units (EXISTING bldg B) = 9 1.5 X 4 units (NEW bldg C) = 6 TOTAL: 33	18 (TO BE REMOVED)	IMPACT FEE WILL BE PAID AT TIME OF PERMIT
	NEW REQUIRED: 6		
LOADING ZONES AND TRASH COLLECTION AREAS:	N/A		

* BUILDING B MINIMUM UNIT SIZE VARIANCE REQUEST: 52 SF VARIANCE REQUEST (348 SF MIN. UNIT SIZE)

*** BUILDING A AVERAGE UNIT SIZE VARIANCE REQUEST: 32 SF VARIANCE REQUEST (516 SF AVERG. UNIT SIZE)

*** BUILDING B AVERAGE UNIT SIZE VARIANCE REQUEST: 21 SF VARIANCE REQUEST (529 SF AVERG. UNIT SIZE)

**** NEW BLDG C REAR SETBACK VARIANCE REQUEST: 10 FT VARIANCE REQUEST (5 FT FROM PROPERTY LINE)

SKLAR NEW TOWNHOMES & HISTORIC RENOVATION OF EXISTING BULLDING FOR
THREEGO INC. 1610 EUCLID AVE. MIAMI BEACH
1510 Eucld Avenue.
Marri Beach FL. 3339 REVIEW SET

PRELIMINARY

NOT FOR CONSTRUCTION


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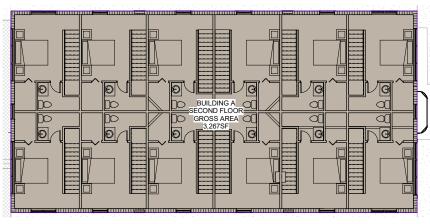
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CONSTRUCTION SET DRAWN BY: Author CHECKED BY: ARI SKLAR **A0.3** DATE: 03-29-16

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2 BLDG A_GROSS AREA_FIRST FLOOR



8 BLDG C_GROSS AREA_THRID FLOOR

3 BLDG A GROSS AREA SECOND FLOOR

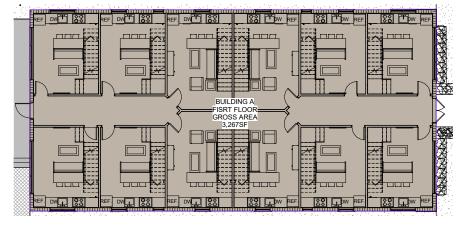


GROSS AREA CALCULATIONS BUILDING A		
AREA		
3,267 SF		
3,267 SF		
6,534 SF		

GROSS AREA CALCULATIONS BUILDING B	
NAME	AREA
FIRST FLOOR	1,591 SF
SECOND FLOOR	1,591 SF
TOTAL 3,182 SF	

GROSS AREA CALCULATIONS BUILDING C		
NAME	AREA	
FIRST FLOOR	1,435 SF	
SECOND FLOOR	1,435 SF	
THIRD FLOOR	1,435 SF	
TOTAL 4,305 SF		

TOTAL GROSS AREA		
NAME	AREA	
BUILDING A	6,534 SF	
BUILDING B	3,182 SF	
BUILDING C	4,305 SF	
TOTAL	14,021SF	

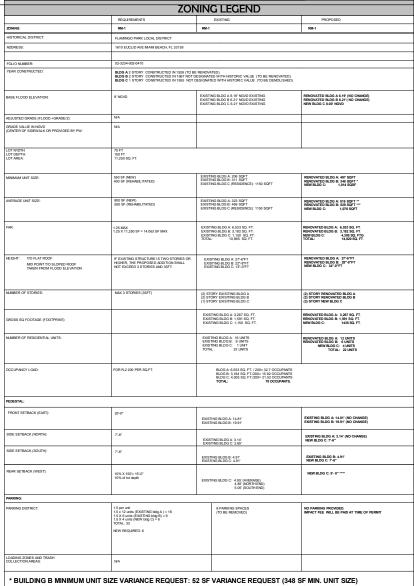

SKLAR

SEAL ARI L. SKLAR LICENSE #AR1473

REVISIONS

HOLLYWOOD, FL 3302 TEL - (954) 925-9292 FAX - (954) 925-6292 www.SKLARchitect.com AA 0002849 IB 0000894 NCARB CERTIFIED

BEACH

MIAMI

1610 EUCLID AVE.

NEW TOWNHOMES & HISTORY
THREEGO INC. 11
1610 Euclid Avenue,
Monni Beach FL 33139

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□ PRELIMINARY
□ NOT FOR CONSTRUCTION
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□ PERMIT SET
□ BID SET
□ CONSTRUCTION SET

SUBMITTAL DATE: 06-09-16

DRAWN BY: Author CHECKED BY: ARI SKLAR

FLOOR AREA CALCULATIONS

A0.4

PROJECT #: 16-006

DATE: 03-29-16

* BUILDING B MINIMUM UNIT SIZE VARIANCE REQUEST: 52 SF VARIANCE REQUEST (348 SF MIN. UNIT SIZE)


** BUILDING A AVERAGE UNIT SIZE VARIANCE REQUEST: 32 SF VARIANCE REQUEST (516 SF AVERG. UNIT SIZE)

**** BUILDING B AVERAGE UNIT SIZE VARIANCE REQUEST: 21 SF VARIANCE REQUEST (529 SF AVERG. UNIT SIZE)


***** NEW BLDG C REAR SETBACK VARIANCE REQUEST: 10 FT VARIANCE REQUEST (571 FF ROM PROPERTY LINE)



4 BLDG B_GROSS AREA_FIRST FLOOR

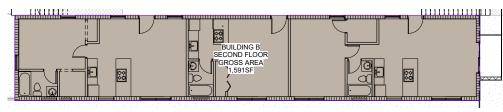

5 BLDG B_GROSS AREA_SECOND FLOOR

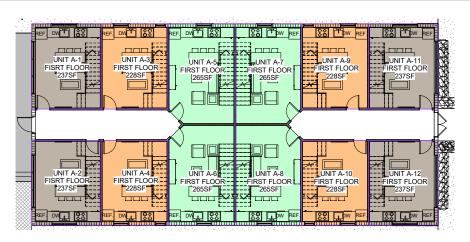


BLDG A_UNIT AREA_FIRST FLOOR

1/8" = 1"-0"

UNIT A-1 SECOND FLOOR- 280SF	UNIT A3 SECOND FLOOR- 299SF	UNIT A-5 SECOND FLOOR- 1 269SF	UNIT A-7 SECOND FLOOR	UNIT A9 SECOND FLOOR	UNIT A-11 SECOND FLOOR 280SF
UNIT A-2 SECOND FLOOR: 280SF	UNIT A-4 SECOND FLOOR 269SF	Unit A6	UNIT A-8 SECOND FLOOR 289SF	UNIT A-10 D SECOND FLOOR	UNIT A-12 SECOND FLOOR

3 BLDG A_UNIT AREA_SECOND FLOOR

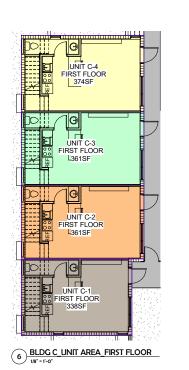



NAME		AREA
UNIT A-1		517 SF
UNIT A-2		517 SF
UNIT A-3		497 SF
UNIT A-4		497 SF
UNIT A-5		534 SF
UNIT A-6		534 SF
UNIT A-7		534 SF
UNIT A-8		534 SF
UNIT A-9		497 SF
UNIT A-10		497 SF
UNIT A-11		517 SF
UNIT A-12		517 SF
TOTAL		6,192 SF
AVERAGE .	AREA	6,192/12 = 516 SF

UNIT AREA CALCULATIONS BUILDING B	
NAME	AREA
UNIT B-1	651 SF
UNIT B-2	348 SF
UNIT B-3	588 SF
UNIT B-4	651 SF
UNIT B-5	348 SF
UNIT B-6	588 SF
TOTAL	3,174 SF
AVERAGE AREA	3,174/6 = 529 SF

UNIT AREA CALCULATIONS BUILDING C		
NAME	AREA	
UNIT C-1	1,014 SF	
UNIT C-2	1,083 SF	
UNIT C-3	1,083 SF	
UNIT C-4	1,122 SF	
TOTAL	4,302 SF	
AVERAGE AREA	4,302/4 = 1,076 SF	

500

THIRD FLOOR


UNIT C-1_ THIRD FLOOR

8 BLDG C_UNIT AREA_THRID FLOOR

UNIT AREA CALCULATIONS TOTAL SITE		
NAME	AREA	
MINIMUM UNIT SIZE	348 SF	
AVERAGE UNIT SIZE	621 SF	

UNIT AREA CALCULATIONS TOTAL REHAB		
NAME	AREA	
BUILDING A TOTAL	6,192 SF	
BUILDING B TOTAL	3,174 SF	
TOTAL	9,366 SF	
MINIMUM A & B	348 SF	
AVERAGE A & B	9,366/18= 520 SF	

UNIT AREA CALCULATIONS TOTAL NEW	
NAME	AREA
BUILDING C MIN.	1,014 SF
BUILDING C AVERAGE	1,076 SF

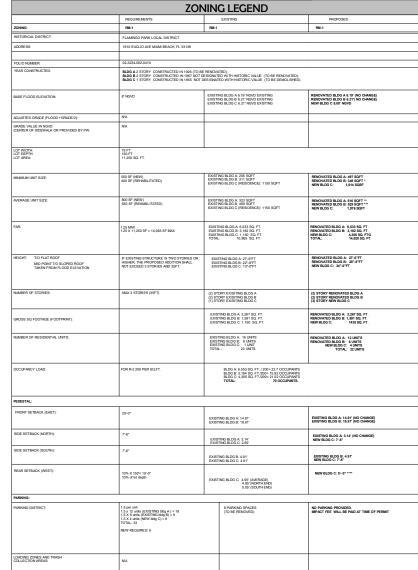


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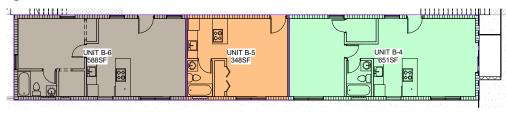
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*** BUILDING B AVERAGE UNIT SIZE VARIANCE REQUEST: 21 SF VARIANCE REQUEST (529 SF AVERG. UNIT SIZE)

**** NEW BLDG C REAR SETBACK VARIANCE REQUEST: 10 FT VARIANCE REQUEST (5 FT FROM PROPERTY LINE)



4 BLDG B UNIT AREA_FIRST FLOOR

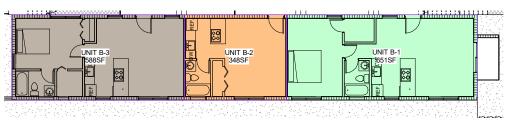

5 BLDG B UNIT AREA_SECOND FLOOR

REVIEW SET

REVIEW

BEACH

1610 EUCLID AVE.

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REVISIONS

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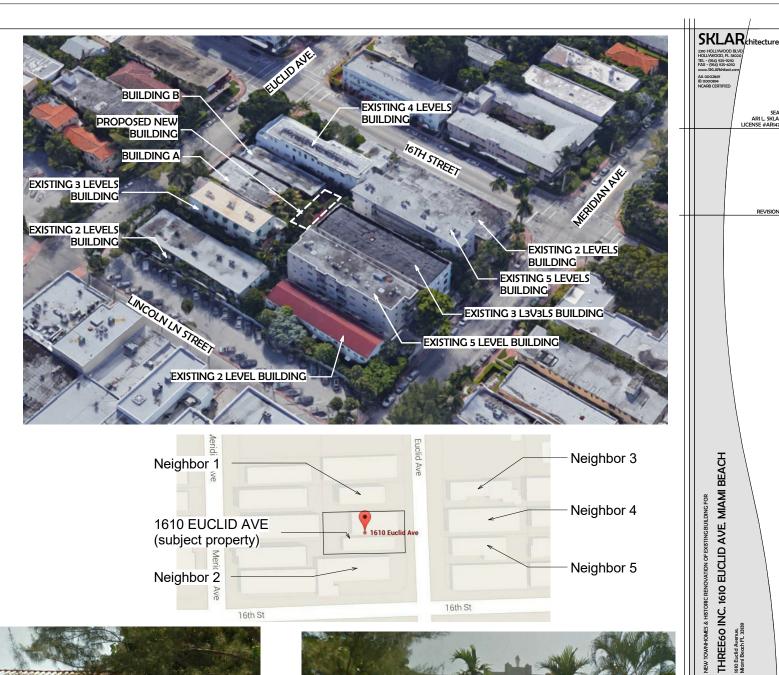
Neighbor 1- 1614 EUCLID AVE



Neighbor 5- 1605 EUCLID AVE




Neighbor 2- 1600 EUCLID AVE





Neighbor 3- 1615 EUCLID AVE

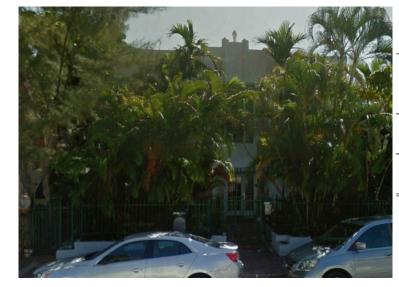

Neighbor 4- 1611 EUCLID AVE


□ NOT FOR CONSTRUCTION
□ DRY RUN PERMIT SET
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□ FINAL SUBMITTAL
SUBMITTAL DATE: 06-09-16


DRAWN BY:
Author
CHECKED BY:
ARI SKLAR

SITE ANALYSIS

DATE: 03-29-16

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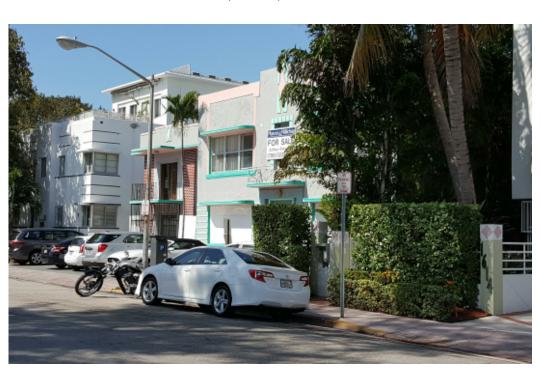


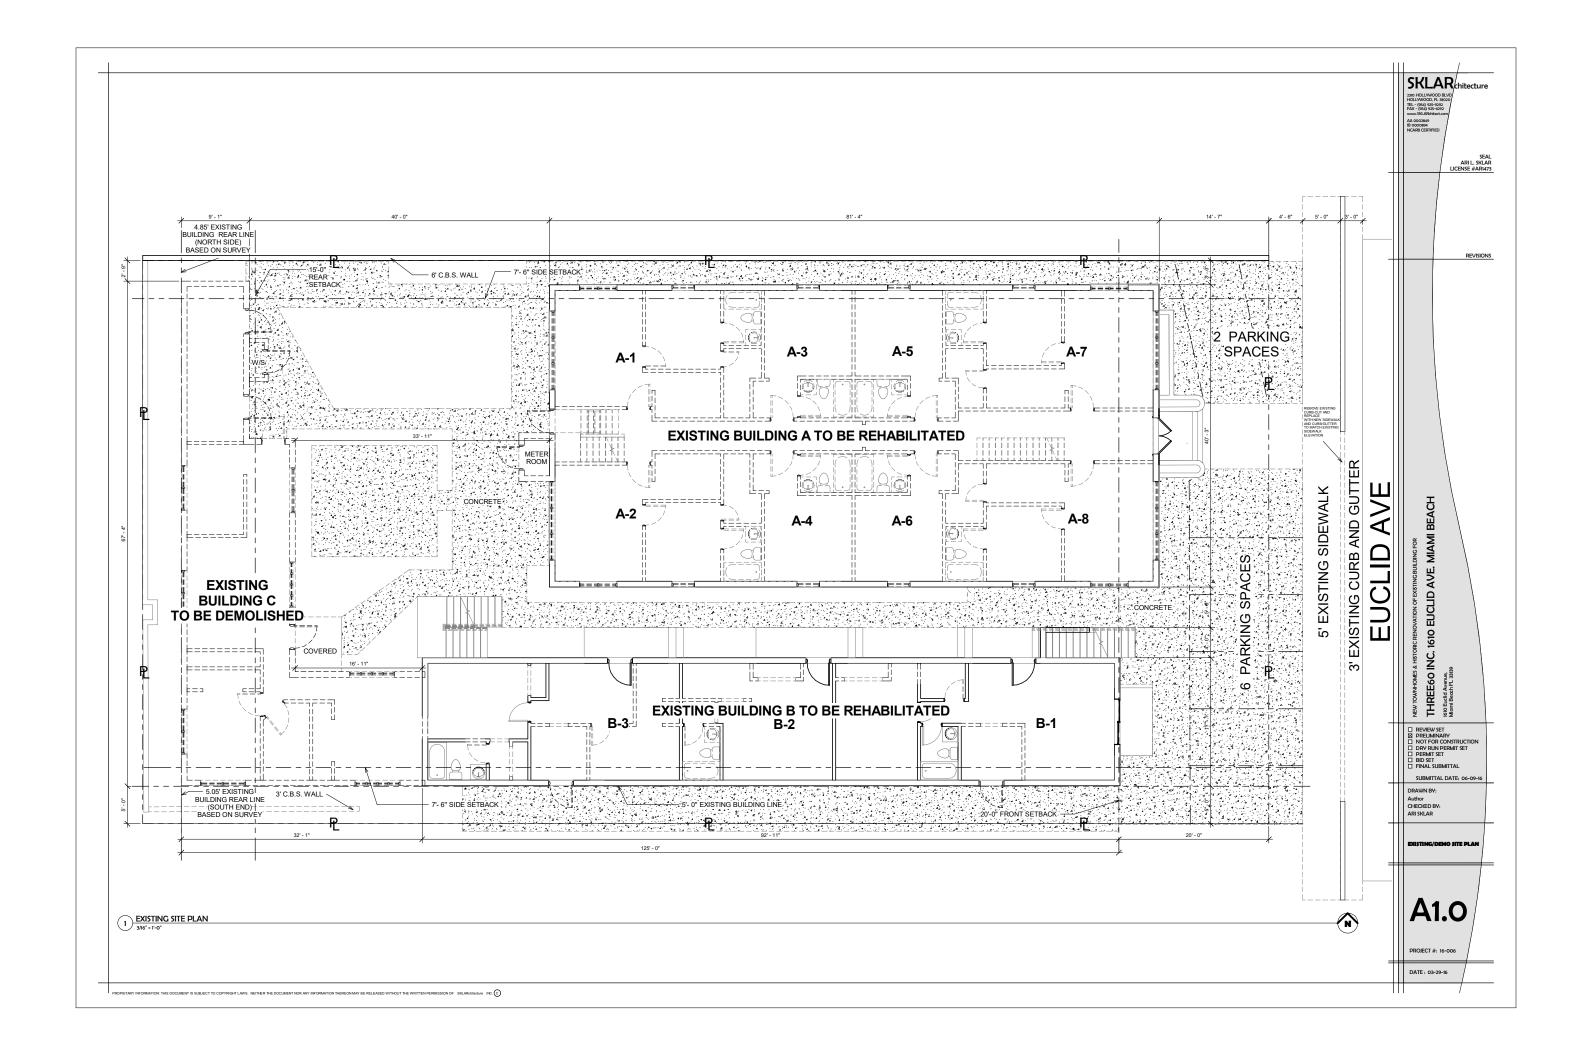BUILDING B EAST (FRONT)

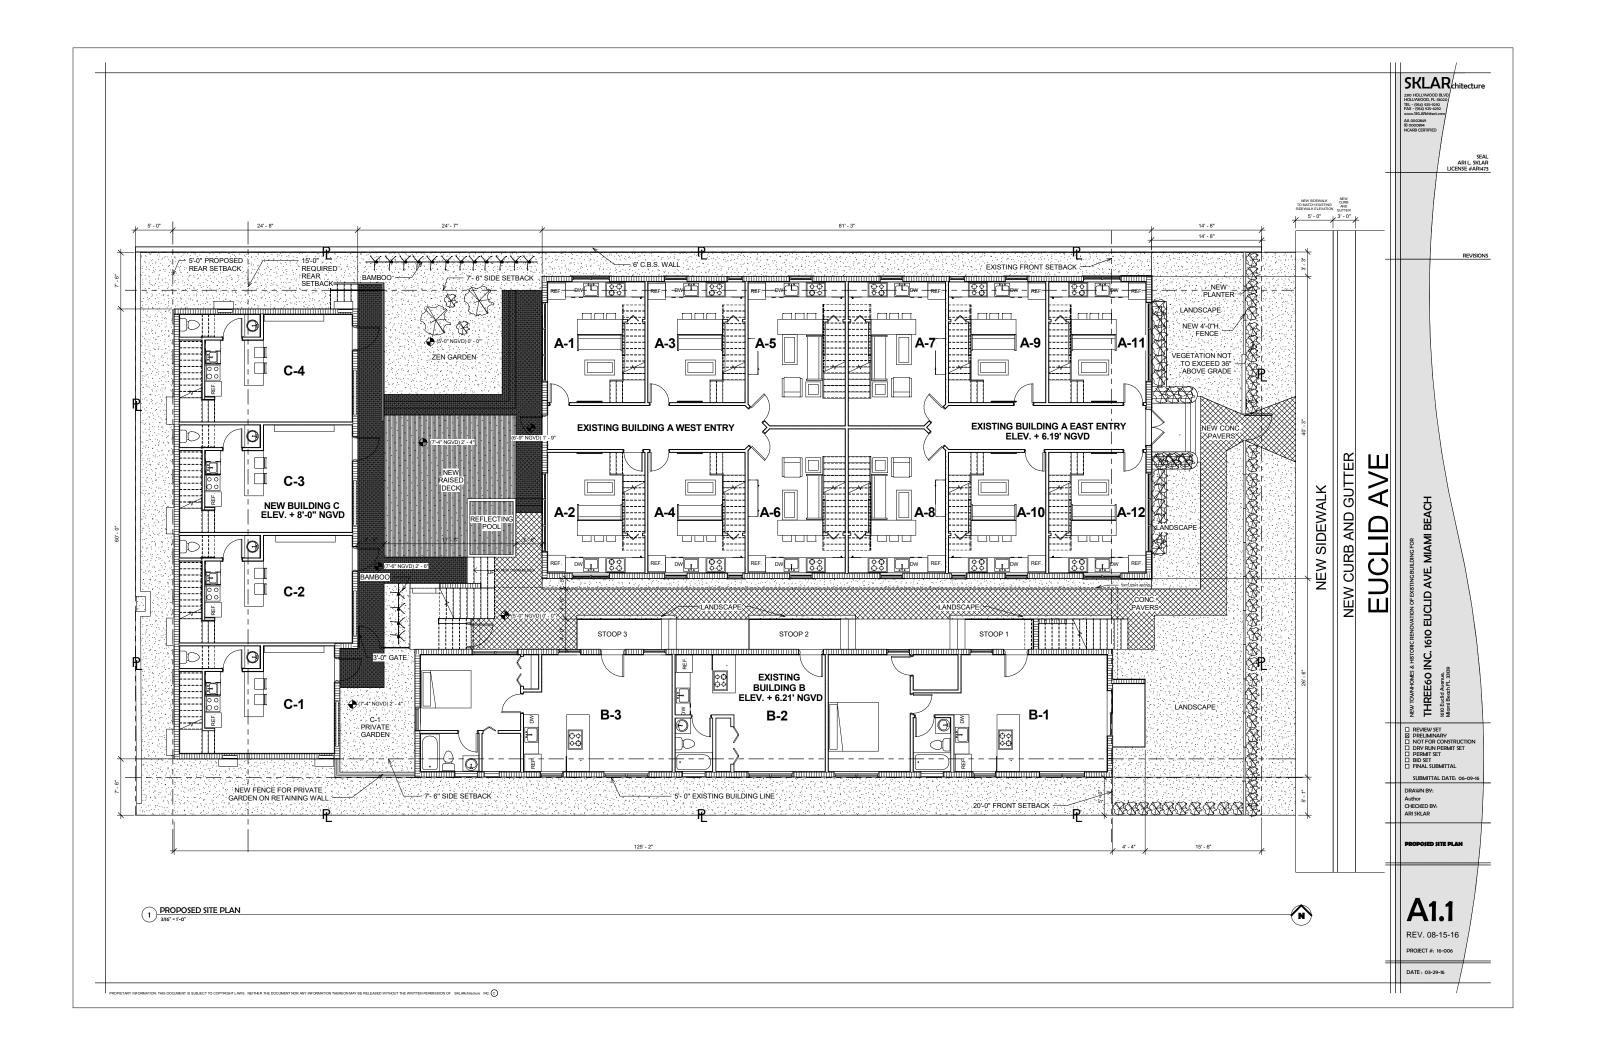

BUILDING B SOUTH EAST (FRONT)

BUILDING A EAST (FRONT)



BUILDING A NORTH EAST (FRONT)


	SKLAR chitecture
	2310 HOLLYWOOD BLUD HOLLYWOOD, FL 30020 TEL - (954) 925-9292 FAX - (954) 925-9292 www.SLARhitect.com AA 0002849
	AA 0002849 IB 0000894 NCARB CERTIFIED
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	REVISIONS
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1	SUBMITTAL DATE: 06-09-16
	DRAWN BY: Author CHECKED BY:
+	ARI SKLAR
	EXISTING BUILDING FRONT IMAGES
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	A0.7
	PROJECT #: 16-006
+	DATE: 03-29-16



BUILDING A EAST (FRONT)



BUILDING A WEST (REAR)

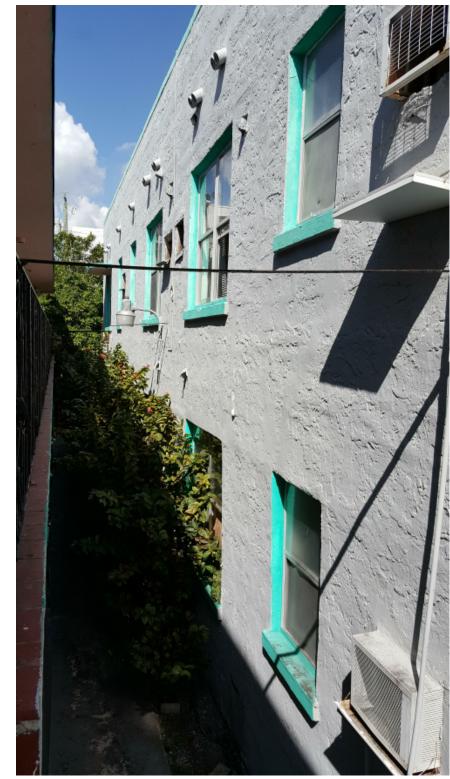

BUILDING A SOUTH (SIDE)

SKLAR **Ao.8**



BUILDING B EAST (FRONT)




BUILDING B SOUTH (SIDE)

	SKLAR Chitecture 230 HOLLWOOD BLVD HOLLWOOD BLVD HOLLWOOD BLVD ELE. (964) 925-928 300 WWW.SMARHISEC.com AA OCCUSABY BL OCCUSABY NOARB CERTIFIED
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	DRAWN BV: Author CHECKED BV: ARI SKLAR
	EXISTING BUILDING B
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#	PROJECT #: 16-006
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BUILDING C SOUTH EAST (FRONT)



BUILDING C COURTYARD

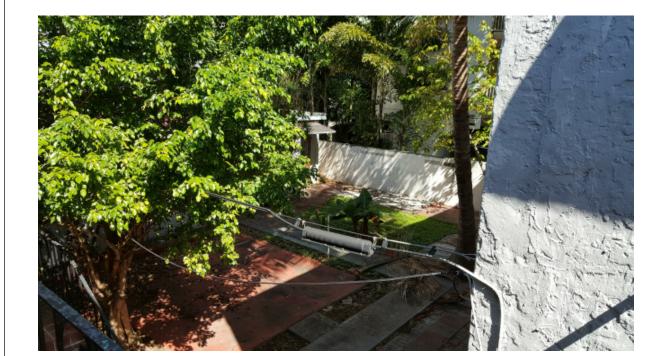


BUILDING C NORTH EAST (FRONT)



BUILDING C NORTH EAST (FRONT)

	H
	SKLAR chitecture
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	REVISIONS
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de	NEW TOWNSHOMES & HISTORIC RENOWATON OF EXISTING BULLING FOR THREEGO INC. 1610 EUCLID AVE. MIAMI BEACH Manni Beach FL 33399 Manni Beach FL 33399
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	INC.
	NEW TOWNHONES & THREE60 II 1610 Ekield Avenue, Morni Beach F. 3399
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1	DRAWN BY: Author CHECKED BY:
-	CHECKED BY: ARI SKLAR
	EXISTING BUILDING C IMAGES
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	PROJECT #: 16-006

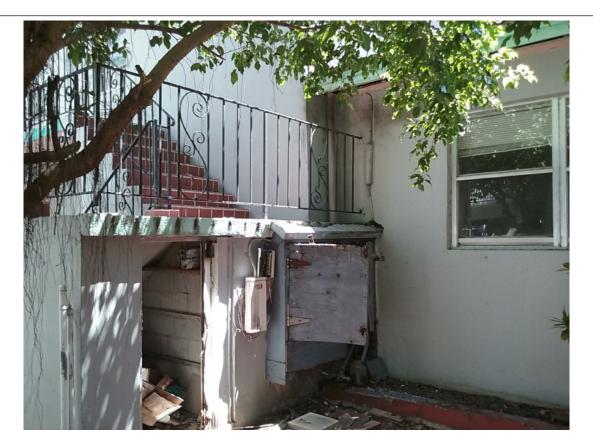


EXISTING CONNECTION BETWEEN BUILDINGS B AND C




BUILDING C INTERIOR VIEW



BUILDING C ENTRY PORCH

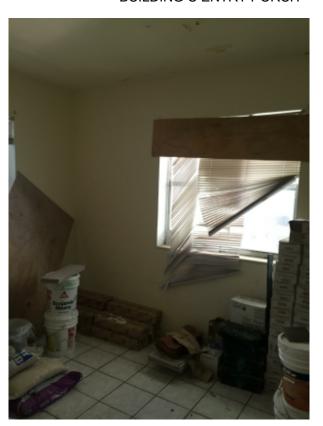

BUILDING C INTERIOR VIEW

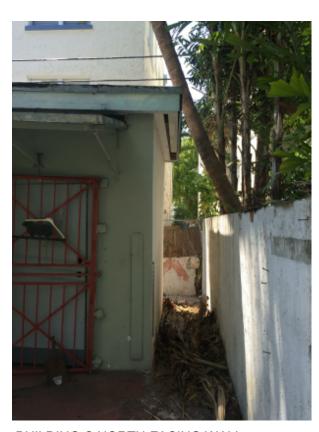


BUILDING C NORTH-FACING WALL (NORTH SIDE)

SKLAR, chitecture 230 HOLLWOOD BLVD HOLLWOOD R. SOND HOLL
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DRAWN BY: Author CHECKED BY: ARI SKLAR
EXISTING BUILDING C
AO.11



BUILDING C INTERIROR

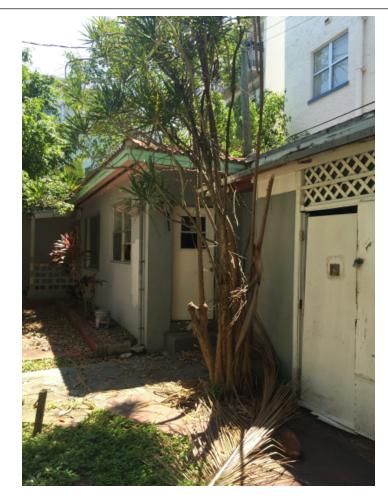

BUILDING C VIEW LOOKING SOUTH





BUILDING C INTERIOR VIEW LOOKING TOWARDS ENTRY



BUILDING C INTERIOR VIEW LOOKING TOWARDS LIVING AREA

NEW TOWNHOMES & HISTORIC RENOVATION OF EXETTING BULLING FOR
THREEGO INC. 1610 EUCLID AVE. MIAMI BEACH
MOTH BEACH ALIENDE
MOTH BEACH I 31399 A0.12 DATE: 03-29-16

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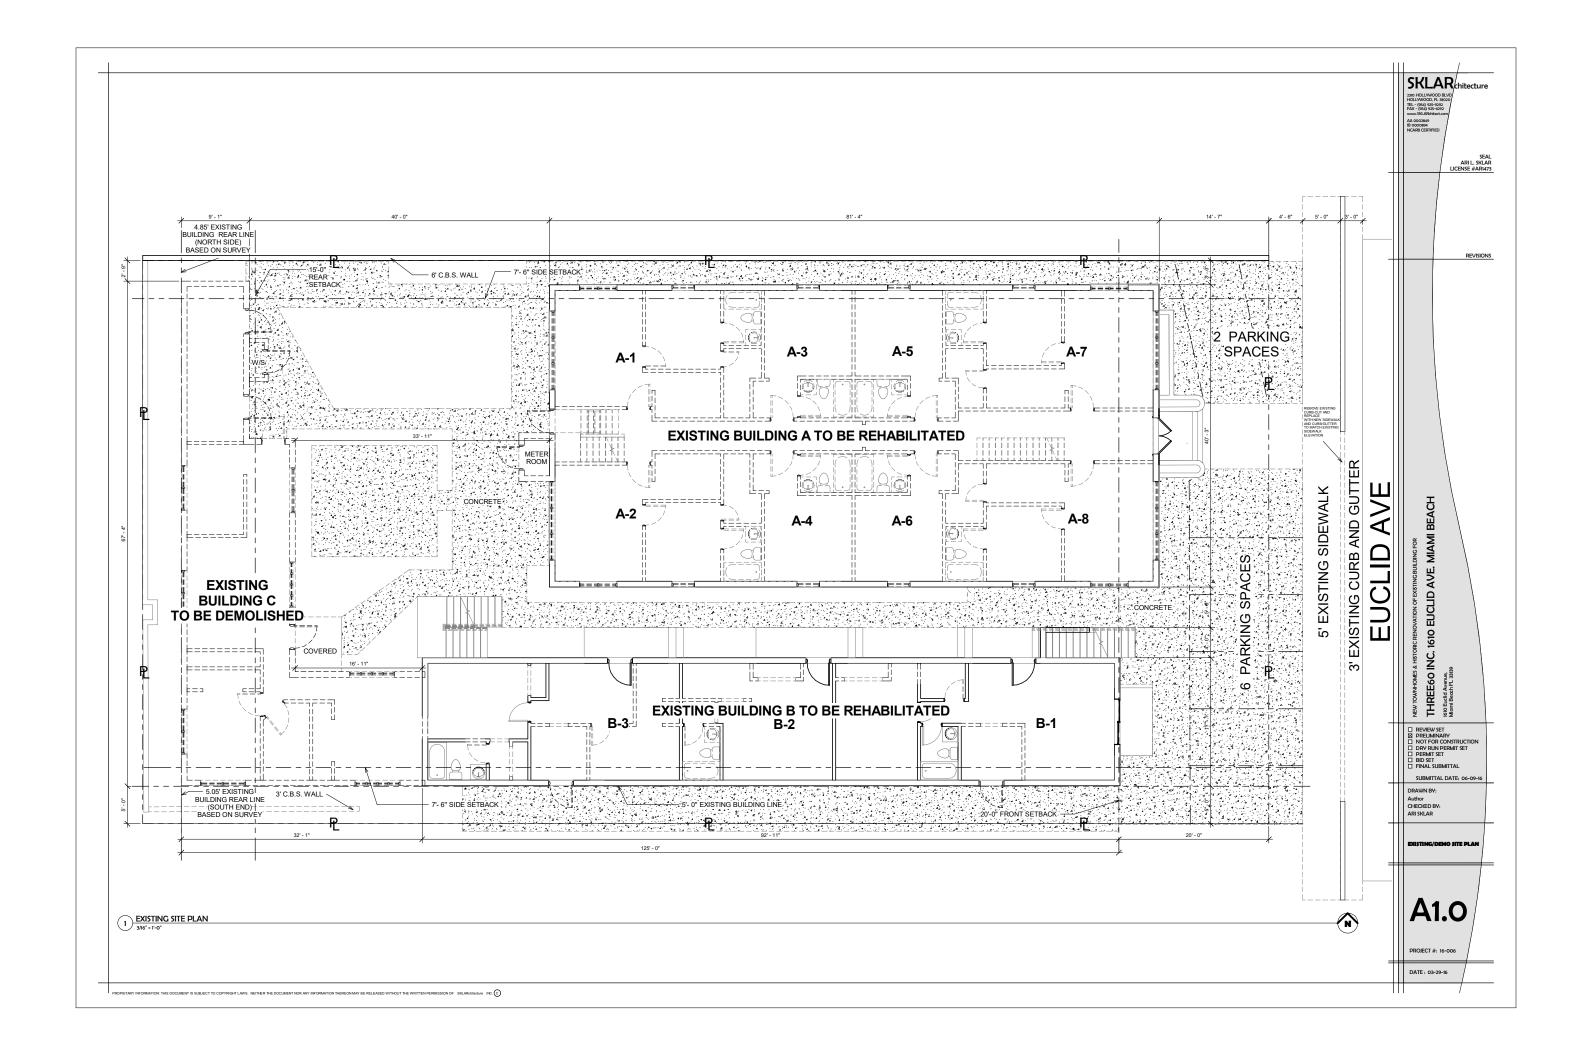



CONTEXTUAL SKETCH. MAIN FACADE. FROM LEFT TO RIGHT: BUILDINGS B AND A


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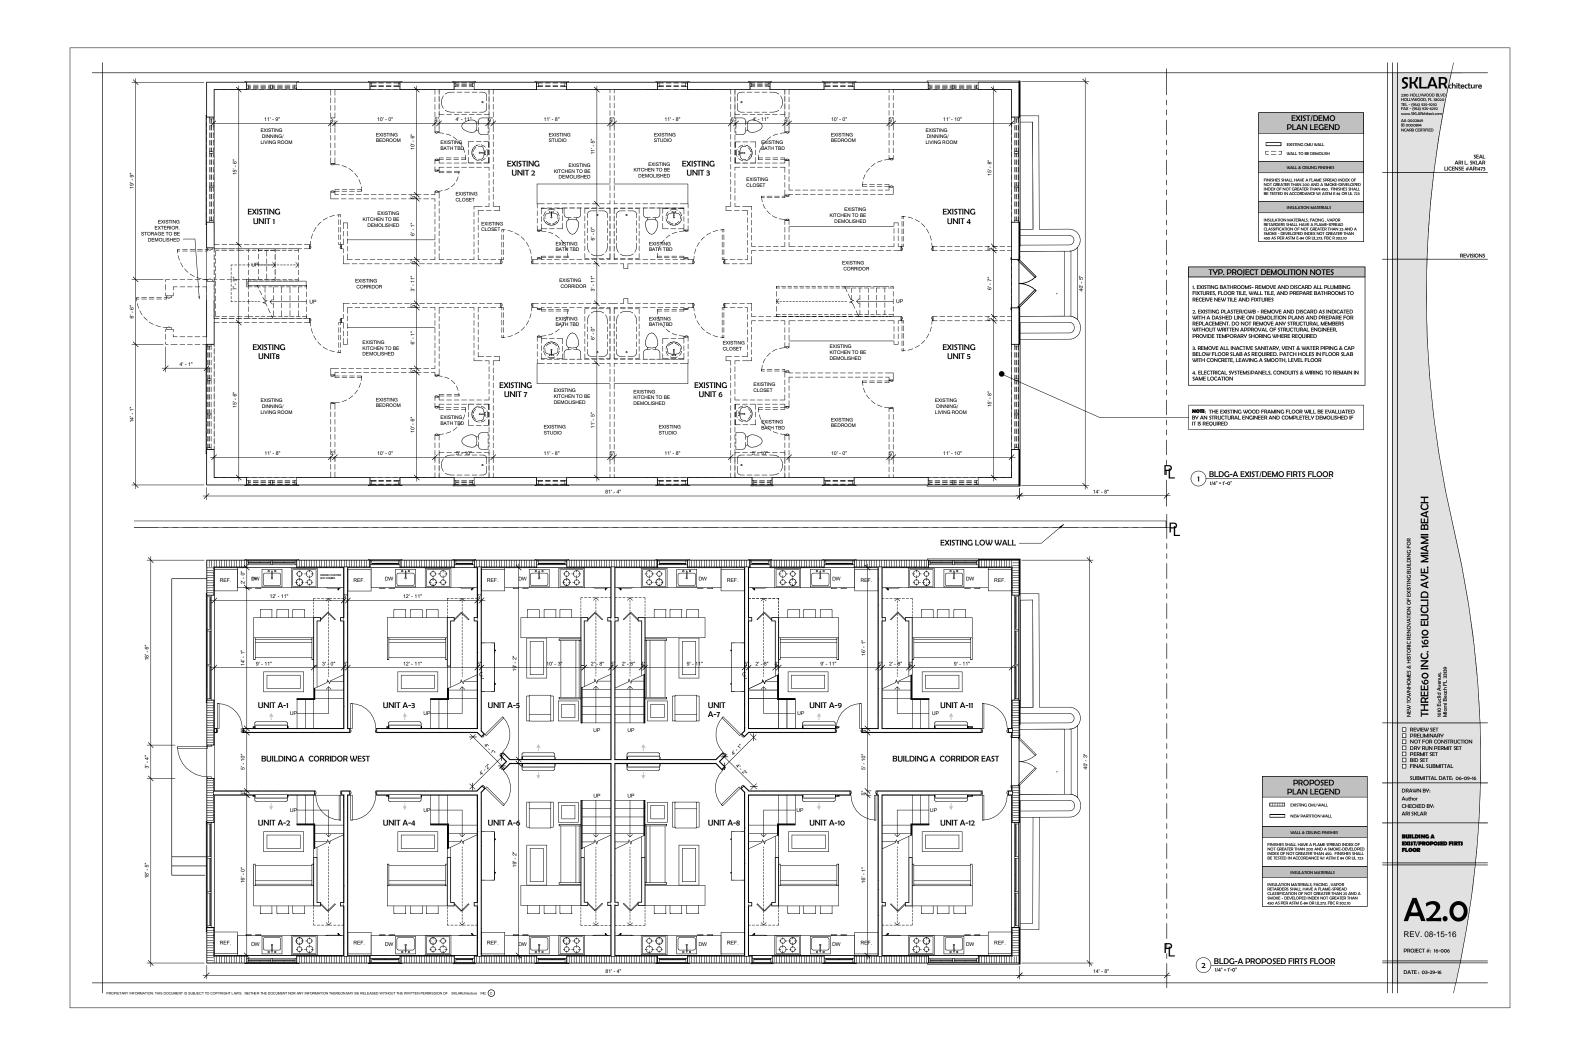
SKLAR NEW TOWNHOMES & HISTORIC RENOVATION OF EXETTING BUILDING FOR
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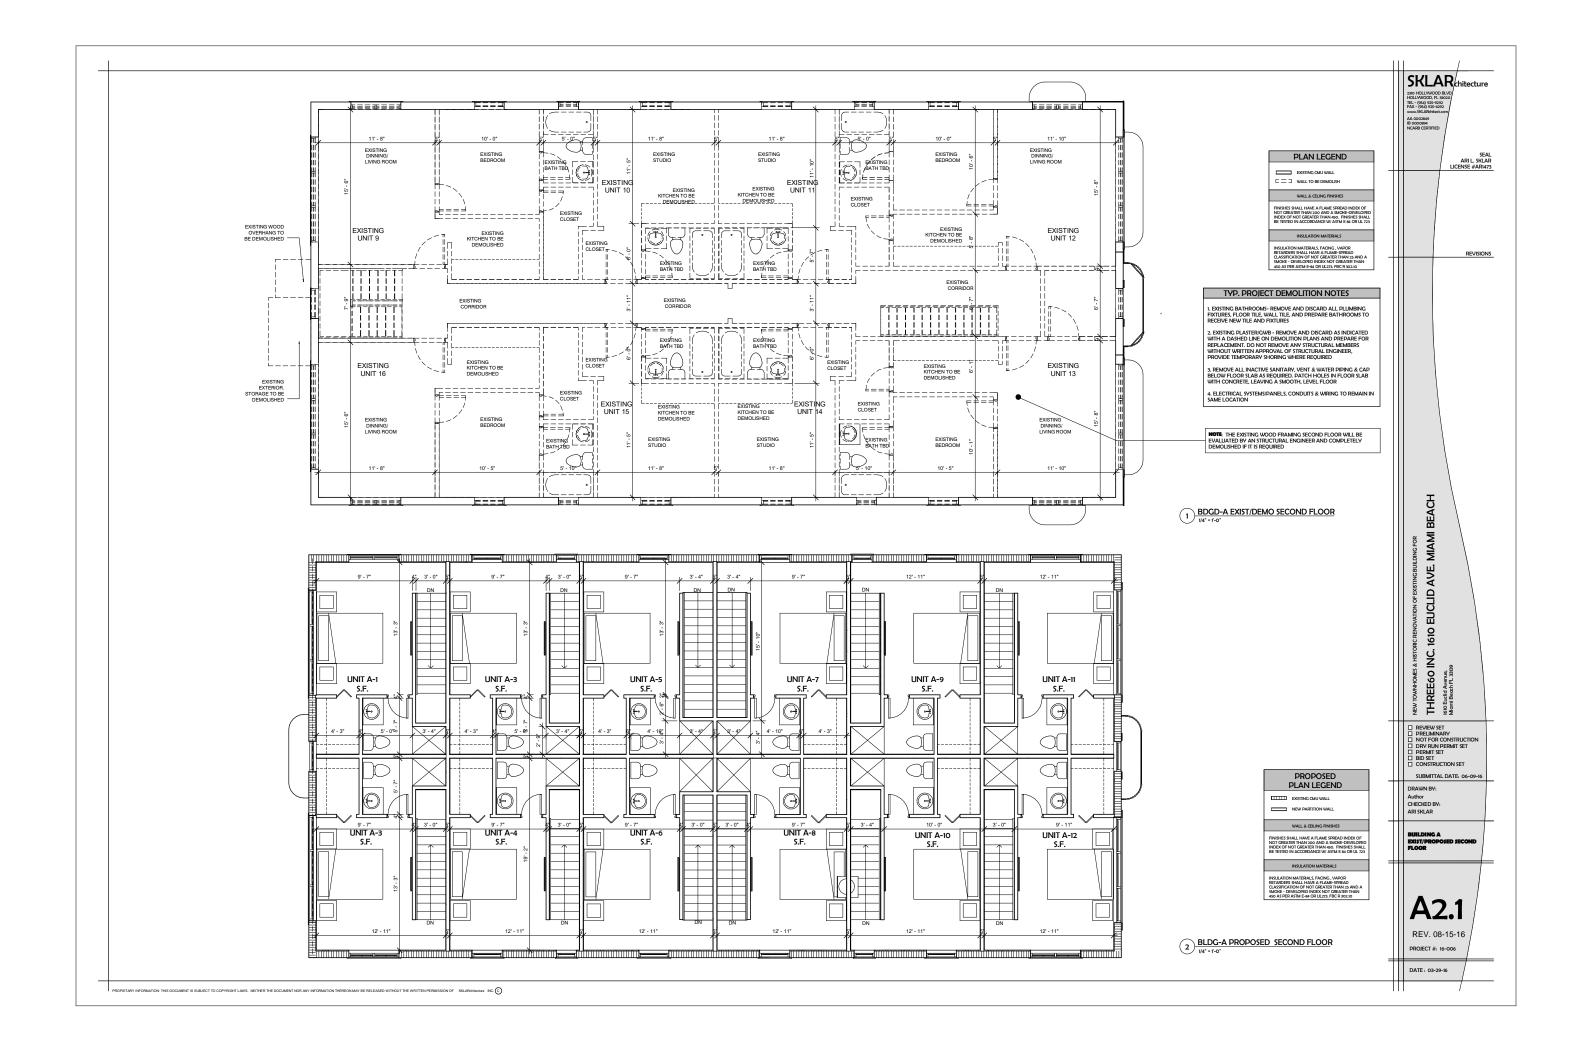











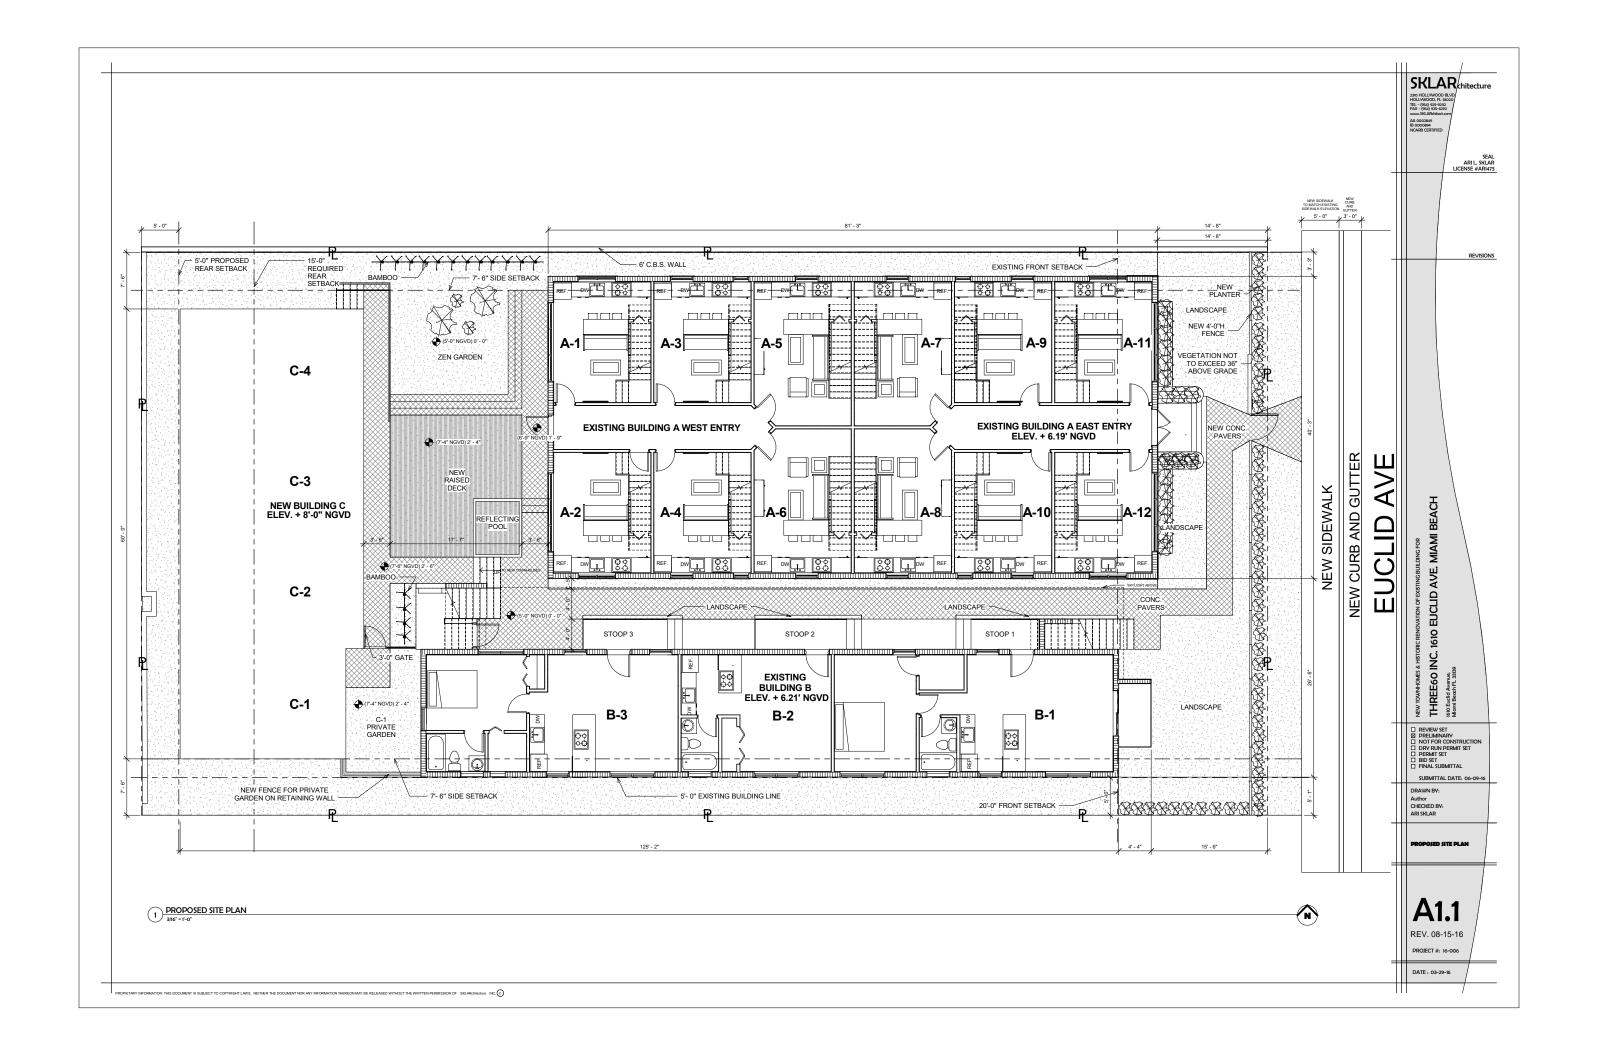


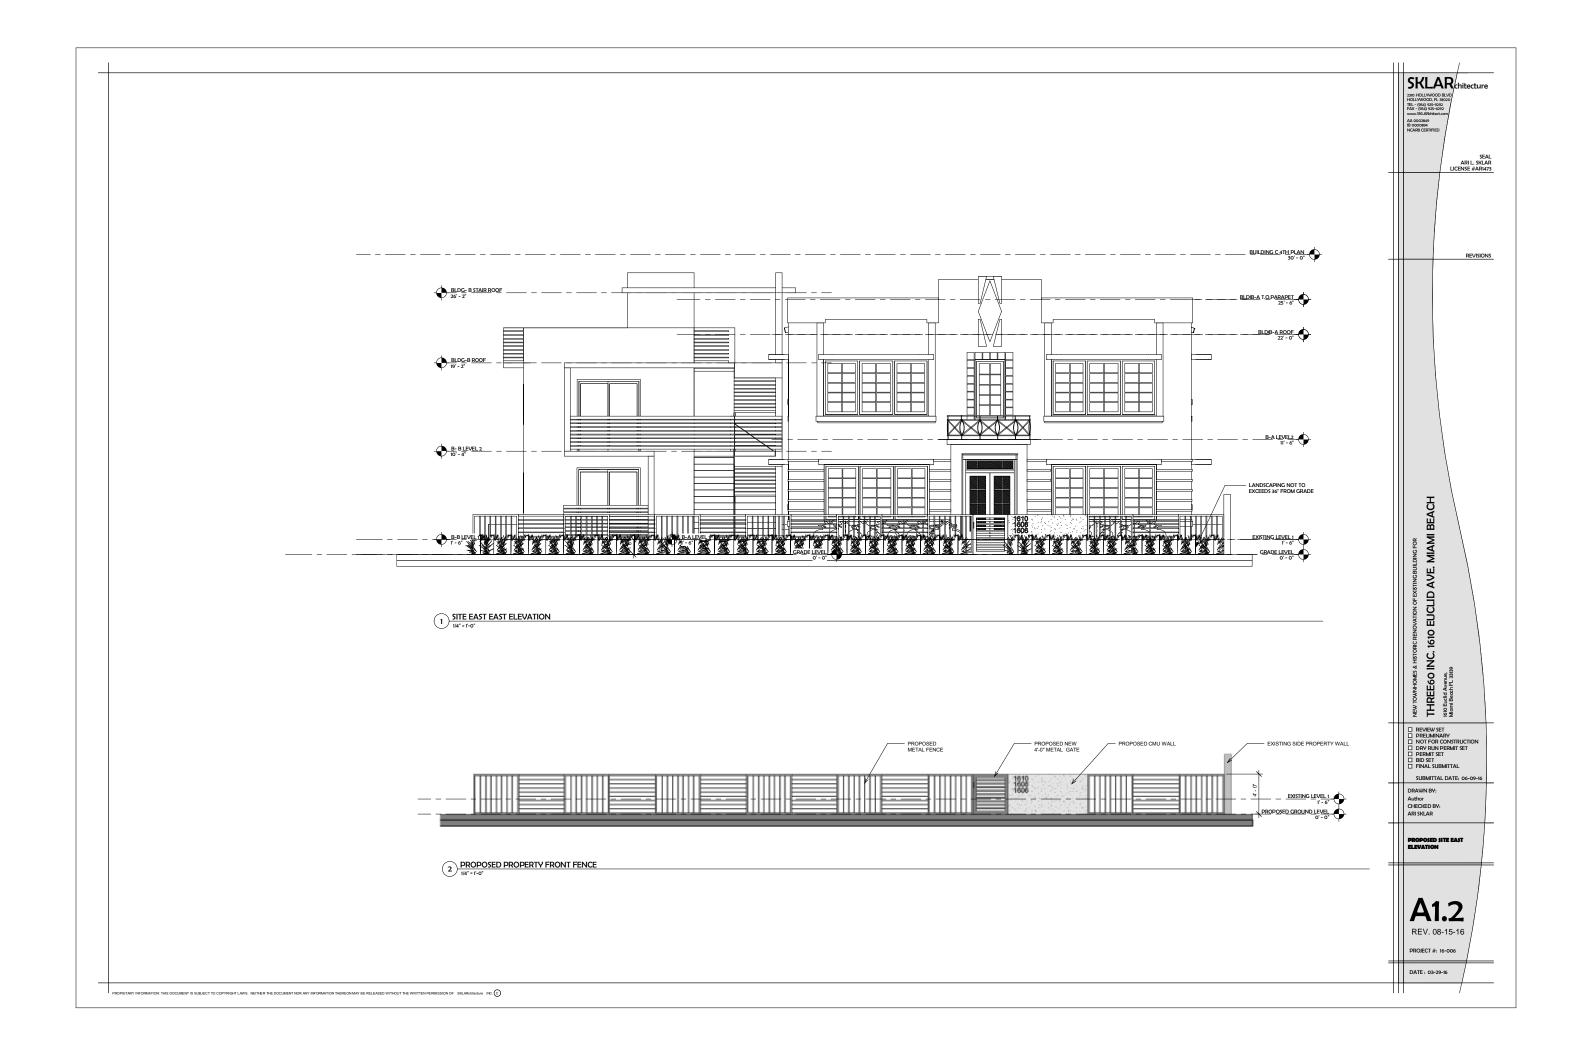


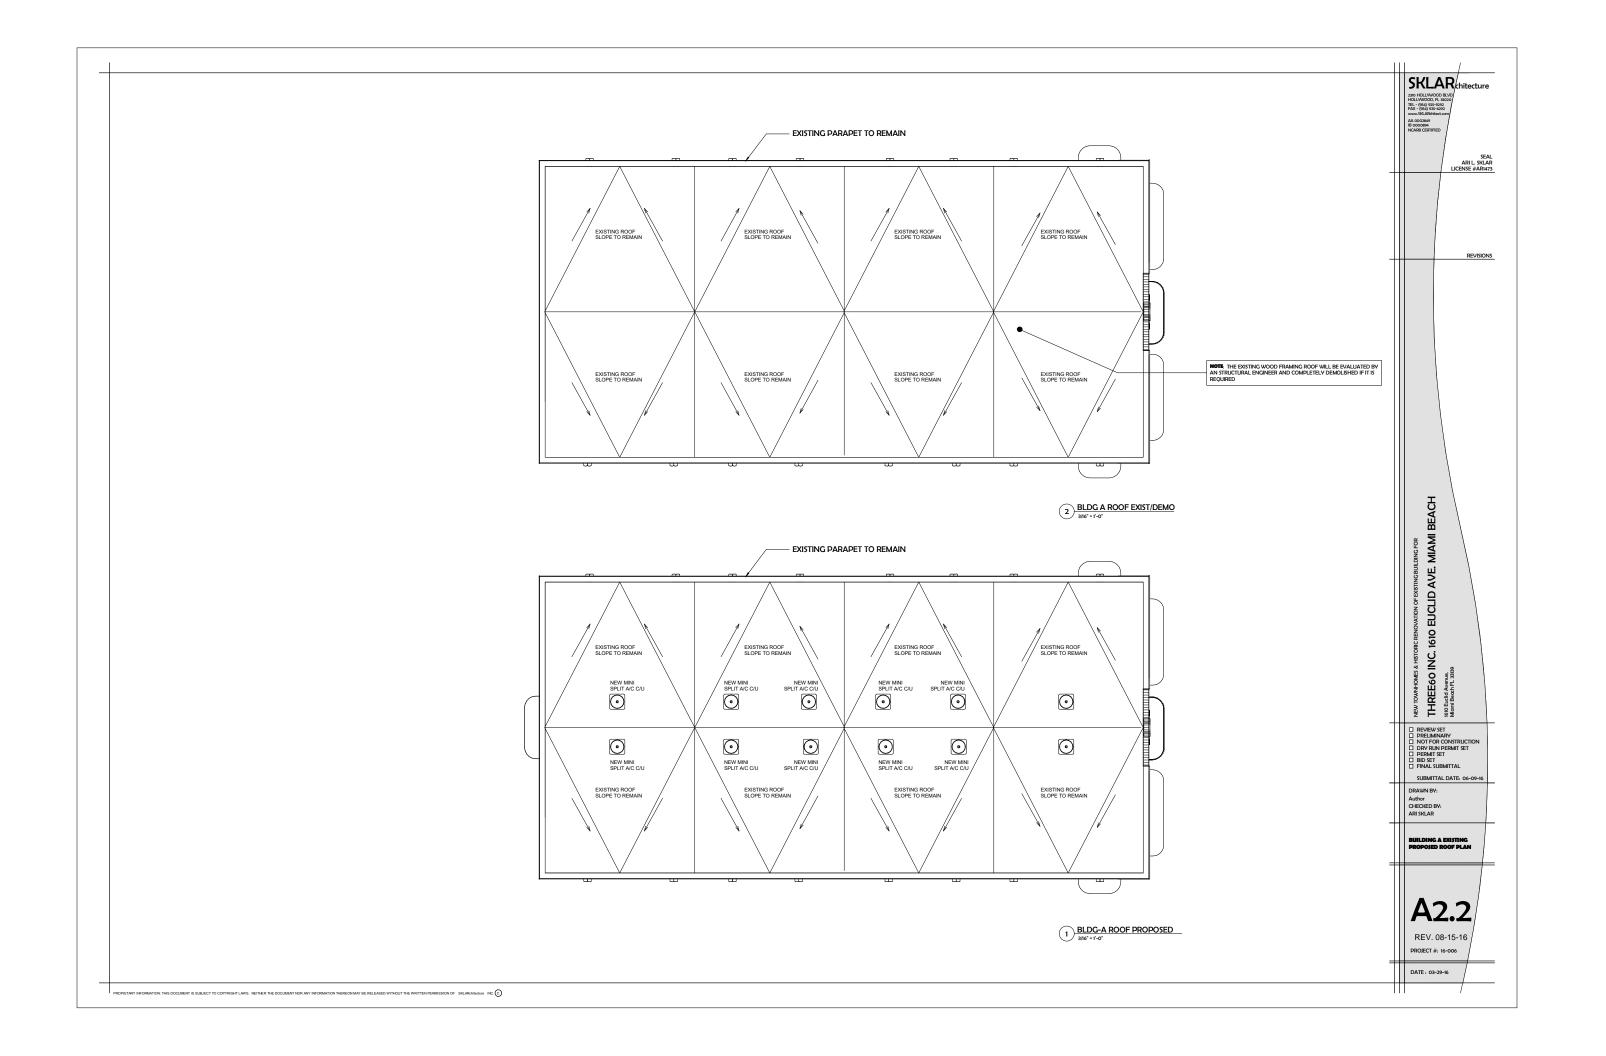


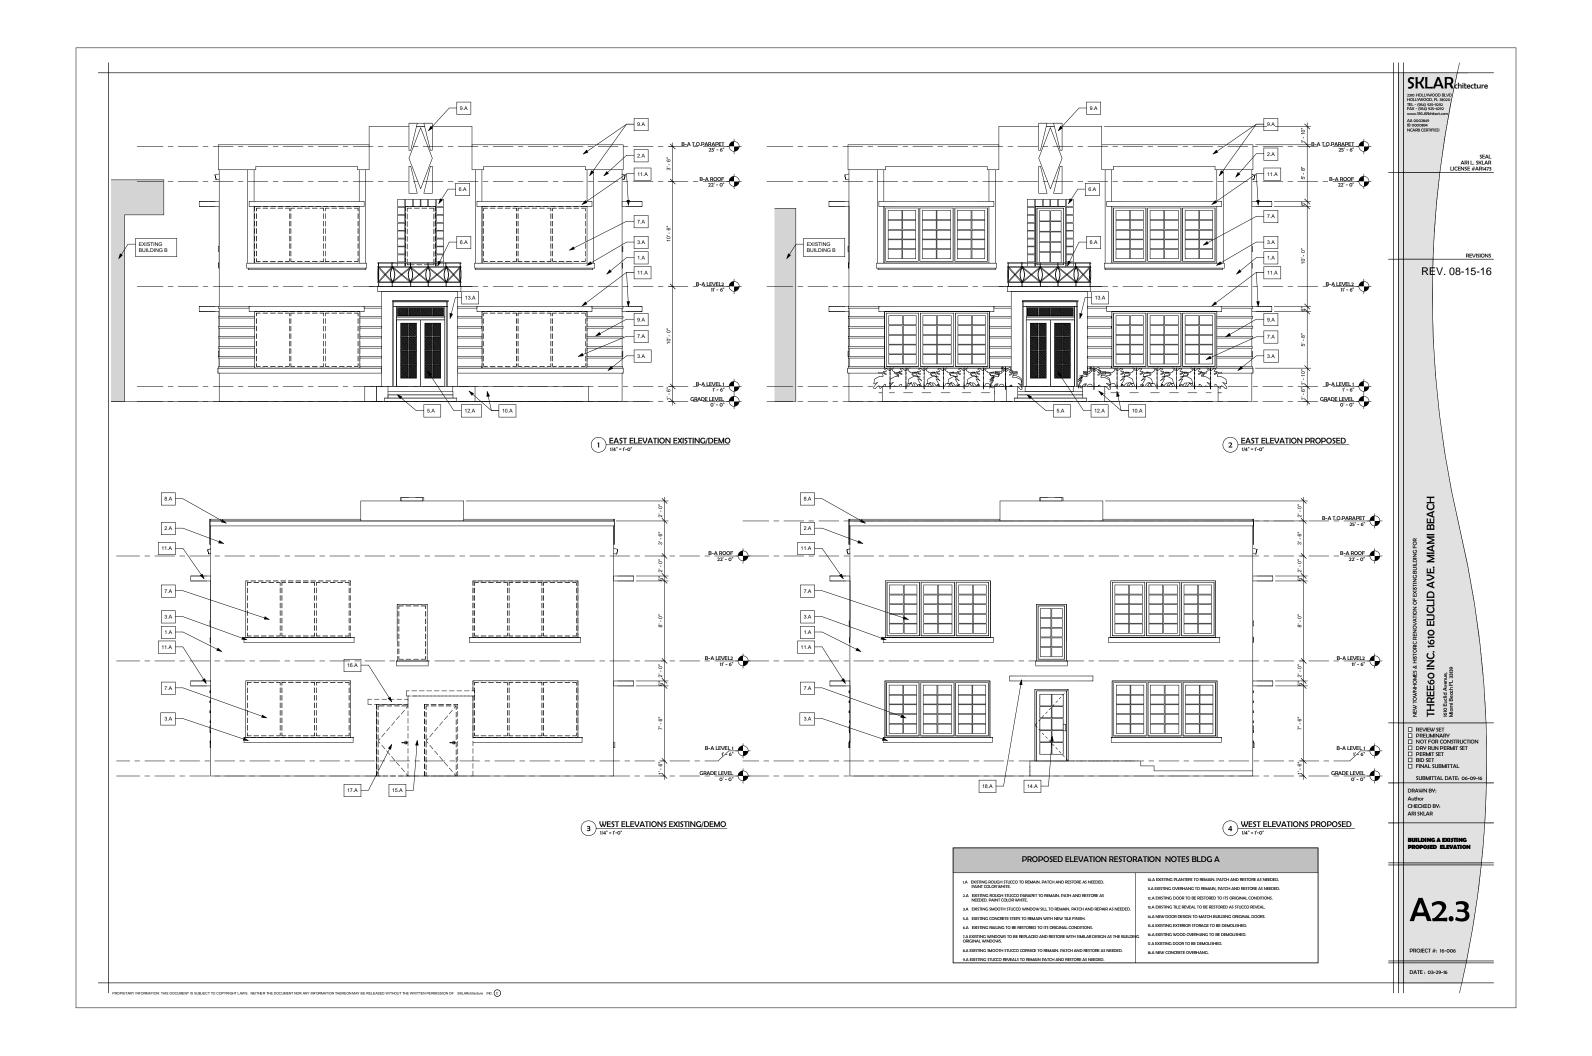


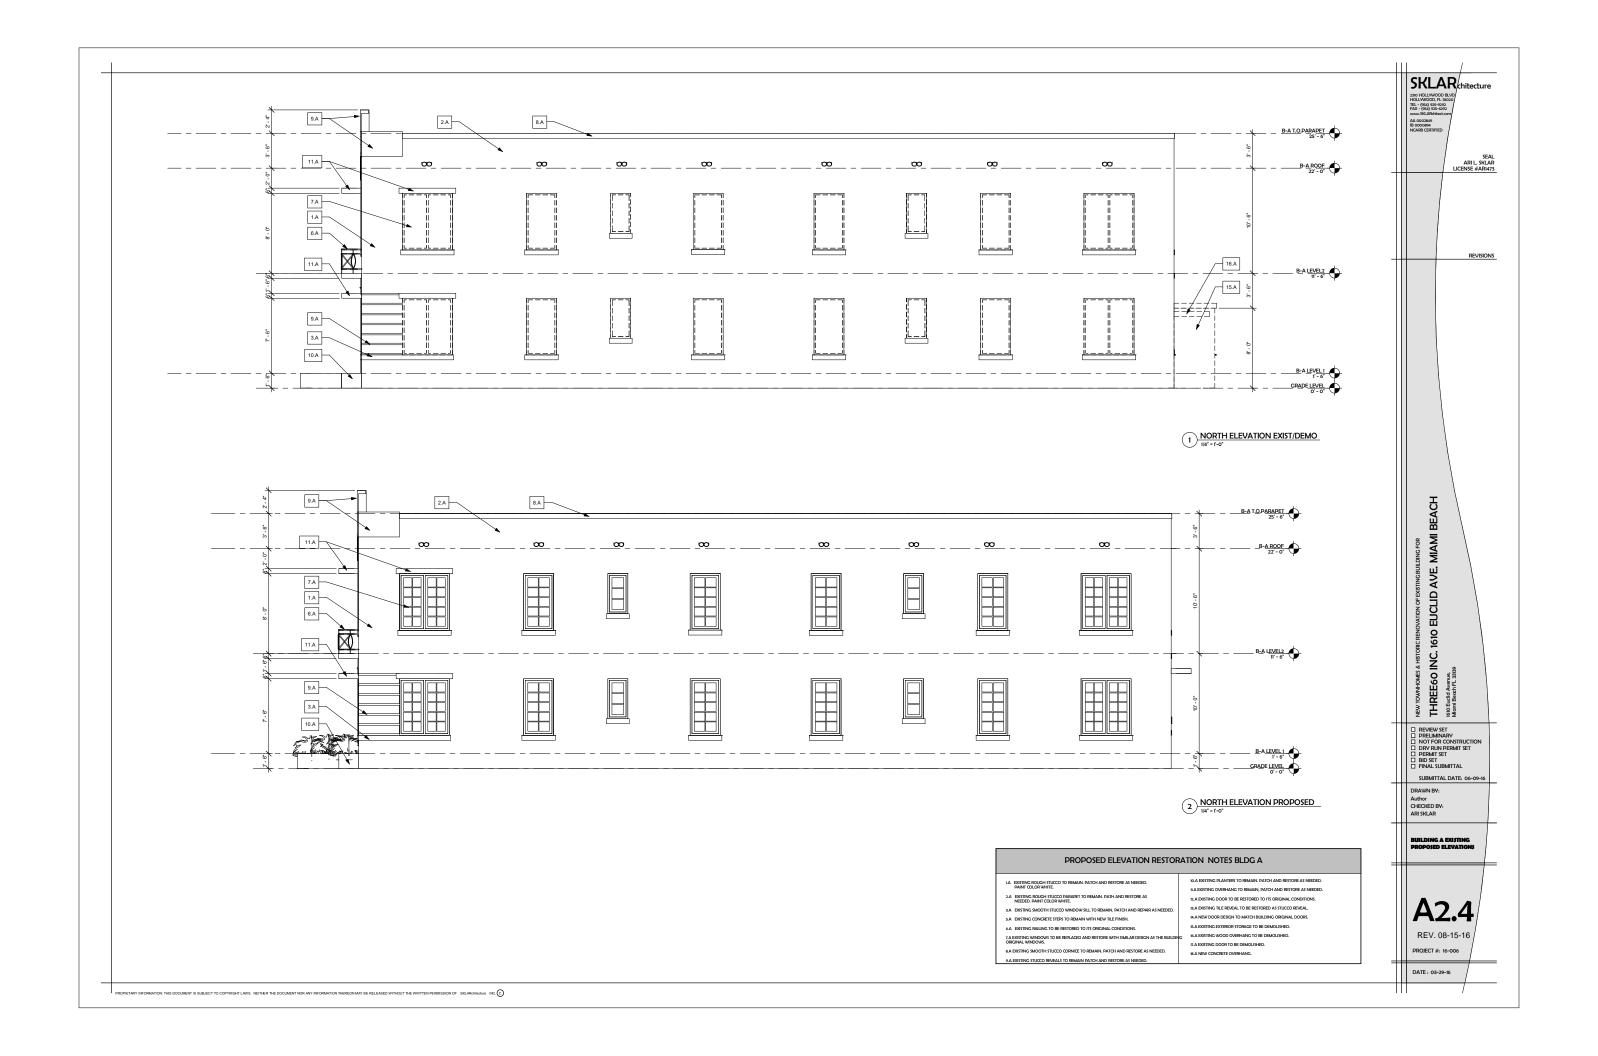


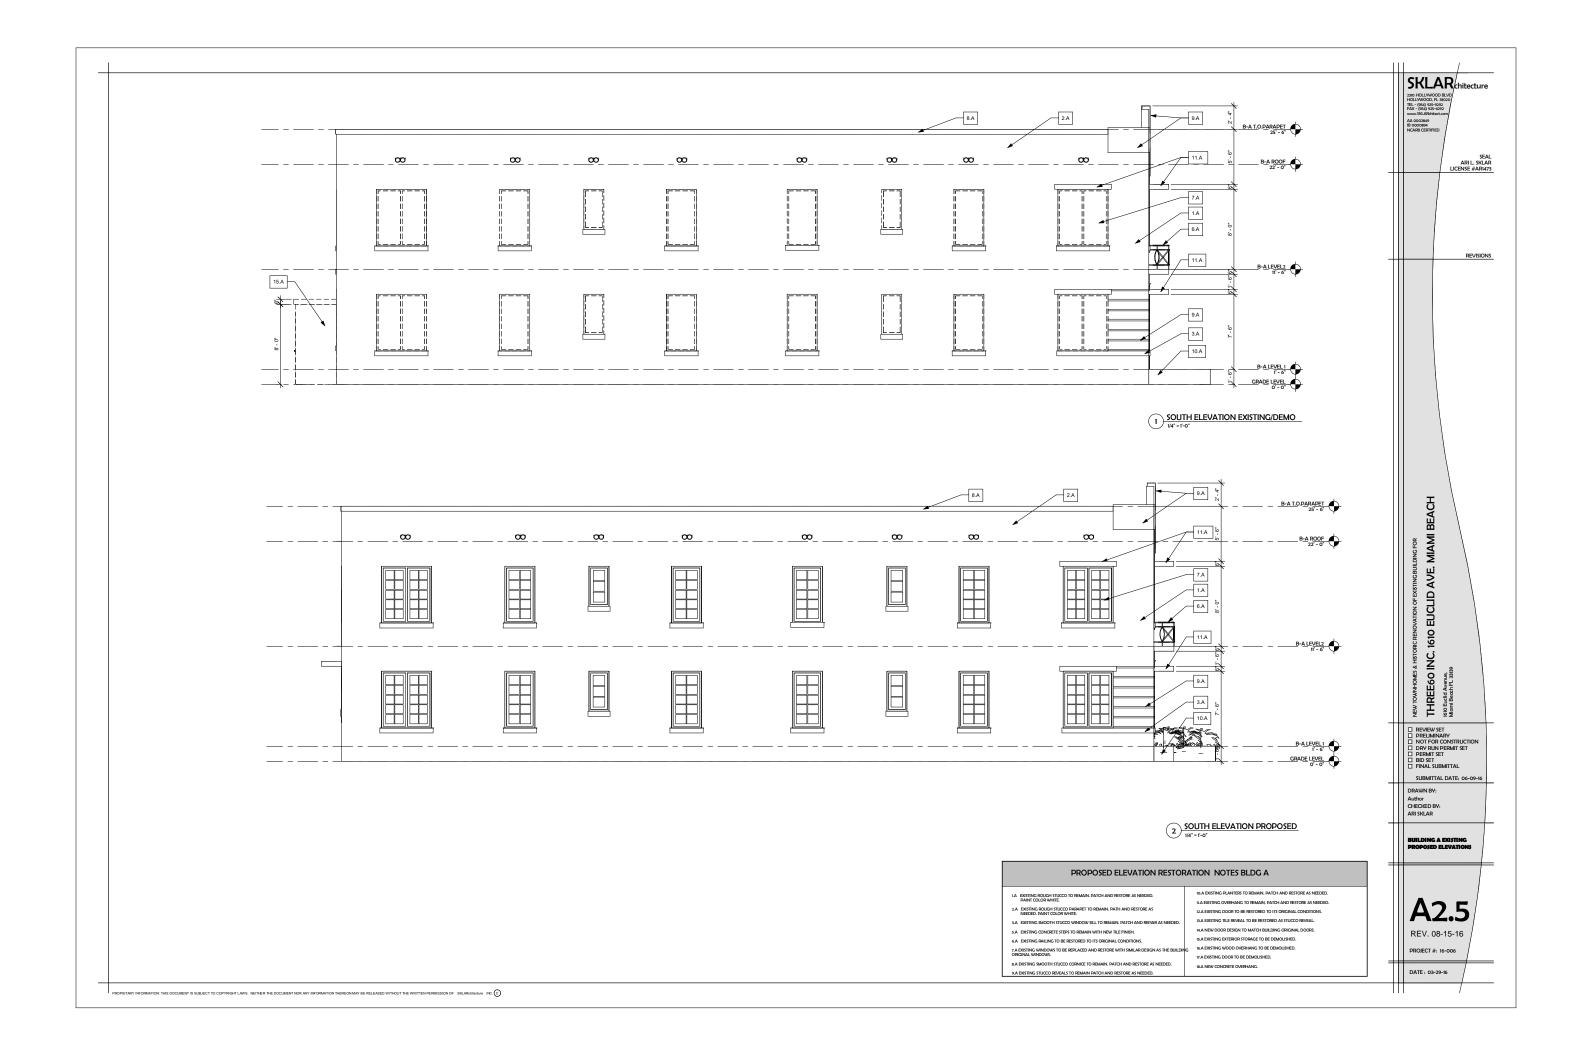

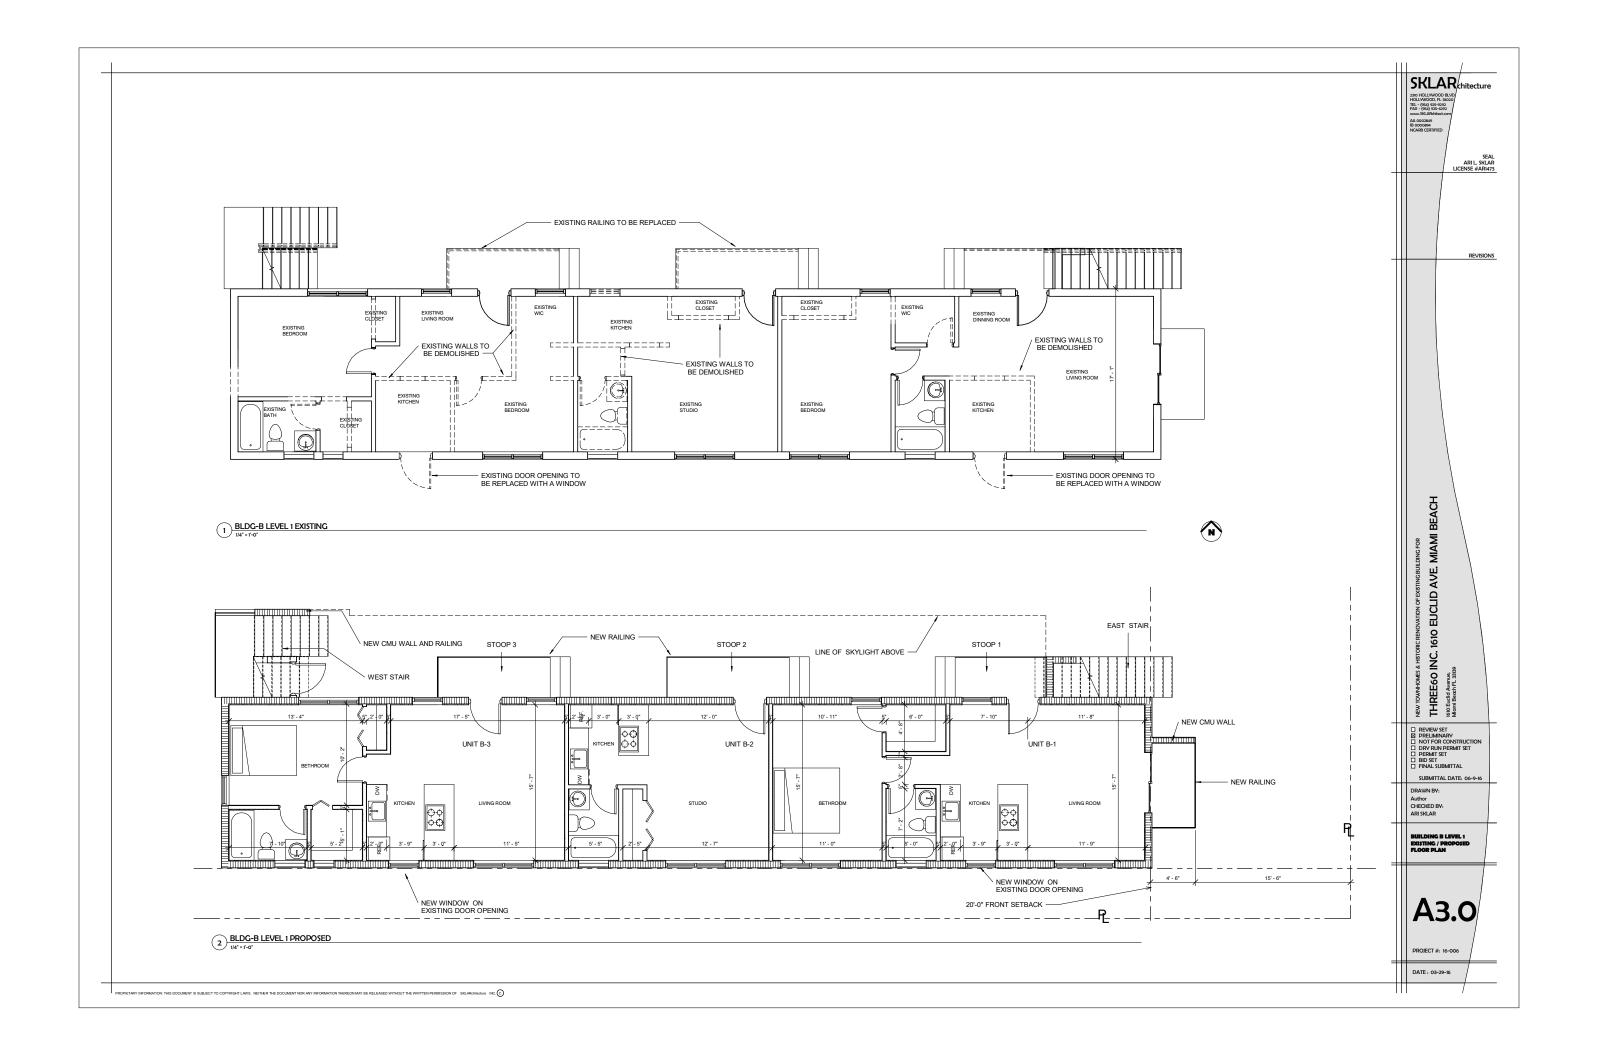

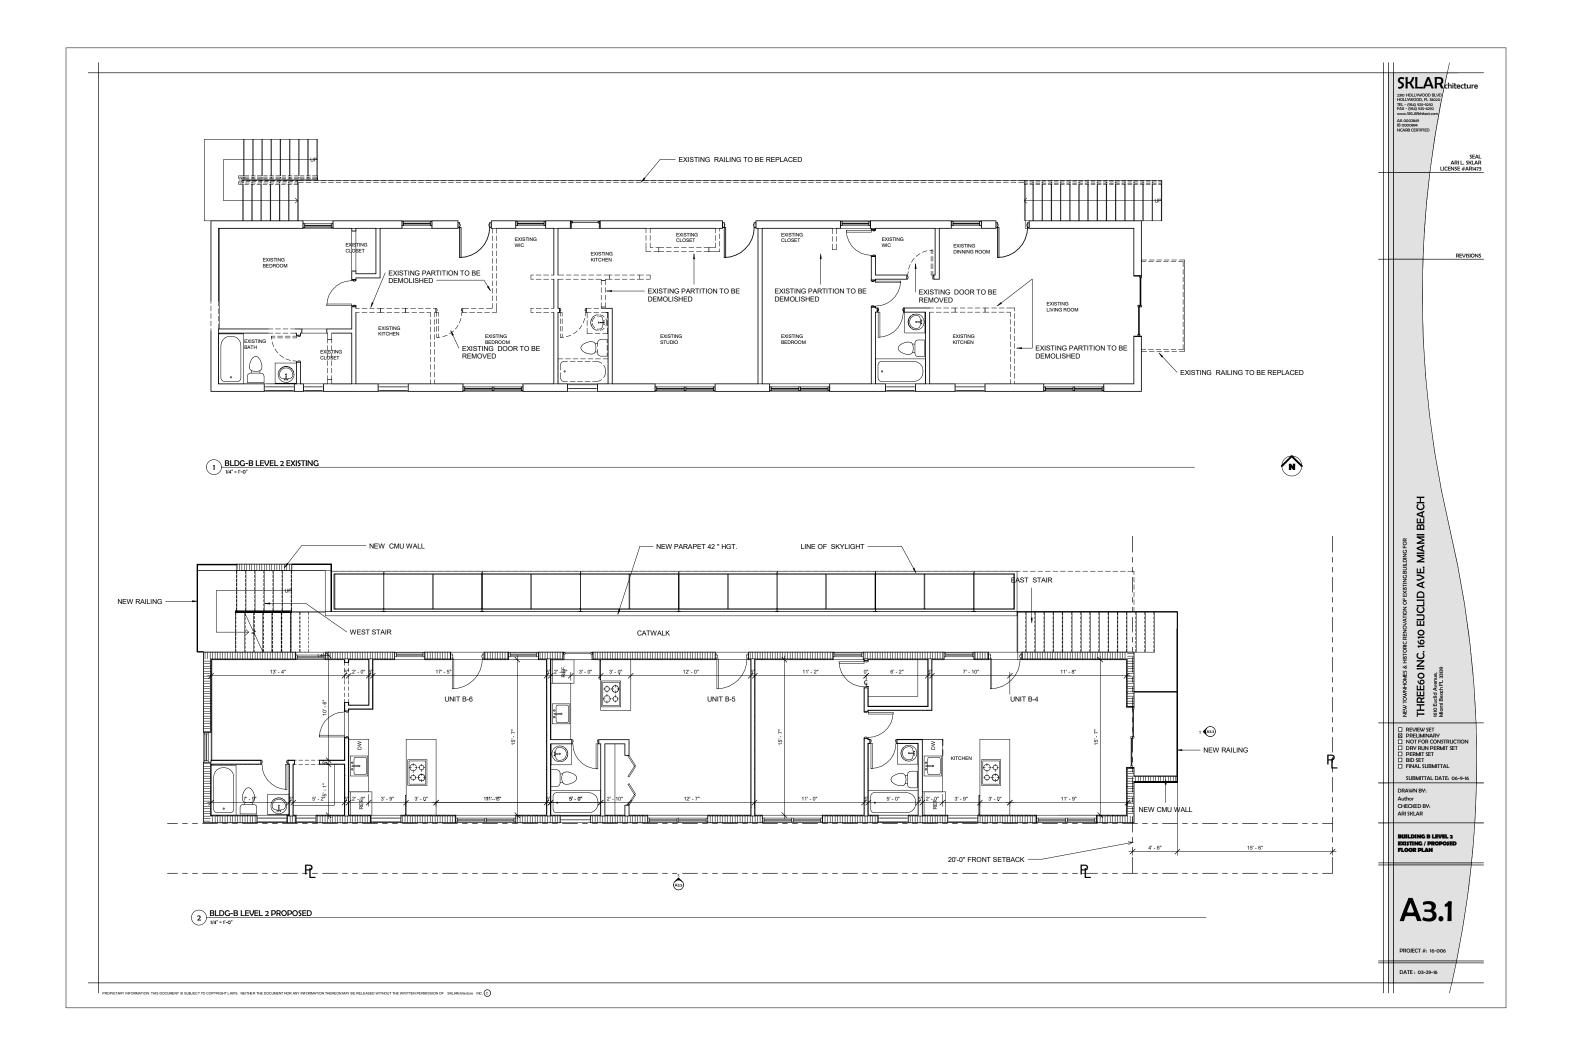


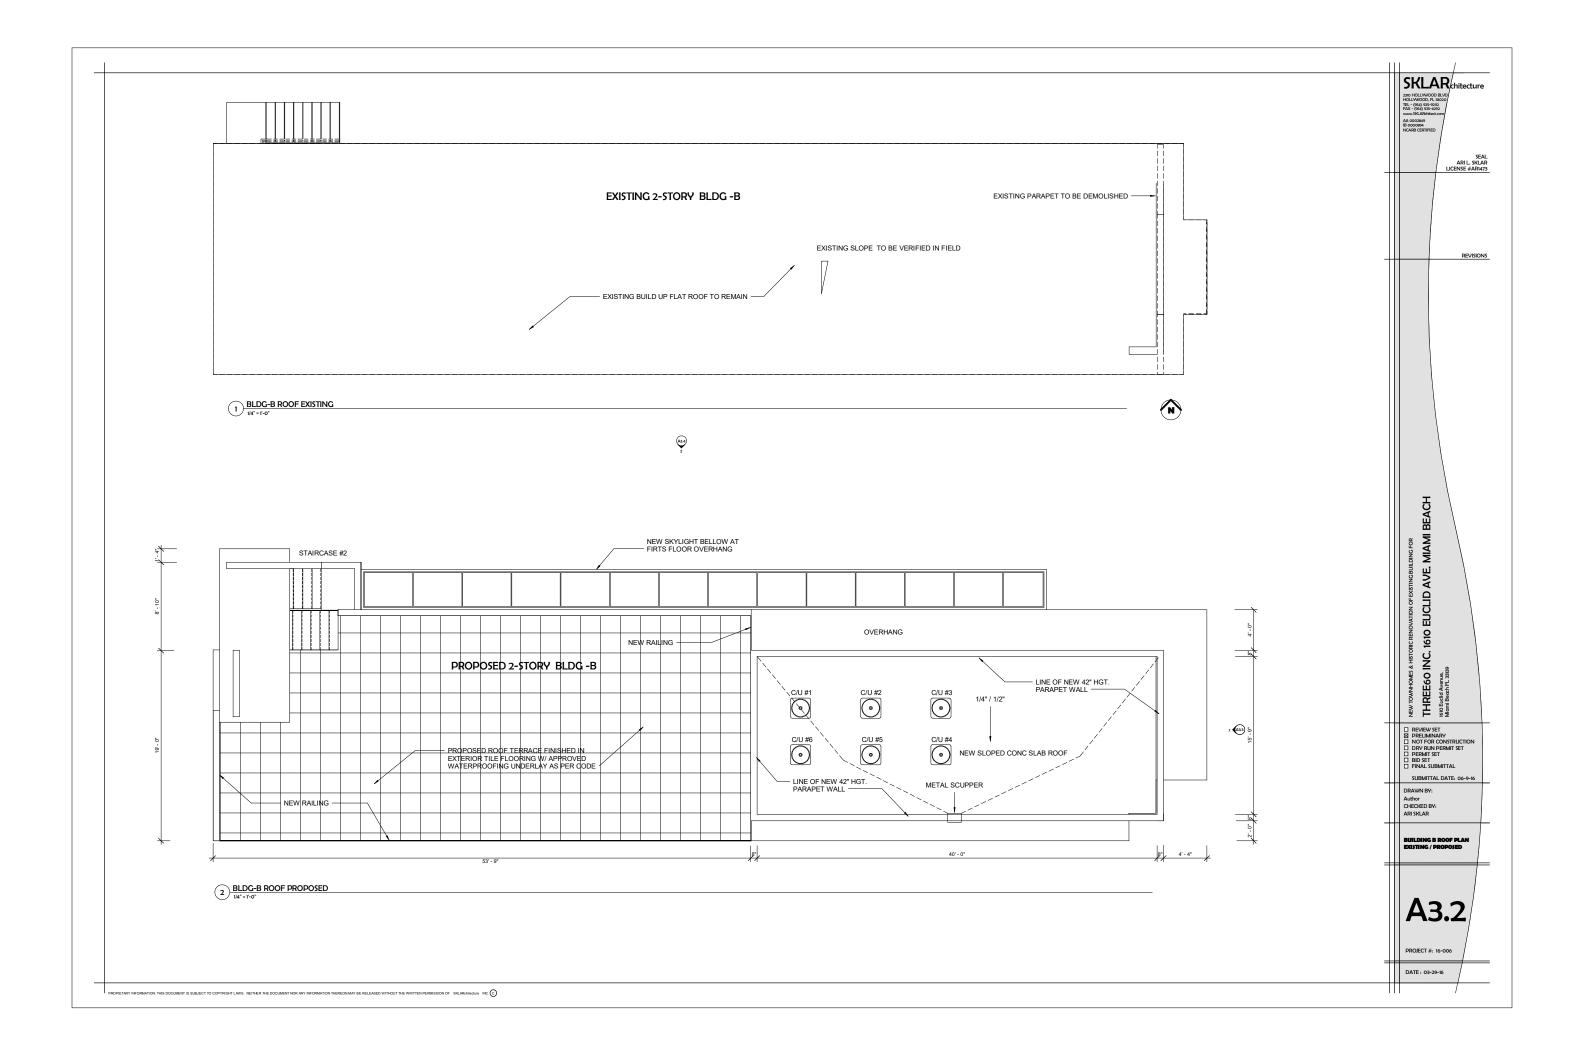


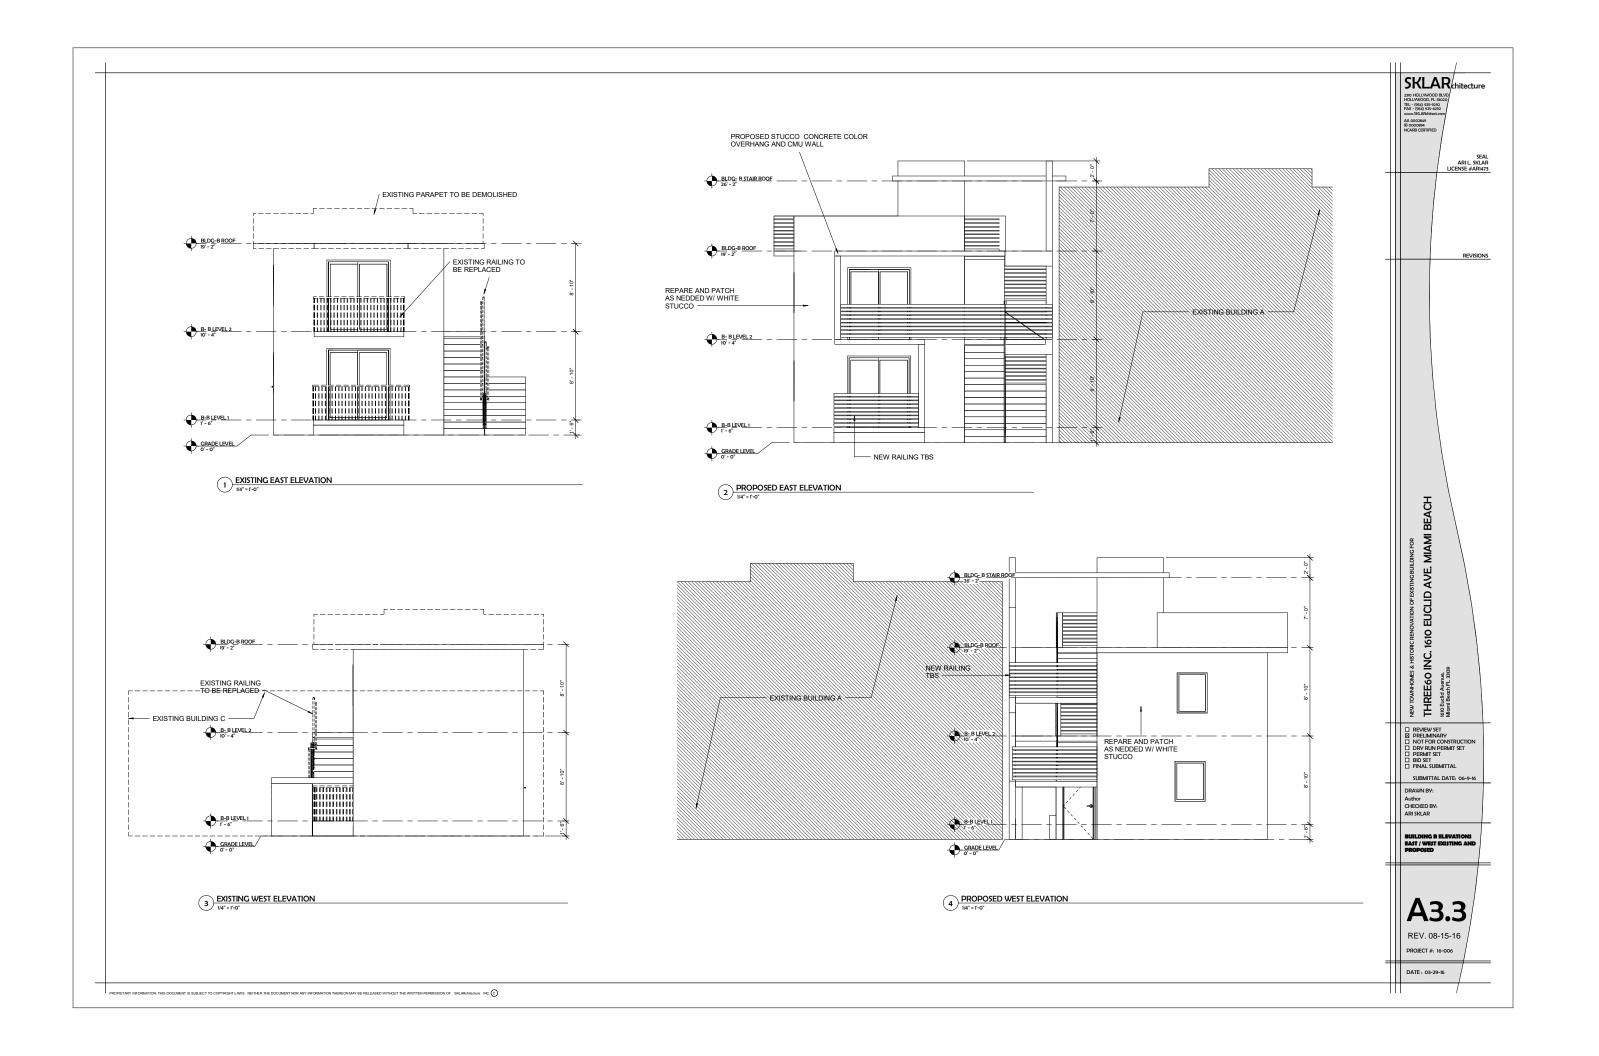








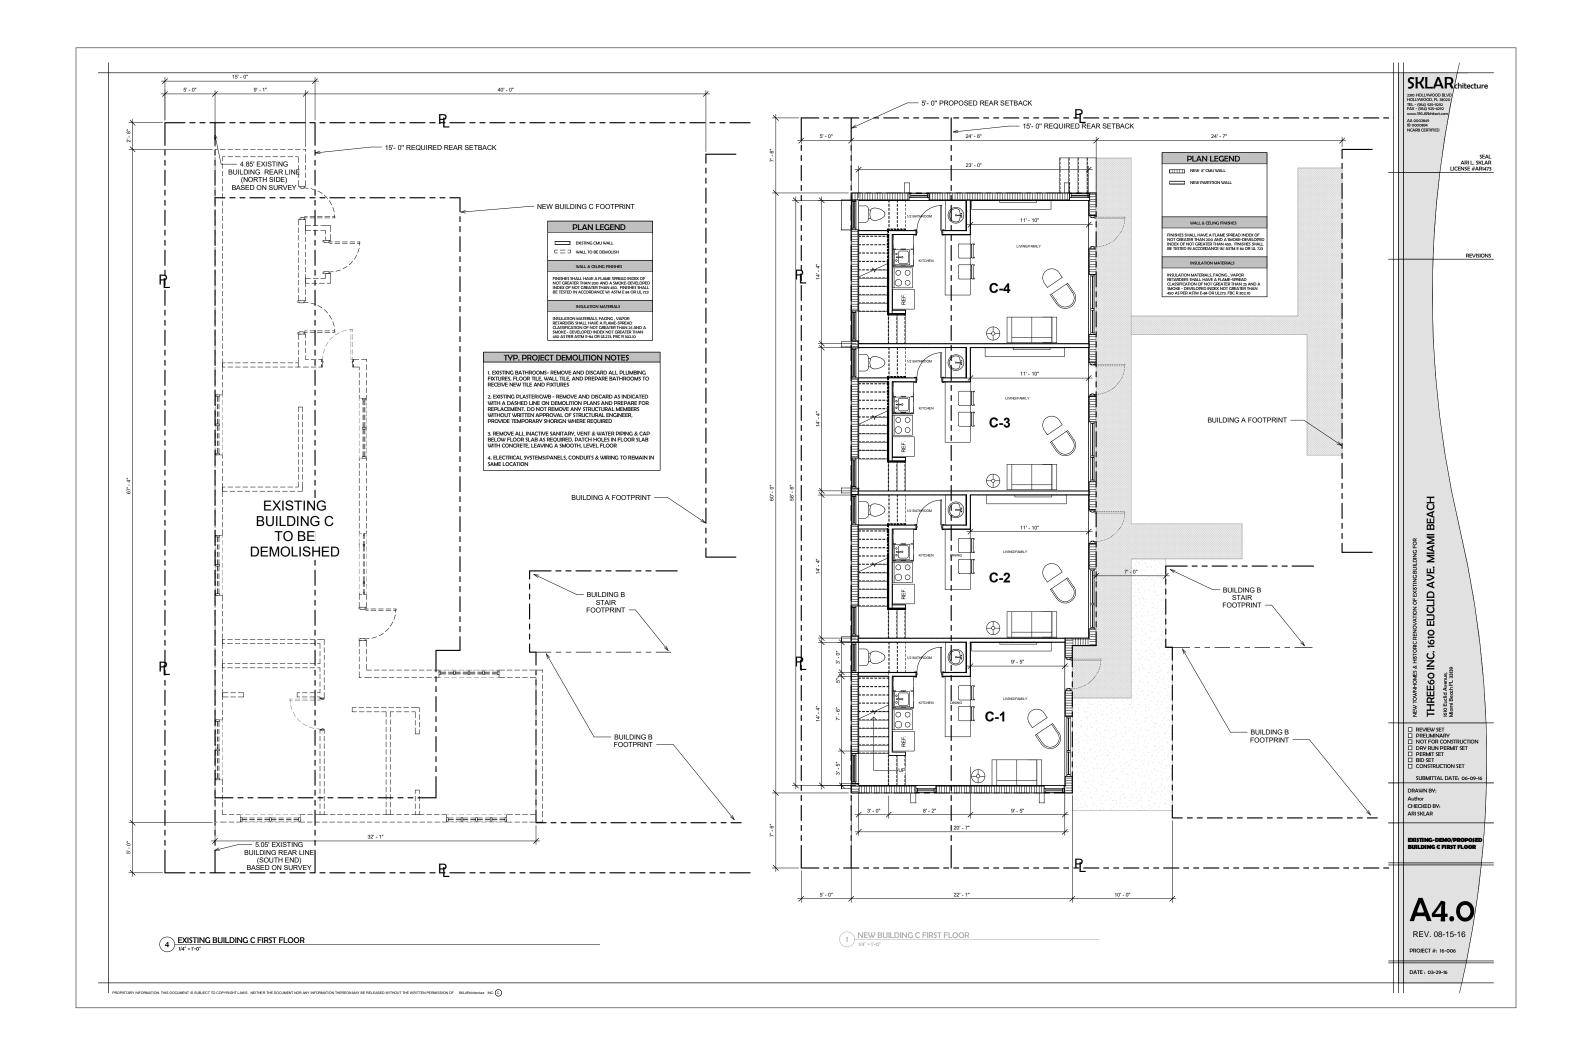


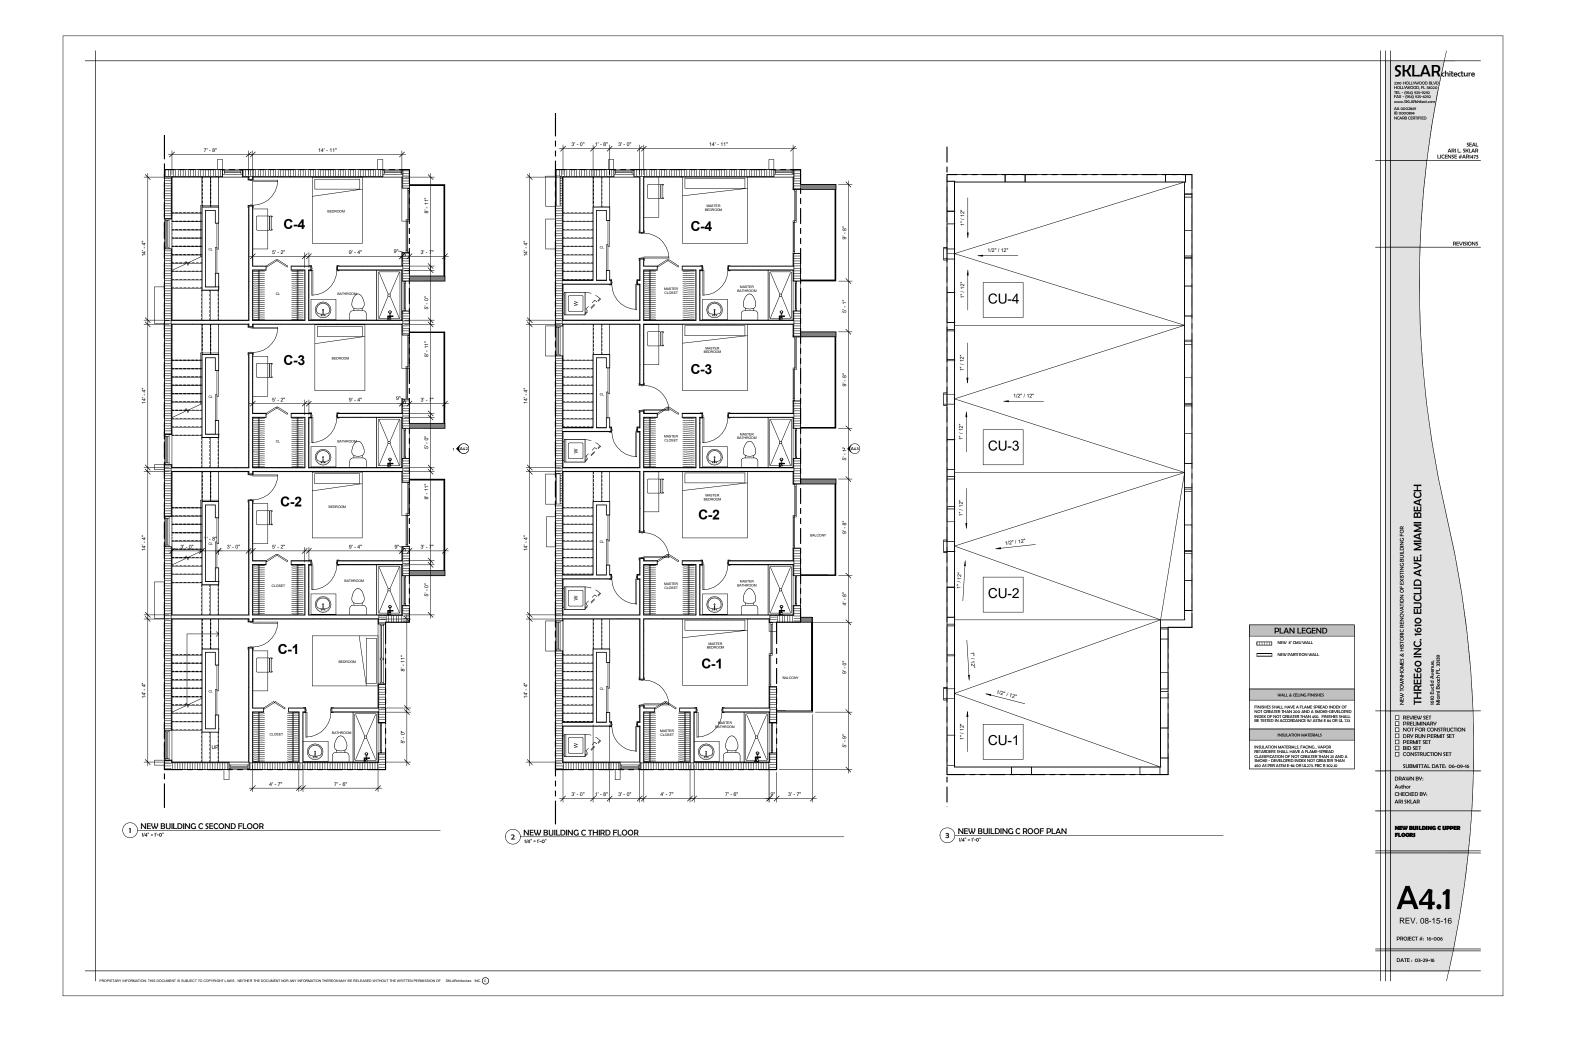

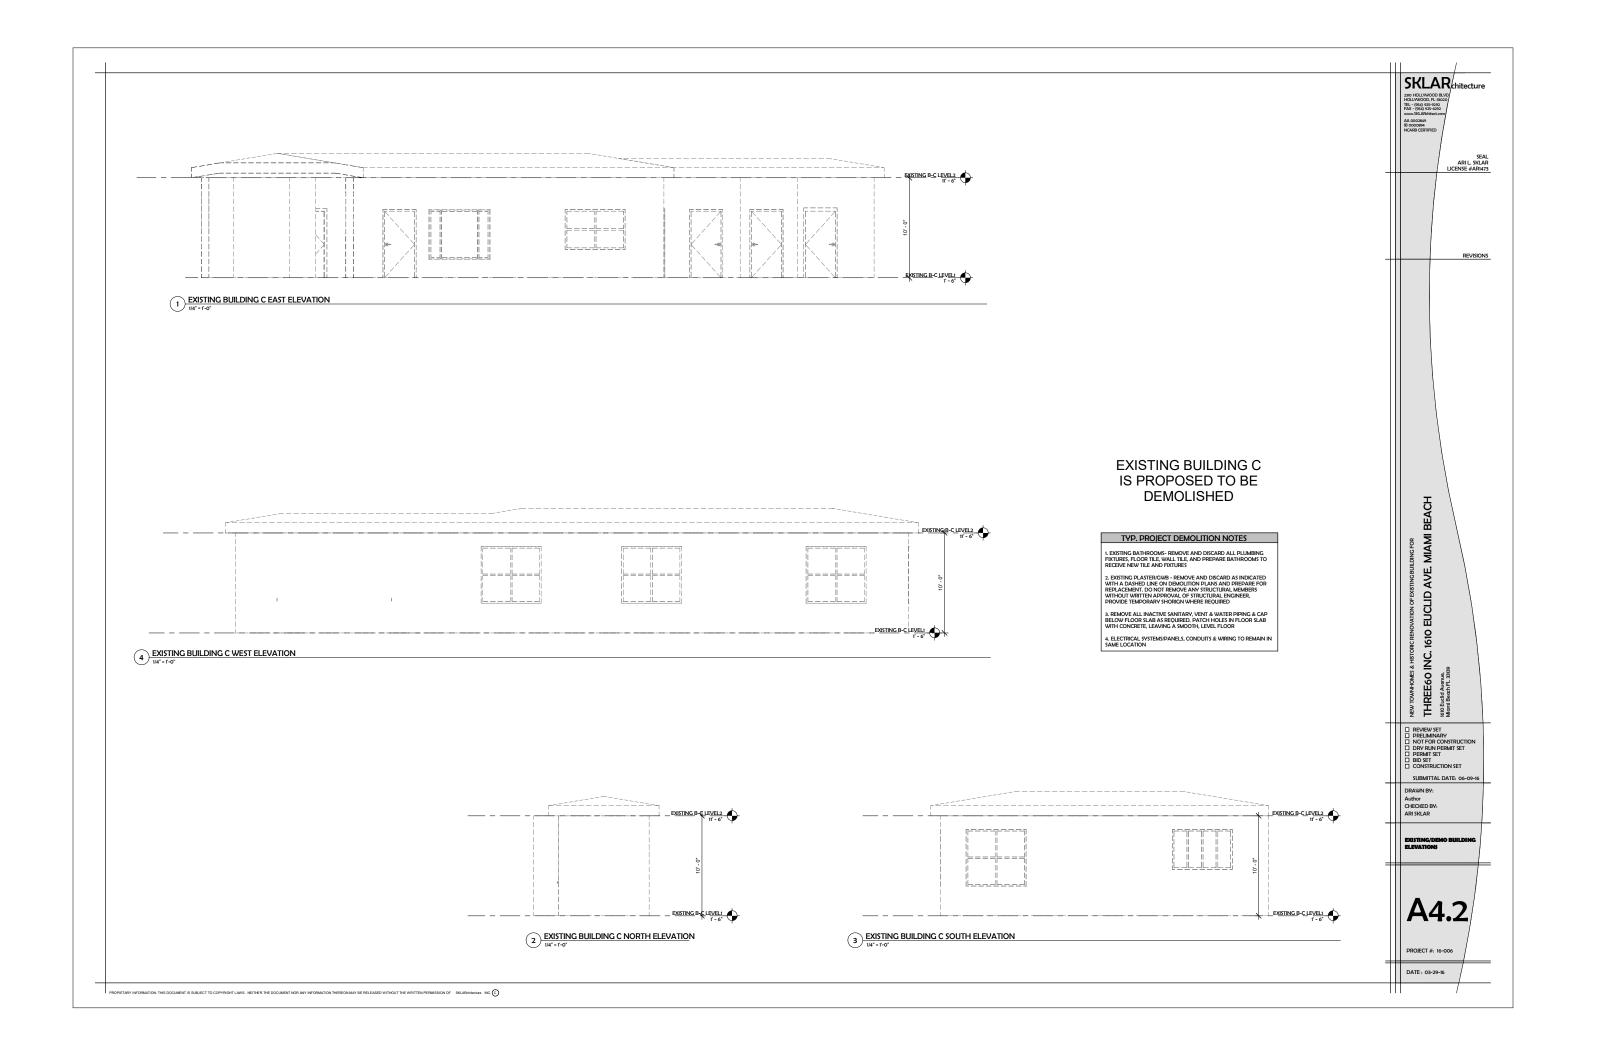

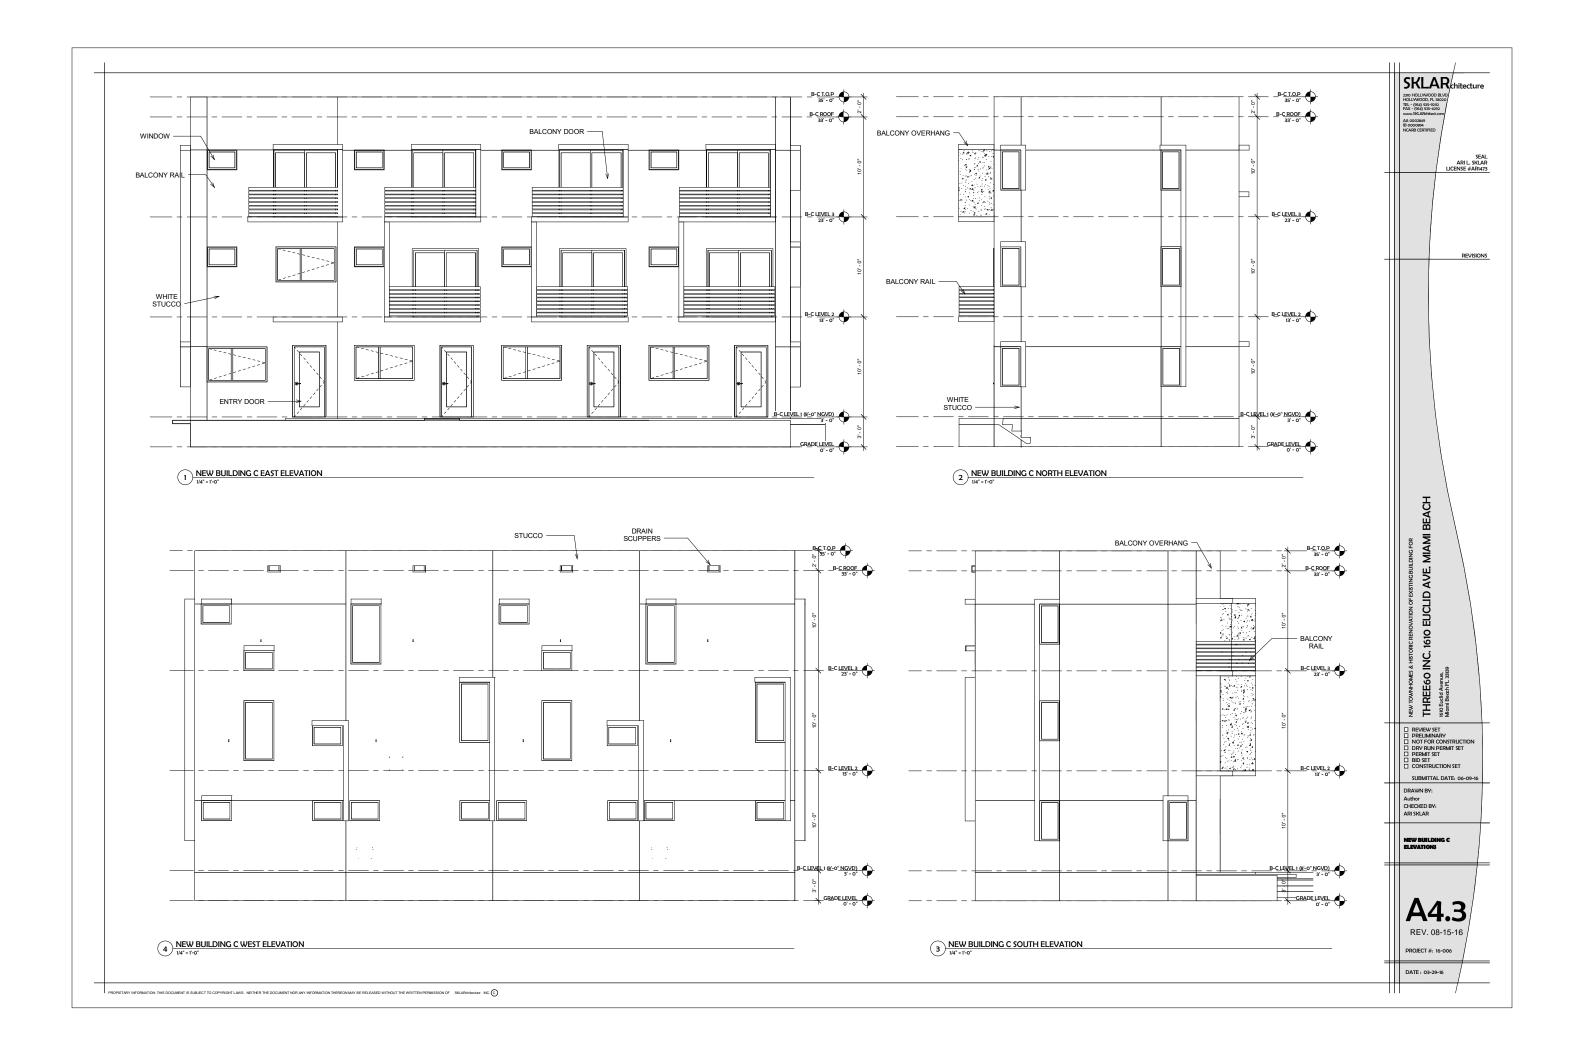

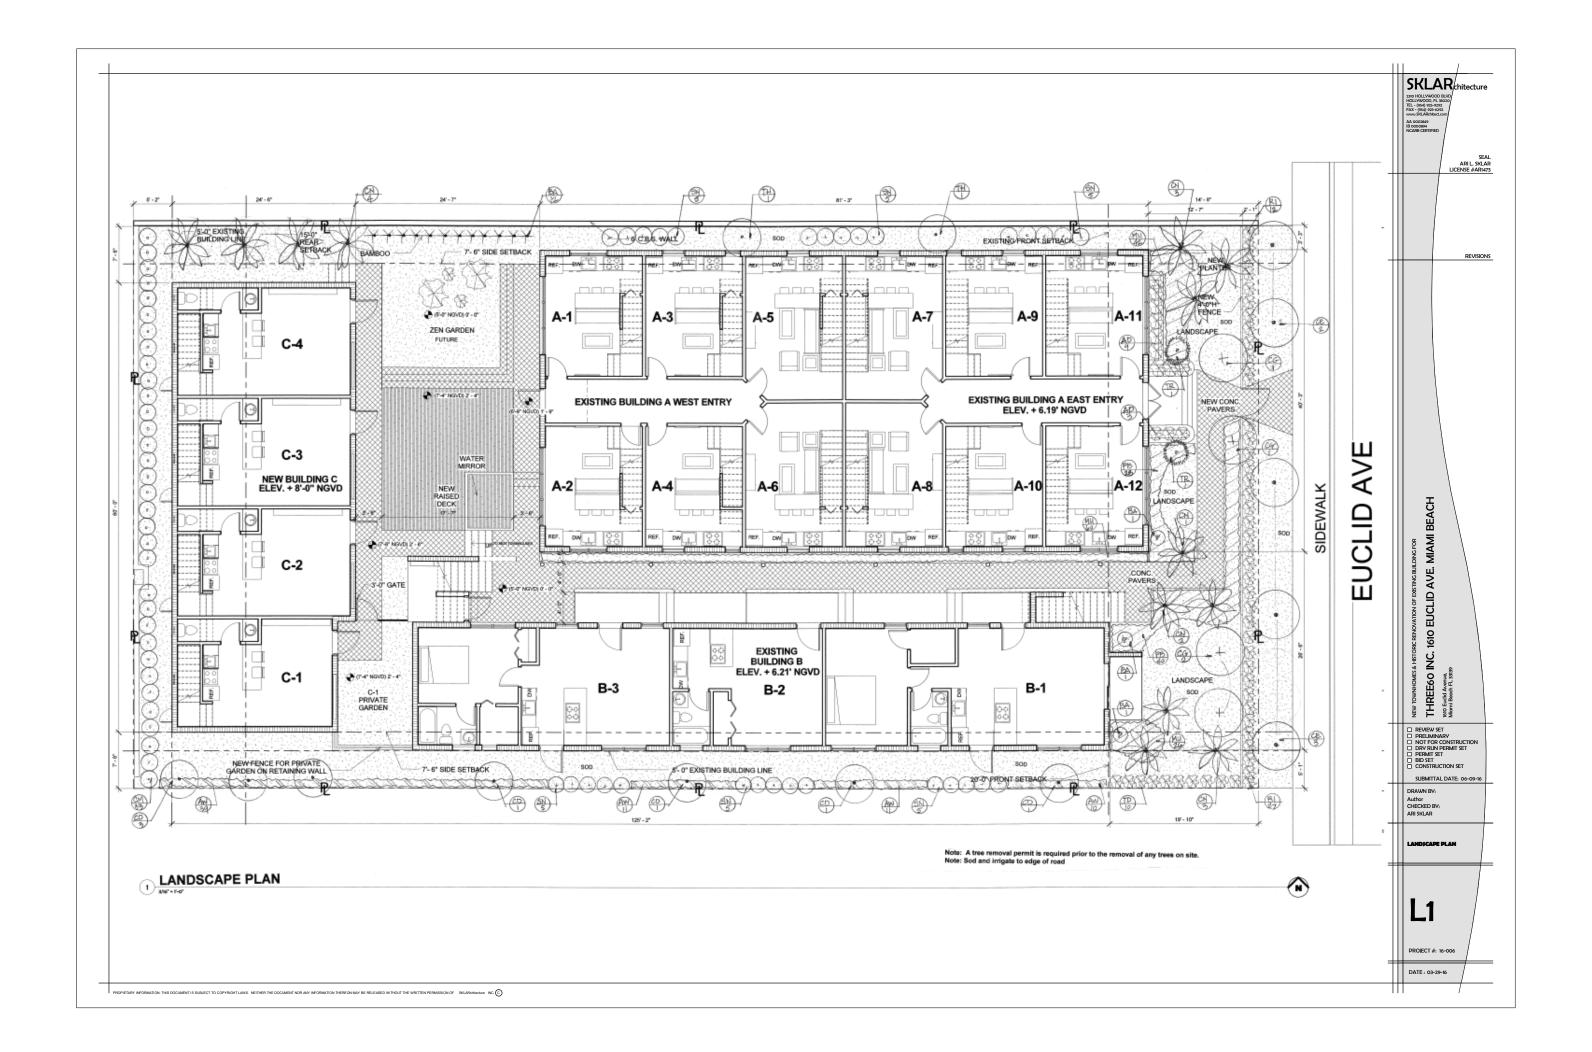

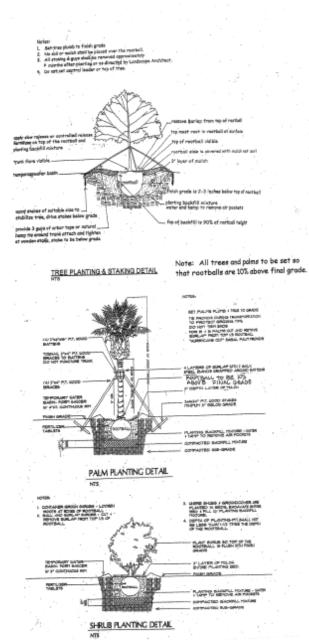

General Notes:

- General Notes:

 1. All plant matini shall be Florida No. 1 or better as given in the current Florida Grades and Standarda for humany Pharia, 2015. Florida Department of Agriculture and Consurser Services.

 2. All plant materials shall be subject to inspection and approval by the Landacape Architect at place of growth and upon delivery for conformity to specification.

 3. All plants shall be true to species and variety and shall conform to measurements specified, All substitutions shall be submitted to the City and Landacape Architect for final approval.

 4. All plants shall be exceptionally heavy, symmetrical, girt lank and ac trained in appearance as to be superior to form, branching and symmetry.

 5. Contractor shall notify Sunshine 611 (out 811) to flocations of existing utility lines 46 hours prior to beginning work. Contractor shall verify location of all utility lines and examines prior to commencing any work. Excervation in the vicinity of underground utilities shall be undertaken with care and by hand, if in accessary. The Contractor bears full responsibility for this work and disruption or derrage to utilities shall be repaired immediately at no expense to Owner.

- undertaken with care and by hend, if necessary. The Contractor beers full responsibility for this work and disruption or derange to utilities shall be respired immodistely at no expense to Owner.

 Crade B4, shredded sterilized Eucalyptus much shall be used in all mass planning bads and for individual tree pits. All trees shall have a much hing with a depth of 3" and a disenser of 3"-4" around heir base. All much shall be leget 4" from base of all plant material. Much beds shall be a minimum of 12" widor than plants measured from outside edge of foliage.

 Sod shall be a minimum of 12" widor than plants measured from outside edge of foliage.

 Sod shall be St. Augusties and fine of weeds, insects, fingus and disease, laid with alternating and abutting joins.

 All trees and shrubs shall be backfilled with a suitable planning soil consisting of 50 percent sand and 50 patient approved compost. All plant materials shall be planted with a minimum of 6 to 18 inches of planning soil and the root ball. Refer to planting details. Planting soil to be backfilled into plant plan by weating in. Planting beds shall be free from road, pea, egg or coloned rock, building materials, others, weeds, nouslous peets and disease.

 All socked arease to have a minimum of 2" of planting soil as described in note 88.

 All lines shall be warmanted by the Contractor and will be healthy and in flourishing condition of active growth one year from date of final acceptance.

 All and the shall be carried and so of shall be fully warmanted for 90 days under same condition as above.

 All shall be promoved before any trees are planted. All synthetic species or occurred from trurius, branchas, etc.before any trees are planted. All synthetic species or occurred from trurius, branchas, etc.before any trees are planted. All synthetic species or occurred from trurius, branchas, etc.before any trees are planted. All synthetic species of the planting area.

 In arrease where pawed surfaces abut sod or muldit, the final level of both surfaces should be even.

- 14. In areas where pawed surfaces abut so or mulent, the final level of both surfaces should be even.
 15. All planting shall be installed with furtilizer at time of planting.
 16. All planting shall be installed in a sound, work-manifele manner and according to good planting procedures. Installation shall include watering, weeding, fertilizing, mulching, selective pruning and reserved of refuse and debris on a regular basis so as to precent a neal and well kept appearance at all times.
 17. All landscape and sod areas what have an automatic imigation system installed. Coverage should be 100% with 50% minimum overlap using rust thee water to all landscape and sod areas. Spray upon public sidewalks, streets and adjacent properties should be minimized.
 Sodded areas and shruly dynamionare hosts should be on separate imigation zones when feasible for a more efficient system. Imigation system shall be installed with a rainswitch device.
- divice.

 18. All landscape and irrigation shall be installed in compliance with all local codes.


 19. The plan shall take precedence over the plant list, should there be any discrepancy between


Plant List


Sym	Qty	Botanical/ Common Name	Size	Native
CE	5	Conocarpus erectus/ Green Buttonwood	14' Ht x 5' Spr, 3" cal	yes
CD	7	Coccolobe diversifolia/ Pigeon Plum	10' Ht x 5' Spr. 2" cal	yes
CN	13	Cocce nuclfera 'Green Malayan'/ Coconut Palm	8' CT	no
CG	4	Caesalpinia granadillo/ Bridalveil Tree	12' Ht x 5' Spr, 2" cal.	yes
TH	2	Tabebula heterophylla/ Pink Tabebula	10' Ht x 5' Spr, 2" cal	no
TR:	2	Thrunax radiata/ Thatch Palm	8' CA HI	yes
CM	-33	Caryotat mitis/ Fishtali Palm	6'-8' OA Ht	no
TD	10	Tripsacum dactyloides/ Fakahatchee Grass	24" x 24", 24" O.C.	yes
BA.	15	Bambusa textilis gracilis/ Slender Weavers Bamboo	6'-8' Ht, 9' Stem min full	no
MU	128	Muhlenbergia capillaries/ Muhly Grass	18" x 18", 24" O.C.	yes
SN	30	Strelitzia nicolai/ Giant Bird of Paradise	6'-8' Ht	no
RJ	39	Raphiolopis indica/ Indian Hawthorn	18" x 18", 24" O.C.	no
AD	12	Asperagus densifiorus densifiorus 'Meyersi// Foxtali Fern16' x 16', 24' O.C.		no
PB	68	Philodendron 'Burle Marx'/ Burle Marx	18" x 18", 24" O.C.	no
AW	71	Acalypha wilkesiana/ Copperleaf	24" x 24", 24" O.C.	no
Sod		St. Augustine ' Floratam'		
Mulch	1	Shredded Eucalyptus, Metaleuca or recycled mulch		

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	SKLAR chitecture SSE HELLWACOD BLID FICLIAWOOD R. SOND FILE. (964) 975-9702 FIX. (964) 975-9702 FIX. (964) 975-9702 AB COCCOPIA NCARB CERTIFIED SEAL
	ARIL SIČAR LICENSE #ARI473 REVISIONS
	NEW TOWNHOMES & HISTORIC RENOVATION OF EXISTING BULLING FOR THREEGO INC. 1610 EUCLID AVE, MIAMI BEACH ROOTELEID AVER MANT BROTH L 33899
	REVIEW SET PRELIMINARY NOT FOR CONSTRUCTION DRY RUN PERMIT SET PERMIT SET BID SET CONSTRUCTION SET SUBMITTAL DATE: 06-09-16
	DRAWN BY: Author CHECKED BY: ARI SKLAR
	LANDICAPE PLAN
	L2
#	DATE: 03-29-16

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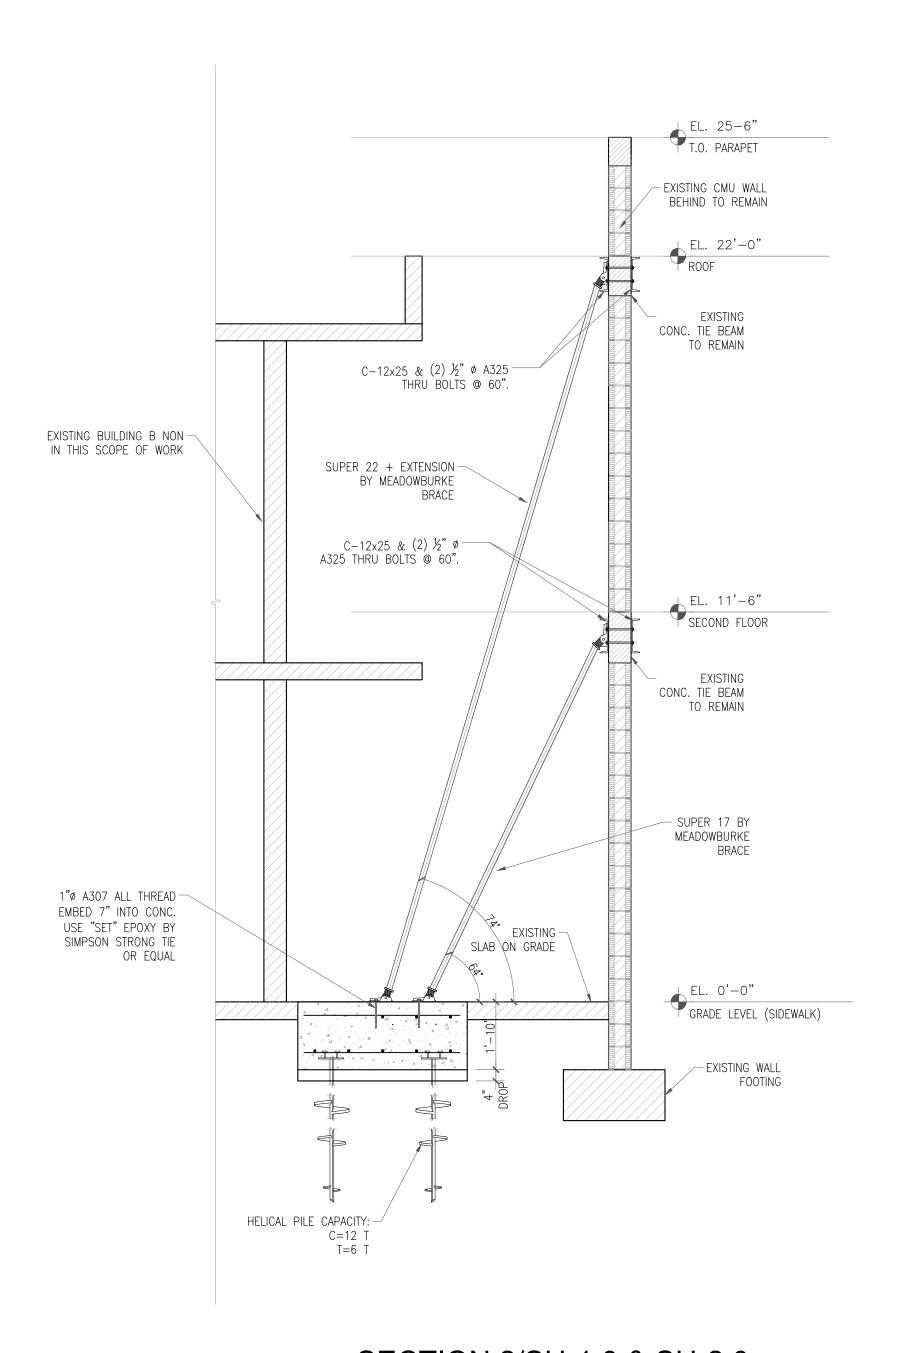


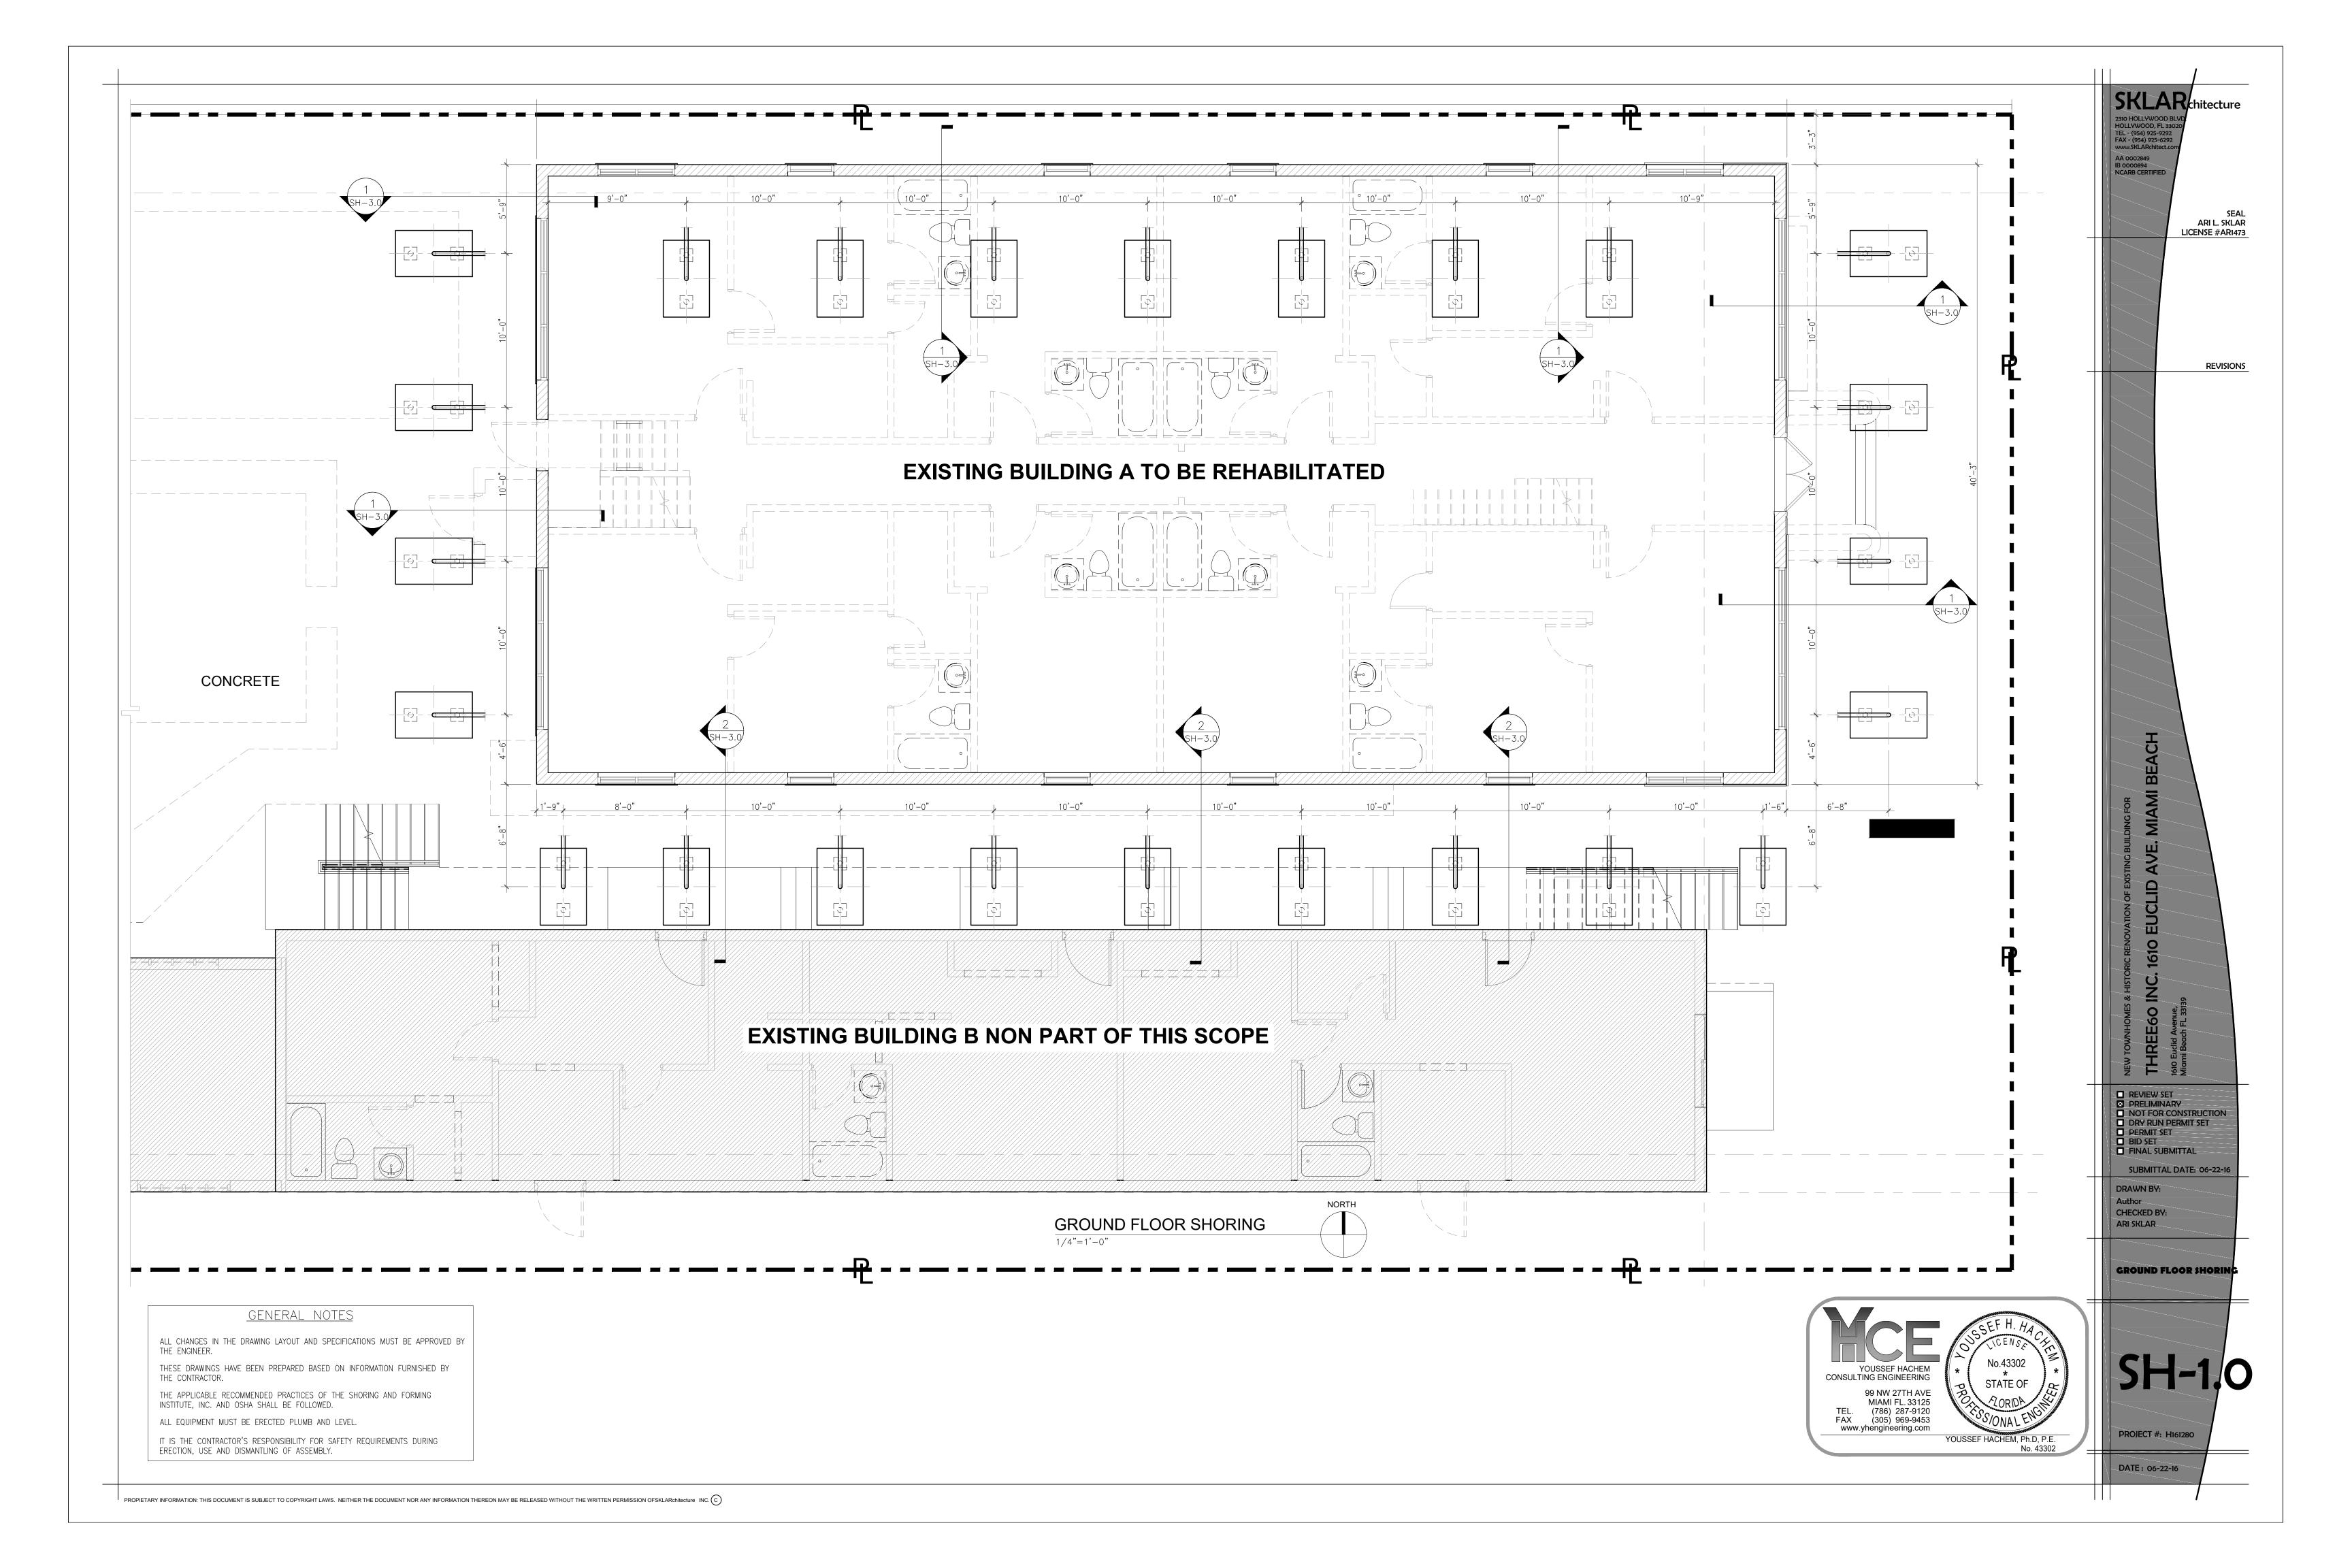

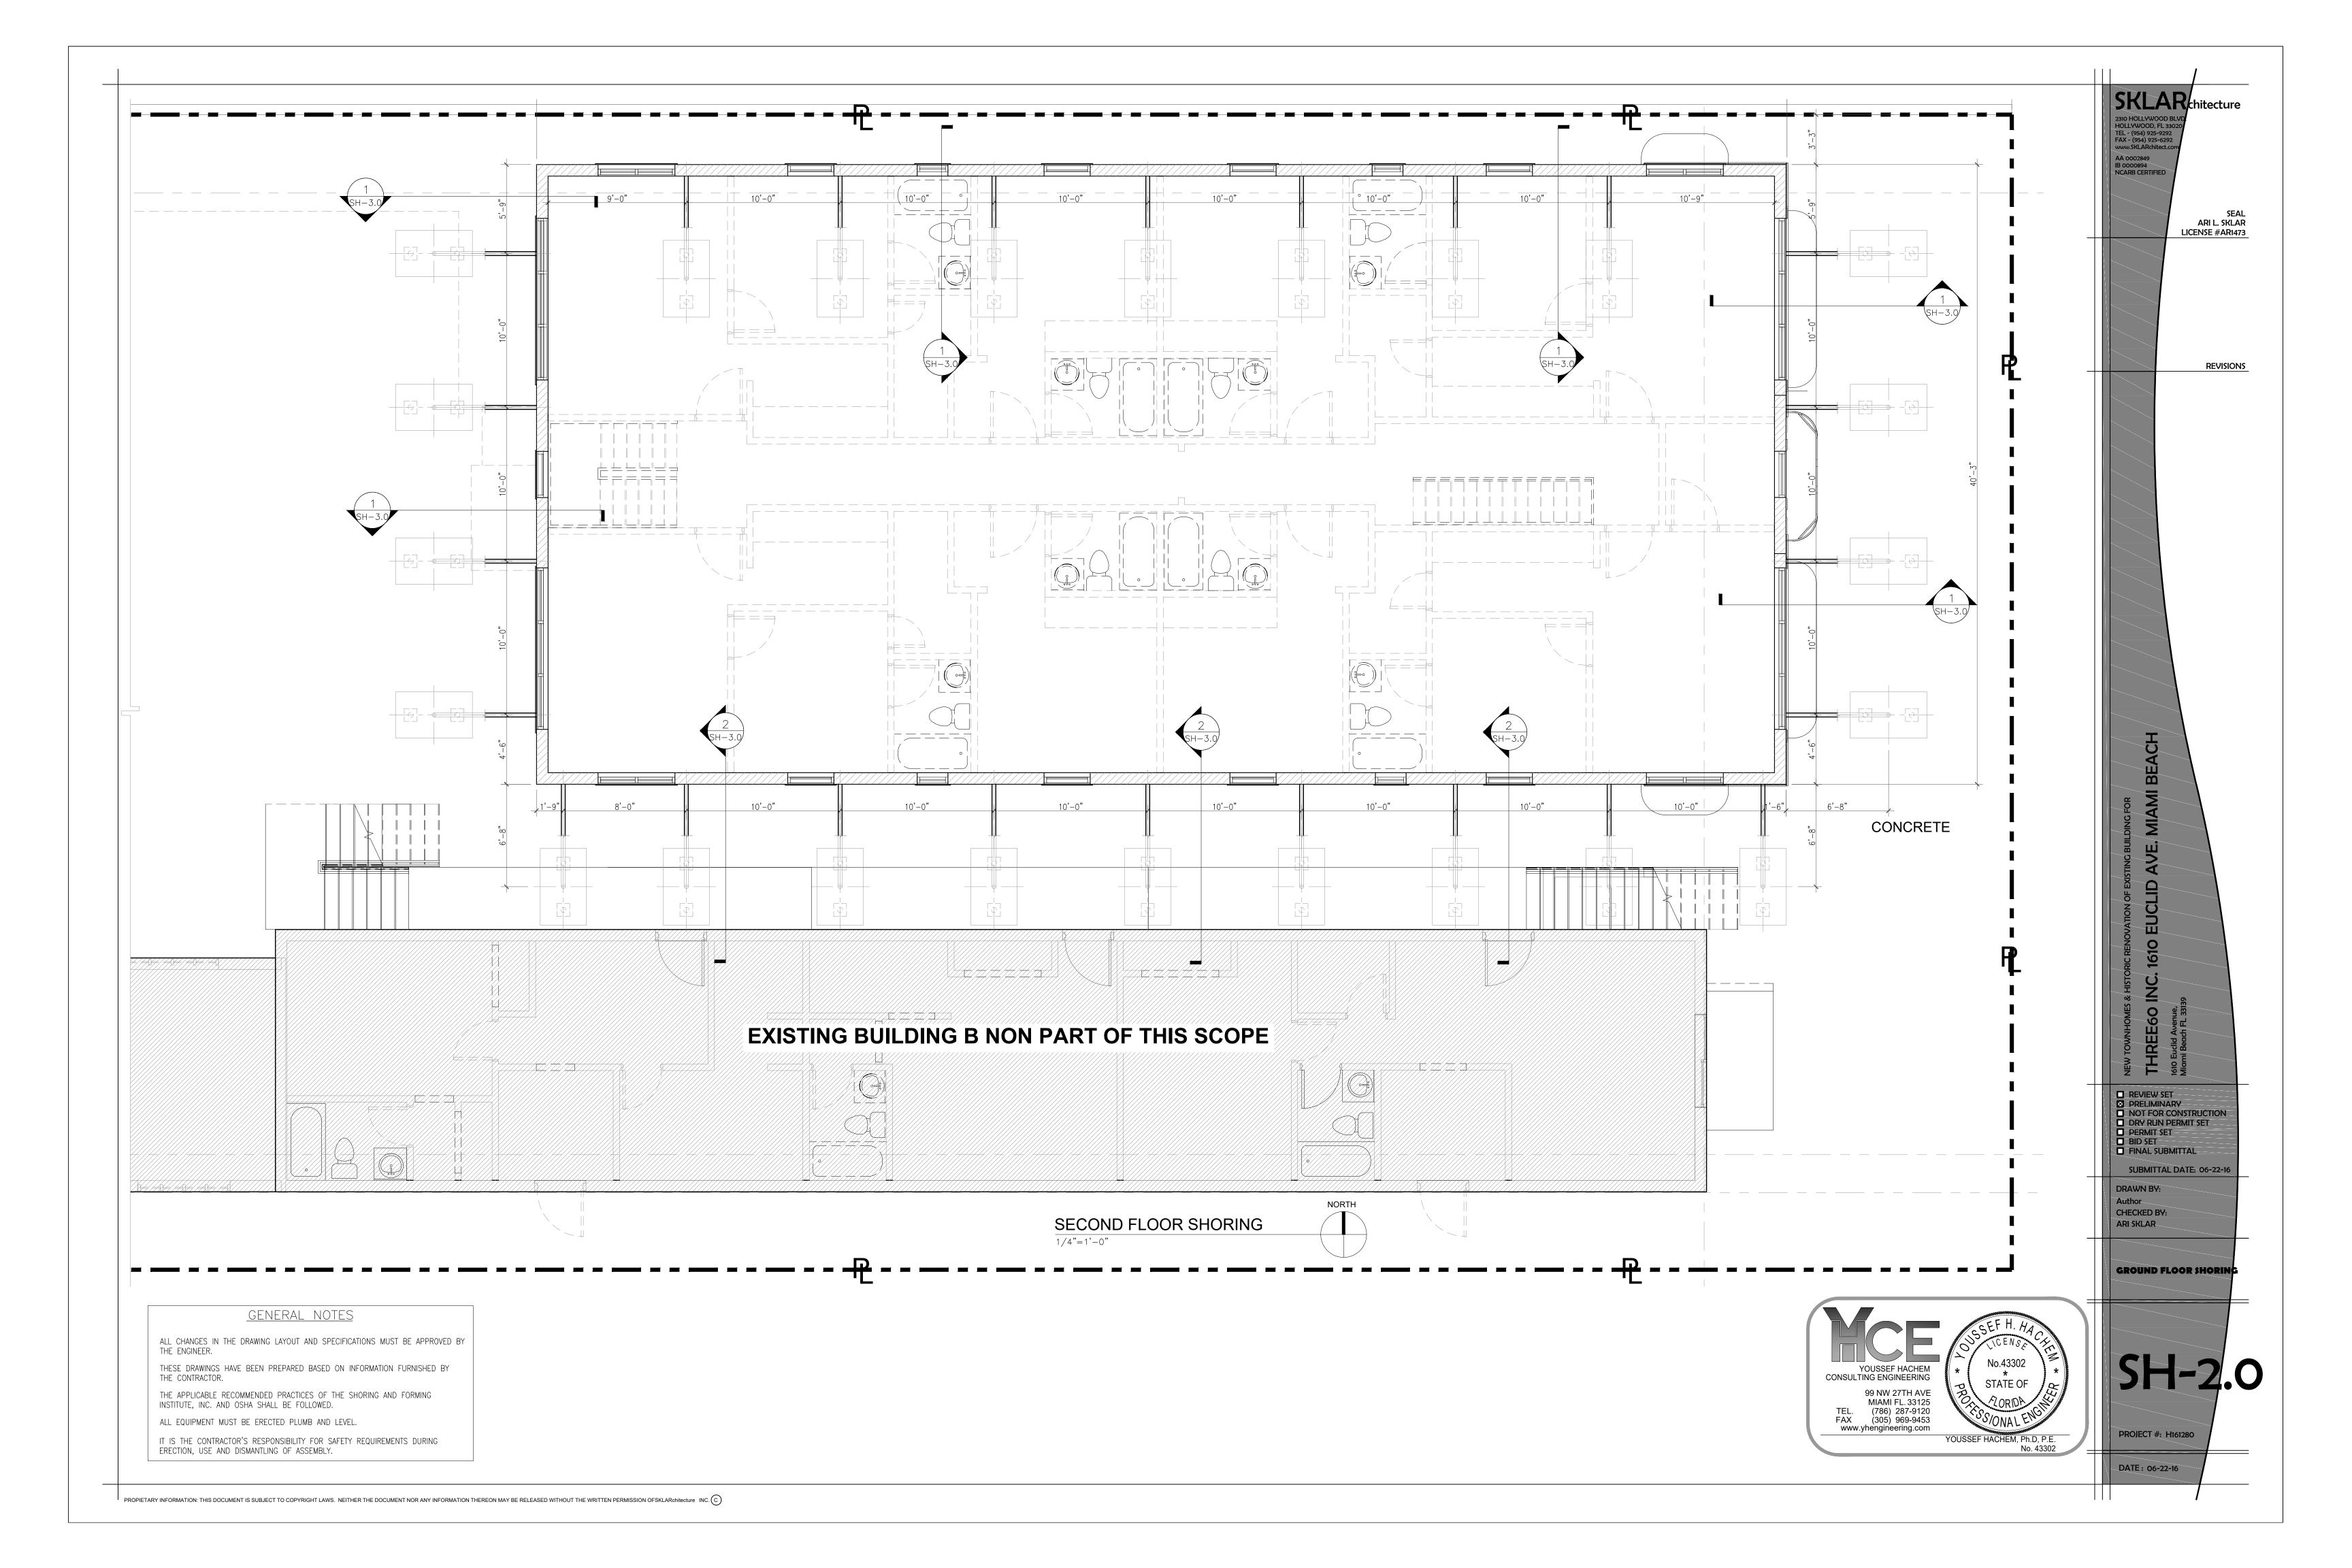

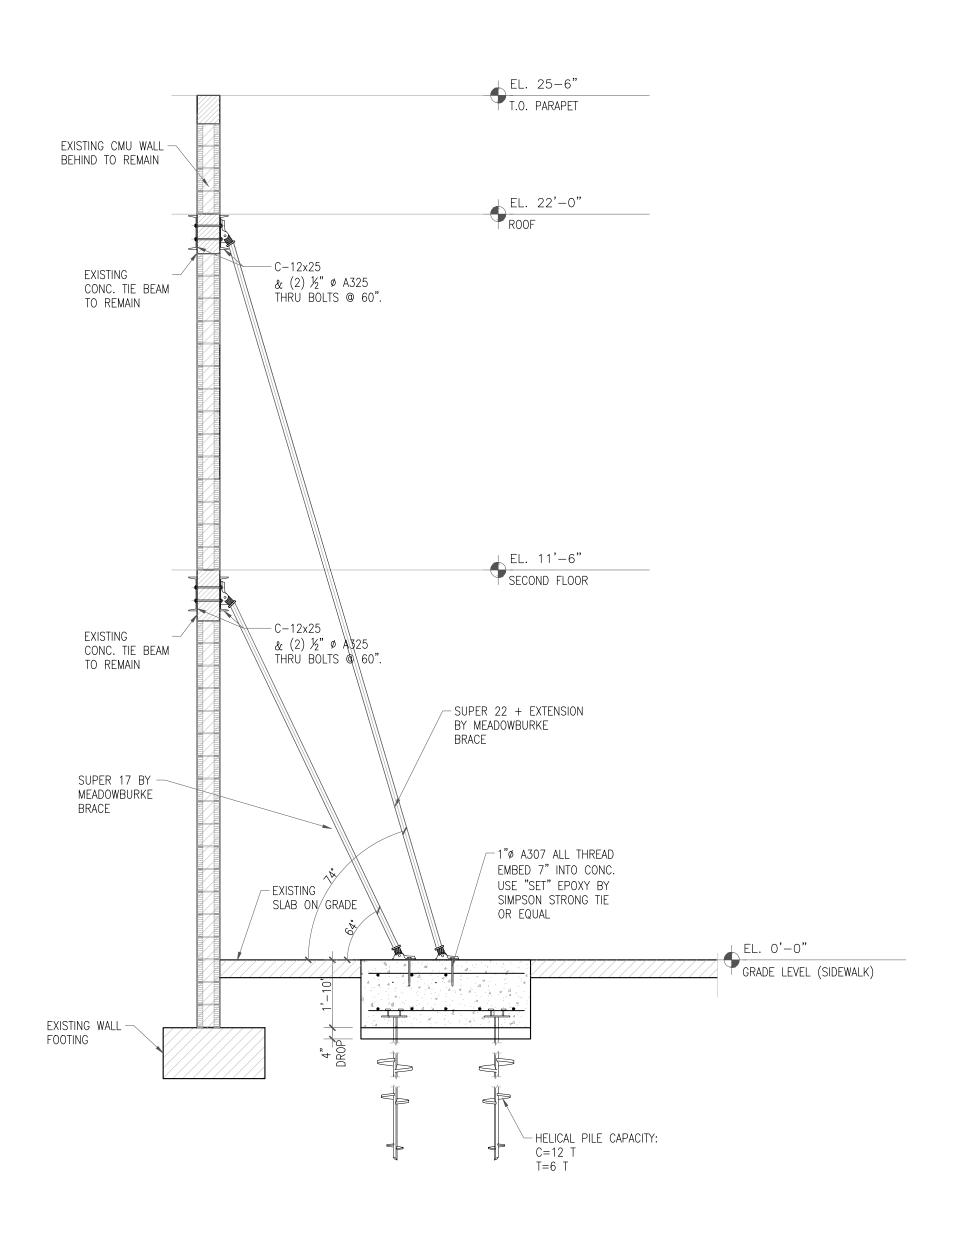SECTION 1/SH-1.0 & SH-2.0

SCALE: 3/8"=1'-0"



SECTION 2/SH-1.0 & SH-2.0

SCALE: 3/8"=1'-0"

CONCRETE:

- 1. CONCRETE DESIGN AND REINFORCEMENT IN ACCORDANCE WITH "BUILDING CODE REQUIREMENTS FOR REINFORCED CONCRETE" (A.C.I. 318-LASTEST EDITION) AND WITH
- "DETAILS AND DETAILING OF CONCRETE REINFORCEMENT" (A.C.I. 315-LASTEST EDITION).

 2. ALL CONCRETE WORK IN ACCORDANCE WITH "SPECIFICATIONS FOR STRUCTURAL CONCRETE FOR BUILDING" (ACI 301). PRODUCTION OF CONCRETE, DELIVERY, PLACING AND CURING TO BE IN ACCORDANCE WITH "HOT WEATHER CONCRETING" (A.C.I. 305R-99).
- WALLS ---- I/2"


 4. NO ADMIXTURES PERMITTED WITHOUT THE REVIEW OF ARCHITECT / ENGINEER.

 5. FOR ALL CONCRETE TO BE PLACED IN SLABS (INCLUDING SLABS ON
- GRADE), THE SLUMP SHALL NOT EXCEED 4", NO WAIVERS OF THIS REQUIREMENT SHALL BE CONSIDERED. SLUMP FOR OTHER CONCRETE SHALL NOT EXCEED 5".
- 7. CONCRETE TO BE REGULAR WEIGHT WITH A DESIGN STRENGTH ACHIEVED AT 28 DAYS AS FOLLOWS:
- A. COLUMNS & FOOTINGS f'C= 3,000 PSI

 B. BEAMS f'C= 5,000 PSI (U.O.N.) W/ W/C OF 0.4 MAX


 8. TAKE ONE SET OF 5 CYLINDERS FOR EVERY FIFTY CUBIC YARDS OR FRACTION THEREOF FOR EACH CLASS OF CONCRETE POURED EACH DAY. FOLLOW ASTM STANDARDS FOR SAMPLING AND TESTING. TEST ONE CYLINDER AT 3 DAYS AND 7 DAYS AND 3 AT 28 DAYS. IF ONE OF THE TWO 28 DAYS TESTS FALLS BELOW SPECIFIED STRENGTH, TEST THE THIRD CYLINDER AT 56 DAYS. TAKE ONE SLUMP TEST (ASTM C143) FOR EACH SET OF TEST CYLINDERS
- 9. NO CONCRETE TEST WILL BE ACCEPTED IF CONCRETE IS TAMPERED WITH IN ANY WAY AFTER SAID TEST IS PERFORMED. REPEAT TEST IF WATER IS ADDED AFTER INITIAL SAMPLING.

 10. IF CONCRETE IS PUMPED, SLUMP MAY BE INCREASED TO 6" AT THE TRUCK, PROVIDED THE
- IF CONCRETE IS PUMPED, SLUMP MAY BE INCREASED TO 6" AT THE TRUCK, PROVIDED THE SLUMP SPECIFIED IN NOTE 4 IS MAINTAINED AT THE DISCHARGE END. USE A MINIMUM 4-INCH PUMP. TAKE CONCRETE SAMPLES FOR SLUMP AT TRUCK AND AT DISCHARGE END AND FOR CYLINDER TESTING AT DISCHARGE END.
 CONTRACTOR IS RESPONSIBLE FOR THE ADEQUACY OF FORMS AND SHORING AND FOR
- 11. CONTRACTOR IS RESPONSIBLE FOR THE ADEQUACY OF FORMS AND SHORING AND FOR SAFE PRACTICE IN THEIR USE AND REMOVAL. CONTRACTOR SHALL DESIGN AND ERECT FORMWORK IN STRICT COMPLIANCE WITH ACI 347R-LASTEST EDITION SUBMIT SIGNED & SEALED SHOP DWGS. CONTRACTOR SHALL COORDINATE ALL OPENINGS AS REQUIRED FOR OTHER TRADES. OPENINGS WHERE SHOWN ON THE STRUCTURAL DRAWINGS ARE TO IDENTIFY DESIGN INTENT ONLY. THE SPECIFIC DIMENSIONS AND LOCATIONS SHALL BE FURNISHED OR CONFIRMED BY THE TRADE REQUIRING THE OPENING. PROVIDE CHAMFERS AT ALL CORNERS IN CONCRETE MEMBERS EXPOSED TO VIEW. FORMWORK TO REMAIN IN PLACE UNTIL CONCRETE HAS ATTAINED ENOUGH STRENGTH TO SUPPORT ALL DEAD LOADS PLUS A MINIMUM OF 50 PSF OF ADDITIONAL CONSTRUCTION LOAD.
- 12. SPECIFIED EXPANSION BOLTS SHALL BE OF THE SIZE INDICATED AND OF THE MAXIMUM EMBEDMENT LENGTH INTO THE CONCRETE. LEAD SHIELDS ARE NOT ACCEPTABLE. EXPANSION BOLTS SHALL NOT BE SUBSTITUTED FOR SPECIFIED ANCHOR BOLTS WITHOUT THE ENGINEER'S APPROVAL.

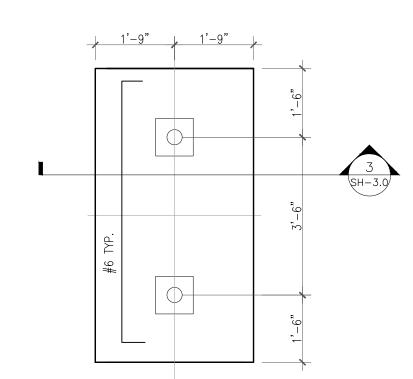

PILE CAP TYP. DETAIL

SCALE: 1/2"=1'-0"

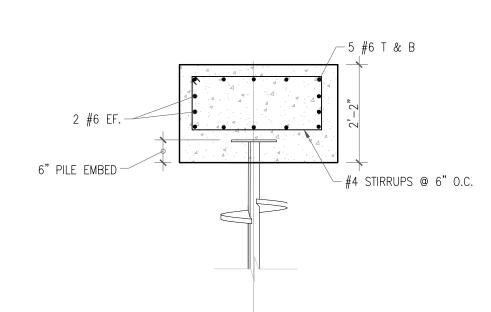

SECTION 3/SH-3.0

SCALE: 1/2"=1'-0"

YOUSSEF HACHEM CONSULTING ENGINEERING

99 NW 27TH AVE MIAMI FL. 33125
TEL. (786) 287-9120
FAX (305) 969-9453
www.yhengineering.com

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310 HOLLYWOOD BLVD

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EL - (954) 925-9292

AX - (954) 925-6292

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REVISIONS

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□ PERMIT SET
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Author CHECKED BY: ARI SKLAR

\$ECTION:

SH-3.0

DATE: 06-22-16

PROJECT #: H161280

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