


2

revuelta

SH-1.0

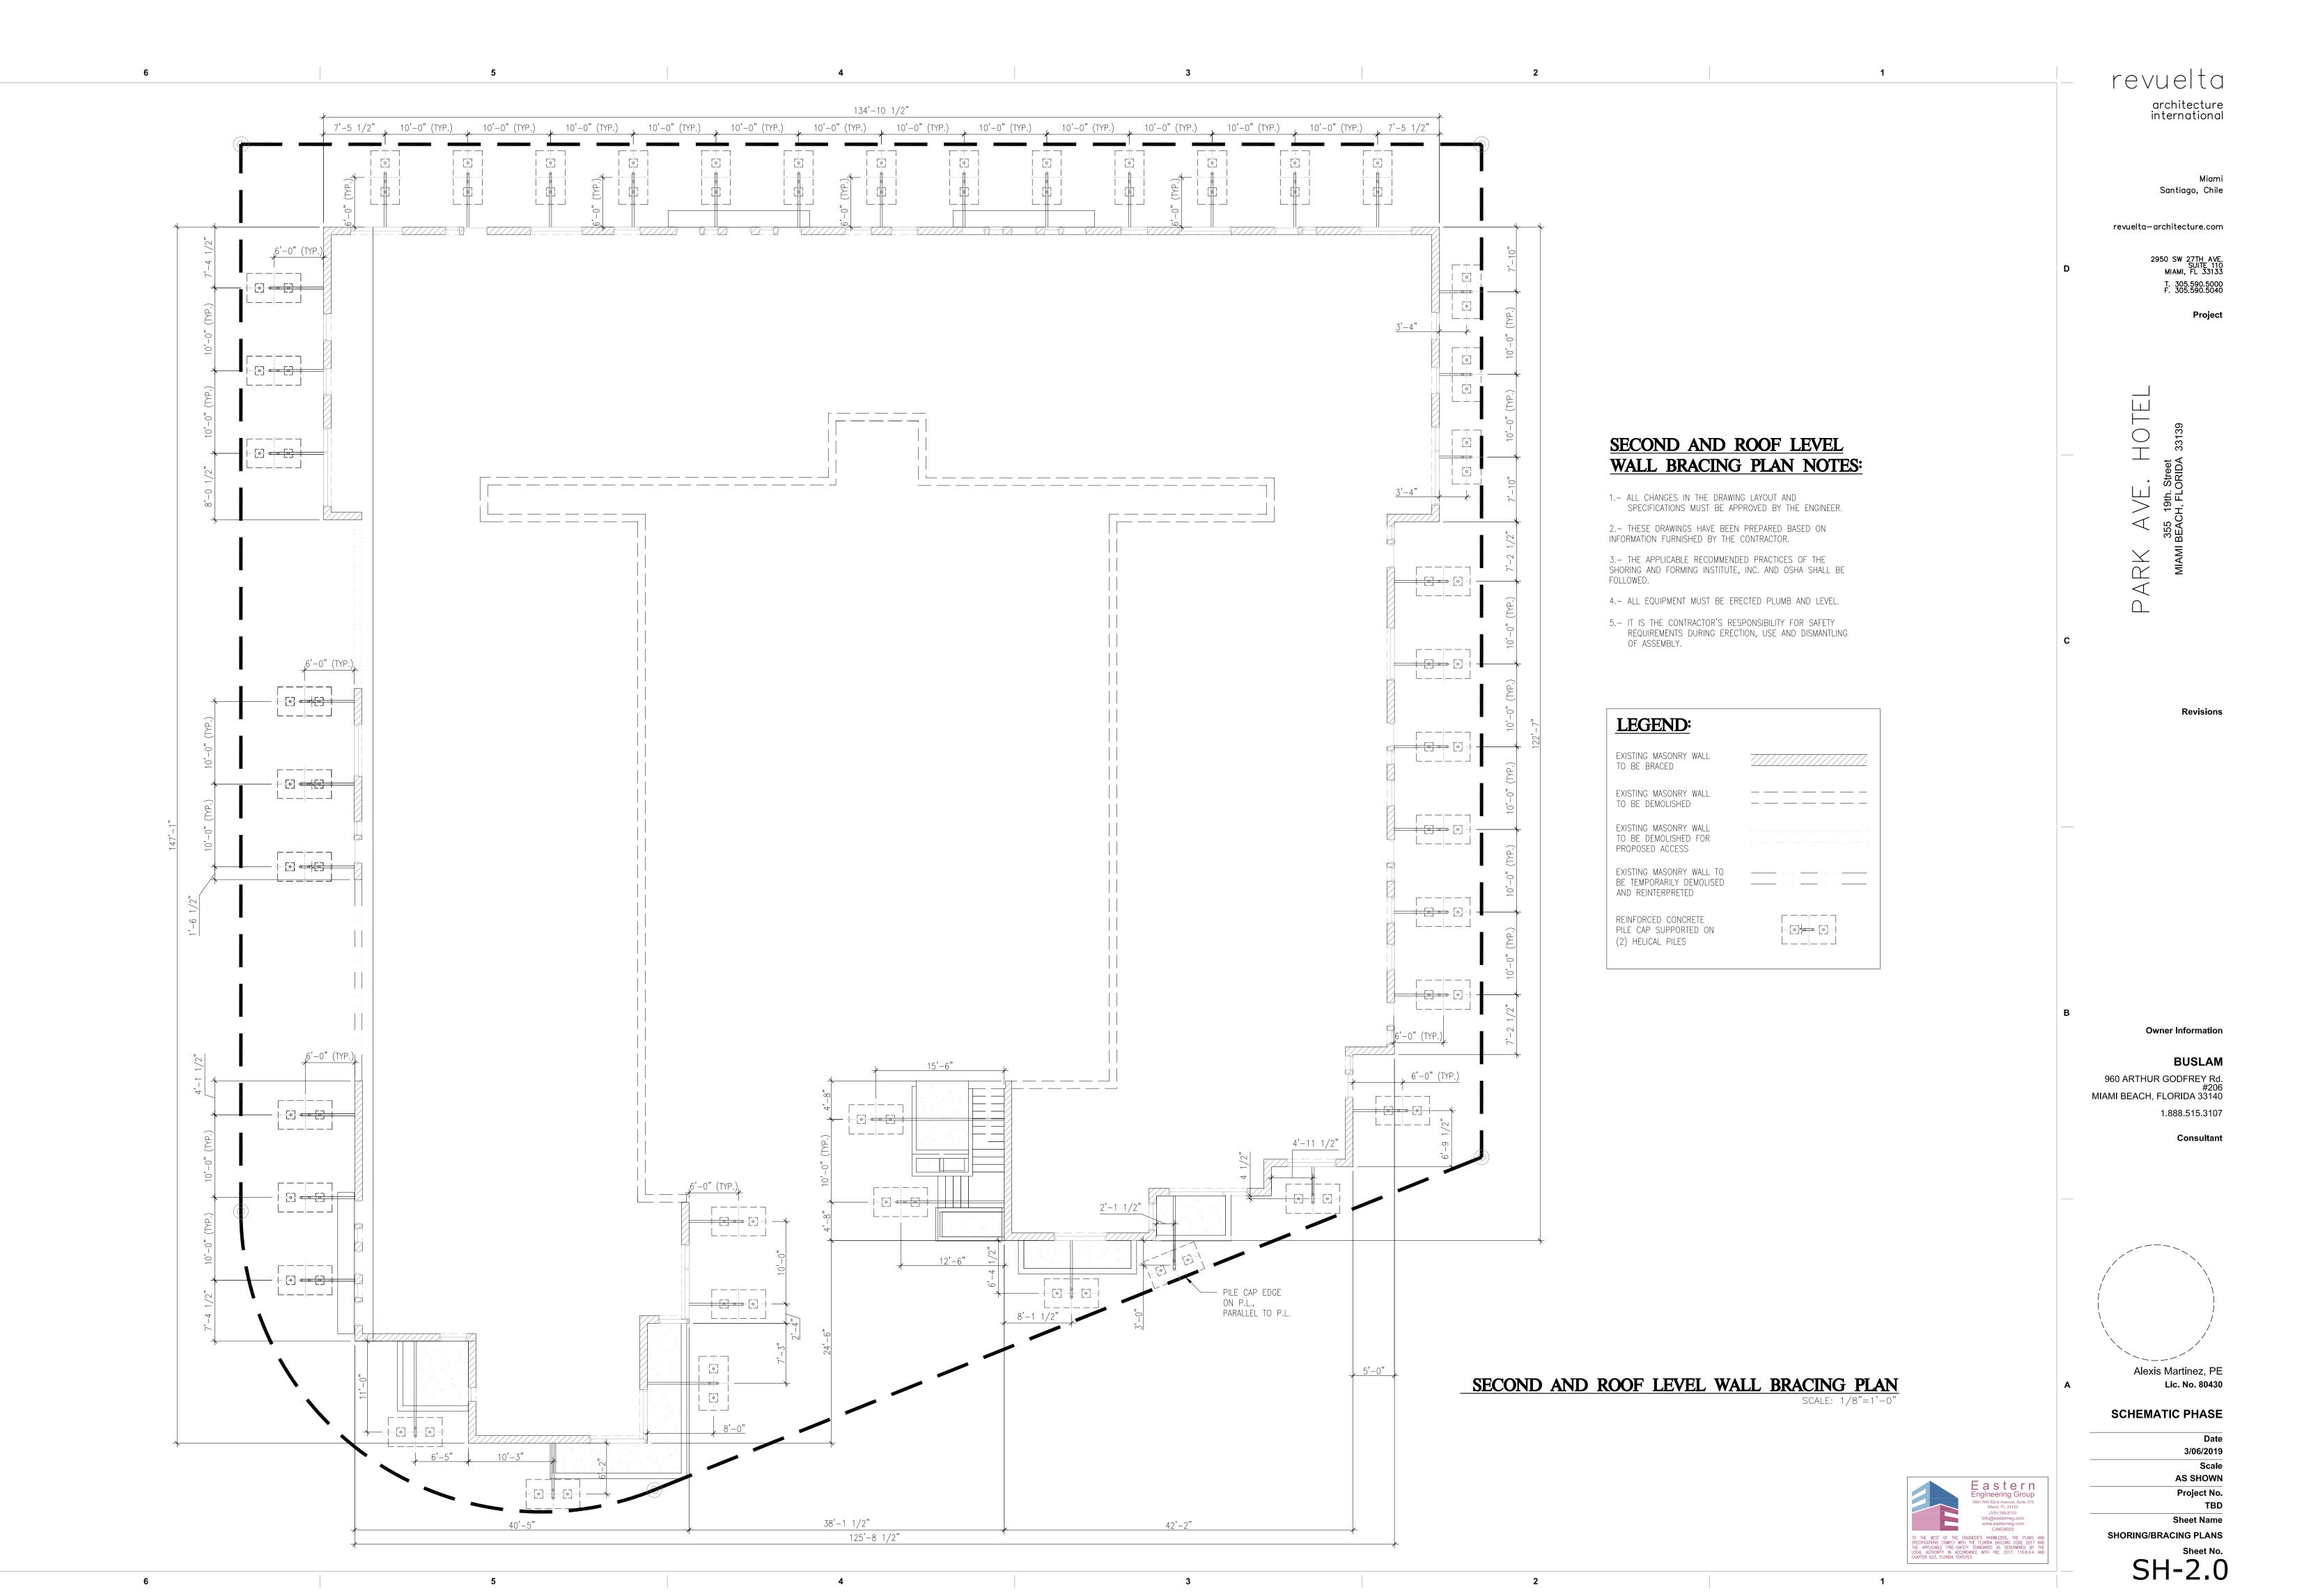

Santiago, Chile

Owner Information

─#4 STIRRUPS @ 6" O.C.

PILE CAP SECTION

Consultant

Alexis Martinez, PE Lic. No. 80430

SCHEMATIC PHASE

3/06/2019 **AS SHOWN** Project No.

Sheet Name SHORING/BRACING PLANS

CONCRETE:

-ALL STRUCTURAL CONCRETE HAS BEEN DESIGNED IN ACCORDANCE WITH THE ACI 318 LATEST EDITION AND THE BUILDING -THE CONCRETE REQUIREMENTS ARE:

A. CEMENT SHALL BE TYPE I OR II CONFORMING TO ASTM C150. B. FINE AND COURSE AGGREGATES SHALL CONFORM TO ASTM C33.

-COMPRESSIVE STRENGTH AT 28 DAYS:

ALL CONCRETE SHALL HAVE A MAXIMUM WATER CEMENT RATIO OF 0.4 FOR EXTERIOR CONCRETE ACCORDING TO ACI 318-11, TABLES 4.2.1 AND 4.3.1, AND A 0.15 MAX. WATER-SOLUBLE CHLORIDE ION CONTENT IN CONCRETE.

.....5000 PSI

-TEST: A MIN. OF 5 CONCRETE SPECIMENS SHALL BE TAKEN FROM EACH 50 CU. YD. OR PORTION THEREOF SPECIMENS SHALL BE TESTED ACCORDING TO A.S.T.M. C-39, ONE AT 3, ONE AT 7, AND 3 AT 28 DAYS.

-COVER:

CONCRETE DEPOSITED AGAINST THE GROUND:..... FORMED CONCRETE IN CONTACT WITH THE GROUND:....

STRUCTURAL STEEL:

-STRUCTURAL STEEL HAS BEEN DESIGNED IN ACCORDANCE WITH THE BUILDING CODE AND AISC SPECIFICATIONS NINTH EDITION. STRUCTURAL STEEL SHALL MEET THE FOLLOWING REQUIREMENTS UNLESS NOTED OTHERWISE ON THE DRAWINGS:

ASTM GRADE Fy ALL STANDARD STEEL SHAPES A36 ---- 36 KSI ANCHOR BOLTS A307 ----STRUCTURAL BOLTS A325 ----

-ALL WELDING SHALL BE IN ACCORDANCE WITH LATEST AWS CODE. ALL WELDS SHALL USE E70XX ELECTRODES SERIES LOW HYDROGEN ELECTRODES.

-WELDERS SHALL BE AWS CERTIFIED.

-PROVIDE ONE SHOP COAT OF RUST INHIBITING PAINT MIN. 3 ML. DRY FILM THICKNESS).

-ALL STEEL EXPOSED TO THE WEATHER SHALL BE HOT DIPPED GALVANIZED IN ACCORDANCE WITH ASTM A123 FOR MEMBERS AND ASTM A153 FOR CONNECTION ELEMENTS. THIS INCLUDES ALL STRUCTURAL STEEL USED TO SUPPORT MECHANICAL EQUIPMENT AND ALL ROOF BRACING AND OTHER STRUCTURAL MEMBERS.

-PLATES SHALL BE TOUCHED AFTER WELDING HAS TAKEN PLACE.

-ALL ANCHOR BOLTS/NUT SHALL BE A307 U.N.O. HEAD PLATE SHALL CONFORM TO ASTM-A36.

-NUTS SHALL BE HEAVY HEX

-DRILL OR PUNCH BOLT HOLES \mathcal{Y}_{6} " LARGER THAN BOLT DIAMETER.

-STRUCTURAL BOLTS CONNECTION TYPE SHALL BE SLIP CRITICAL CLASS A

-FINISH COLOR OF PAINT TO BE SELECTED BY THE OWNER AND APPLIED IN THE FIELD.

-ALL STEEL COLUMN TUBULAR SECTIONS TO FILLED SOLID W/ 2500 PSI FINE GROUT.

REINFORCING STEEL:

-REINFORCING BARS CONFORMING TO A.S.T.M. A-615 GRADE 60, INCLUDING COLUMN AND BEAM TIES.

-WELDED FIRE FABRIC CONFORMING TO A.S.T.M. A-185 AND SUPPORTED ON SLAB BOLSTERS SPACED AT 3'-0" O/C. -REINFORCING BARS REQUIRED TO BE WELDED SHALL CONFORM TO THE REQUIREMENTS OF ASTM A706 GRADE 60. WELDING OF REINFORCING OTHER THAN SPECIFIED IS PROHIBITED.

-MECHANICAL CONNECTORS SHALL BE IN ACCORD WITH ACI 439-3R-83.

-FABRICATION AND DETAILING ACCORDING TO A.C.I.-315.

-ALL ACCESSORIES TO HAVE UPTURNED LEGS AND BE PLASTIC DIPPED AFTER FABRICATION. THE CONTRACTOR SHALL INCLUDE IN HIS BASE BID THE COST

SHORING, RE-SHORING, AND TEMPORARY BRACING:


-ALL SHORING, RE-SHORING AND TEMPORARY BRACING REQUIRED IN THIS PROJECT IS TO BE DESIGNED BY FLORIDA PROFESSIONAL ENGINEER WHO SPECIALIZES IN FORM WORK/TEMPORARY BRACING DESIGN. AND WHO HAS BEEN HIRED BY THE GENERAL CONTRACTOR. THE GENERAL CONTRACTOR IS THE ULTIMATE RESPONSIBLE PARTY FOR SHORING, RE-SHORING, AND TEMPORARY BRACING REQUIRED ON THIS PROJECT AND MUST SATISFY HIMSELF WITH THE ADEQUACY OF THE INSTALLATION OF THESE ITEMS AT ALL TIMES. IN THE SPECIFIC CASE OF POURED SLABS IT IS HIGHLY RECOMMENDED THAT FROM THE SHORING DESIGNER OR HIS AGENT PRIOR TO THE PLACEMENT OF CONCRETE THE GENERAL CONTRACTOR SECURE A CERTIFICATION OF THE INSTALLED SHORING.


SAFETY OSHA AND LABOR LAWS.

sign And Drawings Are The Copyrighted Property Of Revuelta Architecture International P.A. and May Not Be Reproduced Except with actor Must Check And Verify all Dimensions Of The Job And Be Responsible For Same, Reporting Any Discrepancies to The Architects sloud: RAI - BIM Server_1 - BIMcloud Basic for ARCHICAD 22/1822_PARK AV/1822_PARK AV HOTEL - By surbina - Date: 3/4/2019

-THE STRUCTURE IS DESIGNED TO BE SELF-SUPPORTING AND STABLE AFTER THE BUILDING IS FULLY COMPLETED. IT IS THE CONTRACTOR'S SOLE RESPONSIBILITY TO DETERMINE ERECTION PROCEDURE AND SEQUENCE AND INSURE THE SAFETY OF THE BUILDING AND ITS COMPONENT PARTS DURING ERECTION. THIS INCLUDES THE ADDITION OF WHATEVER SHORING, TEMPORARY BRACING, ETC. THAT MAY BE NECESSARY. SUCH MATERIAL SHALL REMAIN THE CONTRACTOR'S PROPERTY AFTER COMPLETION OF THE PROJECT.

-THE STRUCTURAL ENGINEER OF RECORD DOES NOT POSSES, NOR PRESUMES TO POSSES ANY KNOWLEDGE OR EXPERTISE IN MATTERS TO JOB SITE EMPLOYEE SAFETY, OSHA OR LABOR LAE REQUIREMENTS FOR A CONSTRUCTION PROJECT. SAFETY AND COMPLIANCE WITH OSHA AND LABOR LAWS ARE THE ABSOLUTE RESPONSIBILITY OF THE GENERAL CONTRACTOR AND THOSE CONSULTANTS HE HIRES TO ADDRESS THESE MATTERS. THE STRUCTURAL ENGINEER OF RECORD SPECIALIZES IN STRUCTURAL DESIGN ONLY, AND THE BOARD OF PROFESSIONAL REGULATION FORBIDS HIM FROM ASSUMING RESPONSIBILITY OUTSIDE HIS AREA OF EXPERTISE

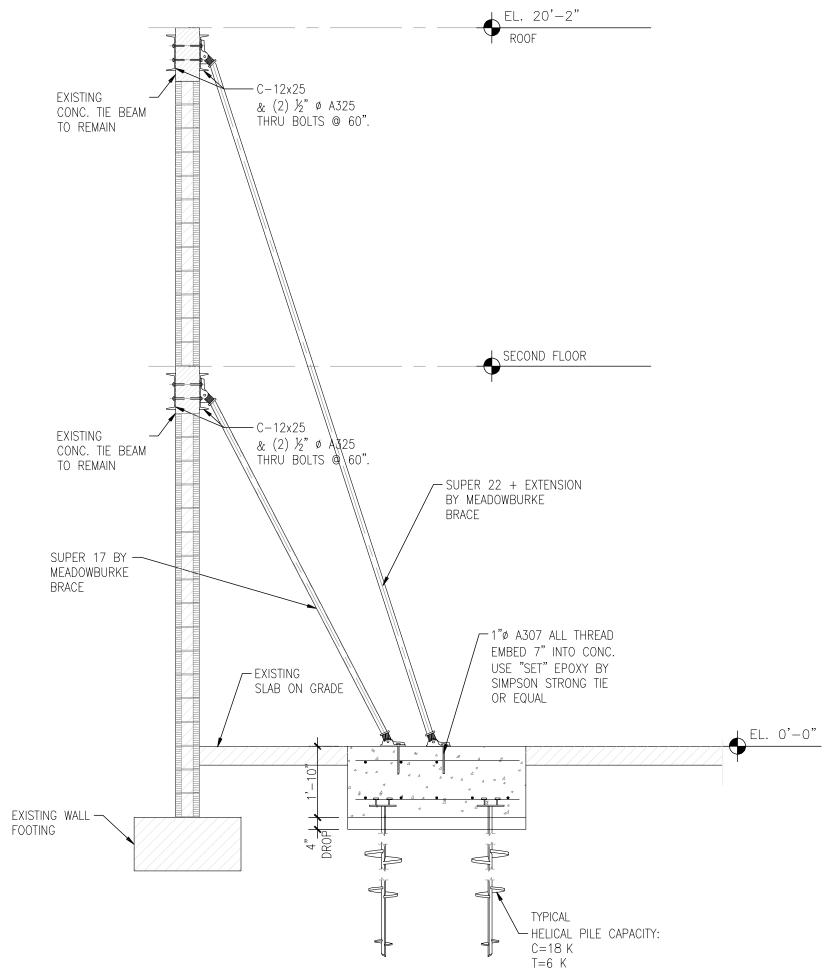

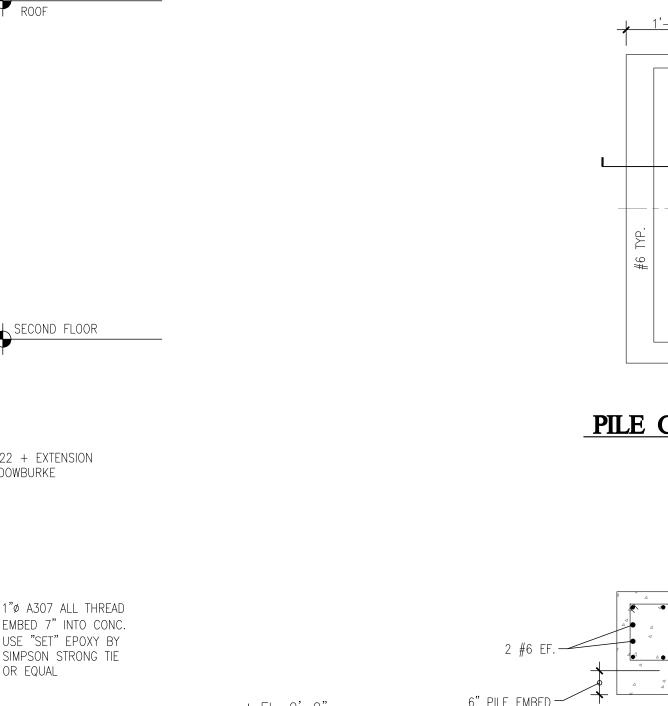

2

TYPICAL BRACING SECTION

revuelta architecture international

revuelta—architecture.com

2950 SW 27TH AVE. SUITE 110 MIAMI, FL 33133 T. 305.590.5000 F. 305.590.5040

PARK AVE, HOTEL

355 19th. Street
MIAMI BEACH, FLORIDA 33139

960 ARTHUR GODFREY Rd. #206 MIAMI BEACH, FLORIDA 33140


1.888.515.3107


Alexis Martinez, PE

SCHEMATIC PHASE

AS SHOWN

SHORING/BRACING PLANS SH-4.0

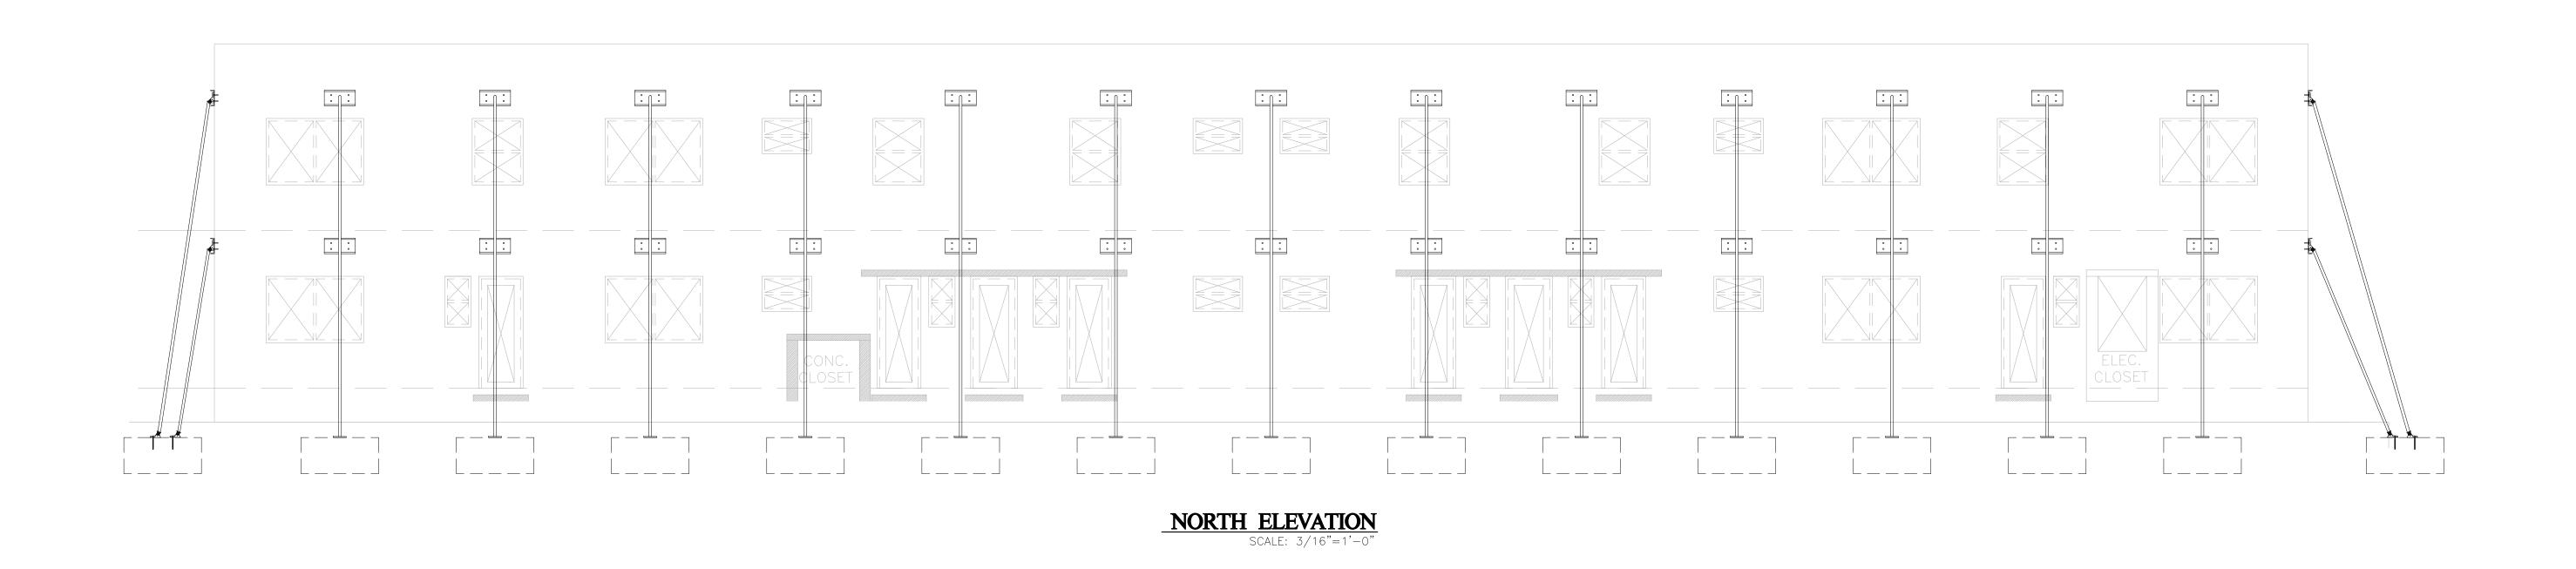

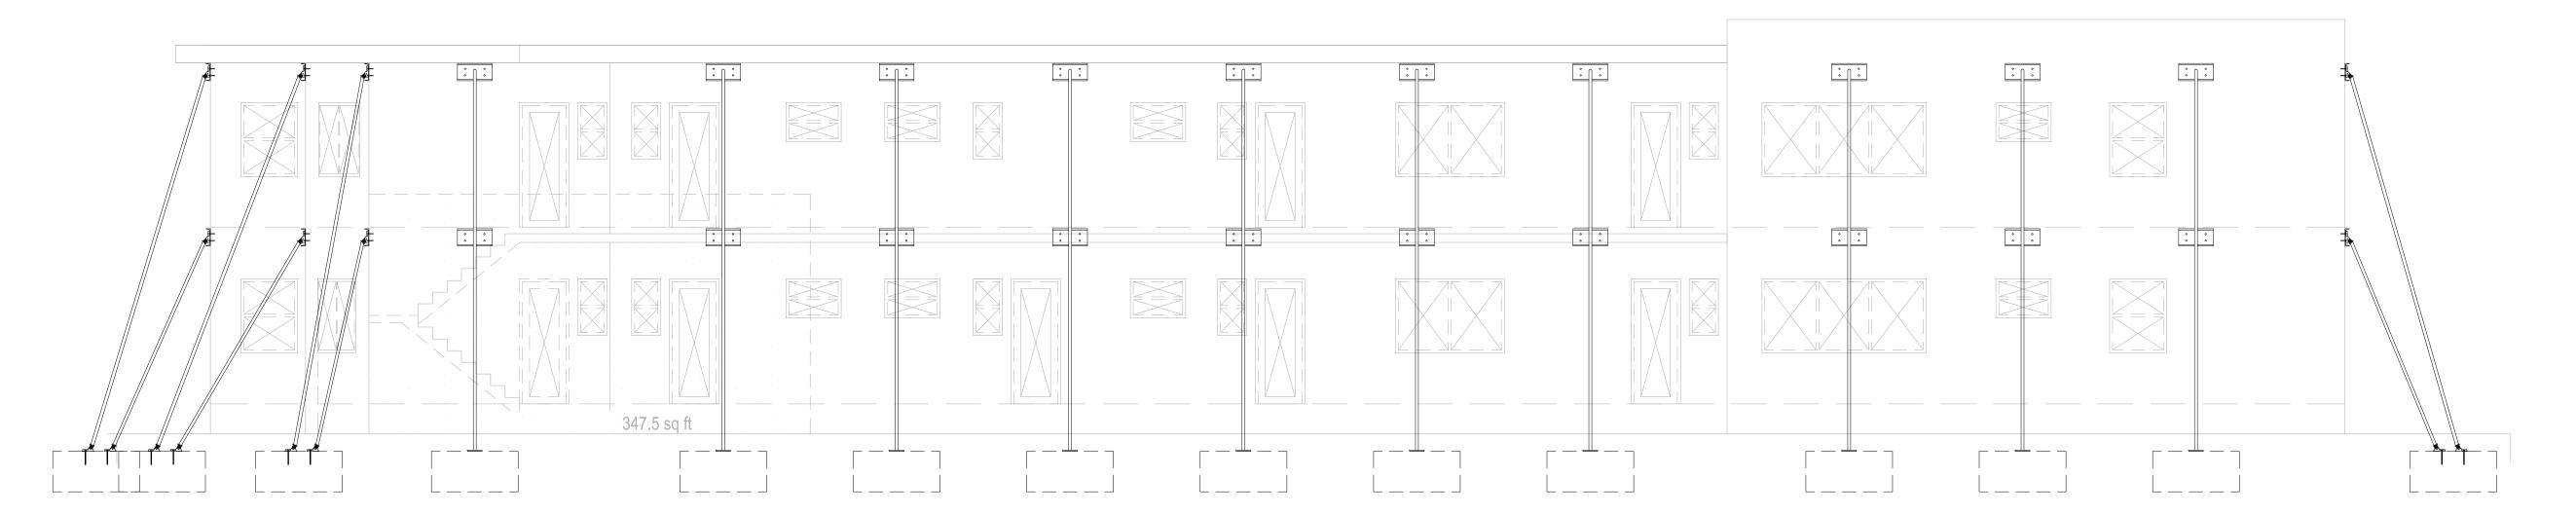

EAST ELEVATION
SCALE: 3/16"=1'-0"

revuelta architecture international Santiago, Chile revuelta—architecture.com 2950 SW 27TH AVE. SUITE 110 MIAMI, FL 33133 T. 305.590.5000 F. 305.590.5040 PARK

960 ARTHUR GODFREY Rd. #206 MIAMI BEACH, FLORIDA 33140


1.888.515.3107

Alexis Martinez, PE

SCHEMATIC PHASE

SHORING/BRACING PLANS

SH-5.0

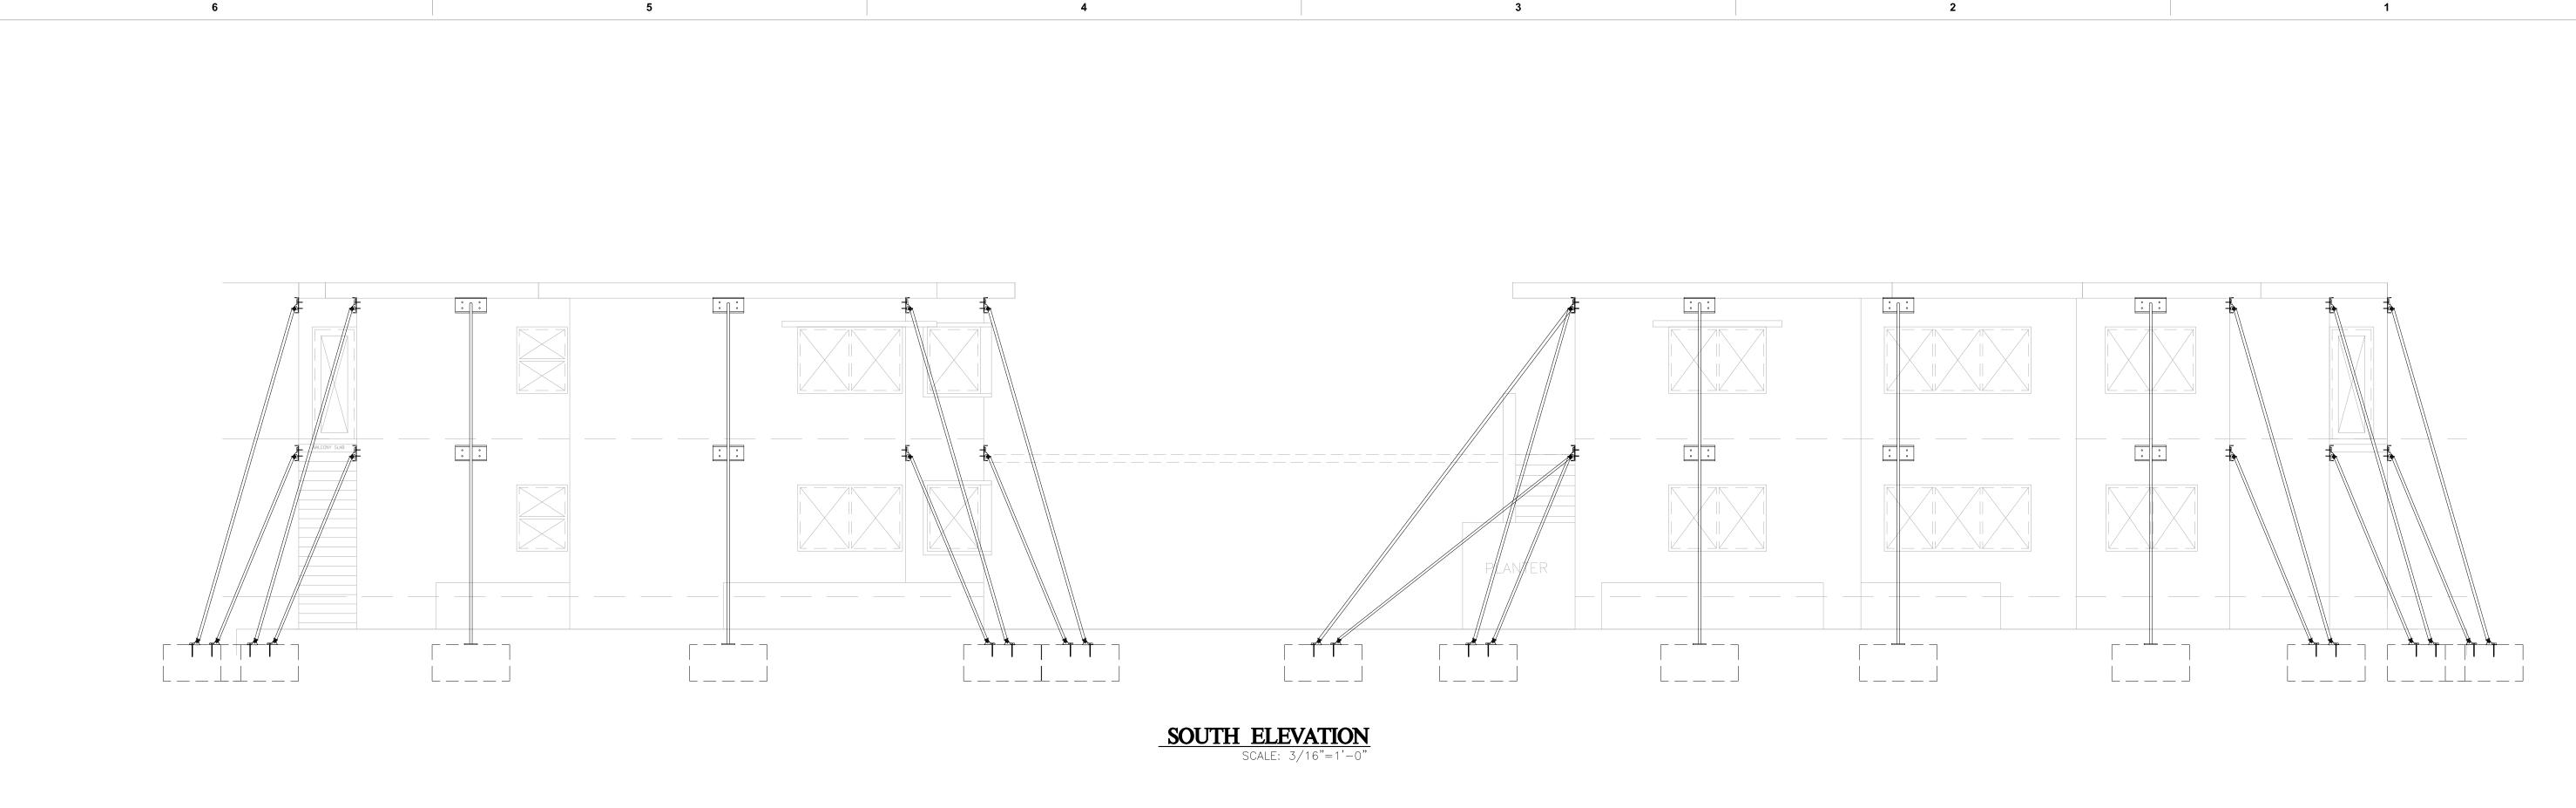

WEST ELEVATION
SCALE: 3/16"=1'-0"

These Design And Drawings Are The Copyrighted Property Of Revuelta Architecture International P.A. and May Not Be Reproduced Except with Specific Wri The Contractor Must Check And Verify all Dimensions Of The Job And Be Responsible For Same, Reporting Any Discrepancies to The Architects Before Con File: BIMcloud: RAI - BIM Server 1 - BIMcloud Basic for ARCHICAD 22/1822 PARK AV/1822 PARK AV HOTEL - By surbina - Date: 3/4/2019