4RCH D 36"x24"

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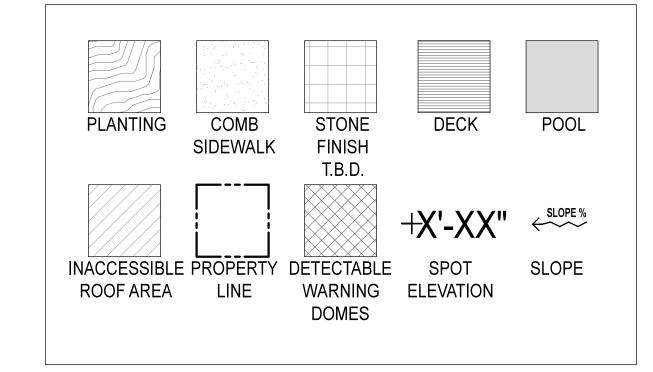
SCOPE OF WORK

●HARDSCAPE, LANDSCAPE, IRRIGATION, AND LANDSCAPE LIGHTING WITHIN THE PROPERTY LINE AND THE LANDSCAPE AND LANDSCAPE LIGHTING FOR THE R.O.W.

GENERAL SITE NOTES

- GENERAL CONTRACTOR, SUBCONTRACTORS, AND INSTALLERS SHALL CROSS REFERENCE ARCH, DWGS, ENGINEERING DWGS, AND LANDSCAPE DWGS, THROUGHOUT THE IMPLEMENTATION TO ENSURE THE DESIGN INTENT IS MET. ANY DISCREPANCIES SHALL BE NOTED AND BROUGHT TO THE GENERAL CONTRACTOR'S ATTENTION.
- SEE CIVIL AND ARCHITECTURE DRAWINGS FOR F.F.E & SURFACE DRAINAGE
- SEE MEP AND CIVIL DRAWINGS FOR IRRIGATION CONNECTIONS.
- SEE STRUCT. ENG. DRAWINGS FOR STRUCTURAL COMPONENTS.
- SEE ELECTRICAL ENG. DRAWINGS FOR LANDSCAPE LIGHTING WIRING.
- ALL WORK, MATERIALS, AND EQUIPMENT UTILIZED IN THIS PROJECT SHALL BE INSTALLED IN STRICT ACCORDANCE WITH THE GOVERNING ZONING & BUILDING CODE, MANUFACTURER'S RECOMMENDATIONS, AND SPECIFICATIONS.
- CONTRACTOR SHALL BE RESPONSIBLE FOR VISITING SITE PRIOR TO BIDDING IN ORDER TO FAMILIARIZE THEMSELVES WITH ALL EXISTING CONDITIONS AFFECTING THE WORK, INCLUDING BUT NOT LIMITED TO PRIVATE AND PUBLIC UTILITIES, ON AND OFF SITE, ACCESS ROADS, AND OTHER SUPPORT FACILITIES.
- CONTRACTOR MUST NOTIFY LANDSCAPE ARCHITECT IMMEDIATELY OF ANY UNEXPECTED OR UNKNOWN CONDITIONS OR DISCREPANCIES IN THE DRAWINGS AND CONTRACT DOCUMENTS, AS WELL AS ANY ERRORS OR OMISSIONS ON THE DRAWINGS PRIOR TO PROCEEDING WITH THE WORK OR SHOP FABRICATION.
- CONTRACTOR SHALL PREPARE AND MAINTAIN ALL CONSTRUCTION AREAS, AS WELL AS SURROUNDING AREAS FREE OF DEBRIS OR HAZARDOUS EQUIPMENT AT ALL TIMES.

GRAPHIC LEGEND



PROJECT

TORINO GARAGE

400 COLLINS AVE., MIAMI BEACH, FL 33139 Savoy Hotel Partners, LLC c/o Allied Partners 770 Lexington Ave 17th Floor New York, NY 10065-8165

Architect: Brandon Haw Architecture LLP 375 Park Avenue, Suite 3308 New York, NY 10152 License # AA26003249

CONSULTANTS

Structural Engineer: DeSimone 800 Brickell Avenue, 6th Floor Miami, FL 33131 **MEP Engineer:**

Miami, FL 33137-3737 Civil Engineer:

3915 Biscayne Blvd, Suite 401

VSN Engineering, Inc. 8660 W. Flagler Street, Suite 113 Miami, FL 33144

Geo-tech Engineer:

Langan 15150 NW 79th Court, Suite 200 Miami Lakes, FL 33016-5848

Life Safety Consultant: SLS Consulting, Inc.

260 Palermo Avenue Coral Gables, FL 33134

Parking Consultant: Timothy Haahs & Associates, Inc. 40 NW 3rd Street, Suite 1102 Miami, FL 33128

Elevator Consultant: Van Deusen & Associates, Inc. 8201 Peters Road, Suite 1000 Plantation, FL 33324

Acoustic Consultant: Electro-Media Design, Ltd. 973-C Russell Avenue Gaithersburg, MD 20879 Landscape Architect: Naturalficial, Inc.

6915 Red Road, Suite 224 Coral Gables, FL 33143 Contact: Andres Arcila O: 786.717.6564 / M: 305.321.2341 Firm Reg. No. LC26000548

NO. DESCRIPTION

DATE OF ISSUE	DRAWN BY
04/15/2019	PS & AR


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PROJECT NO. & TITLE

Project Title TORINO GARAGE

PROJECT STATUS


FINAL HISTORIC PRESERVATION BOARD SUBMITTAL

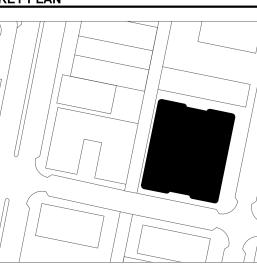

SCALE & ORIENTATION




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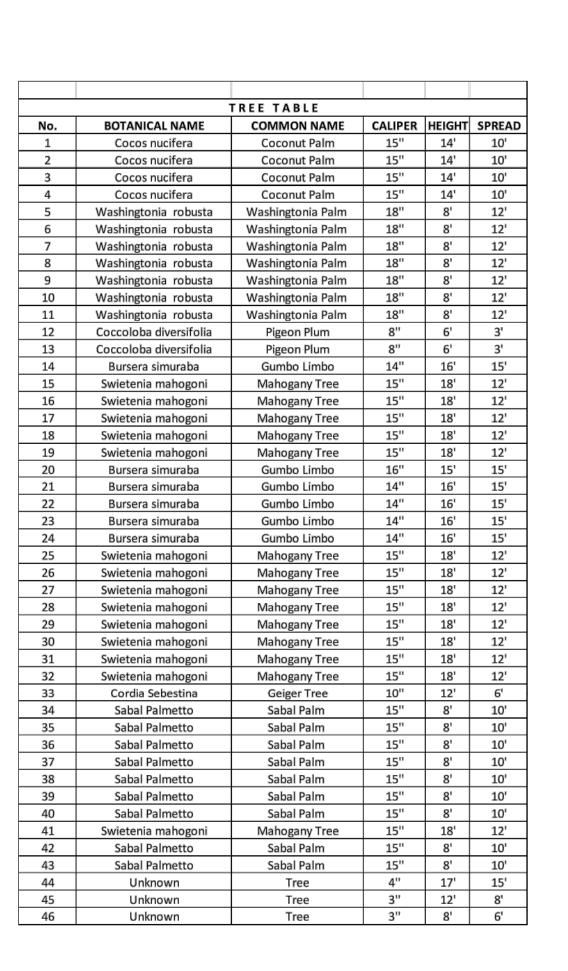


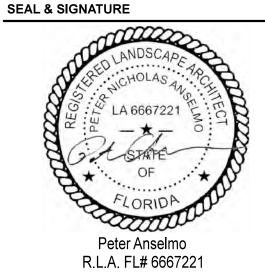
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COVER SHEET & NOTES



MAP OF TOPOGRAPHIC SURVEY

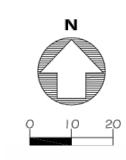

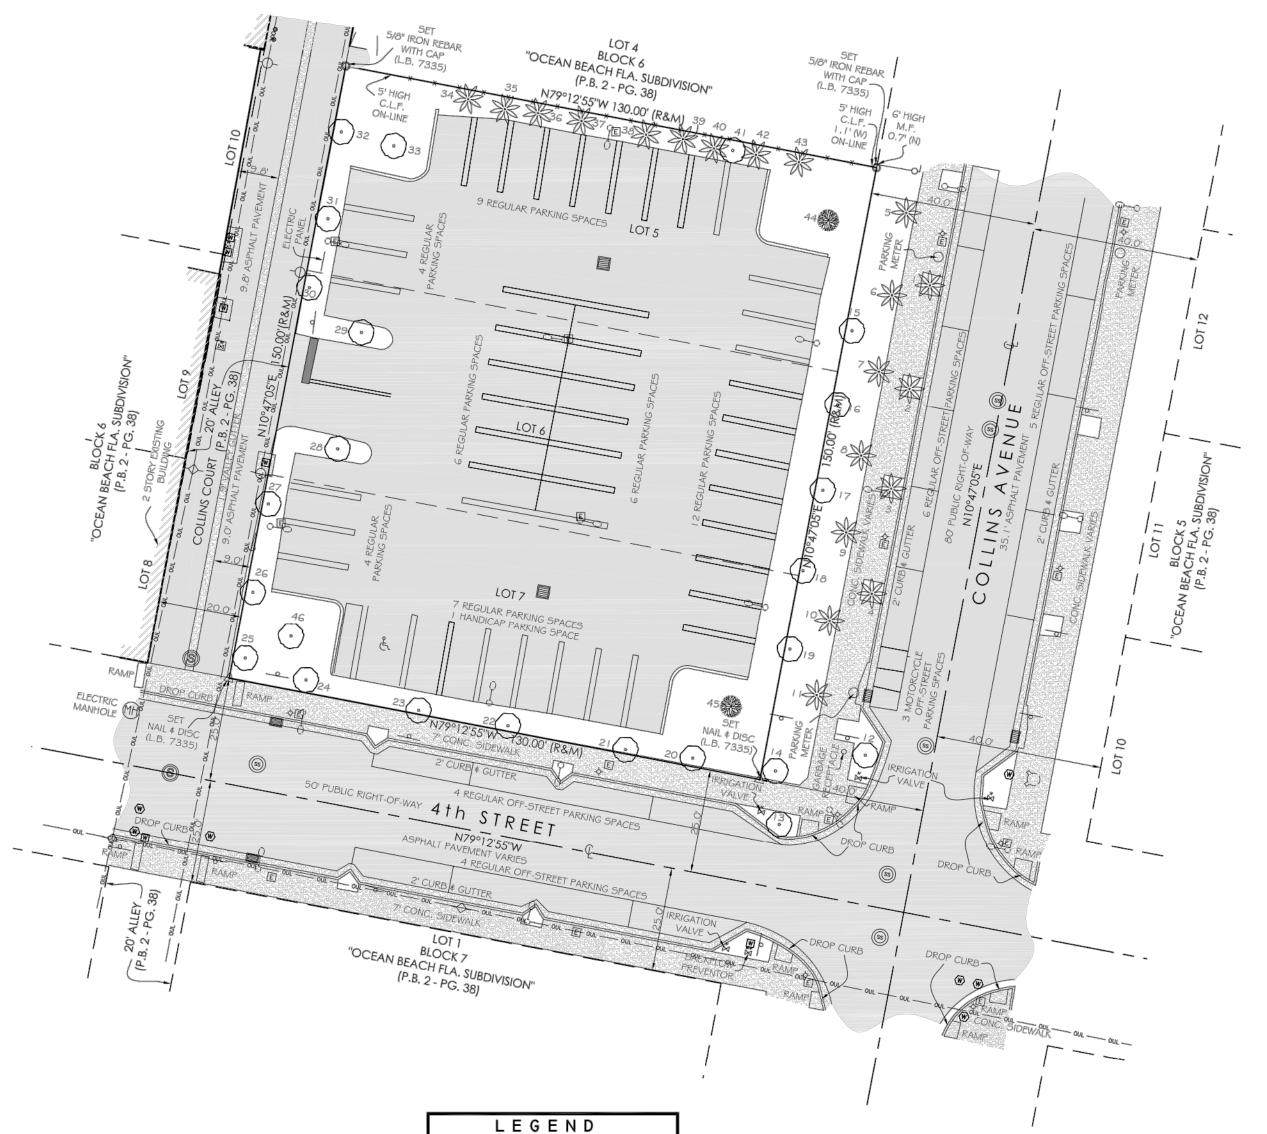

= CONCRETE = CALCULATED

C.B.S. = CONCRETE BLOCK STUCCO = AIR CONDITIONING UNIT

= CENTERLINE = SEWER VALVE = PLAT BOOK

= PAGE M.F. = METAL FENCE = WOOD POWER POLE = METAL FENCE

= GUY ANCHOR = RADIUIS = CATCH BASIN = WATER VALVE = WATER METER

= SEWER VALVE = FIRE HYDRANT = TEMPORARY SITE BENCHMARK = ELECTRIC BOX

= SANITARY SEWER MANHOLE = SIGN -

₩ = PALM - oul - OVERHEAD WIRE ELEV. = ELEVATION

= TREE


O-O = METAL LIGHT POLE = ORNAMENTAL LIGHT POLE

= SPOT ELEVATION

= STORM DRAINAGE MANHOLE = BQLLARD

LYING AND BEING IN THE CITY OF MIAMI BEACH,

SECTION 3 TOWNSHIP 54 SOUTH - RANGE 42 EAST

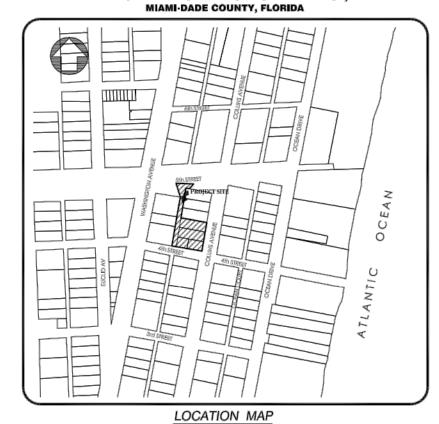

SURVEYOR'S REPORT:

The date of completion of the original field Survey was on <u>June 30, 2013</u> and Updated on <u>May 01, 2015.</u>

Lots 5, 6, 7 and the 20 foot Alley (Collins Court), in Block 6, of "OCEAN BEACH SUBDIVISION", according to the Plat thereof, as recorded in Plat Book 2, Page 38, of the Public Records of Miami-Dade County, Florida.

Containig 19,500 Square Feet or 0.45 Acres, more or less, by calculations.

ACCURACY:

The accuracy obtained by field measurement methods and office calculations of closed geometric figures meets and exceeds the Minimum Technical Standards requirement for Commercial / High Risk Area (Linear: 1 foot in 10,000 feet) as defined in Rule 5J-17.051, Florida Administrative Code.

Well identified features as depicted on the Survey Map were measured to an estimated horizontal position

This Map of Survey is intended to be displayed at a scale of One inch equals Twenty feet or smaller.

PERTINENT INFORMATION USED FOR SURVEY:

North arrow direction is based on an assumed Meridian.

Bearings as shown hereon are based upon the centerline of Collins Avenue with an assumed bearing of

This property appears to be located in a Flood Zone "AE" with a Base Flood Elevation being 8.0 feet, as per Federal Emergency Management Agency (FEMA) Community-Panel Number 120651 (City of Miami Beach), Map No. 0319, Suffix L, Map Revised Date: September 11, 2009.

Florida Department of Transportation Right-of-Way Map Section 87060 S.R. A1A.

Since no other information were furnished other than that is cited under pertinent information, the Client is hereby advised that there may be legal restrictions on the Subject Property that are not shown on the Survey Map that may be found in the Public Works Department of Miami-Dade County, Florida.

individual who may appear of Public Records of this County.

No excavation or determination was made as to how the Subject Property is served by utilities.

No improvements were located, other than those shown. No underground foundations, improvements and/or utilities were located or shown hereon.

The purpose of this survey is for Design.

CLIENT INFORMATION:

This Topographic Survey was prepared at the insistence of and certified to:

SURVEYOR'S CERTIFICATE:

I hereby certify: That this "Topographic Survey" and the Survey Map resulting therefrom was performed under my direction and is true and correct to the best of my knowledge and belief and further, that said "Topographic Survey" meets the intent of the applicable provisions of the "Minimum Technical Standards for Land Surveying in the State of Florida", pursuant to Rule 5J-17.051 through 5J-17.052 of the Florida Administrative Code and its

LONGITUDE SURVEYORS LLC., a Florida Limited Liability Corporation Florida Certificate of Authorization Number LB7335

Eduardo M Suarez, PSM Signature Date: Registered Surveyor and Mapper LS6313

NOTICE: Not valid without the signature and original raised seal of a Florida Licensed Surveyor and Mapper. Additions or deletions to Survey Maps by other than the signing party are prohibited without the written consent of

DATE OF FIELD SURVEY:

Property Address: 400 Collins Avenue, Miami Beach, Florida 33139

Folio No. 02-4203-003-0800

N10°47'05"E, said line to be considered a well established and monumented line.

Plat of "OCEAN BEACH FLA. SUBDIVISION" recorded in Plat Book 2 at Page 38 of the Public Records of Miami-Dade

The Surveyor makes no representation as to ownership or possession of the Subject Property by any entity or

PURPOSE OF SURVEY:

Shulman & Associates

implementing law, Chapter 472.027 of the Florida Statutes.



8290 N.W. 64TH STREET MIAMI, FLORIDA 33166 PHONE:(305)463-0912 FAX:(305)513-5680 WWW.LONGITUDESURVEYORS.COM

JOB NO.: 14297 FIELD BOOK: EFB

DRAWN BY: RE SHEET 1 OF 1

THIS SURVEY IS FOR REFERENCE ONLY. BY LONGITUDE SURVEYORS. NFI NOT RESPONSIBLE FOR INACCURATE INFORMATION ON THE CORRESPONDING

ORIGINAL BOUNDARY SURVEY PERFORMED PLAN.

TORINO GARAGE

400 COLLINS AVE., MIAMI BEACH,

Savoy Hotel Partners, LLC 770 Lexington Ave 17th Floor New York, NY 10065-8165

Brandon Haw Architecture LLP 375 Park Avenue, Suite 3308 New York, NY 10152

License # AA26003249 CONSULTANTS

Structural Engineer: 800 Brickell Avenue, 6th Floor

Miami, FL 33131 **MEP Engineer:**

3915 Biscayne Blvd, Suite 401 Miami, FL 33137-3737

Civil Engineer: VSN Engineering, Inc. 8660 W. Flagler Street, Suite 113

Miami, FL 33144

Geo-tech Engineer:

15150 NW 79th Court, Suite 200

Miami Lakes, FL 33016-5848 Life Safety Consultant: SLS Consulting, Inc.

260 Palermo Avenue Coral Gables, FL 33134 Parking Consultant:

Timothy Haahs & Associates, Inc. 40 NW 3rd Street, Suite 1102 Miami, FL 33128 **Elevator Consultant:**

Van Deusen & Associates, Inc. 8201 Peters Road, Suite 1000 Acoustic Consultant: Electro-Media Design, Ltd. 973-C Russell Avenue Gaithersburg, MD 20879

Landscape Architect: Naturalficial, Inc. 6915 Red Road, Suite 224 Coral Gables, FL 33143 Contact: Andres Arcila O: 786.717.6564 / M: 305.321.2341


Firm Reg. No. LC26000548 DESCRIPTION

DATE OF ISSUE DRAWN BY PS & AR 04/15/2019

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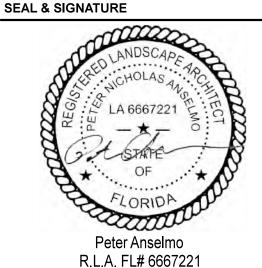
Project Title TORINO GARAGE PROJECT STATUS FINAL HISTORIC PRESERVATION

BOARD SUBMITTAL

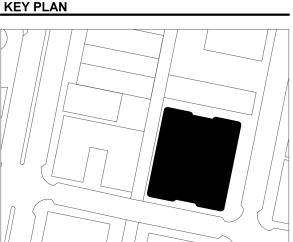


SCALE & ORIENTATION





DRAWING TITLE L-0.01

EXISTING TREE SURVEY

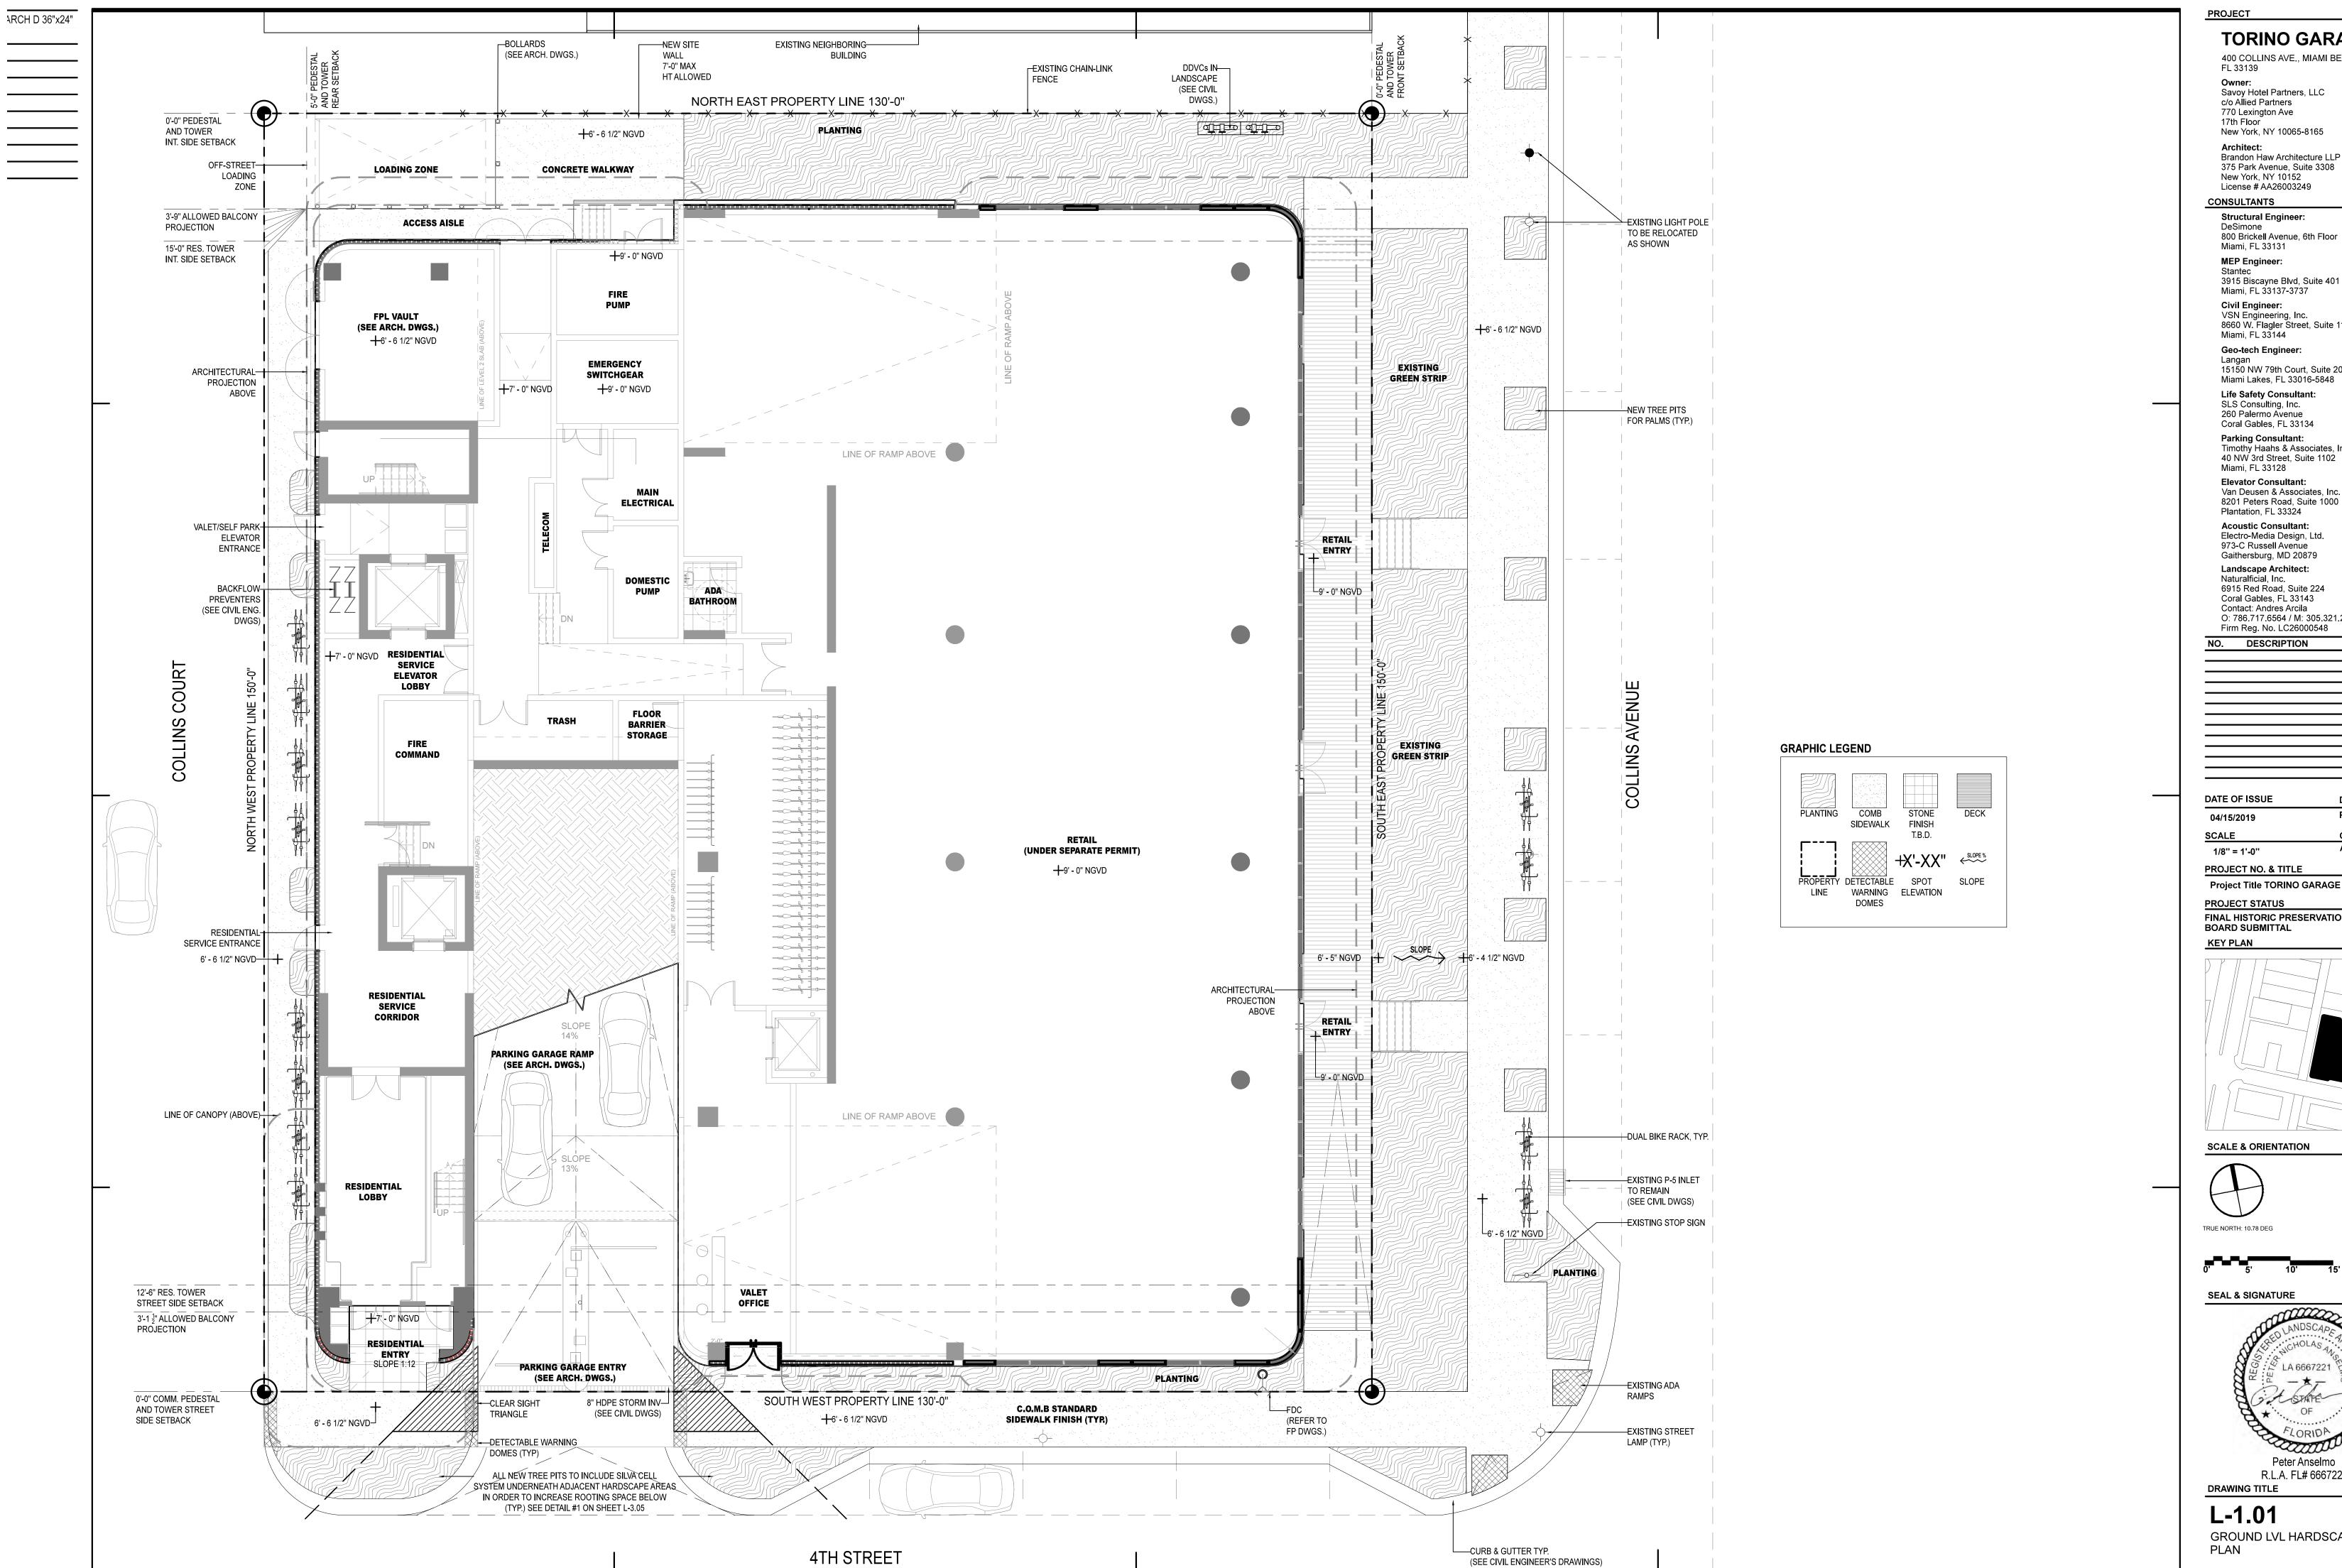

TORINO GARAGE

400 COLLINS AVE., MIAMI BEACH, FL 33139 Owner:

Savoy Hotel Partners, LLC c/o A**l**lied Partners 770 Lexington Ave 17th Floor New York, NY 10065-8165

Architect: Brandon Haw Architecture LLP 375 Park Avenue, Suite 3308 New York, NY 10152 License # AA26003249

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Miami Lakes, FL 33016-5848

Life Safety Consultant: SLS Consulting, Inc. 260 Palermo Avenue

Coral Gables, FL 33134 Parking Consultant: Timothy Haahs & Associates, Inc.

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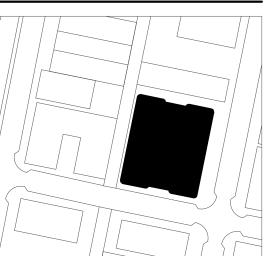
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PROJECT NO. & TITLE Project Title TORINO GARAGE

PROJECT STATUS

FINAL HISTORIC PRESERVATION BOARD SUBMITTAL

KEY PLAN




SCALE & ORIENTATION



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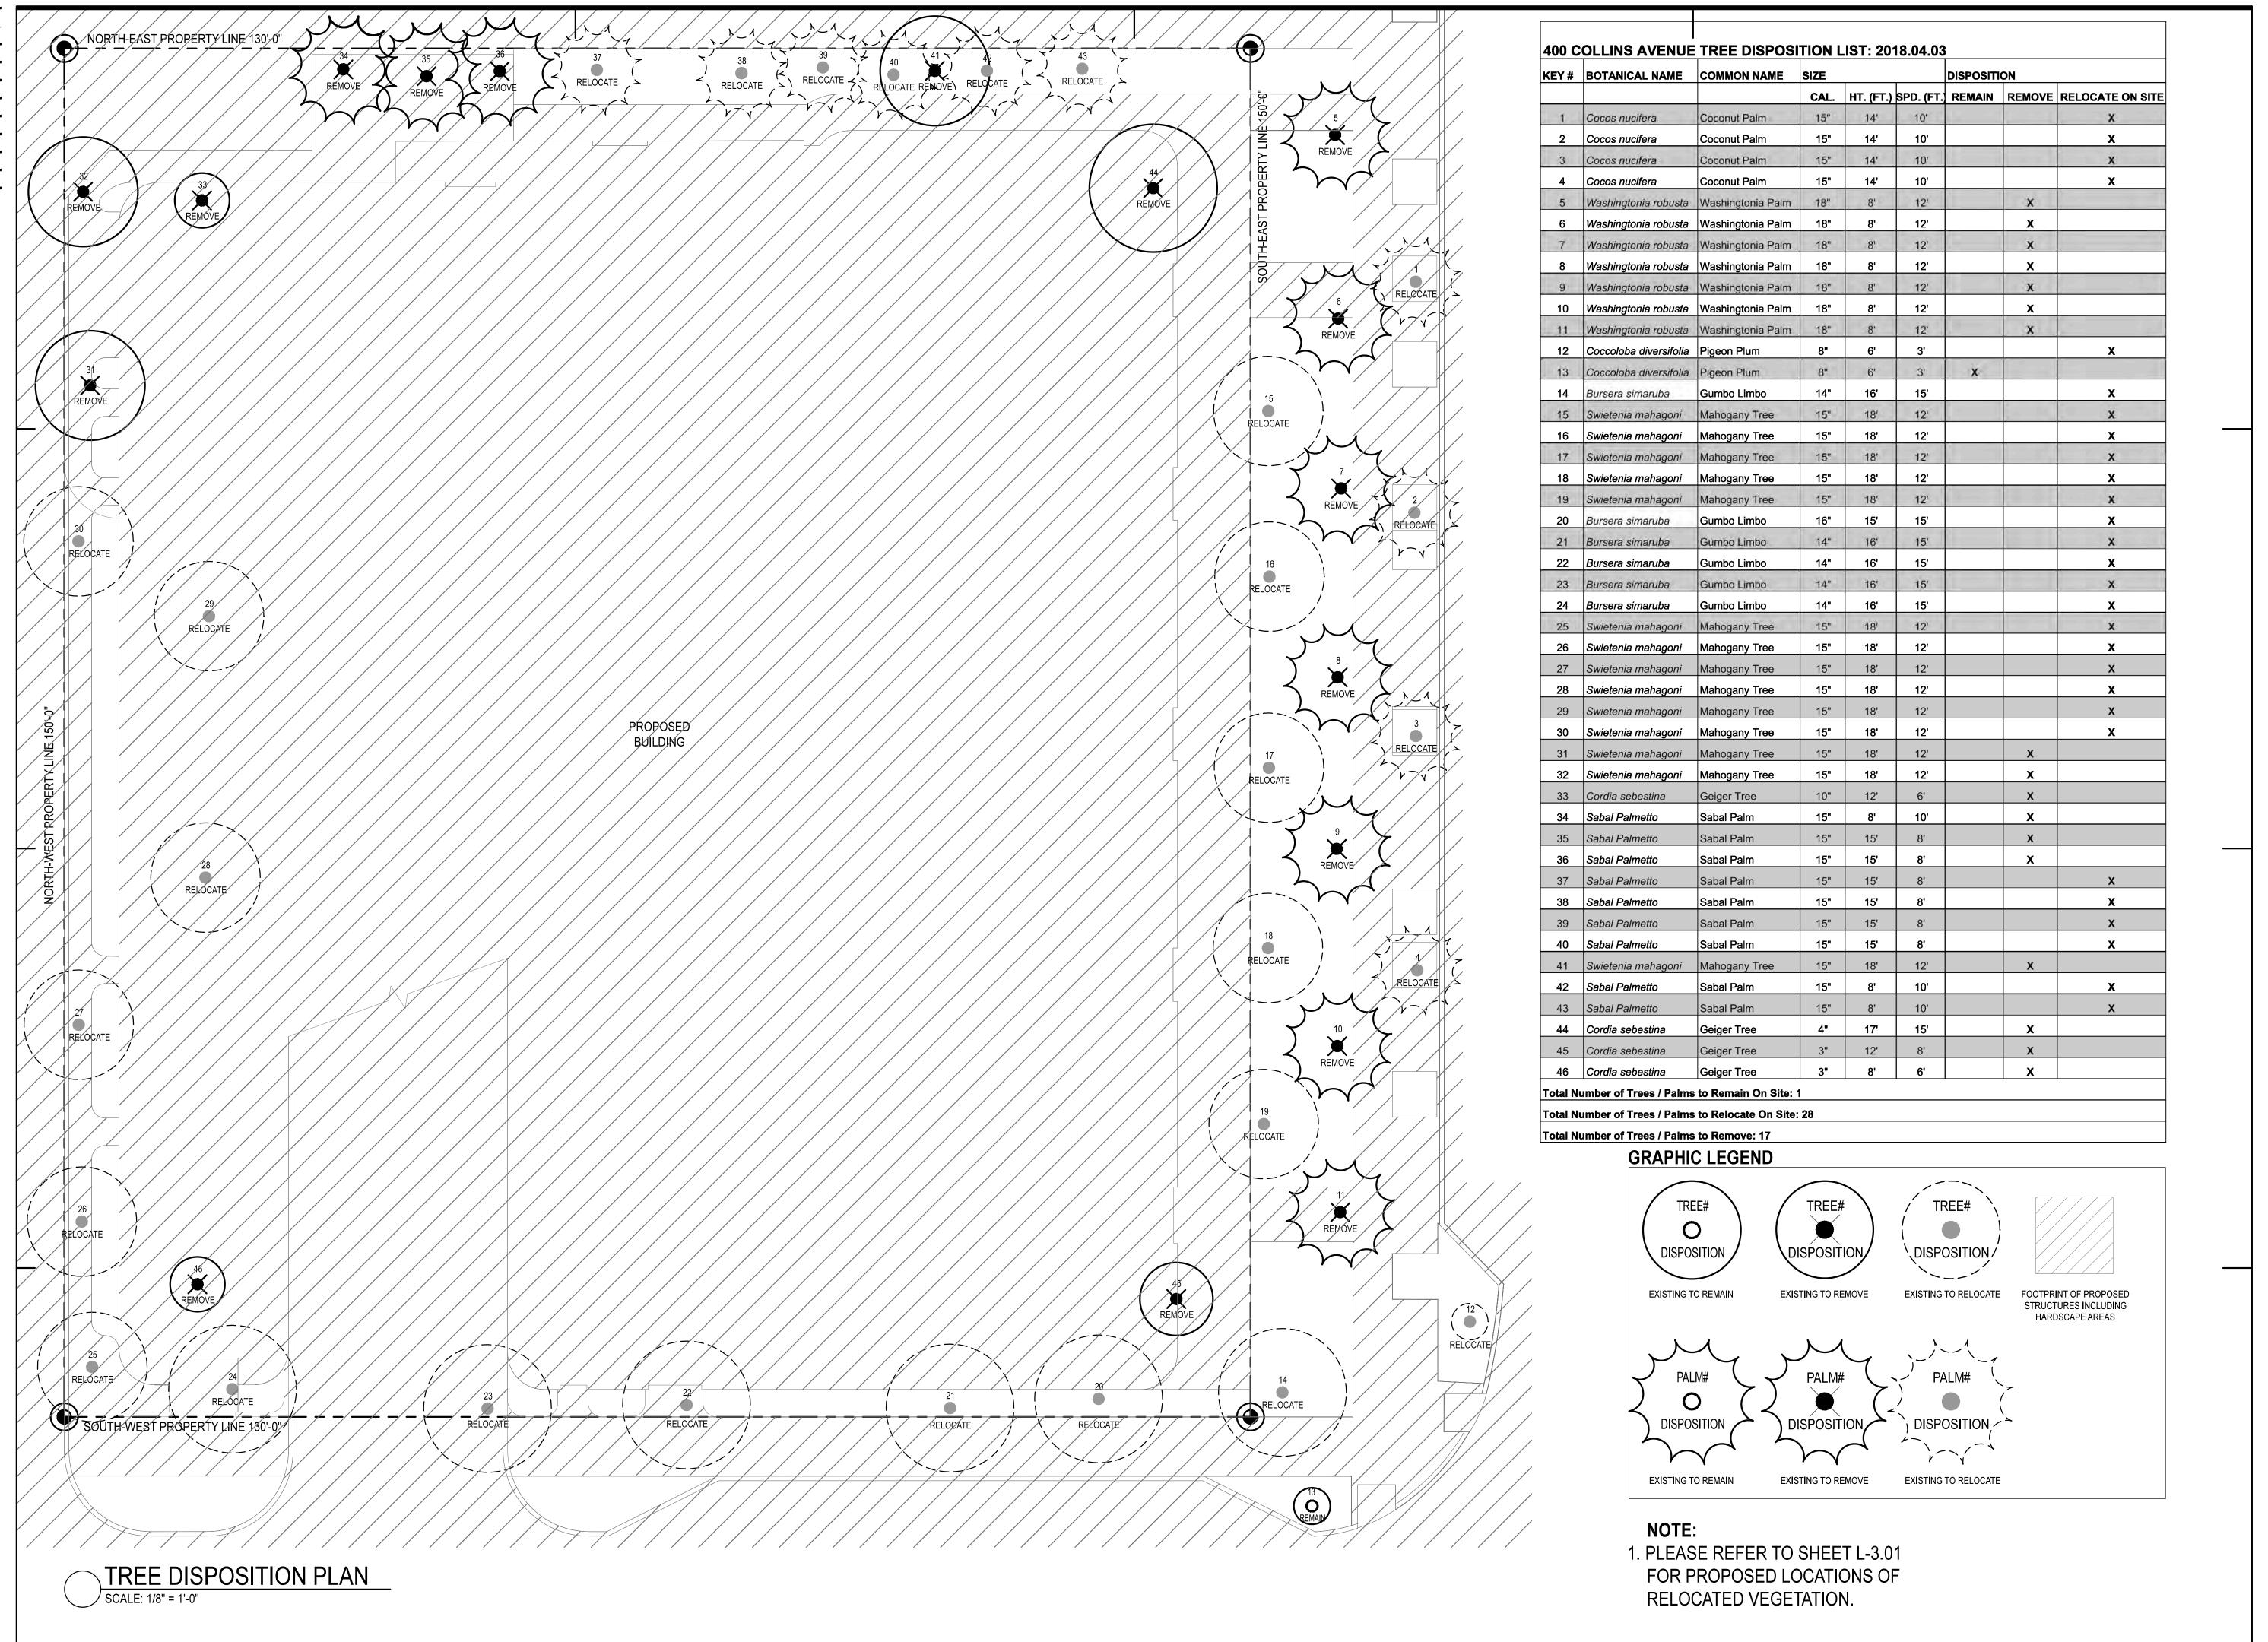


SEAL & SIGNATURE

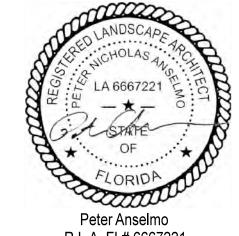

R.L.A. FL# 6667221 DRAWING TITLE

L-1.01 GROUND LVL HARDSCAPE



TORINO GARAGE

400 COLLINS AVE., MIAMI BEACH, Savoy Hotel Partners, LLC c/o Allied Partners 770 Lexington Ave 17th Floor

New York, NY 10065-8165 Architect: Brandon Haw Architecture LLP 375 Park Avenue, Suite 3308 New York, NY 10152

License # AA26003249 CONSULTANTS

Structural Engineer: DeSimone 800 Brickell Avenue, 6th Floor Miami, FL 33131

MEP Engineer: 3915 Biscayne Blvd, Suite 401

Miami, FL 33137-3737 Civil Engineer:

VSN Engineering, Inc. 8660 W. Flagler Street, Suite 113 Miami, FL 33144

Geo-tech Engineer:

Langan 15150 NW 79th Court, Suite 200

Miami Lakes, FL 33016-5848

Life Safety Consultant: SLS Consulting, Inc. 260 Palermo Avenue

Coral Gables, FL 33134 Parking Consultant:

Timothy Haahs & Associates, Inc. 40 NW 3rd Street. Suite 1102 Miami, FL 33128

Elevator Consultant: Van Deusen & Associates, Inc. 8201 Peters Road, Suite 1000 Plantation, FL 33324

Acoustic Consultant: Electro-Media Design, Ltd. 973-C Russell Avenue Gaithersburg, MD 20879 Landscape Architect: Naturalficial, Inc.

6915 Red Road, Suite 224 Coral Gables, FL 33143 Contact: Andres Arcila O: 786.717.6564 / M: 305.321.2341 Firm Reg. No. LC26000548

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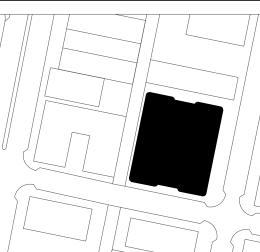
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1/8" = 1'-0" PROJECT NO. & TITLE

Project Title TORINO GARAGE

PROJECT STATUS FINAL HISTORIC PRESERVATION BOARD SUBMITTAL

KEY PLAN



SCALE & ORIENTATION



TRUE NORTH: 10.78 DEG




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R.L.A. FL# 6667221 **DRAWING TITLE**

TREE DISPOSITION PLAN

L-3.00



TORINO GARAGE

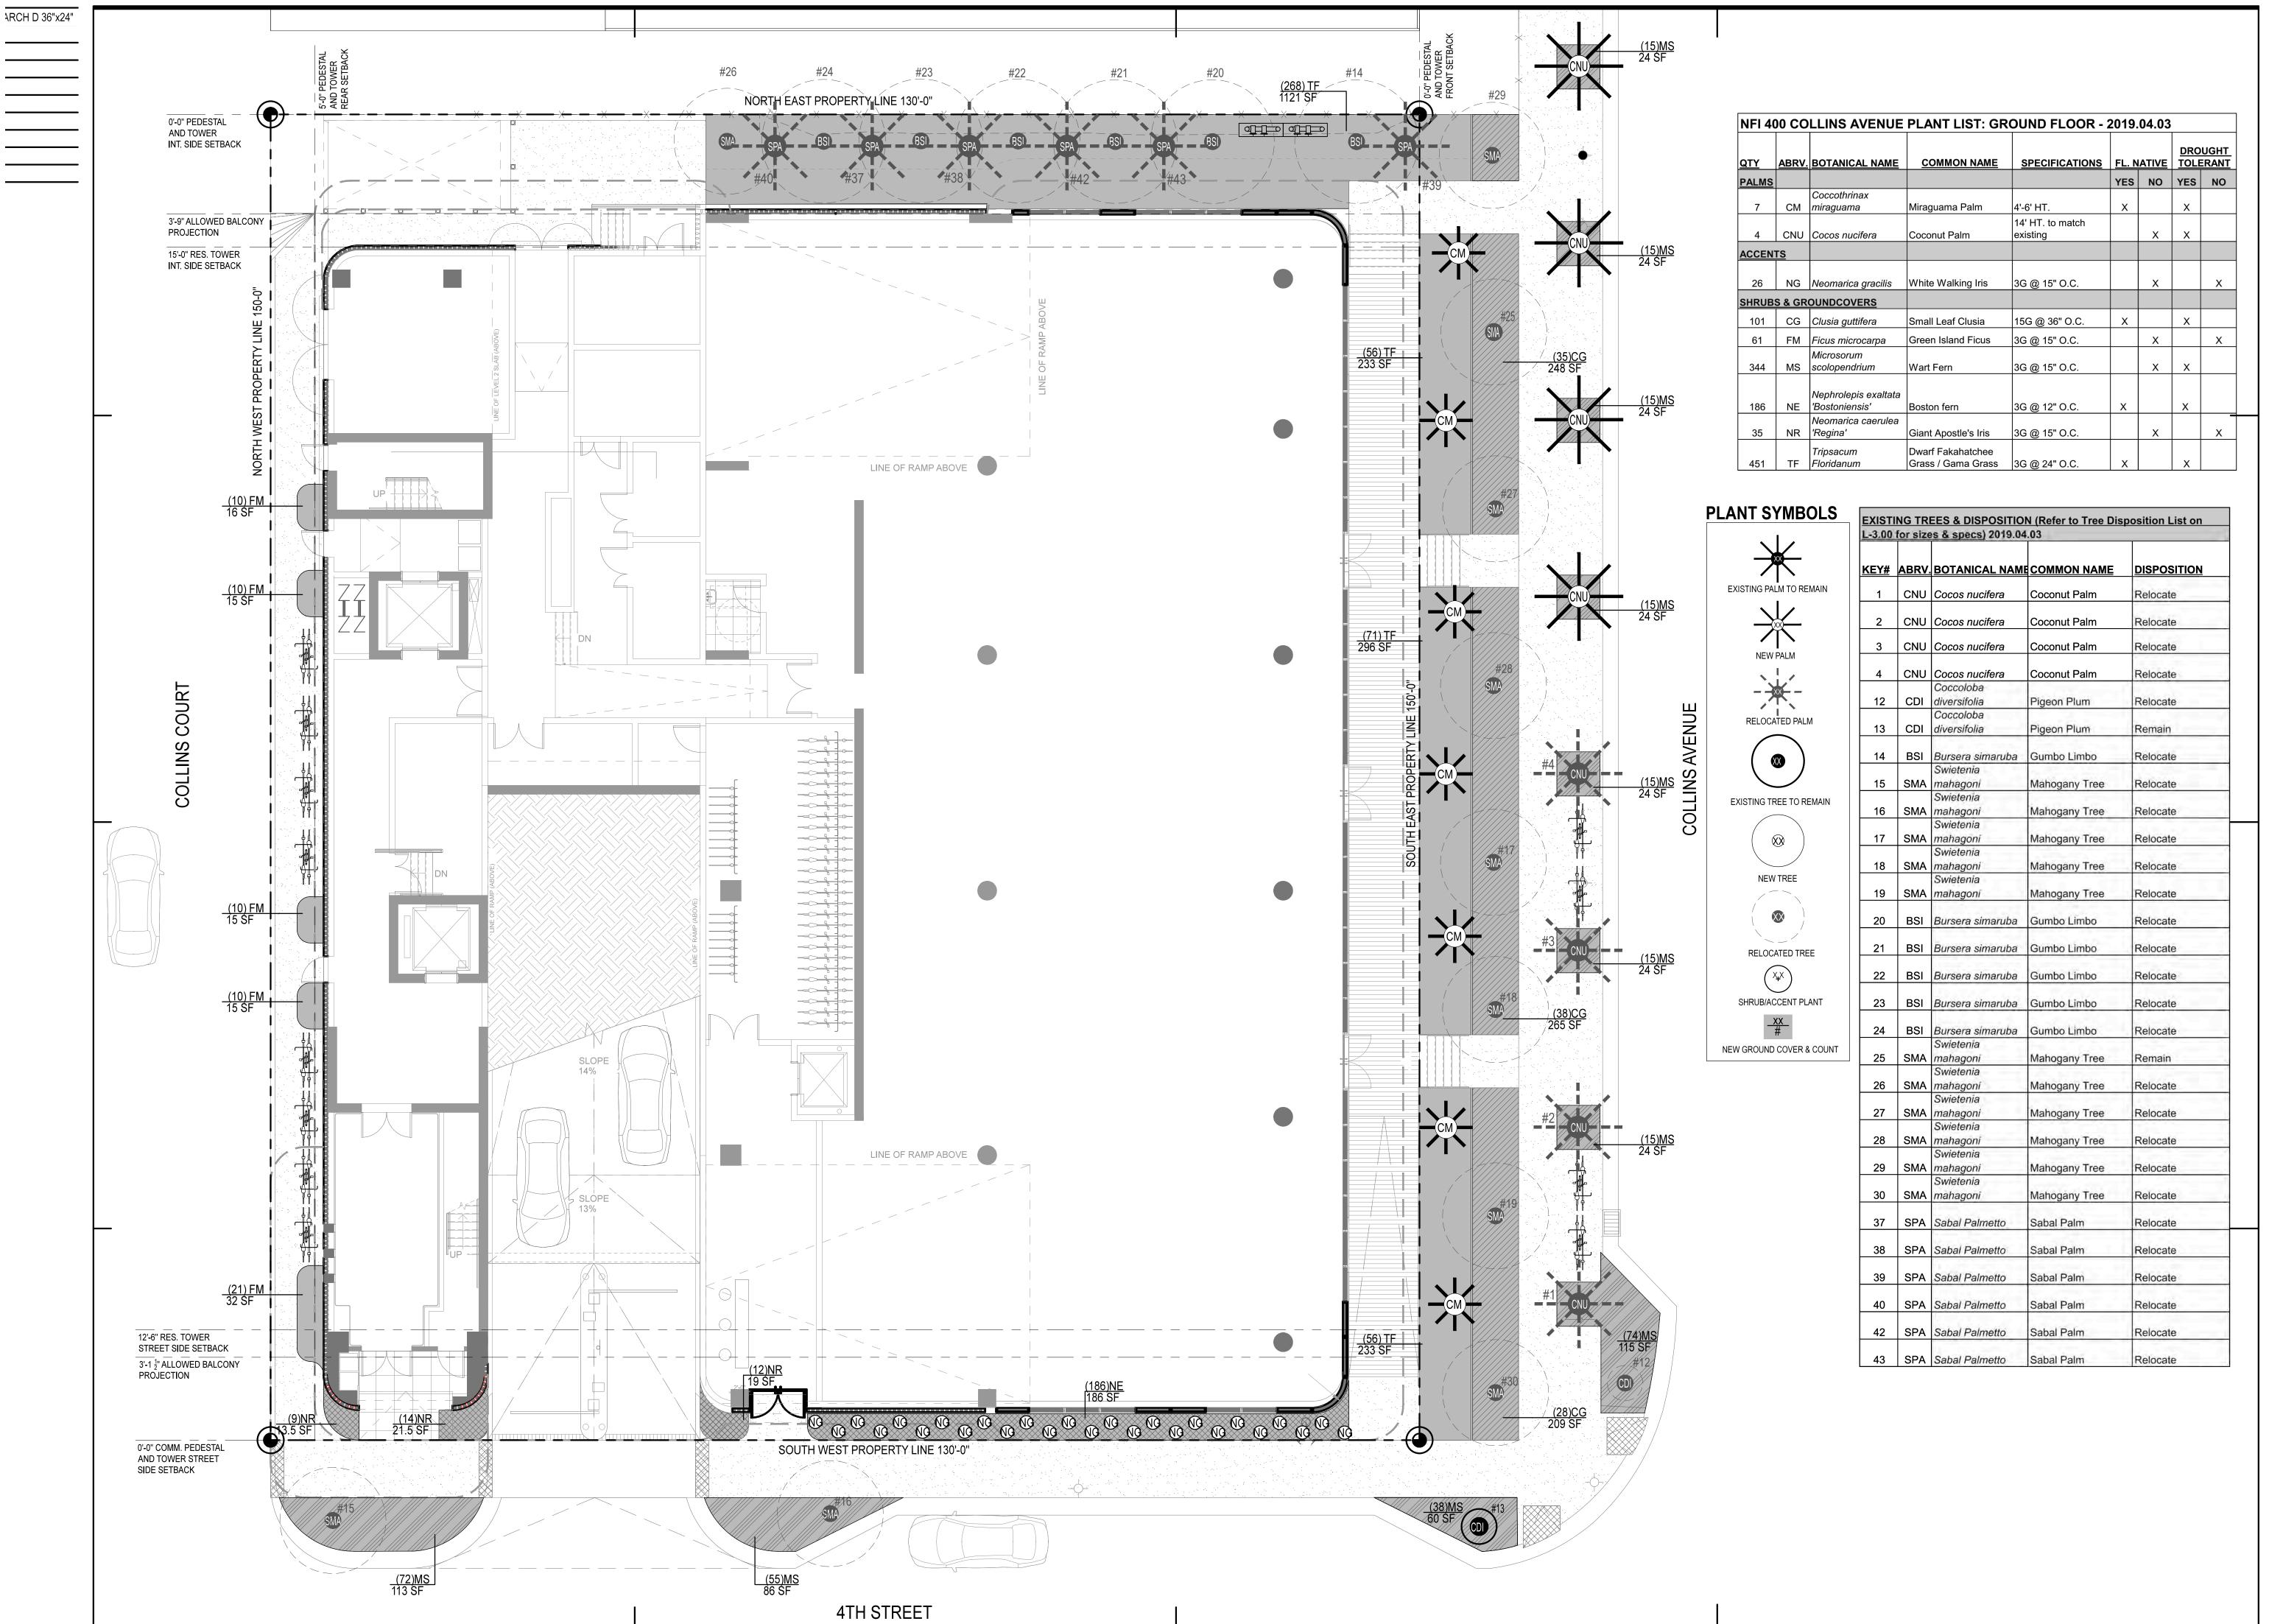400 COLLINS AVE., MIAMI BEACH, FL 33139

Owner:
Savoy Hotel Partners, LLC c/o Allied Partners
770 Lexington Ave
17th Floor

New York, NY 10065-8165

Architect:
Brandon Haw Architecture LLP
375 Park Avenue, Suite 3308
New York, NY 10152

License # AA26003249 CONSULTANTS

Structural Engineer: DeSimone 800 Brickell Avenue, 6th Floor Miami, FL 33131

MEP Engineer: Stantec 3915 Biscayne Blvd, Suite 401

Miami, FL 33137-3737

Civil Engineer:
VSN Engineering, Inc.

VSN Engineering, Inc. 8660 W. Flagler Street, Suite 113 Miami, FL 33144

Geo-tech Engineer:
Langan
15150 NW 79th Court, Suite 200

Miami Lakes, FL 33016-5848

Life Safety Consultant:

SLS Consulting, Inc.
260 Palermo Avenue
Coral Gables, FL 33134

Parking Consultant:
Timothy Haahs & Associates, Inc.
40 NW 3rd Street, Suite 1102

Miami, FL 33128

Elevator Consultant:
Van Deusen & Associates, Inc.
8201 Peters Road, Suite 1000

Plantation, FL 33324

Acoustic Consultant:
Electro-Media Design, Ltd.
973-C Russell Avenue
Gaithersburg, MD 20879

Landscape Architect:
Naturalficial, Inc.
6915 Red Road, Suite 224
Coral Gables, FL 33143
Contact: Andres Arcila
O: 786.717.6564 / M: 305.321.2341

O: 786.717.6564 / M: 305.321.23 Firm Reg. No. LC26000548 IO. DESCRIPTION

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04/15/2019 PS & AR

SCALE CHECKED BY

AA & PA


PROJECT NO. & TITLE

Project Title TORINO GARAGE

PROJECT STATUS
FINAL HISTORIC PRESERVATION
BOARD SUBMITTAL

KEY PLAN

1/8" = 1'-0"

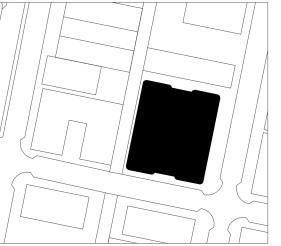

SCALE & ORIENTATION



5' 10'


SEAL & SIGNATURE



Peter Anselmo R.L.A. FL# 6667221 DRAWING TITLE

L-3.01
GROUND LVL LANDSCAPE

PLAN

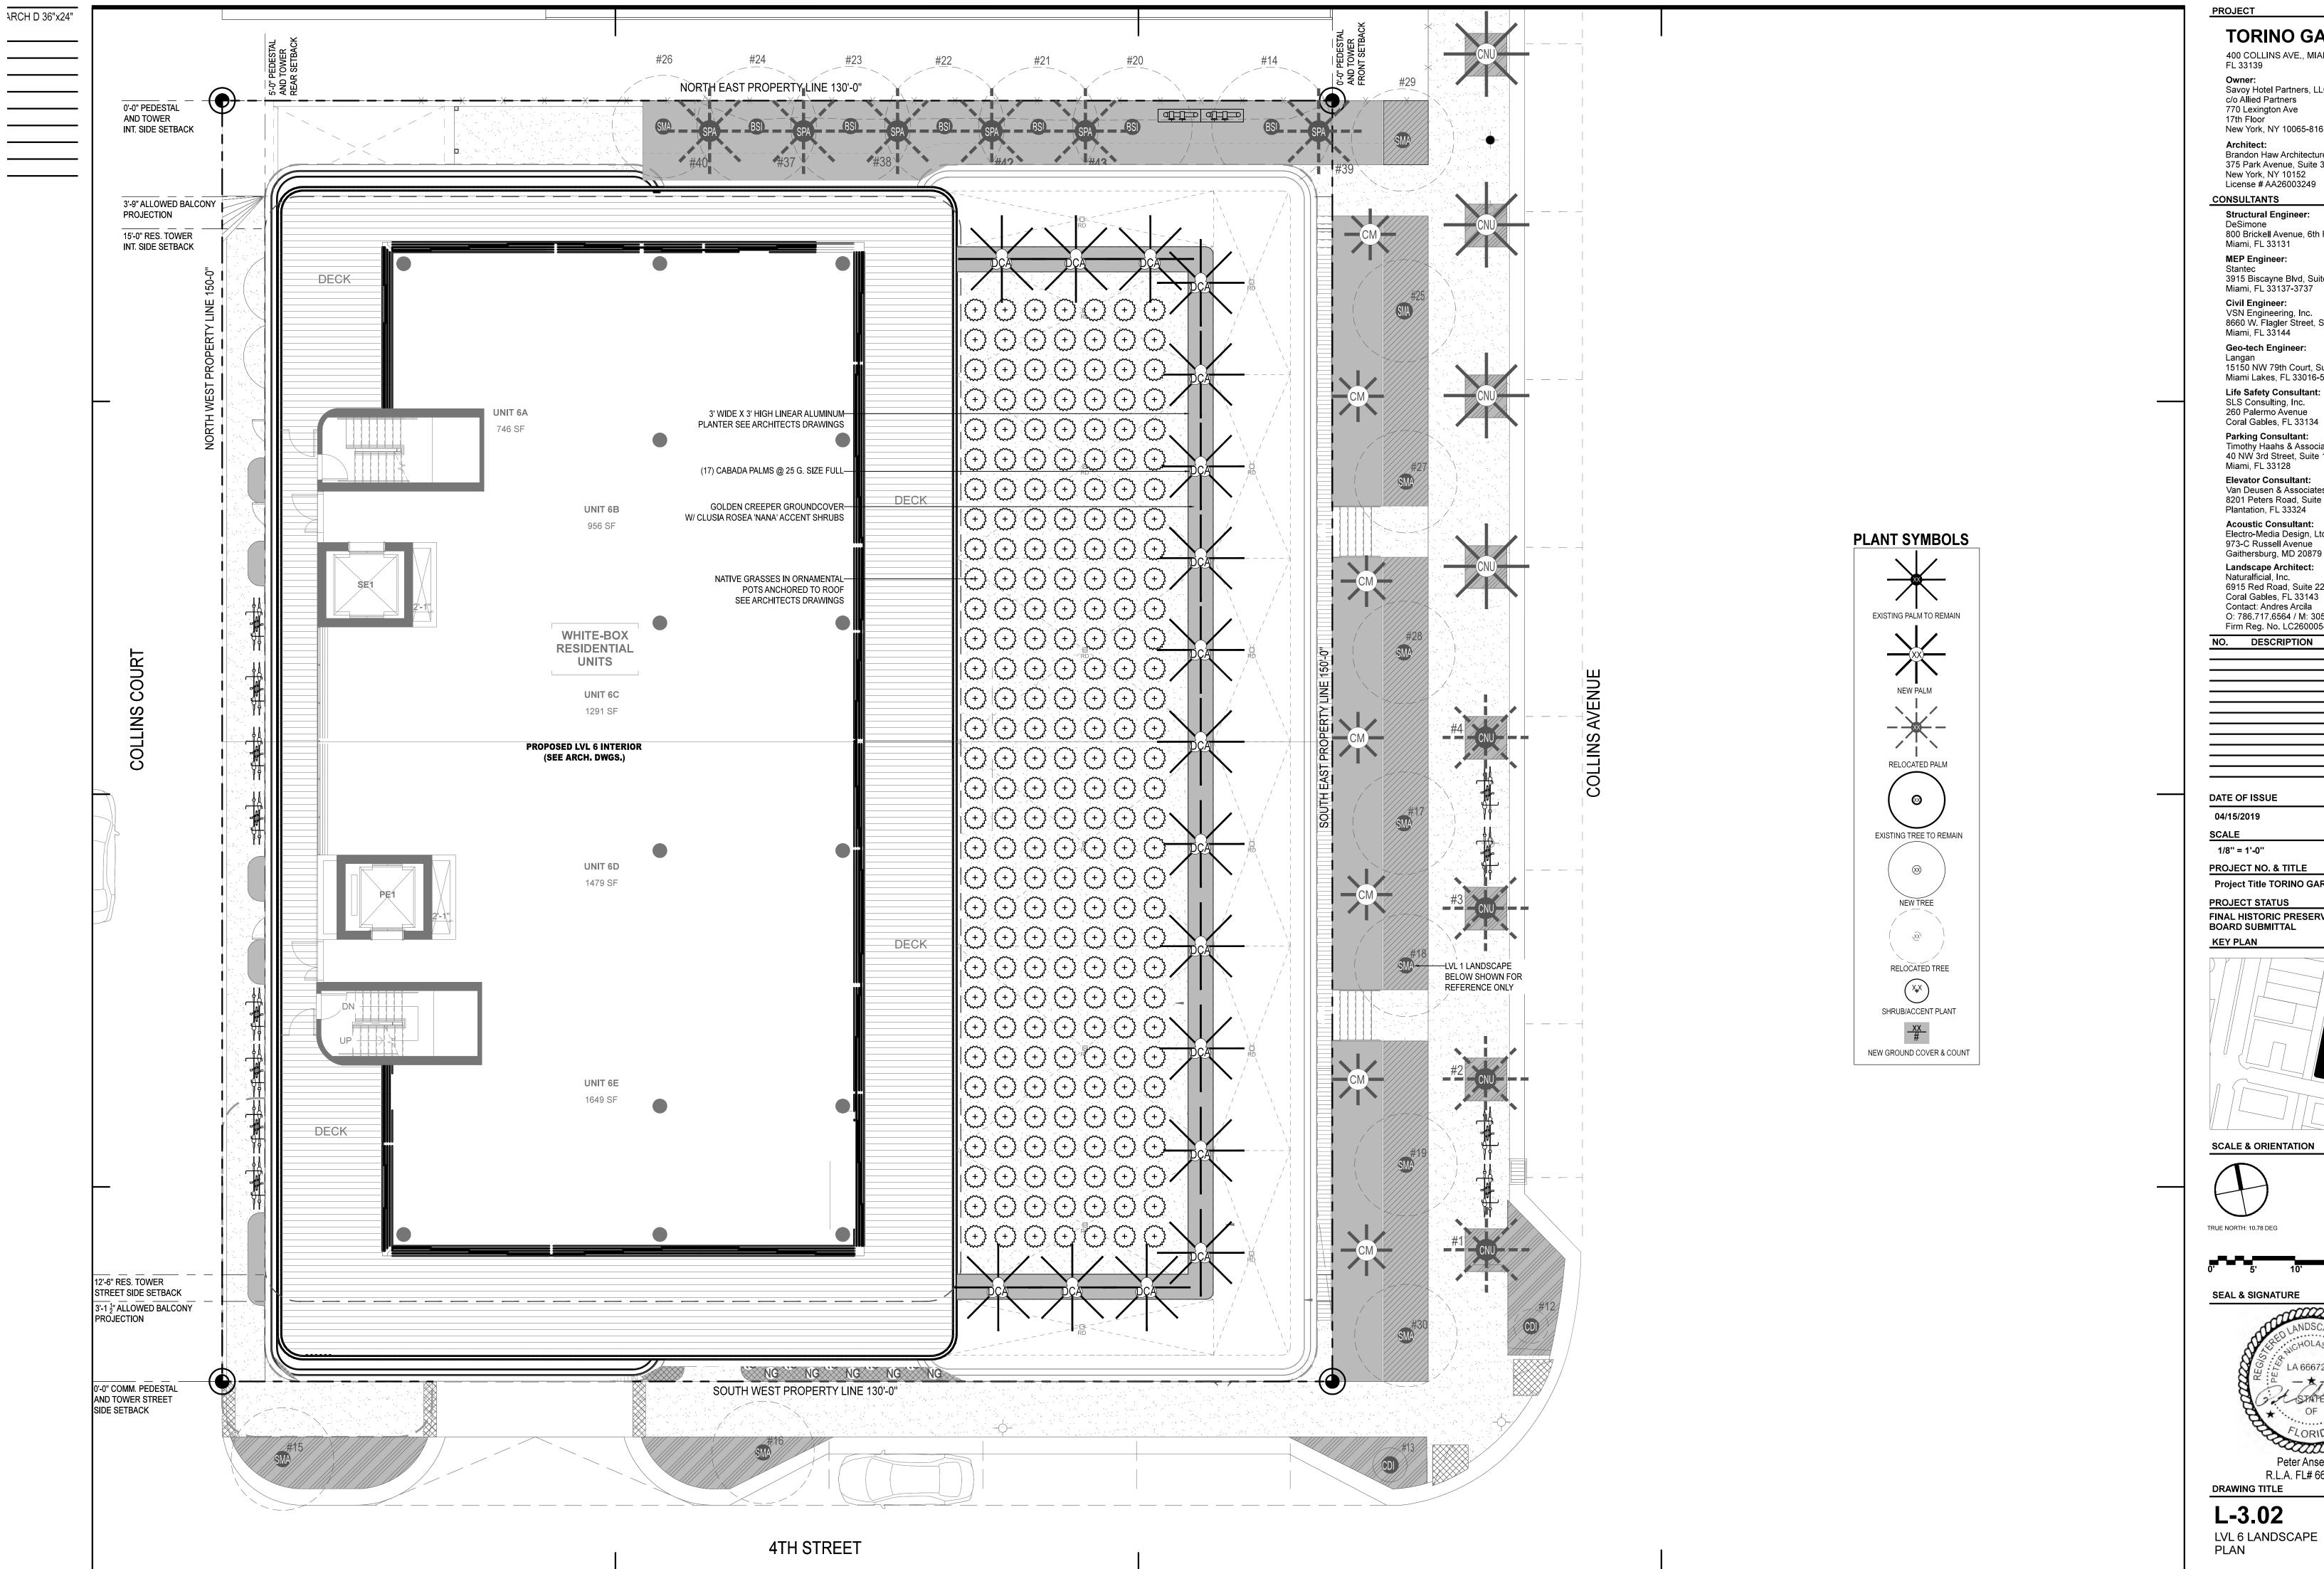

TORINO GARAGE

400 COLLINS AVE., MIAMI BEACH, FL 33139

Owner:
Savoy Hotel Partners, LLC
c/o Allied Partners
770 Lexington Ave 17th Floor New York, NY 10065-8165

> Architect: Brandon Haw Architecture LLP 375 Park Avenue, Suite 3308 New York, NY 10152 License # AA26003249

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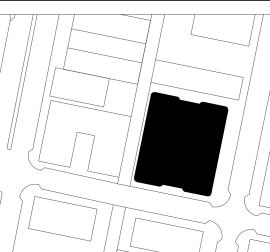
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PROJECT NO. & TITLE Project Title TORINO GARAGE

PROJECT STATUS

FINAL HISTORIC PRESERVATION BOARD SUBMITTAL

KEY PLAN




SCALE & ORIENTATION






SEAL & SIGNATURE

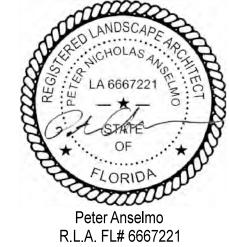

DRAWING TITLE

L-3.02

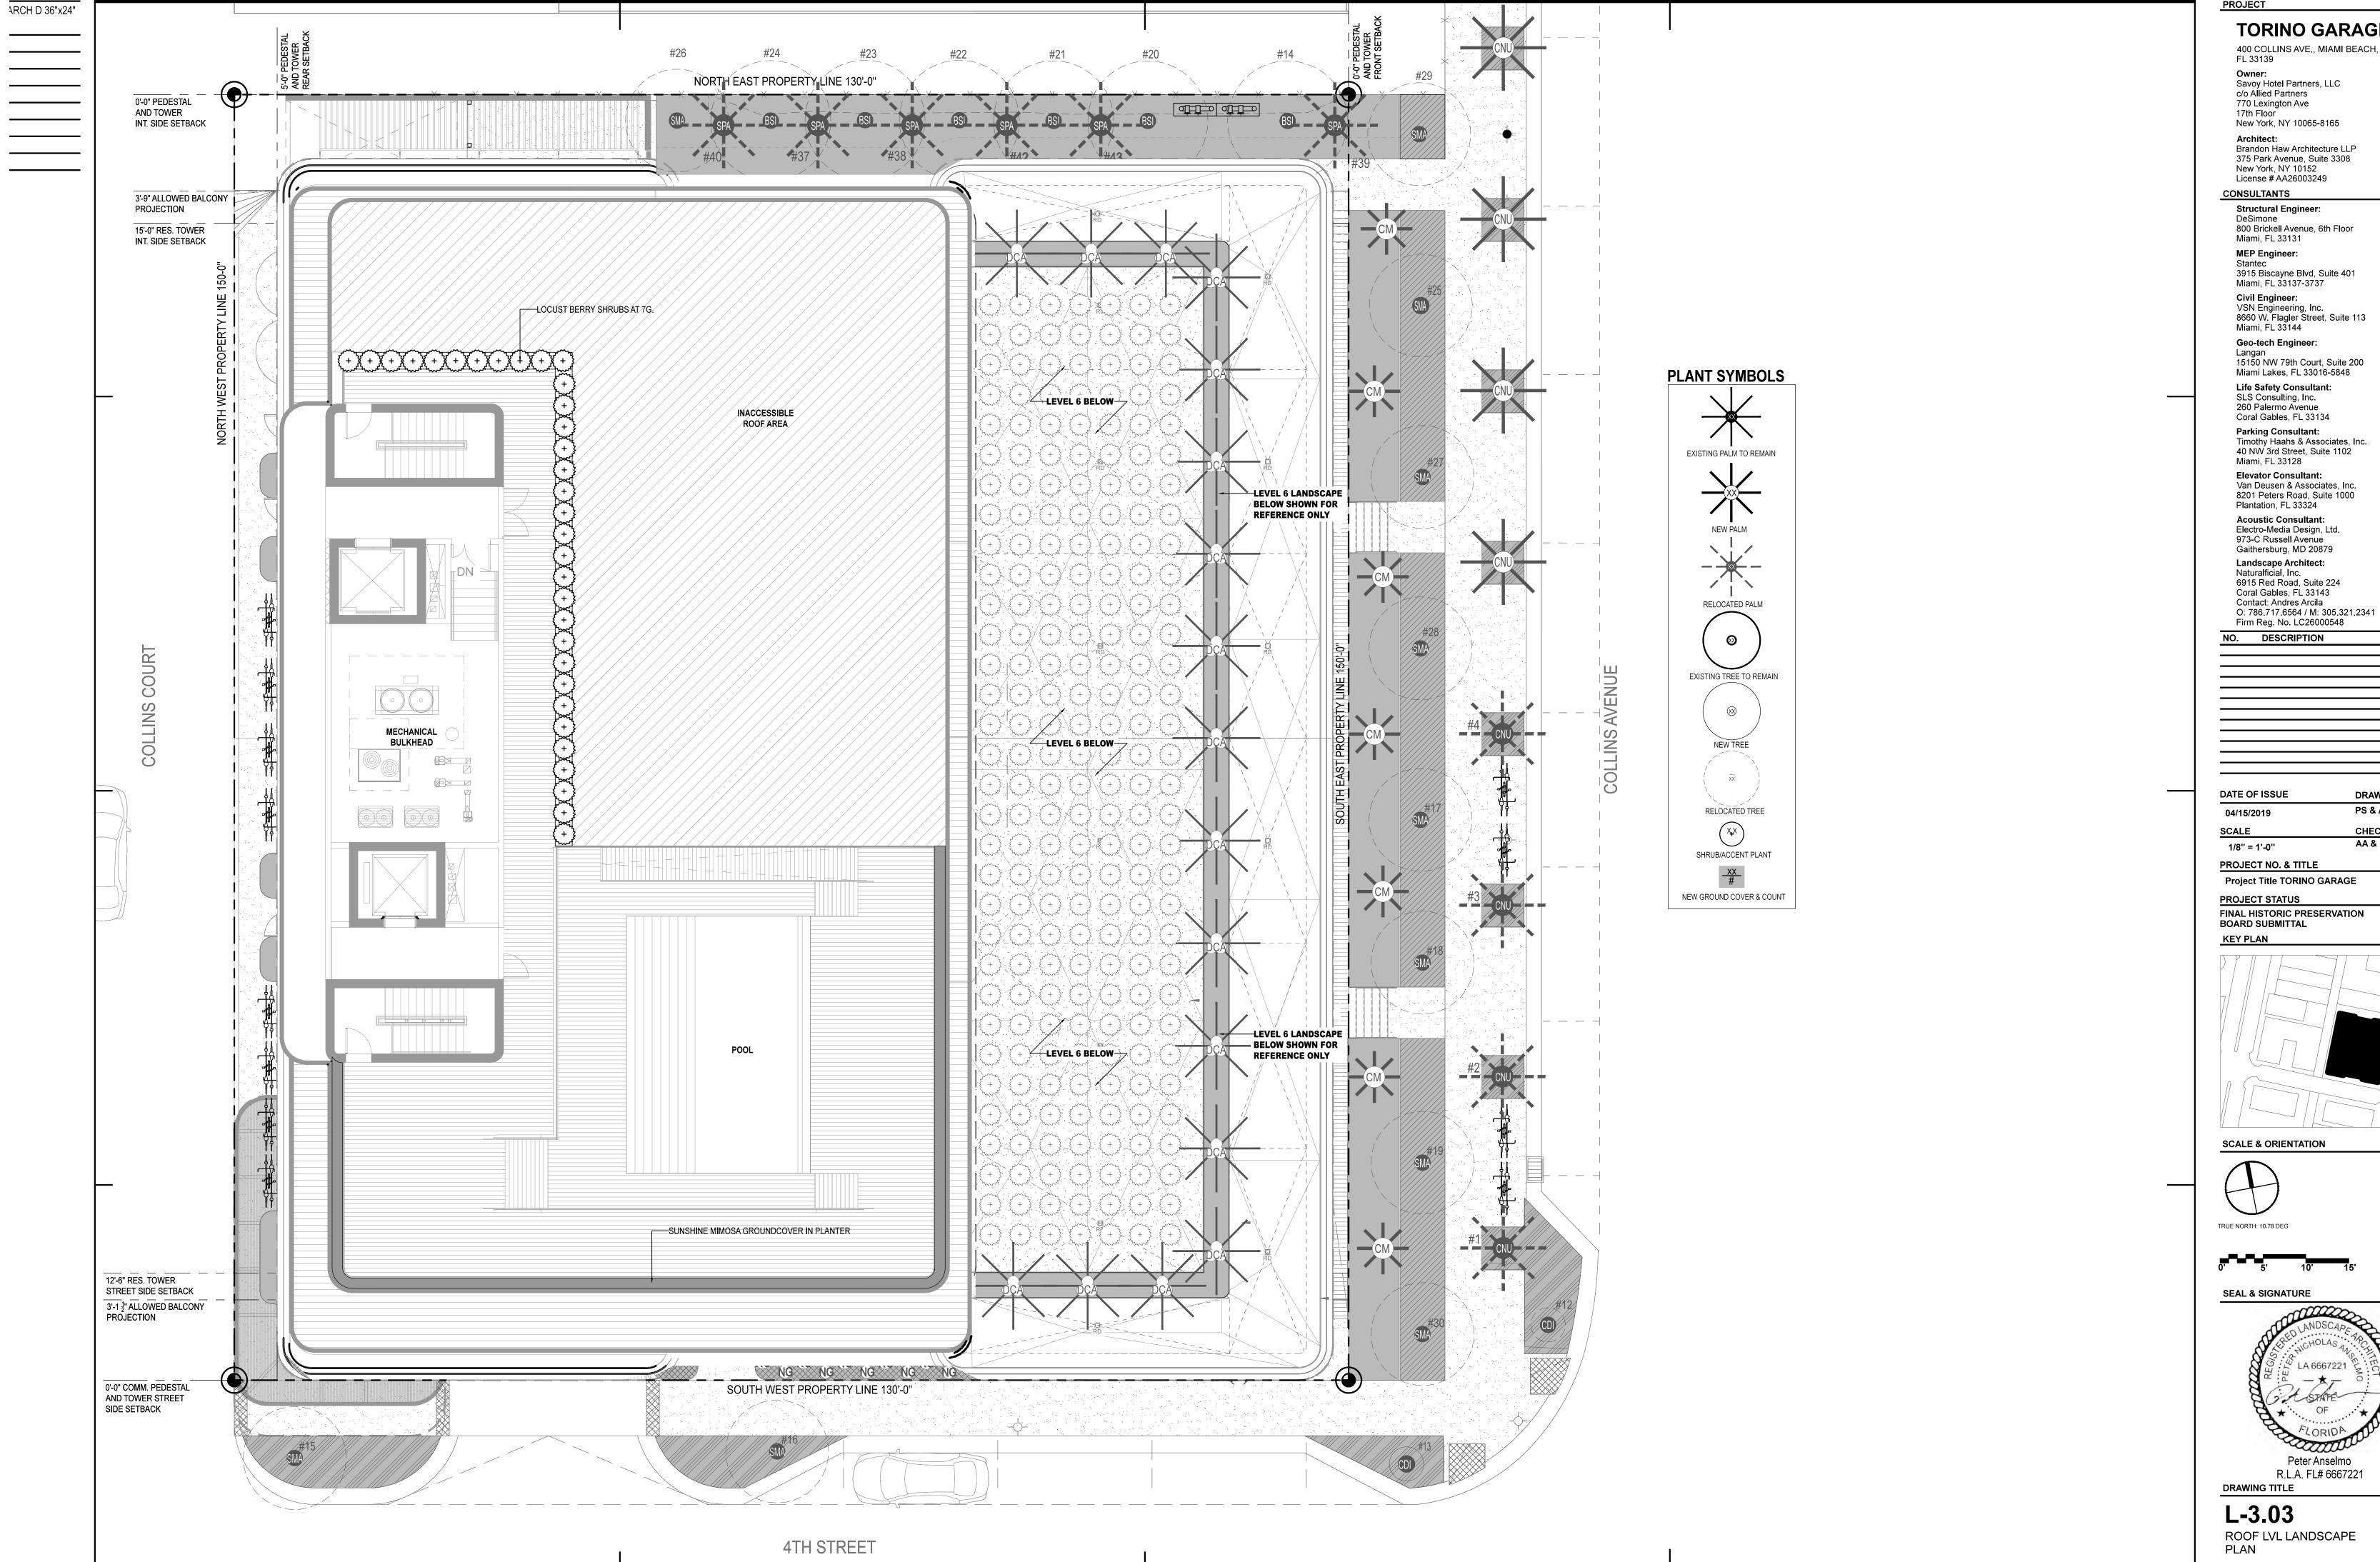

TORINO GARAGE

400 COLLINS AVE., MIAMI BEACH, FL 33139 Owner:
Savoy Hotel Partners, LLC
c/o Allied Partners
770 Lexington Ave
17th Floor

> **DRAWN BY** PS & AR

CHECKED BY AA & PA

Peter Anselmo R.L.A. FL# 6667221

GENERAL PLANTING NOTES AND SPECIFICATIONS:

. EXISTING TREES DESIGNATED TO REMAIN SHALL BE PROTECTED 1. BARRICADE SHALL BE GALVANIZED AND WELDED WIRE FABRIC: 1X1" DURING ALL CONSTRUCTION PHASES. ANY TREES DESIGNATED TO MESH .063, 48" IN HEIGHT RECOMMENDED CONTACT: REMAIN WHICH ARE SCARRED OR DESTROYED WILL BE REPLACED AT THE Wire Cloth Man CONTRACTOR'S EXPENSE, WITH SIMILAR SPECIES, SIZE AND QUALITY.

EXISTING TREES DESIGNATED TO BE STORED OFF-SITE, SHALL BE PH: 1,888,947,3256 PROTECTED AND CARED FOR ACCORDING TO INDUSTRY STANDARD. FX: 727.524.4000 ANY TREES OR SHRUBS SCARRED OR DESTROYED WILL BE REPLACED AT THE CONTRACTOR'S EXPENSE. WITH SIMILAR SPECIES, SIZE AND QUALITY,

3.LANDSCAPE CONTRACTOR SHALL BECOME FAMILIAR WITH ALL 3. ACCESS: PROVIDE HINGED, LATCHING GATE. UNDERGROUND UTILITIES OR STRUCTURES PRIOR TO DIGGING. 4. METAL GATE: SHALL PERMIT FREE PASSAGE OF WATER, AIR AND SHALL LANDSCAPE CONTRACTOR SHALL REPAIR ALL DAMAGE TO UTILITIES, ACCEPT CONSTRUCTION TRAFFIC WITHOUT EXCESSIVE DEFLECTION. AND/OR CONSTRUCTION CAUSED BY CONSTRUCTION OR DIGGING, AT NO COST TO THE OWNER.

4. ALL PLANT MATERIALS SHALL BE GUARANTEED FOR A PERIOD OF 12 1. LANDSCAPE CONTRACTOR SHALL PROVIDE A MINIMUM OF ONE (1) YEAR MONTHS AFTER DATE OF SUBSTANTIAL COMPLETION.

5.LANDSCAPE CONTRACTOR SHALL VERIFY ALL ESTIMATED QUANTITIES OF MATERIAL SHOWN ON THE DRAWINGS PRIOR TO SUBMITTING HIS BID. 2. LANDSCAPE CONTRACTOR SHALL REMOVE COMPLETELY AND DISPOSE OF PLANTING PLAN TO TAKE PRECEDENCE OVER PLANT LIST.

6. EXISTING PLANT MATERIAL NOT SHOWN ON THE PLAN AND IN CONFLICT WITH NEW PLANTING SHALL BE EVALUATED AT THE TIME OF NEW PLANTING INSTALLATION BY THE LANDSCAPE ARCHITECT.

SHALL BE REMOVED FROM PLANTING AREAS AND REPLACED WITH 80/20 ARCHITECT PRIOR TO PROCUREMENT, PREPARATION OR INSTALLATION. MIX FILL SOIL, OR AS PER SPECIFICATIONS. ALL ISLANDS IN PARKING LOTS AND AROUND BUILDINGS, SHALL BE EXCAVATED TO A DEPTH OF 3' MIN. AND REPLACED WITH 80/20 PLANT MIX, OR AS PER SPECIFICATIONS.

FIELD BY CONTRACTOR TO AVOID ALL UTILITIES AND ALL OTHER OF THE LANDSCAPE ARCHITECT IMMEDIATELY, PRIOR TO PREPARATION. OBSTRUCTIONS AFTER CONSULTING THE LANDSCAPE ARCHITECT.

9. ALL SIZES SHOWN FOR PLANT MATERIAL ON THE PLAN AND PLANT LIST ARE TO BE CONSIDERED MINIMUM. ALL PLANT MATERIAL MUST MEET OR SPREAD. ANY OTHER REQUIREMENTS FOR SPECIFIC SHAPE OR EFFECT AS NOTED ON THE PLAN SHALL ALSO BE REQUIRED FOR ACCEPTANCE.

3. TREE ROOT BALL SHALL BE ROOT PRUNED 50% (EQUALLY AROUND TREE) 60 THE PLANS OR PLANT LIST.

10. SITE PREPARATION SHALL INCLUDE THE ERADICATION AND REMOVAL OF ANY WEEDS AND/OR GRASS, AS WELL AS CLEAN-UP OF ANY DEAD MATERIAL AND FINISH GRADING AS PER THE SPECS.

SITE CLEAN AND FREE FROM ACCUMULATION OF WASTE MATERIAL, CERTIFIED ARBORIST.

12, THE LANDSCAPE CONTRACTOR SHALL EXERCISE CAUTION TO PROTECT DURING ROOT PRUNING AND DIGGING OPERATIONS. ALL PRUNING TO BE ANY NEW HARDSCAPE CONSTRUCTION OR IRRIGATION. ANY DAMAGE REVIEWED AND APPROVED BY LANDSCAPE ARCHITECT PRIOR TO PRUNING. LANDSCAPE CONTRACTOR AT NO ADDITIONAL COST TO THE OWNER.

FOR NURSERY PLANTS PART I AND II".

14. MULCH ALL PLANTING AREAS WITH SHREDDED ORGANIC MULCH TO A TO PRUNING. MINIMUM DEPTH OF 2". WITH THE EXCEPTION OF BEACH PLANTING.

, 16. ON-SITE LAYOUT OF PLANT MATERIAL MUST BE COORDINATED WITH TREE/PALM CALIPER THE LANDSCAPE ARCHITECT PRIOR TO INSTALLATION, L.A. TO BE GIVEN A ↑ MIN. OF (1) WEEK NOTICE TO REVIEW PRIOR TO IMPLEMENTATION.

COMPLY WITH THE PROPOSED IRRIGATION DESIGN.

17. LANDSCAPE CONTRACTOR TO INCLUDE REMOVAL, CORRECTIVE 13/4"-2" PRUNING AND OR REPLACEMENT. ANY CORRECTIVE ACTIONS REQUIRED 2" - 2 1/2" SHALL BE PERFORMED OR DIRECTED BY AN ISA OR ASCA CERTIFIED ARBORIST IN ACCORDANCE WITH MIAMI DADE COUNTY CODE, ANSI A-300 (PART1) PRUNING STANDARDS AND OR AN ISSUED ERM TREE OR

18. TREE PROTECTION BARRIERS MUST BE INSTALLED AT THE DRIP LINES START OF CONSTRUCTION ACTVITIES ONSITE AND SHALL REMAIN IN PLACE UNTIL CONSTRUCTION HAS COMPLETED

19. MULCH SHALL NOT BE APPLIED WITHIN 6" OF ANY TREE OR PALM 9. MAINTAIN COMPACT ROOT BALLS. ROOT BALLS SHALL BE COMPLETELY FOR ROW TREES/PALMS PLEASE UTILIZE AMERIGROW (PREMIUM USED WITHIN THE HORTICULTURAL INDUSTRY, IN TWO COMPLETE LAYERS. , PINEBARK BROWN) SHREDDED MULCH OR A CITY APPROVED 10. ALL TREES TO BE FLOODED FOR FIVE (5) DAYS PRIOR TO TRANSPLANT. ALTERNATIVE.

FOR TREES PROPOSED TO REMAIN ON SITE, DUE TO CLEARANCE, IS PLACED. REPEAT UNTIL BACKFILL IS FLUSH WITH SURROUNDING GRADE. SAFETY OR FOR CONSTRUCTION RELATED REASONS THE PRUNING SHALL BE PERFORMED OR DIRECTED BY AN ISA OR ASCA CERTIFIED URBAN FORESTER SHALL BE PROVIDED WITH A WRITTEN COPY OF THE RESIDUAL ROOTS, STUMPS AND PORTIONS AND PARTS THEREOF. , PROPOSED PRUNING PLAN INCLUDING THE REASONS WHY PRUNING IS 13. RESTORE THE SURFACE WITH MATERIAL TO MATCH ADJACENT AREAS. NECESSARY, PRIOR TO THE PRUNING ACTIVITIES TAKING PLACE.

REQUIRES THE CUTTING OF ANY ROOTS WITH A DIAMETER OF 2" OR ROOT BALL BURLAP OR SHRINK WRAP. GREATER, ROOTS SHALL BE CLEANLY CUT WITH A SHARP TOOL, AS DIRECTED BY AN ISA CERTIFIED ARBORIST, AND IN ACCORDANCE WITH THE ANSI A-300 STANDARDS, CUT ROOTS SHOULD BE IMMEDIATELY COVERED WITH SOIL TO PREVENT DRYING. ROOTS SHOULD NOT BE 1. VERIFY ALL UNDERGROUND CONSTRUCTIONS OR OBSTRUCTIONS (UTILITIES,

HANDLING AND TRANSPORTATION

I. TREES/PALMS SHALL BE PROPERLY HANDLED DURING EXCAVATION, 2. LANDSCAPE CONTRACTOR TO FLAG ALL PROPOSED PLANT LOCATIONS FOR MOVING, STORAGE, RELOCATION, AND REPLANTING. DO NOT SCAR OR LANDSCAPE ARCHITECT'S APPROVAL PRIOR TO INSTALLATION. OTHERWISE DAMAGE TRUNKS AND BRANCHES, AND AVOID BREAKING LIMBS, BRANCHES, AND FRONDS. DAMAGE TO TREE/PALM MAY BE CAUSE FOR ITS REJECTION, AND MAY REQUIRE MITIGATION REPLACEMENT.

2. CONTRACTOR SHALL BE RESPONSIBLE FOR THE MANUAL WATERING 4. AFTER EACH PLANTING PIT IS EXCAVATED, PLACE SUFFICIENT PLANTING MIX IN FINAL ACCEPTANCE OF ALL WORK BY THE LANDSCAPE ARCHITECT FLUSH WITH IMMEDIATELY ADJACENT FINAL OR PROPOSED GRADE. AND/OR CLIENT.

3. LANDSCAPE CONTRACTOR SHALL BE RESPONSIBLE FOR INSTALLING THE CORRECT ELEVATION. REFER TO GRADING PLAN. AND MAINTAINING TREE/PALM PROTECTION. INSTALL BARRICADE OF
6. LANDSCAPE CONTRACTOR TO INSURE ALL ROOT FLARES ARE EXPOSED. GALVANIZED WELDED WIRE FABRIC OR PLASTIC MESH TO ENCOMPASS AND STURDY BARRICADE TO BE LEFT UP AND MAINTAINED UNTIL WITH SPECIFIED PLANTING MIX. DIRECTED TO REMOVE BY LANDSCAPE ARCHITECT.

TREE PROTECTION MATERIALS

7158 123rd Circle N Largo, FL 33773

2. POSTS & RAIL: METAL POST, SUFFICIENT TO HOLD FABRIC PLUMB AND TAUT

GUARANTEE FOR ALL RELOCATED TREES/PALMS AFTER FINAL ACCEPTANCE BY LANDSCAPE ARCHITECT AND/OR CLIENT.

OFF-SITE, ANY RELOCATED TREE/PALM THAT FAILS TO THRIVE AS DETERMINED BY THE LANDSCAPE ARCHITECT. 3. FOR ANY RELOCATED TREE/PALM REMOVED DUE TO ITS FAILURE TO THRIVE LANDSCAPE CONTRACTOR SHALL BE RESPONSIBLE FOR REPLACING AND

INSTALLING WITH A SPECIMEN OF EQUAL OR GREATER SPECIFICATION OF 7. ALL BUILDING CONSTRUCTION MATERIAL AND FOREIGN MATERIAL ORIGINAL. REPLACEMENT MATERIAL SHALL BE APPROVED BY LANDSCAPE

1. VERIFY AND INSURE ALL TREES/PALMS IDENTIFIED ON THE CONSTRUCTION 8. ALL PLANT MATERIAL SYMBOLS SHOWN ON LANDSCAPE PLAN SHALL DRAWINGS AND THOSE TAGGED IN THE FIELD CORRESPOND AS TO NUMBER BE CONSIDERED DIAGRAMMATIC AND SHOULD BE ADJUSTED IN THE AND DESCRIPTION. ANY DISCREPANCIES SHALL BE BROUGHT TO THE ATTENTION

2. LANDSCAPE CONTRACTOR SHALL BE RESPONSIBLE FOR TREE/PALM PROTECTION OF ALL VERIFIED MATERIAL. INSTALL BARRICADE OF GALVANIZED WELDED WIRE FABRIC OR PLASTIC MESH TO ENCOMPASS THE DRIPLINE OF THE EXCEED THESE MINIMUM REQUIREMENTS FOR BOTH HEIGHT AND TREE/PALM. BARRICADE TO BE REMOVED WHEN DIRECTED BY LANDSCAPE

ALL TREES TO HAVE SINGLE TRUNK, UNLESS OTHERWISE NOTED ON DAYS PRIOR TO TRANSPLANT. THE REMAINING 50% TO BE PRUNED 30 DAYS PRIOR TO TRANSPLANTING.

4. PALMS TO BE RELOCATED MAY BE IMMEDIATELY RELOCATED AFTER DIGGING. 5, ROOTS TO BE PRUNED WITH CLEAN, SHARP TOOLS, ROOTS ONE (1) INCH AND LARGER IN DIAMETER SHALL BE NEATLY AND CLEANLY CUT WITH A HAND SAW OR 11. THE LANDSCAPE CONTRACTOR SHALL AT ALL TIMES KEEP THE JOB OTHER APPROVED CUTTING IMPLEMENT AS DIRECTED BY AN ISA OR ASCA

6. LANDSCAPE CONTRACTOR TO APPLY MYCORRHIZA APPLICATION TO ROOTS

SHALL BE REPLACED OR REPAIRED TO THE ORIGINAL STATE BY THE 7, DEAD WOOD, CROSSING BRANCHES, AND GENERAL CANOPY PRUNING SHALL BE PERFORMED OR DIRECTED BY AN ISA OR ASCA CERTIFIED ARBORIST IN 13. ALL PLANT MATERIAL TO BE FLORIDA #1 OR BETTER, AS DEFINED BY ACCORDANCE WITH THE LATEST VERSION OF THE ANSI A-300 PRUNING THE FLORIDA DEPARTMENT OF AGRICULTURE'S "CODES AND STANDARDS" STANDARDS AND GOOD HORTICULTURAL PRACTICES IMMEDIATELY AFTER COMPLETION OF ROOT PRUNING OF EACH SPECIMEN TO BE RELOCATED. ALL PRUNING TO BE REVIEWED AND APPROVED BY LANDSCAPE ARCHITECT PRIOR

8. ROOT BALL SIZE TABLE 15. ALL PLANTING AREAS WITHIN LIMIT OF WORK SHALL BE 100% FULLY (NOTE: ROOT BALL SIZES SHALL EXCEED MINIMUM STANDARDS SET FORTH IN IRRIGATED. THE IRRIGATION CONTRACTOR AWARDED THE BID SHALL "GRADES AND STANDARDS FOR NURSERY PLANTS, PART II, PALMS AND TREES, FLORIDA DEPARTMENT OF AGRICULTURE")

MINIMUM ROOT BALL DIAMETER

4" - 4 1/3"

OF ALL TREES AND PALMS TO REMAIN OR BE RELOCATED PRIOR TO THE PROPORTIONALLY AT THREE (3) INCHES OF ROOT BALL DIAMETER FOR EVERY INCREASE OF ONE (1) INCH IN CALIPER OR FRACTION THEREOF.

TRUNKS THAT ARE INSTALLED OR INCORPORATED INTO THE PROJECT.

ENCLOSED WITHIN A BURLAP COVERING OR STRETCH WRAP AS COMMONLY

11. ALL PITS TO BE FILLED THE SAME DAY AND WITH CLEAN FILL IN 18 INCH 20. SHOULD ANY CORRECTIVE STRUCTURAL PRUNING BE NECESSARY LIFTS/LAYERS, EACH THEN COMPACTED BEFORE A SUBSEQUENT 18" LIFT/LAYER

12, CORRECT ALL PROBLEMS RELATED TO SETTLEMENT, EROSION, OR OTHER ARBORIST IN ACCORDANCE WITH THE LATEST VERSION IF THE ANSI A-300

DISTRESS OF EXCAVATED/BACKFILLED PIT FROM WHICH TREE/PALM HAS BEEN PRUNING STANDARDS AND GOOD HORTICULTURAL PRACTICES. THE CITY

REMOVED, INCLUDING THE COMPLETE AND THROUGH REMOVAL OF ALL

MATERIAL TO BE APPROVED BY LANDSCAPE ARCHITECT, CONTRACTOR TO 21. CARE SHALL BE TAKEN TO AVOID UTILITY OR CONSTRUCTION PROVIDE A MINIMUM ONE YEAR WARRANTY ON SETTLING AND PLANT MATERIAL. TRENCHING THROUGH EXISTING TREE OR PALM DRIPLINES OF TREES

14. LANDSCAPE CONTRACTOR IS RESPONSIBLE FOR ALL MATERIAL INCLUDING SLATED TO REMAIN IN PLACE OR BE RELOCATED. IF CONSTRUCTION BUT NOT LIMITED TO BACKFILL MATERIAL, PROTECTION FENCING, FLAGGING,

TORN OR BROKEN BY HEAVY EQUIPMENT. SHREDDED, RAGGED OR SEPTIC SYSTEMS, ETC.) ARE IDENTIFIED, LOCATED AND CLEARLY MARKED AS BROKEN ROOTS ENDS SHOULD BE NOTED IN WRITING AND AN ARBORIST APPROPRIATE PRIOR TO EXCAVATION OF PLANTING PITS FOR RELOCATED TREES. SHOULD BE CONSULTED PRIOR TO ANY ROOT PRUNING TAKING PLACE . AND PALMS. ANY UNKNOWN OBJECTS SHALL BE BROUGHT TO THE ATTENTION OF THE LANDSCAPE ARCHITECT IMMEDIATELY, PRIOR TO INSTALLING AND BACKFILLING.


3. PLANTING PITS SHALL BE A MINIMUM OF TWO (2) TIMES LARGER IN DIAMETER AND ONE AND A HALF (1-1/2) TIMES LARGER IN DEPTH THAN THE ROOT BALL. ROUGHEN SIDES AND BOTTOM OF PIT.


OF ALL RELOCATED TREES/PALMS DURING MAINTENANCE PERIOD, UNTIL BOTTOM OF EXCAVATION, AND SEAT PLANT, INSURING TOP OF ROOT BALL IS 5. LANDSCAPE CONTRACTOR TO INSURE ALL PLANT MATERIAL IS INSTALLED AT

THE DRIPLINE OF THE TREE/PALM. BARRICADE SHALL BE PLUMB, TAUT, 7. CENTER EACH RELOCATED TREE/PALM IN ITS PLANTING PIT AND BACKFILL

8. PLACE PLANTING MIX IN 12 INCH LIFTS/LAYERS AROUND ROOT BALL AND COMPACT UNTIL ALL VOIDS ARE FILLED WITH COMPACTED PLANTING MIX. 9. BUILD SOIL SAUCER OF MOUNDED EXCAVATED SOIL AROUND PERIMETER OF

EACH PLANTING PIT TO FORM WATERING BASIN. MULCH TO A DEPTH OF 3".

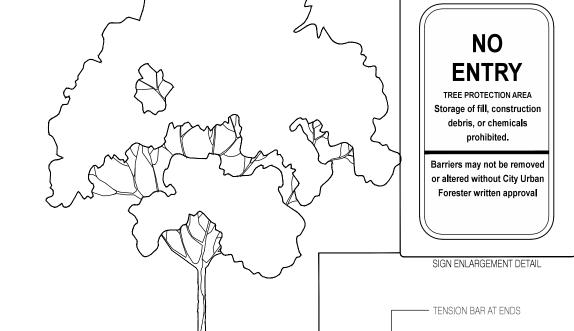

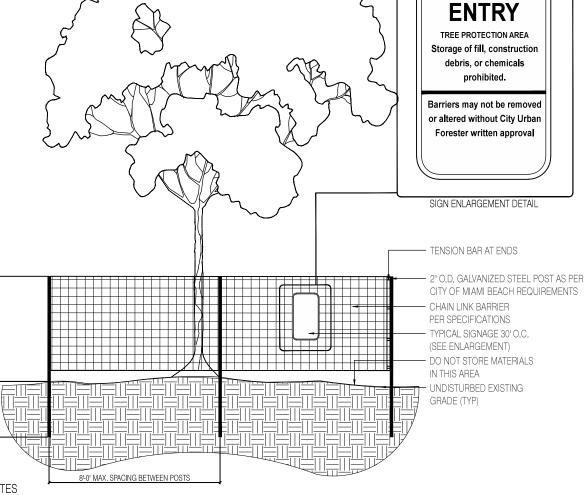

1.) TREE BARRICADE APPROVAL: OBTAIN CITY APPROVAL OF TREE BARRICADES BEFORE BEGINNING CLEARING OPERATIONS OR ANY SITE DEVELOPMENT.

2.)TREE PROTECTION FENCE SHALL BE INSTALLED PRIOR TO ANY SITE WORK, CLEARING, OR DEMOLITION. 3.) THE TREE PROTECTION BARRICADE SHALL BE INSTALLED PER CITY OF MIAMI BEACH CODE CHAPTER 46, AND WILL BE AT LEAST FOUR (4) FEET HIGH. THE BARRIER SHALL BE CONSTRUCTED OF CONTINUOUS 2" CHAIN LINK FENCE FABRIC WITH GALVANIZED STEEL POSTS AT (8) FOOT SPACING, OR OF 2X4 POSTS WITH THREE EQUALLY SPACED 2X4 RAILS, POSTS MAY BE SHIFTED TO AVOID ROOTS.

4.) THE BARRIER SHALL BE PLACED AT THE DRIP LINE OF EACH TREE OR PRESERVATION AREA, AND IN NO CASE LESS THAN 10' FROM THE TRUNK OF ANY PROTECTED TREE, FOR ANY DISCREPANCIES RELATED TO PLACEMENT OF THE BARRIER, THE CITY'S URBAN FORESTER SHOULD BE CONTACTED FOR APPROVAL 5.) HAND WORK ONLY WITHIN TREE BARRICADES. NO CONSTRUCTION ACTIVITIES PERMITTED WITHIN TREE PROTECTION FENCE WITHOUT URBAN FORESTER APPROVAL.

6.) TREE PROTECTION FENCE SHALL BE MAINTAINED THROUGHOUT CONSTRUCTION. 7.) REMOVE TREE PROTECTION FENCE ONLY WITHIN WRITTEN APPROVAL FROM CITY URBAN FORESTER AFTER ALL SITE


WORK HAS BEEN COMPLETED. COMB TREE PROTECTION DETAIL

SCALE: N.T.S

1,) PRUNING: REMOVE ANY BROKEN BRANCHES.

3) USE THREE LODGE POLES FOR ADDED STABILITY.

2) NO MULCH WITHIN 4" OF TRUNK, TYP.

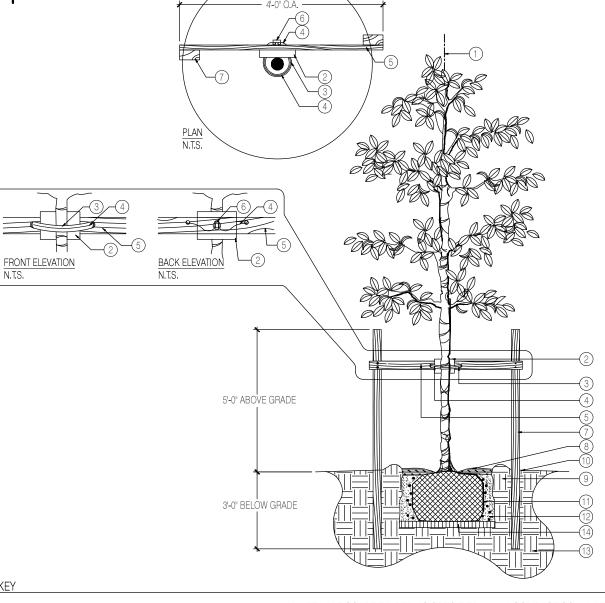

8.) 2" MULCH DEPTH LAYER ON ROOT BALL.

PRIOR RO MULCHING AND PLATING.

13.) UNDISTURBED SUBGRADE.

TO PLANTING.

TIMES IMMEDIATLEY AFTER PLANTING, RAKE OUT

WITH FERTILIZER AND COMPOST AS REQUIRED.

MEDIUM TREE PLANTING & STAKING DETAIL

1.) SET TREE PLUMB IN PLANTING PIT. 2.) PROTECT TREE TRUNK WITH 1 NOMACO ® STYROFOAM PADDING GUARDS, #6U048048, AS SPECIFIED, OR APPROVED EQUAL. 3.) AMAZON HOUSE AND RUBBER ®. 1 ½" AIR HOSE #K1146 OR APPROVED EQUAL, TO COVER 10 GAUGE WIRE.

4.) 1 10 GAUGE GALVANIZED WIRE. WIRE PRODUCT ®, OR APPROVED EQUAL. 5.) 1 2" X 4" X 4' NON TREATED LANDSCAPE TIMBER AS SPECIFIED. FASTEN WITH 4 3 ½ DECK SCREWS TO 2" X 4" X 8' P.T. LANDSCAPE

6.) 1 $\frac{1}{8}$ MALLEABLE CLAMP FASTENER FOR WIRE. SUPPLIER: FLORIDA WIRE ® OR APPROVED EQUAL.

7.) 2 2" X 4" X 8' P.T. LANDSCAPE TIMBER AS SPECIFIED. 14.) COMPACT SOIL IMMEDIATELY BENEATH THE ROOT BALL TO PREVENT SETTLING. 9.) 4" WATER RING, (WITHIN ROOTBALL DIA.), FILL 3

1.) CONTRACTOR TO ASSURE PERCOLATION

10.) ROOT FLARE 1"-2" ABOVE FINISHED GRADE. 2.) NO MULCH WITHIN 4" OF TRUNK. 11.) B&B OR CONTAINERIZED ROOTBALL. REMOVE ALL BURLAP IF NOT 100% BIODEGRADABLE. REMOVE CONTAINER FROM ROOTBALL PRIOR

12.) BACKFILL, TOP SOIL TYP, OR AREA, BACKFILL SHALL BE AMENDED THROUGHOUT ENTIRE SITE

IN TREE PITS.

LAYERS OF BURLAP BASE OF LEAF BUD 3/4" STEEL BANDING (5) 2"x4"x2' BATTONS NAIL BRACING TO WOOD - 3/4" STEEL BANDING (3) 2"X4" WOOD BRACES & PAINTED BLACK (SEE NOTES BELOW) 2" DEPTH MULCH LAYER- REFER TO SPECIFICATION — 6" COMPACTED SOIL SAUCER TO HOLD WATER FINAL GRADE 11 2"X4"x30" TREE STAKE **ROOT BALL** NATIVE SOIL BACKFILL OR RECIEVING AMENDED PLANTING SOIL PLANTING HOLE AS REQUIRED BY SOIL ANALYSIS

1,) PALMS OVER 30' GW HEIGHT, USE MINIMUM (4) 4X4 BRACING AND STAKES. 2.) PRIMARY STAKES SHOULD PLACED PARALLEL TO WALKWAYS WHENEVER POSSIBLE


4.) BUD SHALL BE PERPENDICULAR TO THE GROUND PLANE. 5.) TRUNK SHALL BE STRAIGHT AND WITHOUT CURVES.

6.) NO SCARRED OR BLACKENED TRUNKS.

7.) AMENDED SOIL MIX, TO BE ADDED AT THE TIME OF PLANTING IF NEEDED, SHALL CONSIST OF A RATIO MIX OF 80% CLEAN SILICA SAND AND 20% SCREENED,

PULVERIZED TOPSOIL AS NEEDED.

PALM PLANTING AND STAKING DETAIL SCALE: N TS

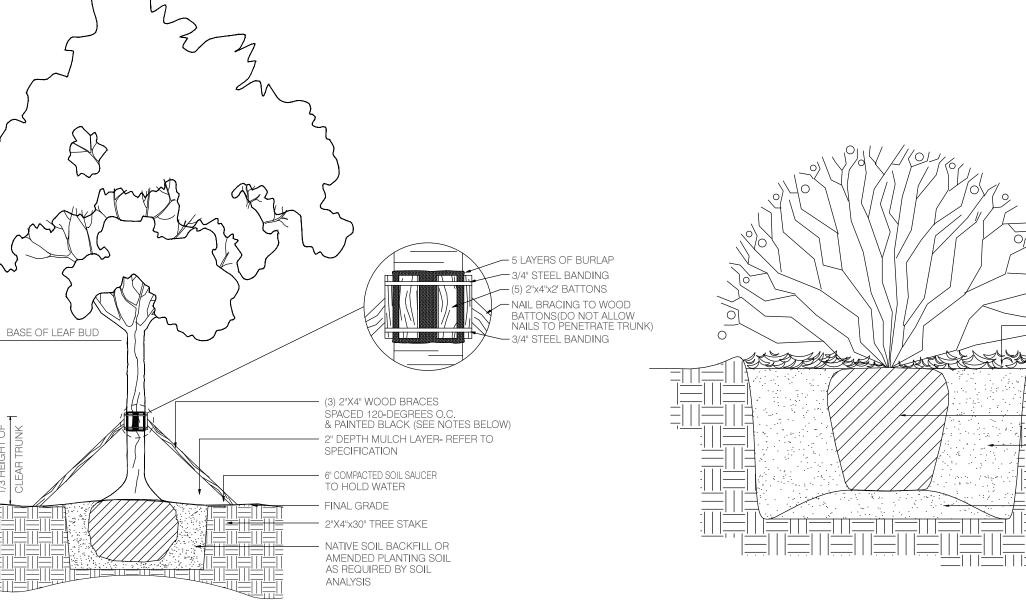

SMALL TREE PLANTING AND STAKING DETAIL

FASTEN IN FIGURE 8.

BELOW CANOPY TYP).

- STAKE - 2" DIA. PRESSURE TREATED LODGE POLE, HEIGHT AS SPECIFIED.

(NOTE: TOP OF STAKES SHALL BE

- 2" DEPTH MULCH ON ROOT BALL

- 4" WATER RING - (WITHIN ROOT BALL

PLANTING RAKE OUT PRIOR TO

MULCHING AND PLANTING.

FINISHED GRADE.

DIA) FILL 3 TIMES IMMEDIATELY AFTER

ROOTBALL: LOOSEN AND REMOVE BURLAF

AND WIREFROM TOP OF ROOT BALL

BURLAP IF NOT 100% BIODEGRADABLE.

BACKFILL: TOP SOIL TYPICAL OF AREA.


FERTILIZER AND COMPOST AS REQUIRED.

TO 1 OF THE DEPTH. REMOVE ALL

(BACKFILL SHALL BE AMENDED THROUGHOUT ENTIRE SITE W/


1.) FOR SMALL TREES UP TO AND INCLUDING 2.5"

LARGE TREE PLANTING AND STAKING DETAIL

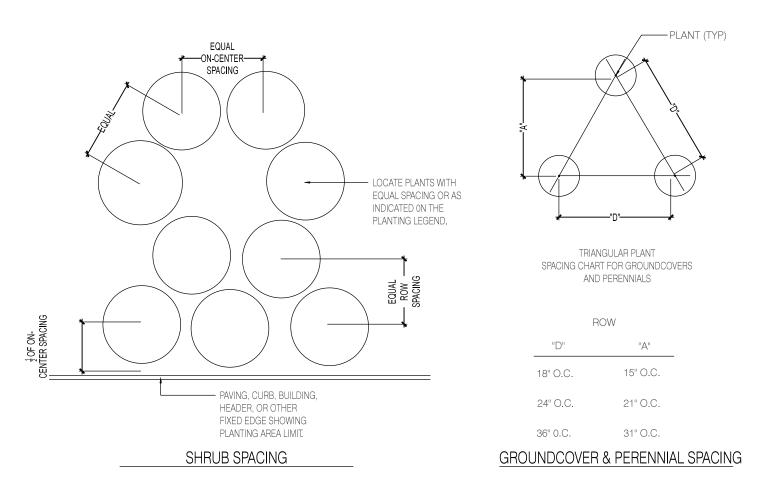


PLANT SPACING DETAIL




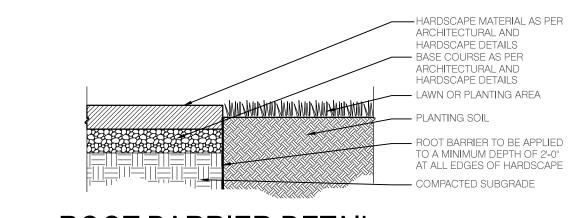


ROOT BARRIER DETAIL

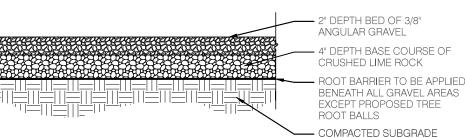

GRAVEL BED DETAI

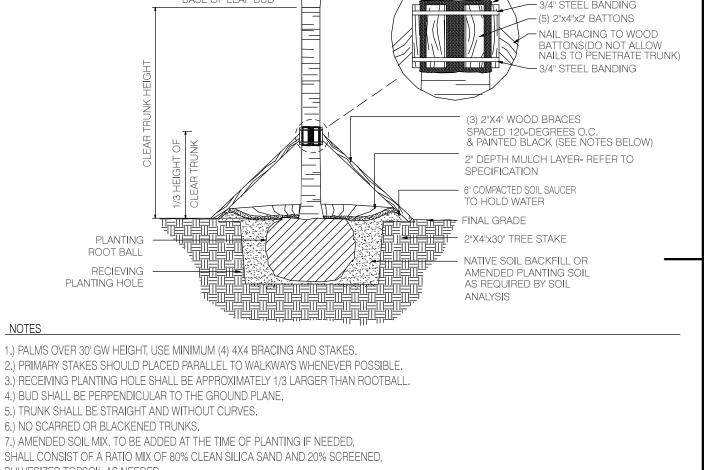



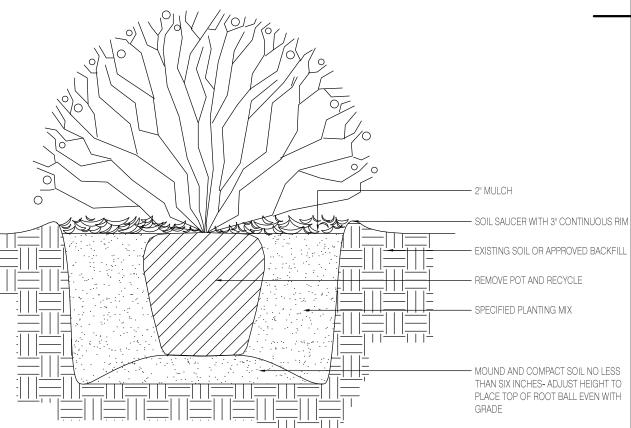

SCALE & ORIENTATION

PROJECT

FL 33139

17th Floor

Architect:

CONSULTANTS

DeSimone

TORINO GARAGE

400 COLLINS AVE., MIAMI BEACH

Savoy Hotel Partners, LLC

New York, NY 10065-8165

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8660 W. Flagler Street, Suite 113

15150 NW 79th Court, Suite 200

Timothy Haahs & Associates, Inc.

40 NW 3rd Street, Suite 1102

Van Deusen & Associates, Inc

8201 Peters Road, Suite 1000

Miami Lakes, FL 33016-5848

Miami, FL 33137-3737

VSN Engineering, Inc.

Geo-tech Engineer:

Life Safety Consultant:

SLS Consulting, Inc.

260 Palermo Avenue

Parking Consultant:

Elevator Consultant:

Plantation, FL 33324

Acoustic Consultant:

973-C Russell Avenue

Landscape Architect:

Naturalficial, Inc.

DATE OF ISSUE

PROJECT NO. & TITLE

PROJECT STATUS

BOARD SUBMITTAL

KEY PLAN

Project Title TORINO GARAGE

FINAL HISTORIC PRESERVATION

04/15/2019

N.T.S.

Gaithersburg, MD 20879

6915 Red Road, Suite 224

Firm Reg. No. LC26000548

DESCRIPTION

O: 786.717.6564 / M: 305.321.2341

DRAWN BY

CHECKED BY

PS & AR

AA & PA

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Contact: Andres Arcila

Electro-Media Design, Ltd.

Miami, FL 33128

Coral Gables, FL 33134

New York, NY 10152

License # AA26003249

Structural Engineer:

Miami, FL 33131

MEP Engineer:

Civil Engineer:

Miami, FL 33144


c/o Allied Partners 770 Lexington Ave




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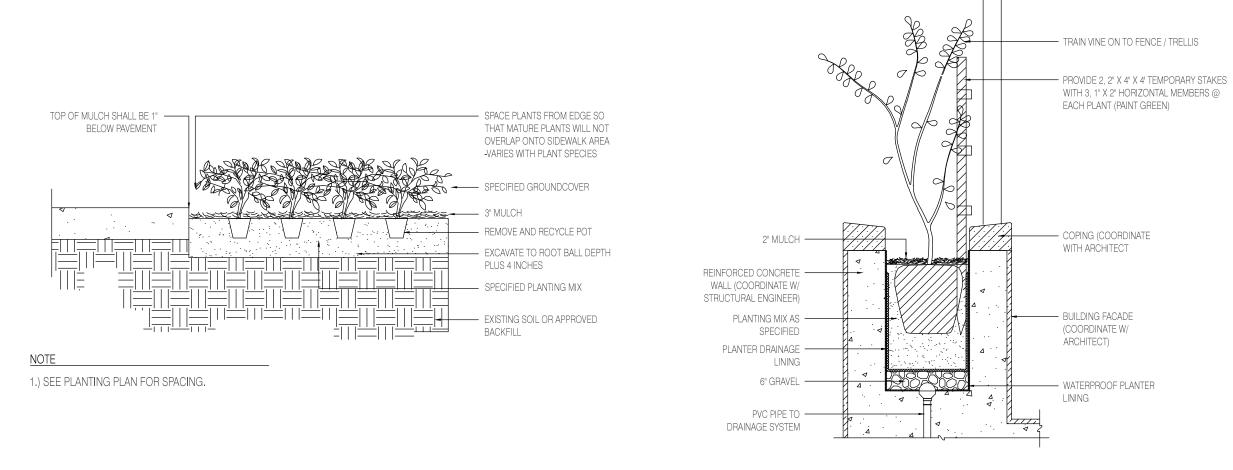


L-3.04 GENERAL PLANTING NOTES & SPECIFICATIONS



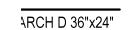

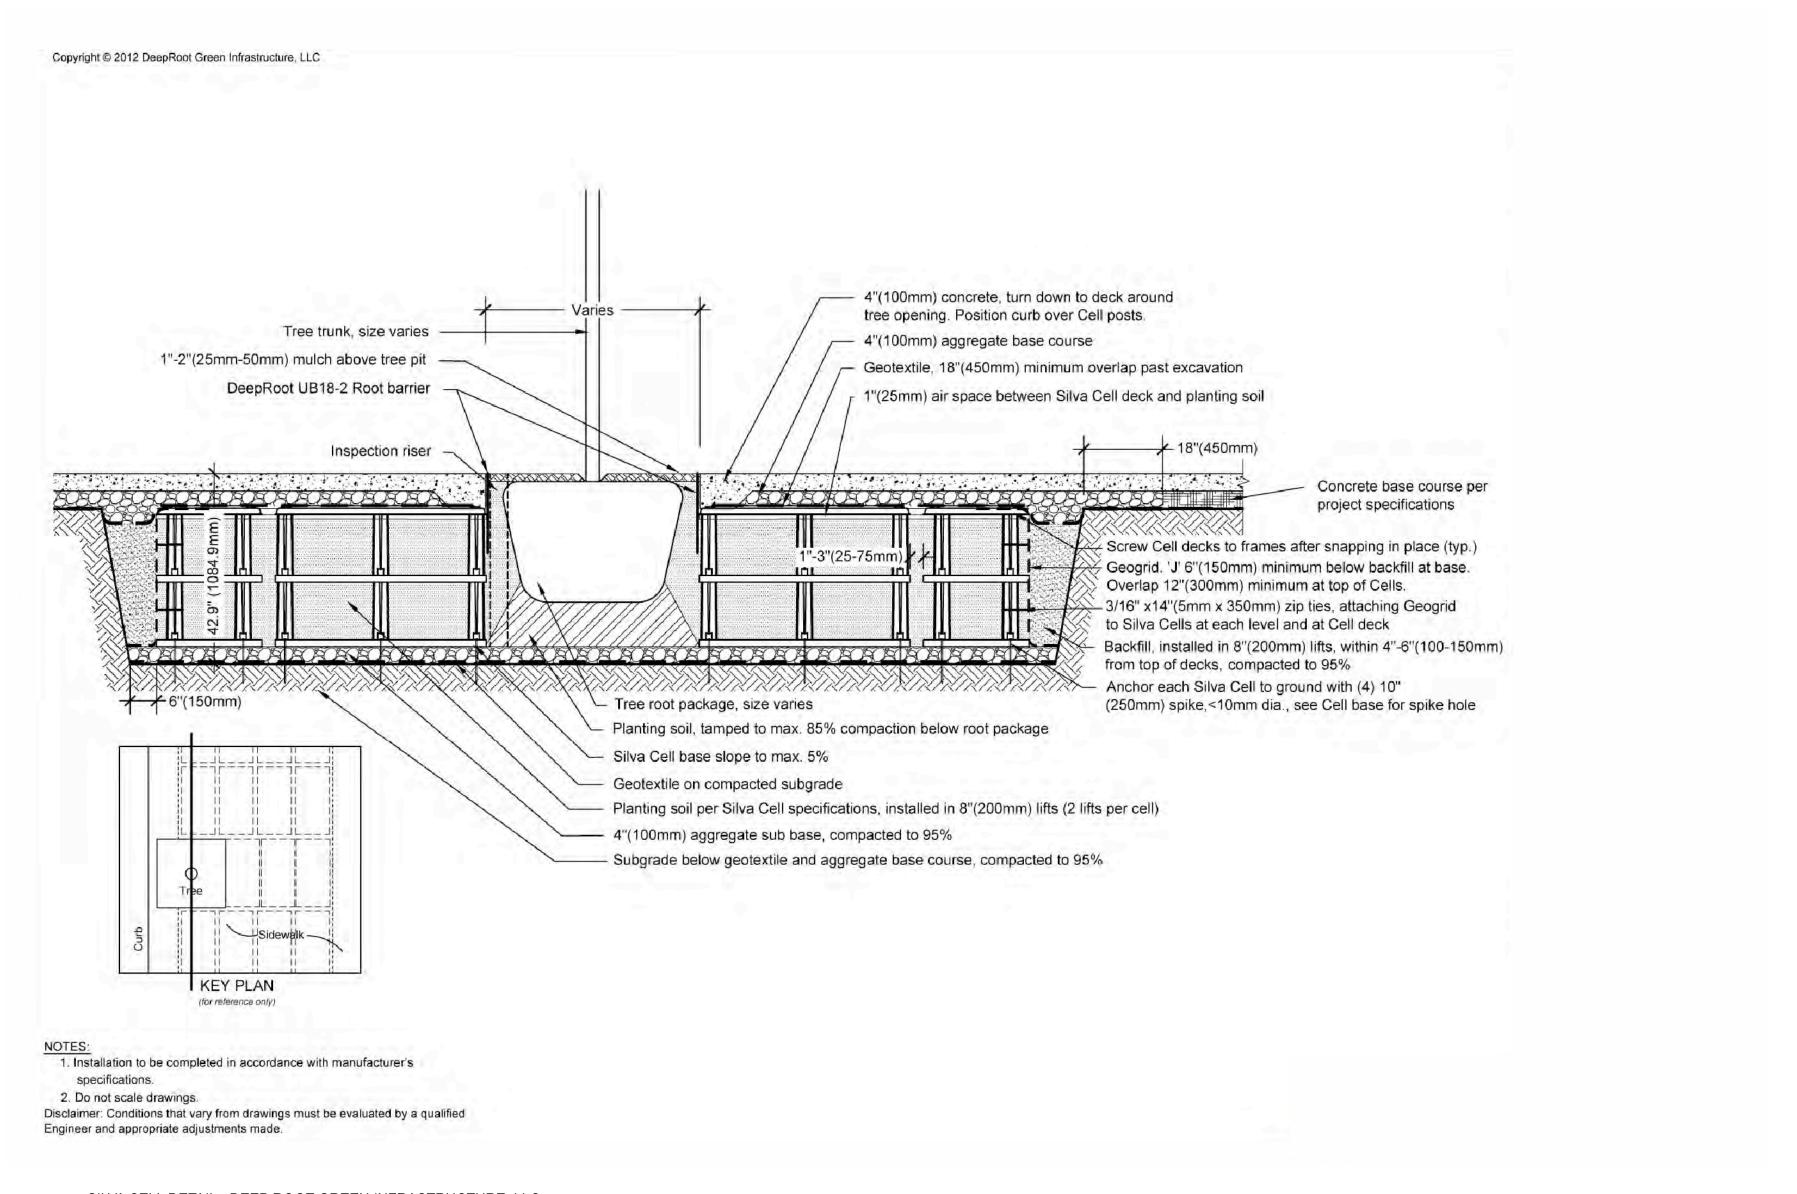SILVA CELL DETAIL - DEEP ROOT GREEN INFRASTRUCTURE, LLC



GROUND COVER PLANTING DETAIL

SCALE: N.T.S.

VINE PLANTING DETAIL

PROJECT

TORINO GARAGE

400 COLLINS AVE., MIAMI BEACH, FL 33139 Owner: Savoy Hotel Partners, LLC c/o Allied Partners 770 Lexington Ave 17th Floor New York, NY 10065-8165

Architect: Brandon Haw Architecture LLP 375 Park Avenue, Suite 3308 New York, NY 10152 License # AA26003249

CONSULTANTS

Structural Engineer: DeSimone 800 Brickell Avenue, 6th Floor Miami, FL 33131 MEP Engineer:

3915 Biscayne Blvd, Suite 401 Miami, FL 33137-3737

Civil Engineer: VSN Engineering, Inc. 8660 W. Flagler Street, Suite 113

Miami, FL 33144 Geo-tech Engineer:

Langan 15150 NW 79th Court, Suite 200

Miami Lakes, FL 33016-5848

Life Safety Consultant: SLS Consulting, Inc. 260 Palermo Avenue

Coral Gables, FL 33134 Parking Consultant: Timothy Haahs & Associates, Inc.

40 NW 3rd Street, Suite 1102 Miami, FL 33128 **Elevator Consultant:** Van Deusen & Associates, Inc.

8201 Peters Road, Suite 1000 Plantation, FL 33324 **Acoustic Consultant:** Electro-Media Design, Ltd. 973-C Russell Avenue Gaithersburg, MD 20879

Landscape Architect: Naturalficial, Inc. 6915 Red Road, Suite 224 Coral Gables, FL 33143 Contact: Andres Arcila O: 786.717.6564 / M: 305.321.2341

Firm Reg. No. LC26000548 NO. DESCRIPTION

DATE OF ISSUE **DRAWN BY** PS & AR 04/15/2019

> **CHECKED BY** AA & PA


N.T.S. PROJECT NO. & TITLE

Project Title TORINO GARAGE

PROJECT STATUS

FINAL HISTORIC PRESERVATION **BOARD SUBMITTAL**

KEY PLAN

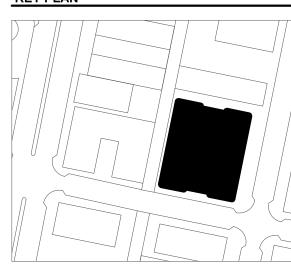


SCALE & ORIENTATION




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SEAL & SIGNATURE

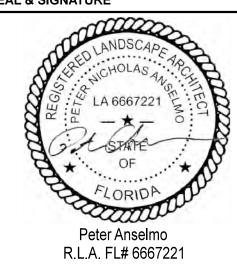

DRAWING TITLE

L-3.05 GENERAL PLANTING NOTES & SPECIFICATIONS

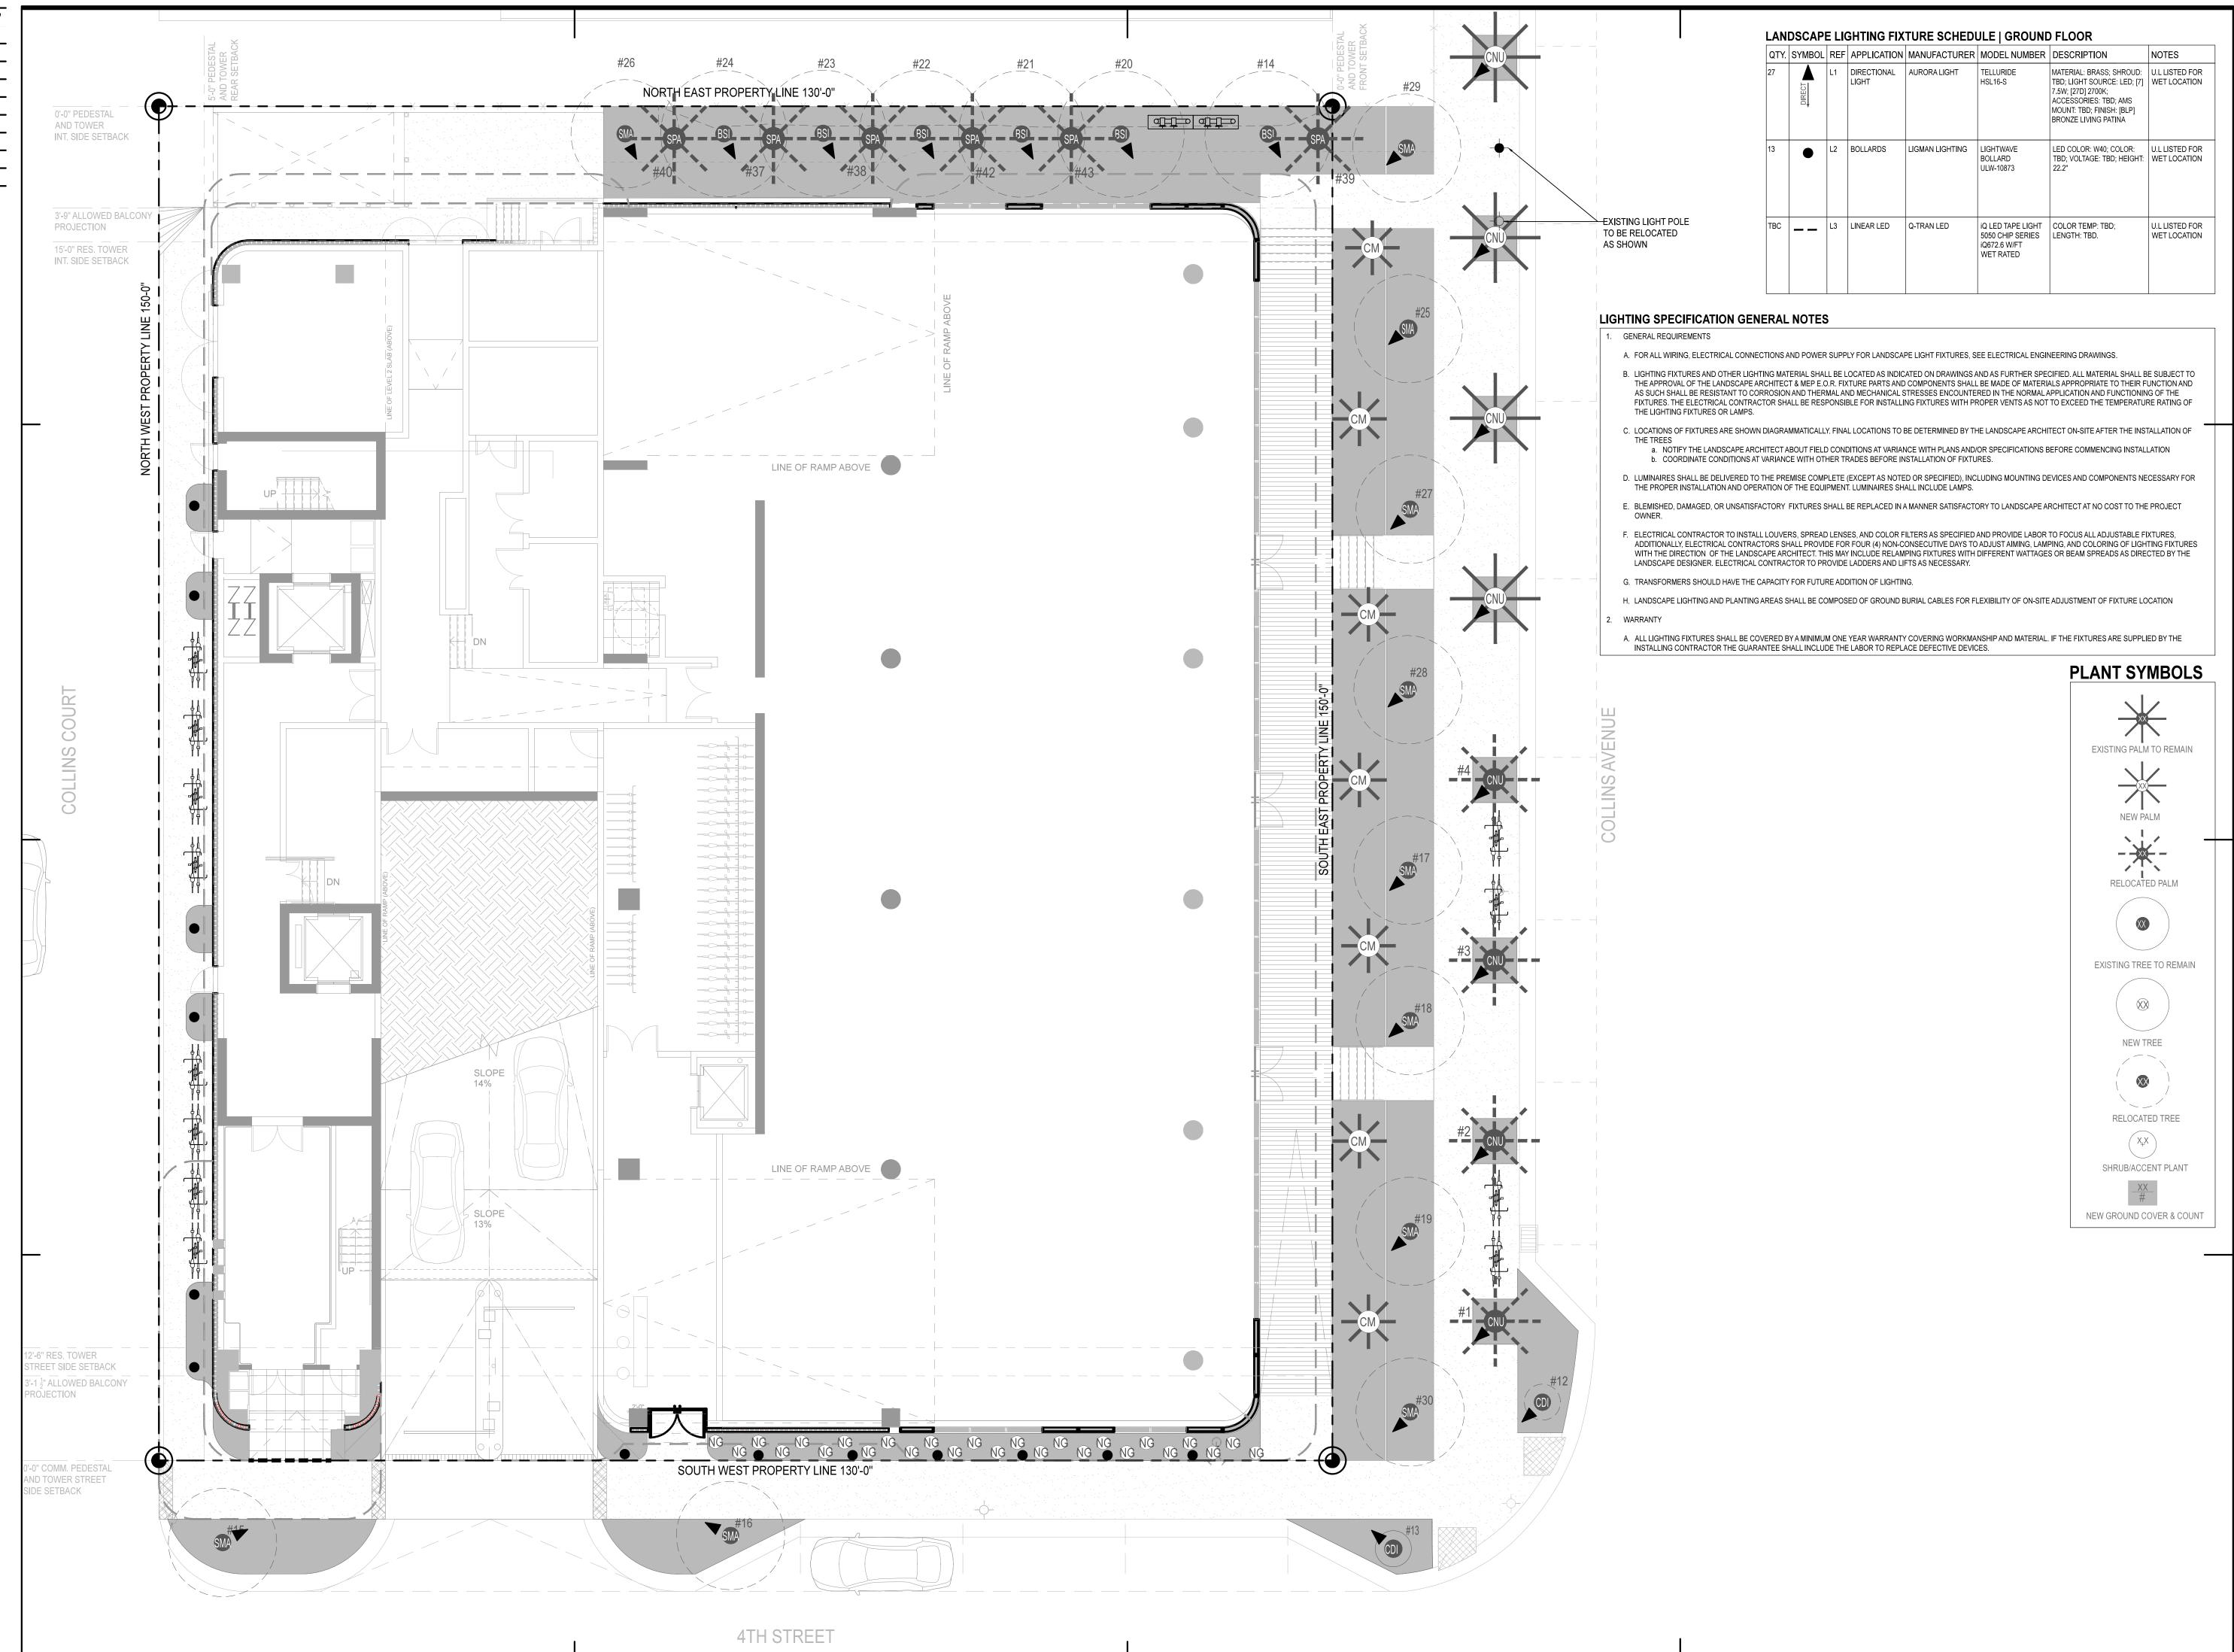

TORINO GARAGE

400 COLLINS AVE., MIAMI BEACH, FL 33139 Savoy Hotel Partners, LLC c/o Allied Partners

770 Lexington Ave 17th Floor New York, NY 10065-8165 Architect:

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Acoustic Consultant: Electro-Media Design, Ltd. 973-C Russell Avenue

Gaithersburg, MD 20879 Landscape Architect: Naturalficial, Inc.

6915 Red Road, Suite 224 Coral Gables, FL 33143 Contact: Andres Arcila

O: 786.717.6564 / M: 305.321.2341 Firm Reg. No. LC26000548

DESCRIPTION

DATE OF ISSUE DRAWN BY

> **CHECKED BY** AA & PA 1/8" = 1'-0" PROJECT NO. & TITLE


PS & AR

Project Title TORINO GARAGE

PROJECT STATUS FINAL HISTORIC PRESERVATION BOARD SUBMITTAL

KEY PLAN

04/15/2019

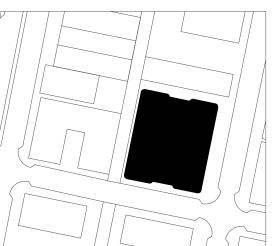

SCALE & ORIENTATION



TRUE NORTH: 10.78 DEG




SEAL & SIGNATURE



R.L.A. FL# 6667221 DRAWING TITLE

L-4.01 GROUND LVL LANDSCAPE

LIGHTING PLAN

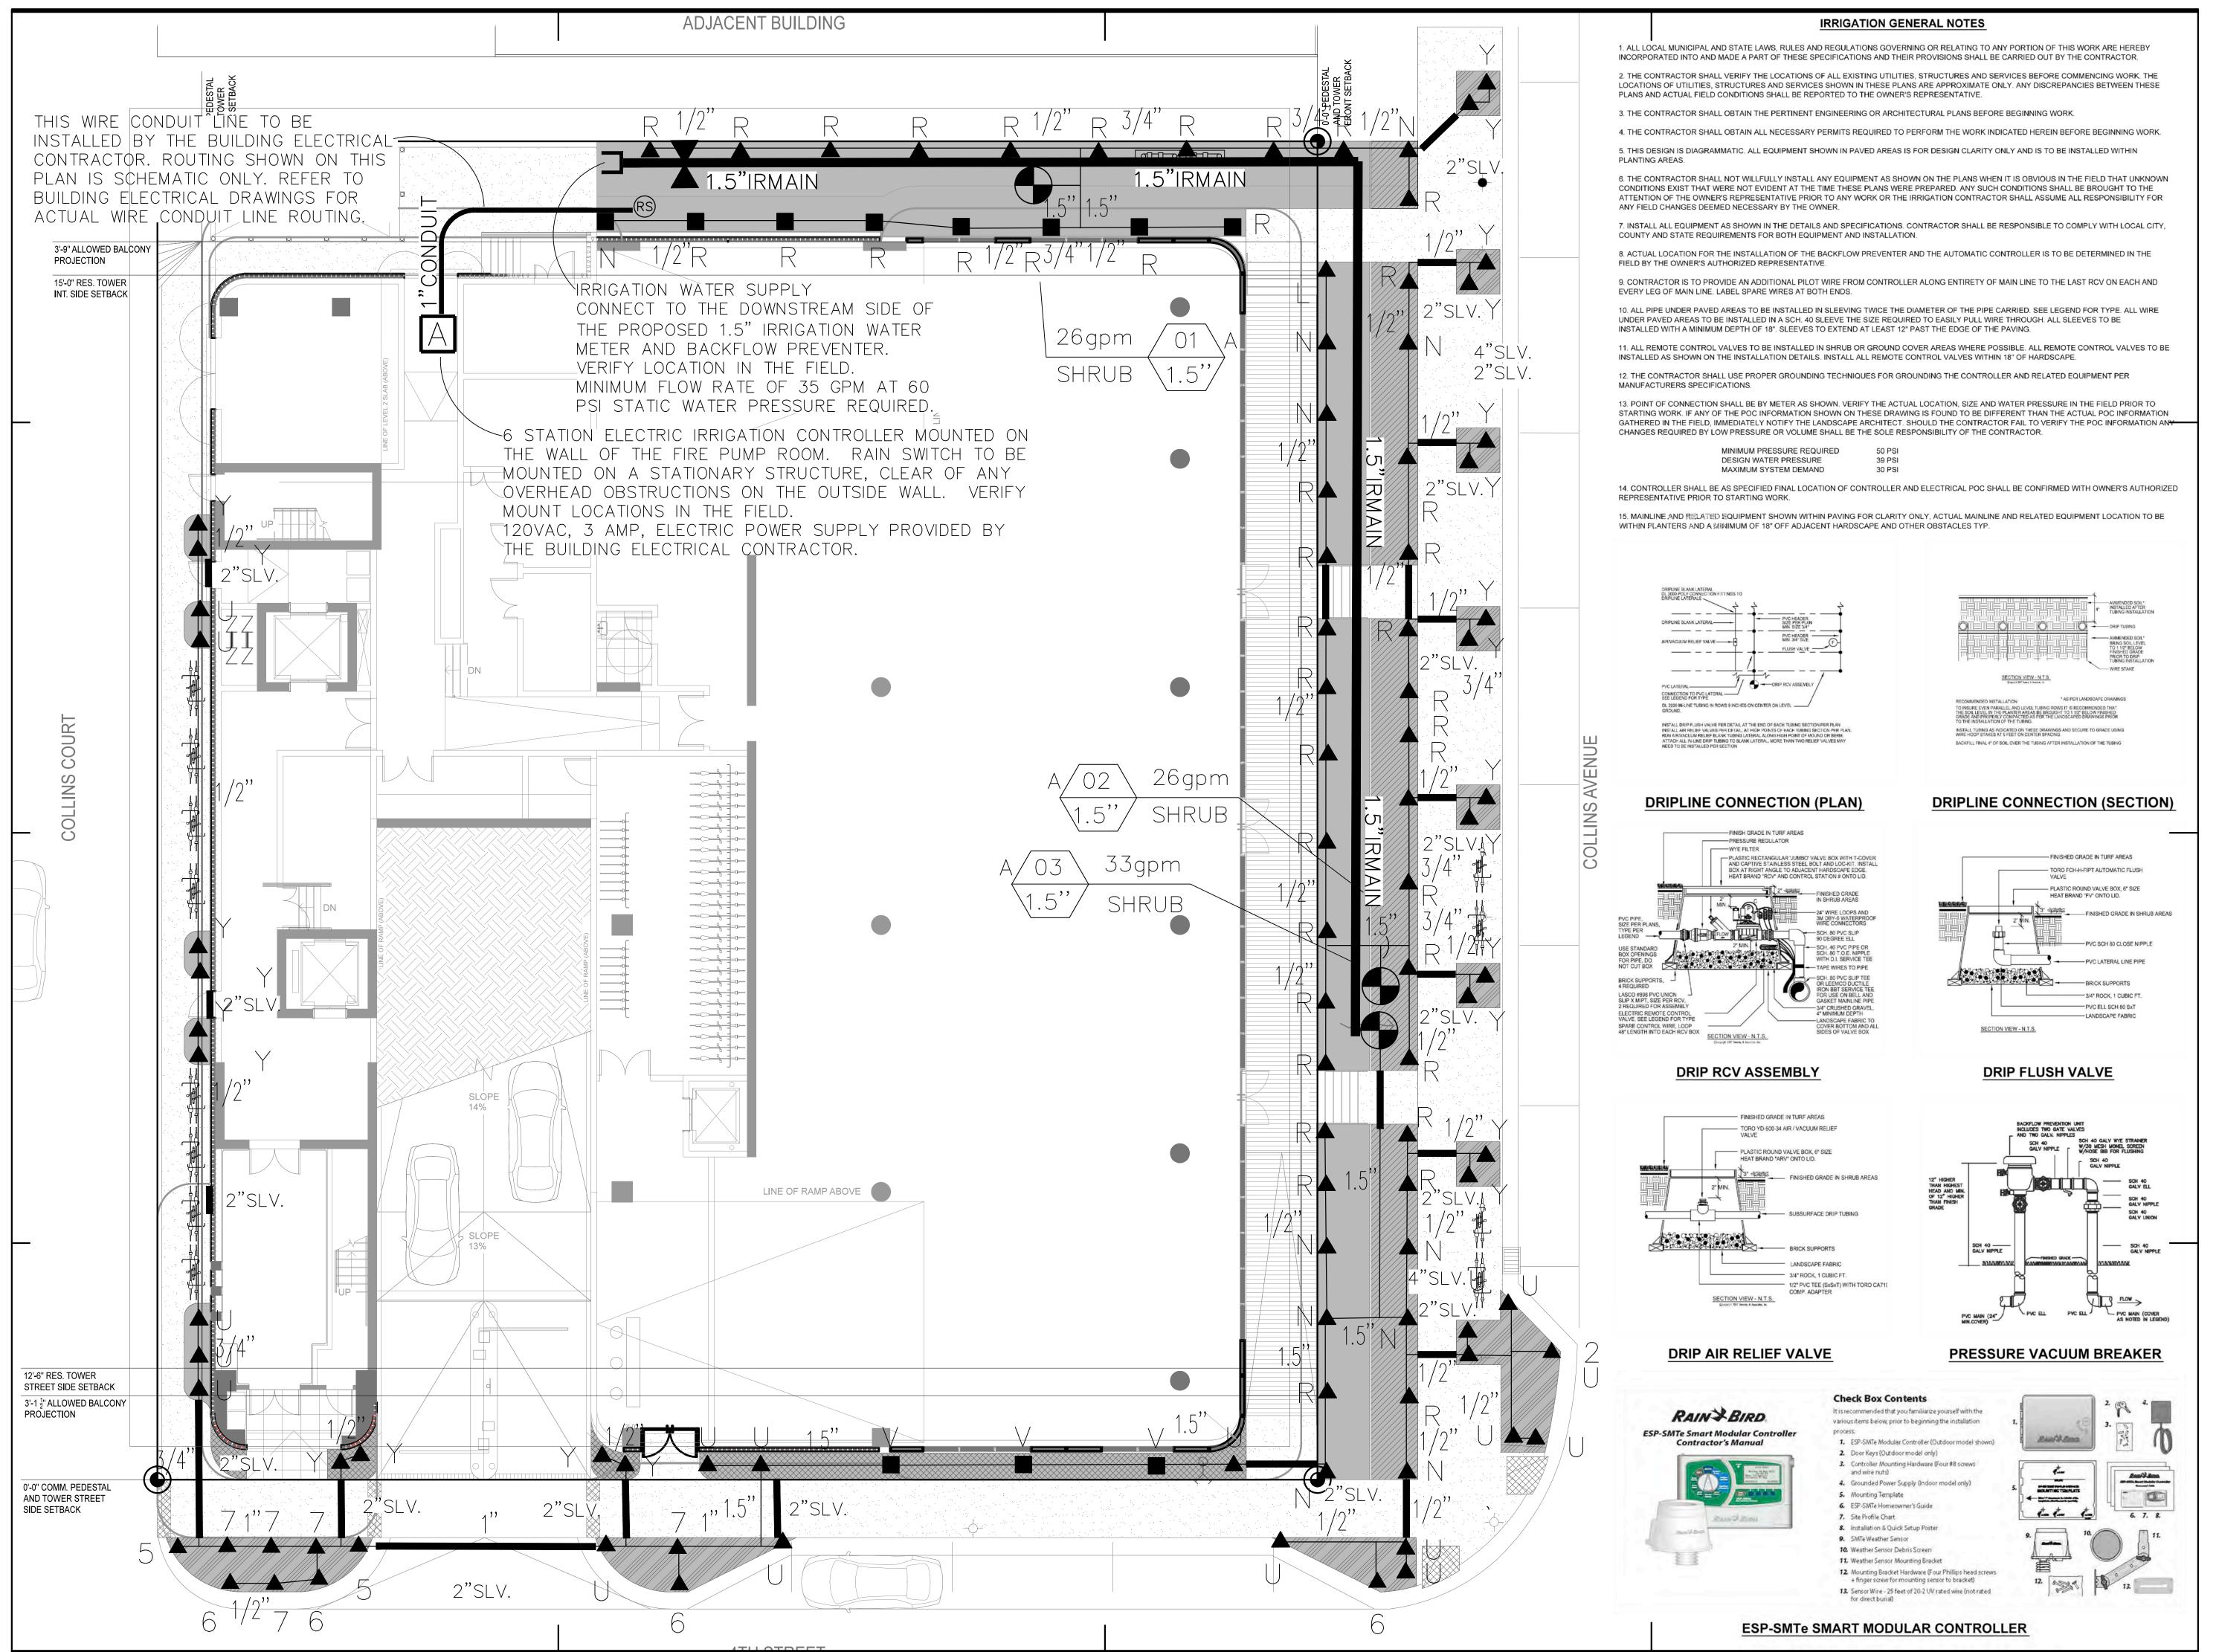

TORINO GARAGE

400 COLLINS AVE., MIAMI BEACH, FL 33139

Owner:
Savoy Hotel Partners, LLC c/o Allied Partners
770 Lexington Ave
17th Floor

New York, NY 10065-8165

Architect:
Brandon Haw Architecture LLP 375 Park Avenue, Suite 3308
New York, NY 10152

License # AA26003249 CONSULTANTS

Structural Engineer: DeSimone 800 Brickell Avenue, 6th Floor Miami, FL 33131

MEP Engineer: Stantec 3915 Biscayne Blvd, Suite 401 Miami, FL 33137-3737

Geo-tech Engineer:

Life Safety Consultant:

SLS Consulting, Inc.

260 Palermo Avenue Coral Gables, FL 33134

Parking Consultant:

Elevator Consultant:

Plantation, FL 33324

Acoustic Consultant: Electro-Media Design, Ltd. 973-C Russell Avenue Gaithersburg, MD 20879 Landscape Architect: Naturalficial, Inc.

6915 Red Road, Suite 224

Firm Reg. No. LC26000548

O. DESCRIPTION

O: 786,717,6564 / M: 305,321,2341

DRAWN BY

CHECKED BY

PS & AR

Coral Gables, FL 33143 Contact: Andres Arcila

DATE OF ISSUE

04/15/2019

1/8" = 1'-0"

PROJECT NO. & TITLE

PROJECT STATUS

BOARD SUBMITTAL

SCALE & ORIENTATION

TRUE NORTH: 10.78 DEG

SEAL & SIGNATURE

KEY PLAN

Project Title TORINO GARAGE

FINAL HISTORIC PRESERVATION

Miami, FL 33128


Civil Engineer: VSN Engineering, Inc. 8660 W. Flagler Street, Suite 113 Miami, FL 33144

15150 NW 79th Court, Suite 200 Miami Lakes, FL 33016-5848

Timothy Haahs & Associates, Inc.

40 NW 3rd Street, Suite 1102

Van Deusen & Associates, Inc. 8201 Peters Road, Suite 1000

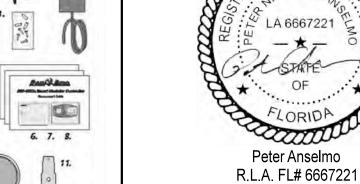

DRAWING TITLE

IR-1.01
GROUND LVL IRRIGATION
PLAN