OUEET NO	OUEET NAME
SHEET NO.	SHEET NAME
1	COVER SHEET
2	BLANK
3	PROPERTY SURVEY
4	PROJECT DATA AND ZONING PLAN
5	CONTEXT LOCATION PLAN
6	FAR CALCULATIONS
7	SITE PLAN
8	BLANK
9	PROJECT SITE PHOTOGRAPHY
10	CONTEXT PHOTOGRAPHY
11	CONTEXT PHOTOGRAPHY
12	CONTEXT PHOTOGRAPHY
13	CONTEXT PHOTOGRAPHY
14	CONTEXT PHOTOGRAPHY
15	BLANK
16	MATERIALS
17	MATERIALS
18	FLOORPLAN I GROUND LEVEL
19	FLOORPLAN I FIRST LEVEL
20	FLOORPLAN I SECOND LEVEL
21	FLOORPLAN I THIRD LEVEL
22	FLOORPLAN I ROOF PLAN
23	BLANK
24	WEST ELEVATION
25	SOUTH ELEVATION
26	EAST ELEVATION
27	NORTH ELEVATION
28	BUILDING SECTION
29	BUILDING SECTION
30	COLORED RENDERINGS
31	COLORED ELEVATION
32	LANDSCAPE - TREE & PALM PLAN
33	LANDSCAPE - UNDERSTORY TREE PLAN
34	LANDSCAPE - UNDERSTORY PLAN
35	LANDSCAPE - HARDSCAPE
36	NEIGHBORHOOD CONTEXT STUDY
37	NEIGHBORHOOD CONTEXT STUDY
38	YARD SECTION DRAWINGS
39	LOT COVERAGE DIAGRAM
40	BLANK
41	VARIANCE DIAGRAM I PARKING
42	VARIANCE DIAGRAM I PARKING
43	VARIANCE DIAGRAM I PARKING
44	VARIANCE DIAGRAM I PARKING
45	VARIANCE DIAGRAM I YARD ELEVATION



# **1425 BAY ROAD TOWNHOUSES**

## **DESIGN REVIEW BOARD**

FINAL SUBMITTAL


SCOPE: CONSTRUCTION OF A NEW 4-STORY 3 UNIT TOWNHOUSE BUILDING

> PLAN NUMBER: DRB18-0349

SUBMITTAL DEADLINE (REVISION): MARCH 12<sup>th</sup>, 2019

McKENZIE grayscale

DESIGN REVIEW BOARD SUBMISSION (REVISED) MARCH 12, 2019

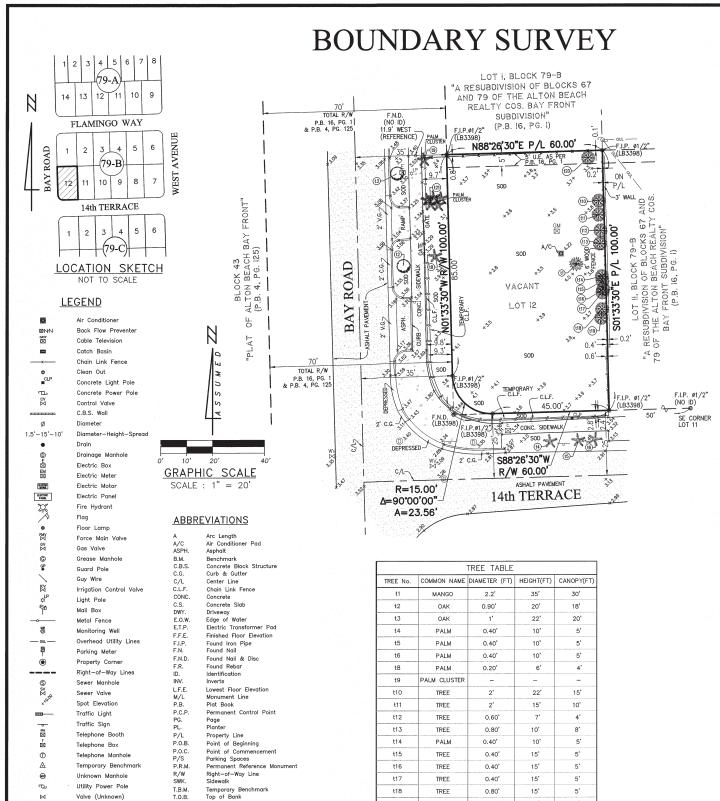

t18

t19

t20

t21

TREE

TREE

TREE

0.80

0.80

2.5'

TREE TABLE

15'

15'

18'

15'

### SURVEYOR'S NOTES:

1. Field Survey was completed on: November 14th, 2018.

Lot 12, Block 79-B, RESUBDIVISION OF BLOCKS 67 AND 79 OF ALTON BEACH REALTY COMPANY'S BAY FRONT SUBDIVISION, according to the Plat thereof, as recorded in Plat Book 16, at Page 1, of the Public Records of Miami-Dade County, Florida.

Containing 5,952 Square feet or 0.14 Acres, more or less, by calculation.

### 3. SOURCES OF DATA:

### AS TO HORIZONTAL CONTROL

North Arrow and Begrings refer to an assumed value of S01\*33'30"E along the Easterly line of the Subject Property, Miami-Dade County, Florida. Said line is considered well-established and

### AS TO VERTICAL CONTROL:

By scaled determination the subject property lies in Flood Zone AE, Base Flood Elev.= 8 feet, as per Federal Emergency Management Agency (FEMA) Community-Panel Number 120651, Map No. 12086C0317, Suffix L, Revised Date: 09-11-2009.

No. 12085C0317, SUTTIX L, Revised Date: 09-11-2009.
An accurate Zone determination should be made by the preparer of the map, the Federal Emergency Management Agency, or the Local Government Agency having jurisdiction over such matters prior to any judgments being made from the Zone as noted. The referenced Federal Emergency Management Agency Map states in the notes to the user that "this map is for insurance purposes only".

The vertical control element of this survey was derived from the National Geodetic Vertical Datum 1929 (N.G.V.D.1929).

Benchmark used: City of Miami Beach Benchmark: 13-05-R Elevation: 3.50 feet (Adjusted to N.G.V.D. 1929) Location: N.E. INTX 11th Street & West Avenue

The accuracy obtained by measurement and calculation of closed geometric figures was found

The above Legal Description provided by client.

Since no other information other than what is cited in the Sources of Data was furnished, Since no other information other than what is cited in the Sources of Data was Turnished, the Client is hereby advised that there may be legal restrictions on the Subject Property that are not shown on the Survey Map or contained within this Report that may be found in the Public Records of Miami-Dade County, or the records of any other public and private entities as their jurisdictions may appear. The Surveyor makes no representation as to ownership or possession of the Subject Property by any entity or individual who may appear in public records. No excavation or determination was made as to how the Subject Property is served by utilities. No improvements were located, other than those shown. No underground foundations, improvements and/or utilities were located or shown hereon. This notice is required by the "Standards of Practice for Land Surveying in the State of

Florida", pursuant to Rule 5J-17 of the Florida Administrative Code.

Notice is hereby given that Sunshine State One Call of Florida, Inc. must be contacted at 1-800-432-4770 at least 48 hours in advance of any construction, excavation or demolition activity within, upon, abutting or adjacent to the Subject Property. This Notice is given in compliance with the "Underground Facility Damage Prevention and Safety Act," pursuant to Chapter 556.101-111 of the Florida Statutes.

- -Bay West 1 LLC, a Florida limited liability company -Siegfried, Rivera, Hyman, Lerner, De La Torre, Mars & Sobel, P.A. -Old Republic National Title Insurance Company
- -Grove Bank & Trust, ISAOA/ATIMA

## SURVEYOR'S CERTIFICATE:

I HEREBY CERTIFY: That the Boundary Survey of the above described property is true and correct to the best of my knowledge and belief as recently surveyed under my direction. Further, there are no above ground encroachments unless shown. This survey meets the Standards of Practice set forth by the Florida Board of Professional Surveyors and Mappers, in Chapter 5J-17, Florida Administrative Code, pursuant to section 472.027 Florida Statutes. Examination of the abstract of title will have to be made to determine recorded instruments, if any, offecting the property. Location and identification of utilities adjacent to the property were not secured as such information was not requested. Ownership is subject to opinion of title.

### J. BONFILL & ASSOCIATES, INC. Florida Certificate of Authorization No. LB 3398

ORIA JANNET SUAREZ

PROFESSIONAL SURVEYOR AND MAPPER No. 6781 STATE OF FLORIDA

Not valid without the signature and the original raised seal of a Florida Licensed Surveyor and Mapper. Additions or deletions to survey maps or reports by other than the signing party or parties is prohibited without written consent of the signing party or parties.



Il & Associates, Inc.
LAND SURVEYORS & MAPPERS
ficate of Authorization LB3398
W. 99th Avenue Suite 104
orida 33173 (305) 598-8383 J. Bonfill & A Florida Certifica 7100 S.W. Miami, Florid

> 39 , MIAMI BEACH, TTY, FLORIDA 3313 SUR BOUNDAR 5 BAY F-DADE

REVISIONS BY

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	Checked: J.S.	
	Scale: AS SHO	NWC
	Field Book: ON F	ILE
	SHEET 1 OF 1	

McKENZIE grayscale

Utility Power Pole

Valve (Unknown)

Water Manhole

Water Meter

Water Pump

Temporary Benchmark Top of Bank

Wood Fence

Calculated

(C)

DESIGN REVIEW BOARD SUBMISSION (REVISED)

3

MIAMIBEACH

Planning Department, 1700 Convention Center Drive Miami Beach, Florida 33139, www.miamibeachfl.gov 305.673.7550

## **MULTIFAMILY - COMMERCIAL - ZONING DATA SHEET**

ITEM #	Zoning Information			
1	Address:	1425 BAY ROAD MIAMI BEACH, F	LORIDA 33139	
2	Board and file numbers :			
3	Folio number(s):	02-3233-016-0420		
4	Year constructed:	N/A	Zoning District:	RM-1 MULTI-FAMILY, LOW INTENSITY
5	Based Flood Elevation:	AE 8 FT NGVD	Grade value in NGVD:	3.34 NGVD
6	Adjusted grade (Flood+Grade/2):	AE 9 FT NGVD	Lot Area:	5,952 SQ FT
7	Lot width:	60 FT	Lot Depth:	100 FT
8	Minimum Unit Size	550 SQ FT	Average Unit Size	825 SQ FT
9	Existing use:	N/A	Proposed use:	MULTI-FAMILY RESIDENCE

		Maximum	Existing	Proposed	Deficiencies
10	Height	50 FT		50 FT	
11	Number of Stories	4		4	
12	FAR	7440 SQ FT		7440 SQ FT	
13	Gross square footage	N/A		7440 SQ FT	
14	Square Footage by use	N/A		N/A	
15	Number of units Residential	N/A		3	
16	Number of units Hotel	N/A		0	
17	Number of seats	N/A		0	
18	Occupancy load	N/A		N/A	

	Setbacks	Required	Existing	Proposed	Deficiencies
	Subterranean:				
19	Front Setback:	20 FT		20 FT	
20		7.5 FT OR 8% OF LOT WIDTH,			
	Side Setback:	WHICHEVER IS GREATER		7.5 FT	
21		7.5 FT OR 8% OF LOT WIDTH,			
	Side Setback facing street:	WHICHEVER IS GREATER		7.5 FT	
22		10% OF LOT DEPTH (NON-			
	Rear Setback:	OCEANFRONT LOTS)		10 FT	
	At Grade Parking:				
23	Front Setback:	20 FT		N/A	
24	Side Setback:	5 FT		N/A	
25	Side Setback facing street:	5 FT		N/A	
26	Rear Setback:	10% OF LOT DEPTH		N/A	
	Pedestal:				
27	Front Setback:	20 FT		20 FT	
28		7.5 FT OR 8% OF LOT WIDTH,			
	Side Setback:	WHICHEVER IS GREATER		7.5 FT	
29		7.5 FT OR 8% OF LOT WIDTH,			
	Side Setback facing street:	WHICHEVER IS GREATER		7.5 FT	
30		10% OF LOT DEPTH (NON-			
	Rear Setback:	OCEANFRONT LOTS)		10 FT	
	Tower:				
31	Front Setback:			N/A	
32	Side Setback:			N/A	
33	Side Setback:			N/A	
34	Side Setback facing street:			N/A	
35	Rear Setback:			N/A	

Planning Department, 1700 Convention Center Drive Miami Beach, Florida 33139, www.miamibeachfl.gov 305.673.7550

	Parking	Required	Existing	Proposed	Deficiencies
36	Parking district	N/A			
37	Total # of parking spaces	NONE		6	
38	# of parking spaces per use (Provide				
	a separate chart for a breakdown				
	calculation)	NONE		N/A	
39	# of parking spaces per level				
	(Provide a separate chart for a				
	breakdown calculation)	NONE		N/A	
40	Parking Space Dimensions	8' - 6" x 18' - 0"		8' - 10" x 18' - 0"	
41	Parking Space configuration				
	(450,600,900,Parallel)	N/A		90°	
42	ADA Spaces	NONE		NONE	
43	Tandem Spaces	NONE		NONE	
44					VARIANCE REQUEST
	Drive aisle width	22' - 0"		19' - 0"	#01
45	Valet drop off and pick up	NONE		NONE	
46	Loading zones and Trash collection				
	areas	NONE		1 PER UNIT	
47	Bicycle parking, location and				
	Number of racks	NONE		2 PER UNIT	

	Restaurants, Cafes, Bars, Lounges,				
	Nightclubs	Required	Existing	Proposed	Deficiencies
48	Type of use			N/A	
49	Total # of seats			N/A	
50	Total # of seats per venue (Provide a				
	separate chart for a breakdown				
	calculation)			N/A	
51	Total occupant content			N/A	
52	Occupant content per venue				
	(Provide a separate chart for a				
	breakdown calculation)			N/A	
53					
54	Is this a contributing building?	NO			
55	Located within a Local Historic				
	District?			NO	

### Notes


1 of 2

If not applicable write N/A

All other data information may be required and presented like the above format.




## **FAR CALCULATIONS**

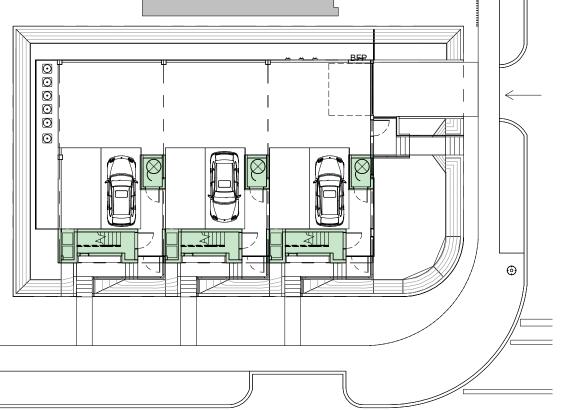



FAR CALCULATION PROPOSED PROJECT AREA TOTAL PER UNIT TOTAL (PER 3 UNITS) UNIT - GROUND LEVEL 161 SF 484 SF UNIT - SECOND LEVEL 2939 SF 980 SF UNIT - THIRD LEVEL 900 SF 2701 SF UNIT - FOURTH LEVEL 439 SF 1317 SF TOTAL PROJECT AREA: 2480 SF 7440 SF

1 GROUND LEVEL 3/64" = 1'-0"

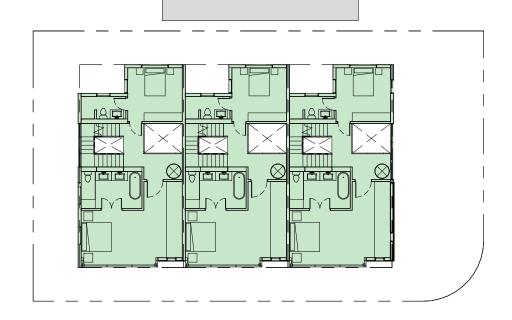

2 FIRST LEVEL 3/64" = 1'-0"



3 SECOND LEVEL 3/64" = 1'-0"


4 THIRD LEVEL 3/64" = 1'-0"

6

DESIGN REVIEW BOARD SUBMISSION (REVISED) MARCH 12, 2019

PROJECT ADDRESS 1425 BAY ROAD MIAMI BEACH, FL 33139



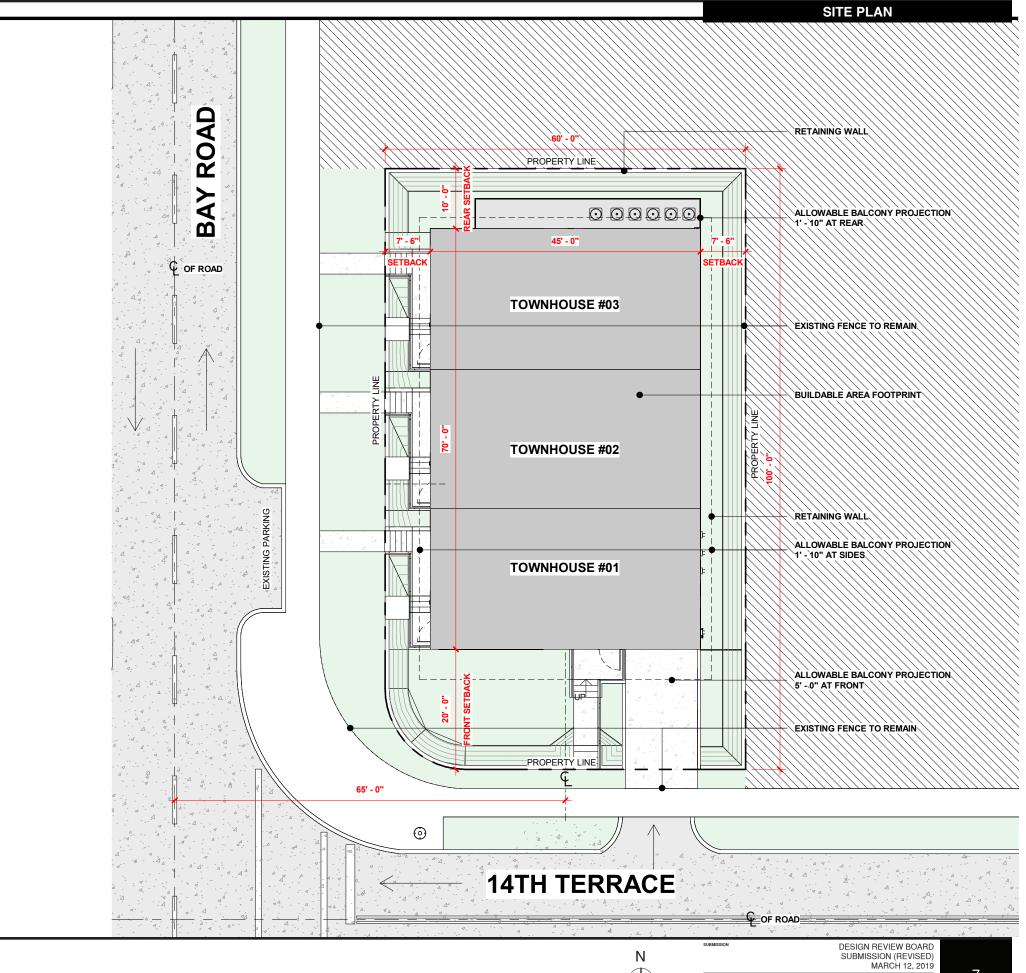





1 1425 BAY ROAD






4 1425 BAY ROAD

1425 BAY ROAD

5 1425 BAY ROAD

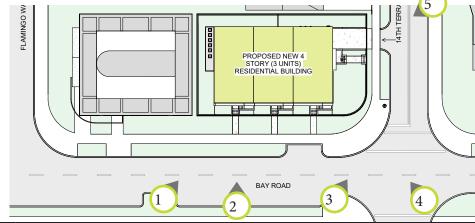





B1) 1425 BAY ROAD (SITE)

B2 1339 14TH TERRACE

B3 1331 14TH TERRACE B4 1321 14TH TERRACE B5 1311 14TH TERRACE B6 1427 WEST AVE

B7 1419 WEST AVE

(C1) 1400 / 1402 / 1404 BAY ROAD

C2 1401 BAY ROAD

C3 1331 14TH TERRACE C4 1312 14TH TERRACE

DESIGN REVIEW BOARD SUBMISSION (REVISED) MARCH 12, 2019

Ν







A1 1422 / 1424 / 1426 / 1428 / 1430 / 1423 / 1434 / 1436 / 1504 / 1536 BAY ROAD BAY ROAD

A2 1435 BAY ROAD

A3 1340 FLAMINGO WAY







A4 1330 FLAMINGO WAY

(A5) 1320 FLAMINGO WAY

A6 1310 FLAMINGO WAY







A7 1428 WEST AVE

A8 1439 WEST AVE

A9 1435 WEST AVE







(B1) 1425 BAY ROAD (SITE)

B2 1339 14TH TERRACE

B3 1331 14TH TERRACE







B4) 1321 14TH TERRACE

B5 1311 14TH TERRACE

B6 1427 WEST AVE







B7 1419 WEST AVE

(C1) 1400 / 1402 / 1404 BAY ROAD

C2 1401 BAY ROAD

## **CONTEXT PHOTOGRAPHY**






C3 1331 14TH TERRACE


C4 1312 14TH TERRACE

PHOTOGRAPHS TAKEN 11-15-18


1425 BAY ROAD MIAMI BEACH, FL 33139

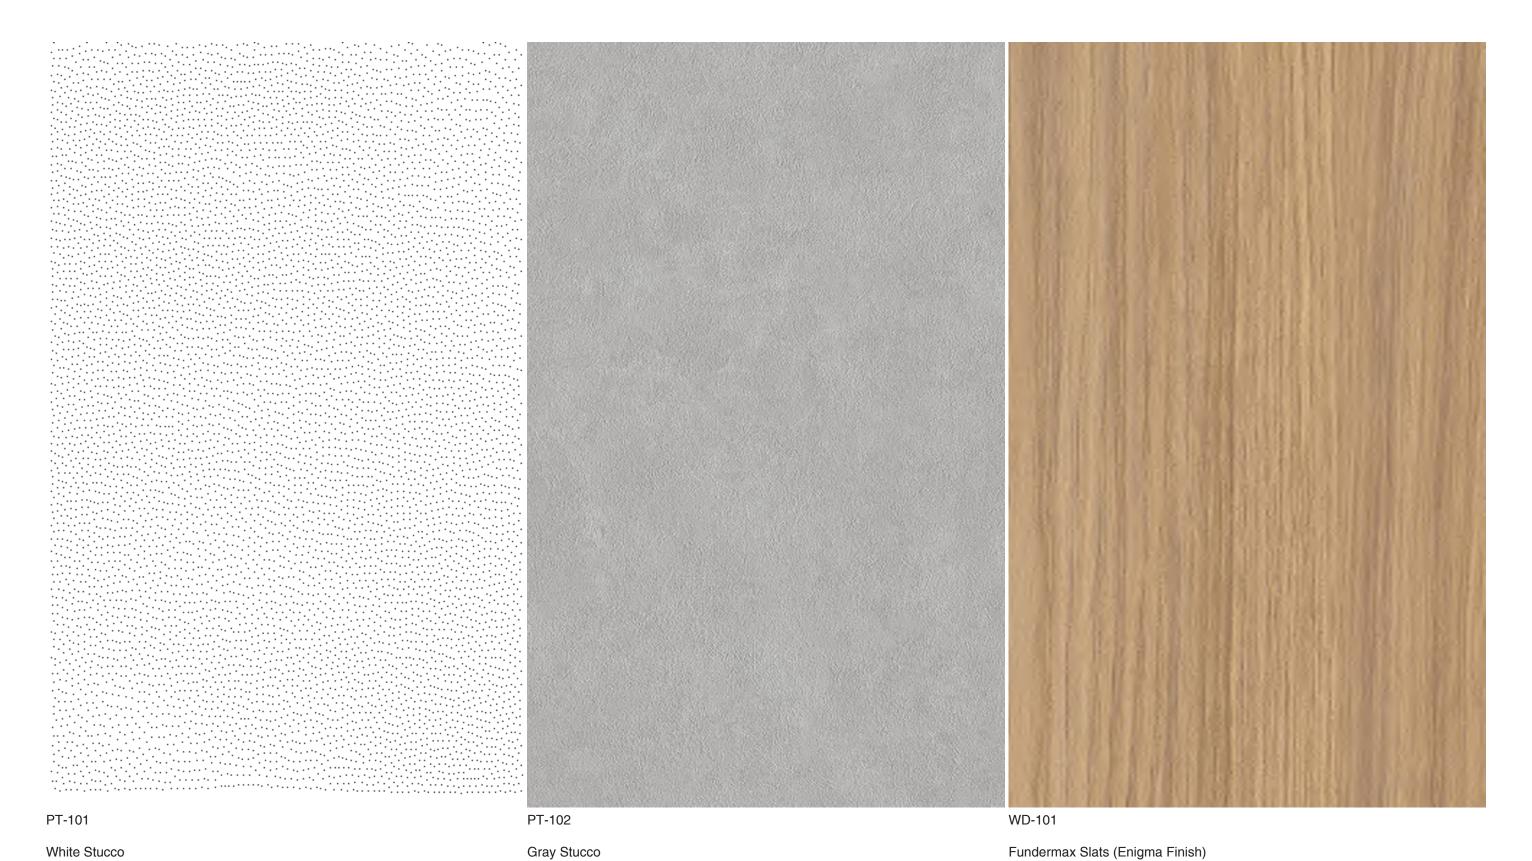



SUBMISSION	DESIGN REVIEW BOARD SUBMISSION (REVISED) MARCH 12, 2019
PROJECT ADDRESS	1425 BAY ROAD MIAMI BEACH, FL 33139

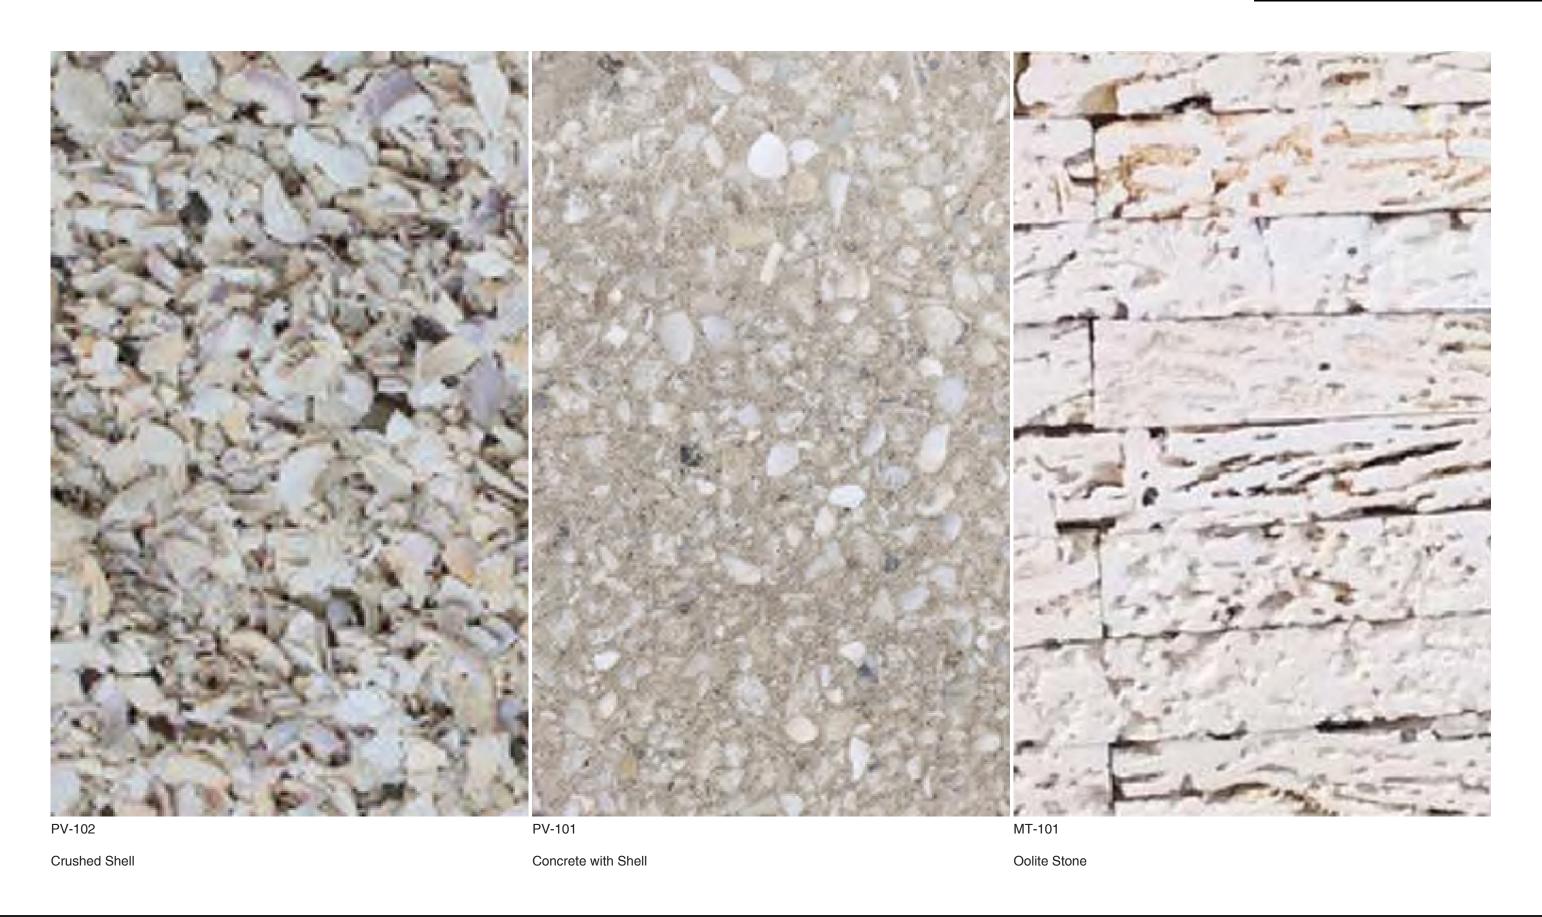


MCKENZIE grayscale

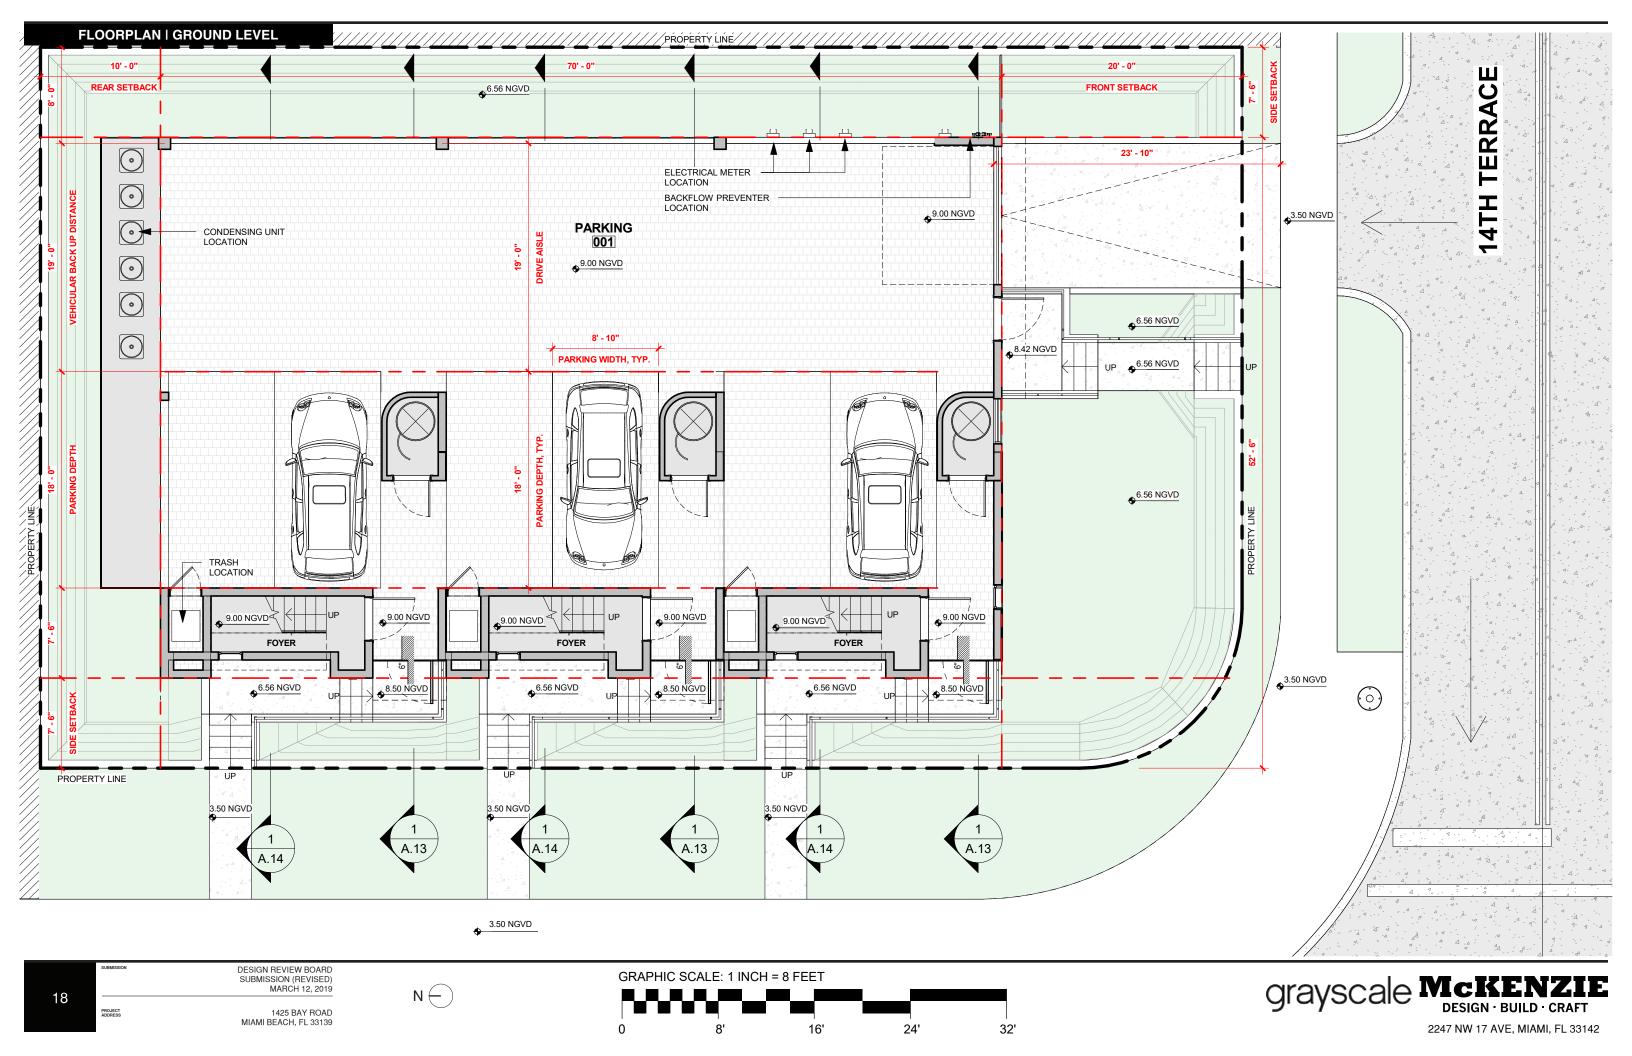


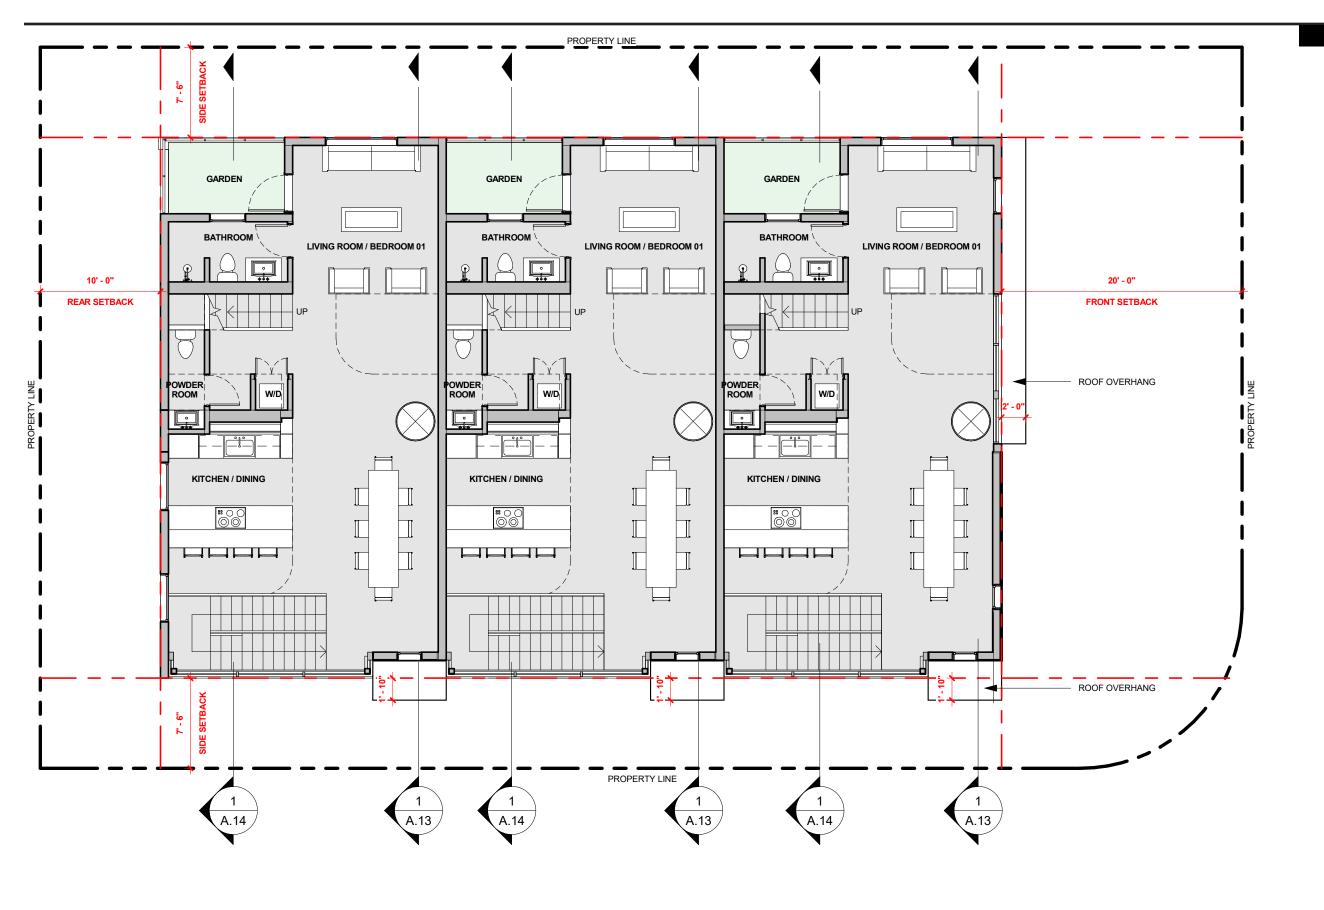


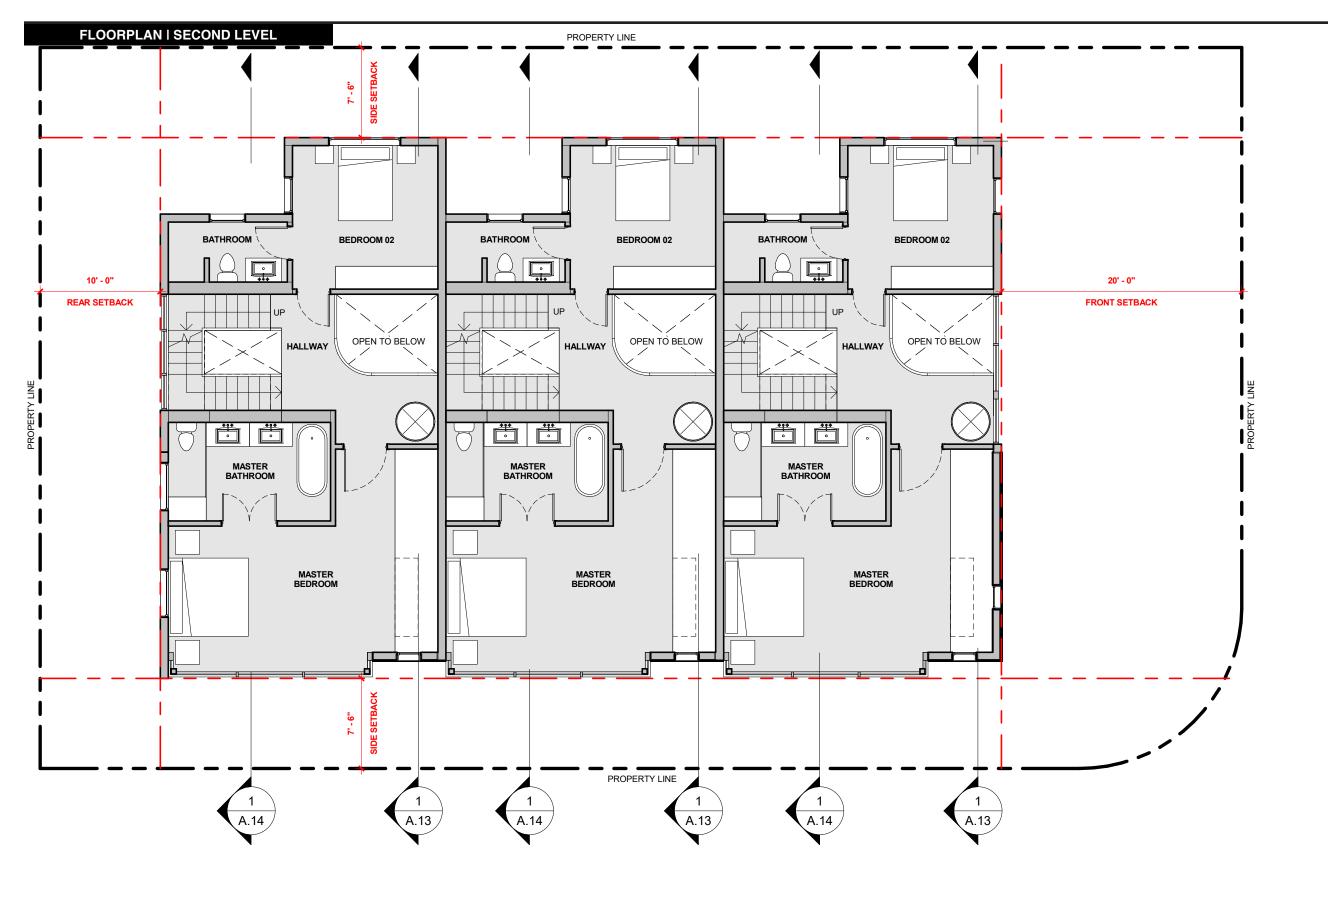



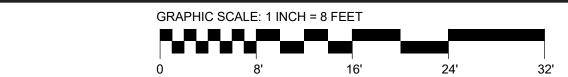

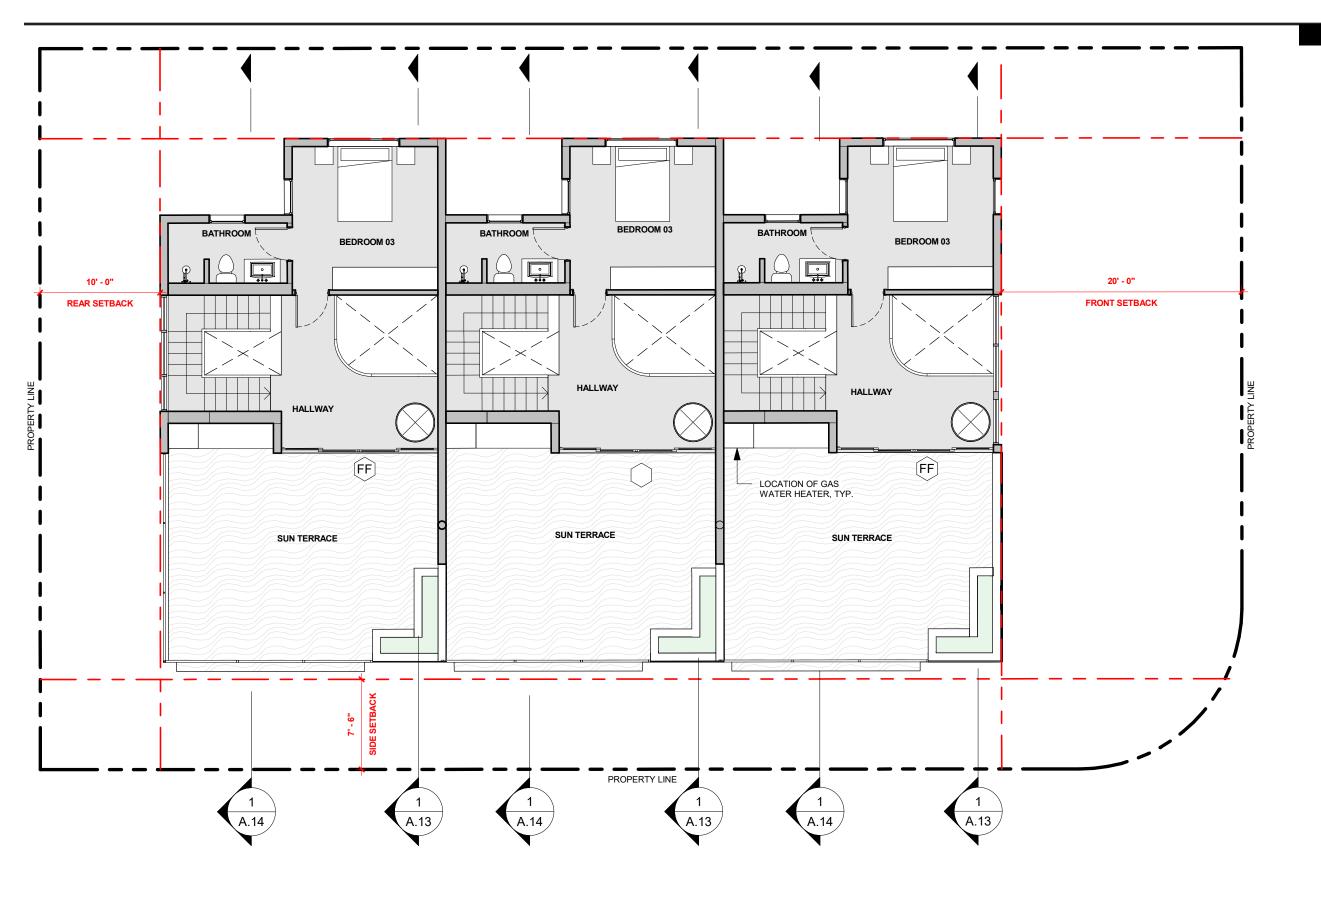


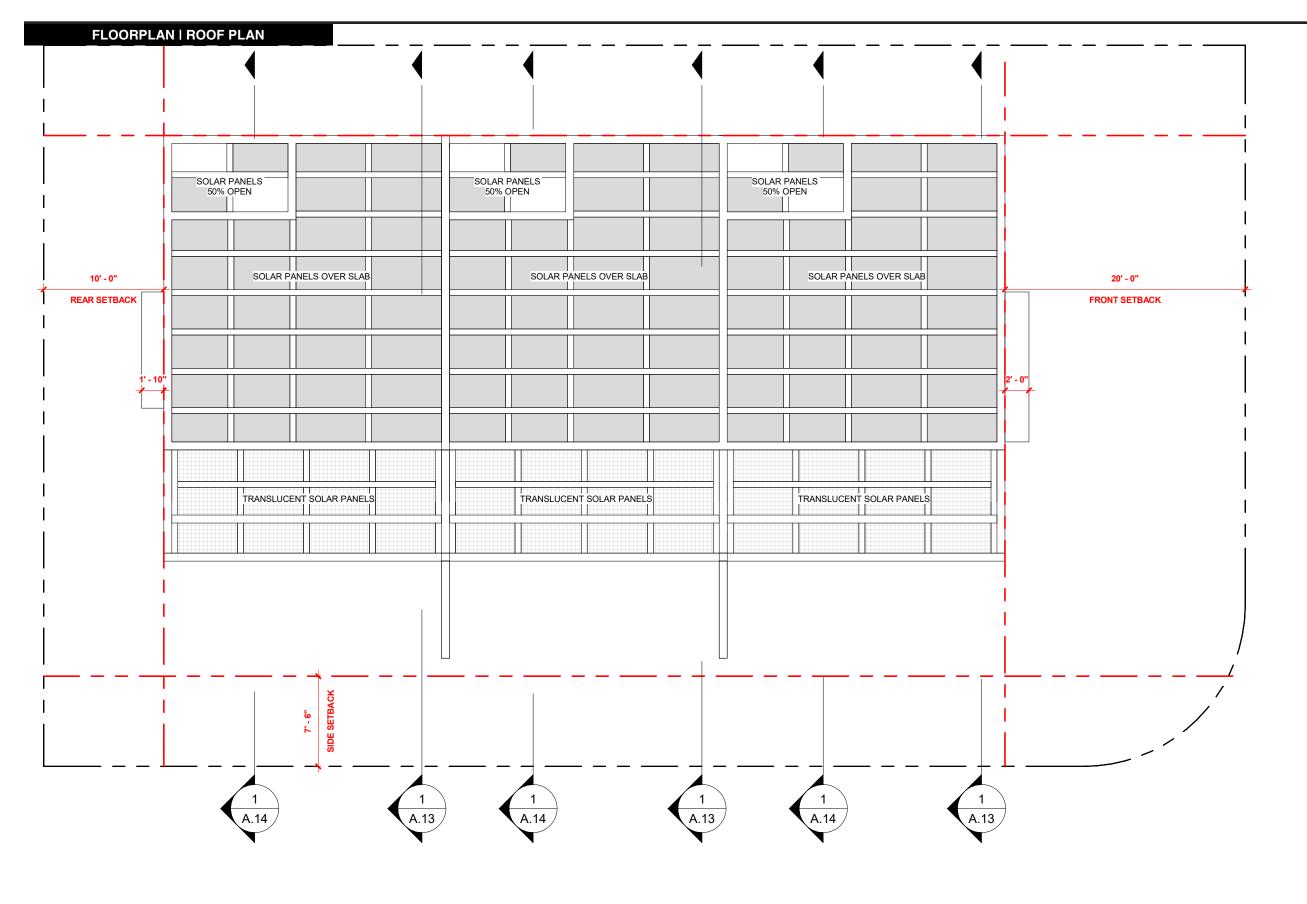






32'

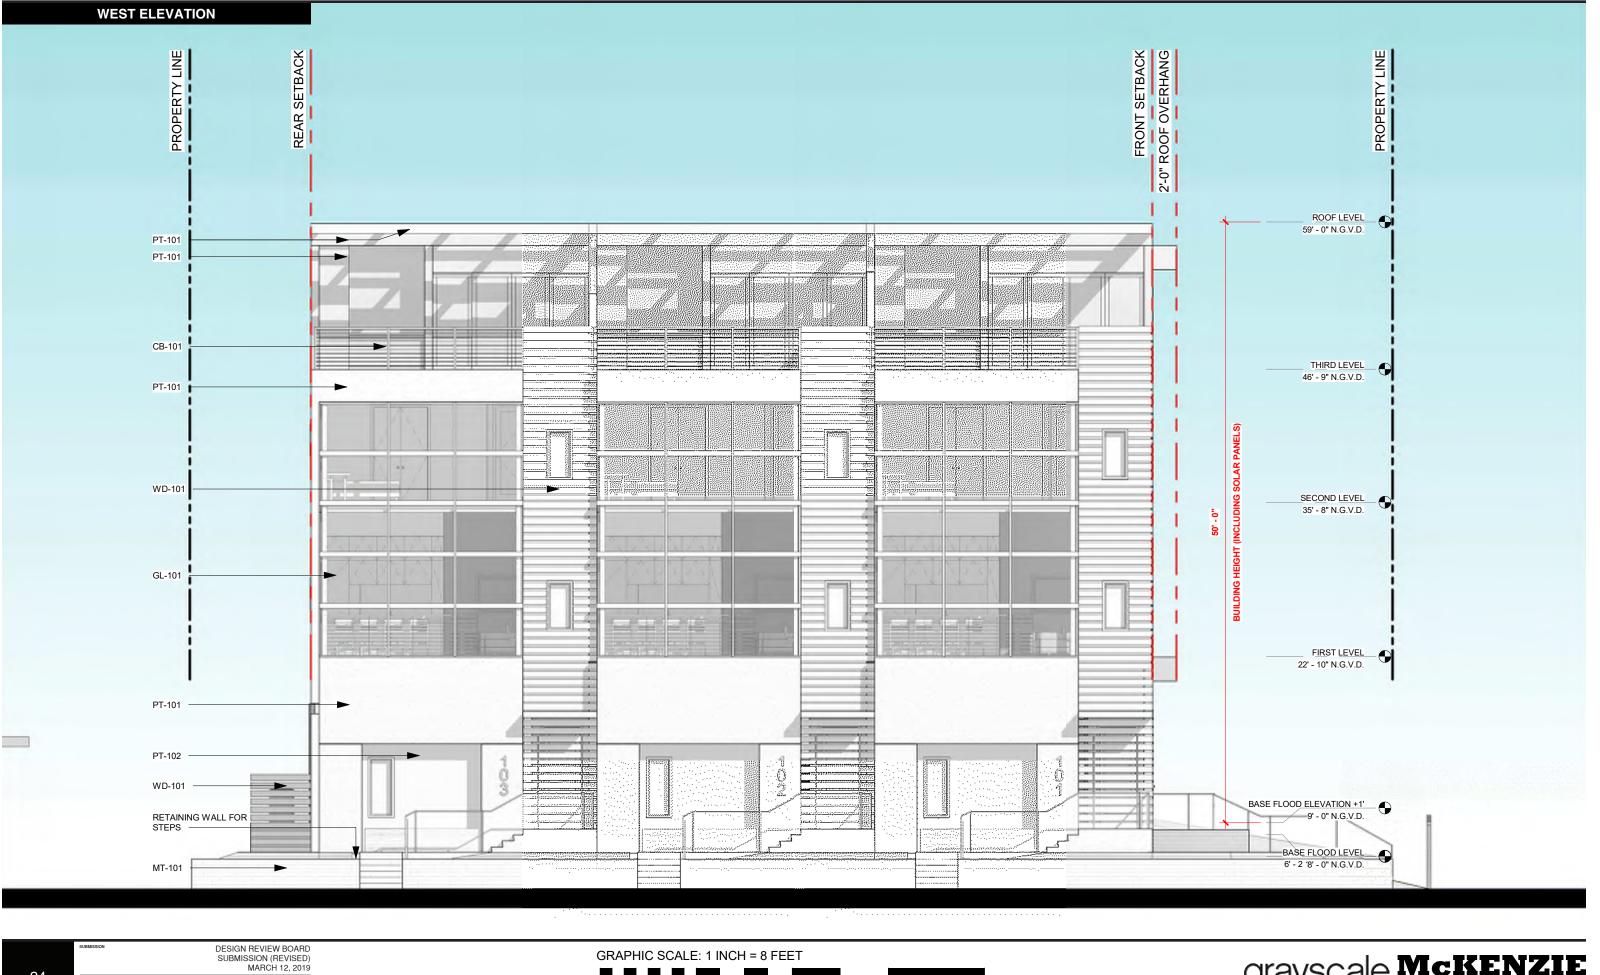


32'


PROJECT ADDRESS 1425 BAY ROAD MIAMI BEACH, FL 33139

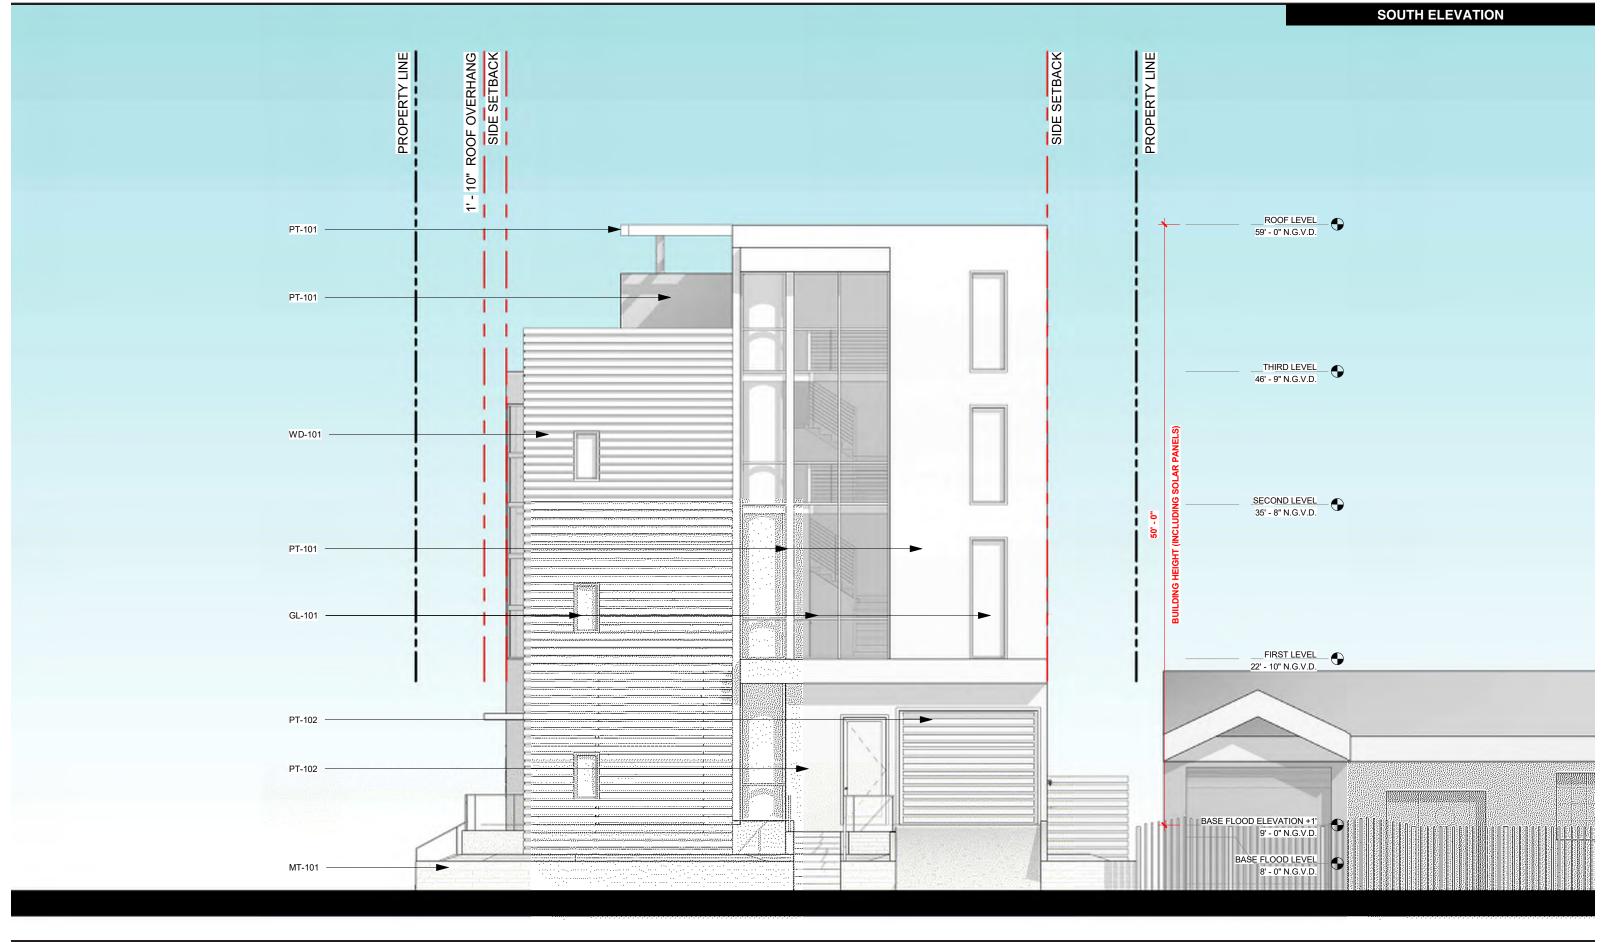


DESIGN REVIEW BOARD SUBMISSION (REVISED) MARCH 12, 2019


1425 BAY ROAD MIAMI BEACH, FL 33139

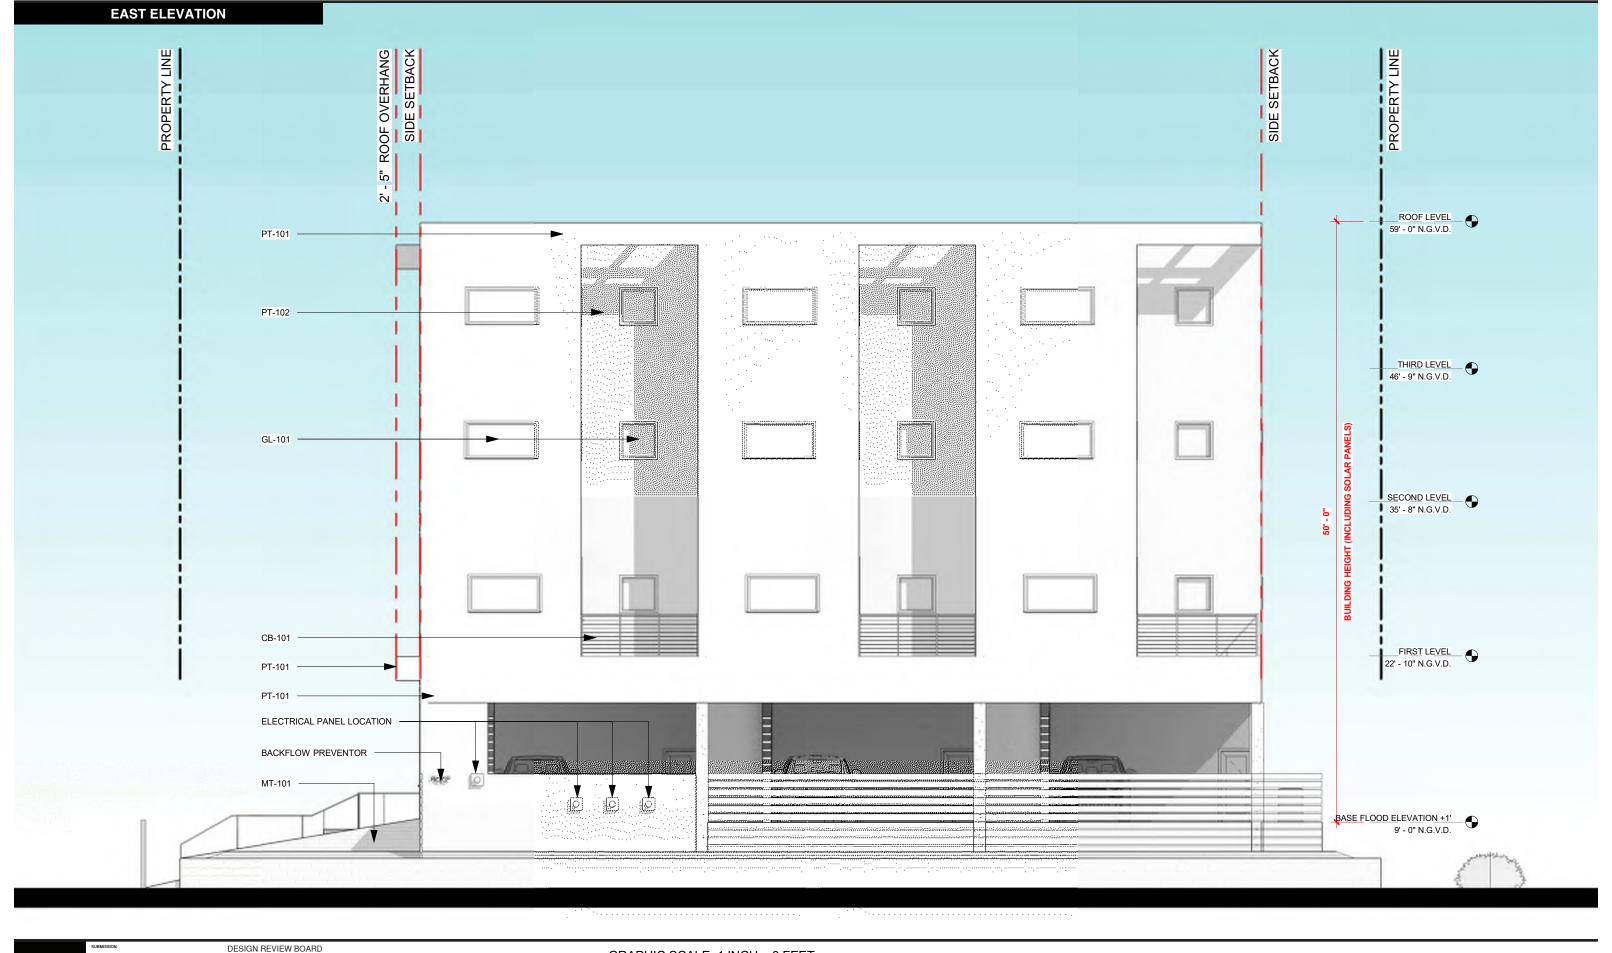


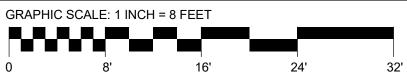

2247 NW 17 AVE, MIAMI, FL 33142

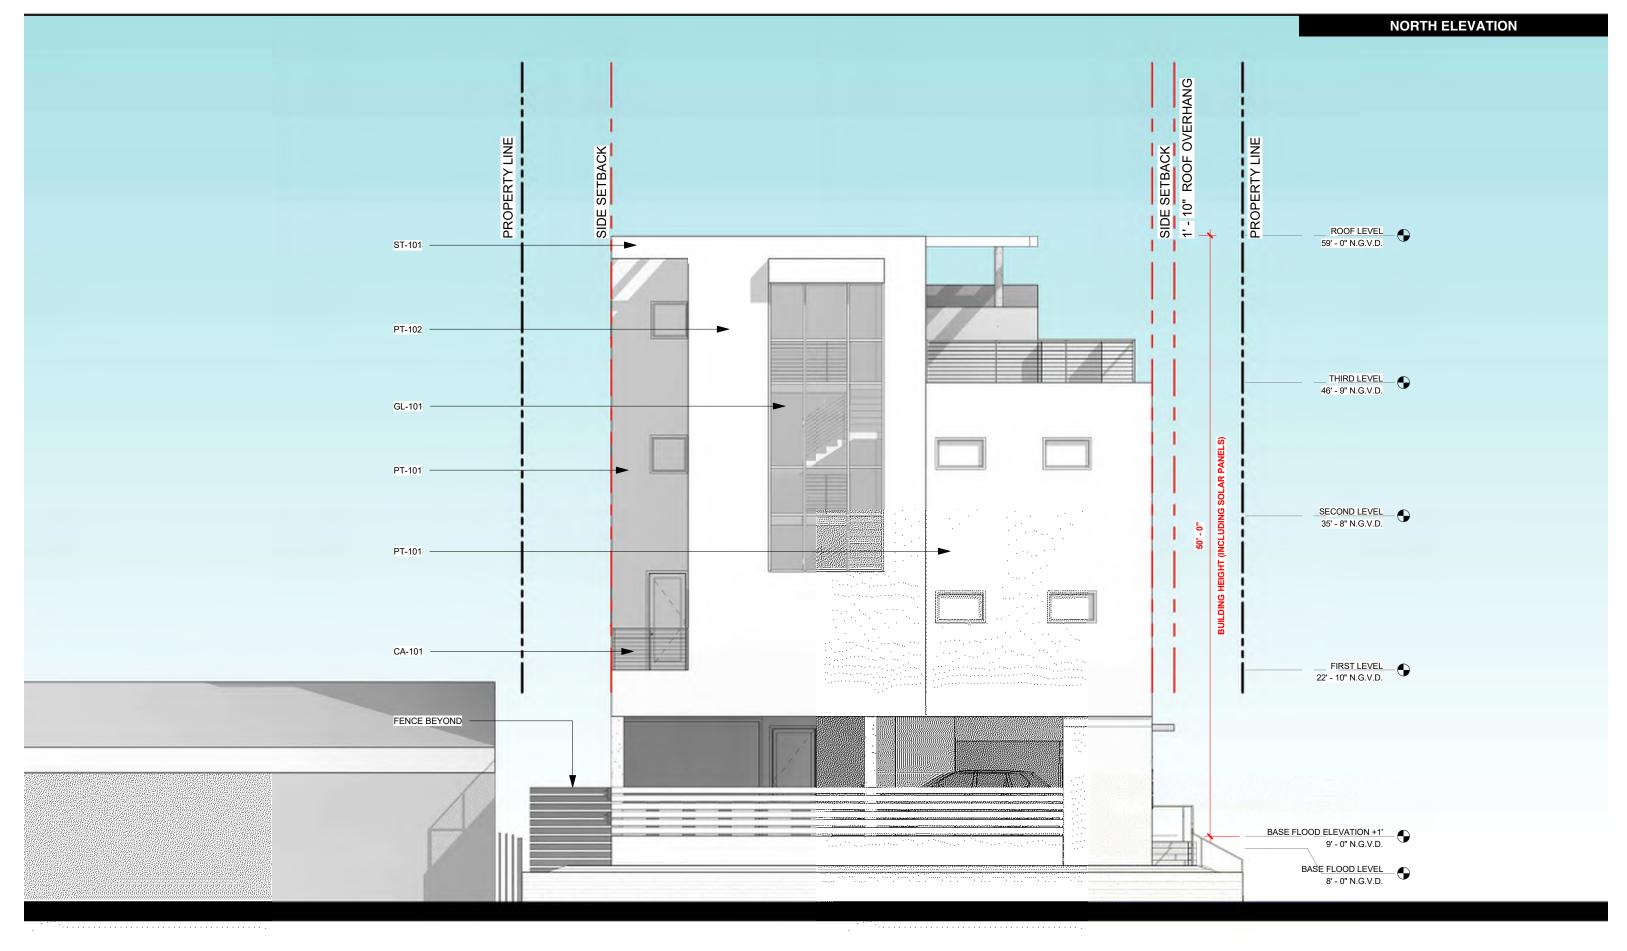

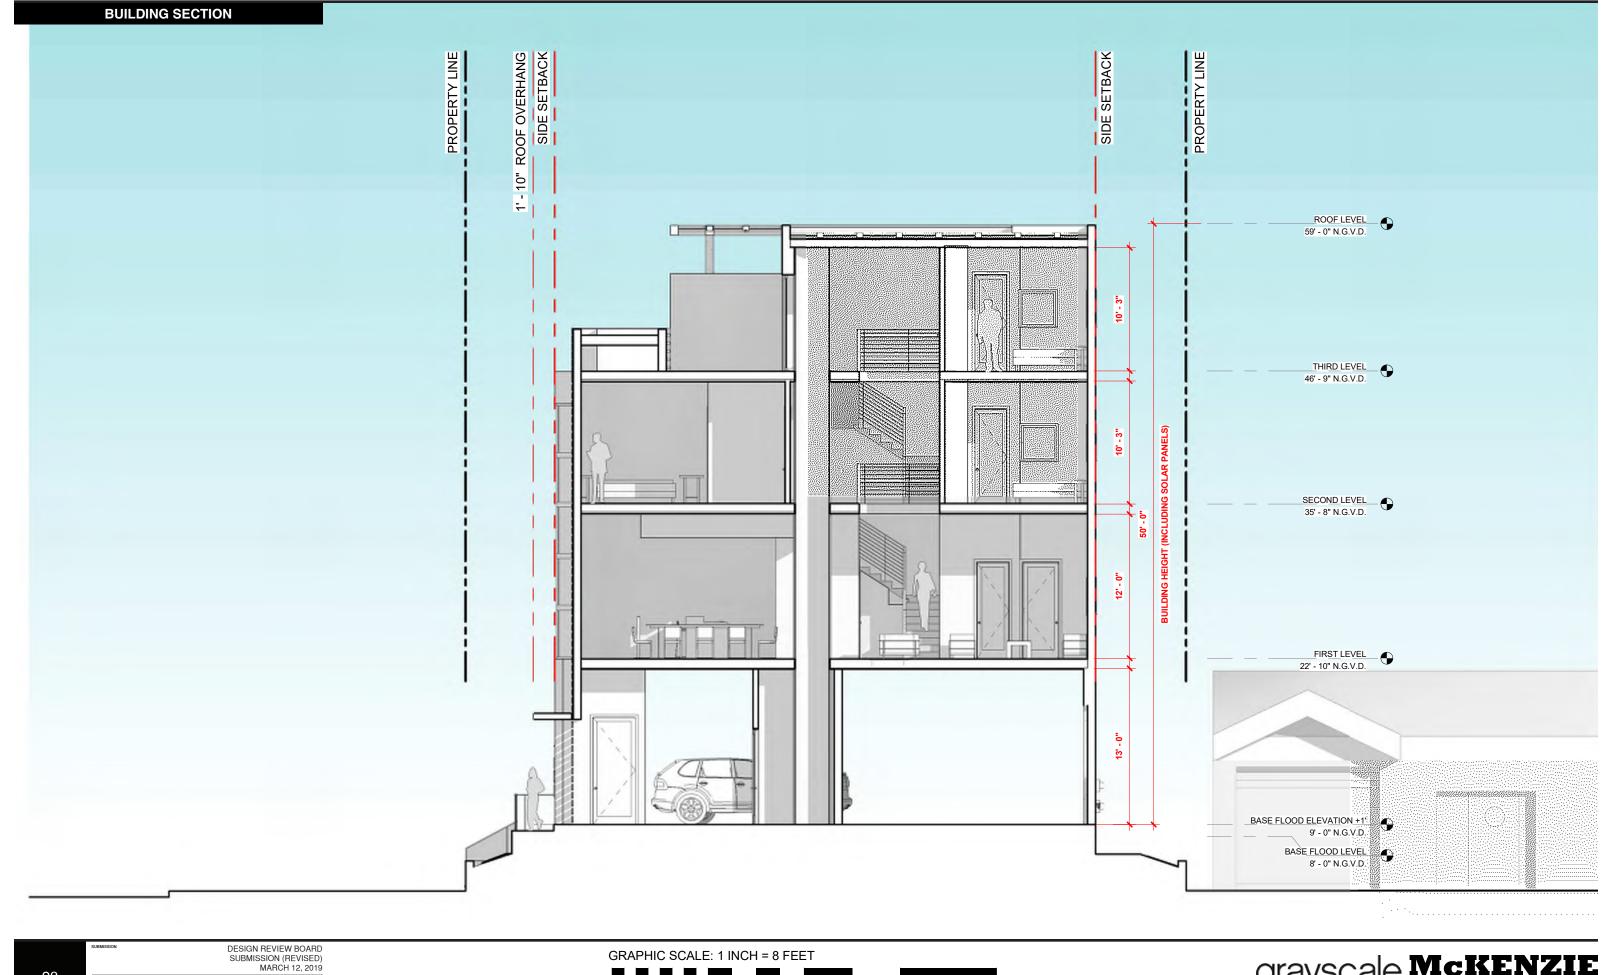

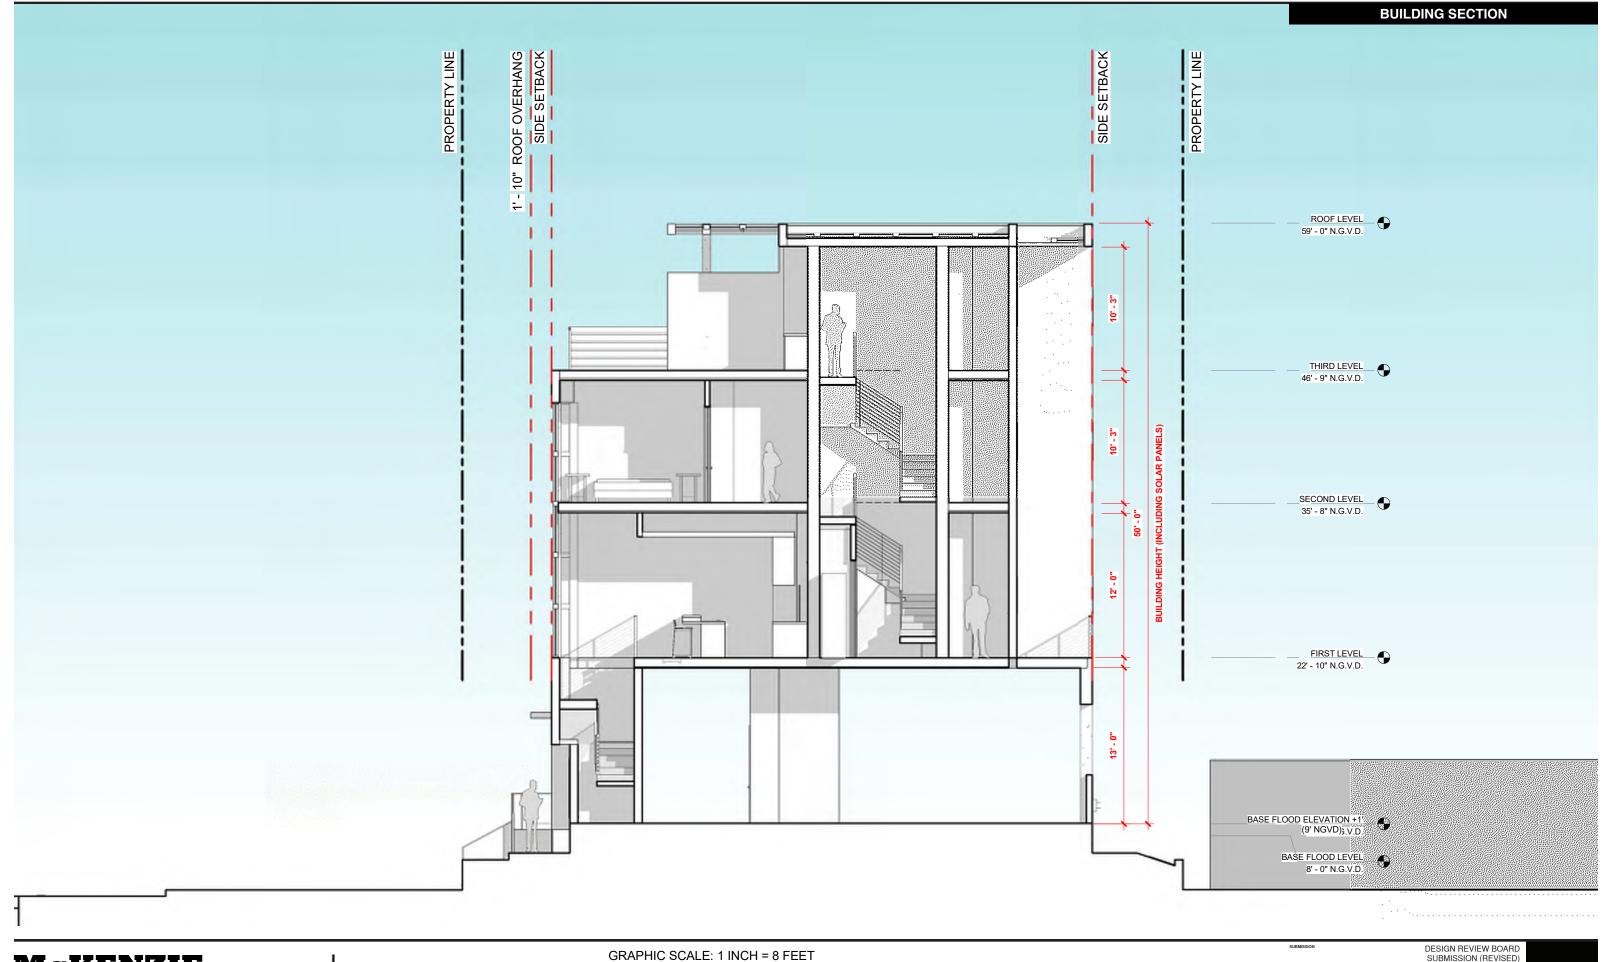




DESIGN REVIEW BOARD SUBMISSION (REVISED) MARCH 12, 2019

grayscale McKENZIE DESIGN BUILD CRAFT




McKENZIE grayscale


DESIGN REVIEW BOARD SUBMISSION (REVISED) MARCH 12, 2019

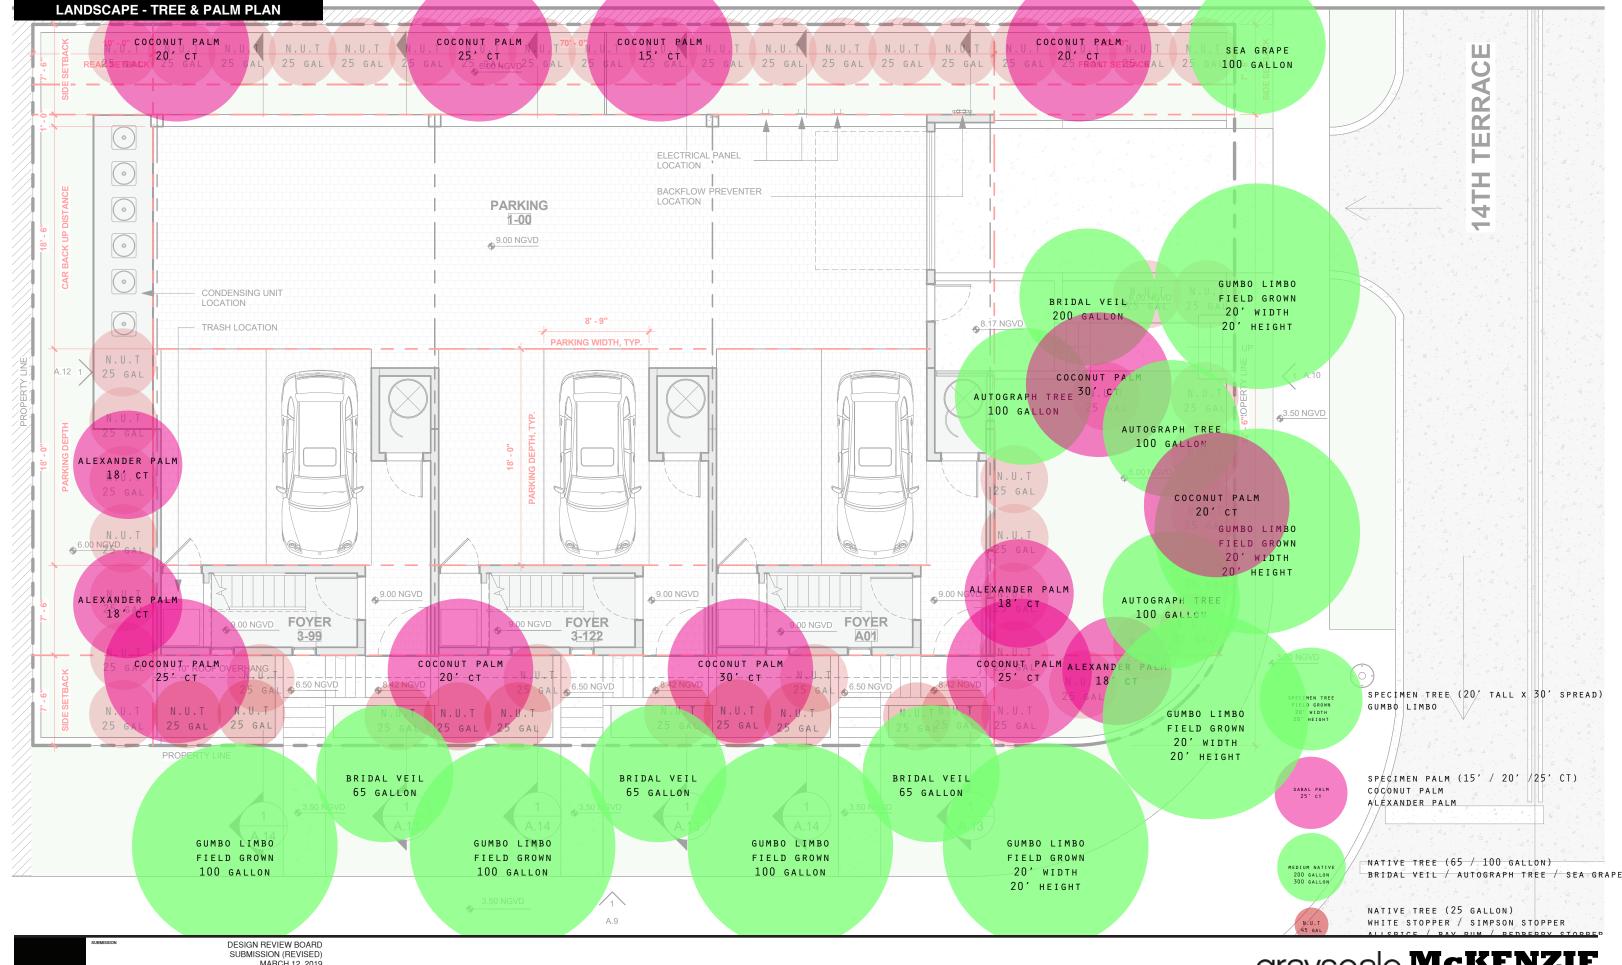


grayscale McKENZIE

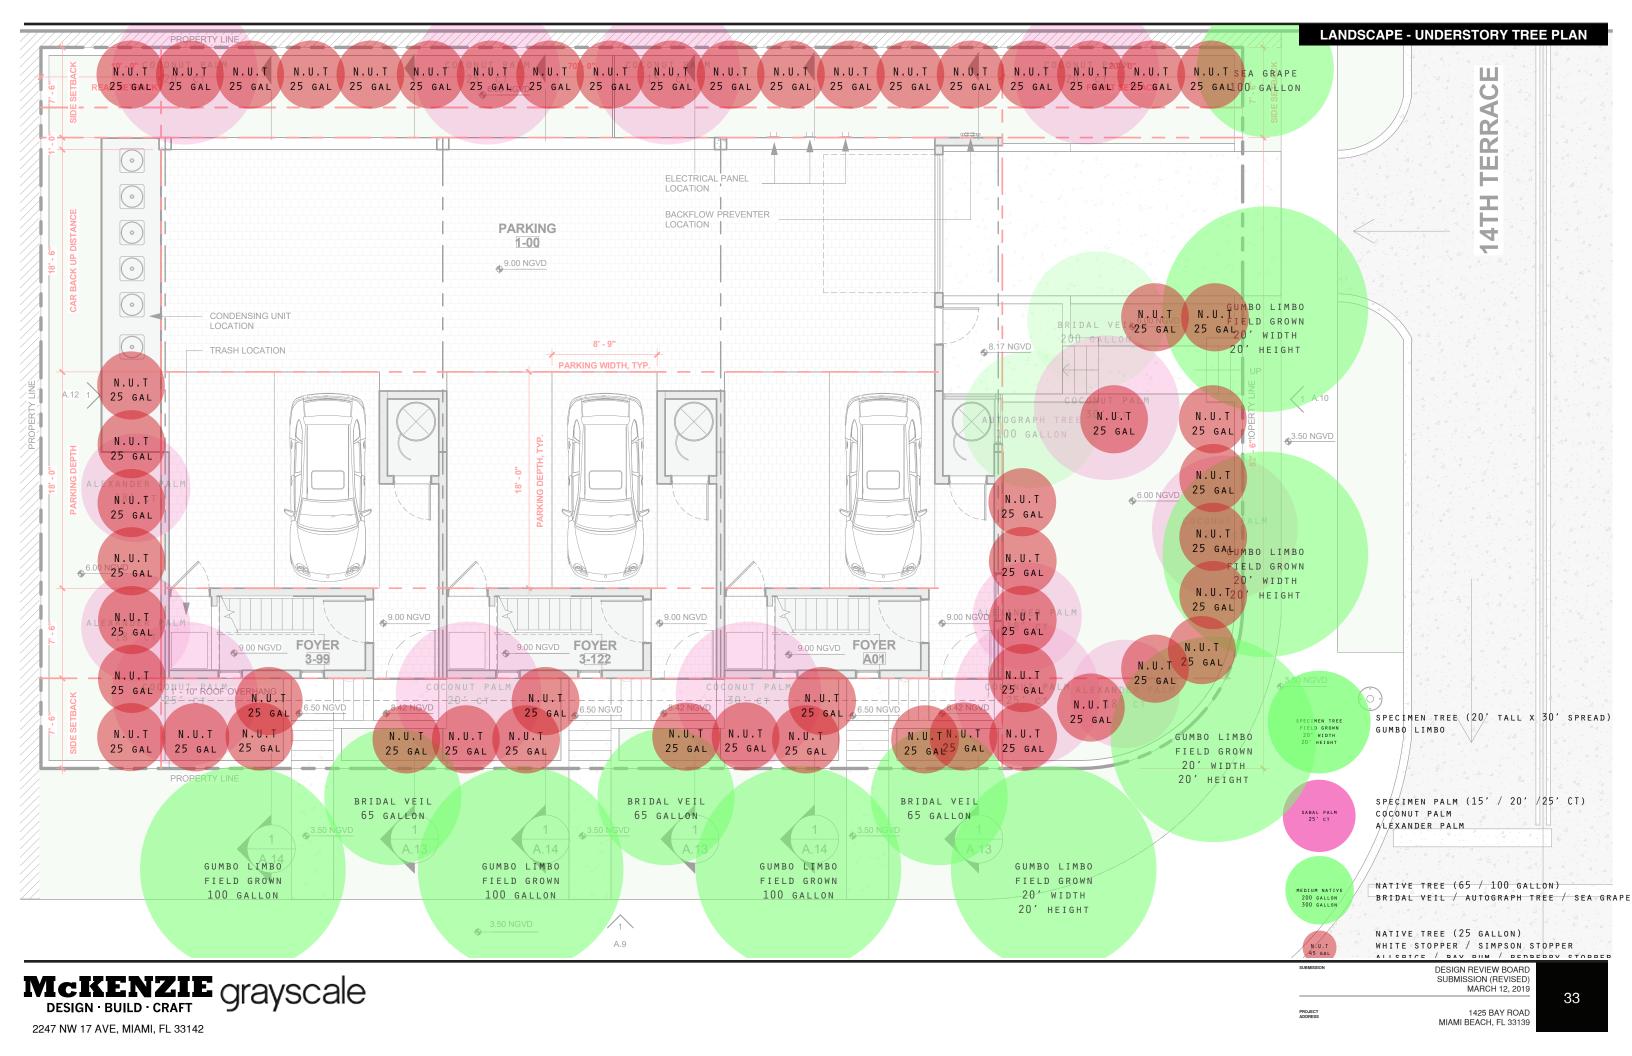



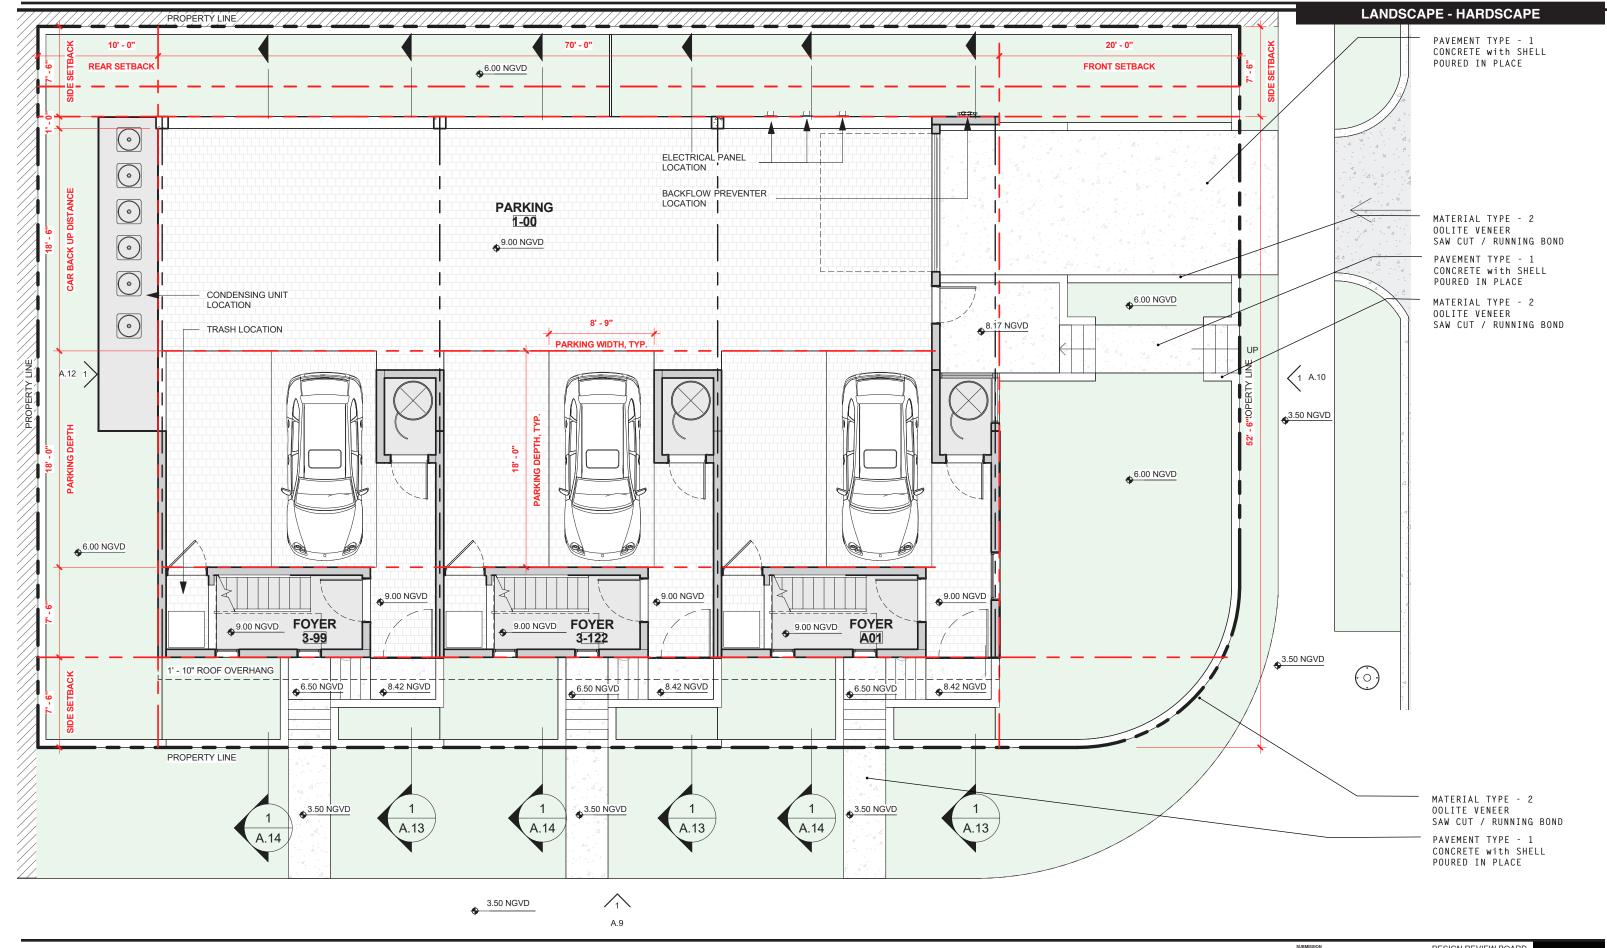

35

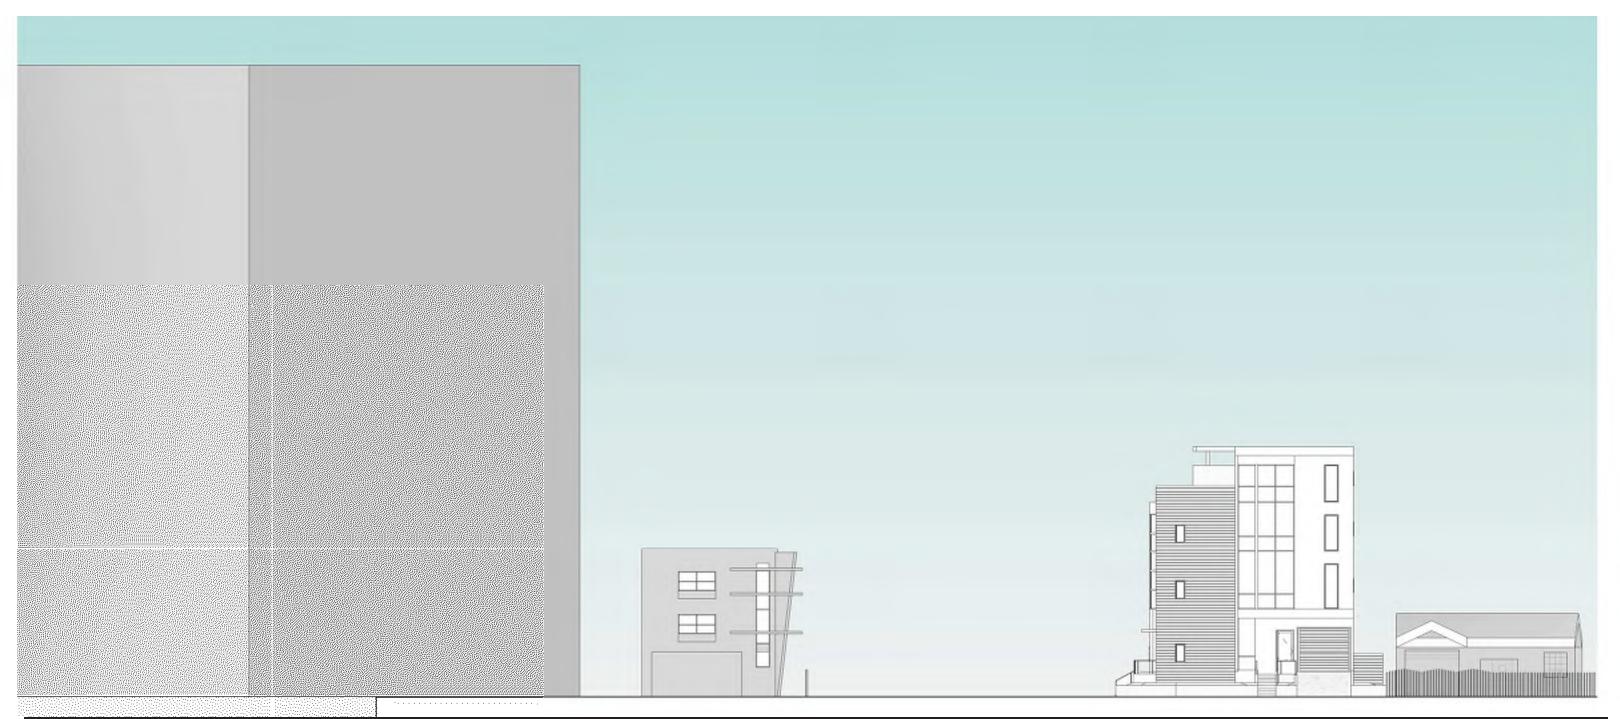


DESIGN REVIEW BOARD SUBMISSION (REVISED) MARCH 12, 2019


grayscale McKENZIE DESIGN · BUILD · CRAFT



37

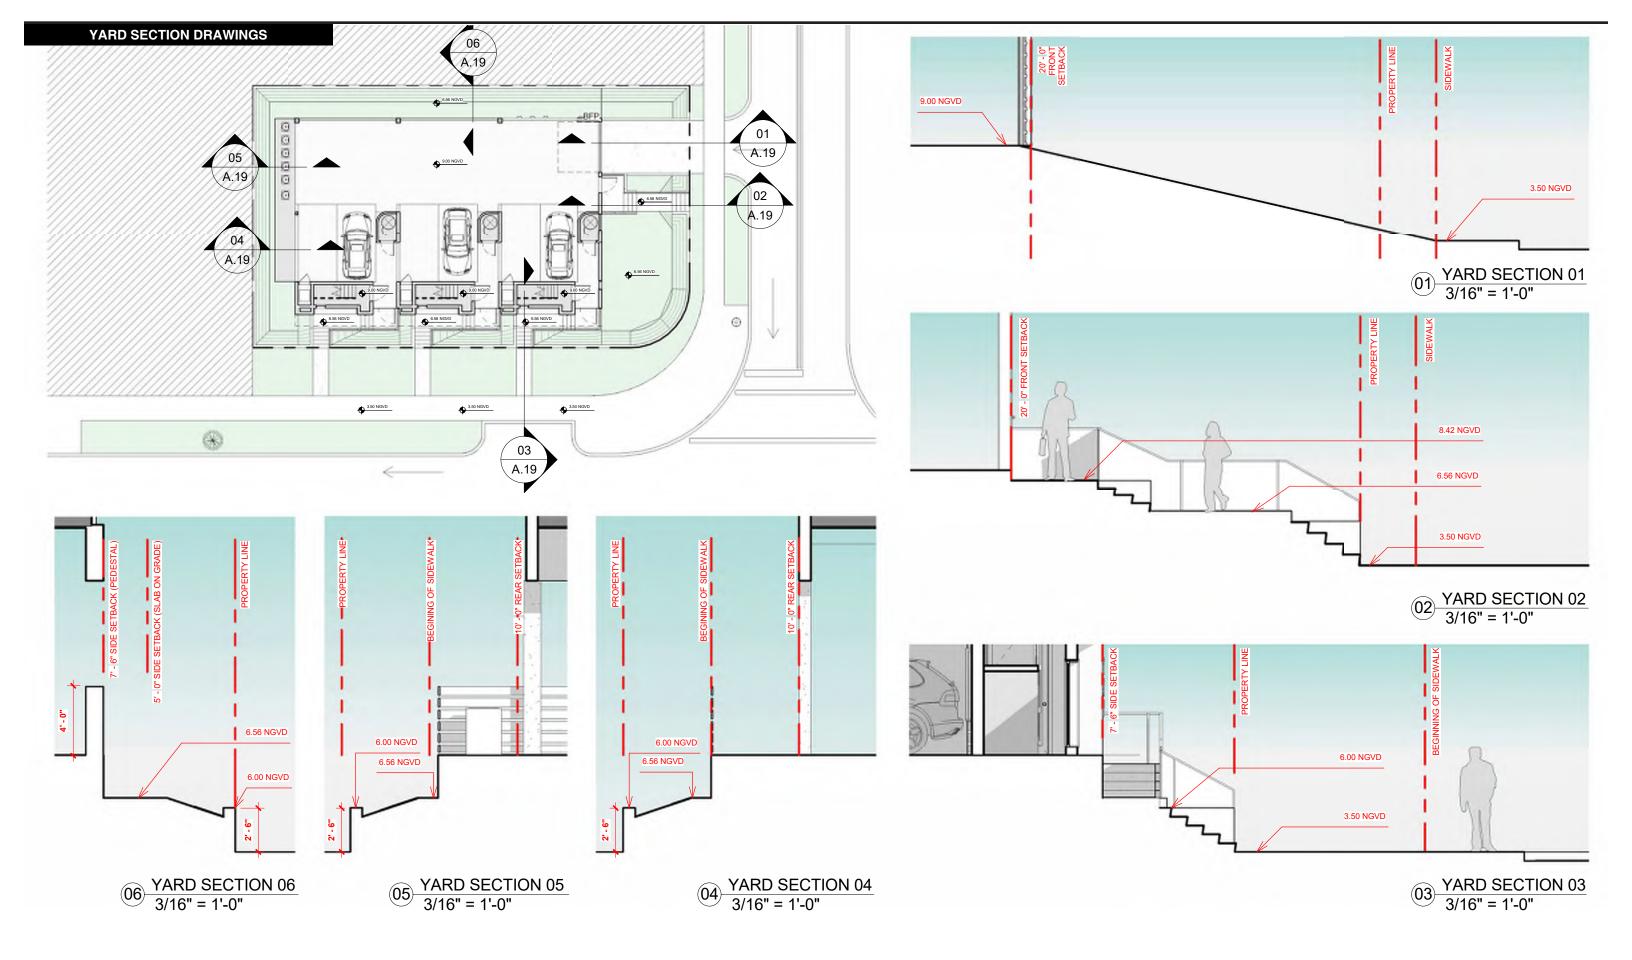

38

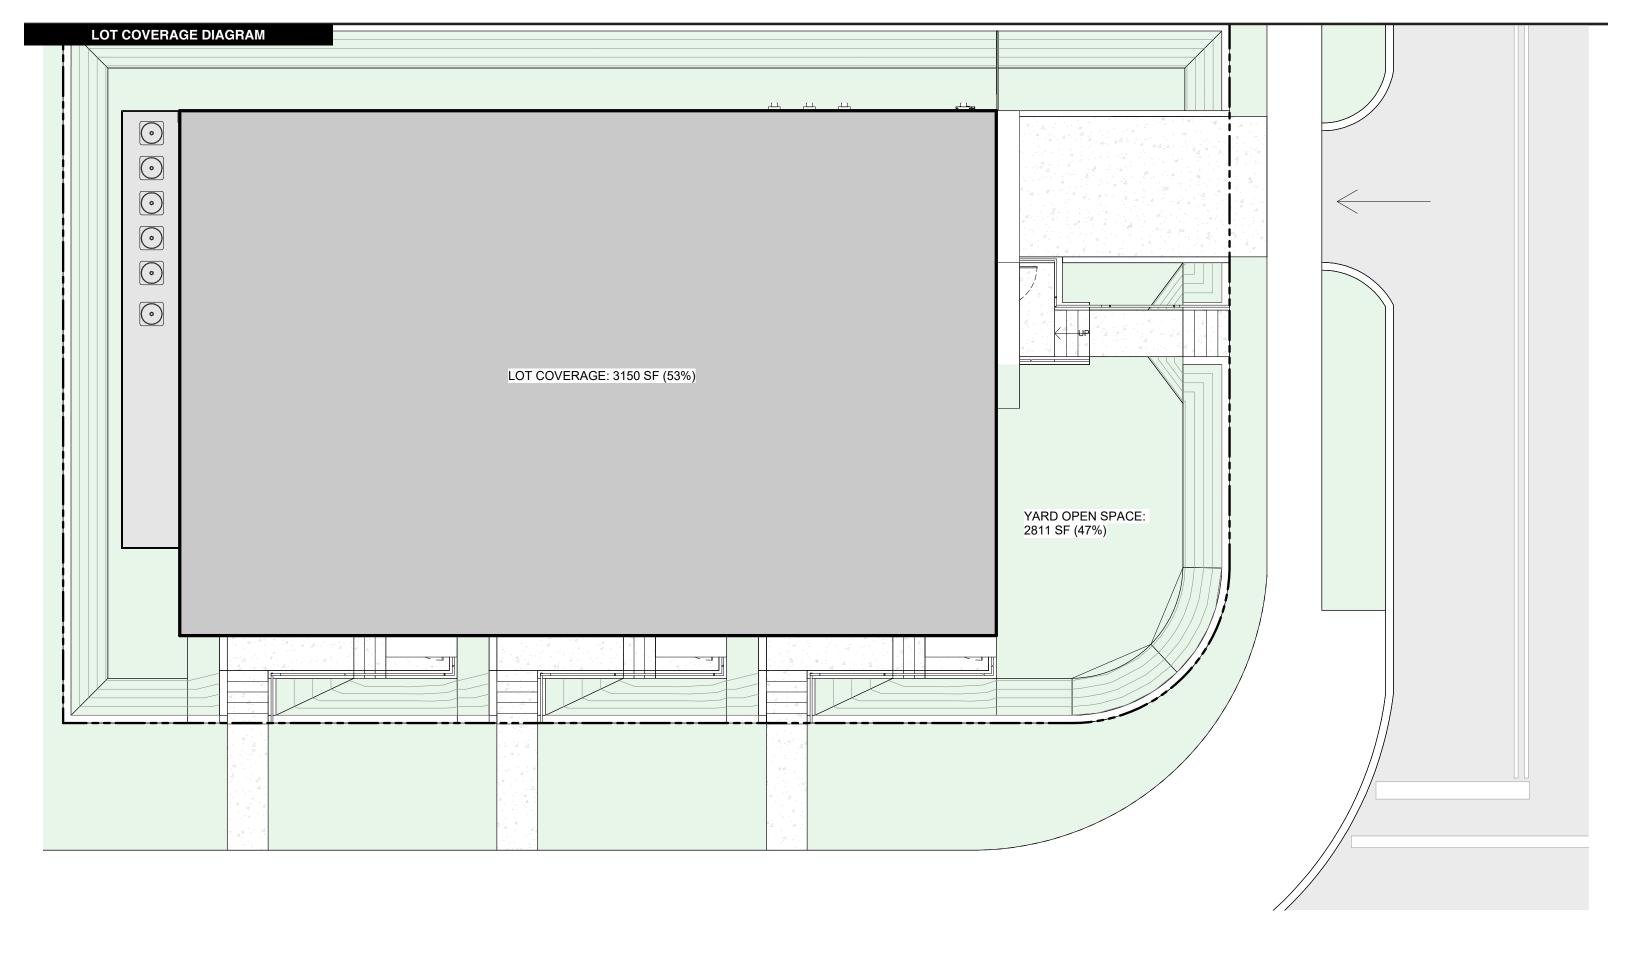

January 30, 2019

Design Review Board City of Miami Beach 1700 Convention Center Drive Miami Beach, FL 33139

Re: Parking Analysis

1425 Bay Road Townhouses

Dear Board Members:

We understand that the referenced project is currently under consideration by the City of Miami Beach Design Review Board. The project consists of three elevated townhouses with a parking garage directly below. The entrance and exit to the garage is located on 14<sup>th</sup> Terrace.


The objective of this analysis is to determine if the parking spaces and back out space within the garage is sufficient for vehicles to safely maneuver in and out of the parking spaces. City of Miami Beach requires a back out space of 22' and, due to the confined space of the lot, the design plans provide a back-out distance of 19' parking spaces 18' long. A variance is therefore needed to reduce the back out space distance from 22' to 19'.

The attached exhibits, Sheet Nos. C-000 through C-105, show how vehicles can maneuver into and out of the proposed parking spaces. The standard vehicle for this analysis is based on the standard vehicle established by the National Parking Association.

Based on our analysis, as depicted in the attached exhibits, it has been concluded that standard vehicles will able to maneuver into and out of the parking spaces with the proposed back-up distance of 19'. The parking spaces and maneuvering area will not be used by the public but will be used, instead, by the owners of the townhomes. As such, they would become familiar with the garage layout and parking within the garage.

Sincerely,
Biscayne Engineering Company, Inc.


Albert R. Dettbarn, P.E. 18966 Vice President

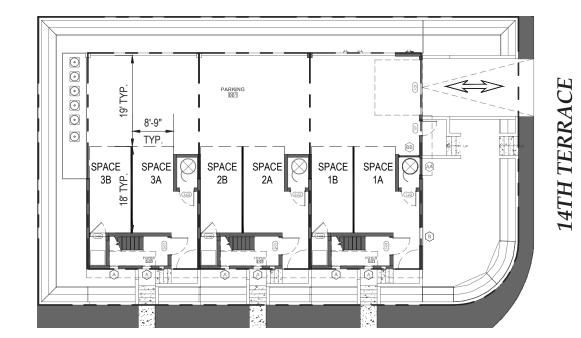

## **BAY ROAD**

## PARKING GARAGE LAYOUT


SCALE 1" = 5'

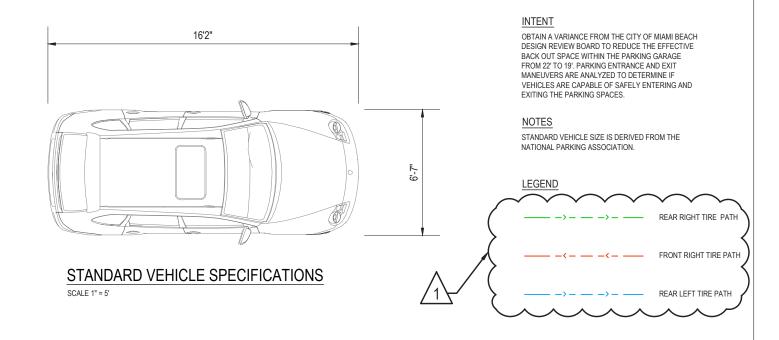



DRAWING NAME: GENERAL DETAILS & NOTES

PROJECT: 1425 BAY ROAD PARKING STUDY

DESIGN REVIEW BOARD

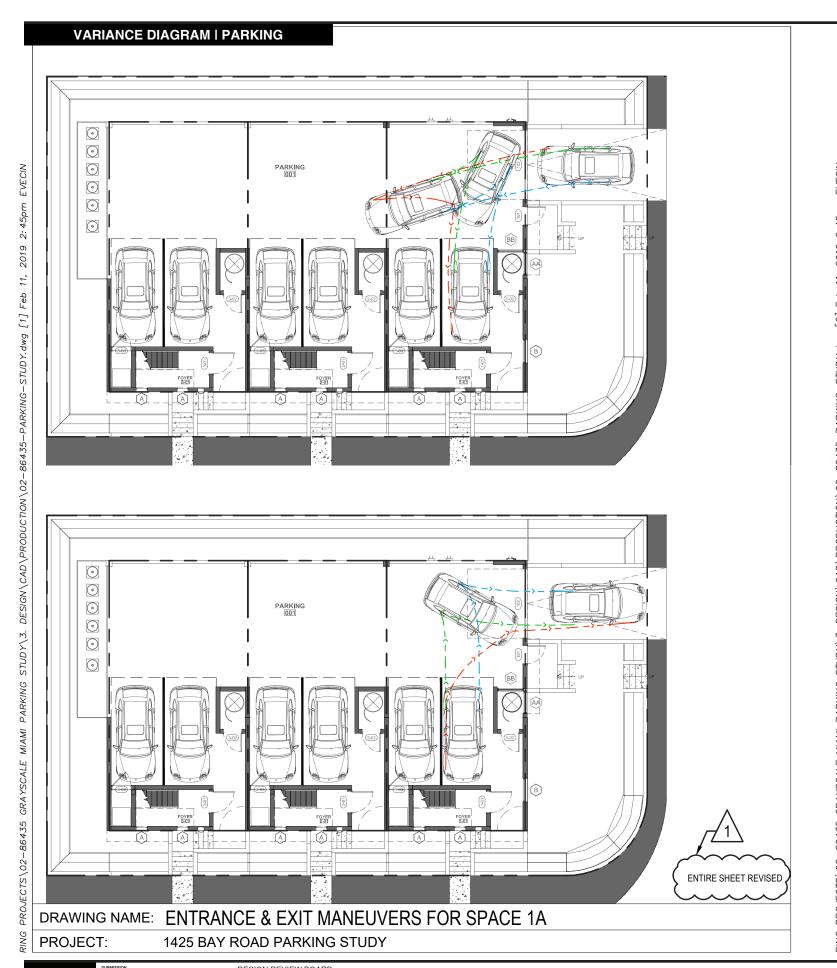

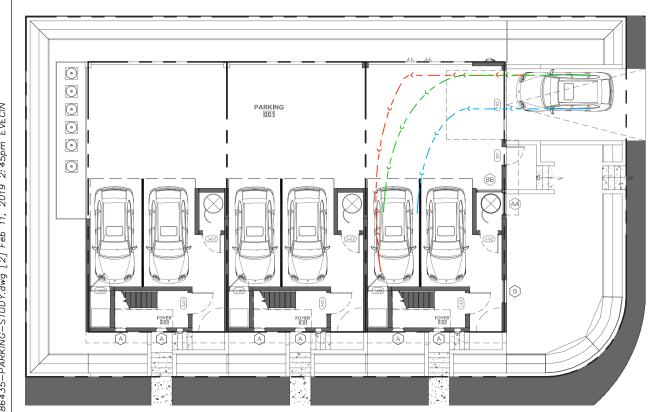

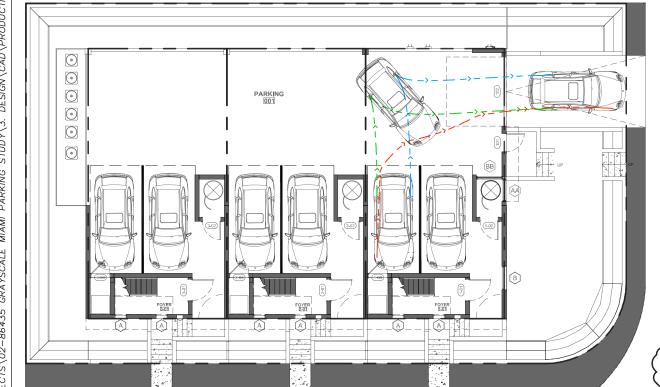


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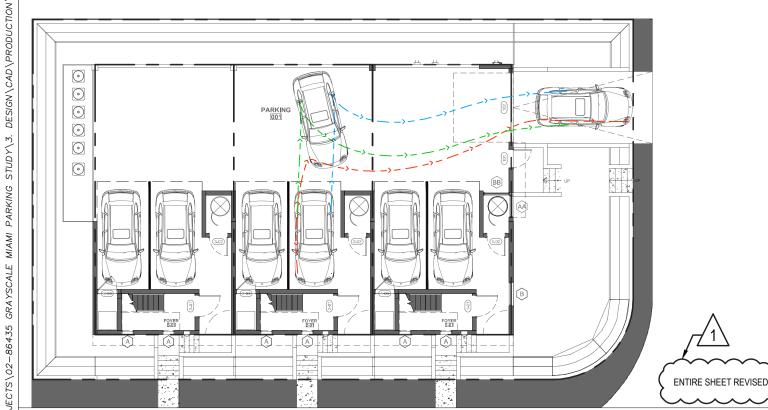
PROJECT: 1425 BAY ROAD PARKING STUDY

grayscale McKENZIE

DESIGN BUILD CRAFT


ENTIRE SHEET REVISED




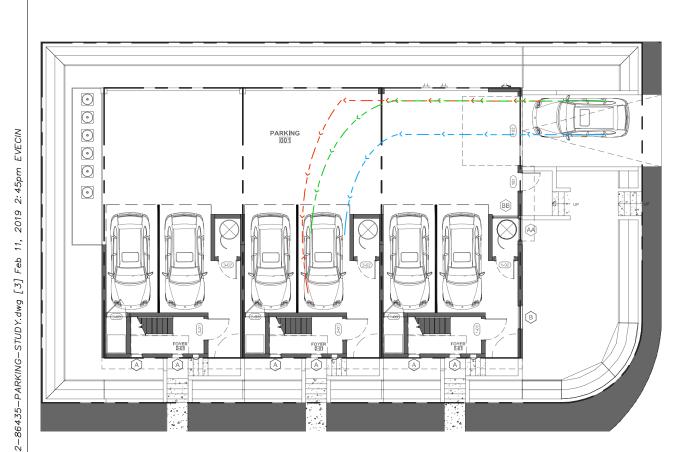

DRAWING NAME: ENTRANCE & EXIT MANEUVERS FOR SPACE 2A

PROJECT: 1425 BAY ROAD PARKING STUDY

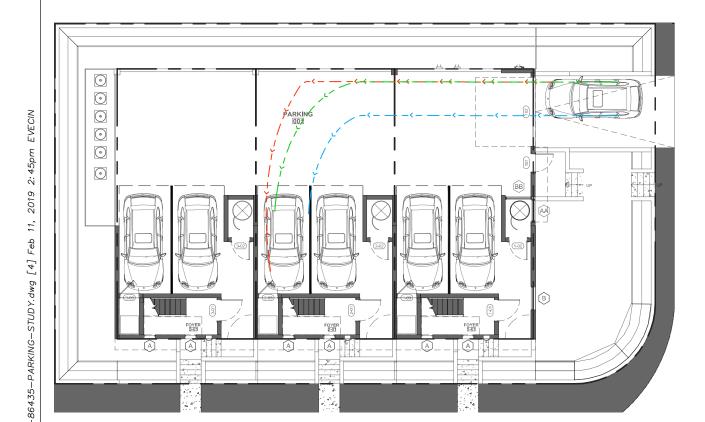

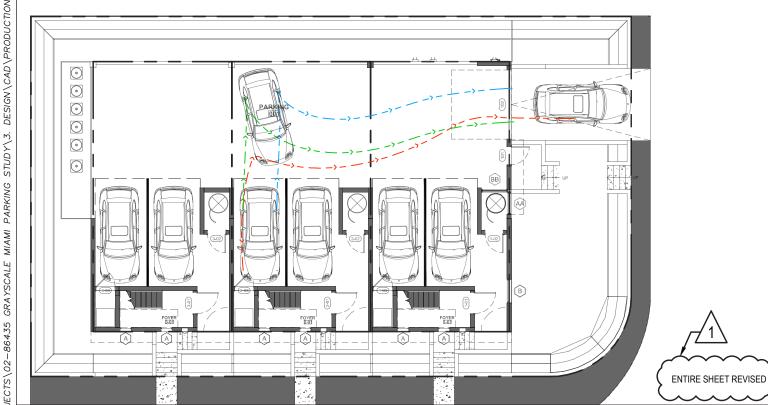


DRAWING NAME: ENTRANCE & EXIT MANEUVERS FOR SPACE 2B


PROJECT: 1425 BAY ROAD PARKING STUDY


Mckenzie grayscale

DESIGN REVIEW BOARD SUBMISSION (REVISED) MARCH 12, 2019

**VARIANCE DIAGRAM | PARKING** 

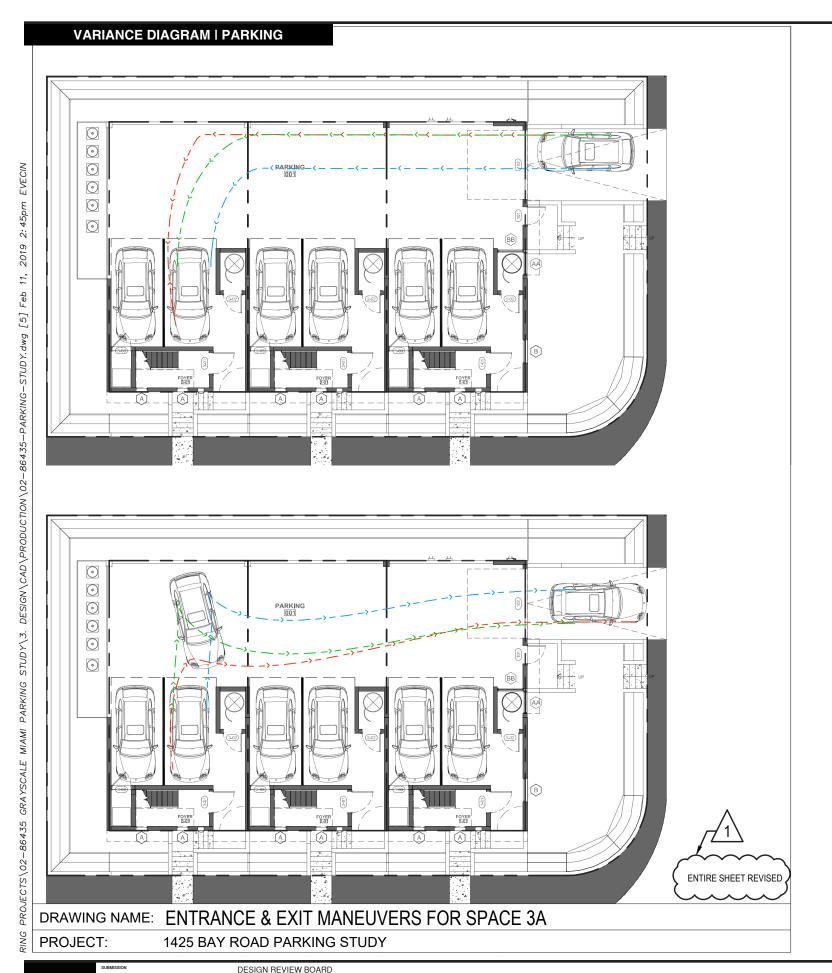

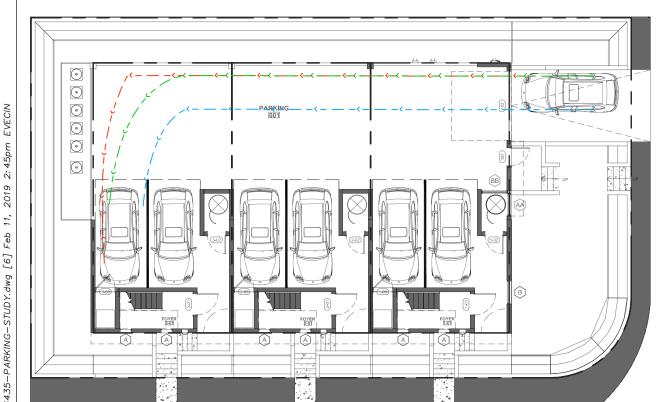

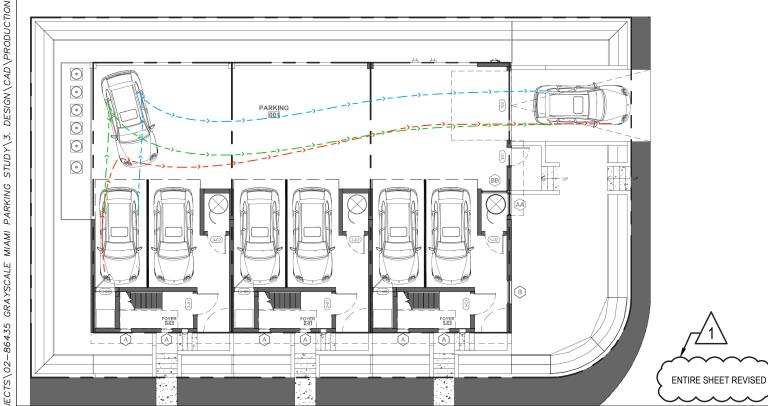



DRAWING NAME: ENTRANCE & EXIT MANEUVERS FOR SPACE 3B

PROJECT: 1425 BAY ROAD PARKING STUDY

grayscale McKENZIE

1425 BAY ROAD MIAMI BEACH, FL 33139

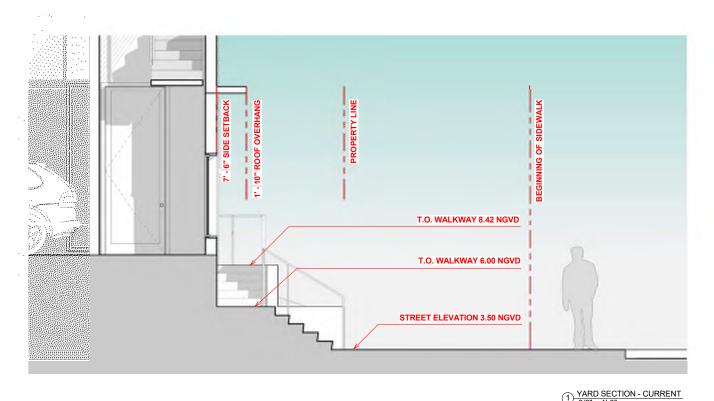

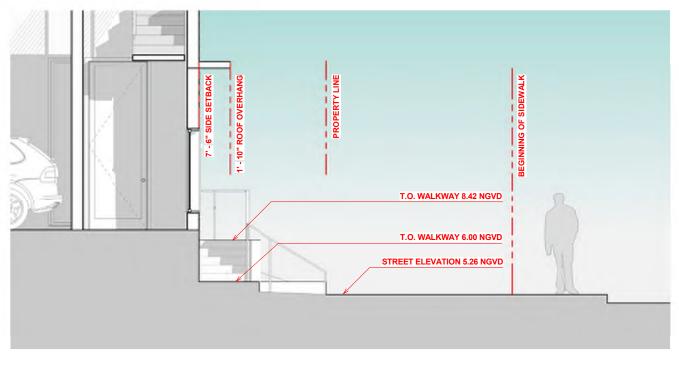

2 YARD SECTION - FUTURE
3/8" = 1'-0"

		3/8" = 1'-0"

EXISTING CONDITIONS:	Formula	NGVD
<b>GRADE</b> <sup>i</sup> (the city sidewalk elevation at the centerline of the front of the property. If		3.34
there is no sidewalk, the elevation of the crown of the road at the centerline of the		
front of the property shall be used)		
ADJUSTED GRADE <sup>ii</sup> (the midpoint elevation between grade and the minimum required	3.34+8/2 = 5.67	5.67
flood elevation for a lot or lots)		
<b>FUTURE CROWN OF ROAD</b> <sup>iii</sup> (the highest elevation of the crown of road as described in	From Public	5.26
the adopted Miami Beach Stormwater Master Plan, located at exhibit X.)	Works	
<b>FUTURE ADJUSTED GRADE</b> <sup>iv</sup> (the midpoint elevation between the future crown of the	5.26+9/2 = 7.13	7.13
road as defined in the city's stormwater master plan, as may be amended, and the base		
flood elevation plus minimum freeboard for a lot or lots)		
MAXIMUM YARD ELEVATION <sup>v</sup> (shall not exceed 30 inches above grade, or future	3.34+2.5 = 5.85	7.13
adjusted grade, whichever is greater)	5.85 < 7.13	
MAXIMUM HEIGHT FOR ALLOWABLE ENCROACHMENTS (shall not exceed 30 inches	5.67+2.5 = 8.17	8.17
above adjusted grade)		

FUTURE CONDITIONS WITH PUBLIC WORKS PLAN:	Formula	NGVD
<b>GRADE</b> (the city sidewalk elevation at the centerline of the front of the property. If		5.26
there is no sidewalk, the elevation of the crown of the road at the centerline of the		
front of the property shall be used)		
ADJUSTED GRADE (the midpoint elevation between grade and the minimum required	5.26+8/2 =6.63	6.63
flood elevation for a lot or lots)		
FUTURE CROWN OF ROAD (the highest elevation of the crown of road as described in	From Public	5.26
the adopted Miami Beach Stormwater Master Plan, located at exhibit X.)	Works	
FUTURE ADJUSTED GRADE (the midpoint elevation between the future crown of the	5.26+9/2 = 7.13	7.13
road as defined in the city's stormwater master plan, as may be amended, and the base		
flood elevation plus minimum freeboard for a lot or lots)		
MAXIMUM YARD ELEVATION (shall not exceed 30 inches above grade, or future	5.26 +2.5 = 7.76	7.76
adjusted grade, whichever is greater)	7.76 > 7.13	
MAXIMUM HEIGHT FOR ALLOWABLE ENCROACHMENTS (shall not exceed 30 inches	6.63+2.5 = 9.13	9.13 <sup>vi</sup>
above adjusted grade)		

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