HISTORIC PRESERVATION BOARD



RESIDENCE / DETACHED ADDITION AT: 925 LENOX AVENUE MIAMI BEACH, FLORIDA 33139



INDEX OF DRAWINGS:

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HPB-5.0	ADJACENT PROPERTY PHOTOS
HPB-5.5	EXISTING PROPERTY PHOTOS
HPB-5.6	RENDERINGS & CONTEXT RENDERING
LA-1.0	LANDSCAPE PLAN
LA-1.1	IRRIGATION PLAN
LA-1.2	ROOF LANDSCAPE PLAN
LA-1.3	TREE SURVEY/DISPOSITION PLAN

SCOPE OF WORK:

- THE ADDITION OF A 3 STORY DUPLEX INCLUDING A POOL& DECK AT ROOF LEVEL TO BE LOCATED AT THE REAR OF THE PROPERTY.
- THE DEMOLITION OF THE EXISTING STEPS AT THE REAR OF THE EXISTING BUILDING TO BE REPLACED BY NEW CONCRETE STEPS, CONCRETE WALKWAY, AND LANDSCAPE BETWEEN BUILDINGS.
- THE PROPOSED DUPLEX WILL BE OF AN ART DECO /CONTEMPORARY STYLE DESIGN, AND A CONCRETE & GLASS TYPE CONSTRUCTION.



		S BERKET BERT I BARTY REFER DER RETAR STERN AFTE (EN)
HISTORIC PRESI City of Mlami Bea	ERVATION BOARD ach, Florida	CF M 2031 55893 401 5223 DR BK 29667 Pss 3741-3768 (8Pss) RECORDED 06/23/2015 13:53:52 HARMENT REPORT OCTERK OF COURT THIS IS TO CERTE TRAFTIC AREAD DO STATEMENT IN S A TRUE AND ACCURATE COPY OF THE ORIGINAL ON FILE A THE OFFICE OF THE PLANNING DEPARTMENT THE OFFICE OFFICE THE OFFICE OF
MEETING DATE:	May 12, 2015	Personally innovan is my or Produced ID:
		Painteo Ganne
FILE NO:	7498	SELECTION OF THE REAL PROPERTY
PROPERTY:	925 Lenox Avenue	* **** * #ROBS17
APPLICANT:	925 Lenox LLC	The Public, STATE State
LEGAL:	Lot 1, Block 94, Ocean Additi Thereof, as Recorded in Plat E Miami-Dade County, Florida.	on Number Three, According to the Plat ook 2, Page 81, of the Public Records of
NRE:	demolition and renovation of t	cate of Appropriateness for the partial ne existing 1-story home, along with the ground level addition and partial 1-story
	ORDER	
The applicant filed Certificate of Appro	an application with the City of priateness and for one or more va	Miami Beach Planning Department for a riances.
lased upon the evi	Beach Historic Preservation Board dence, information, testimony and of the record for this matter:	makes the following FINDINGS OF FACT, I materials presented at the public hearing

A. The subject structure is classified as a 'contributing' structure in the Miami Beach Historic Properties Database, and is located within the Flamingo Park Local Historic District.

B. Based on the plans and documents submitted with the application, testimony and information provided by the applicant, and the reasons set forth in the Playfung Department Staff Report, the project as submitted:

1. Is consistent with the Certificate of Appropriateness Criteria in Section 118-564(a)(1) of the Miami Beach Code.

PAGE 1

 Page 5 of 8 HPB File No. 7498 Meeting Date: May 12, 2015 terms of this Ordinance and would work unnecessary and undue hardship on the applicant; That the variance granted is the minimum variance that will make possible the reasonable use of the land, building or structure; That the granting of the variance will be in harmony with the general intent and purpose of this Ordinance and that such variance will not be injurious to the area involved or otherwise detrimental to the public welfare; and That the granting of this request is consistent with the comprehensive plan and does not reduce the levels of service as set forth in the plan. C. The Board hereby approves the requested variances and imposes the following conditions based on its authority in Section 118-354 of the Miami Beach City Code: 1. A Construction Parking and Traffic Management Plan (CPTMP) shall be approved by the Parking Director pursuant to Chapter 106, Article II, Division 3 of the City Code, prior to the issuance of the Board Order. 	 Page 6 of 8 HPB File No. 7498 Weeting Date: Way 12, 2015 d. Ambient lighting shall be provided along the driveway from the edge of the front facade to the rear edge of the new building addition in a manner to be reviewed and approved by staff. The decision of the Board regarding variances shall be final and there shall be no further review thereof except by resort to a court of competent furisdiction by petition for writ of certiorari. III. General Terms and Conditions applying to both 1. Certificate of Appropriateness' and 11. Variances' noted above. A. Site plan approval is contingent upon meeting Public School Concurrency requirements. Applicant shall obtain a valid School Concurrency Determination Certificate (Certificate) issued by the Miani-Dade County Public School. The Certificate shall state the number of seats reserved at each school level. In the event sufficient seats are not available, a proportionate share mitigation plan shall be incorporated into a tri-party development agreement and duly executed prior to the issuance of a Building Pemilt. B. A Construction Parking and Traffic Management Plan (CPTMP) shall be approved by the Parking Director pursuant to Chapter 108, Article 11, Division 3 of the City Code, prior to
 Substantial modifications to the plans submitted and approved as part of the application, as determined by the Planning Director or designee, may require the applicant to return to the Board for approval of the modified plans, even if the modifications do not affect variances approved by the Board. 	the issuance of a Building Permit. C. A copy of all pages of the recorded Final Order shall be scanned into the plans submitted for building permit, and shall be located immediately after the front cover page of the permit plans.
 The applicant shall submit a Hold Harmless Covenant Running with the Land to the City Attorney's Office in a form acceptable to the City Attorney indemnifying and holding harmless the city against any claim or loss in the event of an accident involving a motor vehicle or other instrumentality due to the proximity of the driveway to the adjacent neighboring property. Revised elevations, site plan and floor plan drawings shall be submitted to and approved by staff; at a minimum, such drawings shall incorporate the following: The elevator vestibule and entry court shall be eliminated or shifted northward a minimum of five (5') feet and the driveway shall be moved closer to the new building, and a landscape buffer of at least five (5') feet shall be provided, in a manner to be reviewed and approved by staff. 	 D. The Final Order shall be recorded in the Public Records of Miami-Dade County, prior to the issuance of a Building Permit. E. Applicant agrees that in the event Code Compliance receives complaints of unreasonably loud noise from mechanical and/or electrical equipment, and determines the complaints to be valid, even if the equipment is operating pursuant to manufacturer specifications, the applicant shall take such steps to mitigate the noise with noise attenuating materials as reviewed and verified by an acoustic engineer. In a manner to be reviewed and approved by staff consistent with the Certificate of Appropriateness Criteria and/or the directions from the Board. F. Satisfaction of all conditions is required for the Planning Department to give its approval on a Certificate of Occupancy; a Temporary Certificate of Occupancy or Partial Certificate of Occupancy may also be conditionally granted Planning Departmental
 b. A temporary construction fence with fabric screening shall be constructed prior to any demolition or new construction along the entire south property line. c. A solid 7'-0" tall masonry wall shall be introduced along the south property line beginning at the west façade wall of the existing structure located at 915 Lenox Avenue extending eastward for the length of the property, in a manuar to be reviewed and approved by staff. 	 Certificate of Occupancy may also be conditioned granted rearing experimental approval. G. The Final Order is not severable, and if any provision or condition hereof is held void or unconstitutional in a final decision by a court of competent jurisdiction, the order shall be returned to the Board for reconsideration as to whether the order meets the criteria for approval absent the stricken provision or condition, and/or it is appropriate to mocify the remaining conditions or impose new conditions.

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- - the following conditions are met:

 - shall include the following:
 - directions from the Board.
 - and/or the directions from the Board.

 - and/or the directions from the Board.

PAGE 2

PAGE 5

2. Is not consistent with Certificate of Appropriateness Criteria 'b',' d' & 'f' in Section 118-564(a)(2) of the Miami Beach Code.

3. Is not consistent with Certificate of Appropriateness Criteria 'a', 'b', 'd', 'e', 'f', 'h', 'f' & 'm' in Section 118-564(a)(3) of the Miami Beach Code.

4. Is consistent with Certificate of Appropriateness Criteria 'a-e' for Demolition in Section 118-564(f)(4) of the Miami Beach Code.

C. The project would be consistent with the criteria and requirements of section 118-564 if

1. Revised elevation, site plan and floor plan drawings shall be submitted and, at a minimum, such drawings shall incorporate the following:

a. The proposed driveway shall consist of 18" wide wheel strips composed of concrete paver or a similar material. The remainder of the driveway area shall consist of sodding, in a manner to be reviewed and approved by staff consistent with the Certificate of Appropriateness Criteria and/or the directions from the Board. If an accessible walkway is required to be provided accessing the new construction, it shall be located within the north side setback.

b. The existing structure on site shall be fully renovated and restored, in a manner to be reviewed and approved by staff consistent with the Certificate of Appropriateness Criteria and/or the directions from the Board; at a minimum, this

i. All through-the-wall air conditioning units shall be removed and replaced with a central air conditioning system, in a manner to be reviewed and approved by staff consistent with the Certificate of Appropriateness Criteria and/or the

ii. The existing windows shall be removed; new casement windows shall be provided and shall incorporate a muntin configuration that is consistent with the with the architectural style of the building, in a manner to be reviewed and approved by staff consistent with the Certificate of Appropriateness Criteria

c. Final details of all exterior surface finishes and materials, including samples, shall be submitted, in a manner to be reviewed and approved by staff consistent with the Certificate of Appropriateness Criteria and/or the directions from the Board.

d. The final location and details of all exterior ramp and railings systems, including materials, dimensions and finishes, shall be provided in a manner to be reviewed and approved by staff consistent with the Certificate of Appropriateness Cificeria

e. All roof-top fixtures, air-conditioning units and mechanical devices shall be clearly noted on a revised roof plan and elevation drawings and shall be screened from our

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> view, in a manner to be reviewed and approved by staff, consistent with the Certificate of Appropriateness Criteria and/or the directions from the Board.

f. A copy of all pages of the recorded Final Order shall be scanned into the plans submitted for building permit, and shall be located immediately after the front cover page of the permit plans.

2. A revised landscape plan, prepared by a Professional Landscape Architect, registered in the State of Florida, and corresponding site plan, shall be submitted to and approved by staff. The species type, quantity, dimensions, spacing, location and overall height of all plant material shall be clearly delineated and subject to the review and approval of staff. At a minimum, such plan shall incorporate the following:

a. Additional landscaping shall be provided within the south side setback, in a manner to be reviewed and approved by staff consistent with the Certificate of Appropriateness Criteria and/or the directions from the Board.

b. The existing hedge within the front yard of the property shall be removed. Within this portion of the site any landscaping shall consist of plant material that does not exceed approximately 36" in height at maturity with the exception of trees, in a manner to be reviewed and approved by staff consistent with the Certificate of Appropriateness Criteria and/or the directions from the Board.

c. The existing chain link fence located within the required front yard shall be removed and replaced with a metal picket fence, in a manner to be reviewed and approved by staff consistent with the Certificate of Appropriateness Criteria and/or the directions from the Board.

d. Gravel shall not be utilized within the required yards, in a manner to be reviewed and approved by staff consistent with the Certificate of Appropriateness Criteria and/or the directions from the Board.

e. Trees shall not be permitted on the roof deck, in a manner to be reviewed and approved by staff consistent with the Certificate of Appropriateness Criteria and/or the directions from the Board.

f. The utilization of root barriers and/or Silva Cells, as applicable, shall be clearly delineated on the final revised landscape plan.

g. A fully automatic irrigation system with 100% coverage and an automatic rain sensor in order to render the system inoperative in the event of rain. Right-ofway areas shall also be incorporated as part of the irrigation system.

In accordance with Section 118-537, the applicant, the owner(s) of the subject property, the City Manager, Miami Design Preservation League, Dade Heritage Trust, or an affected person may appeal the Board's decision on a Certificate of Appropriateness to a special master appointed by the City Commission.

II. Variance(s)

PAGE 3

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H. The conditions of approval herein are binding on the applicant, the property's owners, operators, and all successors in interest and assigns.

I. Nothing in this order authorizes a violation of the City Code or other applicable law, nor allows a relaxation of any requirement or standard set forth in the City Code.

IT IS HEREBY ORDERED, based upon the foregoing findings of fact, the evidence, information, testimony and materials presented at the public hearing, which are part of the record for this matter, and the staff report and analysis, which are adopted herein, including the staff recommendations, which were amended and adopted by the Board, that the Certificate of Appropriateness is GRANTED for the above-referenced project subject to those certain conditions specified in Paragraph I, II,III of the Findings of Fact, to which the applicant has agreed.

PROVIDED, the applicant shall build substantially in accordance with the plans approved by the Historic Preservation Board, as determined by staff, entitled "Residence Detached Addition 925 Lenox Avenue" as prepared by 3 Design Architecture, dated February 23, 2015.

When requesting a building permit, the plans submitted to the Building Department for permit shall be consistent with the plans approved by the Board, modified in accordance with the conditions set forth in this Order. No building permit may be issued unless and until all conditions of approval that must be satisfied prior to permit issuance, as set forth in this Order, have been met.

The issuance of a Certificate of Appropriateness does not relieve the applicant from obtaining all other required Municipal, County and/or State reviews and permits, including final zoning approval. If adequate handicapped access is not provided on the Board-approved plans, this approval does not mean that such handicapped access is not required. When requesting a building permit, the plans submitted to the Building Department for permit shall be consistent with the plans approved by the Board, modified in accordance with the conditions set forth in this Order.

If the Full Building Permit for the project is not issued within eighteen (18) months of the meeting date at which the original Certificate of Appropriateness was granted, the Certificate of Appropriateness will expire and become null and void. If the Full Building Permit for the project should expire for any reason (including but not limited to construction not commencing and continuing, with required inspections, in accordance with the applicable Building Code), the Certificate of Appropriateness will expire and become null and void.

In accordance with Section 118-561 of the City Code, the violation of any conditions and safeguards that are a part of this Order shall be deemed a violation of the land development regulations of the City Code. Failure to comply with this Order shall subject the Certificate of Appropriateness to Section 118-564, City Code, for revocation or modification of the Certificate of Appropriateness.

Dated this 18th day of Mag

HISTORIC PRESERVATION BOARD THE CITY OF MIAMI BEACH, FLORIDA

6. 23 S





DRAWN BY: REVISIONS: Page 4 of 8 HPB File No. 7498 Meeting Date: May 12, 2015 A. The applicant filed an application with the Planning Department for the following variance(s): DUCEDES A variance to reduce 13'-10" from the minimum required width of 22'-0" for a twoway driveway, in order to construct a driveway for four (4) parking spaces with a minimum driveway width of 8'-2". 2. A variance to reduce 3'-0" from the minimum required curb-cut and driveway entrance width of 12'-0", in order to construct a driveway for four (4) parking spaces with a driveway entrance and curb-cut width of 9'-0". A variance to reduce 3'-6" from the minimum required interior side setback of 5'-0" for driveway in order to construct a new driveway on the south side at 1'-6" from the interior property line. A variance to reduce 1'-6" from the minimum required pedestal interior side setback of 7'-6" in order to construct a new residential building addition at 6'-0" from the north property line. 5. A variance to reduce 11'-0" from the minimum required pedestal rear setback of 16'-0" in order to construct a new residential building addition at 5'-0" from the rear property line. A variance to reduce 2'-6" from the minimum required pedestal sum of the side yards of 15'-0" in order to construct a new residential building addition with a sum of the side yards of 12'-6". B. The applicant has submitted plans and documents with the application that satisfy Article 1, Section 2 of the Related Special Acts, allowing the granting of a variance if the Board finds that practical difficulties exist with respect to implementing the proposed project at the subject property. The applicant has submitted plans and documents with the application that also indicate the following, as they relate to the requirements of Section 118-353(d), Miami Beach City Code: That special conditions and circumstances exist which are peculiar to the land, structure, or building involved and which are not applicable to other lands, structures, or buildings in the same zoning district; That the special conditions and circumstances do not result from the action of the applicant; That granting the variance requested will not confer on the applicant any special on privilege that is denied by this Ordinance to other lands, buildings, or structures in the same zoning district; That literal interpretation of the provisions of this Ordinance would deprive the applicant of rights commonly enjoyed by other properties in the same zoning district Under the PAGE 4 DR BK 27657 PG 3748 LAST PAGE SEAL Page 8 of 8 PRESERVATION BOARD HPB File No. 7498 Meeting Date: May 12, 2015 ADDI AVENUE FL 331 DENCE/DETACHED ETORAL TACKET PRESERVATION AND DESIGN MANAGER BEACH, FOR THE CHAIR STATE OF FLORIDA COUNTY OF MIAMI-DADE 925 AMI E **HISTORIC** The foregoing instrument was acknowledged before me this \geq 2015 by Deborah Tackett, Preservation and Design Manager, may Planning Departmentwell Buildiami Beach, Florida, a Florida Municipal Corporation, on behalf of the corporation of the stand when to me. Ш 10-2-2 NOTARY PUBLIC Miami-Dade County, Florida My commission expires: July 26, 2011 Approved As To City Attorney's Office:" Filed with the Clerk of the Historic Preservation Board F:PLANISHPBI.15HPBI05-12-2015NOrders/HPB 7498_925 Lenox Av SLMay15.FO.docv THESE PLANS ARE FOR BUILDING DEPARTMENT REVIEW ONLY. THEY ARE NOT TO BE CONSTRUED AS CONSTRUCTION STATE OF FLORIDA, COUNTY OF DADA DOCUMENTS UNTIL ALL BUILDING DEPARTMENT APPROVALS ARE OBTAINED. prights on the in the discs. did MARVEY REAVINE CLORE A PAGE 8 PREVIOUS FINAL ORDER

MIAMIBEACH

Planning Department, 1700 Convention Center Drive Miami Beach, Florida 33139, www.miamibeachfl.gov 305.673.7550

MULTIFAMILY - COMMERCIAL - ZONING DATA SHEET

ITEM #	Zoning Information					
1	Address:	925 Lenox Avenue, Miami Beach, Florida, 33139				
2	Board and file numbers :		Historic Preservation Board, HPB18-0247			
3	Folio number(s):	02-4203-014-0190	· · · · ·			
4	Year constructed:	1942	Zoning District:	RM-1		
5	Based Flood Elevation:	+9.00' NGVD	Grade value in NGVD:	+5.37' NGVD		
6	Adjusted grade (Flood+Grade/2):	+7.19' NGVD	Lot Area:	10,000 S.F.		
7	Lot width:	62.50'	Lot Depth:	160.00'		
8	Minimum Unit Size	550 S.F.	Average Unit Size	800 S.F.		
9	Existing use:	Apartments	Proposed use:	Apartments + Dupl	ex	
		Maximum	Existing	Proposed	Deficiencies	
10	Height	35'-0" above grade	22'-11"	34'-10 1/2"	N/A	
11	Number of Stories	3	2	3	N/A	
12	FAR	1.25	0.75	1.082	N/A	
13	Gross square footage	12,500 G.S.F.	3,295 G.S.F.	3,295 + 7,525 = 10,820		
14	Square Footage by use	N/A	3,295 (Residential)	10,820 (Residential)	N/A	
15	Number of units Residential	N/A	3	2	N/A	
16	Number of units Hotel	N/A	N/A	N/A	N/A	
17	Number of seats	N/A	N/A	N/A	N/A	
18	Occupancy load	N/A	16	16 + 22 = 38	N/A	
	Setbacks	Required	Existing	Proposed	Deficiencies	
	Subterranean:	N/A	N/A	N/A	N/A	
19	Front Setback:	N/A	N/A	N/A	N/A	
20	Side Setback:	N/A	N/A	N/A	N/A	
21	Side Setback:	N/A	N/A	N/A	N/A	
22	Side Setback facing street:	N/A	N/A	N/A	N/A	
23	Rear Setback:	N/A	N/A	N/A	N/A	
	At Grade Parking:					
24	Front Setback:	20'-0"	8'-9"	94'-6 1/2"	N/A	
25	Side Setback:	5'-0"	5'-9"	15'-0"	N/A	
26	Side Setback:	5'-0"	35'-9"	21'-4 1/2"	N/A	
27	Side Setback facing street:	N/A	N/A	N/A	N/A	
28	Rear Setback:	16'-0"(10% lot depth)	140'-10 1/2"	5'-8"	Variance requested	
	Pedestal:					
29	Front Setback:	20'-0"	25'-8"	73'-11"	N/A	
30	Side Setback:	7'-6"	5'-0"	6'-0"	2 Variances requested	
31	Side Setback:	7'-6"	10'-6"	7'-6"	N/A	
32	Side Setback facing street:	N/A	N/A	N/A	N/A	
33	Rear Setback:	16'-0"(10% lot depth)	89'-8"	5'-0"	Variance requested	
	Tower:					
34	Front Setback:	N/A	N/A	N/A	N/A	
35	Side Setback:	N/A	N/A	N/A	N/A	

MIAMIBEACH

Planning Department, 1700 Convention Center Drive Miami Beach, Florida 33139, www.miamibeachfl.gov 305.673.7550

1 of 2

ITEM	1				
#	Setbacks	Required	Existing	Proposed	Deficiencies
36	Side Setback:	N/A	N/A	N/A	N/A
37	Side Setback facing street:	N/A	N/A	N/A	N/A
38	Rear Setback:	N/A	N/A	N/A	N/A

	Parking	Required	Existing	Proposed	Deficiencies
39	Parking district	N/A	Parking District No. 1	N/A	N/A
40	Total # of parking spaces	4	1	4	N/A
41	# of parking spaces per use (Provide a separate chart for a breakdown calculation)	2 per dwelling 0 per apartment	1	4	N/A
42	# of parking spaces per level (Provide a separate chart for a breakdown calculation)	2 per level - duplex 0 per level - apartment	0.5 per level - apartment	2 per level - duplex 0 per level - apartment	N/A
43	Parking Space Dimensions	8'-6" x 18'-0"	10'-4 x 21'-0"	8'-6" x 18'-0"	N/A
44	Parking Space configuration (450,600,900,Parallel)	N/A	900	900	N/A
45	ADA Spaces	0	0	0	N/A
46	Tandem Spaces	0	0	0	N/A
47	Drive aisle width	22'-0" (2-way)	9'-0"	9'-0"	Variance requested
48	Valet drop off and pick up	N/A	N/A	N/A	N/A
49	Loading zones and Trash collection areas	N/A	N/A	N/A	N/A
50	racks	N/A	N/A	N/A	N/A

	Restaurants, Cafes, Bars, Lounges,				
	Nightclubs	Required	Existing	Proposed	Deficiencies
51	Type of use	N/A	N/A	N/A	N/A
52	Number of seats located outside on private property	N/A	N/A	N/A	N/A
53	Number of seats inside	N/A	N/A	N/A	N/A
54	Total number of seats	N/A	N/A	N/A	N/A
55	Total number of seats per venue (Provide a separate chart for a breakdown calculation)	N/A	N/A	N/A	N/A
56	Total occupant content	N/A	N/A	N/A	N/A
57	Occupant content per venue (Provide a separate chart for a breakdown calculation)	N/A	N/A	N/A	N/A

58	Proposed hours of operation	N/A	
59	Is this an NIE? (Neighboot Impact stablishment, see CMB 141-1361)	N/A	
60	Is dancing and/or entertainment proposed ? (see CMB 141-1361)	N/A	
61	Is this a contributing building?	Yes or No N/A	
62	Located within a Local Historic District?	Yes or No N/A	

Notes:

If not applicable write N/A

All other data information may be required and presented like the above format.

2 of 2

	AAOOO3569 ANTHONY LEON 0016752		
C			3260 Northwest 7th Street, Miami, FL 33125 P: 305.438.9377 F: 305.438.9379
HISTORIC PRESERVATION BOARD	RESIDENCE/DETACHED ADDITION	AVENUE	MIAMI BEACH, FL 33139

DEPARTMENT APPROVALS ARE OBTAINED. HPB-0.2 ZONING DATA SHEET

SCOPE OF WORK:


THE ADDITION OF A 3 STORY DUPLEX INCLUDING A POOL/POOL DECK AT ROOF LEVEL TO BE LOCATED AT THE REAR OF THE PROPERTY. THE DEMOLITION OF THE EXISTING STEPS AT THE REAR OF THE EXISTING BUILDING TO BE REPLACED BY NEW CONCRETE STEPS, CONCRETE WALKWAY, AND LANDSCAPE BETWEEN BUILDINGS. THE PROPOSED DUPLEX WILL BE OF AN ART DECO/CONTEMPORARY STYLE DESIGN, AND A CONCRETE AND GLASS TYPE CONSTRUCTION.

CODE SUMMARY: **APPLICABLE CODES:** Florida Building Code, Building - 2017 (6th Ed.) Florida Building Code, Existing - 2017 (6th Ed.) Florida Fire Prevention Code - 2017 (6th Ed.) City of Miami Beach Zoning Code

FOLIO NO: 02-4203-014-0190


LEGAL DESCRIPTION: LENOX MANOR RE-SUB PB 7-15 LOT 9 BLK 120 LOT SIZE 62.500 X 160 OR 19557-1415 03 2001 1 COC 26451-4223 06 2008 1

RESIDENTIAL MULTIFAMILY, R-3 FLAMINGO PARK HISTORIC DISTRICT

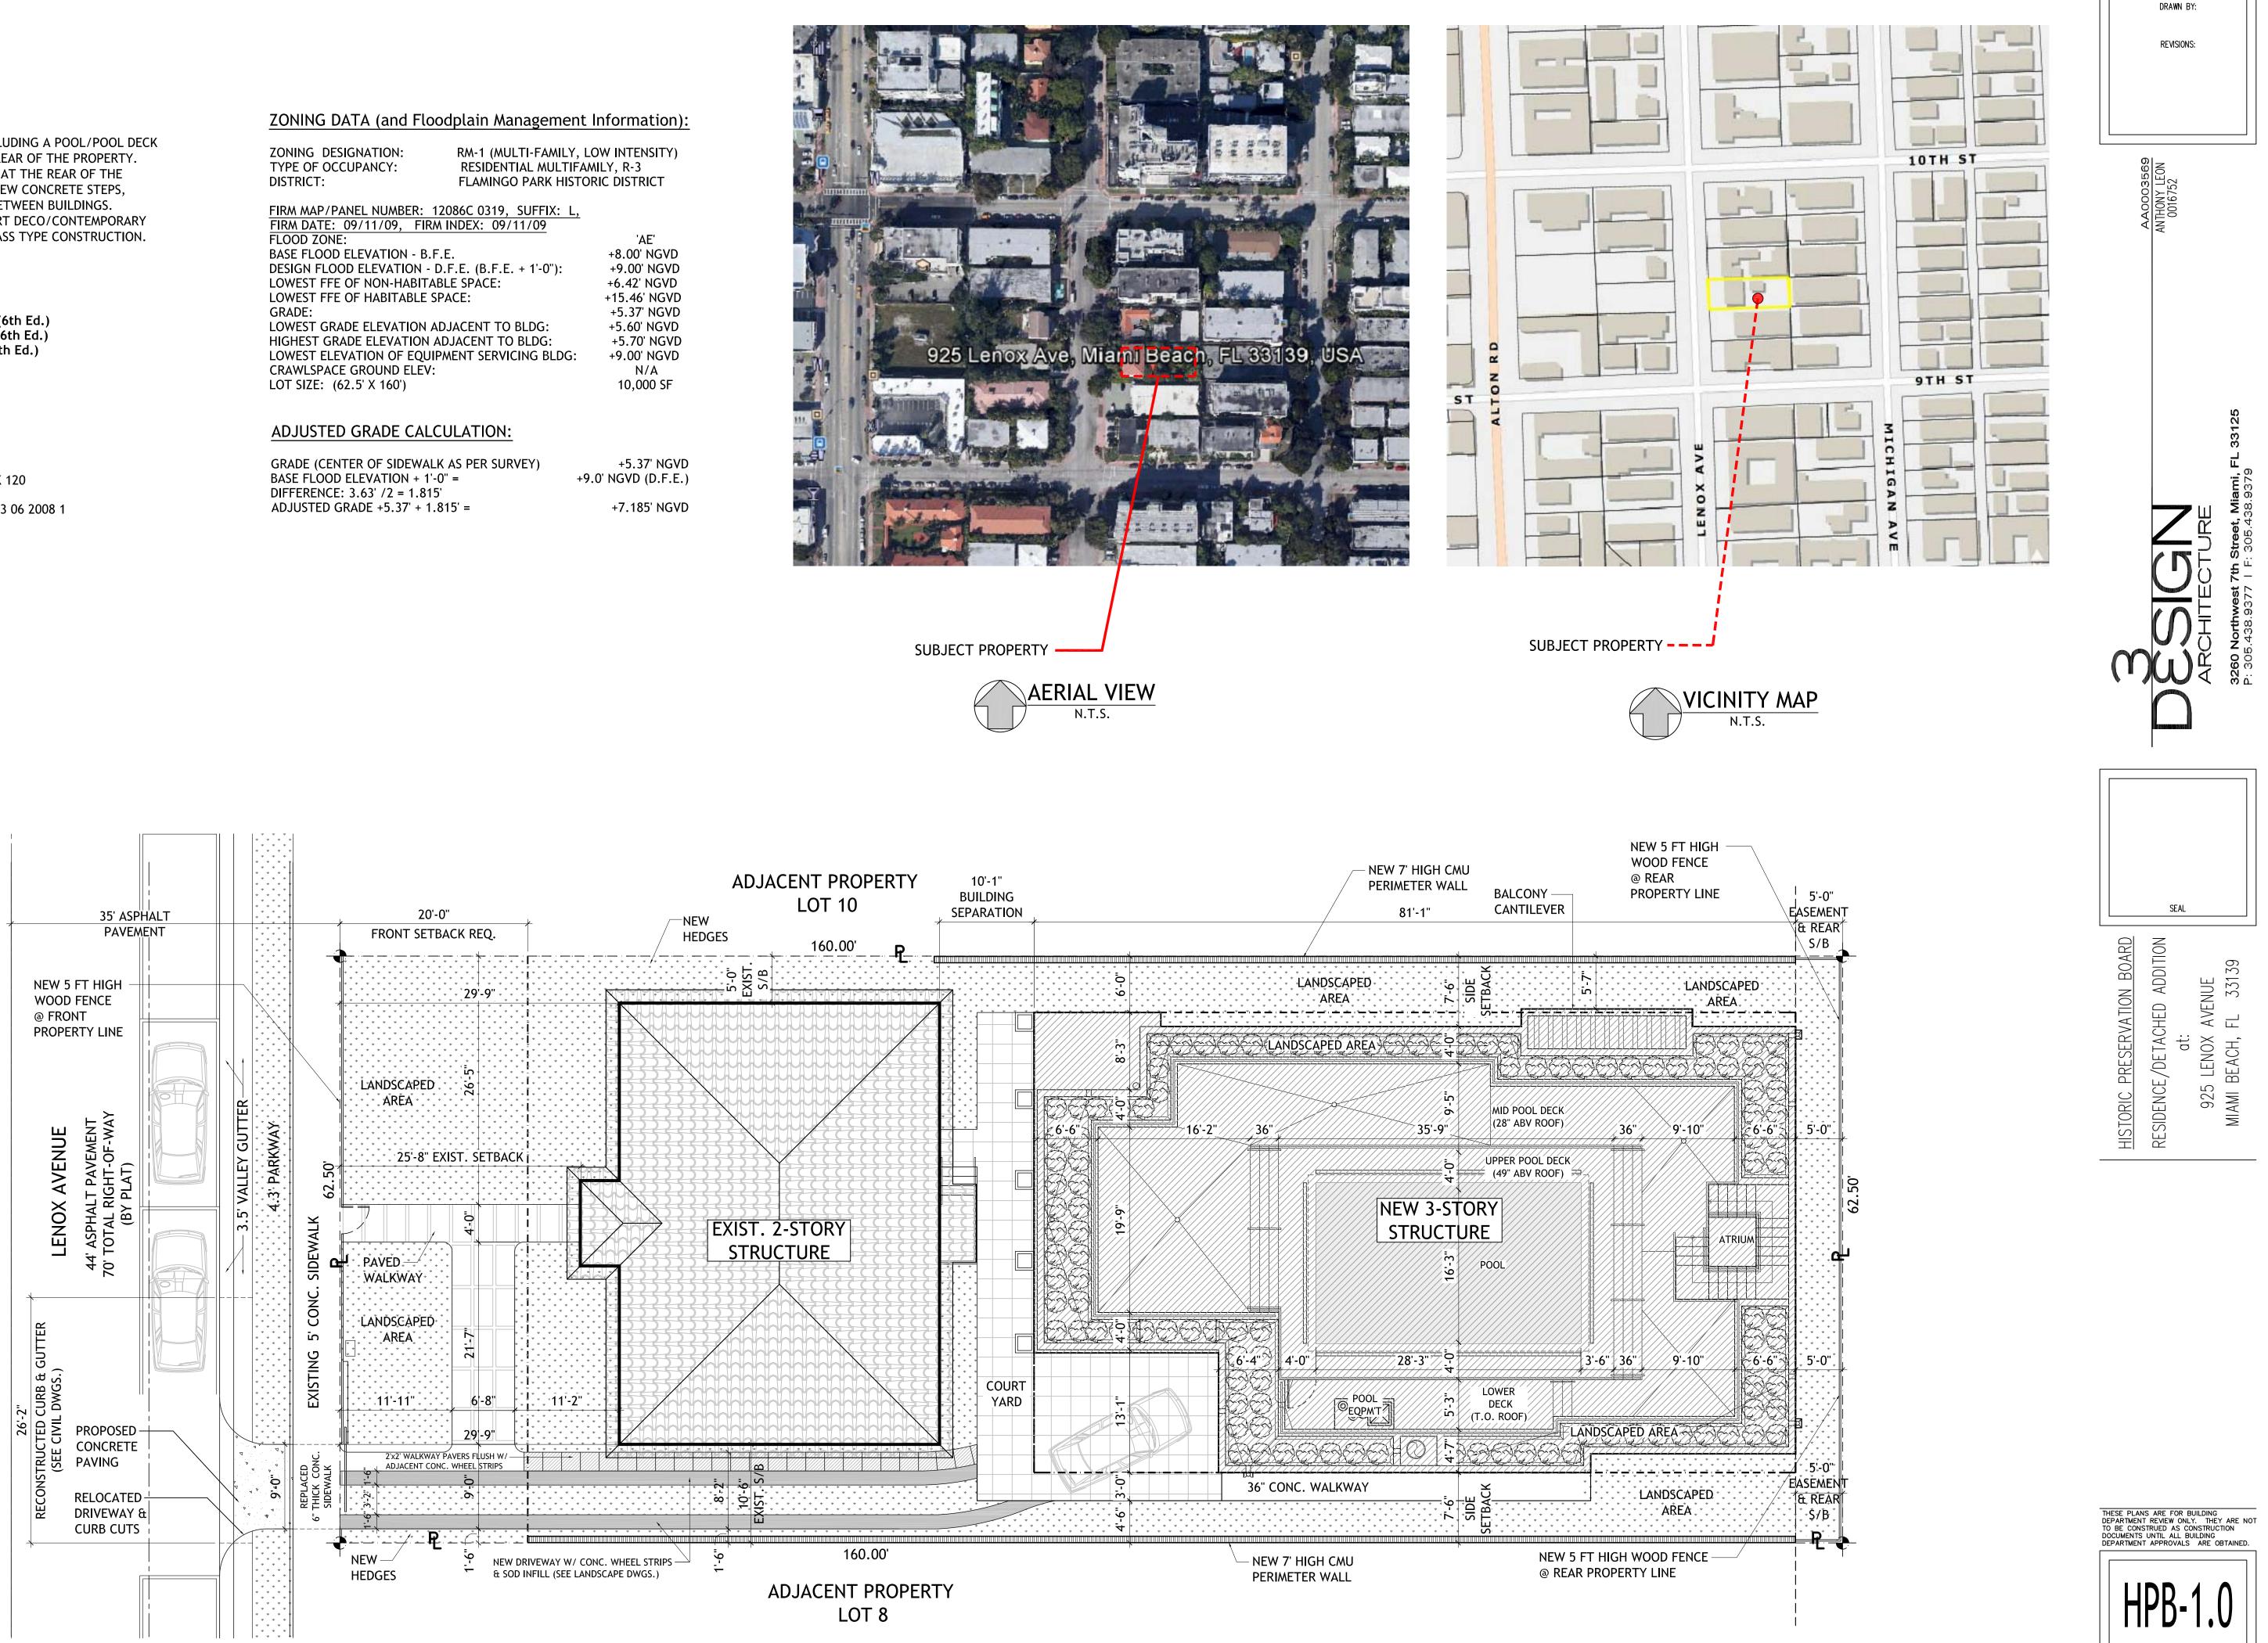


SITE PLAN SCALE: 1/8" = 1'-0"

SCALE: $\frac{1}{8}$ = 1'-0"

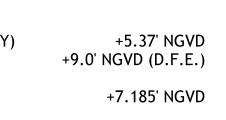


FFIA: L,	
09	
	'AE'
	+8.00' NGVD
1'-0"):	+9.00' NGVD
	+6.42' NGVD
	+15.46' NGVD
	+5.37' NGVD
DG:	+5.60' NGVD
DG:	+5.70' NGVD
G BLDG:	+9.00' NGVD
	NT / A

SITE PLAN, GENERAL NOTES & PROJECT DATA

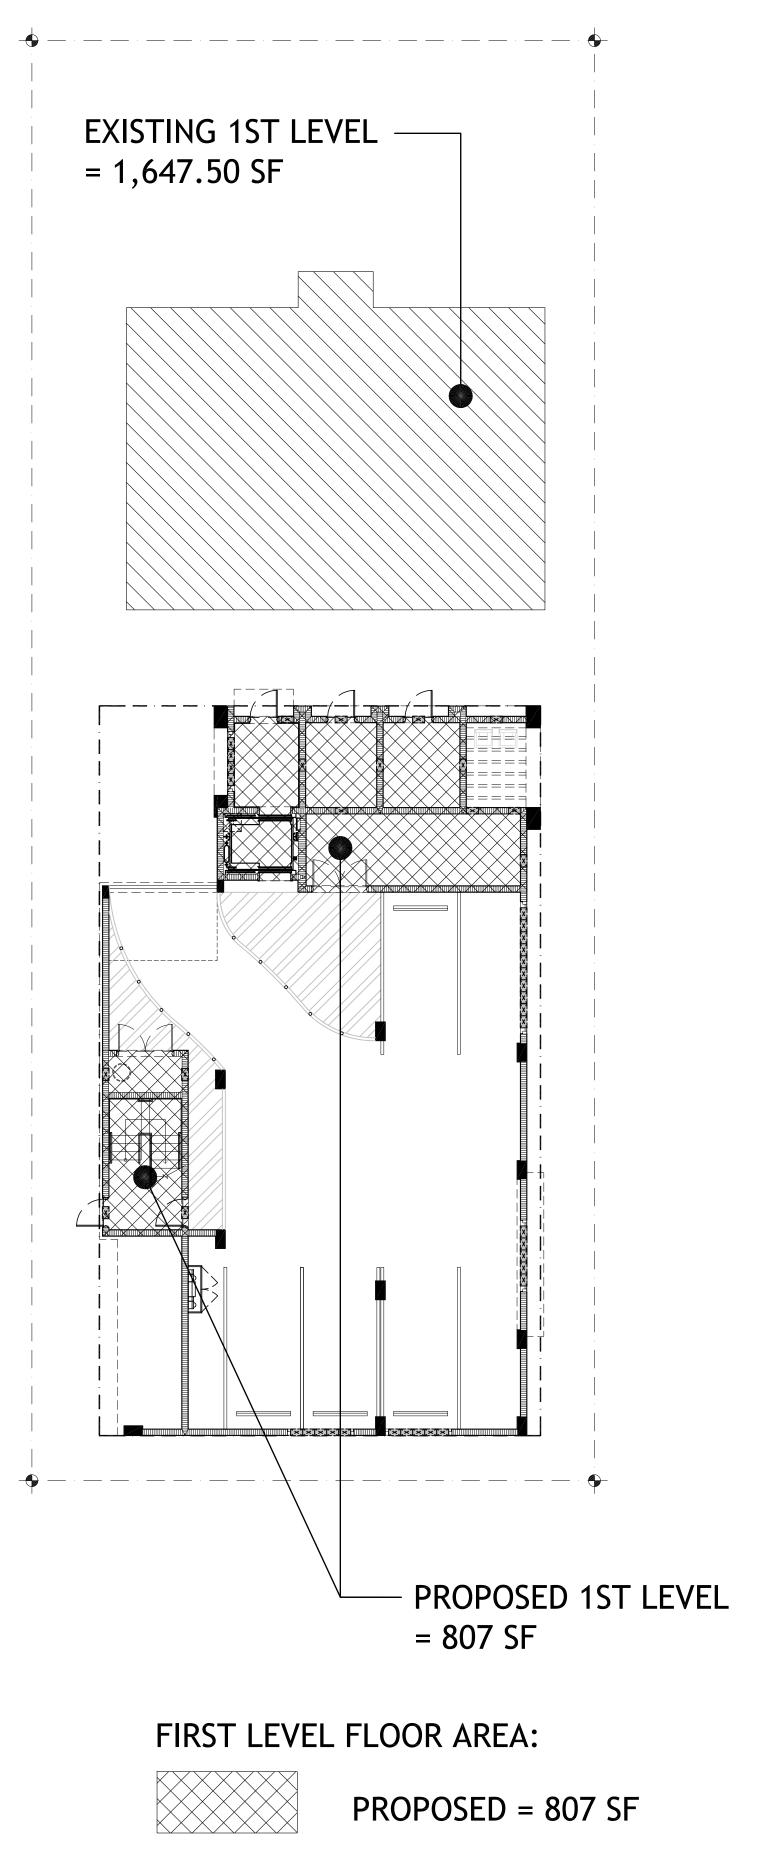





EXISTING = 1,647.50 SF

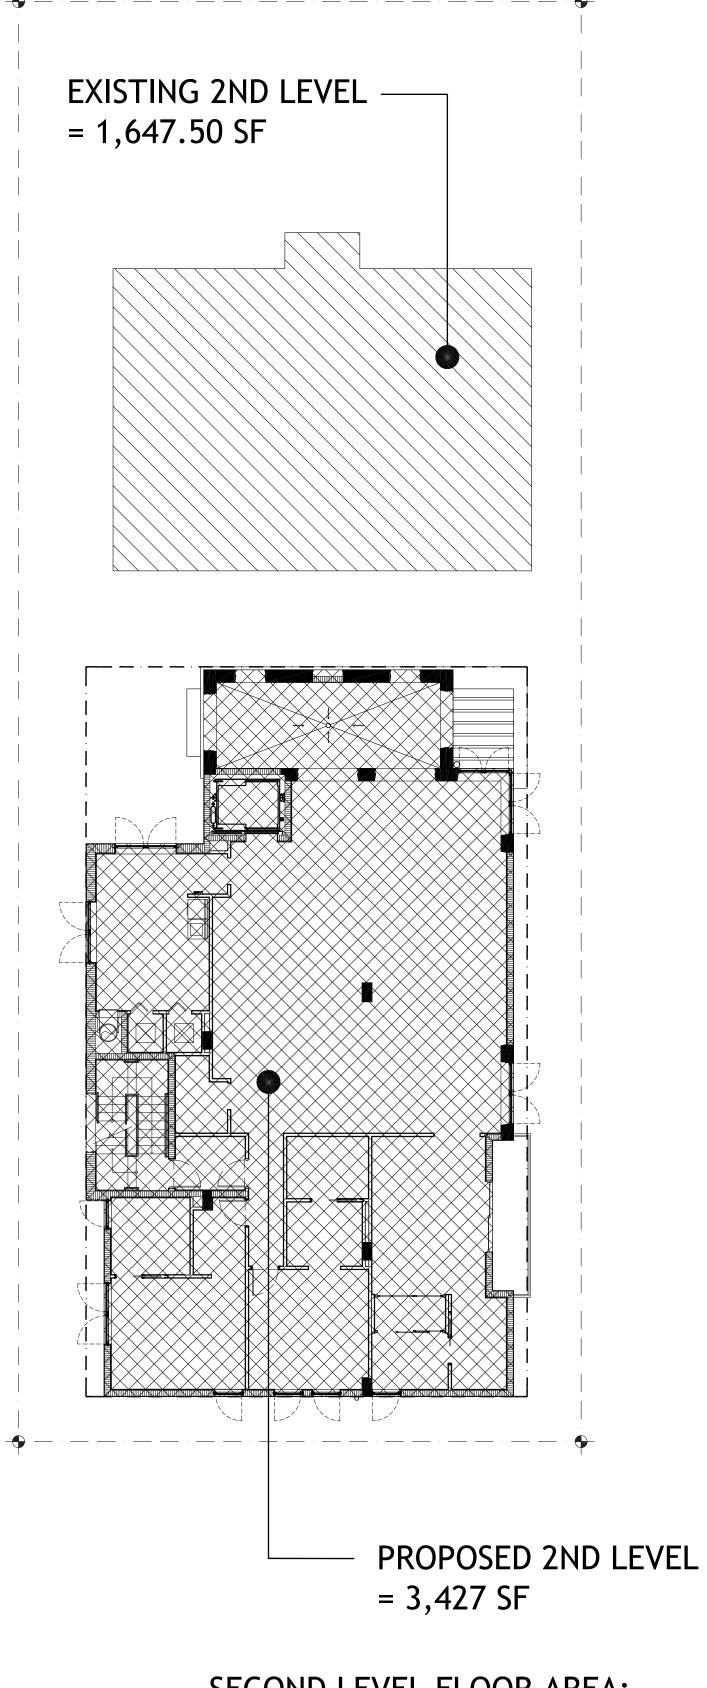

SECOND LEVEL FLOOR AREA:

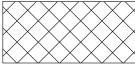


 $\mathsf{PROPOSED} = 3,427 \; \mathsf{SF}$

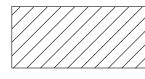


EXISTING = 1,647.50 SF


FLOOR AREA PROPOSED:	= 7,525 SF
TOTAL FLOOR AREA INCLUDING EXISTING:	= 10,820 SF
PROPOSED F.A.R.	= 1.082
MAX. ALLOWABLE F.A.R.	= 1.25

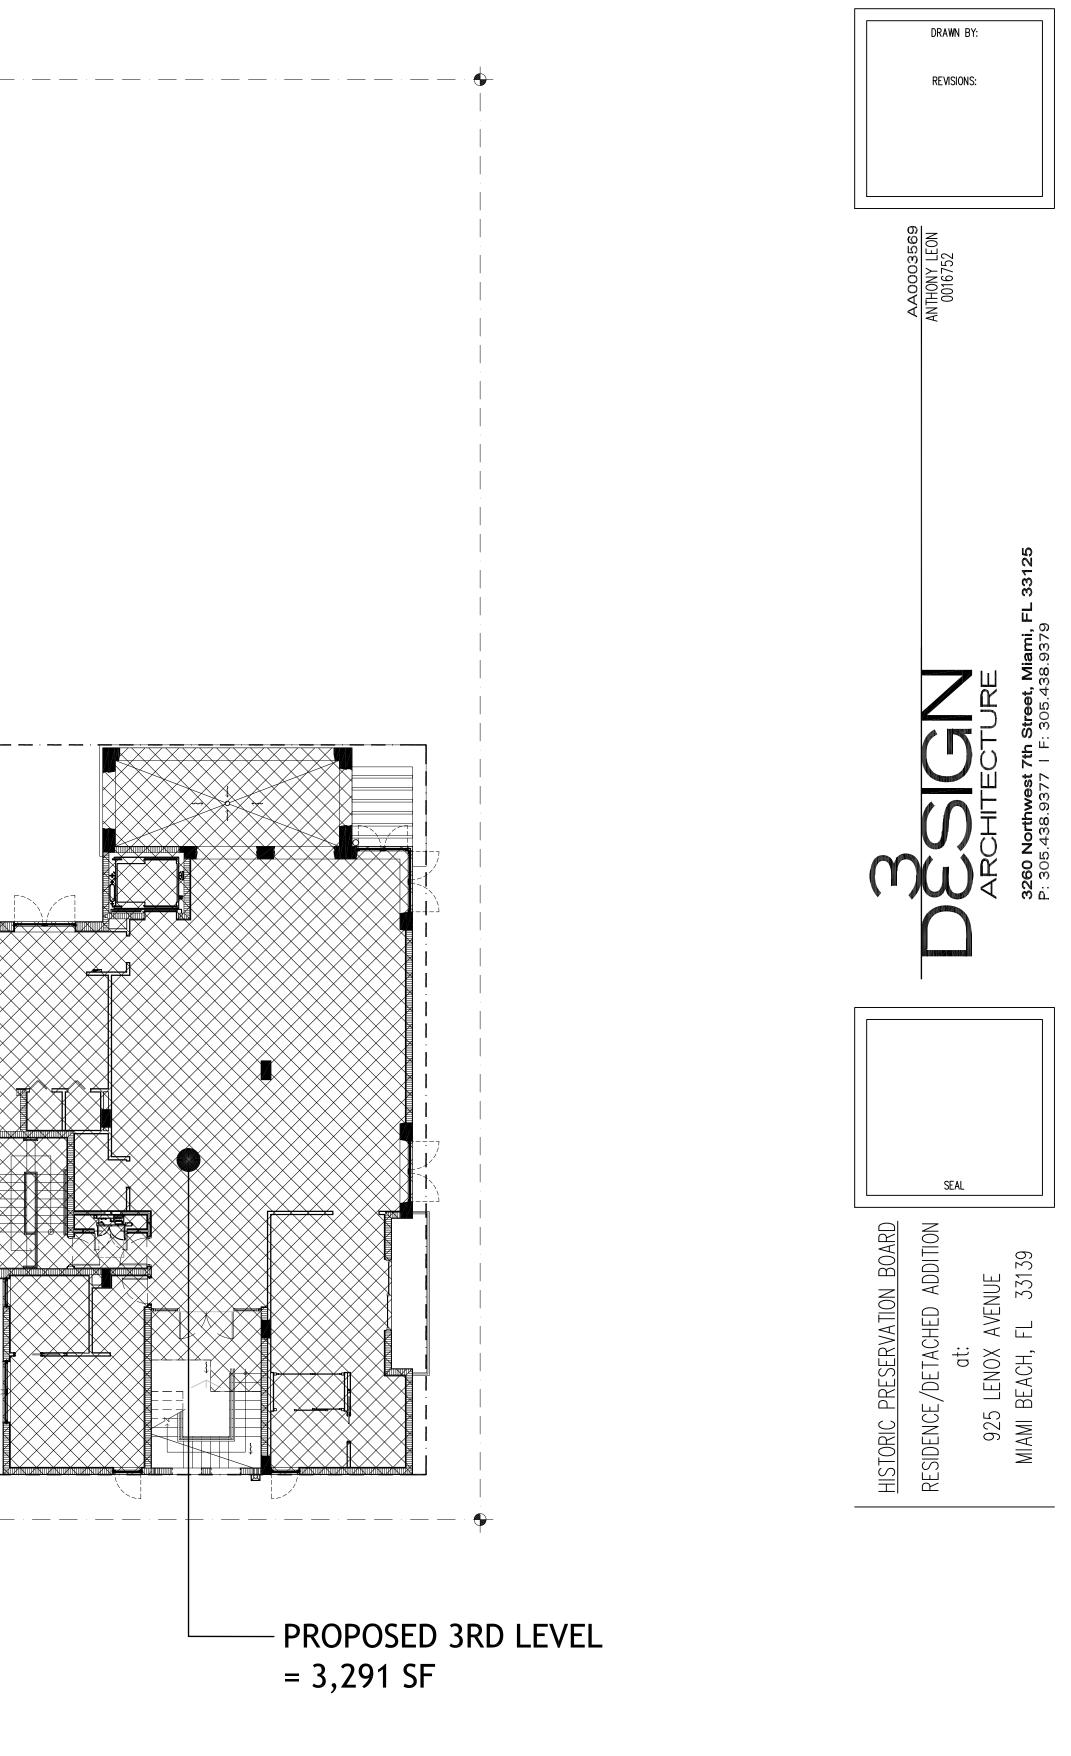



THIRD LEVEL FLOOR AREA:

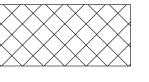


 $\mathsf{PROPOSED} = 3,291 \, \mathsf{SF}$

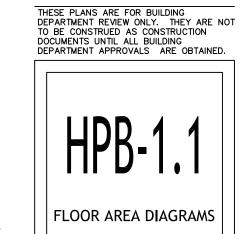

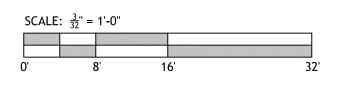

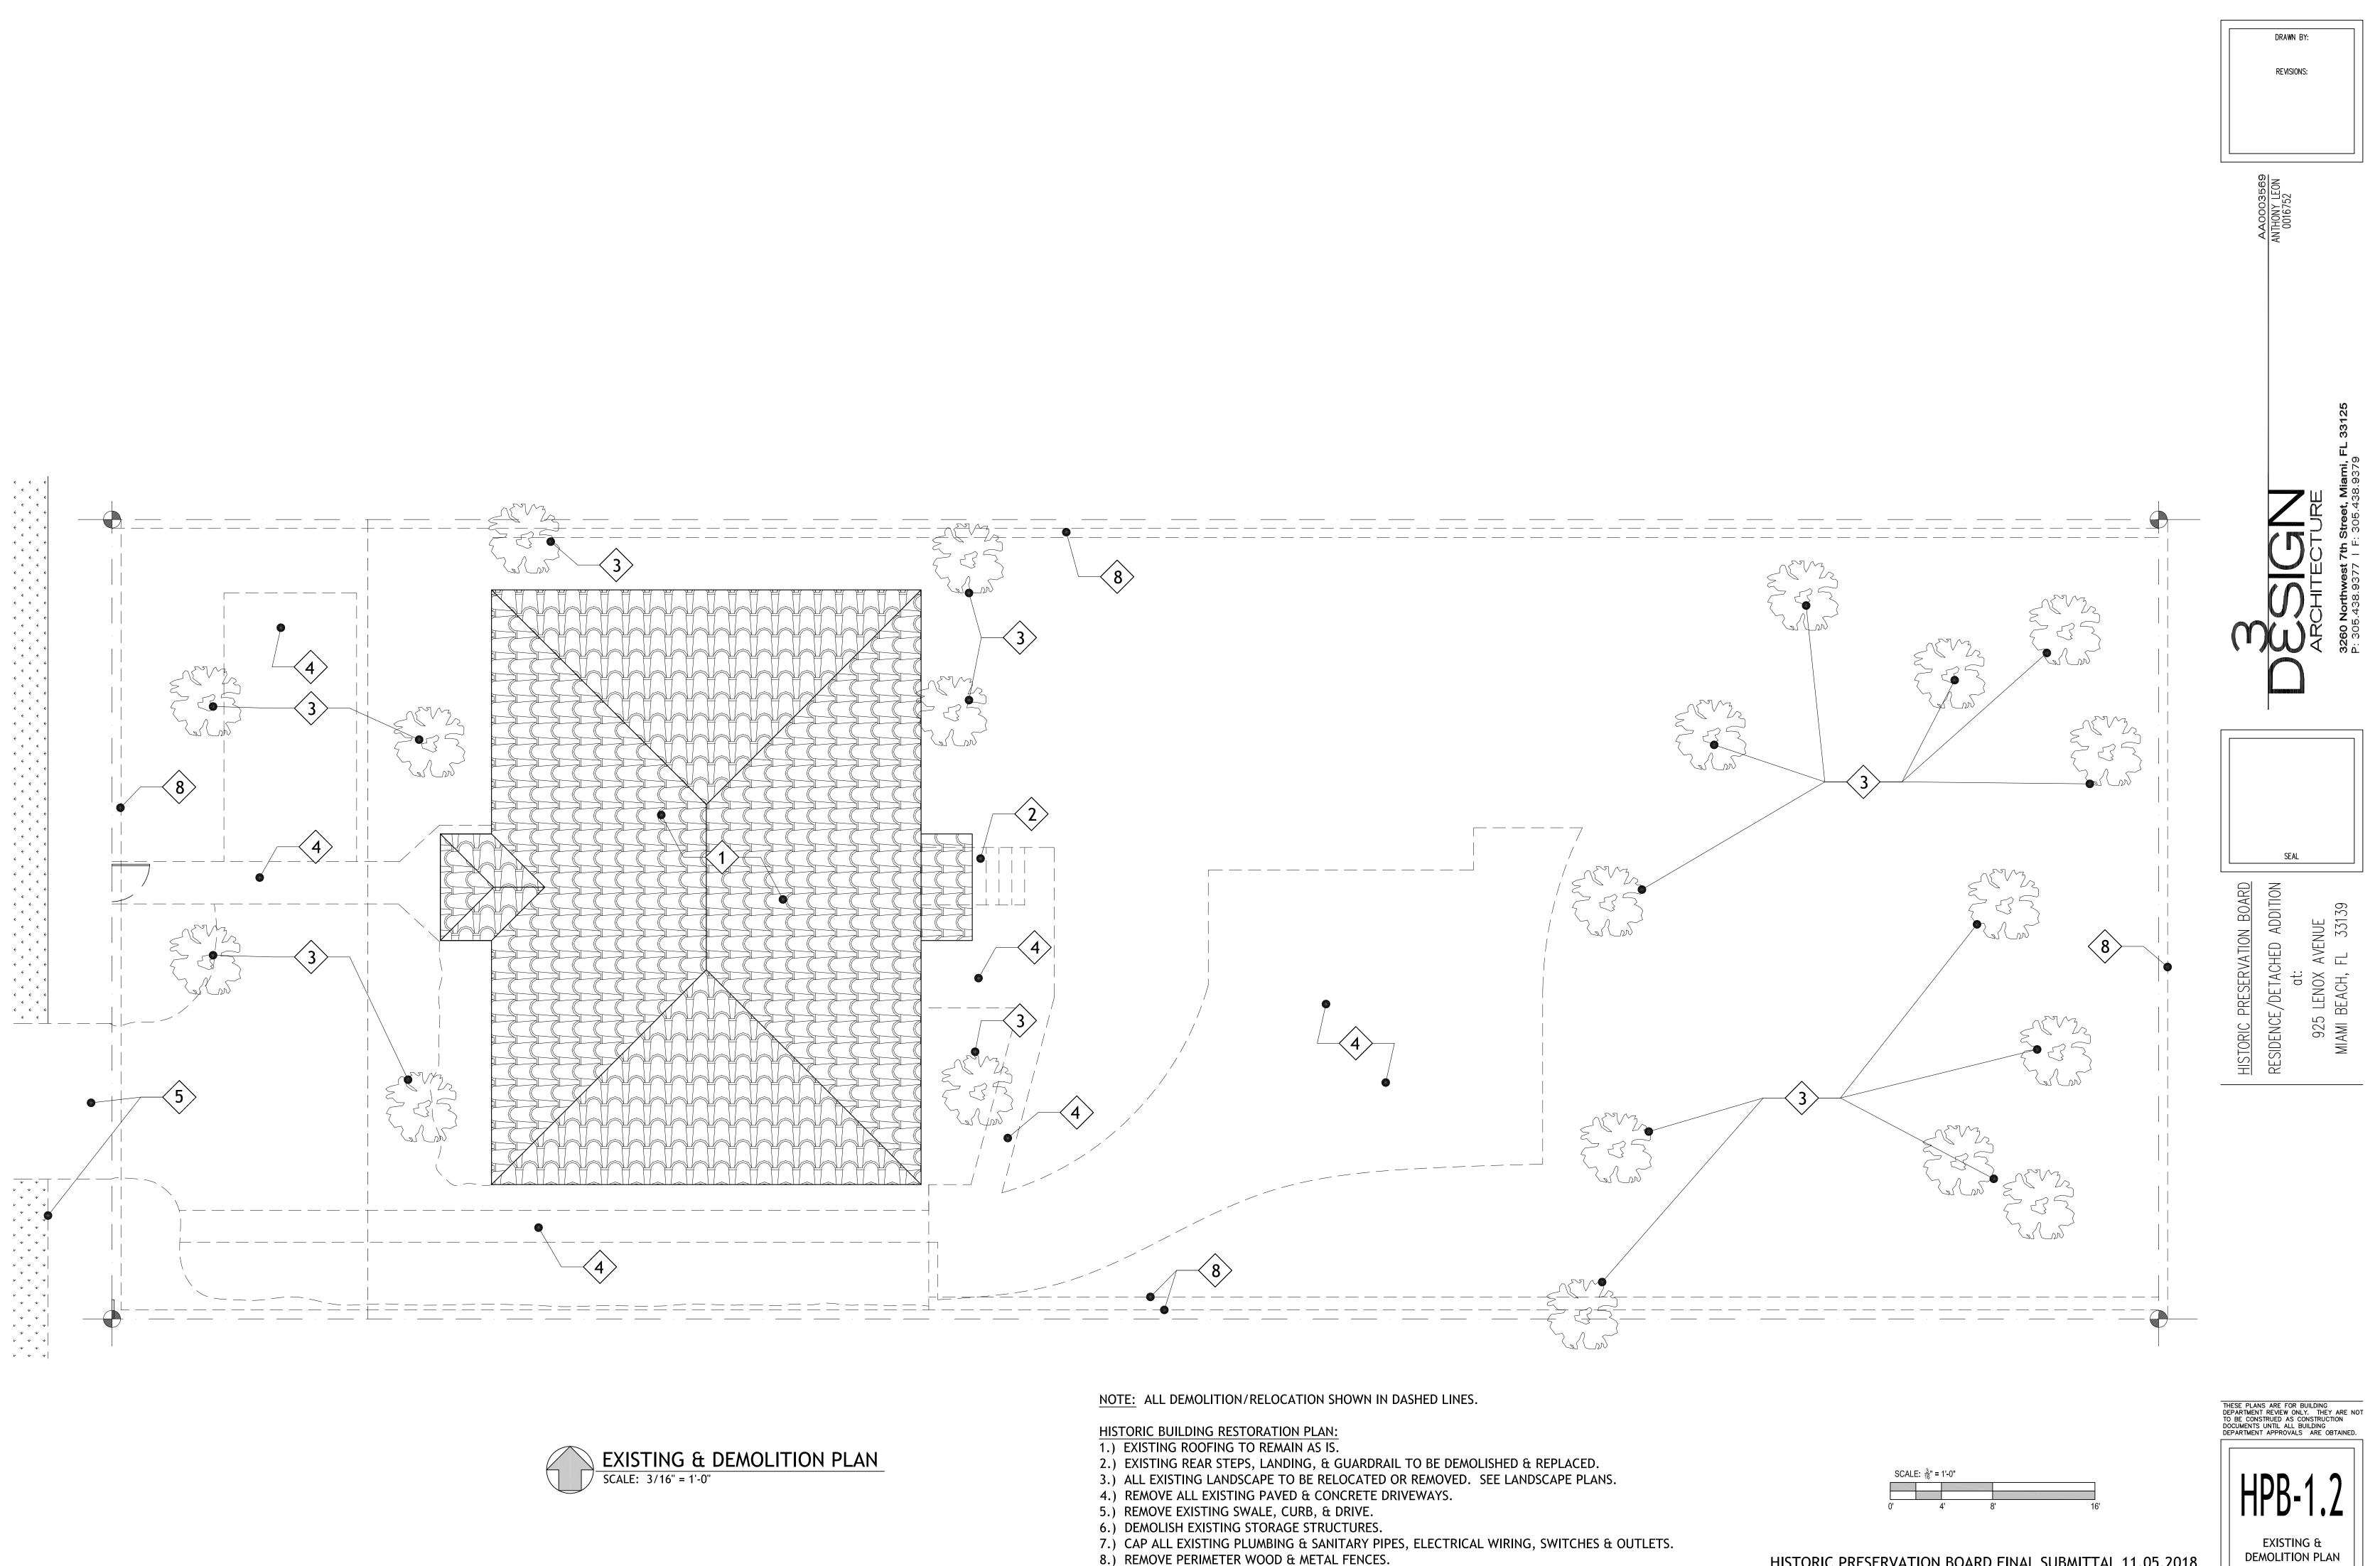


- 8.) REMOVE PERIMETER WOOD & METAL FENCES.

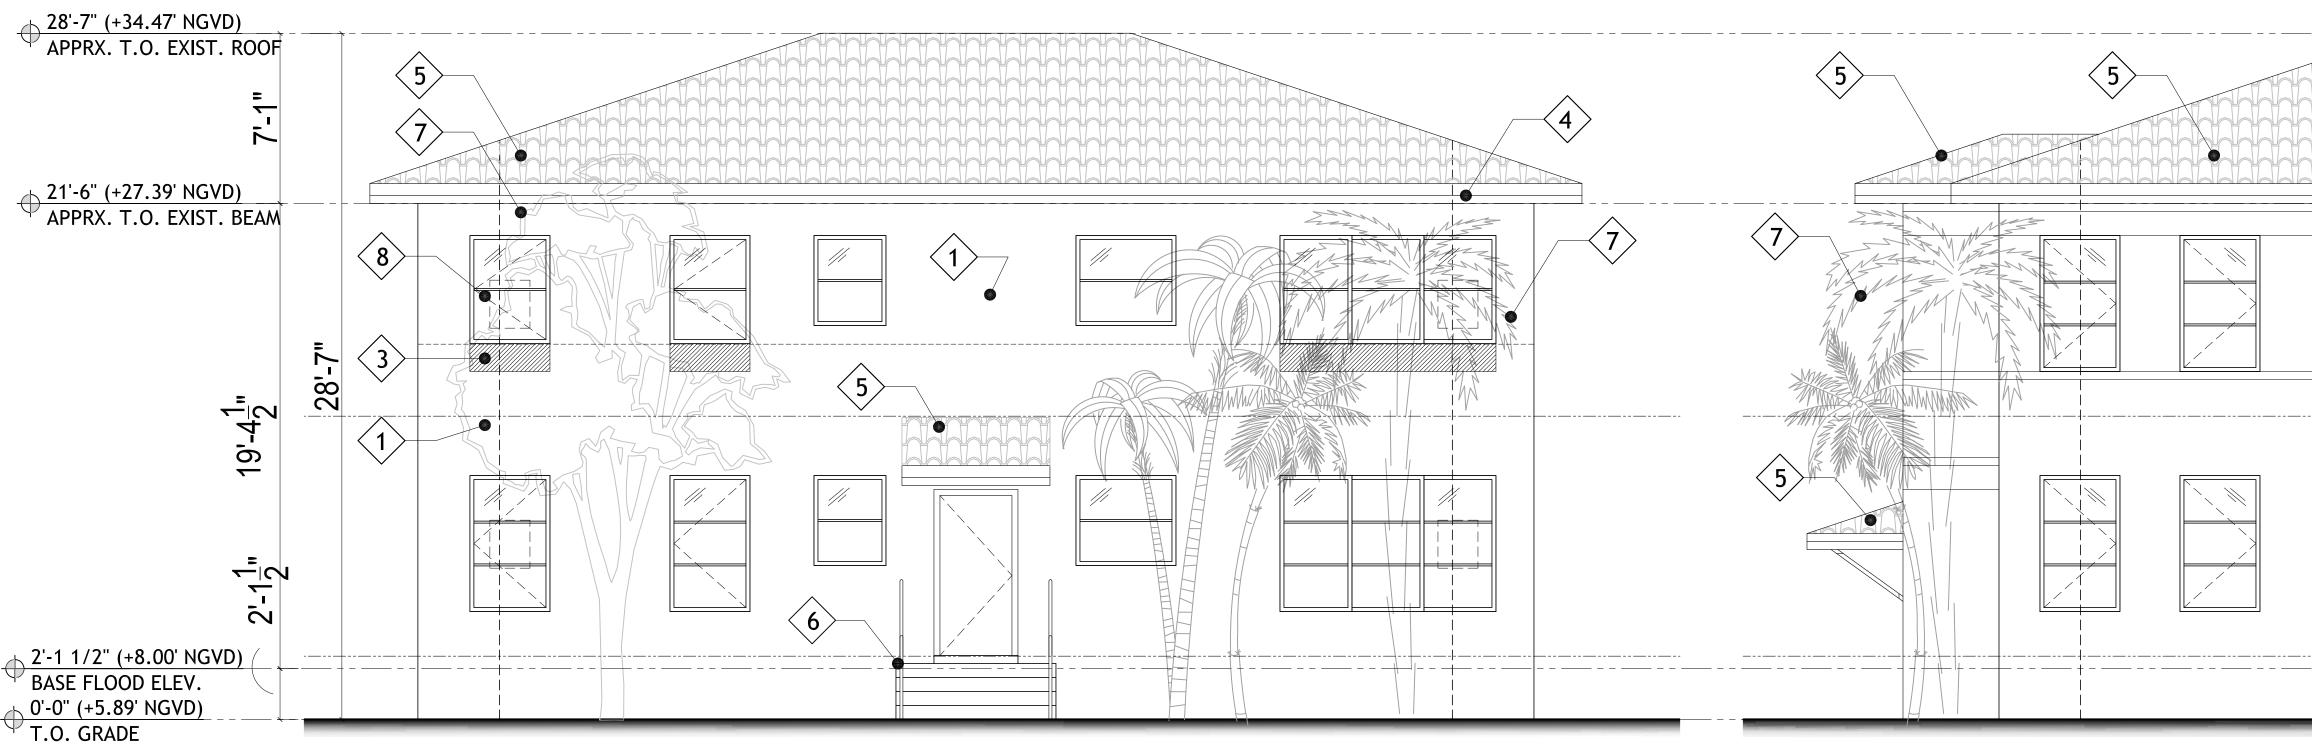

EXISTING PRINCIPAL BUILDING TO BE RESTORED




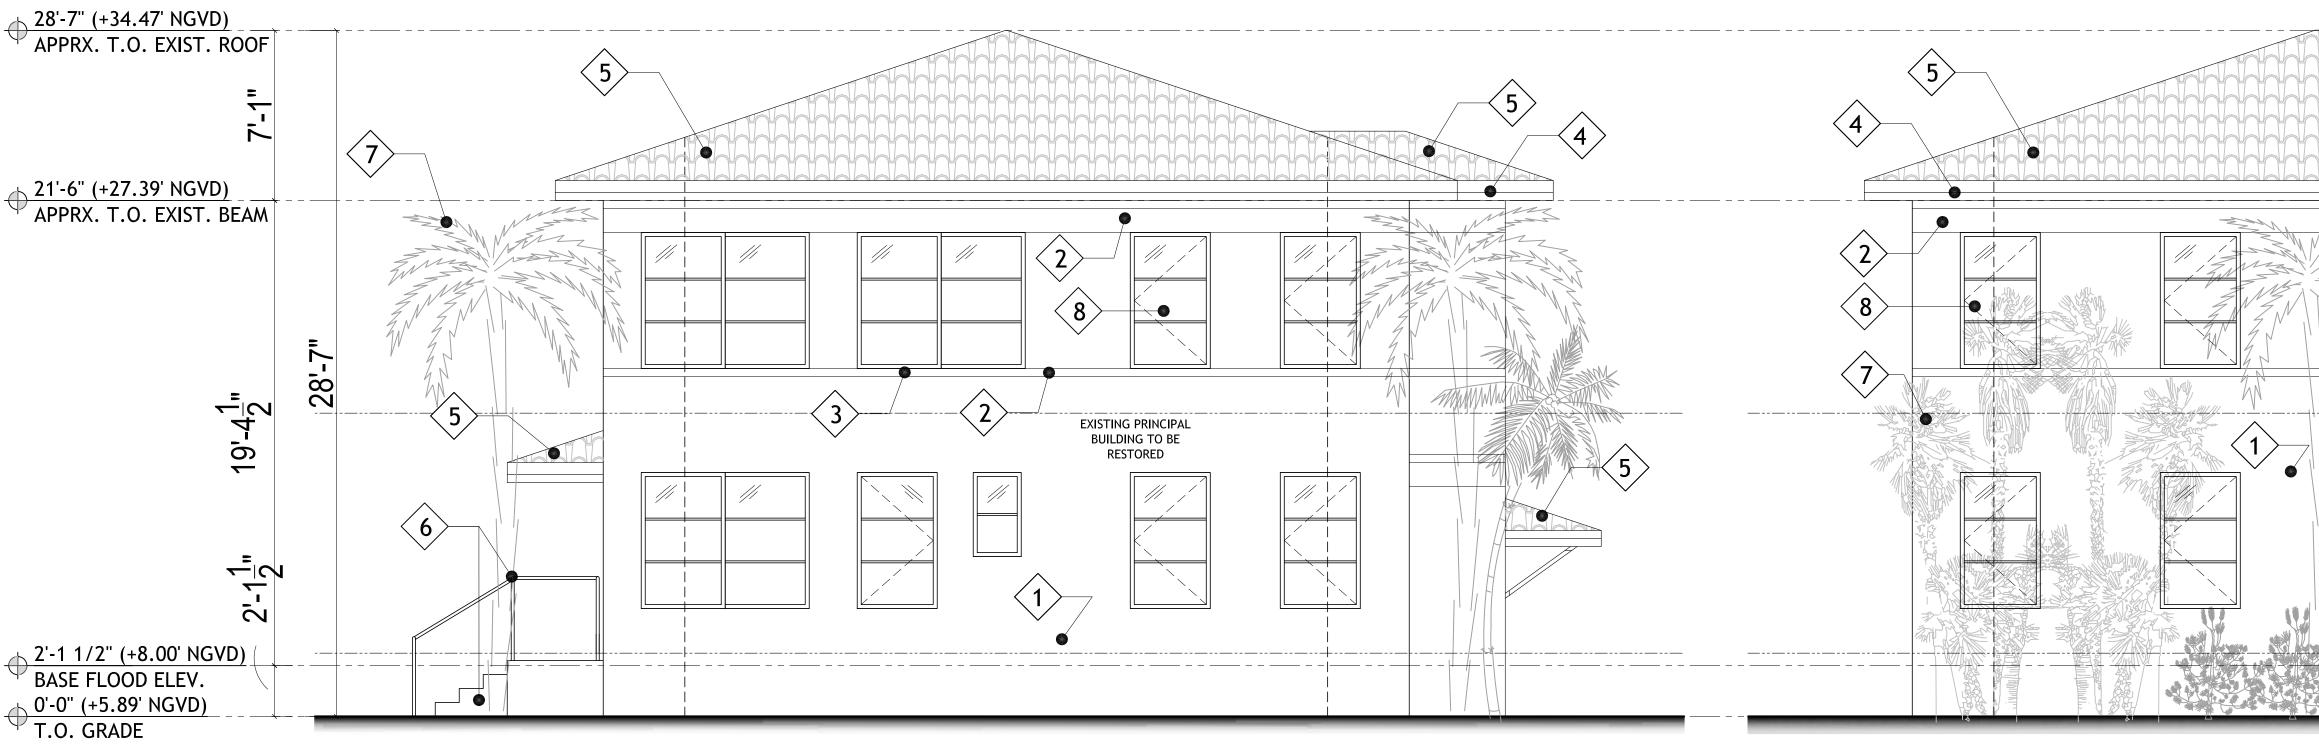


EXISTING PRINCIPAL BUILDING TO BE RESTORED


SIDE ELEVATION (NORTH) SCALE: 1/4" = 1'-0"



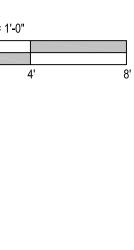


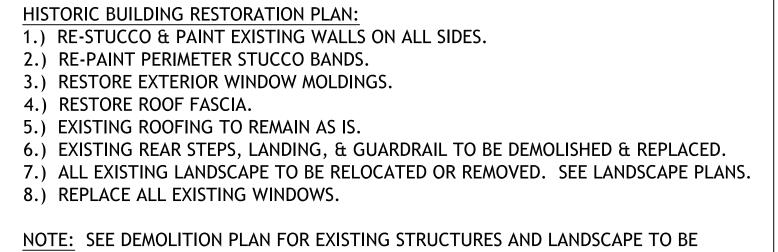


REMOVED & RELOCATED.

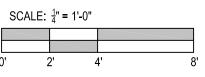


SCALE: 1/4" = 1'-0"

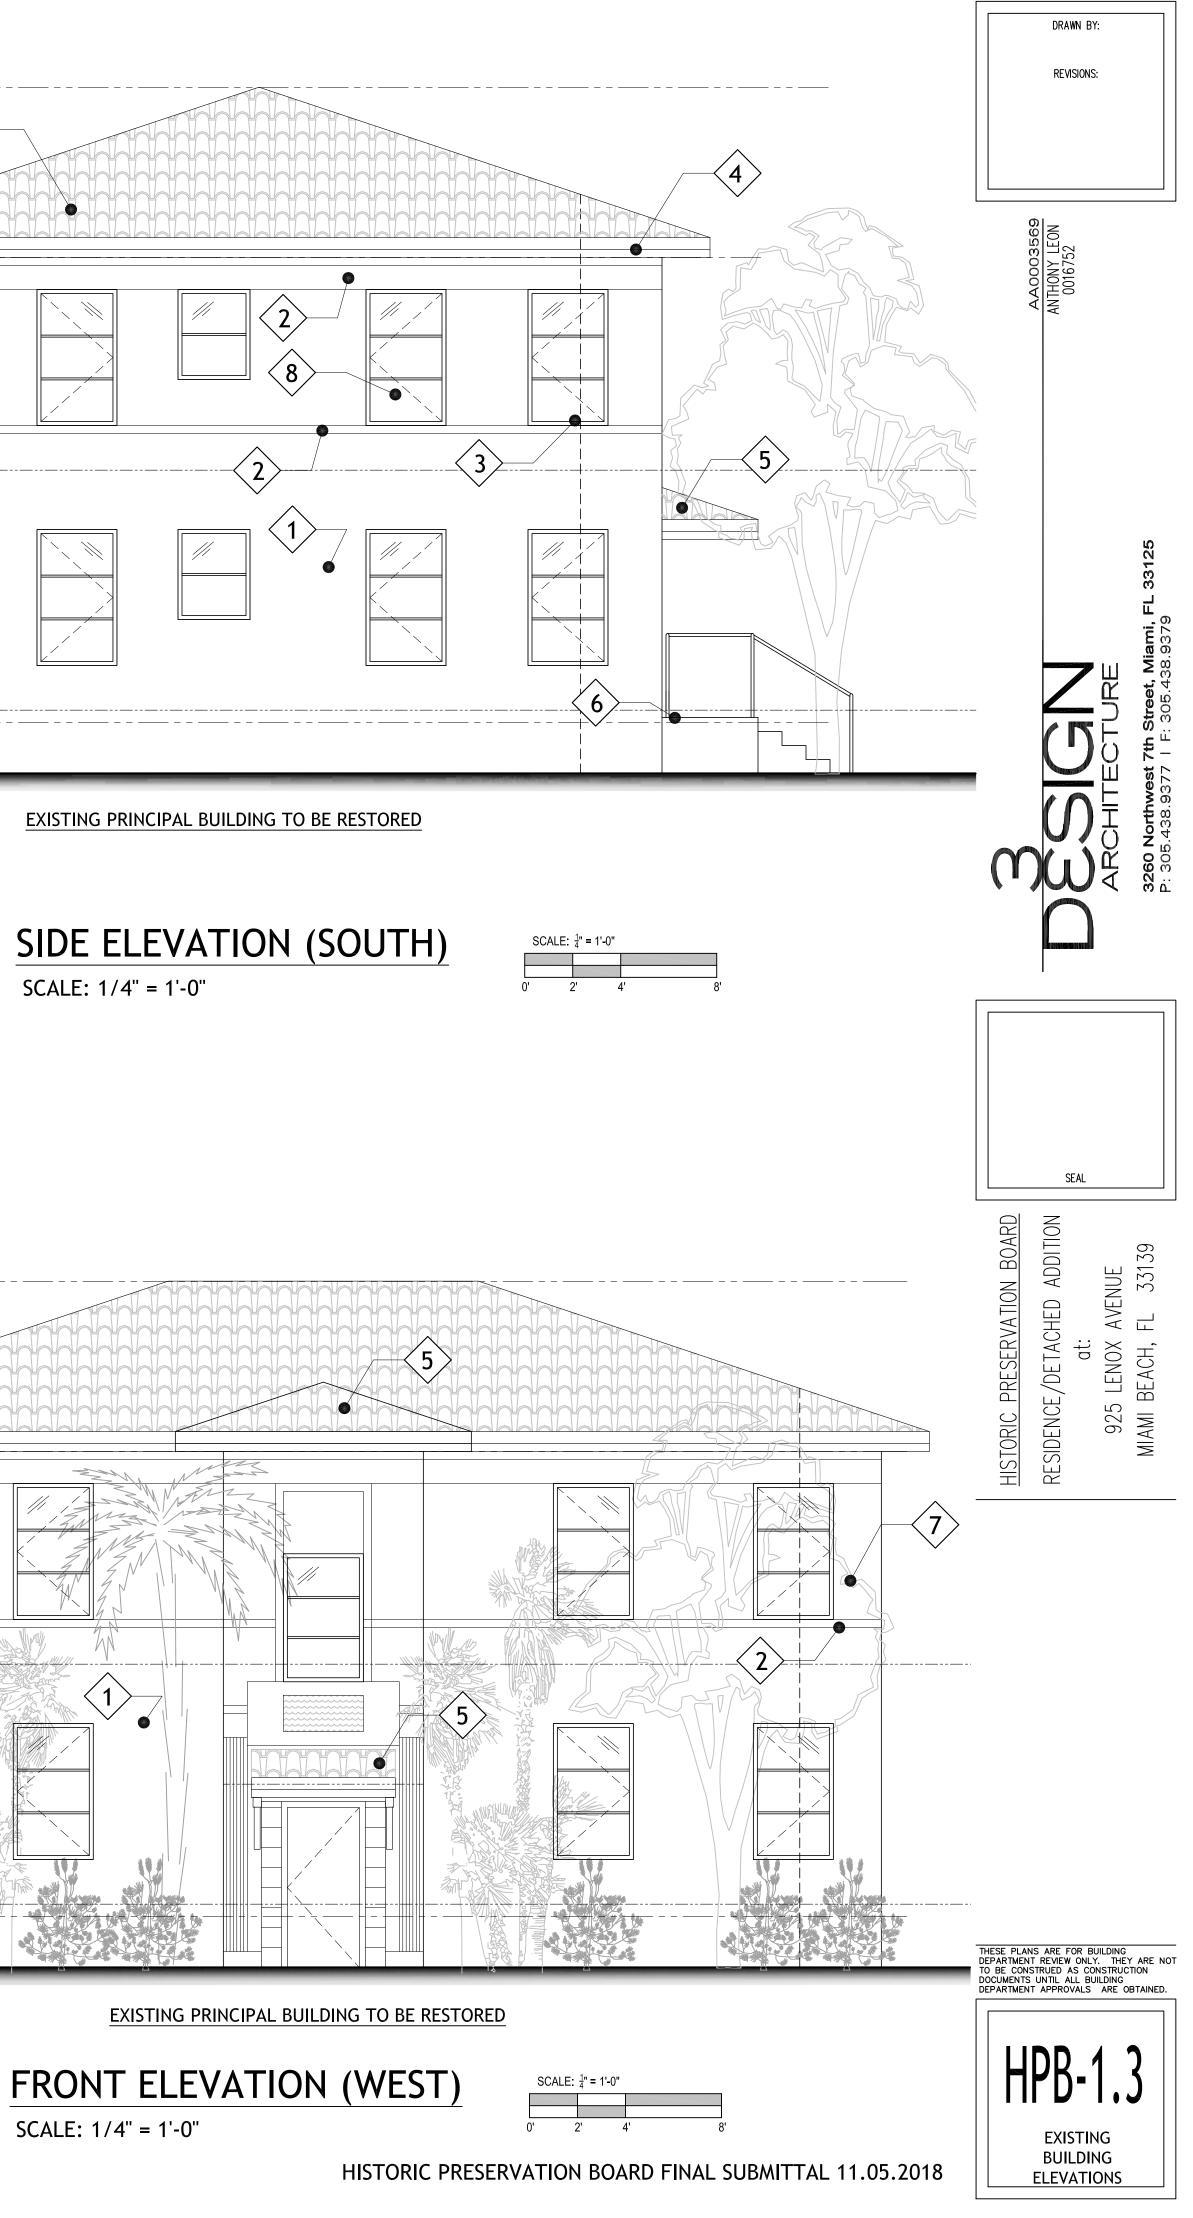


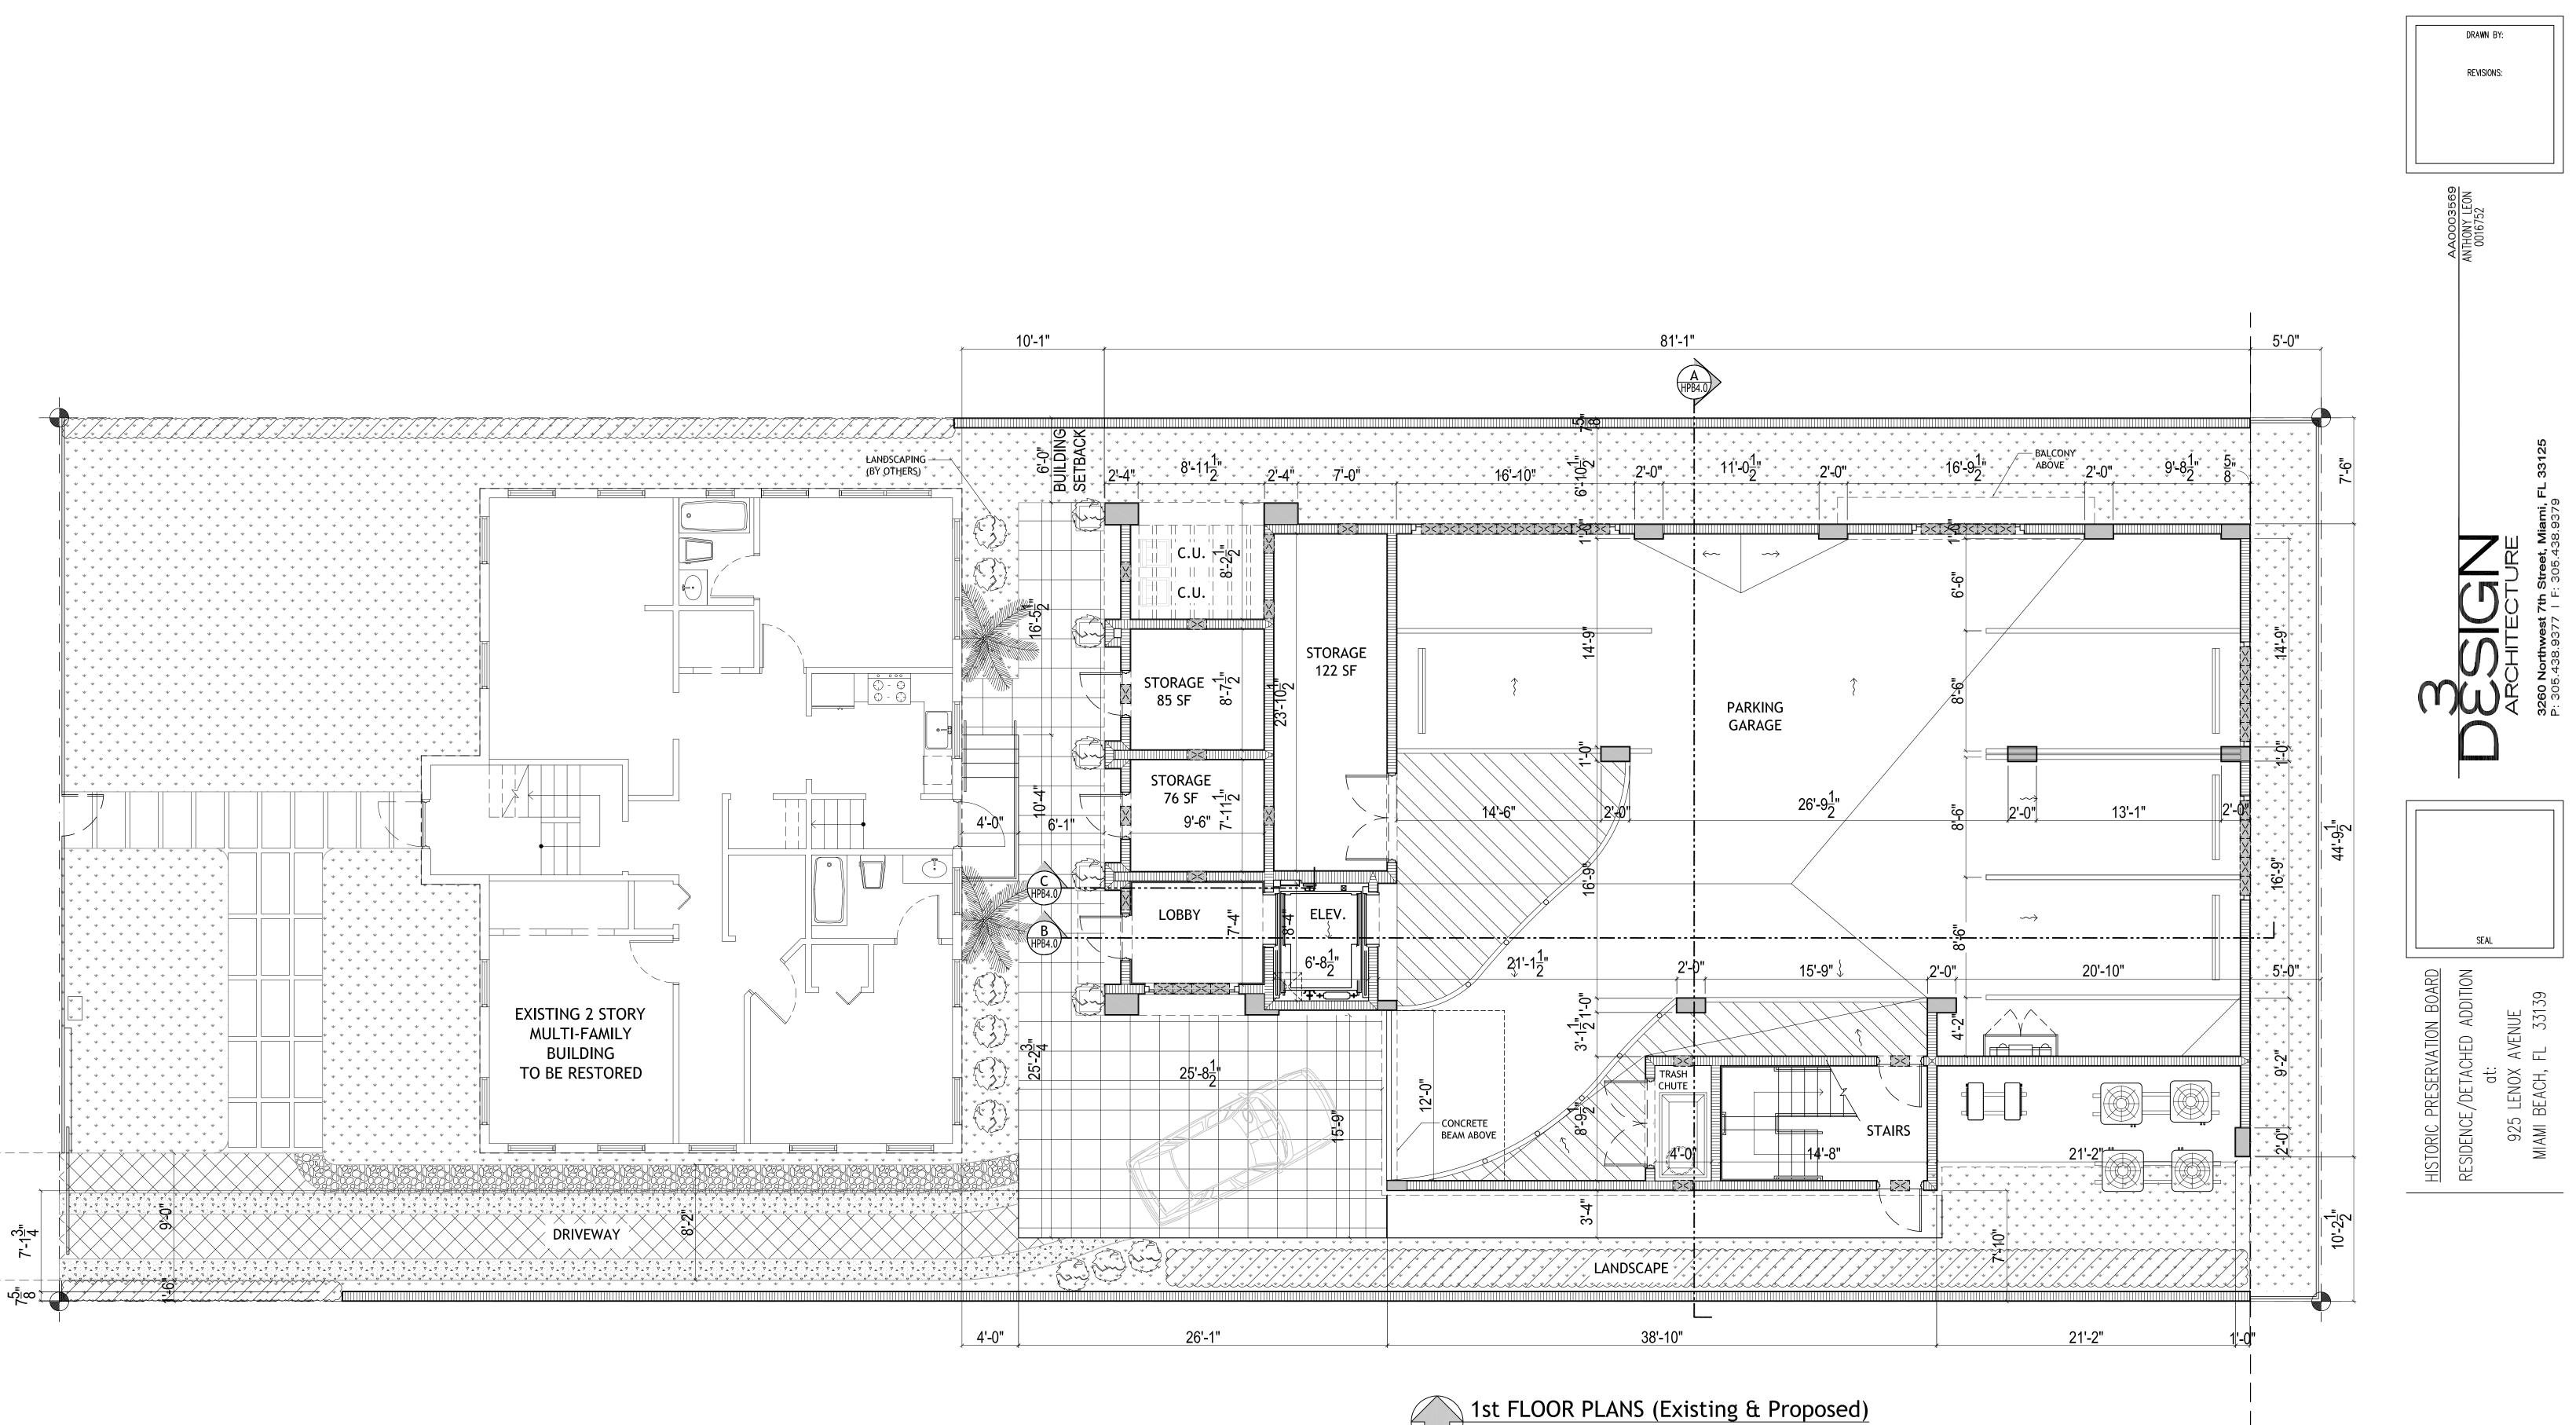


1st FLOOR PLANS (Existing & I SCALE: 3/16" = 1'-0"

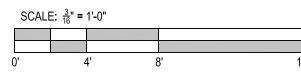


16'

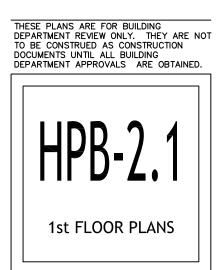

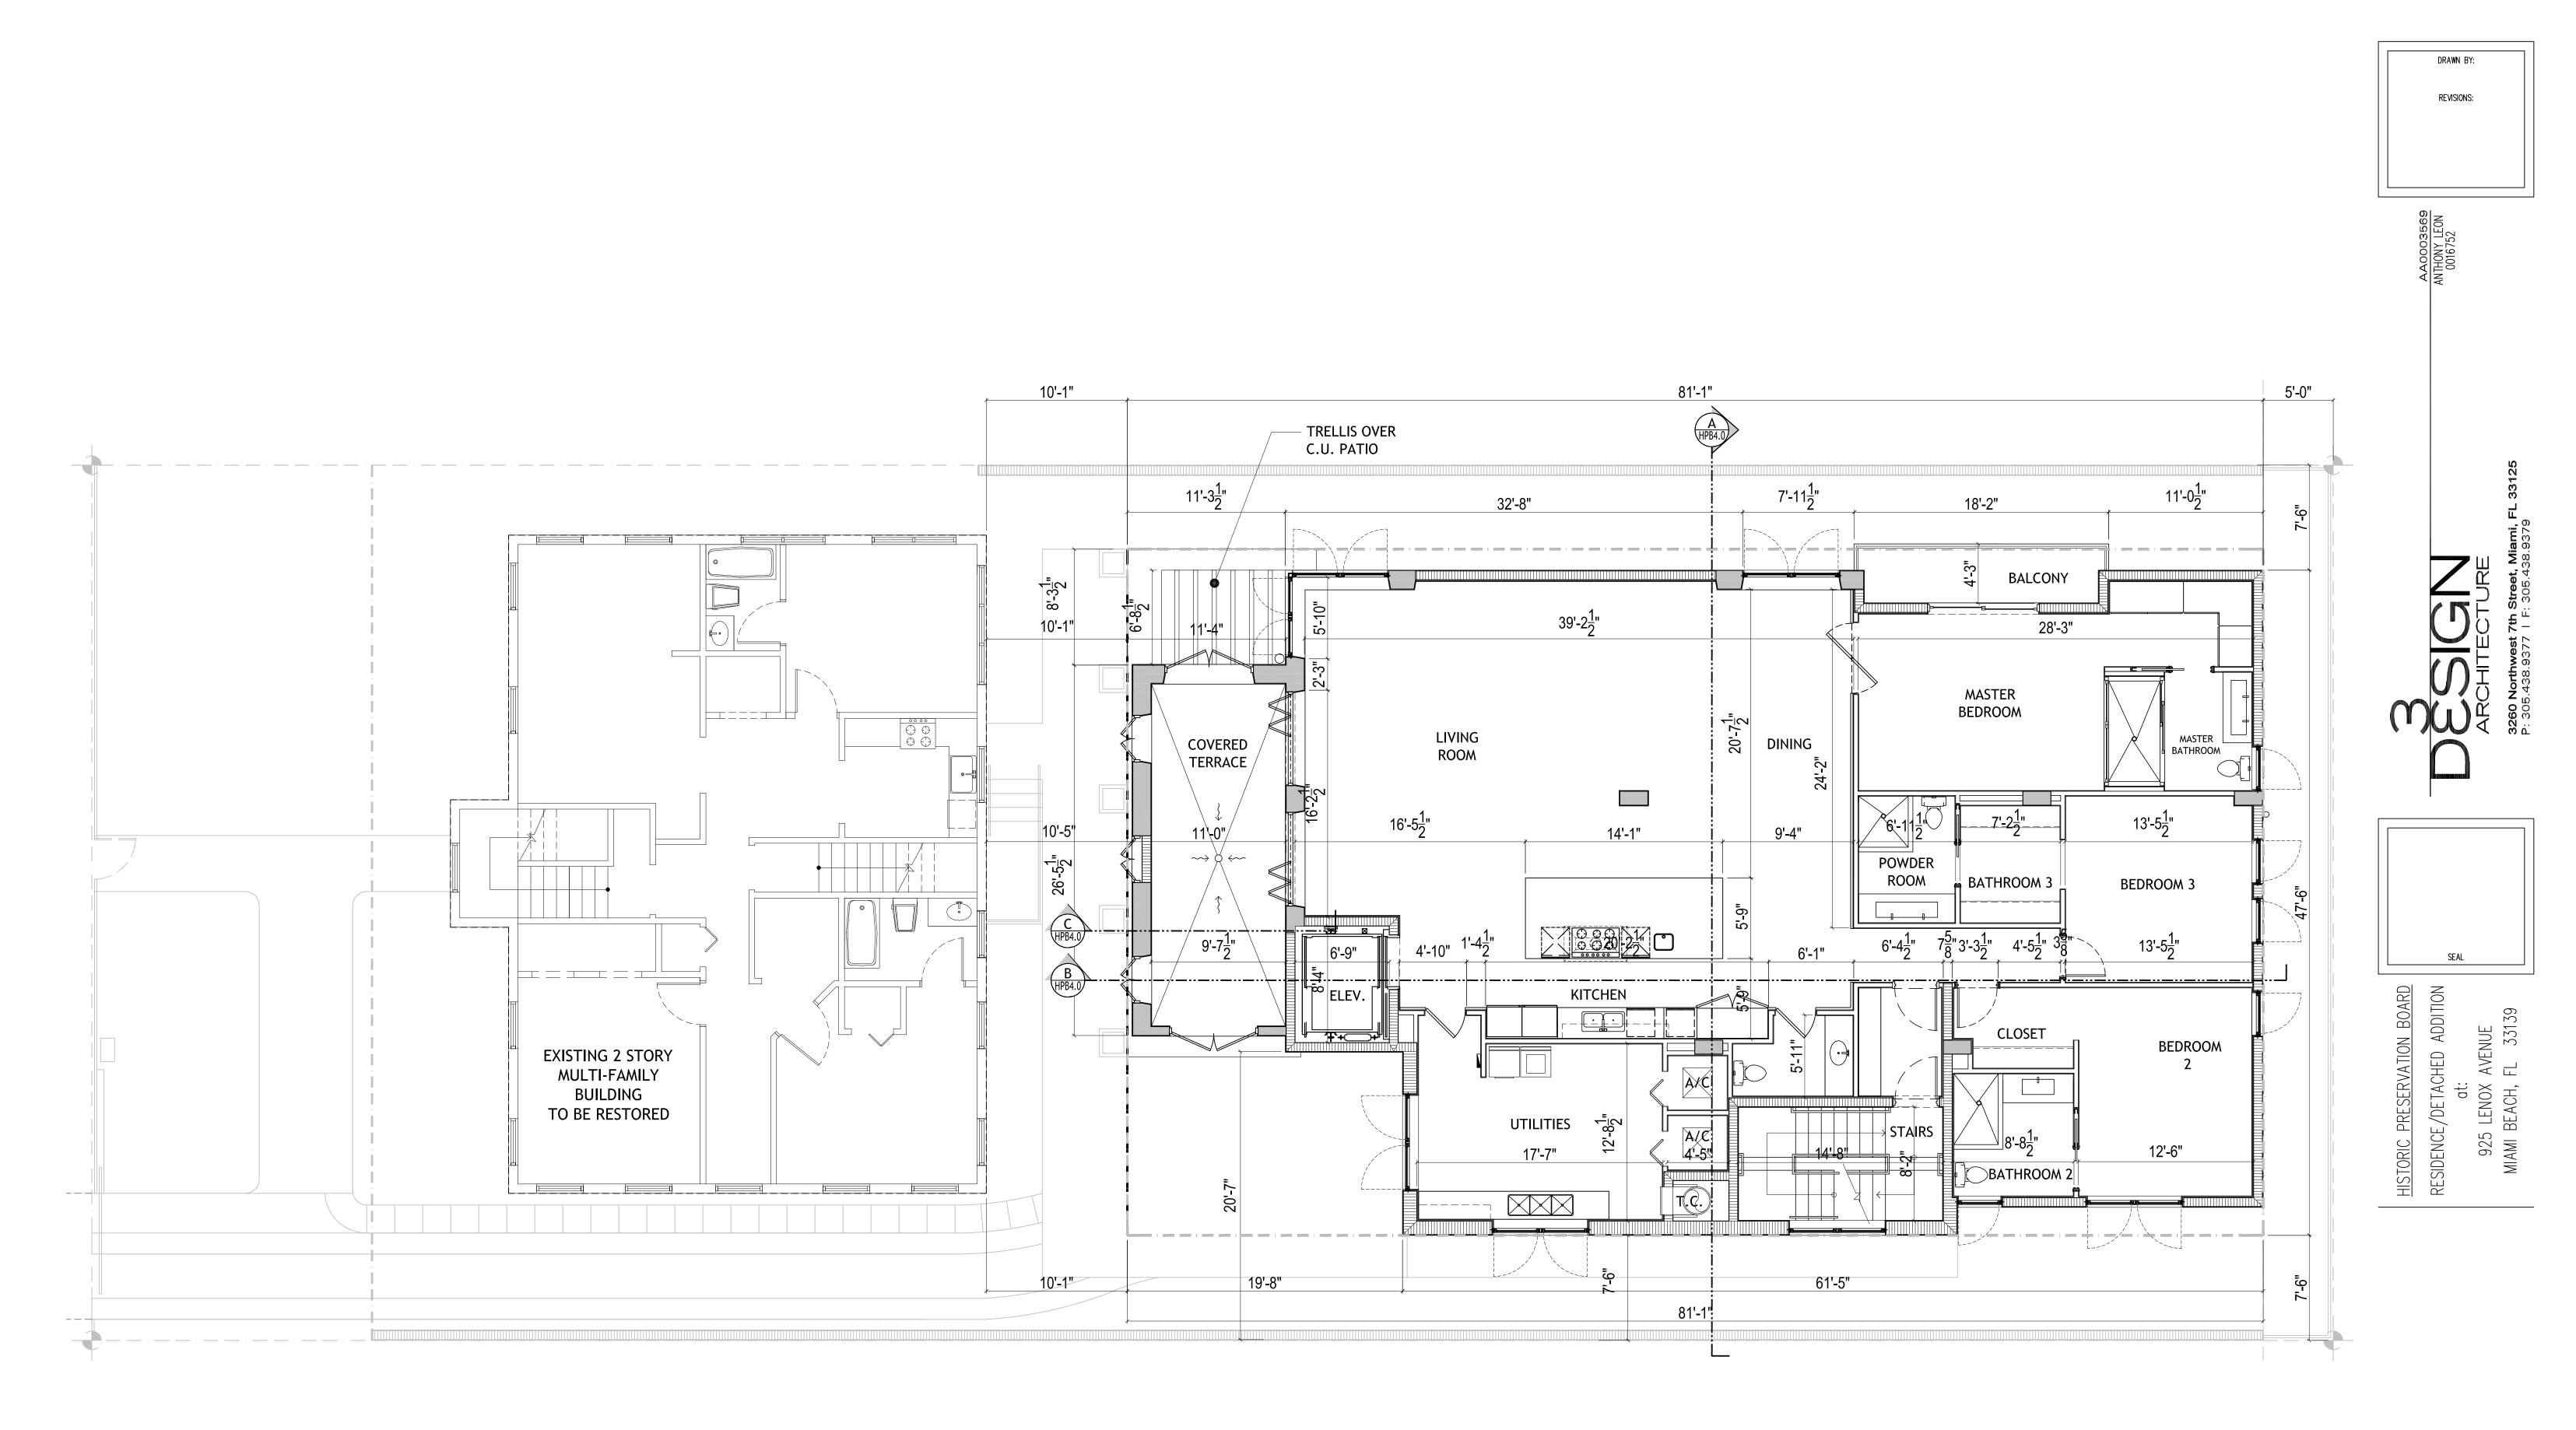







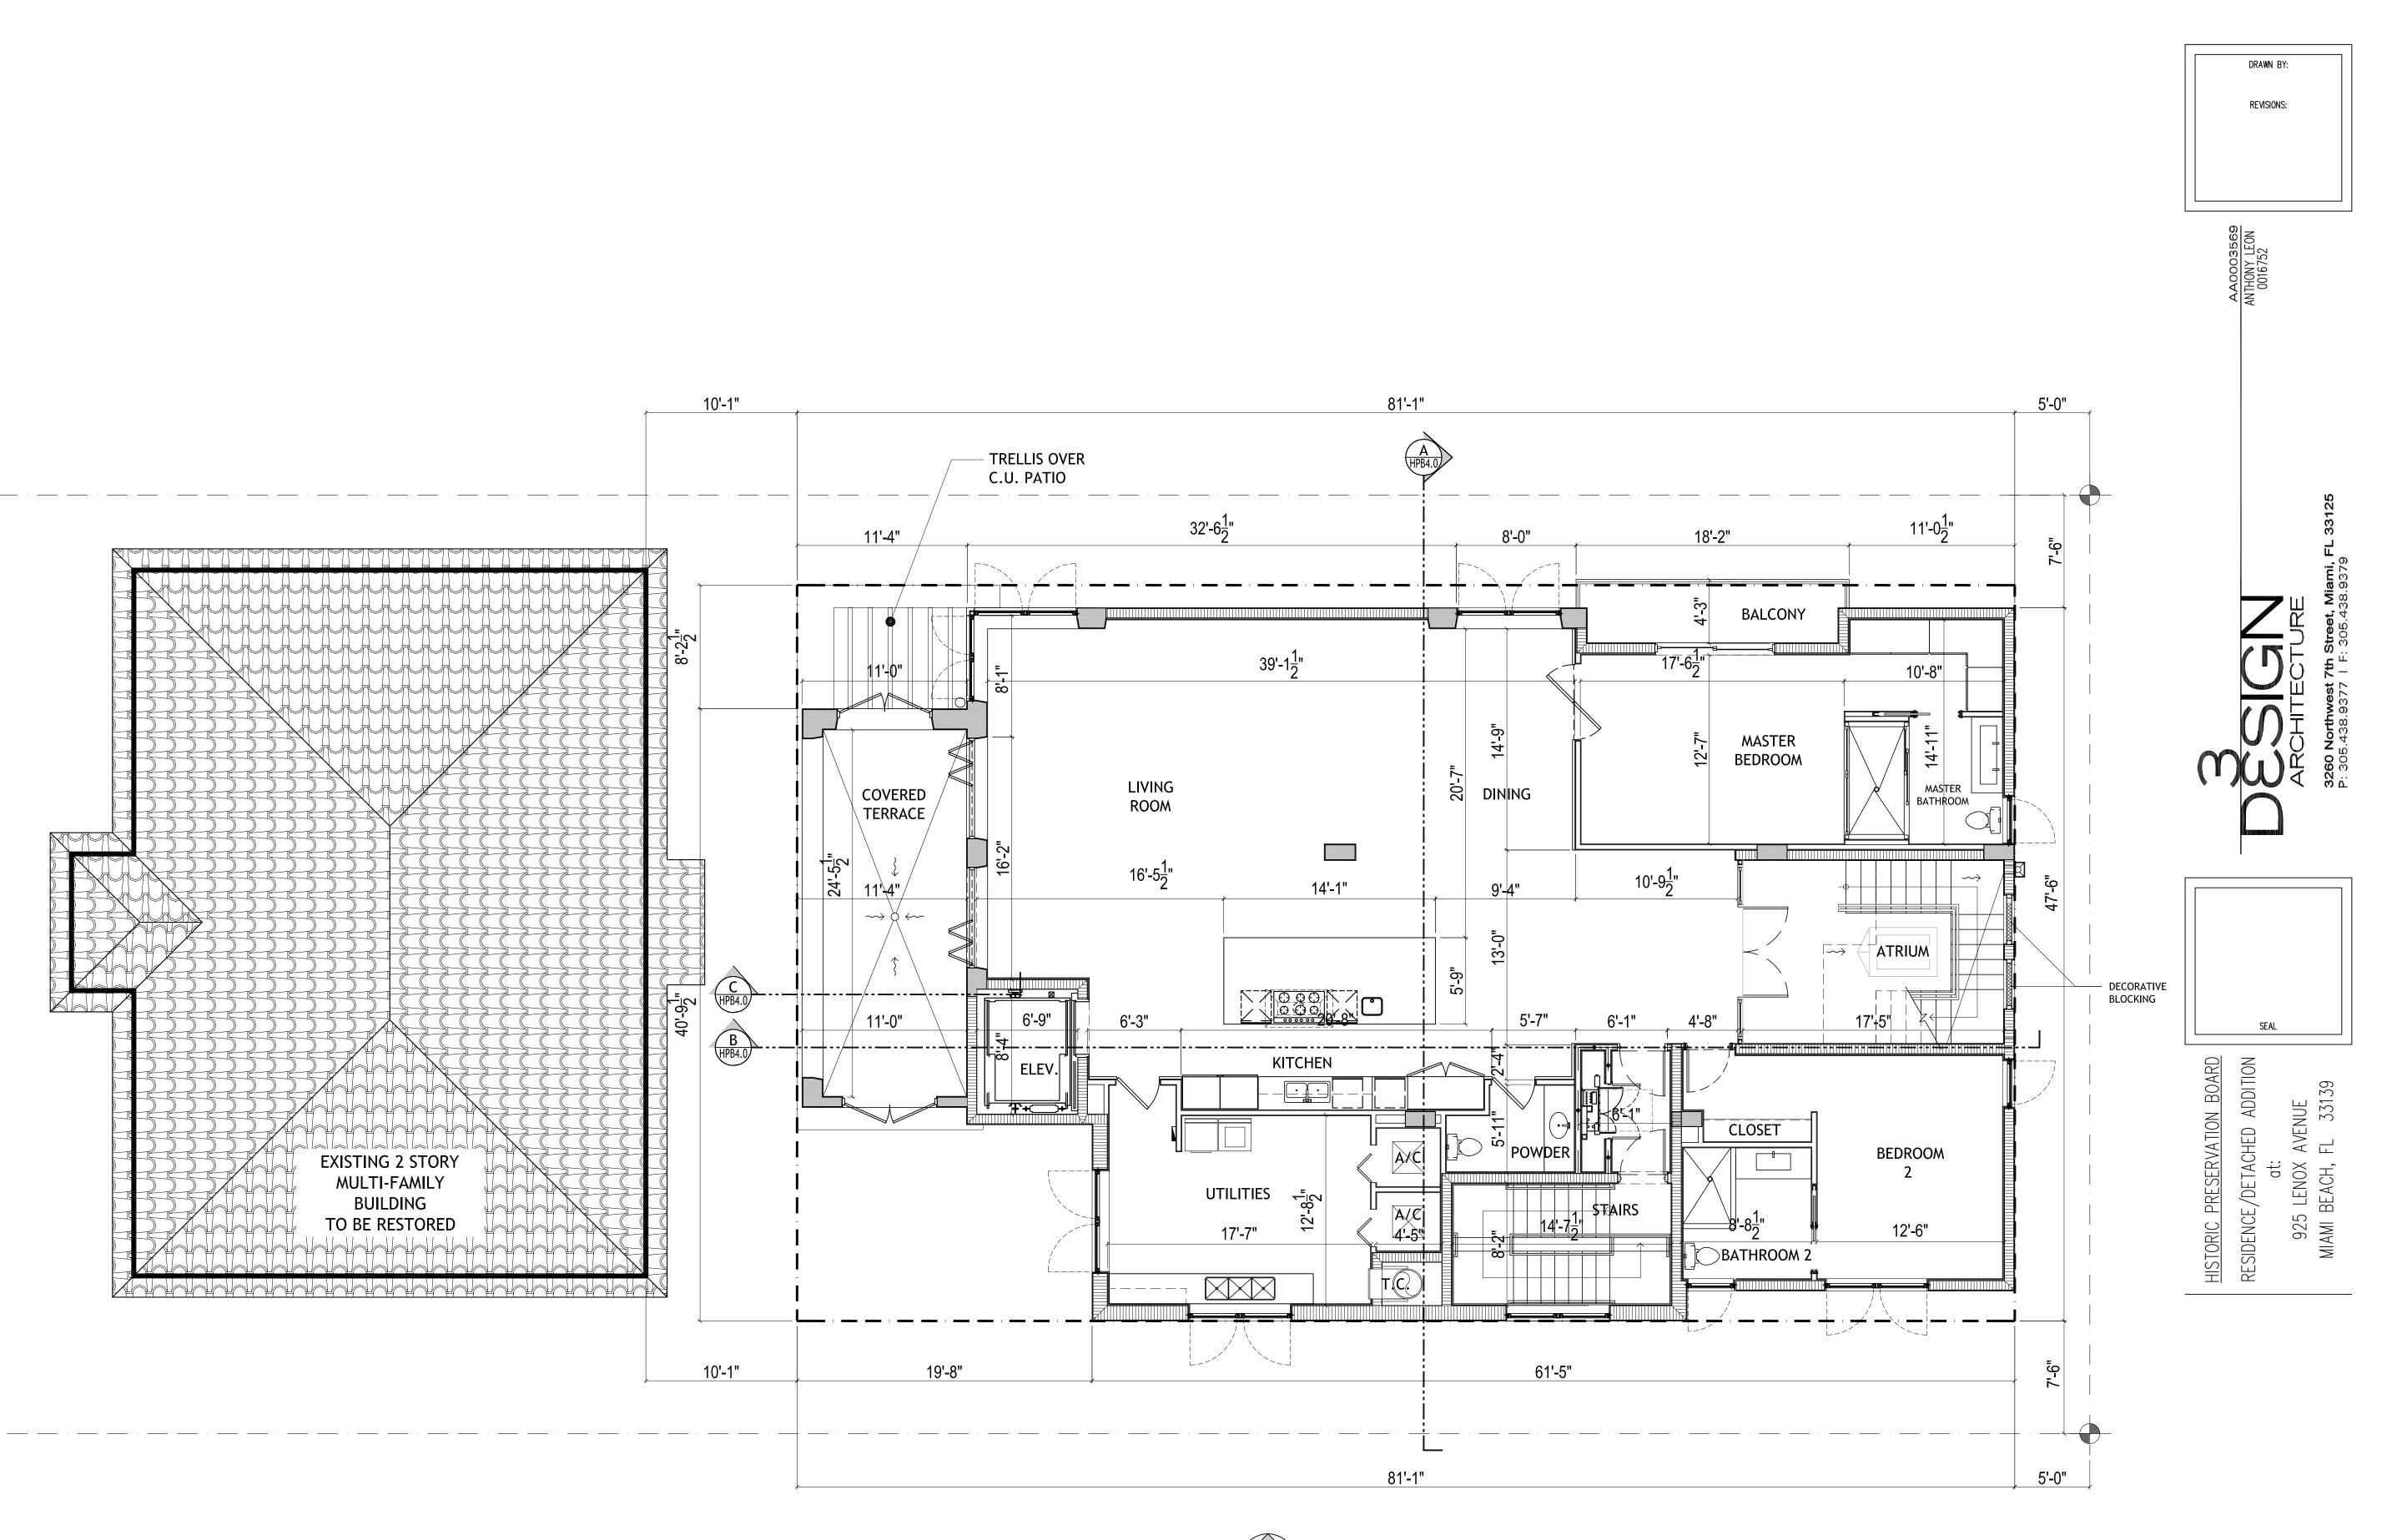



SCALE: $\frac{3}{16}$ " = 1'-0"

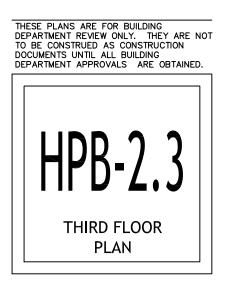

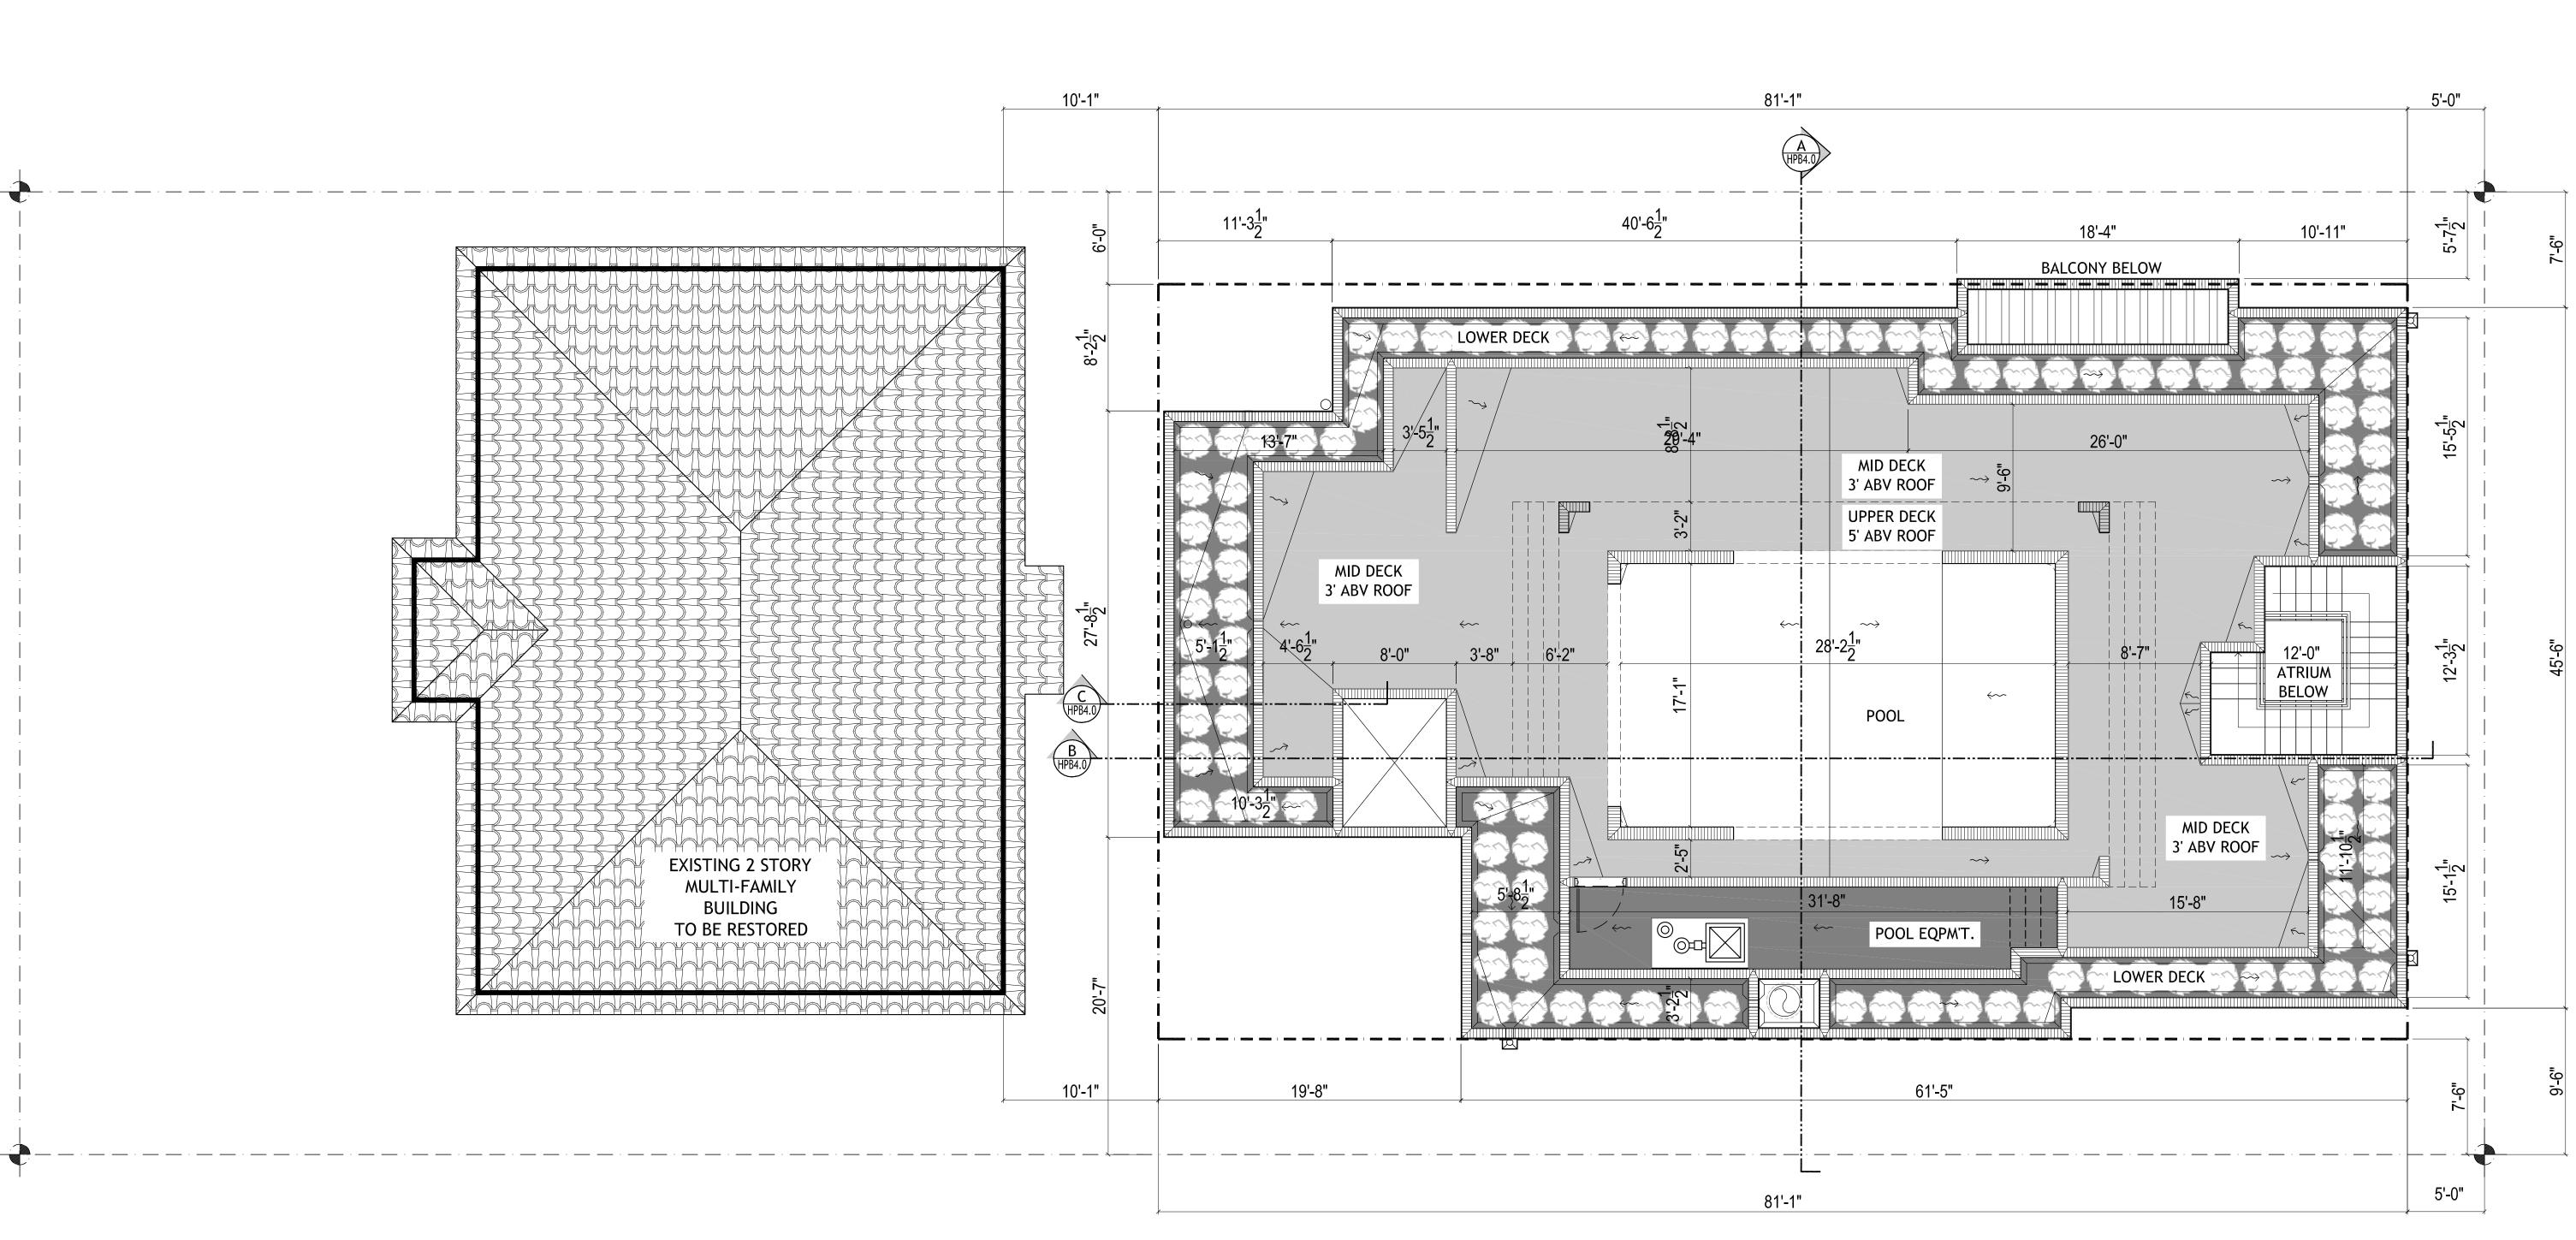

ROOF PLANS (Existing & Proposed) SCALE: 3/16" = 1'-0"

SCALE	≣: <u>3</u> " =	1'-0"		
r'	4	4' 8	3'	16'

ROOF DECK CALCULATION TOTAL ROOF AREA 3' HIGH DECK AREA ALLOWED		3,415 SF 3,415/2 =
3' HIGH DECK AREA PROVIDED	=	454 SF
5' HIGH POOL DECK AREA PROVIDED	=	426 SF
TOTAL DECK 3' ABOVE ROOF SLAB	=	880 SF




DRAWN BY:


REVISIONS:

= 1,708 SF



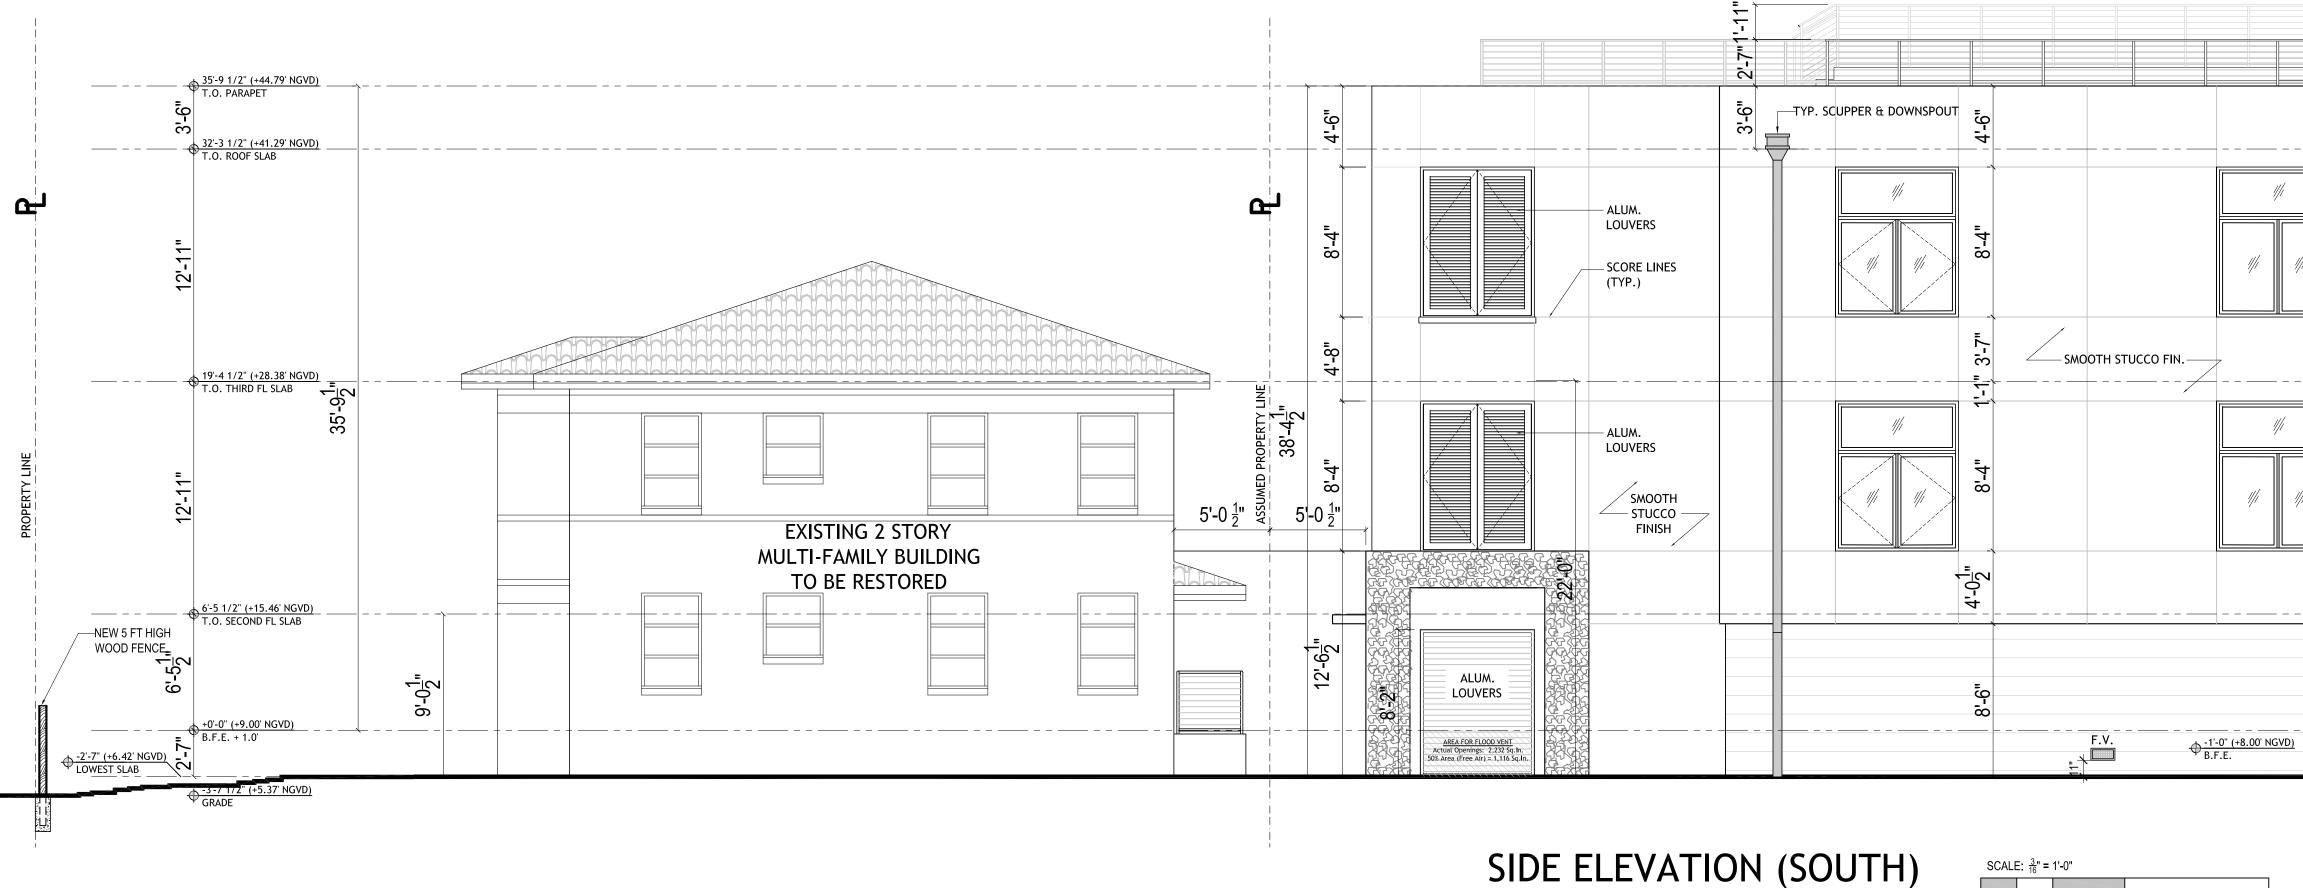





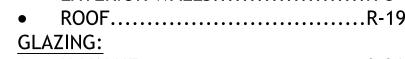


SCALE: $\frac{3}{16}$ " = 1'-0"

SCALE: 3/16" = 1'-0"

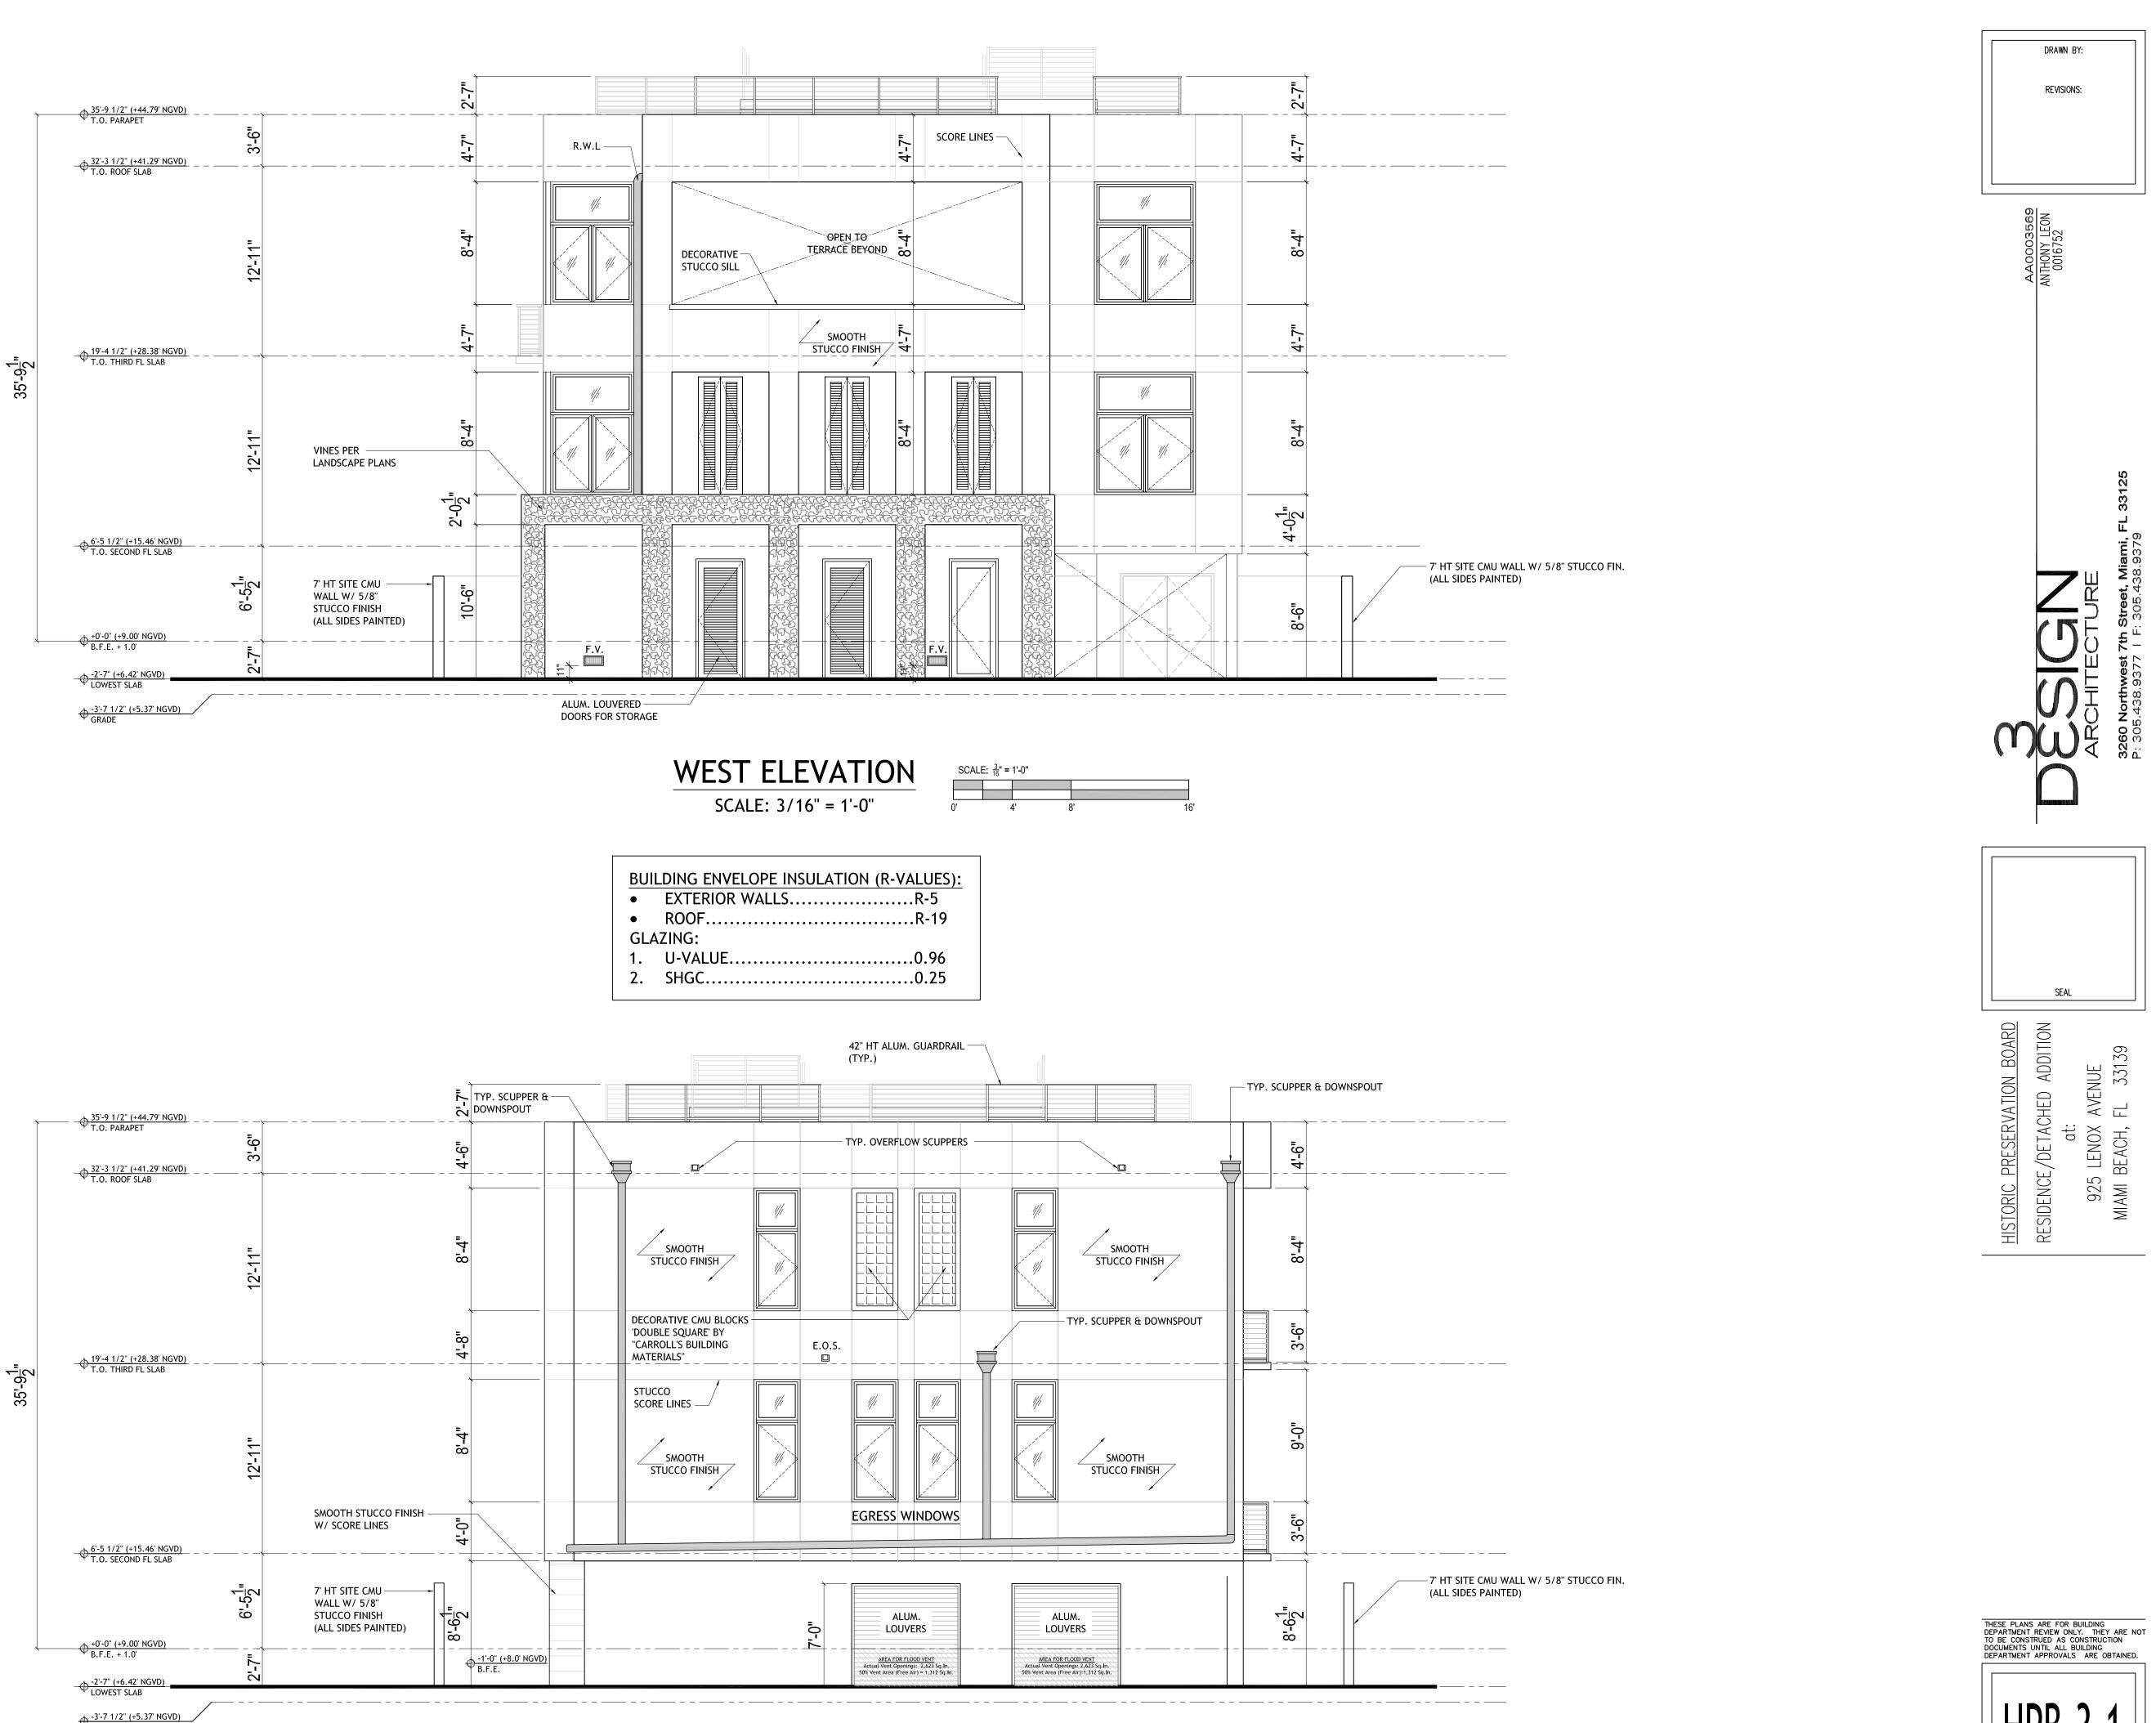


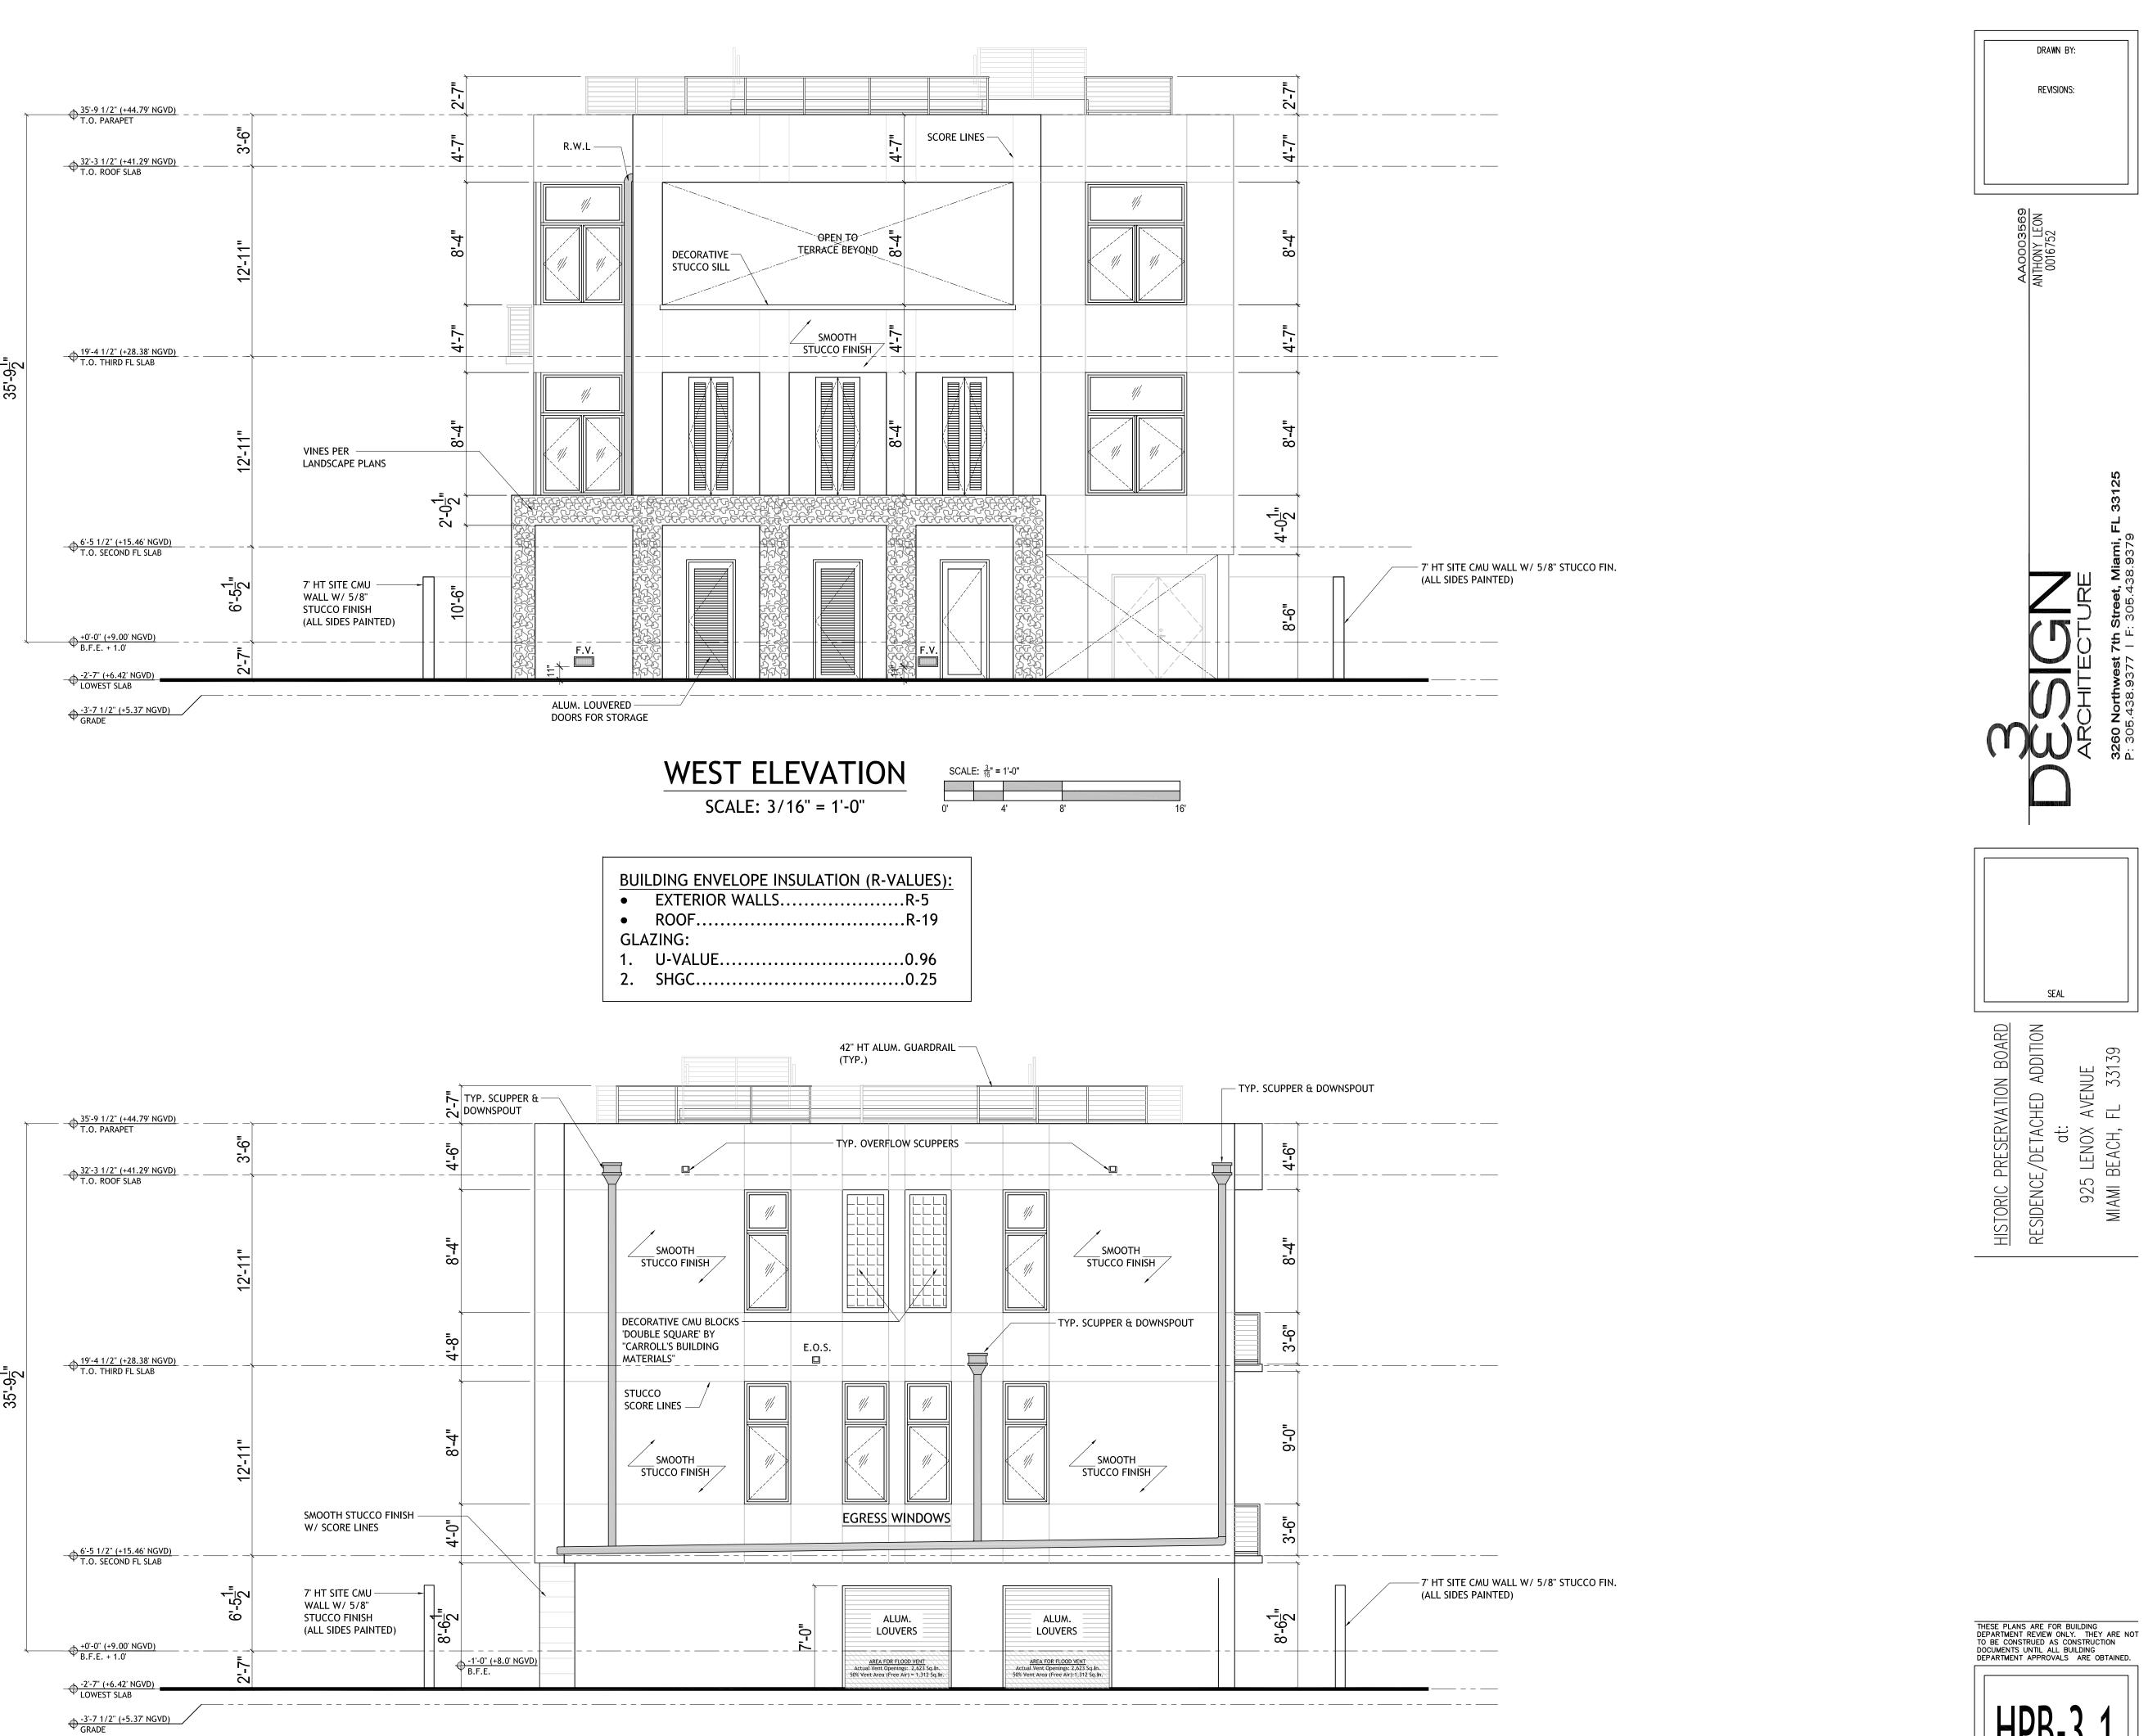



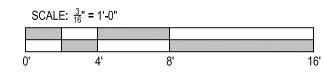





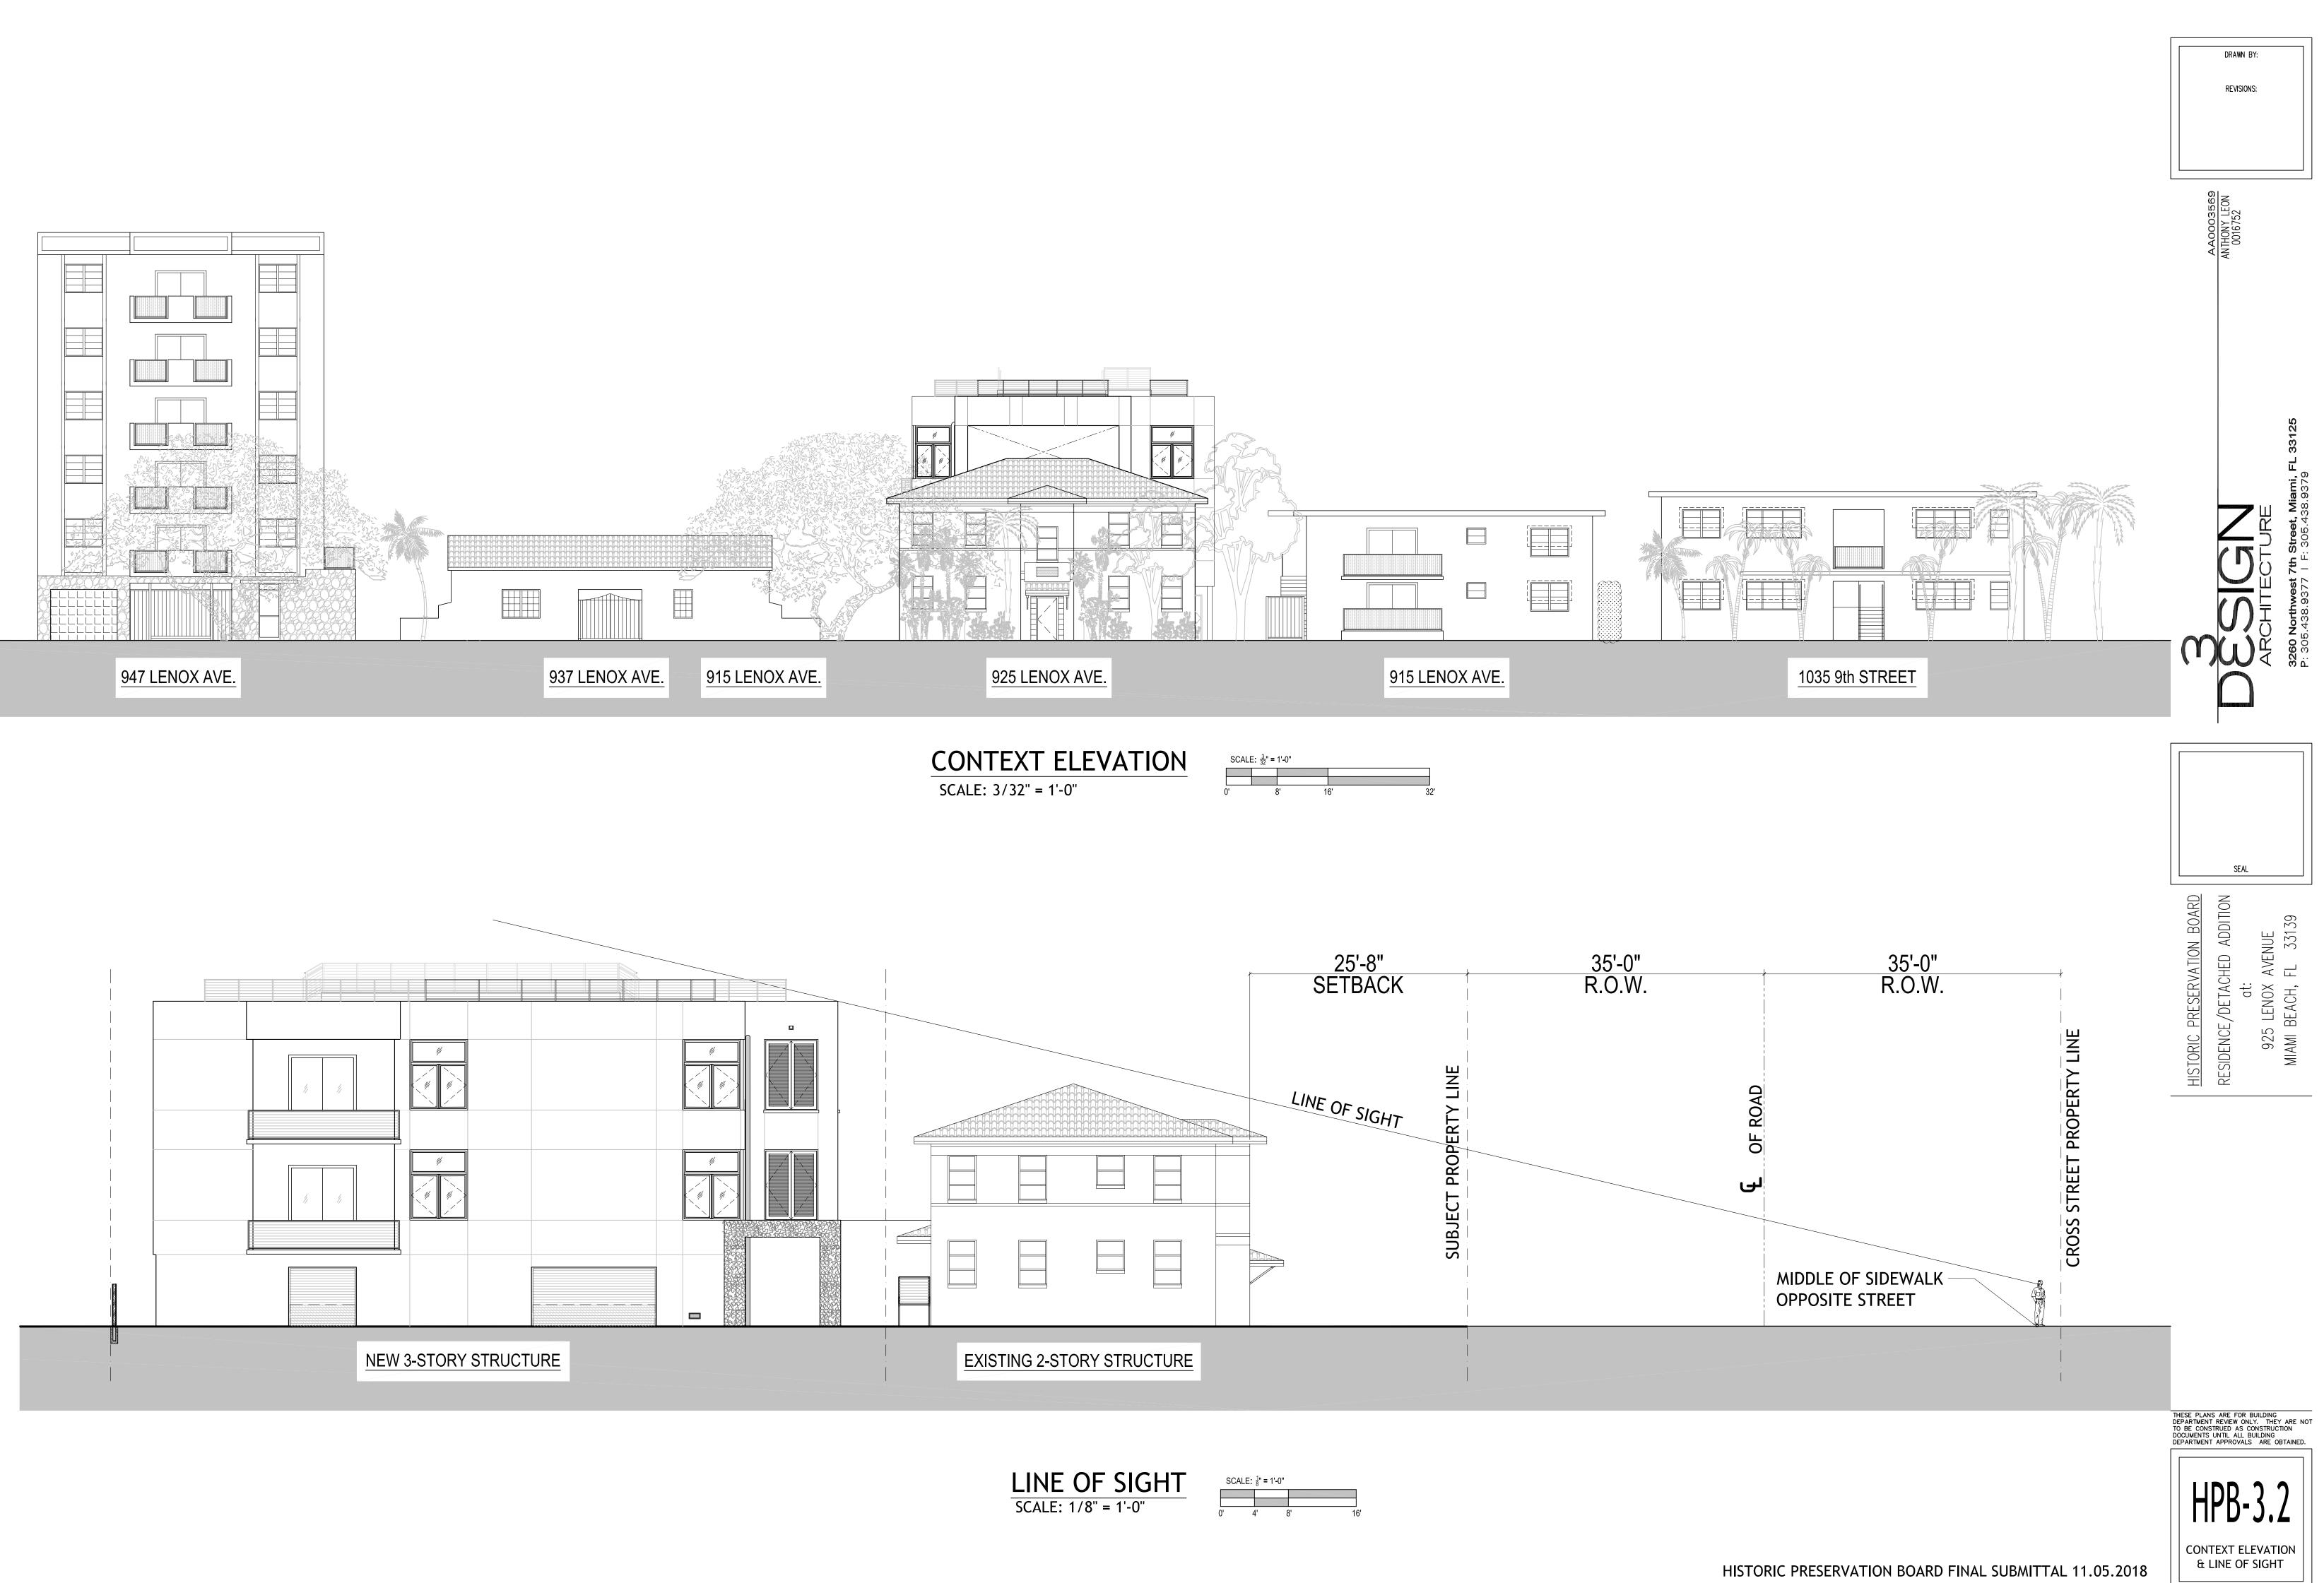





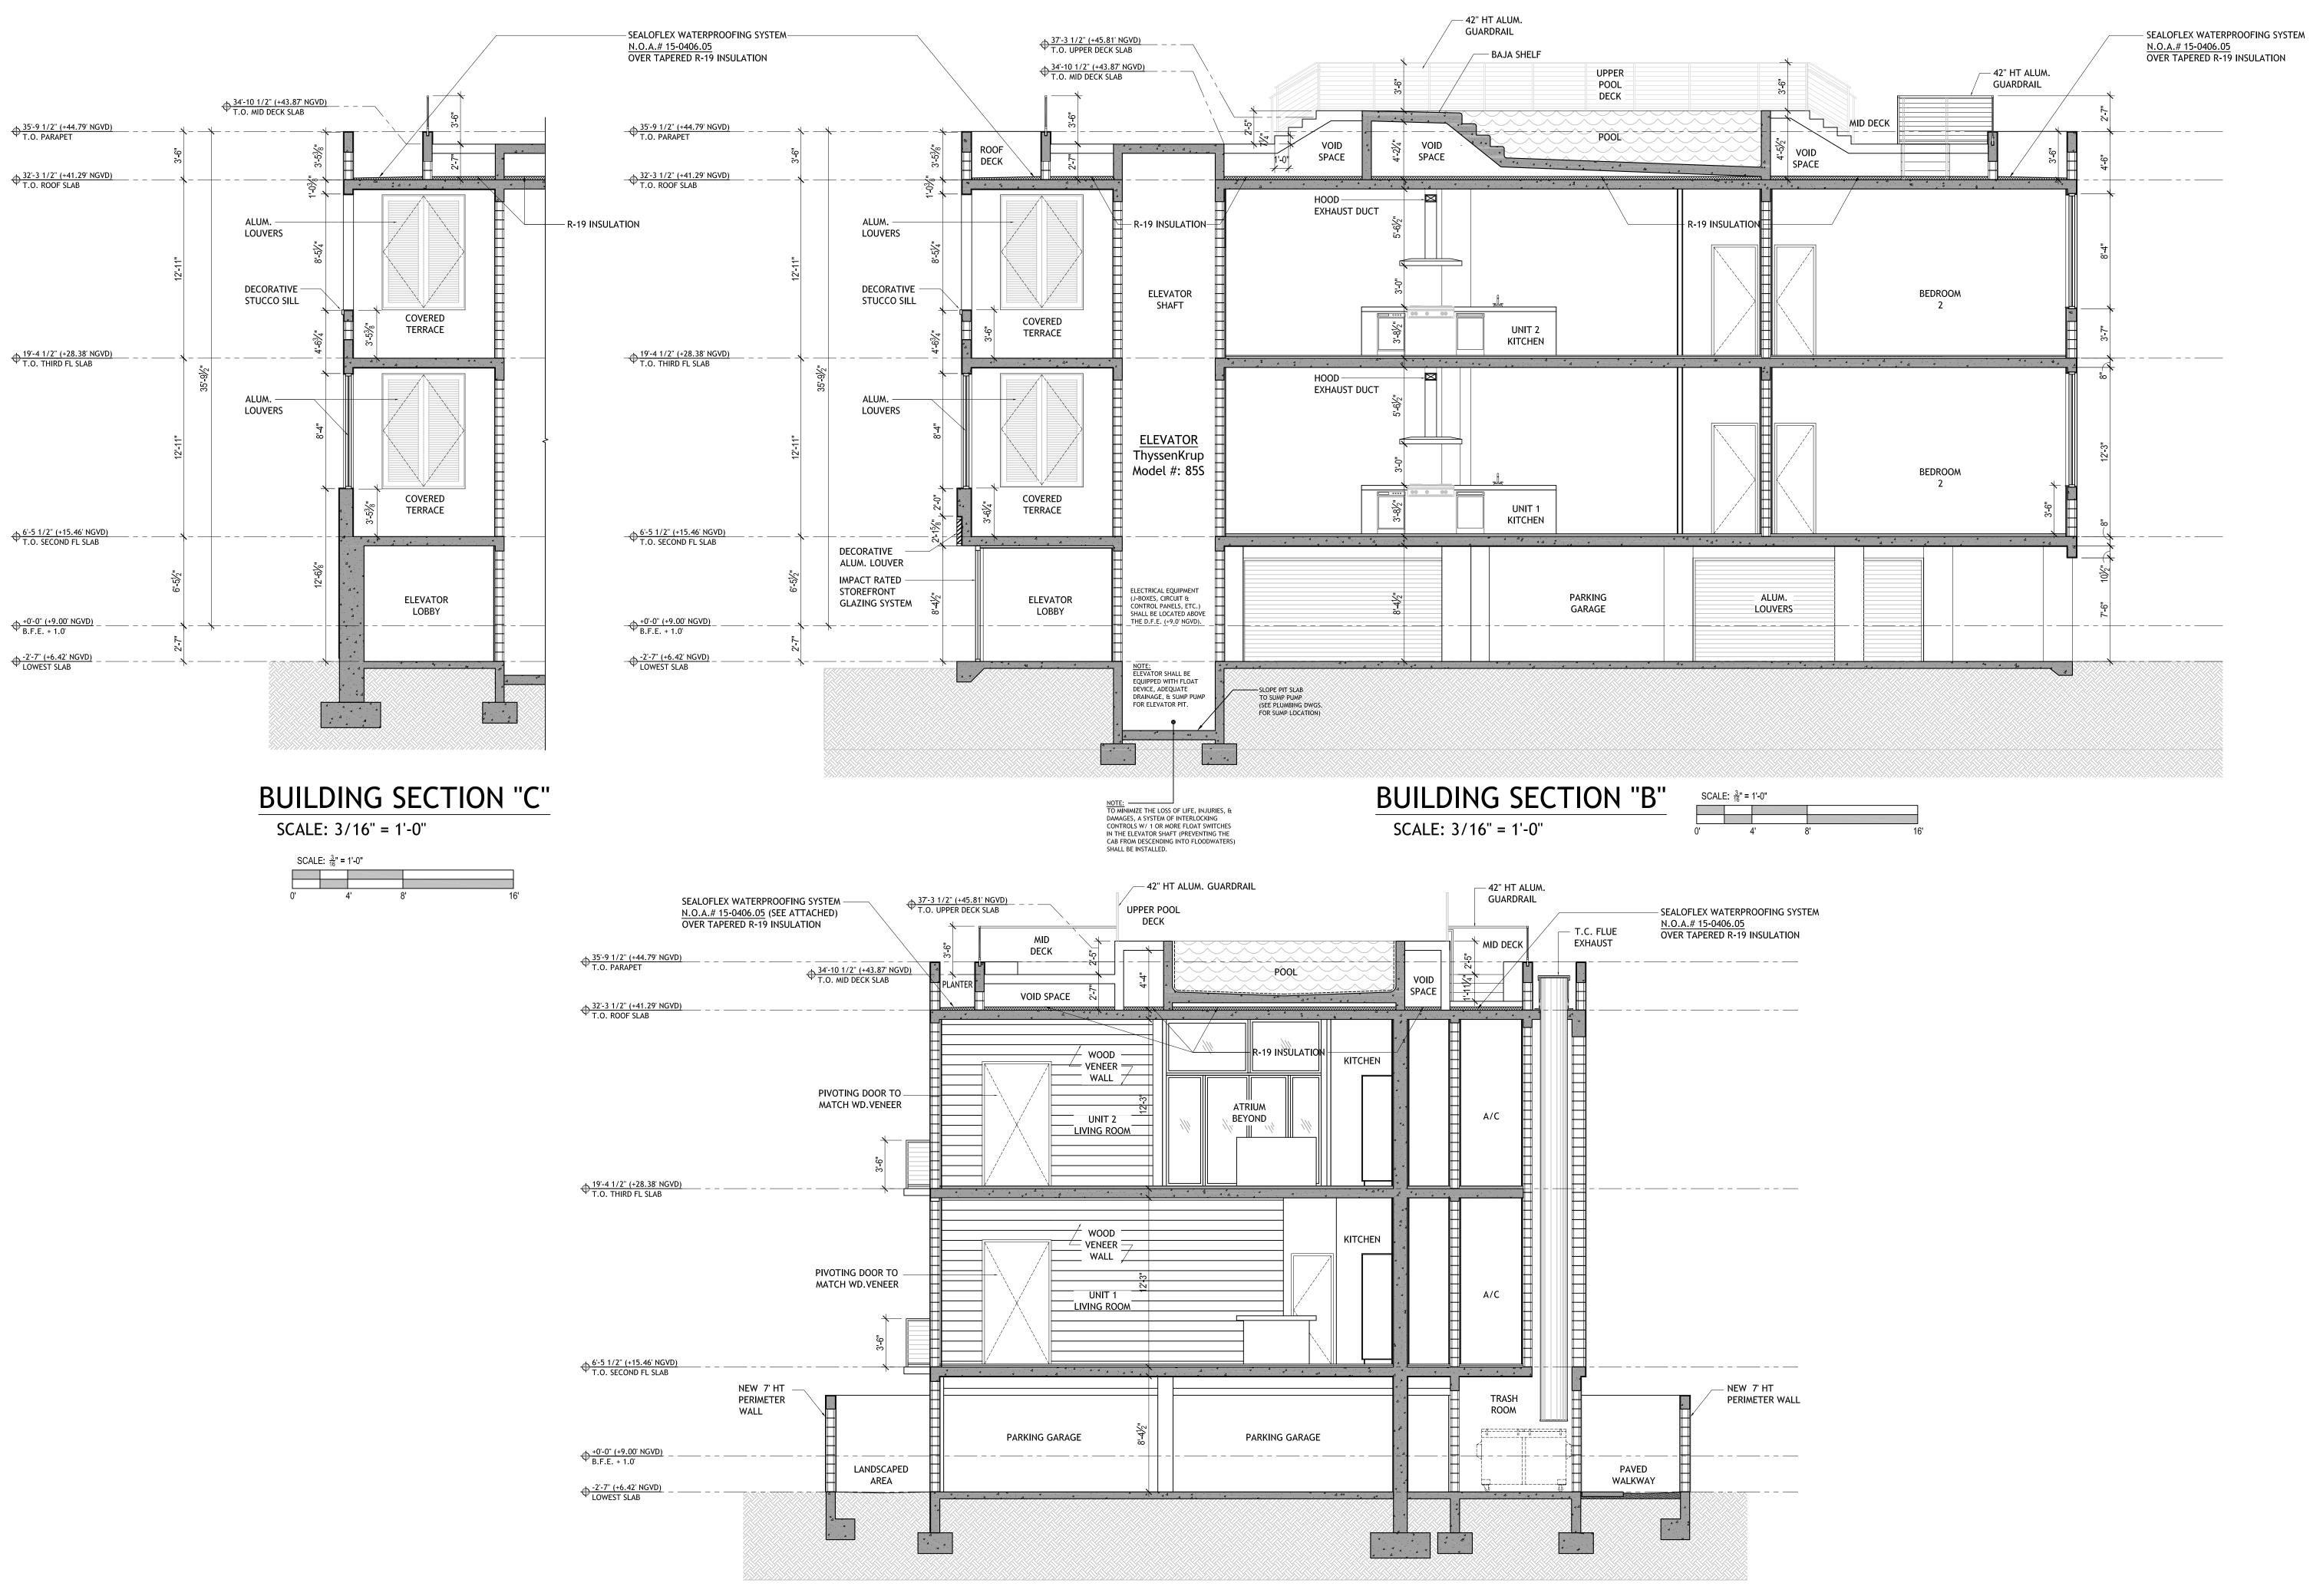


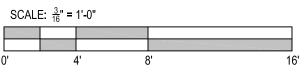

BUILDING SECTION "A" SCALE: 3/16" = 1'-0"

SCALE: <u>3</u>" = 1'-0" 4'



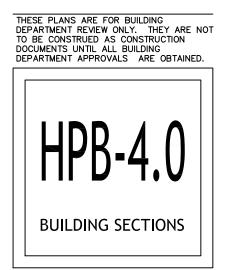

REVISIONS:

DRAWN BY:

947 LENOX

937 LENOX


942 LENOX

932 LENOX

926 LENOX

910 CONDO



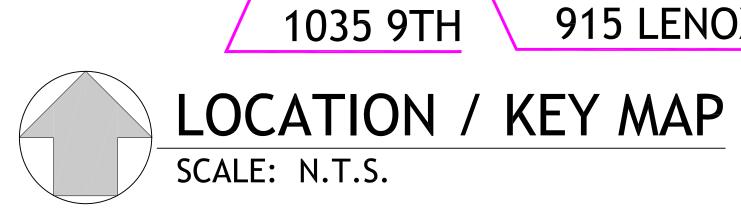




SCALE: N.T.S.

1002 10TH

940 MICH.
934 MICH.
925 LENOX
926 MICH.
910 MICH.
1005 9TH

915 LENOX



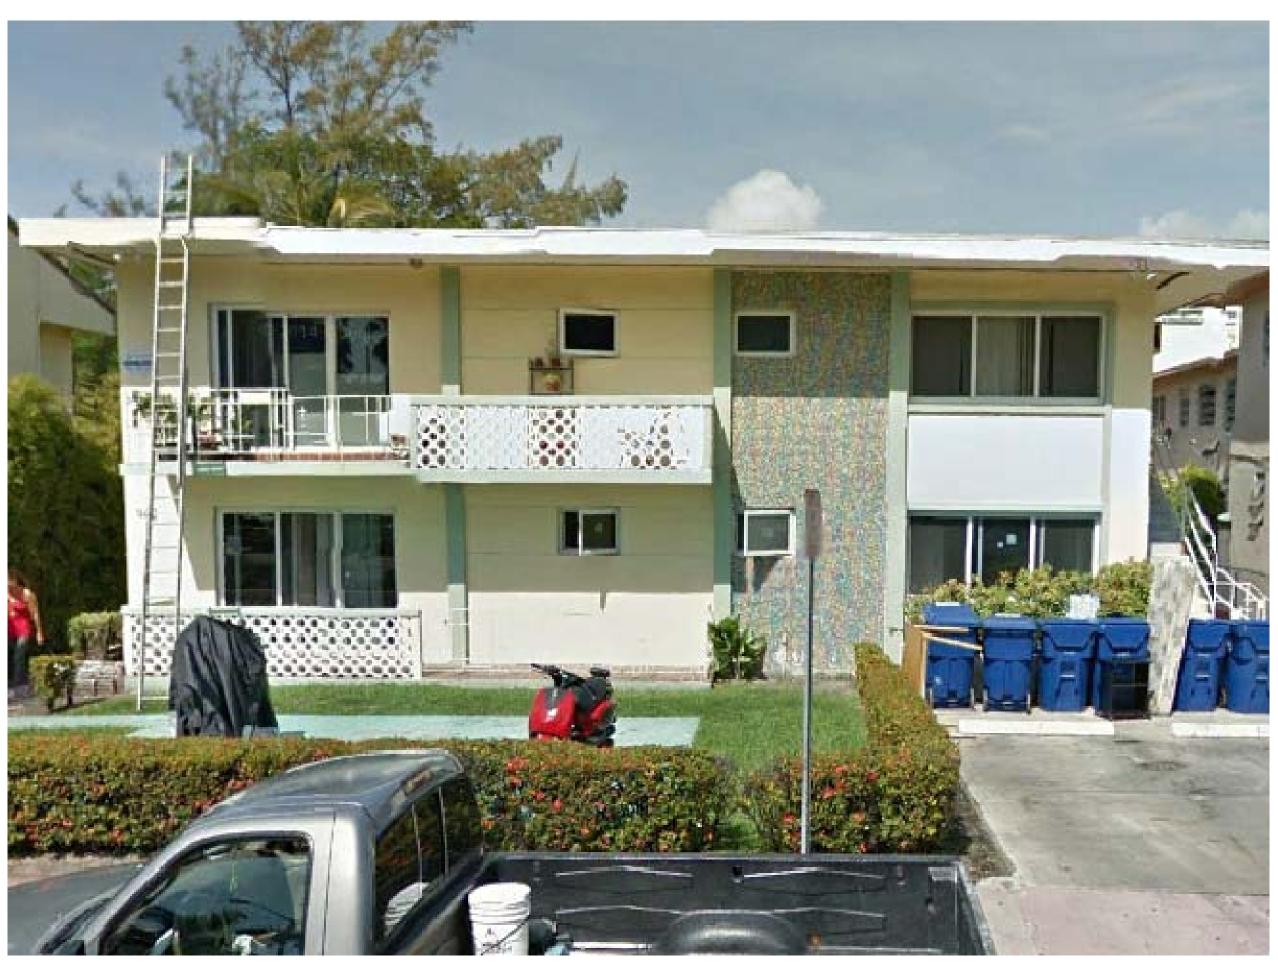



942 LENOX SCALE: N.T.S.

925 LENOX SCALE: N.T.S.



		WN BY			
	AA0003569 ANTHONY LEON	2010100		25	
Ŋ		ろうのいう	ARCHITECTURE	3260 Northwest 7th Street, Miami, FL 331 סיפסה אפא מפדד דריפסה אפא מפדס	
	5	EAL			
 HISTORIC PRESERVATION BOARD	RESIDENCE/DETACHED ADDITION	at:	925 LENOX AVENUE	MIAMI BEACH, FL 33139	

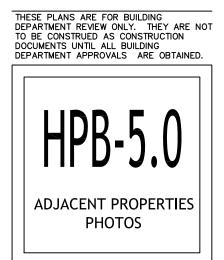

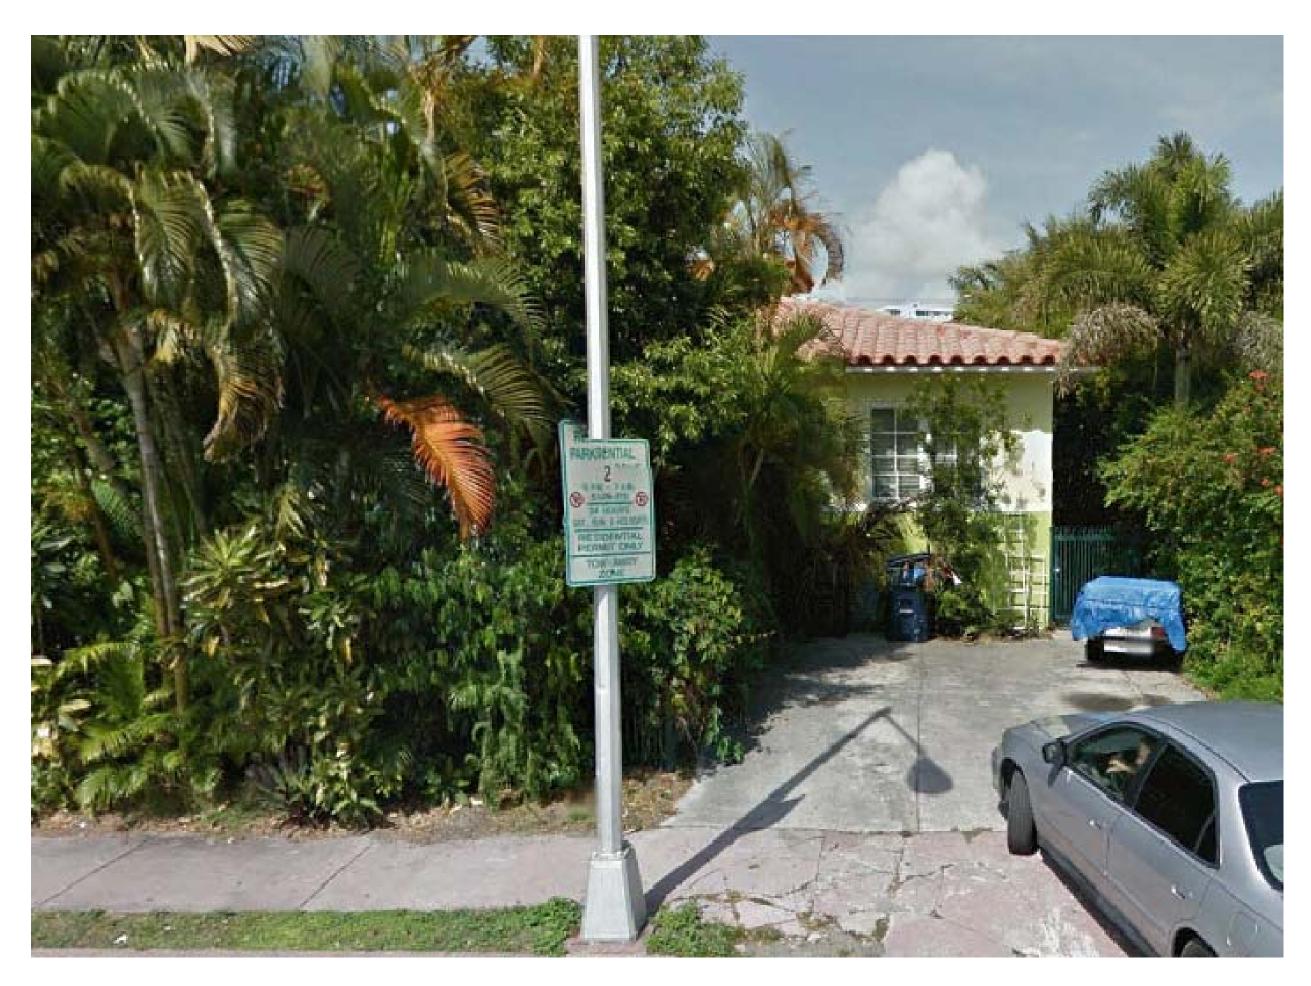

910 CONDO SCALE: N.T.S.



915 LENOX SCALE: N.T.S.




926 LENOX SCALE: N.T.S.



1035 9 ST SCALE: N.T.S.





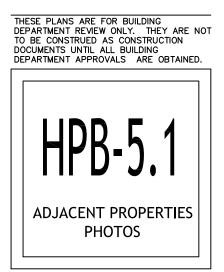



947 LENOX SCALE: N.T.S.



1005 9TH STREET SCALE: N.T.S.




937 LENOX SCALE: N.T.S.




SCALE: N.T.S.

910 MICHIGAN



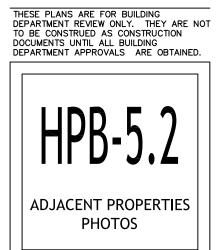

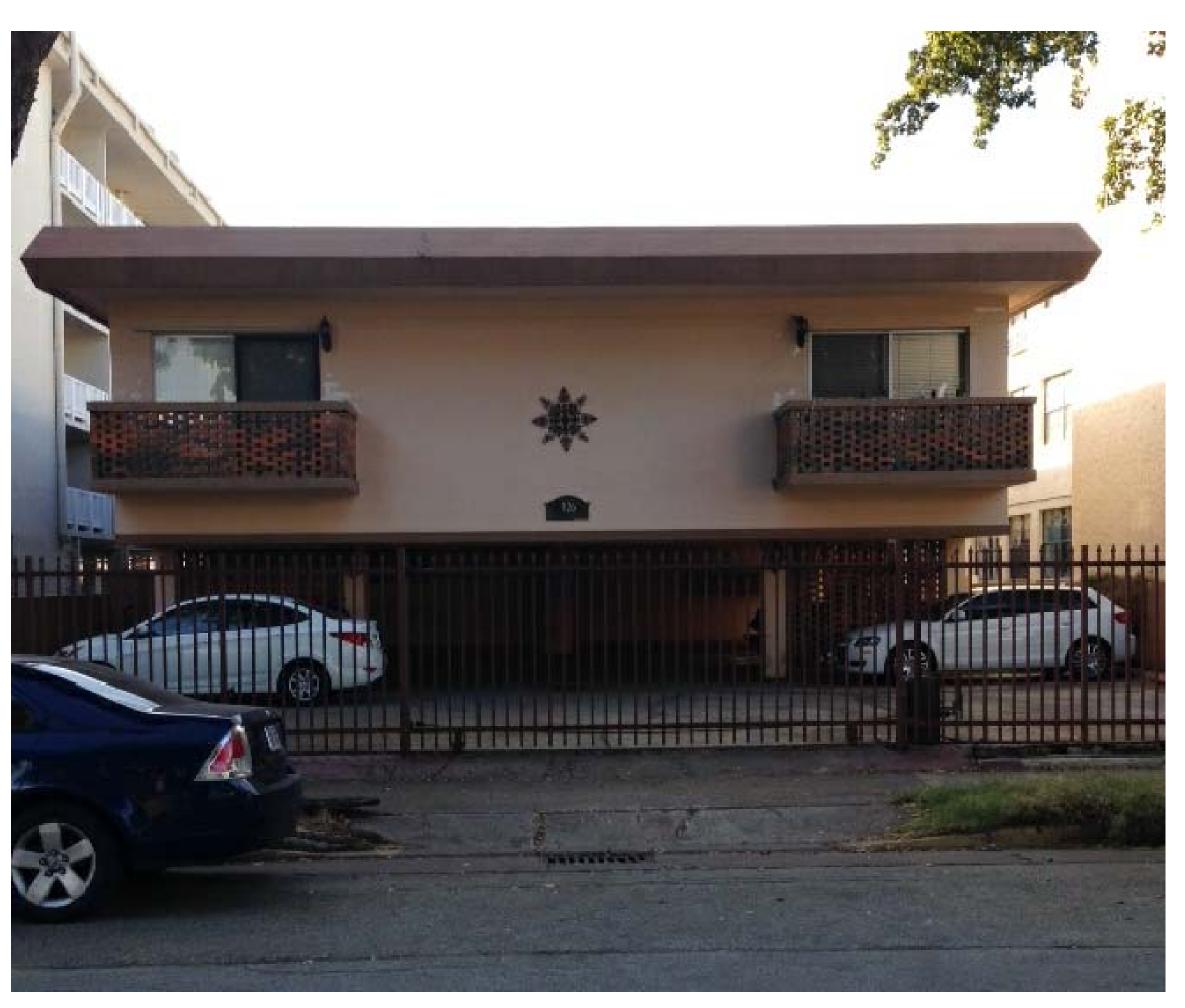

926 MICHIGAN SCALE: N.T.S.

No. of the Local Division of the Local Divis



940 MICHIGAN

SCALE: N.T.S.






934 MICHIGAN SCALE: N.T.S.




1002 10TH STREET SCALE: N.T.S.

DRAWN BY: REVISIONS: ۳Ŋ MW **3260** P: 305 SEAL PRESERVATION BOARD CHED ADDITI(AVENUE FL 33139 /DETA 925 LENO IDENCE, **HISTORIC** Ш




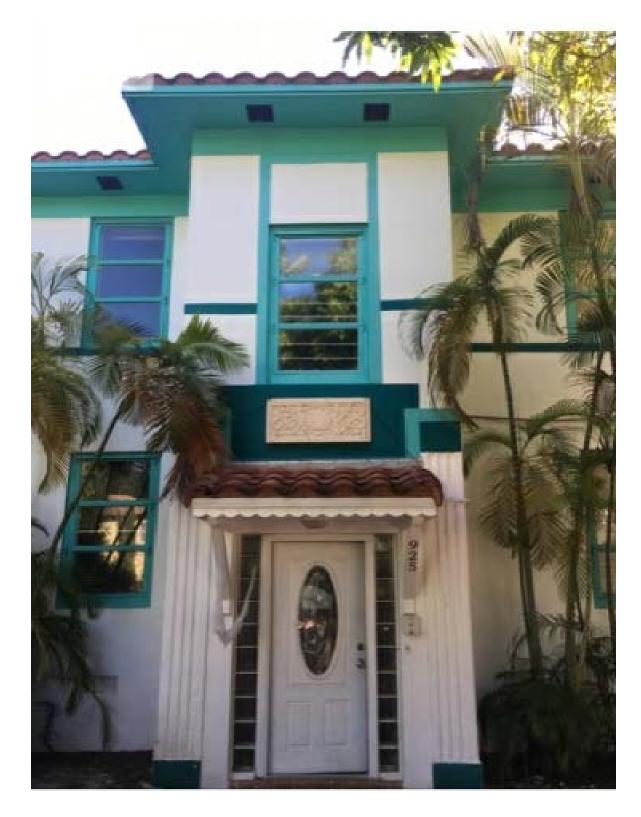


VIEW 1

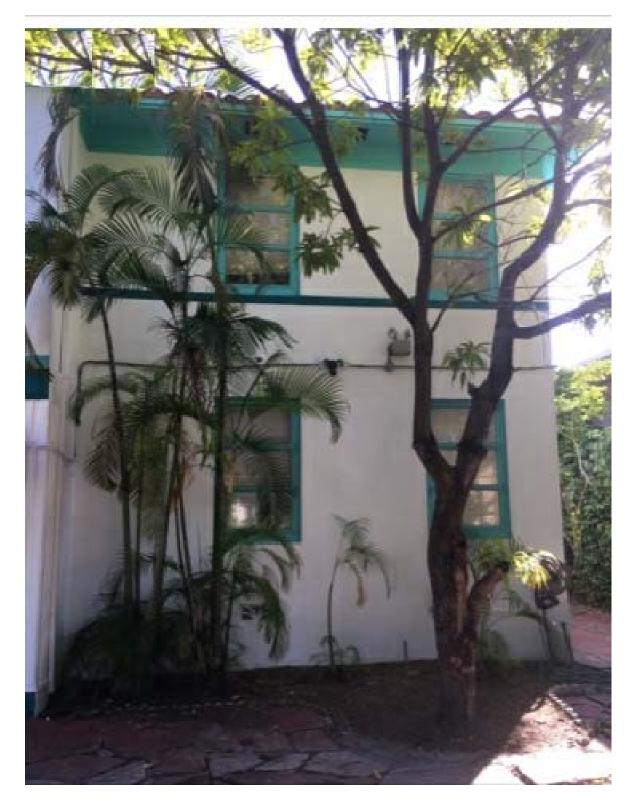

VIEW 2

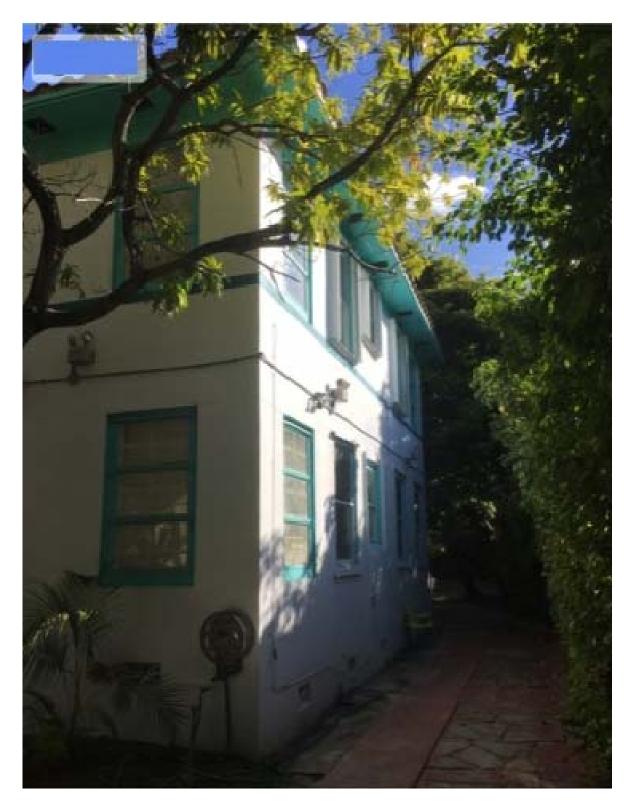


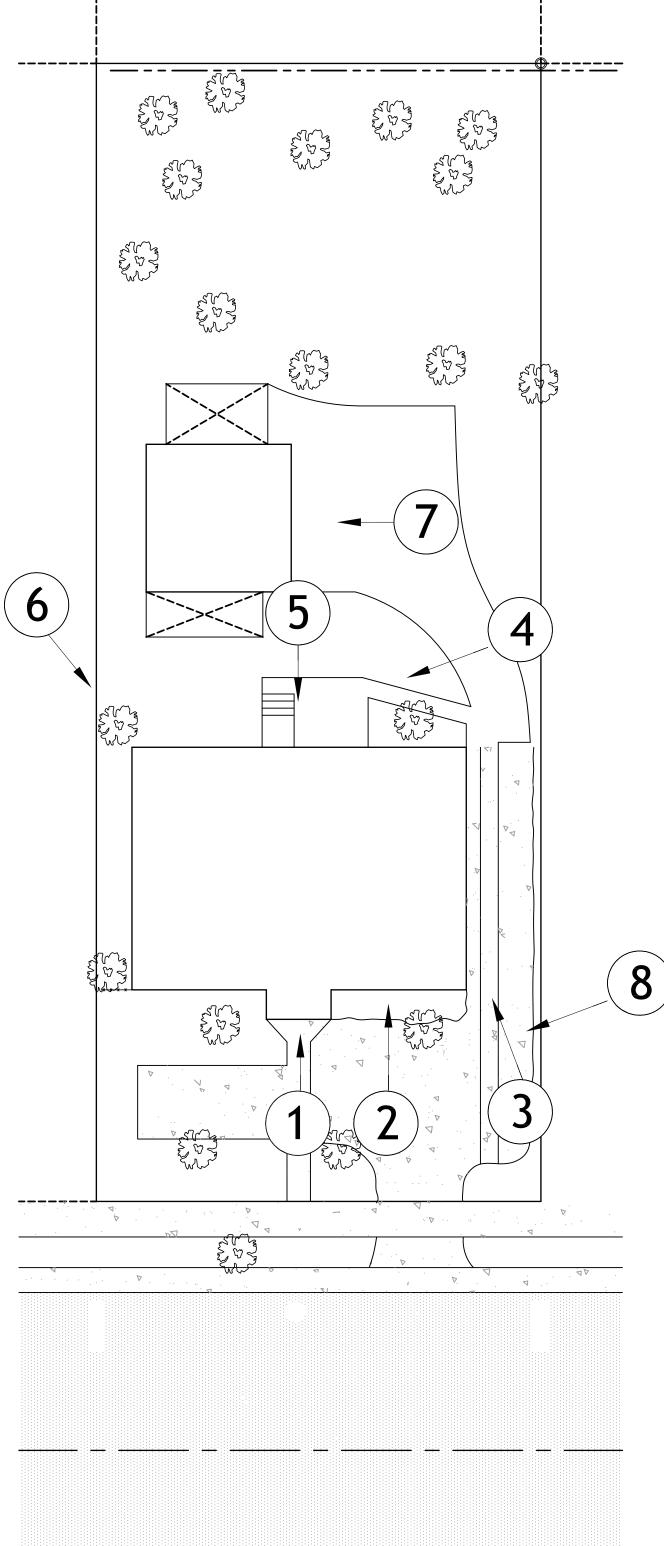



VIEW 3


CURRENT AERIAL VIEW / KEY PLAN

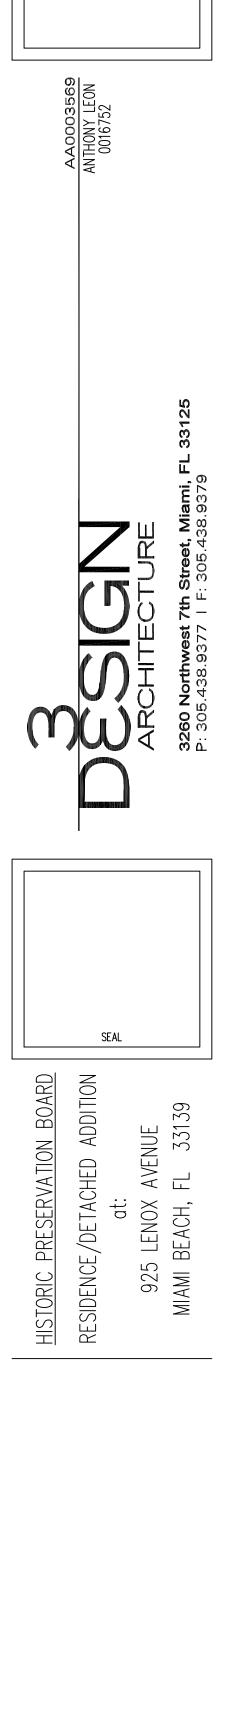


DRAWN BY:

REVISIONS:




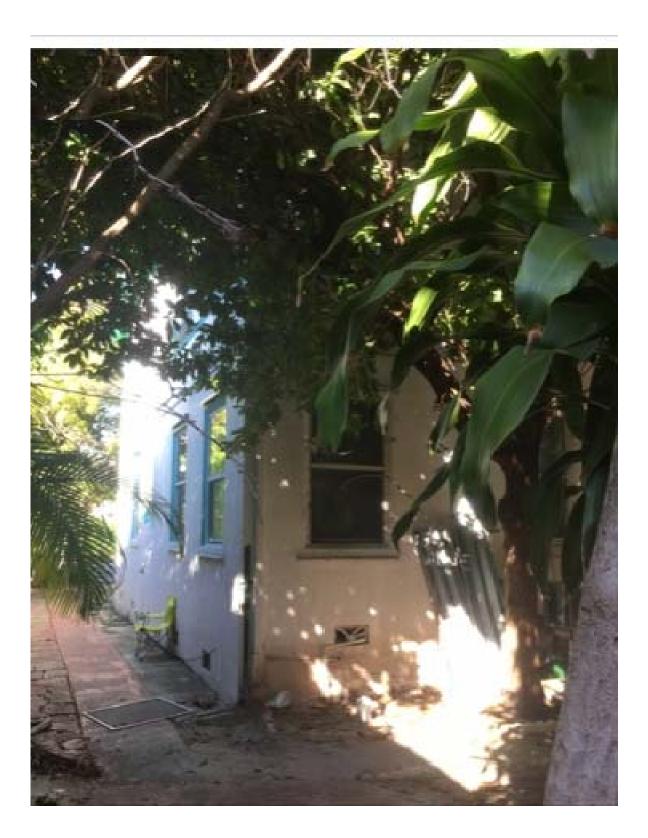


VIEW 4

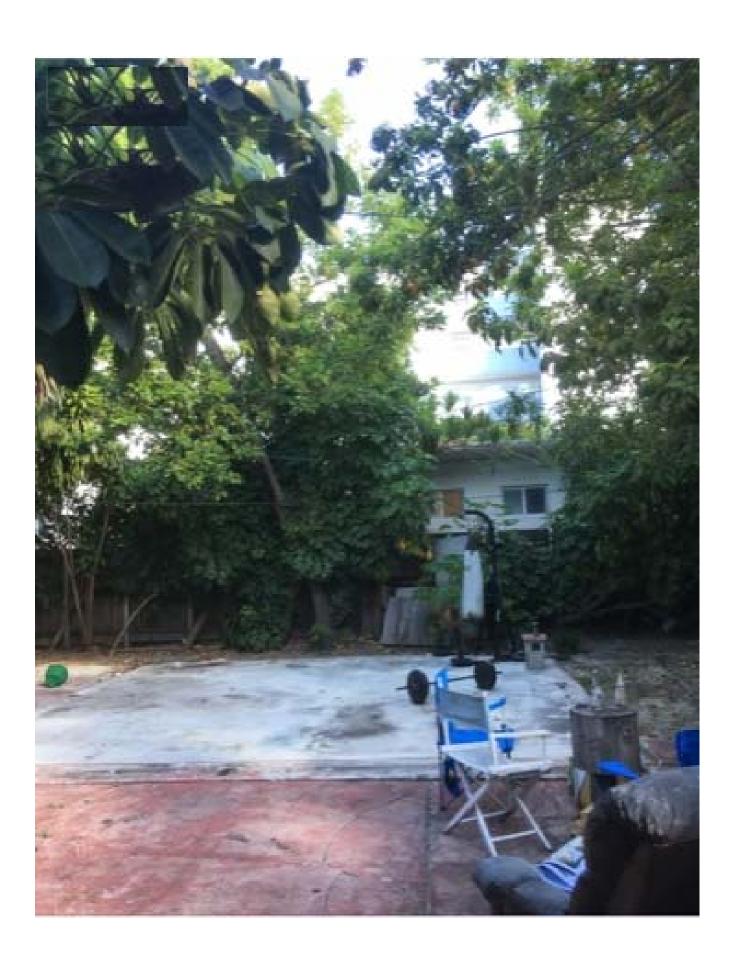



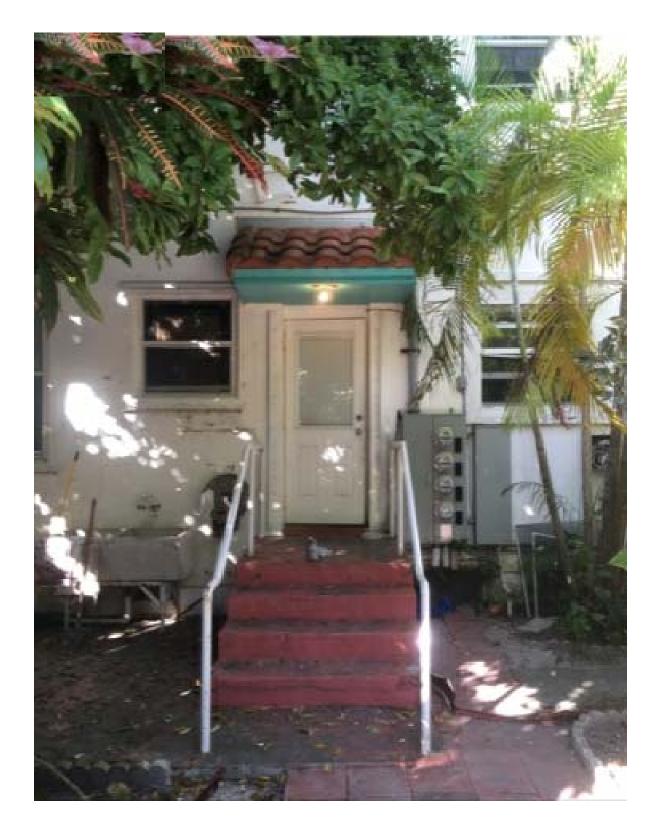


VIEW 5

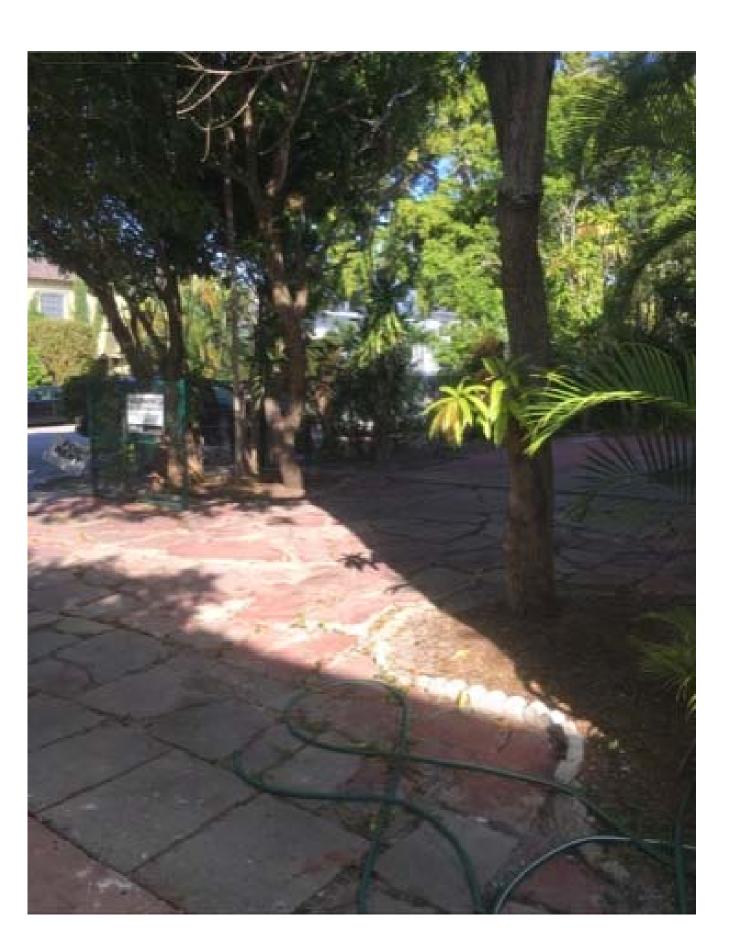




VIEW 7

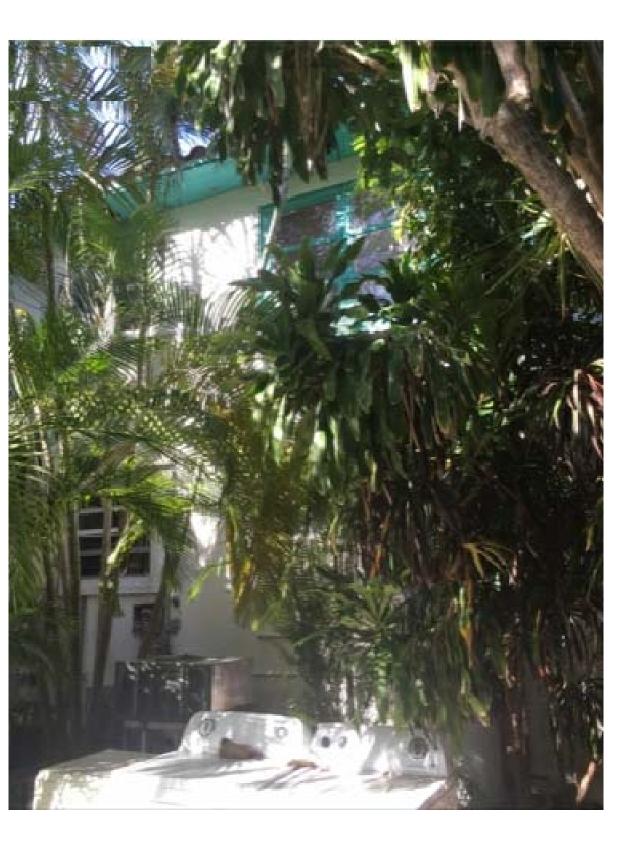

VIEW 6

ſſ		ろりのい	ARCHITECTURE	3260 Northwest 7th Street, Miami, FL 33125	P: 305.438.9377 F: 305.438.9379
		SEAL			
HISTORIC PRESERVATION BOARD	RESIDENCE/DETACHED ADDITION	at:	925 LENOX AVENUE	MIAMI BEACH, FL 33139	

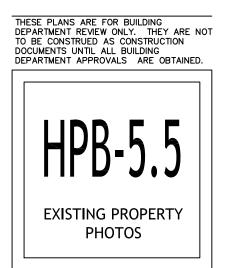




STREET VIEW (WEST) SCALE: N.T.S.








SCALE: N.T.S.

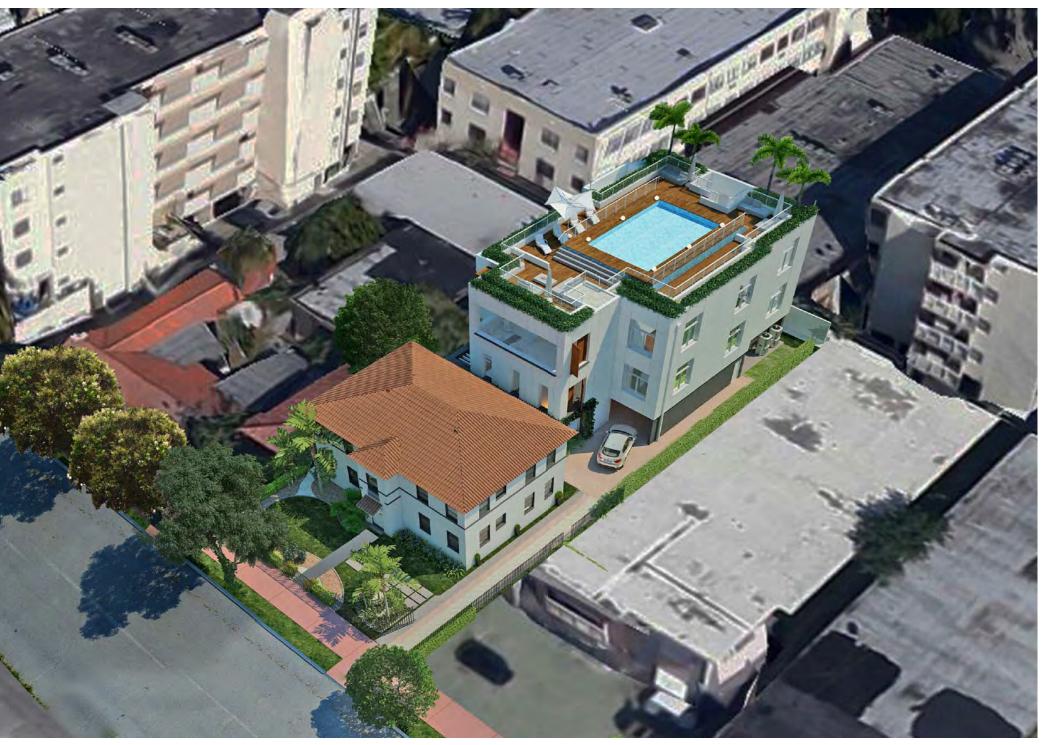



AERIAL VIEW - CONTEXTUAL PERSPECTIVE SCALE: N.T.S.

SIDE VIEW (SOUTH)

				.wn by /Isions:			
		AA0003569	ANTHONY LEON	70/0100			
	(M)		ろりつこ	ARCHITECTURE	3260 Northwest 7th Street, Miami, FL 33125	P: 305.438.9377 F: 305.438.9379
				SEAL			
	HISTORIC PRESERVATION BOARD		RESIDENCE/DETACHED ADDITION	at:	925 LENOX AVENUE	MIAMI BEACH, FL 33139	
_							_

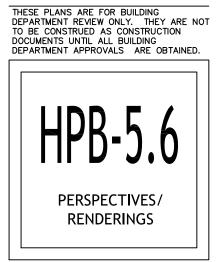

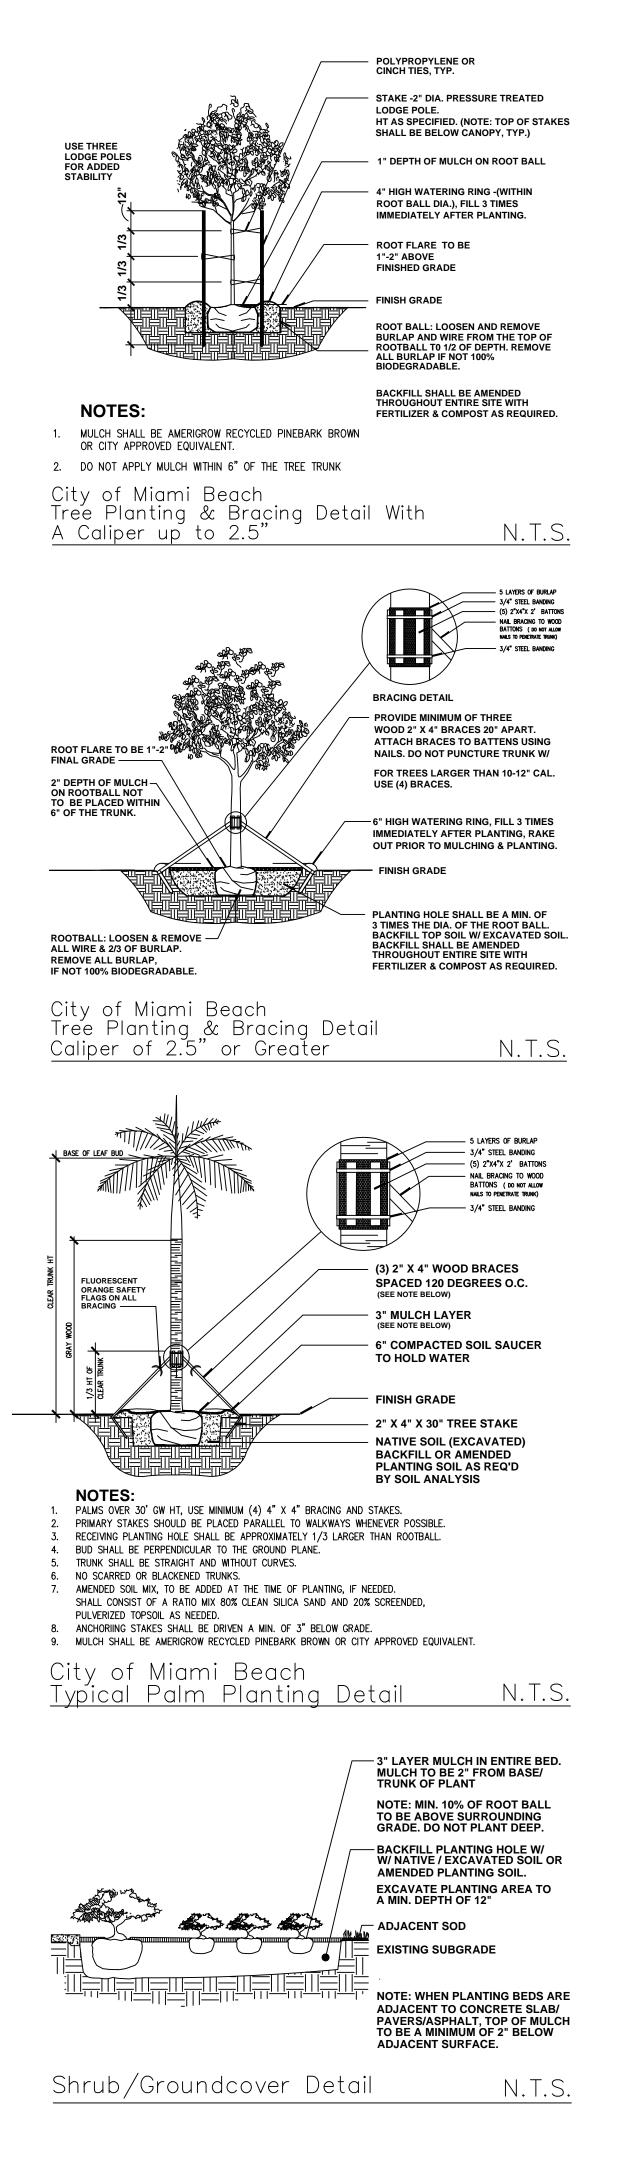

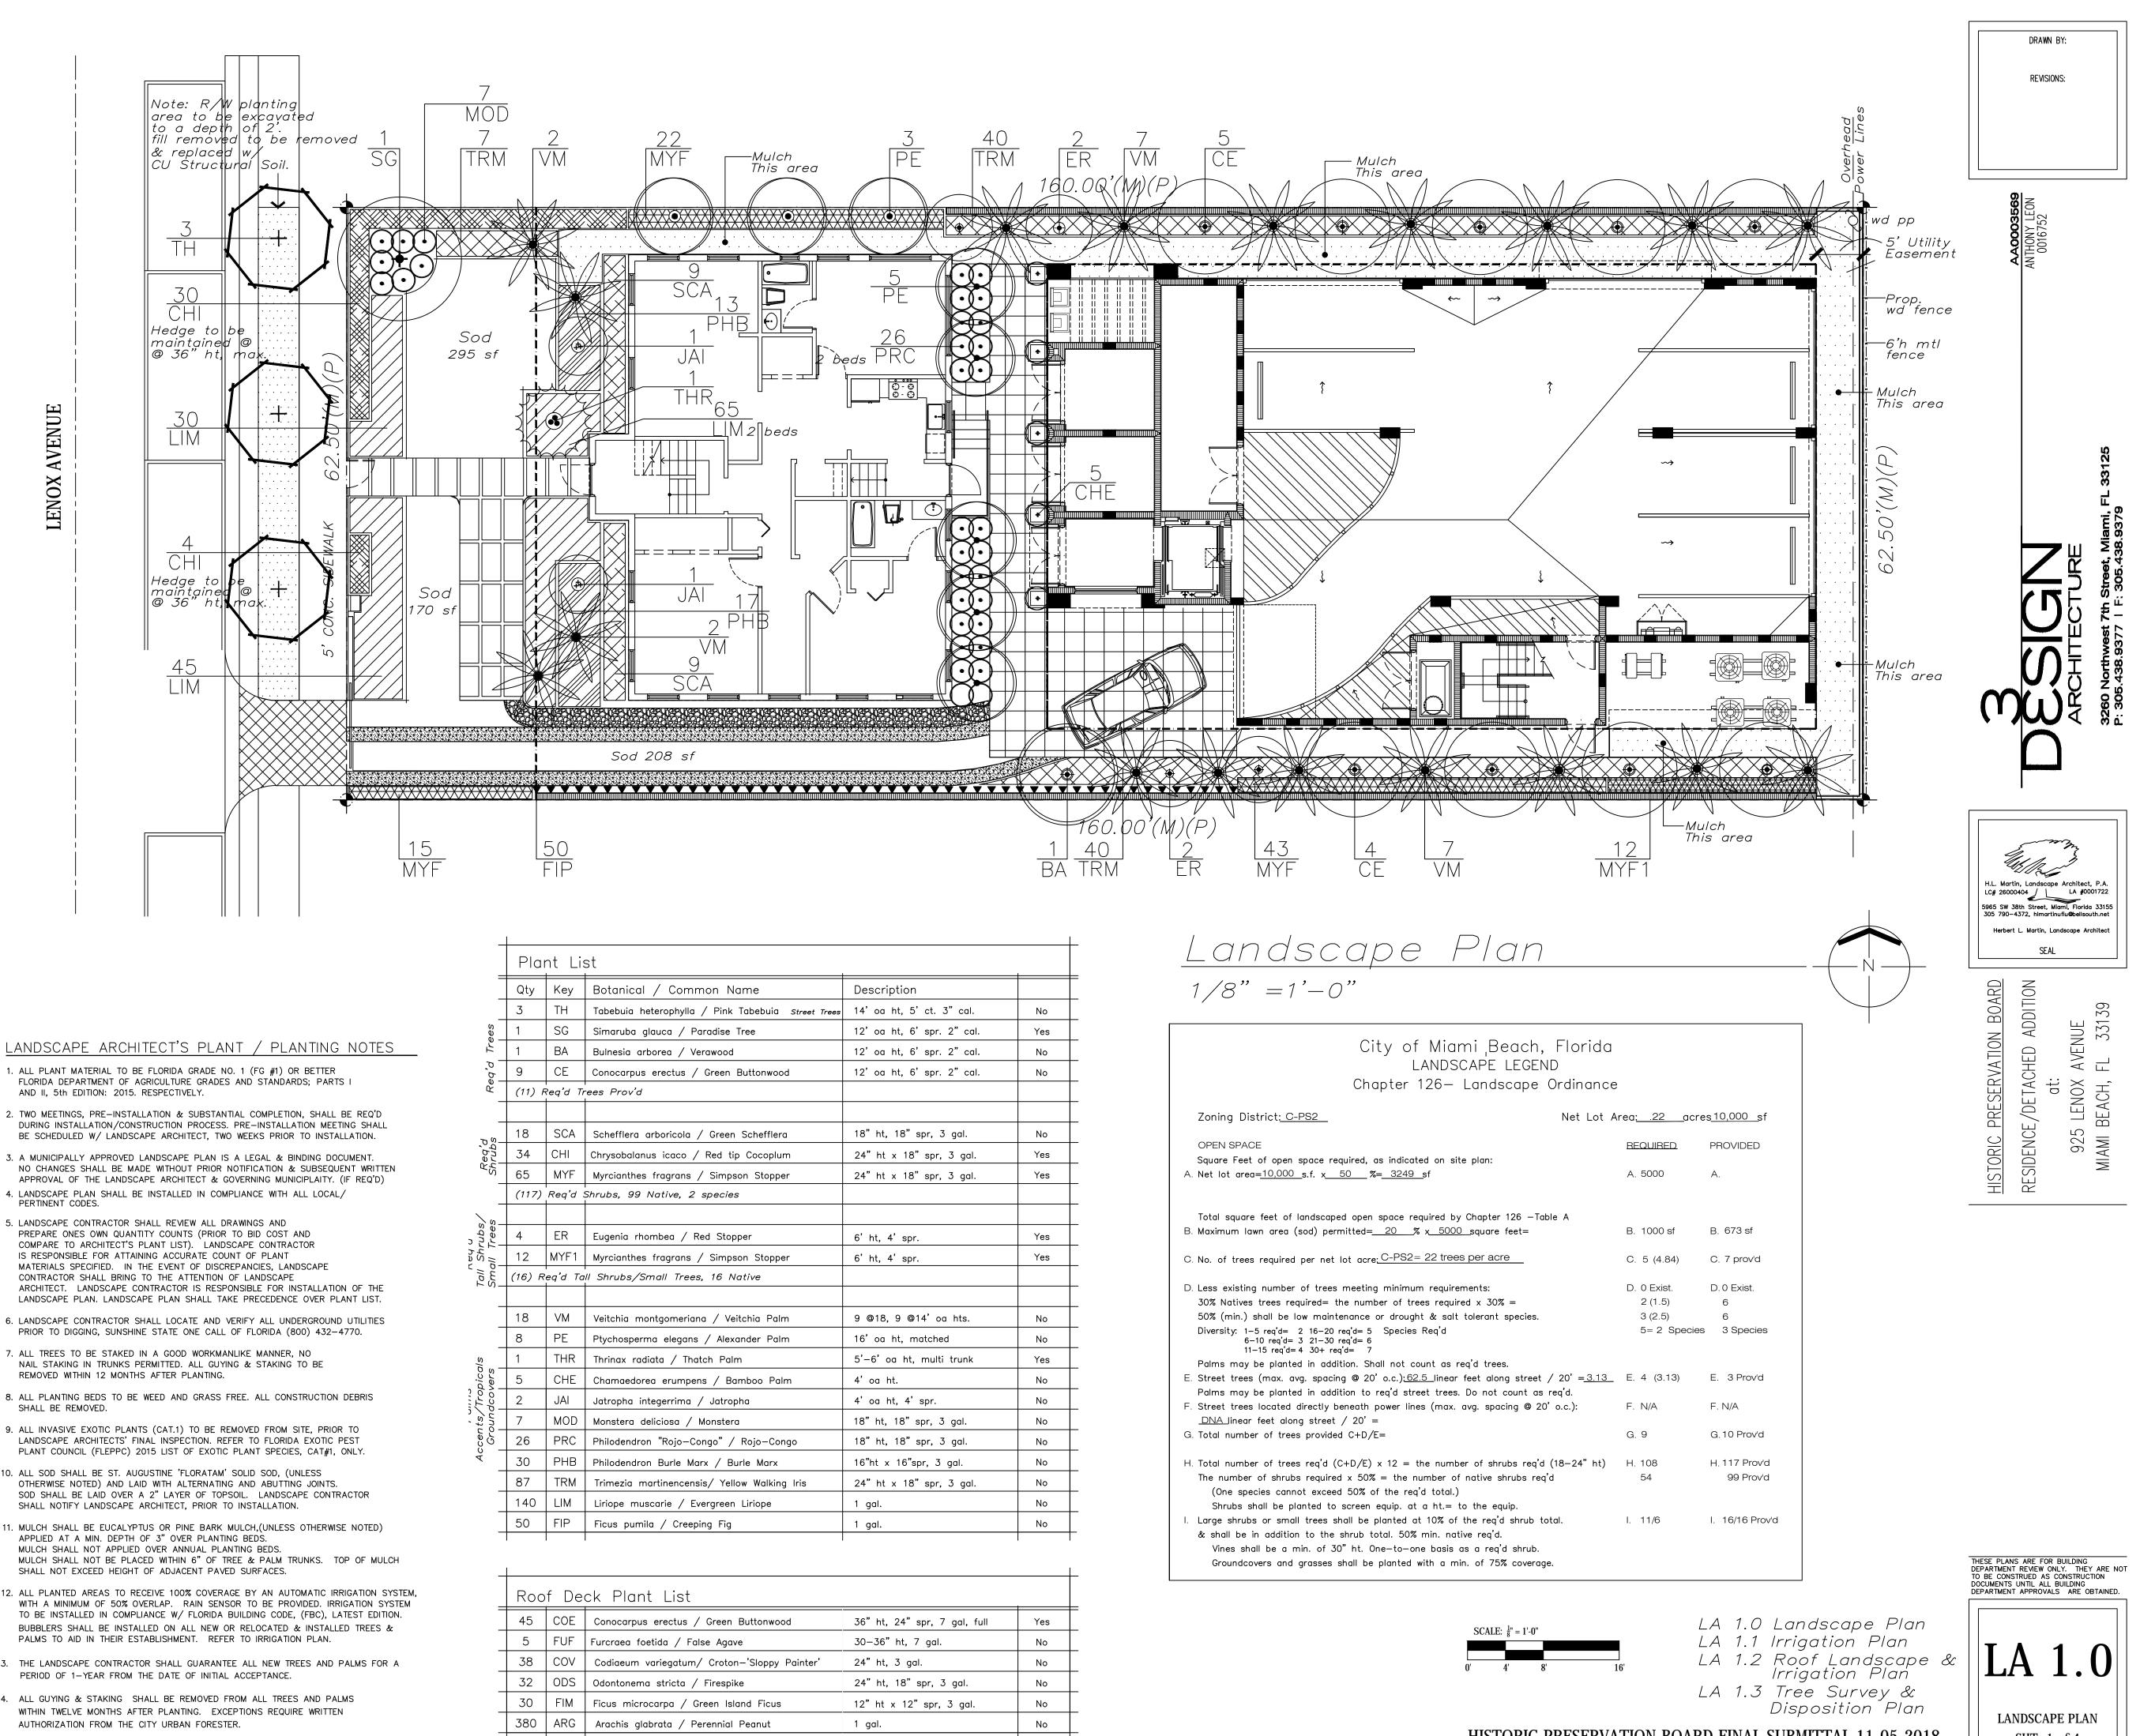

LANDSCAPE ARCHITECT'S PLANT / PLANTING NOTES

- 1. ALL PLANT MATERIAL TO BE FLORIDA GRADE NO. 1 (FG #1) OR BETTER FLORIDA DEPARTMENT OF AGRICULTURE GRADES AND STANDARDS; PARTS I AND II, 5th EDITION: 2015. RESPECTIVELY.
- 2. TWO MEETINGS, PRE-INSTALLATION & SUBSTANTIAL COMPLETION, SHALL BE REQ'D DURING INSTALLATION / CONSTRUCTION PROCESS, PRE-INSTALLATION MEETING SHALL BE SCHEDULED W/ LANDSCAPE ARCHITECT, TWO WEEKS PRIOR TO INSTALLATION.
- 3. A MUNICIPALLY APPROVED LANDSCAPE PLAN IS A LEGAL & BINDING DOCUMENT. NO CHANGES SHALL BE MADE WITHOUT PRIOR NOTIFICATION & SUBSEQUENT WRITTEN APPROVAL OF THE LANDSCAPE ARCHITECT & GOVERNING MUNICIPLAITY. (IF REQ'D)
- PERTINENT CODES.

AVENUE

LENOX


- 5. LANDSCAPE CONTRACTOR SHALL REVIEW ALL DRAWINGS AND PREPARE ONES OWN QUANTITY COUNTS (PRIOR TO BID COST AND COMPARE TO ARCHITECT'S PLANT LIST). LANDSCAPE CONTRACTOR IS RESPONSIBLE FOR ATTAINING ACCURATE COUNT OF PLANT MATERIALS SPECIFIED. IN THE EVENT OF DISCREPANCIES, LANDSCAPE CONTRACTOR SHALL BRING TO THE ATTENTION OF LANDSCAPE ARCHITECT. LANDSCAPE CONTRACTOR IS RESPONSIBLE FOR INSTALLATION OF THE LANDSCAPE PLAN. LANDSCAPE PLAN SHALL TAKE PRECEDENCE OVER PLANT LIST.
- 6. LANDSCAPE CONTRACTOR SHALL LOCATE AND VERIFY ALL UNDERGROUND UTILITIES
- 7. ALL TREES TO BE STAKED IN A GOOD WORKMANLIKE MANNER, NO NAIL STAKING IN TRUNKS PERMITTED. ALL GUYING & STAKING TO BE REMOVED WITHIN 12 MONTHS AFTER PLANTING.
- 8. ALL PLANTING BEDS TO BE WEED AND GRASS FREE. ALL CONSTRUCTION DEBRIS SHALL BE REMOVED.
- 9. ALL INVASIVE EXOTIC PLANTS (CAT.1) TO BE REMOVED FROM SITE, PRIOR TO LANDSCAPE ARCHITECTS' FINAL INSPECTION. REFER TO FLORIDA EXOTIC PEST PLANT COUNCIL (FLEPPC) 2015 LIST OF EXOTIC PLANT SPECIES, CAT#1, ONLY.
- 10. ALL SOD SHALL BE ST. AUGUSTINE 'FLORATAM' SOLID SOD, (UNLESS OTHERWISE NOTED) AND LAID WITH ALTERNATING AND ABUTTING JOINTS. SOD SHALL BE LAID OVER A 2" LAYER OF TOPSOIL. LANDSCAPE CONTRACTOR SHALL NOTIFY LANDSCAPE ARCHITECT, PRIOR TO INSTALLATION.
- 11. MULCH SHALL BE EUCALYPTUS OR PINE BARK MULCH, (UNLESS OTHERWISE NOTED) APPLIED AT A MIN. DEPTH OF 3" OVER PLANTING BEDS. MULCH SHALL NOT APPLIED OVER ANNUAL PLANTING BEDS. MULCH SHALL NOT BE PLACED WITHIN 6" OF TREE & PALM TRUNKS. TOP OF MULCH
- 12. ALL PLANTED AREAS TO RECEIVE 100% COVERAGE BY AN AUTOMATIC IRRIGATION SYSTEM, WITH A MINIMUM OF 50% OVERLAP. RAIN SENSOR TO BE PROVIDED. IRRIGATION SYSTEM TO BE INSTALLED IN COMPLIANCE W/ FLORIDA BUILDING CODE, (FBC), LATEST EDITION. BUBBLERS SHALL BE INSTALLED ON ALL NEW OR RELOCATED & INSTALLED TREES &
- 13. THE LANDSCAPE CONTRACTOR SHALL GUARANTEE ALL NEW TREES AND PALMS FOR A PERIOD OF 1-YEAR FROM THE DATE OF INITIAL ACCEPTANCE.
- 14. ALL GUYING & STAKING SHALL BE REMOVED FROM ALL TREES AND PALMS WITHIN TWELVE MONTHS AFTER PLANTING. EXCEPTIONS REQUIRE WRITTEN AUTHORIZATION FROM THE CITY URBAN FORESTER.


_					
	Pla	nt Li	st		1
=	Qty	Key	Botanical / Common Name	Description	
	3	TH	Tabebuia heterophylla / Pink Tabebuia <i>Street Trees</i>	14' oa ht, 5' ct. 3" cal.	No
Trees	1	SG	Simaruba glauca / Paradise Tree	12' oa ht, 6' spr. 2" cal.	Yes
	1	BA	Bulnesia arborea / Verawood	12' oa ht, 6' spr. 2" cal.	No
Req'd I I	9	CE	Conocarpus erectus / Green Buttonwood	12' oa ht, 6' spr. 2" cal.	No
- <i>R</i> e	(11) F	Req'd Tr	rees Prov'd		
_	18	SCA	Cale officer and arise la / Orean Cale officer	19" ht 19" opr 7 gel	Na
p,t sqi	34		Schefflera arboricola / Green Schefflera	18" ht, 18" spr, 3 gal.	No
Regʻd Shrubs I I		CHI	Chrysobalanus icaco / Red tip Cocoplum	24" ht x 18" spr, 3 gal.	Yes
•, 	65	MYF	Myrcianthes fragrans / Simpson Stopper	24" ht x 18" spr, 3 gal.	Yes
	(117)	Req d 3	Shrubs, 99 Native, 2 species		
' Shrubs/ all Trees	4	ER	Eugenia rhombea / Red Stopper	6'ht, 4'spr.	Yes
	12	MYF1	Myrcianthes fragrans / Simpson Stopper	6' ht, 4' spr.	Yes
Tall St Small	(16) R	'eq'd Ta	ll Shrubs/Small Trees, 16 Native		
_	18	VM	Veitchia montgomeriana / Veitchia Palm	9 @18, 9 @14' oa hts.	No
_	8	PE	Ptychosperma elegans / Alexander Palm	16' oa ht, matched	No
	1		Thrinax radiata / Thatch Palm	5'-6' oa ht, multi trunk	Yes
Tropicals Icovers I I I	5	CHE	Chamaedorea erumpens / Bamboo Palm	4' oa ht.	No
rop. 20V6	2	JAI	Jatropha integerrima / Jatropha	4' oa ht, 4' spr.	No
nde bnd	7	MOD	Monstera deliciosa / Monstera	18" ht, 18" spr, 3 gal.	No
Accents/Tropica Groundcovers 	26	PRC	Philodendron "Rojo-Congo" / Rojo-Congo	18" ht, 18" spr, 3 gal.	No
– УС АС	30	PHB	Philodendron Burle Marx / Burle Marx	16"ht x 16"spr, 3 gal.	No
_	87	TRM	Trimezia martinencensis/ Yellow Walking Iris	24" ht x 18" spr, 3 gal.	No
_	140	LIM	Liriope muscarie / Evergreen Liriope	1 gal.	No
_	50	FIP	Ficus pumila / Creeping Fig	1 gal.	No

45	COE	Conocarpus erectus / Green Buttonwood	36" ht, 24" spr, 7 gal, full	Yes
5	FUF	Furcraea foetida / False Agave	30—36" ht, 7 gal.	No
38	COV	Codiaeum variegatum/ Croton-'Sloppy Painter'	24" ht, 3 gal.	No
32	ODS	Odontonema stricta / Firespike	24" ht, 18" spr, 3 gal.	No
30	FIM	Ficus microcarpa / Green Island Ficus	12" ht x 12" spr, 3 gal.	No
380	ARG	Arachis glabrata / Perennial Peanut	1 gal.	No

HISTORIC PRESERVATION BOARD FINAL SUBMITTAL 11.05.2018

SHT. 1 of 4

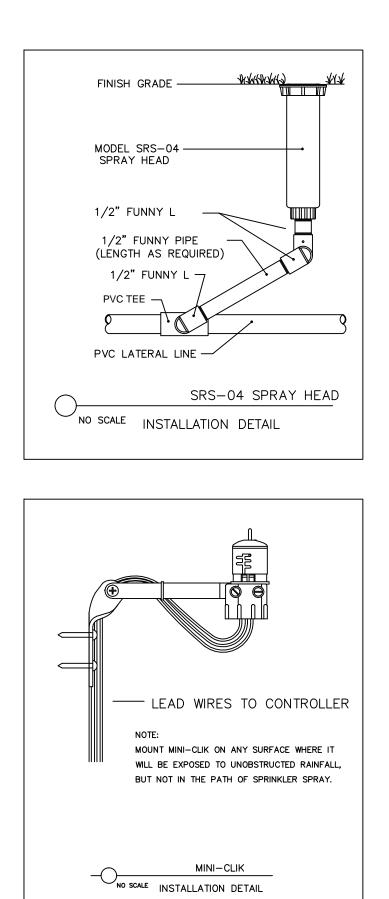


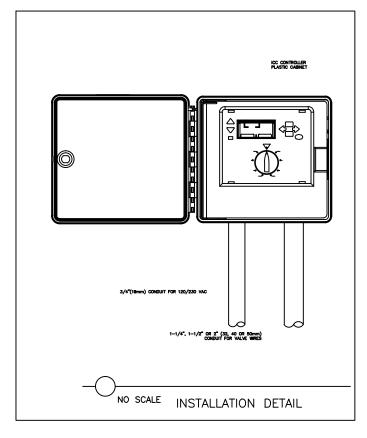

LAYOUT

LAYOUT IRRIGATION SYSTEM MAINLINES AND LATERAL LINES. MAKE ALL NECCESSARY ADJUSTMENTS AS REQUIRED TO TAKE INTO ACCOUNT ALL SITE OBSTRUCTIONS AND LIMITATIONS PRIOR TO EXCAVATING TRENCHES

FLAG ALL SPRINKLER HEAD LOCATIONS. ADJUST LOCATION AND MAKE THE NECESSARY MODIFICATIONS TO NOZZLE TYPES ETC. REQUIRED TO INSURE 100% COVERAGE.

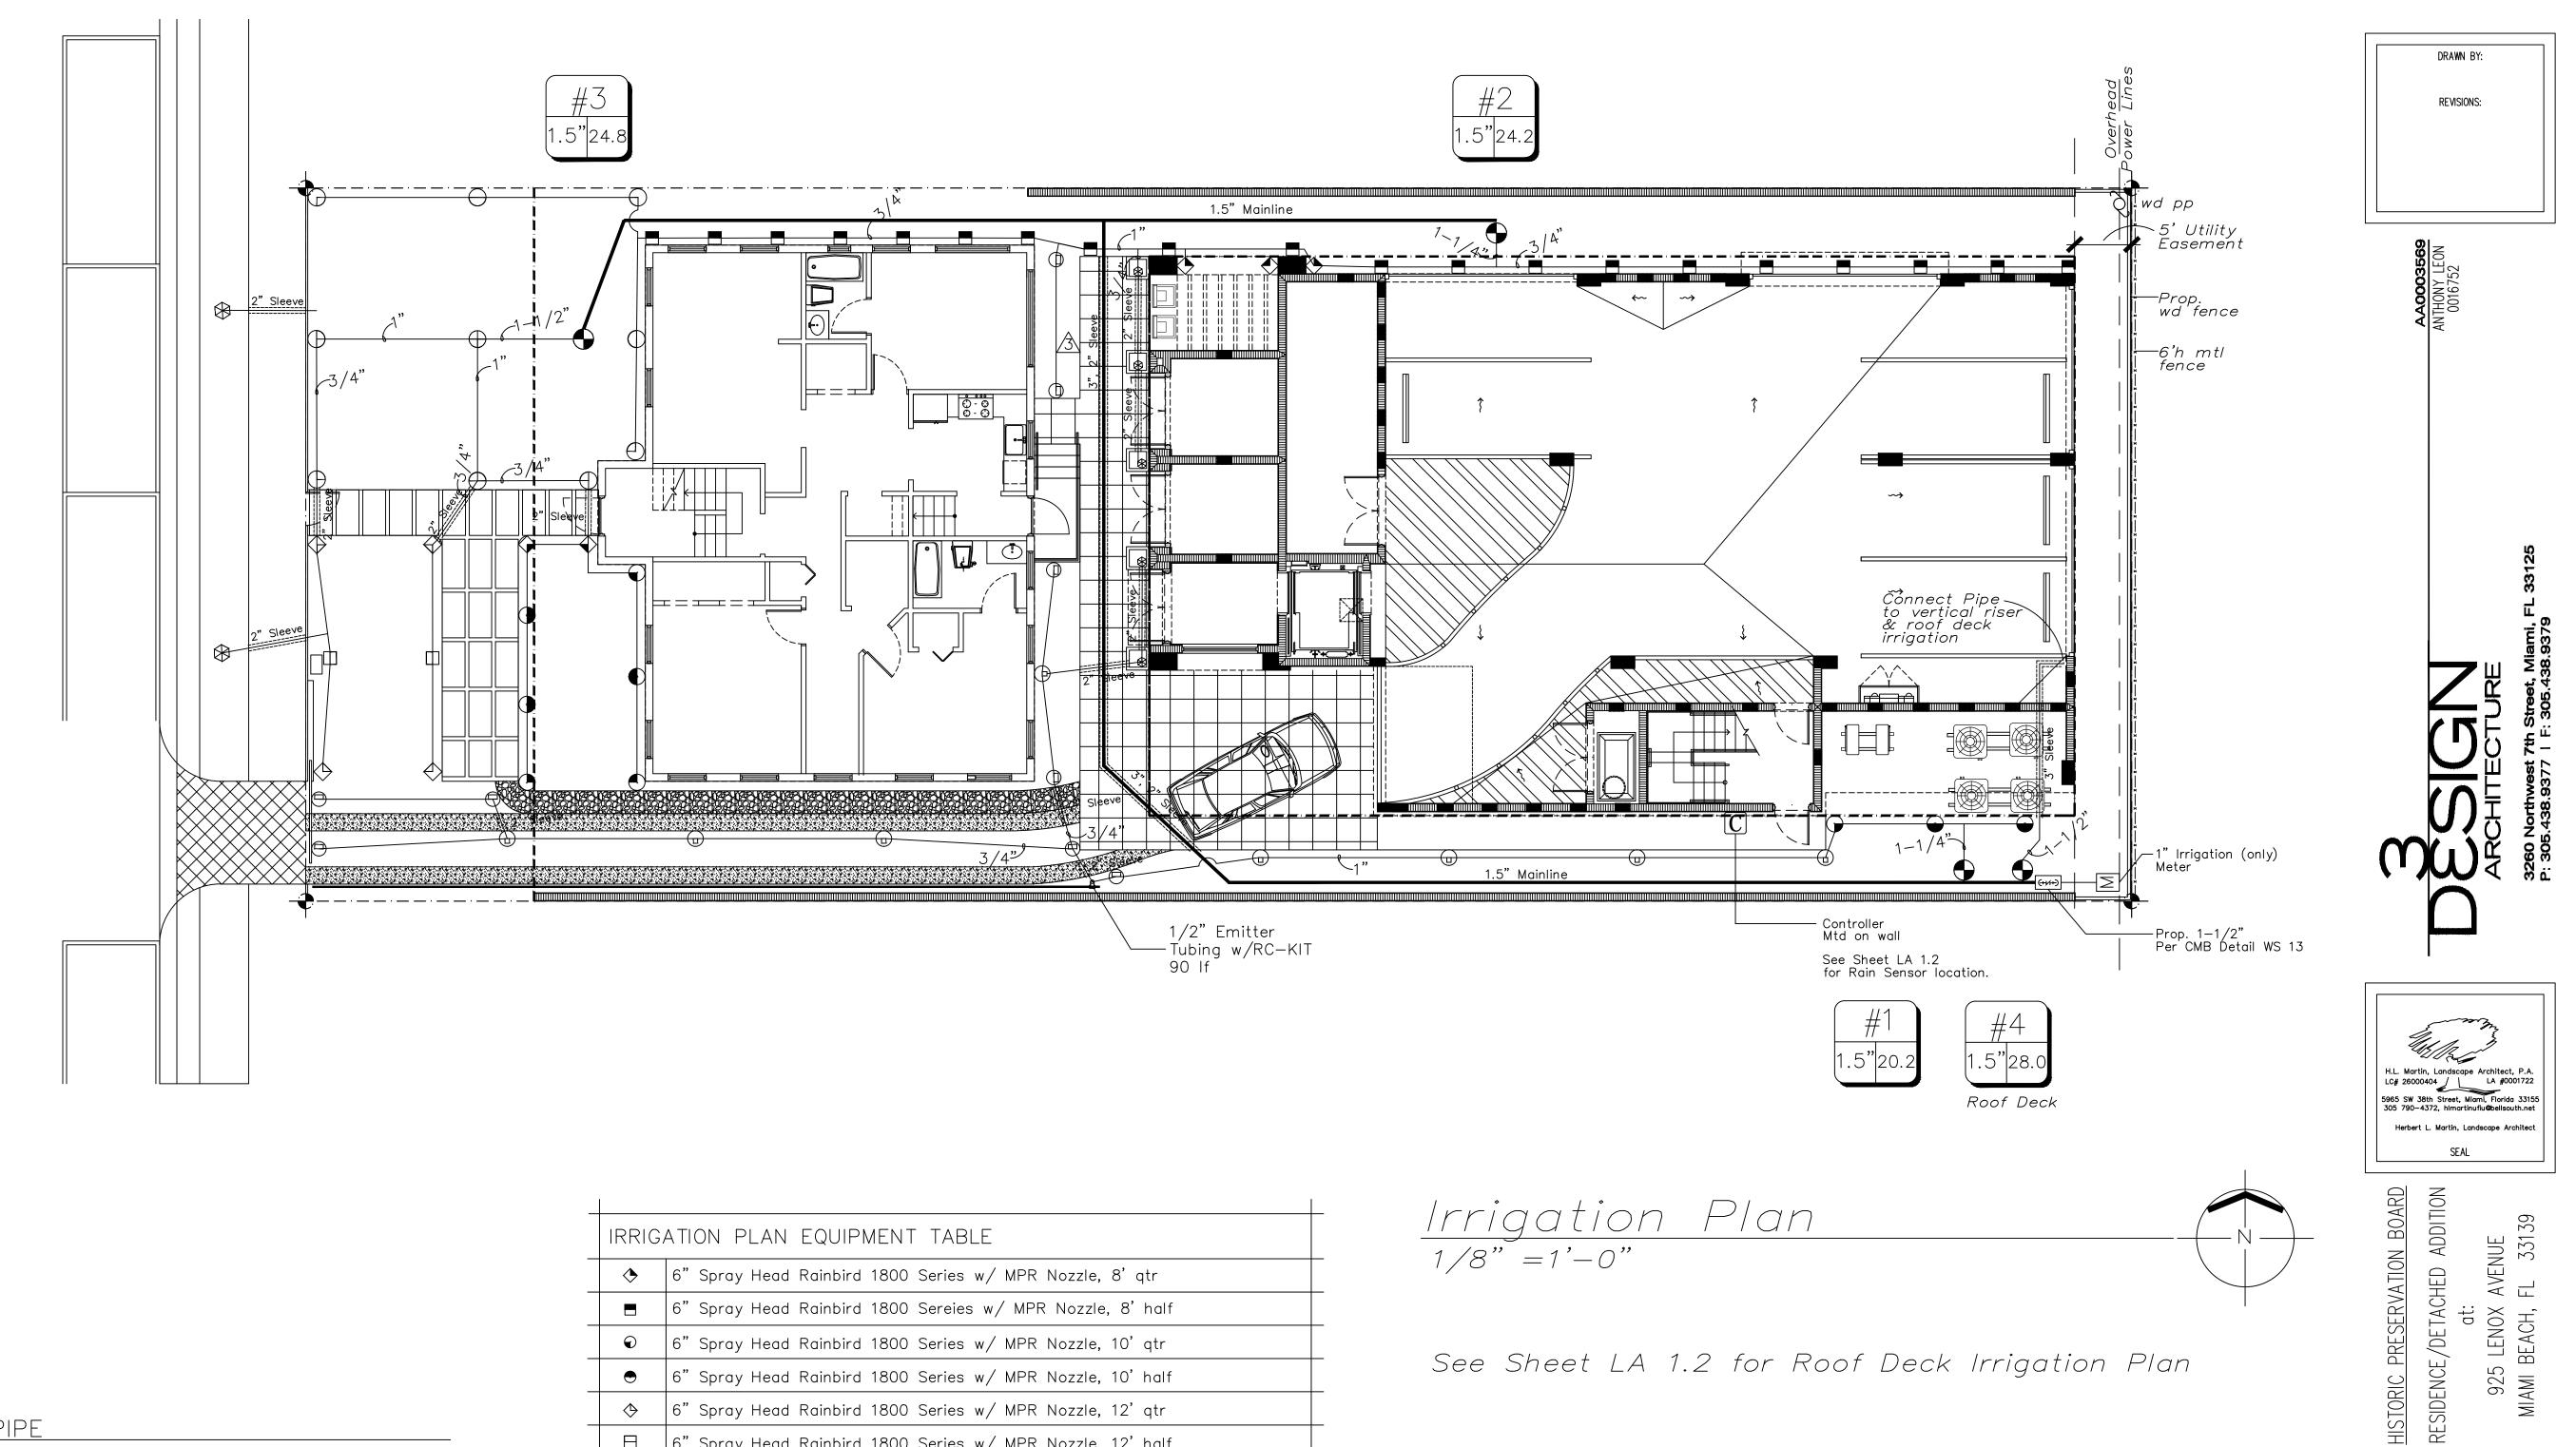


<u>PIPE</u>


LENOX AVENUE

PIPE LOCATIONS SHOWN ON PLAN ARE SCHEMATIC ONLY AND SHALL BE ADJUSTED IN THE FIELD. WHEN LAYING-OUT MAINS AND LATRALS, LOCATE PIPE NEAR EDGES OF PAVEMENT OR AGAINST BUILDINGS WHENEVER POSSIBLE TO ALLOW SPACE FOR PLANT ROOT BALLS. PIPING UNDER HARDSCAPES SUCH AS ROADS, WALKS, AND PATIOS ARE TO BE SLEEVED USING SCH. 40 PIPE. *INSTALL RAIN SENSOR AS PER LOCAL CODE FLUSHING

PRIOR TO PLACEMENT OF HEADS FLUSH ALL LINES UNTIL LINES ARE COMPLETLY CLEAN OF DEBRIS.


IRRIG	ATION PLAN EQUIPMENT TABLE
\diamond	6" Spray Head Rainbird 1800 Series w/ MPR Nozzle, 8' qtr
	6" Spray Head Rainbird 1800 Sereies w/ MPR Nozzle, 8' half
T	6" Spray Head Rainbird 1800 Series w/ MPR Nozzle, 10' qtr
●	6" Spray Head Rainbird 1800 Series w/ MPR Nozzle, 10' half
\diamondsuit	6" Spray Head Rainbird 1800 Series w/ MPR Nozzle, 12' qtr
\square	6" Spray Head Rainbird 1800 Series w/ MPR Nozzle, 12' half
G	6" Spray Head Rainbird 1800 Series w/ MPR Nozzle, 15' qtr
θ	6" Spray Head Rainbird 1800 Series w/ MPR Nozzle, 15' half
\oplus	6" Spray Head Rainbird 1800 Series w/ MPR Nozzle, 15' full
▣	6" Spray Head Rainbird 1800 Series w/ MPR Nozzle, 15' Strip Series-Center
⊜	6" Spray Head Rainbird 1800 Series w/ MPR Nozzle, 15' Strip Series-End
⊗	6" Spray Head Rainbird Bubbler- 1300 A-F
	1/2" Emitter Tubing, Flexible XF Series Dripline, 90 If.
ឋ	RC Kit to Connect Emitter Tubing
•	1", 1.5" Valves by Rainbird, in Carson Valve Box
	1.5" Mainline, Schedule 40 PVC
	Sleeves, Schedule 40 PVC
	Lateral Lines, Schedule 160 pvc
С	Controller, ESP Modular Series 4 Stations
R	Rain Sensor, by Miniclik
(++/++-)	Proposed 1-1/2" ØRPZ For IRR Service. As Per CMB DET WS 31.
Μ	Proposed 1—1/2"øIRR. Water Meter, Per CMB DET WS 13.

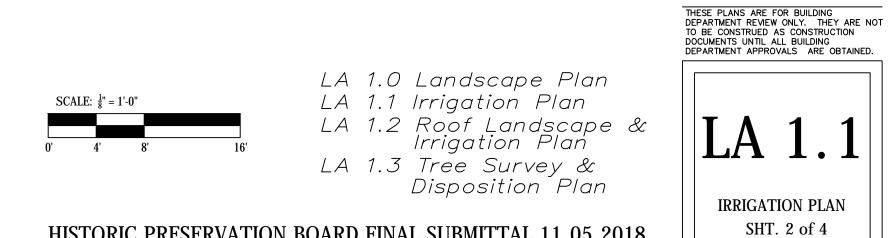


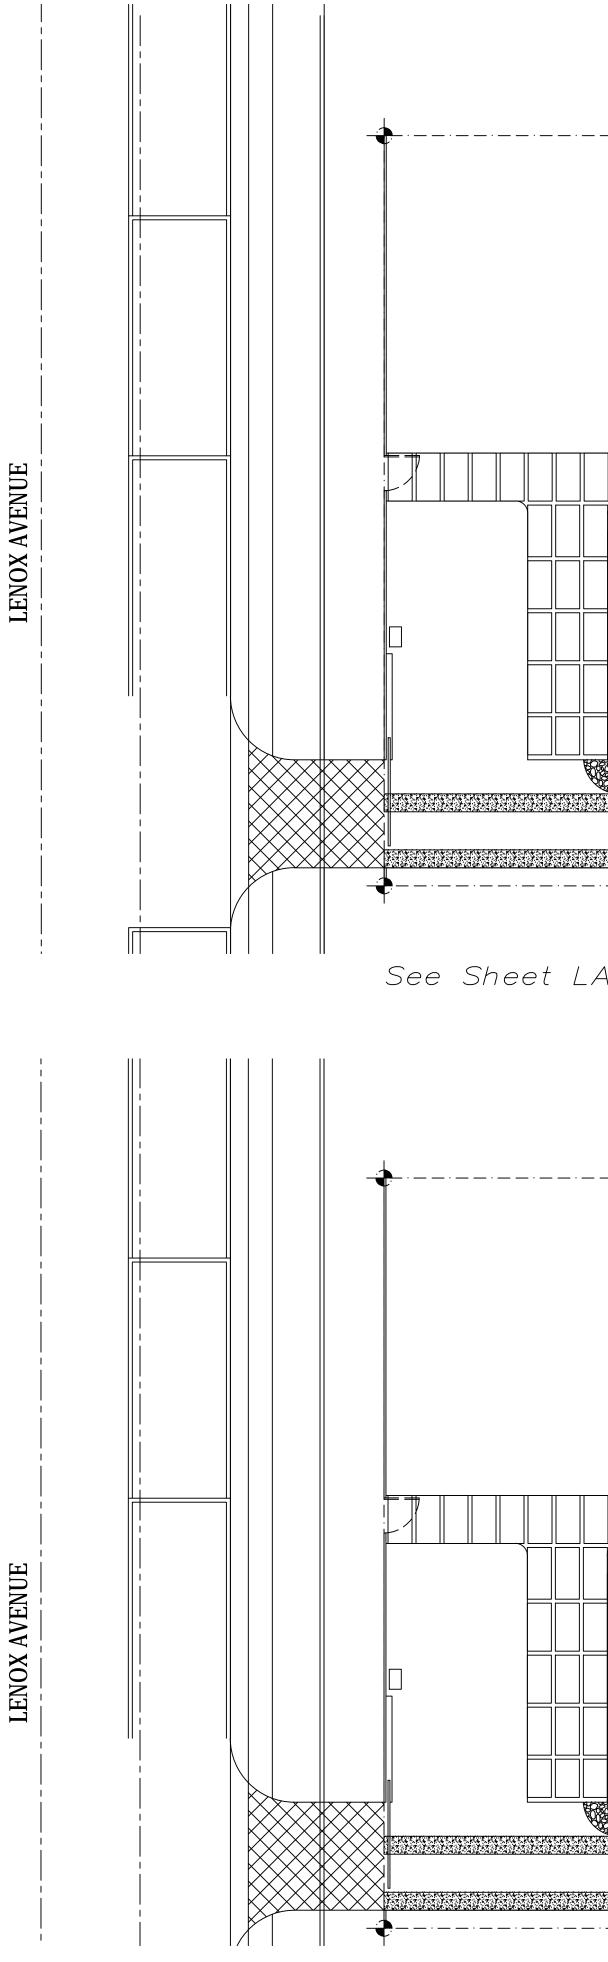

ENUE

ENOX

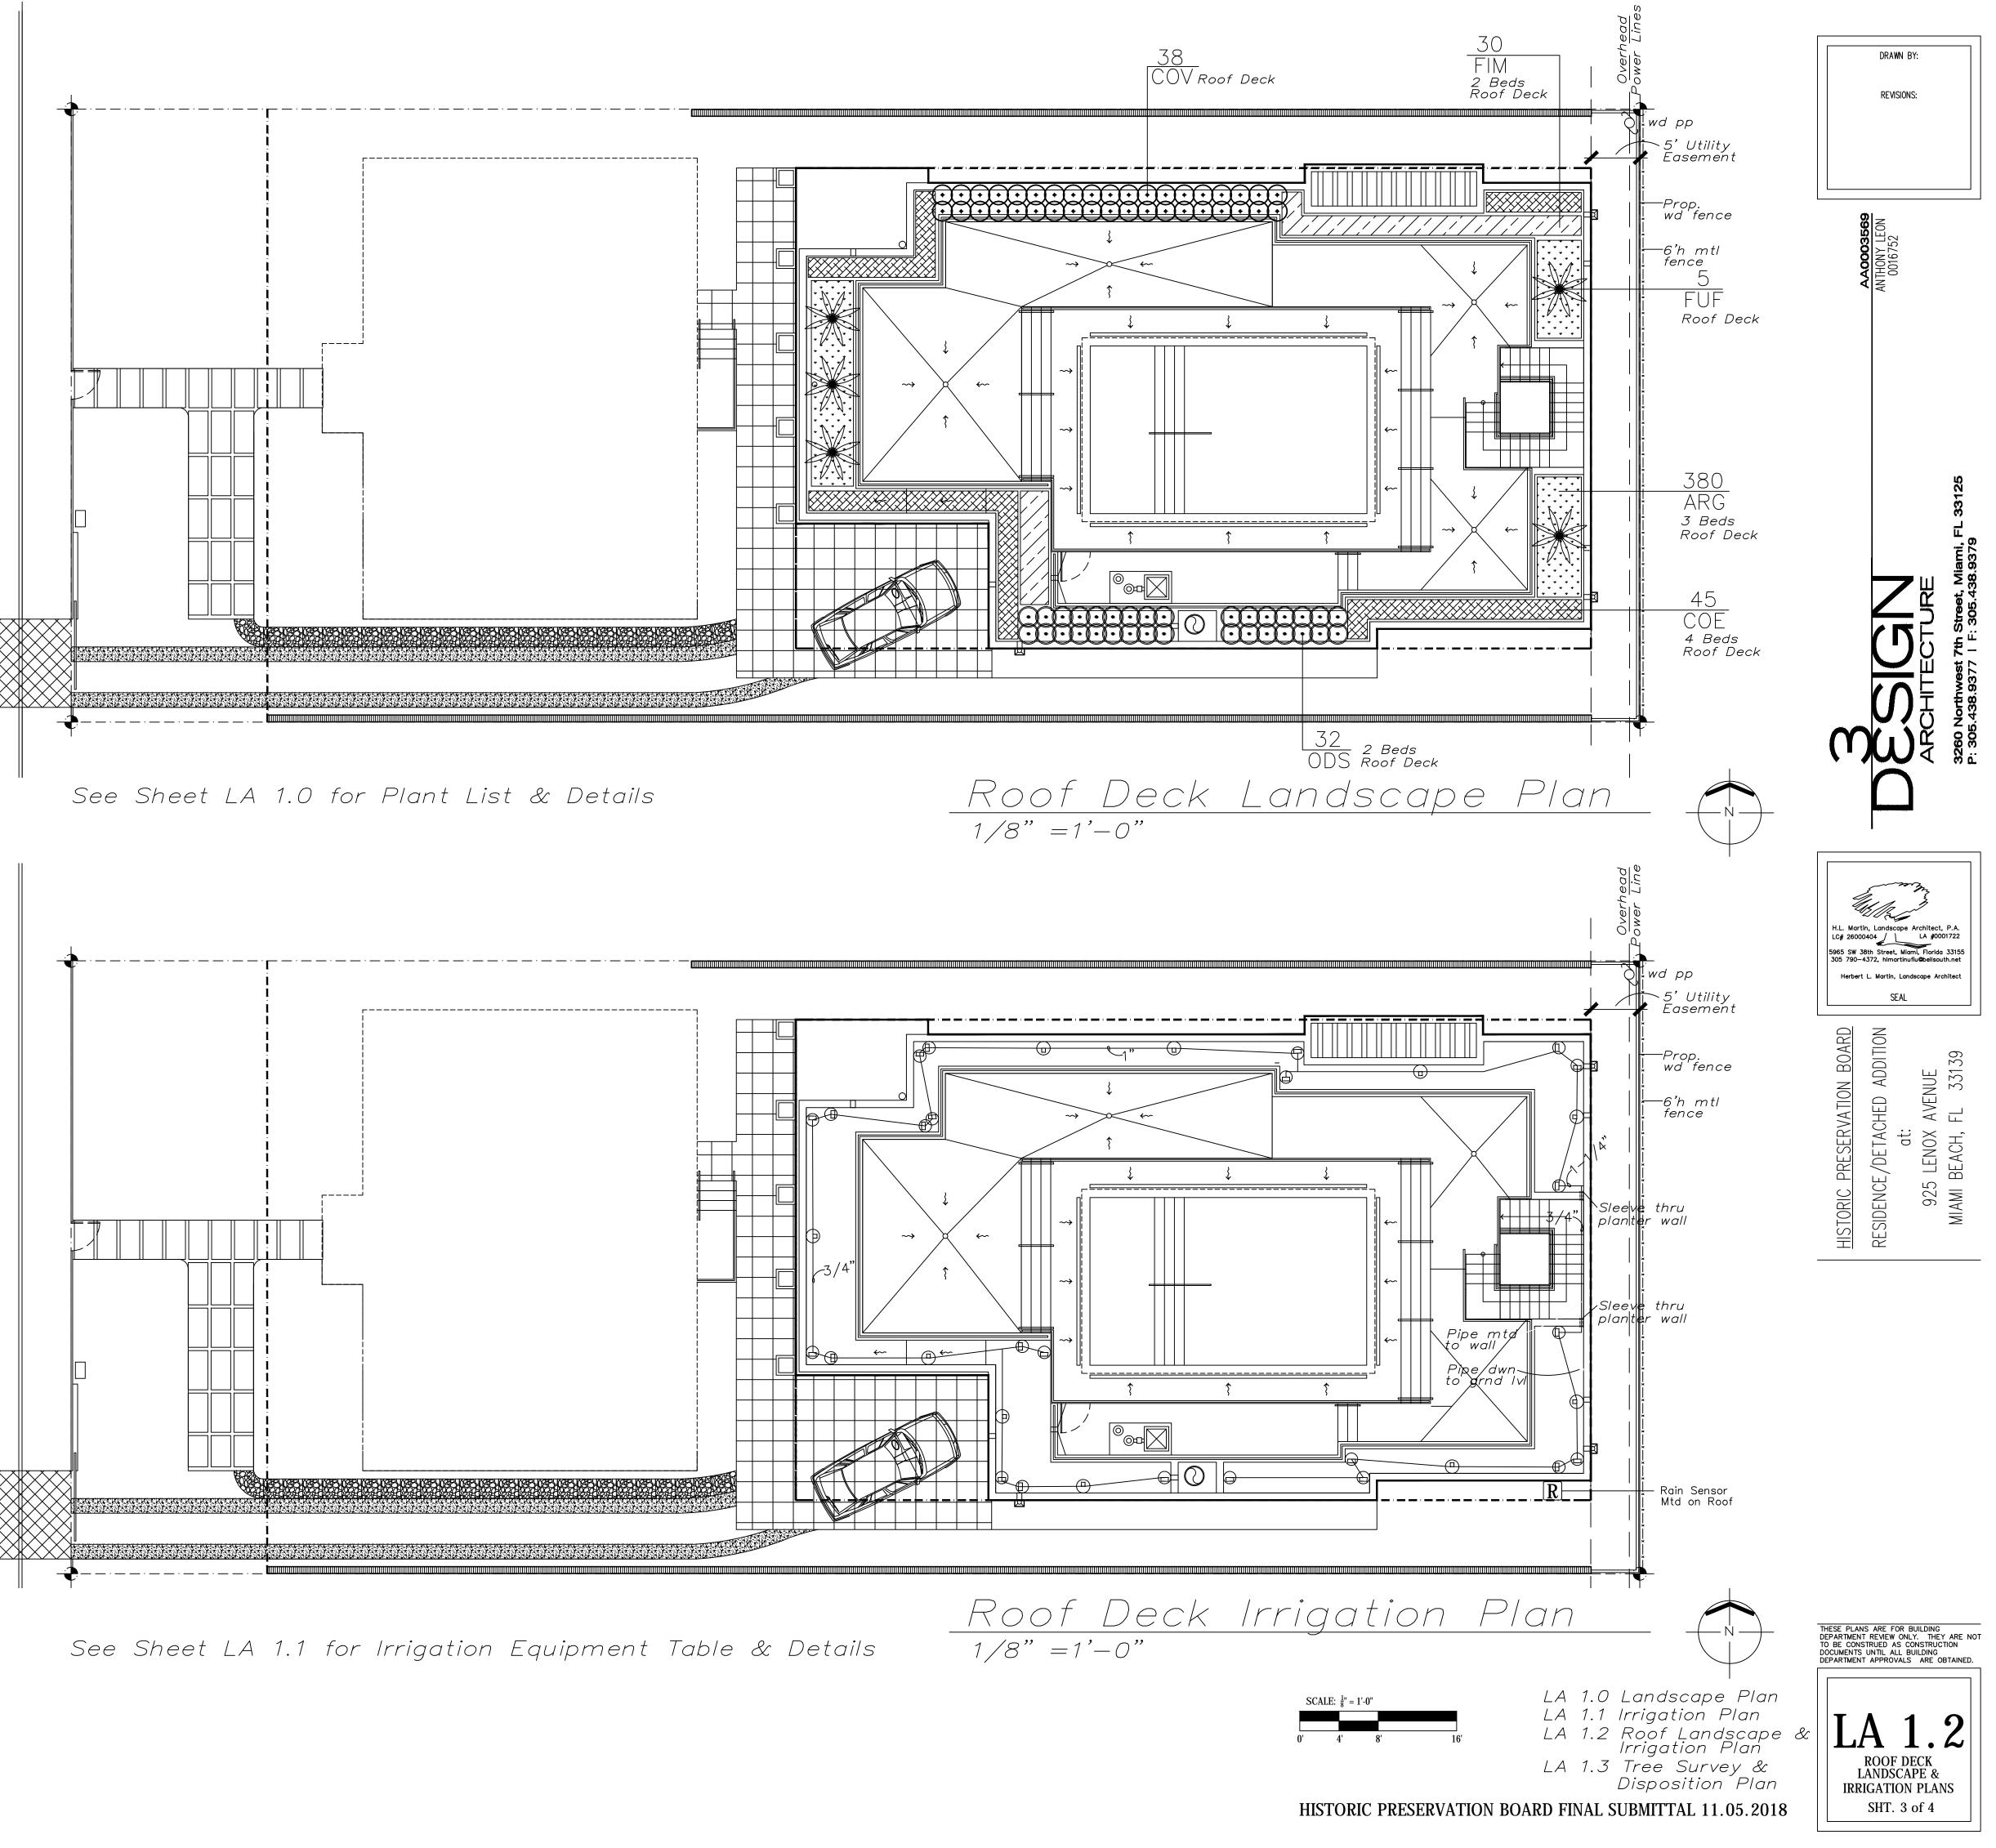

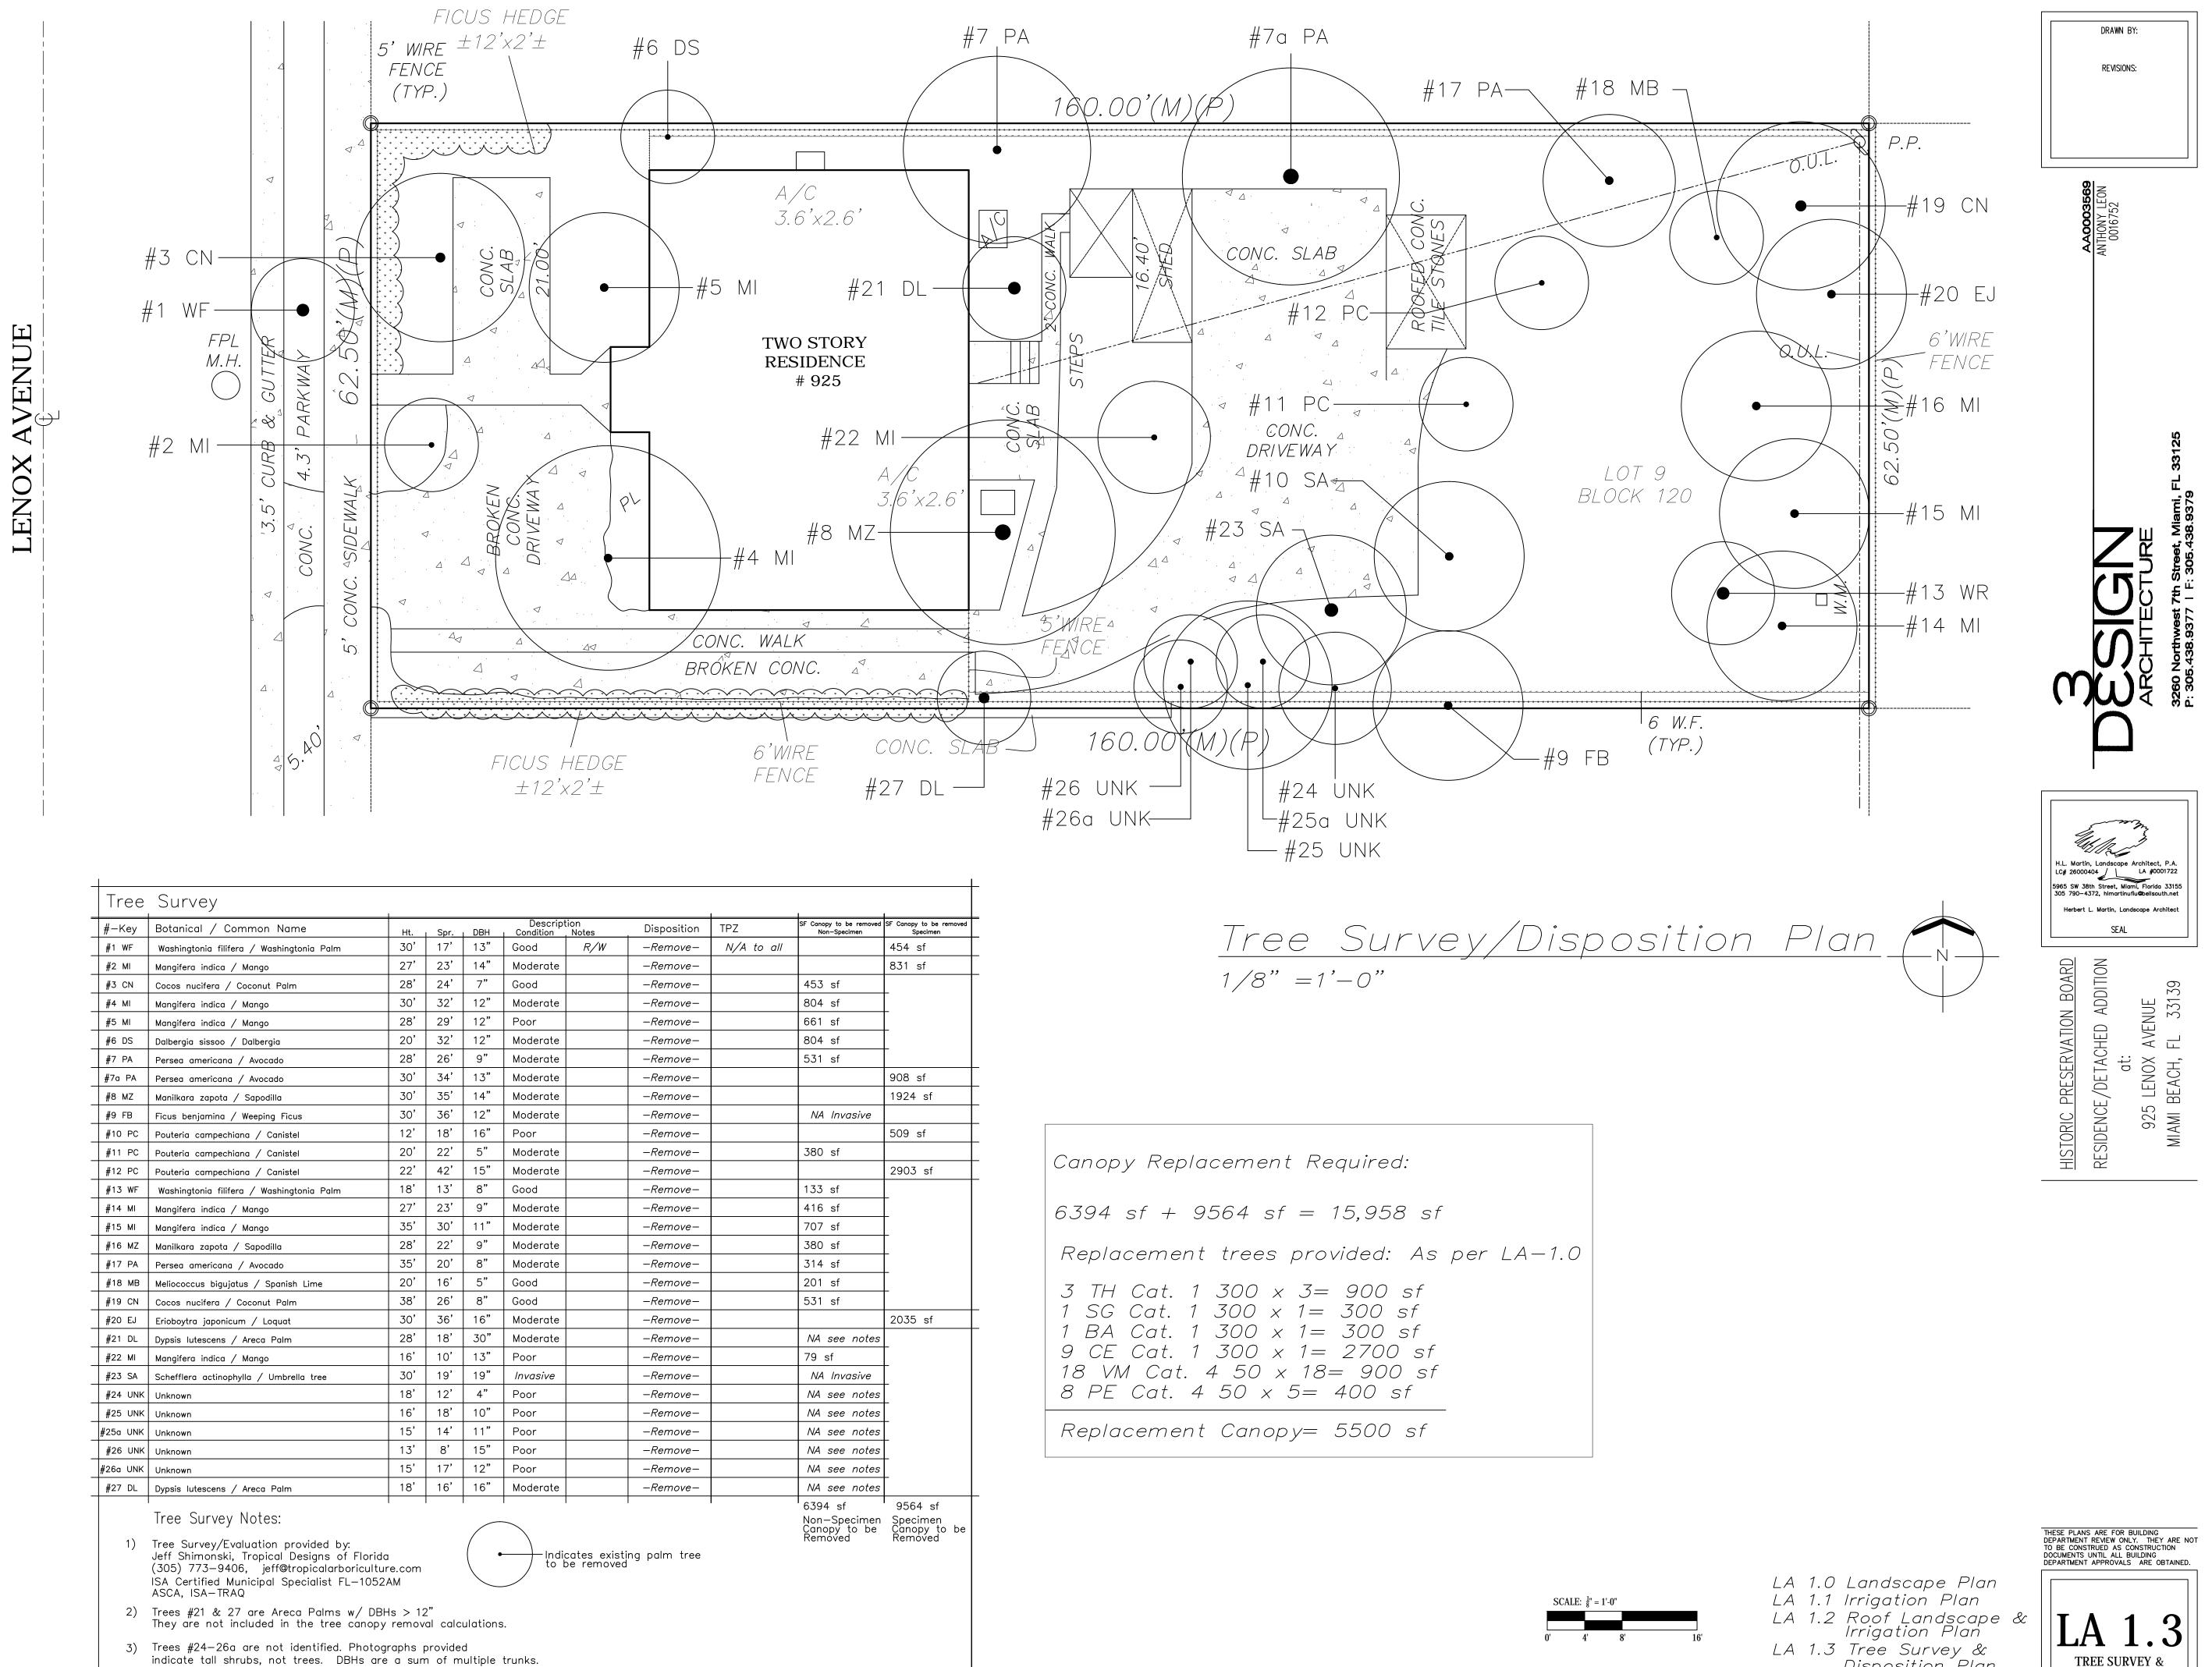

#−Key	Botanical / Common Name	Ht.	Spr
#1 WF	Washingtonia filifera / Washingtonia Palm	30'	17'
#2 MI	Mangifera indica / Mango	27'	23'
#3 CN	Cocos nucifera / Coconut Palm	28'	24'
#4 MI	Mangifera indica / Mango	30'	32'
#5 MI	Mangifera indica / Mango	28'	29'
#6 DS	Dalbergia sissoo / Dalbergia	20'	32'
#7 PA	Persea americana / Avocado	28'	26'
#7a PA	Persea americana / Avocado	30'	34'
#8 MZ	Manilkara zapota / Sapodilla	30'	35
#9 FB	Ficus benjamina / Weeping Ficus	30'	36
#10 PC	Pouteria campechiana / Canistel	12'	18'
#11 PC	Pouteria campechiana / Canistel	20'	22
#12 PC	Pouteria campechiana / Canistel	22'	42
#13 WF	Washingtonia filifera / Washingtonia Palm	18'	13'
#14 MI	Mangifera indica / Mango	27'	23
#15 MI	Mangifera indica / Mango	35'	30
#16 MZ	Manilkara zapota / Sapodilla	28'	22
#17 PA	Persea americana / Avocado	35'	20
#18 MB	Meliococcus bigujatus / Spanish Lime	20'	16'
#19 CN	Cocos nucifera / Coconut Palm	38'	26
#20 EJ	Erioboytra japonicum / Loquat	30'	36
#21 DL	Dypsis lutescens / Areca Palm	28'	18'
#22 MI	Mangifera indica / Mango	16'	10'
#23 SA	Schefflera actinophylla / Umbrella tree	30'	19'
#24 UNK	Unknown	18'	12'
#25 UNK	Unknown	16'	18'
#25a UNK	Unknown	15'	14'
#26 UNK	Unknown	13'	8'
#26a UNK	Unknown	15'	17'
#27 DL	Dypsis lutescens / Areca Palm	18'	16'
	Tree Survey Notes:	·	

indicate tall shrubs, not trees. DBHs are a sum of multiple trunks. They are not included in the tree canopy removal calculations.

HISTORIC PRESERVATION BOARD FINAL SUBMITTAL 11.05.2018

Disposition Plan

DISPOSITION PLAN

SHT. 4 of 4