REQUEST FOR DRB APPROVAL FOR: ESTEFANO ISAIAS RESIDENCE

2324 NORTH BAY ROAD, MIAMI BEACH, FLORIDA 33140



CLIENT

ESTEFANO ISAIAS 2324 NORTH BAY ROAD MIAMI BEACH, FLORIDA 33140

ARCHITECT

CHOEFF LEVY FISCHMAN ARCHITECTURE + DESIGN 8425 BISCAYNE BLVD. SUITE 201 MIAMI, FL 33138 (305) 434-8338

LANDSCAPE ARCHITECT

ROSENBERG GARDNER DESIGN 17670 NW 78th Avenue, Suite 214 Míamí, FL 33015 (305)392-1016

SCOPE OF WORK


REQUEST FOR DRB APPROVAL FOR THE PROPERTY LOCATED AT 2324 NORTH BAY ROAD, MIAMI BEACH, FL.

WAIVERS:

- REQUEST FOR WAIVER TO EXCEED THE 70% SECOND TO FIRST FLOOR RATIO.
- 2. REQUEST TO WAIVE THE ELEVATION REQUIREMENTS FOR THE OPEN-SPACE COURTYARD.

REQUEST FOR DRB APPROVAL FOR: ESTEFANO ISAIAS RESIDENCE

2324 NORTH BAY ROAD, MIAMI BEACH, FLORIDA 33140

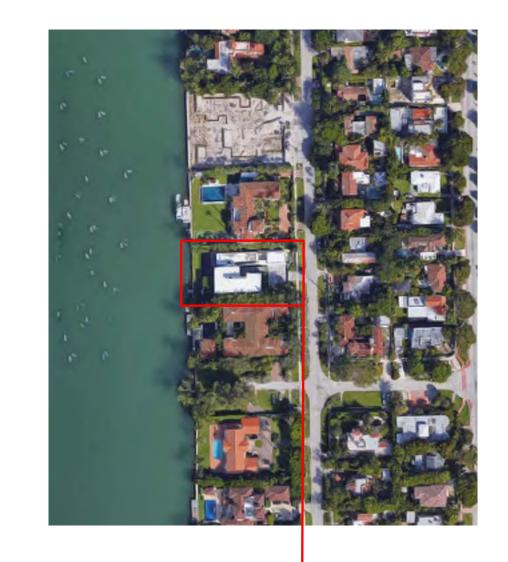



INDEX OF DRAWINGS

FINAL DRB SUBMITAL

JANUARY 2, 2018

COVER PAGES/ CONTEXT

INDEX OF DRAWINGS + LOCATION MAP PHOTOGRAPHIC JOURNAL CONT'D C-2.1 PHOTOGRAPHIC JOURNAL CONT'D

C-22 CONTEXT PHOTOS C-3.0 CONTEXT ANALYSIS - CONTEXTUAL ELEVATION C-4.0 MASSING STUDIES

ARCHITECTURAL

A-02 ZONING DATA SHEET EXISTING CALCS - SECOND TO FIRST FLOOR RATIO EXISTING CALCS - UNIT SIZE EXISTING CALCS - LOT COVERAGE & ROOF CALCS EXISTING CALCS - FRONT & REAR YARD PROPOSED CALCS - SECOND TO FIRST FLOOR RATIO PROPOSED CALCS - UNIT SIZE PROPOSED CALCS - LOT COVERAGE & ROOF CALCS PROPOSED CALCS - FRONT & REAR YARD SITE PLAN FIRST FLOOR PLAN SECOND FLOOR PLAN ROOF PLAN FRONT ELEVATION A-4.0a REAR ELEVATION RIGHT ELEVATION A-4.1a LEFT ELEVATION FRONT RENDERED ELEVATION A-5.0a REAR RENDERED ELEVATION

WAIVER DIAGRAM - UNINTERRUPTED TWO STORY ELEVATION

LANDSCAPING (EXISTING TO REMAIN)

EXISTING TREE DISPOSITION PLAN PLANTING PLAN LANDSCAPE SPECIFICATIONS & PLANT LIST L-2.1 IRRIGATION PLAN

IRRIGATION NOTES & DETAILS

GRAPHICS

G-2.0 FRONT WEST RENDERING (PROPOSED) G-2.0a FRONT WEST RENDERING (EXISTING) BACK EAST RENDERING (PROPOSED)

A-5.1a SIDE RENDERED ELEVATION

SIDE RENDERED ELEVATION

A-6.0 SIDE YARD DIAGRAMS A-7.0 WAIVER DIAGRAM - SECOND TO FIRST FLOOR RATIO

G-10 AXONOMETRICS

G-2.1a BACK EAST RENDERING (EXISTING)



GRAPHIC SCALE (IN FEET) 1 INCH = 30 FT.

MAP OF BOUNDARY SURVEY

LOCATION MAP

SECTION 27, TOWNSHIP 53 SOUTH, RANGE 42 EAST LYING AND BEING IN MIAMI-DADE COUNTY FLORIDA (NOT TO SCALE)



SURVEYOR'S CERTIFICATION:

SIGNED

ARTURO MENDIGUTIA,\@.SM.~

THE BEST OF MY KNOWLEDGE AND BELIEF THAT THIS "MAP OF BOUNDARY SURVEY" IS

A TRUE AND CORRECT REPRESENTATION OF A SURVEY PREPARED UNDER MY DIRECTION.

THAT IT MEETS THE STANDARDS OM PRACTICE AS SET FORTH BY THE STATE OF FLORIDA BOARD OF PROFESSIONAL LAND SURVEYORS IN CHAPTER 5J-17.050 THROUGH

5J-17.052 OF THE FLORIA ADMINISTRATIVE CODE AND ITS IMPLEMENTING LAW, PURSUANT TO CHAPTER 42,02 FLORIDA STATUTE.

NOT VALID WITHOUT THE SIGNATURE AND THE ORIGINAL RAISED SEAL OF A FLORIDA LICENSED SURVEYOR AND MORPER ADDITIONS OF DELETIONS TO SURVEY MAPS OR

REPORTS BY OTHER THAN THE SOME OF ARTY OR PARTIES IS PROHIBITED WITHOUT

AUTHENTIC ELECTRONIC SIGNATURE AND AUTHENTICATED ELECTRONIC SEAL.

WRITTEN CONSENT OF THE SKINING PARTY OF PARTIES AND/OR NOT VALID WITHOUT AN

LANDMARK SURVEYING & ASSOCIATES, INC.

LB No. 7633

PROFESSIONAL SURVEYORS AND MAPPERS 1435 S.W. 87th AVENUE, SUITE "201" MIAMI, FL 33174

PHONE: (305) 556-4002 FAX: (305) 556-4003 WWW.LMSURVEYING.COM

EMAIL-LANDMARKSURVEYING@HOTMAIL.COM

ABBREVIATIONS AND LEGEND

=DENOTES AIR CONDITIONING UNIT B.B. =DENOTES BASIS OF BEARINGS **ASPH** =DENOTES ASPHALT =DENOTES PROPERTY LINE =DENOTES BENCH MARK =DENOTES CONCRETE BLOCK STUCCO =DENOTES CONCRETE =DENOTES LIGHT POLE =DENOTES CATCH BASIN =DENOTES CENTERLINE =DENOTES MONUMENT LINE =DENOTES LAKE & MAINTENANCE =DENOTES DRAINAGE EASEMENT =DENOTES RECORD =DENOTES WOOD POWER POLE =DENOTES UTILITY EASEMENT =DENOTES PLAT BOOK P.B. PG. =DENOTES PAGE P.C.P. =DENOTES PERMANENT CONTROL =DENOTES POINT OF BEGINNING TYP. =DENOTES TYPICAL =DENOTES MEAN HIGH WATER LINE =DENOTES WOOD FENCE =DENOTES CHAIN LINK FENCE =DENOTES IRON FENCE =DENOTES FOUND IRON PIPE (NO ID. =DENOTES FOUND NAIL AND DISC =DENOTES ASPHALT PAVEMENT

ALL BEARINGS AND DISTANCES SHOWN HEREON ARE RECORD AND MEASURED UNLESS OTHERWISE NOTED.

=DENOTES ELEVATIONS

=DENOTES CONCRETE PAD

=DENOTES BRICK

26 7 01		FLOOD Z	ONE:		AE
3.01		ELEVATIO	ON:	8.0) FEET
	\	COMMUNI	TY:	12	20651
	SURVE	PANEL:	•	1208	36C0317
	JR	DATE OF F	FIRM:	09-	11-2009
	S	SUFFIX	•		L
	RY	ORIGINAL F WORK SUR DATE		09-2	22-2018
	BOUNDARY	BENCH M.	ARK:		N/A
	N	ELEVATI	ON:		N/A
I HEREBY CERTIFY TO HIS "MAP OF BOUNDARY SURVEY" IS	BC	DATE		AWN BY	SCALE
RVEY PREPARED UNDER MY DIRECTION. SET FORTH BY THE STATE OF ORS IN CHAPTER 5J—17.050 THROUGH)F	09-24-2018	J.f	FEE	1"=30'
AND ITS IMPLEMENTING LAW,	РС	REVISION /	UPD,	ATE OF	SURVEY
FOR THE FIRM	A	DATE		DESCF	RIPTION
P.S.M. No. 5844—STATE OF FLORIDA	MA	N/A		N	/A
GINAL RAISED SEAL OF A FLORIDA DELETIONS TO SURVEY MAPS OR			JOB	No.	
PARTIES IS PROHIBITED WITHOUT					

1809-135

LEGAL DESCRIPTION:

LOT 2, BLOCK 12, OF "AMENDED PLAT OF SUNSET LAKE SUBDIVISION", ACCORDING TO THE PLAT THEREOF, AS RECORDED IN PLAT BOOK 8, AT PAGE 52, OF THE PUBLIC RECORDS OF MIAMI-DADE COUNTY, FLORIDA.

CERTIFIED TO:

THIS BOUNDARY SURVEY HAS BEEN PREPARED FOR THE EXCLUSIVE USE OF THE ENTITIES NAME HEREON. THE CERTIFICATIONS DO NOT EXTEND TO ANY UNNAMED PARTIES.

- ESTAFANO ISAIAS

SURVEYOR'S NOTES:

1.) THE ABOVE CAPTIONED PROPERTY WAS SURVEYED AND DESCRIBED BASED ON THE ABOVE LEGAL DESCRIPTION: PROVIDED BY CLIENT.

2.) THIS CERTIFICATION IS ONLY FOR THE LANDS AS DESCRIBED. IT IS NOT A CERTIFICATION OF TITLE, ZONING, EASEMENTS, OR FREEDOM OF ENCUMBRANCES. ABSTRACT NOT REVIEWED.

3.) THERE MAY BE ADDITIONAL RESTRICTIONS NOT SHOWN ON THIS BOUNDARY SURVEY THAT MAY BE FOUND IN THE PUBLIC RECORDS OF HIS COUNTY, EXAMINATION OF ABSTRACT OF TITLE WILL HAVE TO BE MADE TO DETERMINE

RECORDED INSTRUMENTS, IF ANY AFFECTING THIS PROPERTY.

4.) ACCURACY: THE EXPECTED USE OF THE LAND, AS CLASSIFIED IN FLORIDA MINIMUM TECHNICAL STANDARDS (5J-17.51FAC), IS "RESIDENTIAL". THE MINIMUM RELATIVE DISTANCE ACCURACY FOR THIS TYPE OF BOUNDARY SURVEY IS 1 FOOT IN 7,500 FEET. THE ACCURACY OBTAINED BY MEASUREMENT AND CALCULATION OF A CLOSED GEOMETRIC FIGURE WAS FOUND TO EXCEED THIS REQUIREMENT. 5.) FOUNDATIONS AND/OR FOOTINGS THAT MAY CROSS BEYOND THE BOUNDARY LINES OF THE PARCEL HEREIN DESCRIBED ARE NOT SHOWN.

6.) TYPE OF SURVEY: BOUNDARY SURVEY 7.) ELEVATIONS SHOWN HEREON ARE BASED ON TO THE NATIONAL GEODETIC VERTICAL DATUM OF 1929 (N.G.V.D.29)

8.) ALL MEASUREMENTS ARE IN ACCORDANCE WITH THE UNITED STATES STANDARD U.S. FOOT

9.) CONTACT THE APPROPRIATE AUTHORITY PRIOR TO ANY DESIGN WORK ON THE HEREIN DESCRIBED PARCEL FOR BUILDING AND ZONING INFORMATION. 10.) UNDERGROUND UTILITIES ARE NOT DEPICTED HEREON, CONTACT THE APPROPRIATE AUTHORITY PRIOR TO ANY DESIGN WORK OR CONSTRUCTION ON THE PROPERTY HEREIN DESCRIBED. SURVEYOR SHALL BE NOTIFIED AS TO ANY

DEVIATION FROM UTILITIES SHOWN HEREON. 11.) ENCUMBRANCES NOT SHOWN ON THE PLAT.

12.) THE WRITTEN CONSENT OF LANDMARK SURVEYING & ASSOCIATES, INC. UNDERGROUND PORTIONS OF FOOTING, FOUNDATIONS OR OTHER IMPROVEMENTS WERE NOT LOCATED.

13.) ONLY VISIBLE AND ABOVE GROUND ENCROACHMENTS LOCATED.

14.) WALL TIES ARE TO THE FACE OF THE WALL.

15.) FENCE OWNERSHIP NOT DETERMINED.

INCH EQUALS 30 FEET OR SMALLER.

16.) BEARINGS REFERENCED TO LINE NOTED AS B.R.


17.) BOUNDARY SURVEY MEANS A DRAWING AND/OR GRAPHIC REPRESENTATION OF THE SURVEY WORK PERFORMED IN THE FIELD.

18.) NO IDENTIFICATION FOUND ON PROPERTY CORNERS UNLESS NOTED. 19.) THE SOURCES OF DATE USED FOR THE PREPARATION OF THIS BOUNDARY

SURVEY IS "AMENDED PLAT OF SUNSET LAKE SUBDIVISION" RECORDED IN PLAT BOOK 8, AT PAGE 52. 20.) THIS MAP OF SURVEY IS INTENDED TO BE DISPLAYED AT A SCALE OF ONE

FOLIO NO. 02-3227-008-0680

AREA OF PROPERTY: 20,000 SQUARE FEET AND/OR

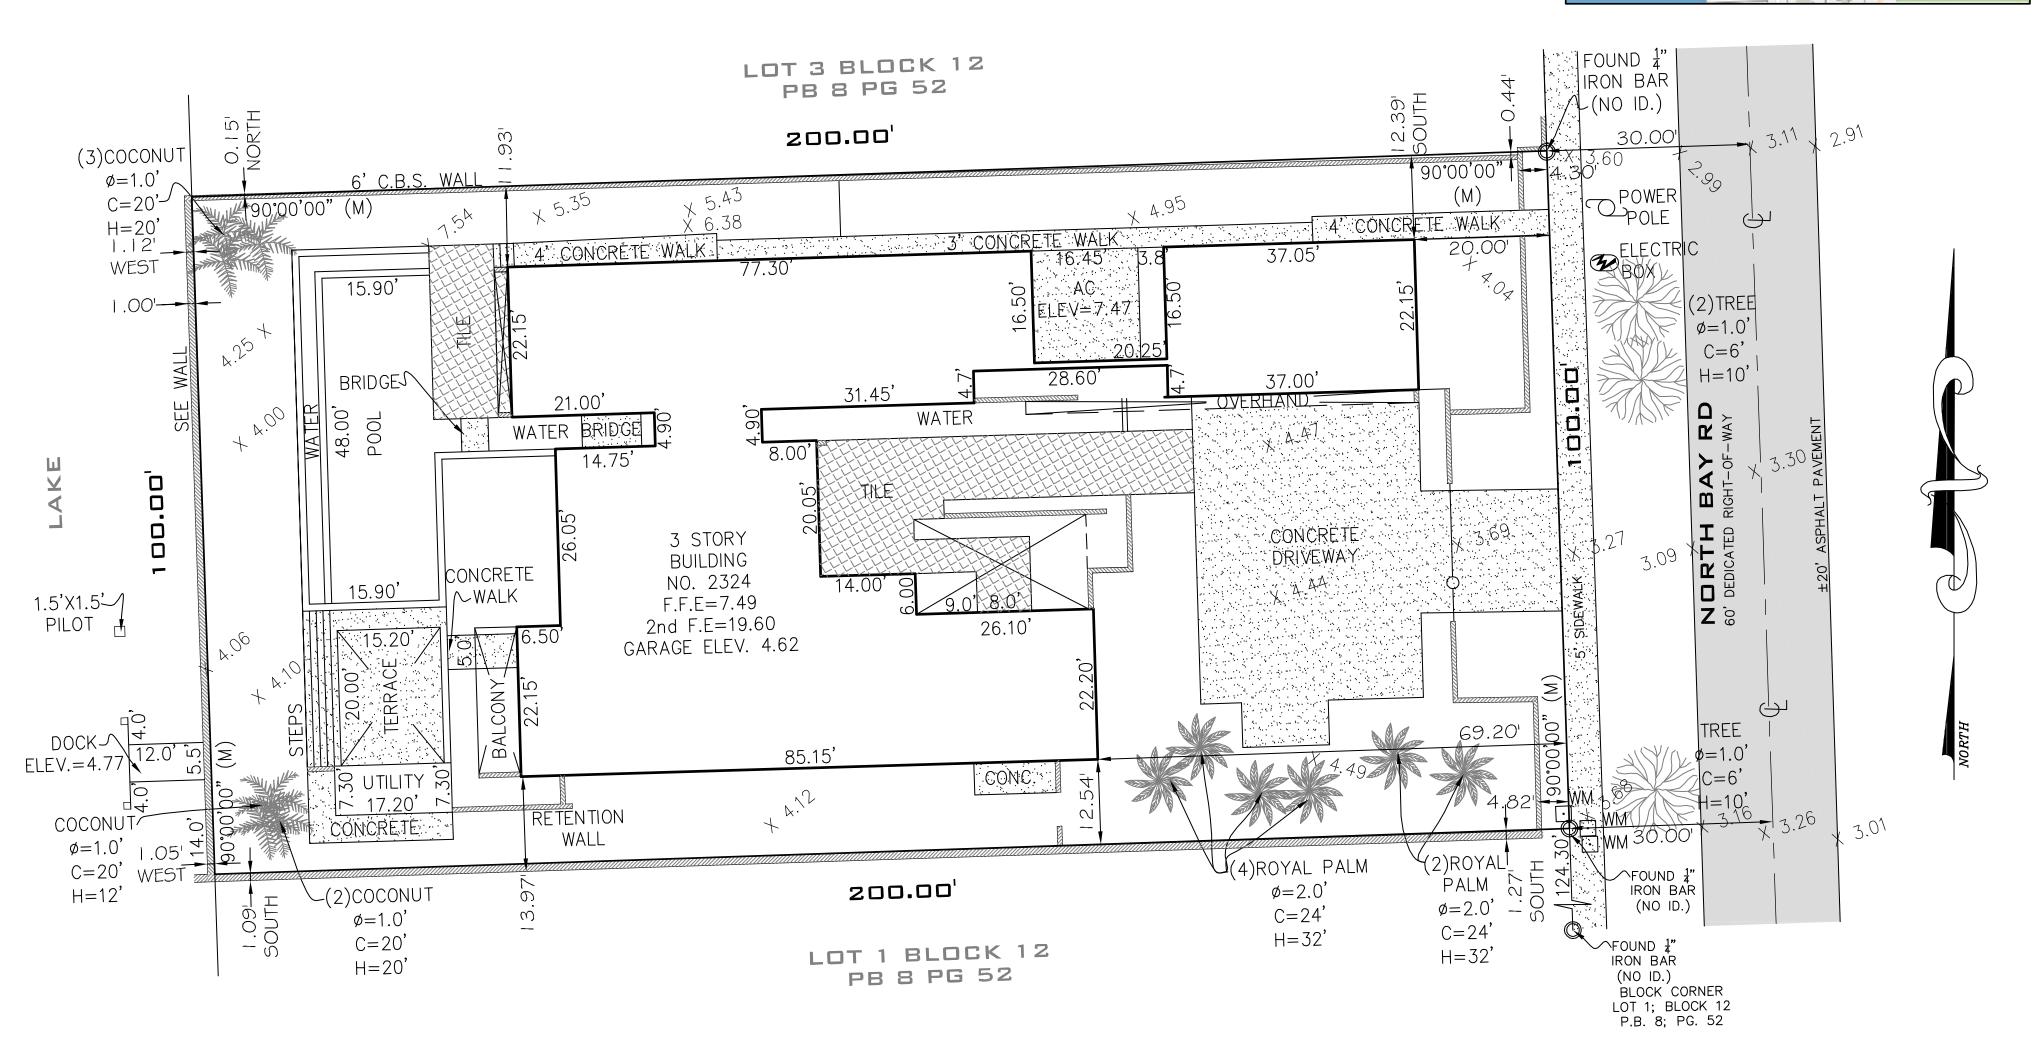


PROPETY ADDRESS:

2324 N BAY RD

MIAMI BEACH, FL 33140-4261

0.459 ACRES MORE OR LESS

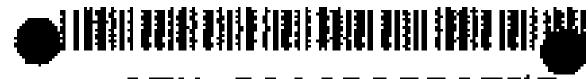

OF Di 2010RO520579 OR Di 27374 fas 0701 · 7054 (5pas) RECERDEO 08/03/2010 11/48:24 HARVEY RUVISE. CLERK OF COURT MIAMI-DADE COUNTY: FLORIDA

DESIGN REVIEW BOARD City of Miami Beach, Florido

MEETING DATE:

July 6, 2010

FILE NO:

22823



PROPERTY:

2324 North Bay Road

LEGAL;

Lot 2, Black 12, Amonded Plat of Sunsat Lake Subdivision, According to the Plat Thereof, as Recorded in Plat Book 8, Paga 52, of the Public

Rocords of Mionsi-Dade County, Ftorido.

IN RE-

The Application for Design Roview Approval for the concruction of einaw 2-otory home, which replace on axisting 2-story pre-1942 enchitochuratty

eignificant home, to be demolished.

ORDER

The applicant, Estotano toios, tited on application with the City of Mromi Beach Planping Deportment for Design Review Approvel.

The City of Miamir Beech Doorgn Reviow Soord makes the fallowing FINDINGS OF FACT, *..... based upon the evidenco, intormetion, testimeny and metorials presented at the public hoaring and which ore part of the record for this matten

- Based on the plans and documents submitted with the opptication, testimony and intormation provided by the applicant, and the raesone set torth in the Planning Deportment Staff Report, the project or submitted is not consistent with Decign Review Criterie 3-7, 10 & 12 in Section 118-25", of the Milomi Beoch Codo.
- The project would be considered with the critoria and requirements of section 118-251 it the following conditions ore mot:
 - Ravisad elevation, exterplon and floor plan drewings chall be submitted to and opproved by stoff; at a minimum, such drewngo of all incorporate the following.
 - to occerdance with Section 142-108(d與1) of the City Code, e demostion permit tor the existing home shall not be issued untitle full building permit for now concernation has been isough.
 - The deelgn of tha north and couth elevations e! the mein home shell be. furthor dovetoped and dotailed, including the introduction of edditional tonestration to holp visually brack-up the mesoivenaes et theco olevetiono, in o mannor to bo reviowed and opproved by oteff.
 - The decign of the south elevation of the proposed cabane objecture sholt be turthor developed and detailed to include added fencotration or the

CERTIFICATION THE REPORT OF A PROPERTY OF A PROPERTY OF THE PARTY OF TH IS A STRUE WAS ABOUNDED FOR DAY THE DISCHALL OF

FLE AN TIME DIFFICE OF THE PLANTAGE DEPARTMENT.

OF THE STATE OF THE PLANTAGE DEPARTMENT.

De Completate (affine (Sele)

This department to the Same



Page 2 of 5 Meeting Dote: July 6, 2010 DRB Filo No. 22823

introduction of a colid vaneer, such so the limestone proposed etcowhere. en the hemo, in e mennor to be reviewed and approved by ctaff.

- Monutacturers drewings and Dedo County product approval numbers for ail new windowo, doore and glood shall be required, prigate the isouence. of a building permit.
- All toof-top fotution, air-conditioning unito one machonical davices challbe cloorly noted en elrevised roes plan and shalt be ocreaned from view, in a menner to be opprovad by stoff.
- Prior to the issuance of a Cestificate of Occupancy, the project Architect sholl verify, in writing, that the oubject project hed been censtructed in occordance with the plane approved by the Planning Department tor-Buitding Pormit.
- A revised tandocapo ptan, and corresponding cite plon, shatt be submitted to and approved by otaff. The species type, quentify, dimensions, specing, io**cation**, end overall height of oil ptent material chair be closely definested and subject to the reviow and opprovat of staff. At a minimum, such plan onell incompraise the .*** fotlowing:
 - Street treeo shatt be roquired within the swele at the frent of the preparty, in a manner te be roviowed and coordinated by otoff.
 - A fully eutometic Irrigetion system with 100% coverage and an outomotic 🖫 🔩 🍰 rain censor in order to rendor the cyclem inoperative in the overthe tribain. Right-ot-way areac chail also be incerperated as part of the irigation. oystem.
 - The utitization of root barriors and/or structure) soit, ea eppliceble, shall be cloarly dolineated on the revised lendscape plan.
 - The applicant sholl vorify, prior to the issuance of a Building Permit, the exact location of ell backflew preventors end oil: other related devices and Exturac; each fixtures and daviced shalf not he permitted within any required yeard or any area fronting electron or oldewark. The location of beaktiew preventors, siemese pipoo or other related devices and tixtures, it ony, and how they are occaned with landscape meterie? from the rightof-woy, onet be clearly indicated on the oits and lendocape plans and នុងម្យាំ ២៩ subject to the review and approval of staff...
 - The applicant enettivesify, prior to the isouence of a Building Permit, the exact location of all opplicable FPL transformers or youth rooms; such transformors and vault rooms, and all other releted devices and fixtures, shell not be permitted within only roquired yard or any orola fronting or street or ordowolk. The rocation of enviousor trensfermers, and how they are ecreaned with tendscape motoriol from the right-of-way, shall be ು ವಿleorly indicated on the cite and landocapo plans and shall bo ಕಬರಿಕೆಲು to the reviow end eppreval of staff.



sheet no.

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- Prior to the Issuence of a Certificete of Occupency, the Lendscape Architect for the project erchitect shall verify, in writing, that the project is consistent with the site and lendecape prens approved by the Planning Department for Suitding Permit.
- 3. The fines exterior surface color scheme, including color eemples, ehelt be subject to the review and appreval of staff and shalt require a separate permit.
- 4. The finel building plans shell meet all other requirements of the Land Development Regulations of the City Code.
- The applicant may be required to submit a coparate analysis for water and sewer requirements, at the discretion of the Public Works Director, or designee. Based on a preliminary review of the proposed project, the following may be required by the Public Works Department:
 - e. Remove/replace eidewalks, curbs and guiters on all street frontages, if applicable. Unless otherwise specified, the standard color for city sidawalks is rad, and the elanderd outbland guiter color is grey. *****
 - b. Mitthesurface eephelt in reer eltey along property, if eppticable.
 - Provide underground utility service connections and on-site transformer location, if neseesery.
 - d. Provide back-flow prevention devices on ed weter services.
 - e. Provide on-site, self-contained sterm water drainage for the proposed development.
 - f. Meet weter/sewer concurrency requirements including a hydrautic water model analysis and gravity sewer system capacity analysis as determined by the Department and the required upgrades to water and sewer mains servicing this project.
 - g. Payment of City utility impact fees for water meters/services.
 - h. Provide flood berrier ramps to underground perking or minimum steb elevation to be at highest adjacent crown road elevation plus B1.
 - i. Right-of-way permit must be obtained from คนอดิต Works.
 - j. All right-of-wey ens-oechmente must be removed,
 - k. Alt plenting/lendsceping in the public right-of-way must be approved by the Public Wosks end Perks Depertments,
- 6. The project enall comply with any landscaping or other sidewelk/street impreventant standards as may be prescribed by a relevant tirben Design Meeter Plan appreved prior to the completion of the project and the issuance of a Certificate of Occupancy, in a manner to be reviewed and coordinated by stell.

- 7. The Final Order shell be recorded in the Public Records of Miami-Dede County, <u>psios</u> to the isevence of a Building Permit
- The Finel Order is not severable, end if any provision or condition hereof is held void or unconstitutional in a final decision by a court of competent jurisdiction, the order shell be returned to the Board for reconcideration as to whether the order meets the criteria for approvel obsent the stricken prevision or condition, and/or it is appropriate to modify the remaining conditions or impose new conditions.
- 5. The conditions of epotoval herein are binding on the applicant, the property's owners, operatore, and ell euccessors in interest and assigns.
- 10. Nething in this erder authorizes a vieletion of the City Code or other applicable lew, not allows a relexation of any requirement or standard eat forth in the City Code.

IT IS HEREBY ORDERED, based upon the foregoing findings of fect, the evidence, intermation, testimony and materiats presented at the public hearing, which are part of the recold for this matter, and the eteff roport and enatysis, which are adopted herein, including the stan recommendations which were adopted by the Board, that the Application for Design Review approved is GRANTED for the above-referenced project subject to those certain conditions appearance in Peragraph 8 of the Findings of Fact (Condition Nes. 1-10, including hereaf, to which the applicant has agreed.

PROVIDED the applicant shall build substantially in accordance with the plane approved by the Design Review Board, as determined by staff, antibed "Residence for Mr. Estafano Isaiea", as prepared by Ralph Choeff Architect, dated 3-19-20-0, modified in accordance with the conditions set torth in this Order and staff review and approval.

No building permit may be issued unless and until all conditions of approvel that must be setisfied prior to permit issuance as set forth in this Order have been met. The issuance of Design Review Approvel does not relieve the applicant from obtaining all other required Municipal, County end/or State reviews and permits, including final zoning approval, if adequate handicapped access is not provided on the Board-approved plans, this approval does not meen that such handicapped access is not required.

When requesting a building permit, the plans submitted to the Building Depertment for permit shall be consistent with the plans approved by the Board, modified in accordance with the conditions set torth in this Order.

the Full Building Permit for the project is not issued within eighteen (18) months of the meeting dete at which the original Design Review Approval was grented, the Design Review Approval will expare and become stull and void, unless the applicant makes application to the Board for an extension of time, in accordance with the requirements and procedures of Chapter 118 of the City Code; the granting of any such extension of time shall be at the discretion of the Board. At the hearing on any such application, the Board may deny are appreve the request and medify the above conditions or impose additional conditions. If the Full Building Permit should expire for any reason (including but not similar to construction net commercing and construing, with required inspections, in accordance with the applicable Building Code), the Design Review







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.....

Approval will expire and become null and void.

th accordance with Section 116-254 of the City Code, the violation of any conditions and saleguards that are a part of this Order shall be deemed a violation of the land development. regulations of the City Code.

Dated this

DESIGN REVIEW BOARD THE CITY OF MIAM! BEACH, FLORIDA

THOMAS R. MOONEY, AICP DESIGN AND PRESERVATION MANAGER

FOR THE CHAIR

STATE OF FLORIDA

COUNTY OF MIAMI-DADE

The foregoing instrument was acknowledged before me this \sqrt{f} 20_*lo*_by Thomas R. Mooney, Design and Preservation Manager,

Planning Department, City of Miami Beach, Florida, a Florida Municipal Corporation, on behalf of the Corporation. He is personally known to me.

the Michely Pothic State of Plancks


NOTARY PUBLIC

Miami-Dade County, Florida My commission expires:_ 3/20/2014

Approved As To Form: Legal Department:

Filed with the Clerk of the Design Review Board on "

E:\PLAM&OR@\DRB15\UU\JRB10\Z2823\\J10\Jp\deck

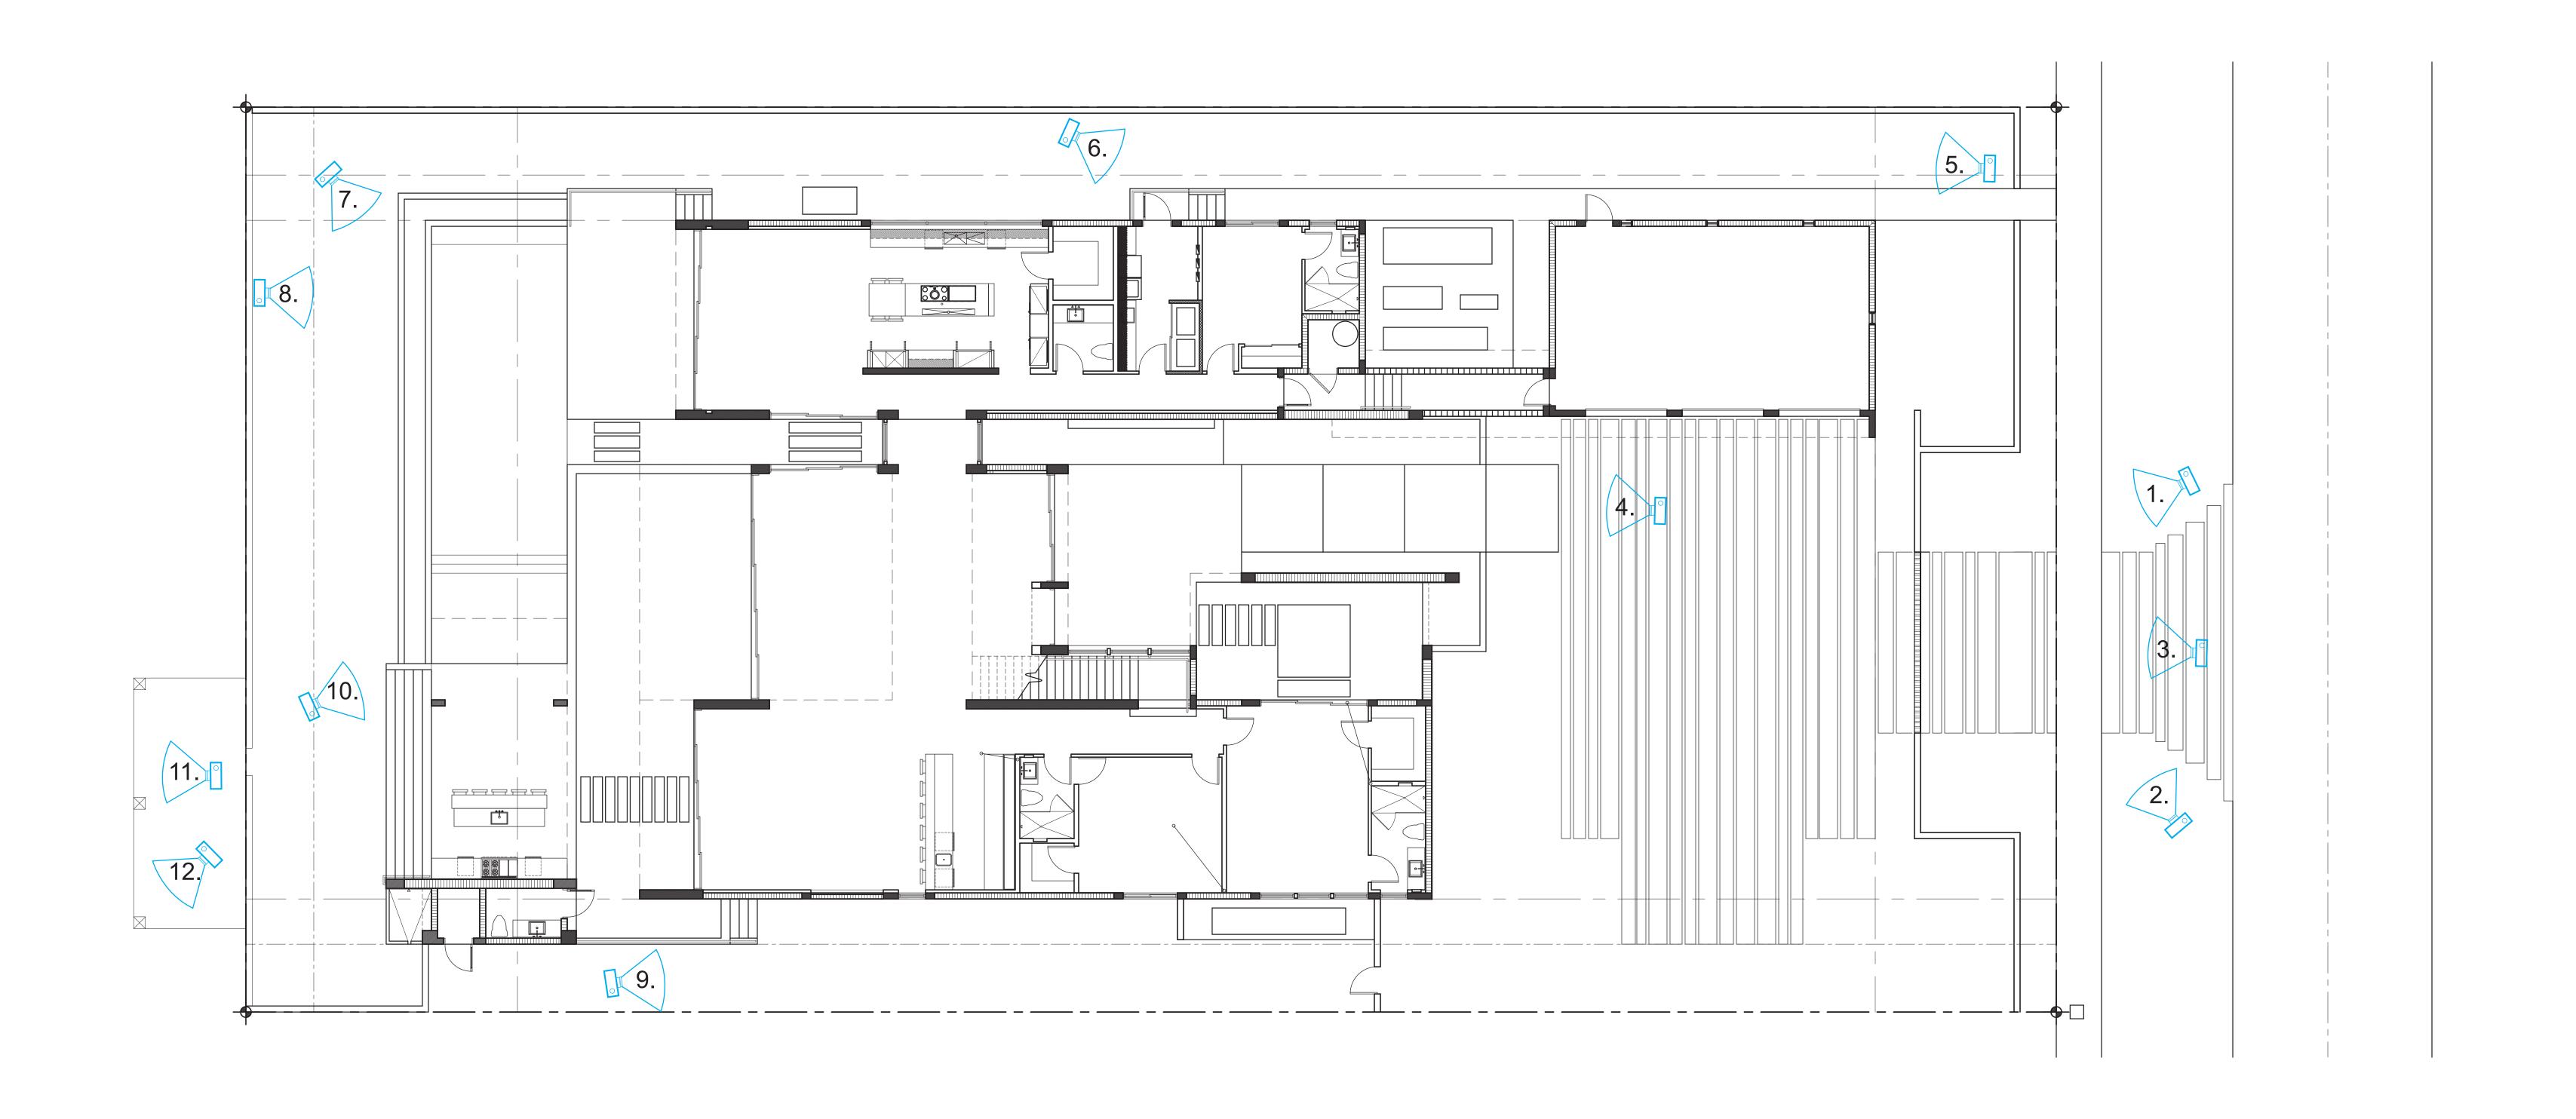



PHOTOGRAPH 1



PHOTOGRAPH 2



PHOTOGRAPH 3



PHOTOGRAPH 4



PHOTOGRAPH 5




PHOTOGRAPH 6



PHOTOGRAPH 7



PHOTOGRAPH 8

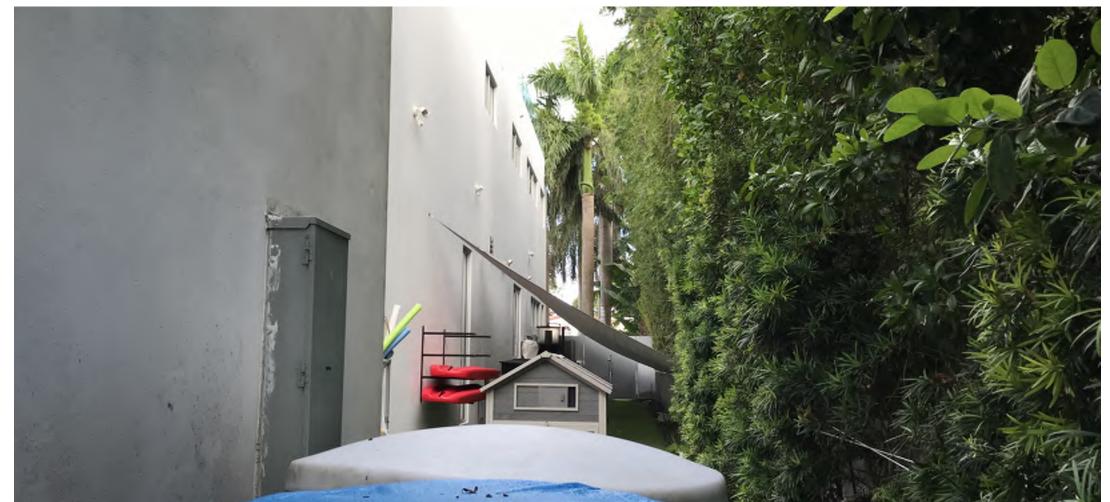

PHOTOGRAPH 9



PHOTOGRAPH 10





PHOTOGRAPH 11

PHOTOGRAPH 12



SITE (2324 NORTH BAY RD.)



RESIDENCE 3



AERIAL PHOTOGRAPH OF PROPERTY AND SORROUNDING PROPERTIES




AERIAL PHOTOGRAPH OF PROPERTY AND SORROUNDING PROPERTIES




RESIDENCE 1



RESIDENCE 4

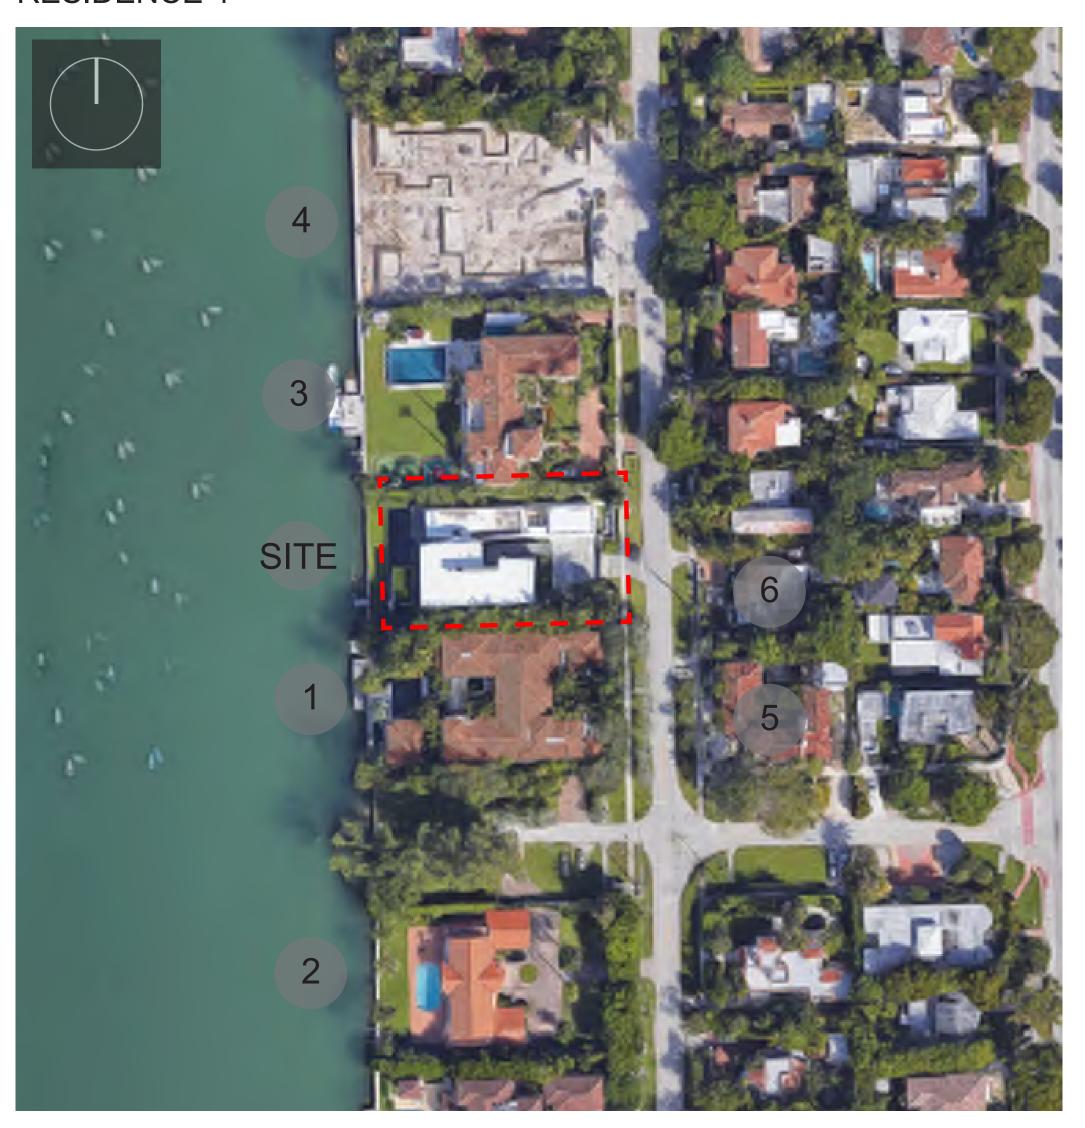

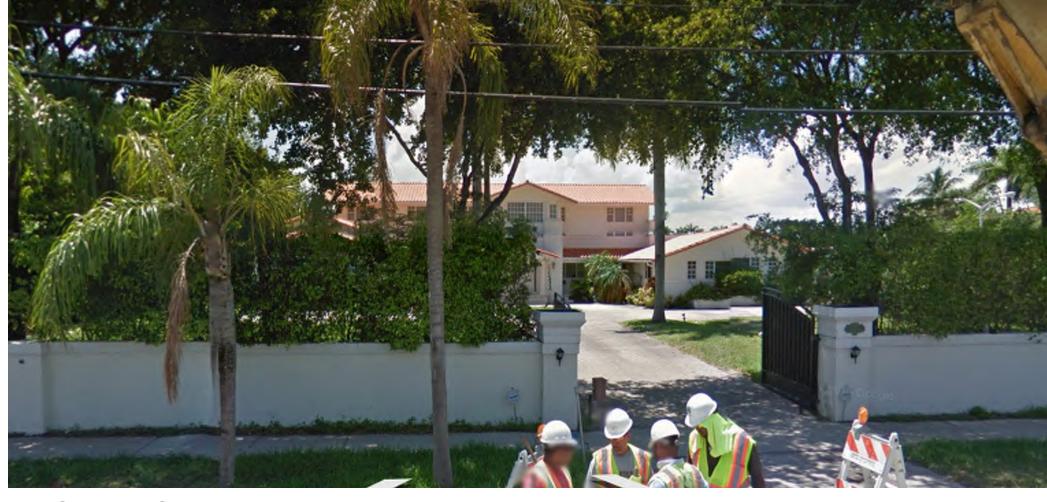


RESIDENCE 2



RESIDENCE 5



RESIDENCE 6

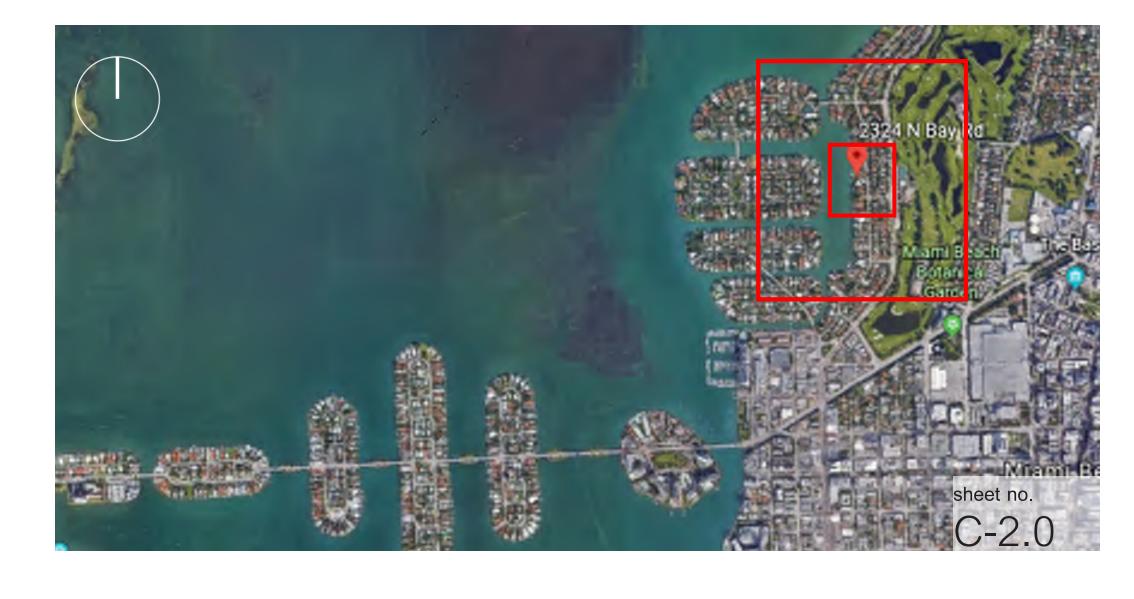



SUBJECT PROPERTY 1 (2324 NORTH BAY ROAD)



RESIDENCE 1



RESIDENCE 3




AERIAL PHOTOGRAPH WITH PROPOSED RESIDENCE INSERTED



AERIAL PHOTOGRAPH WITH PROPOSED RESIDENCE INSERTED



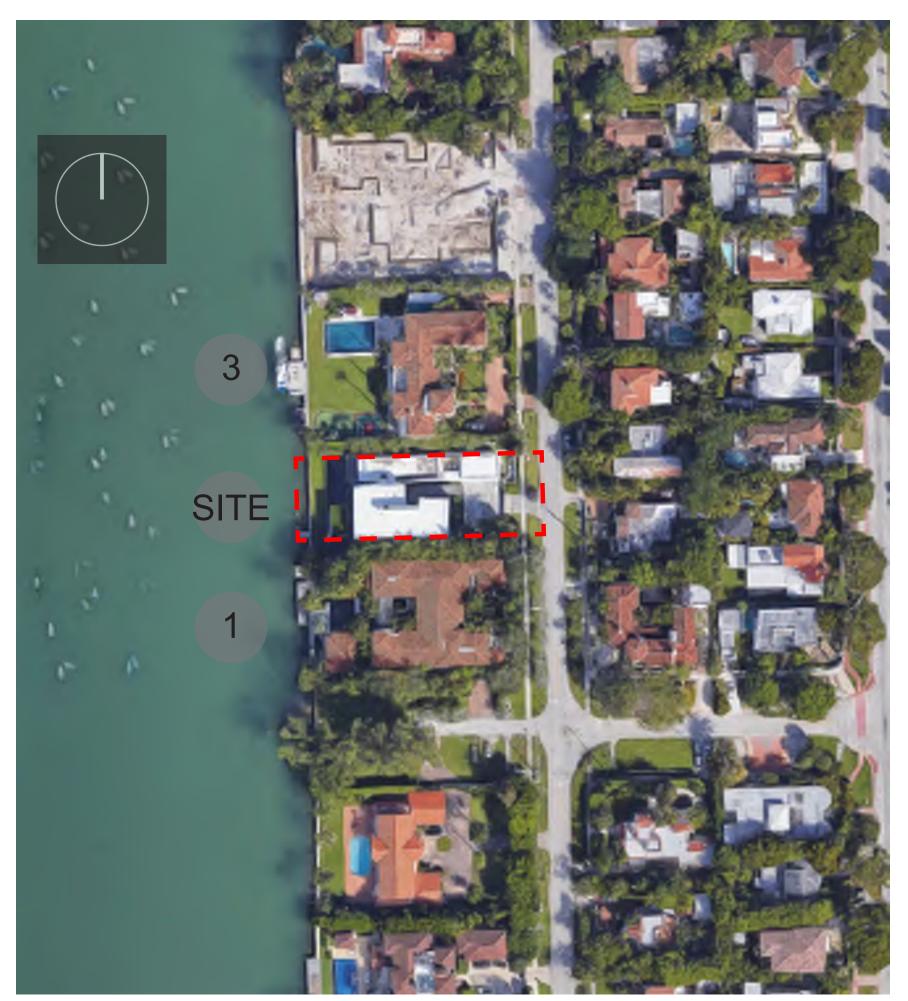

LOCATION MAP




MASSING STUDIES


RESIDENCE 1

ADJACENT PROPERTY - 2318 N BAY ROAD LOT SIZE: 24,860 SQ. FT.

AREA: 14,212 SQ. FT.

APPROXIMATE LOT COVERAGE: 57.2 % APP. FIRST-SECOND FLOOR RATIO: 78.5%

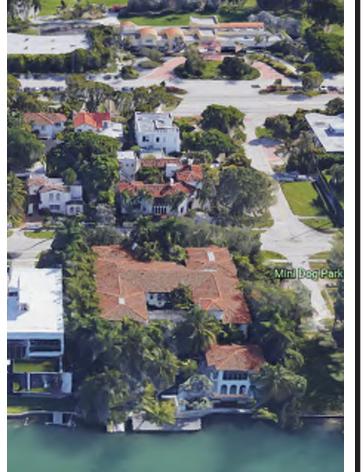

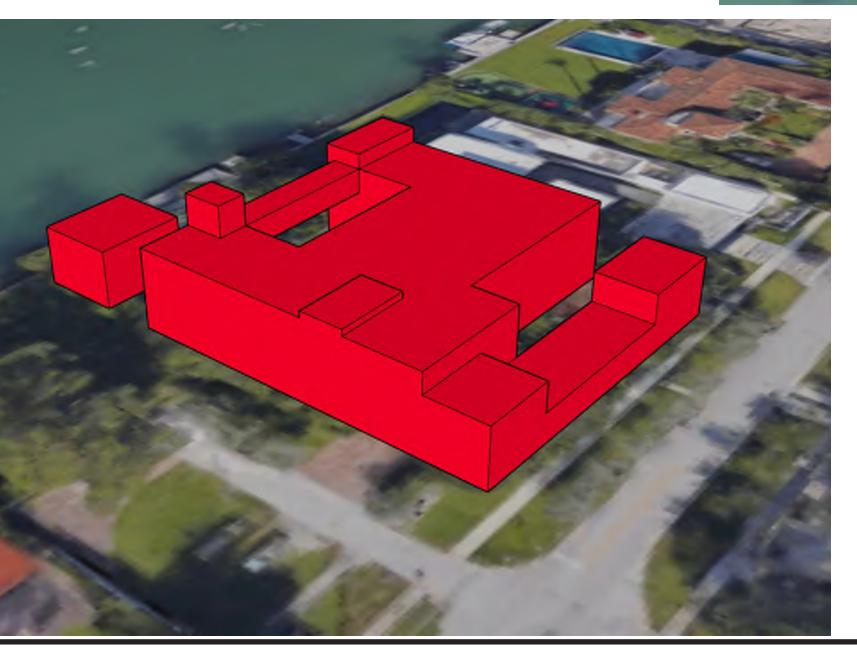



RESIDENCE 3

ADJACENT PROPERTY: 2344 N BAY ROAD LOT SIZE: 30,000 SQ. FT.

AREA: 9,631 SQ. FT.

APPROXIMATE LOT COVERAGE:32.1% FIRST-SECOND FLOOR RATIO: 88.7

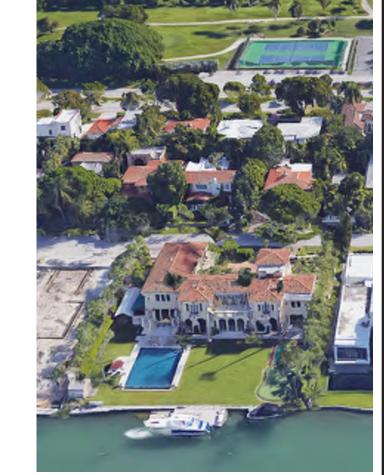

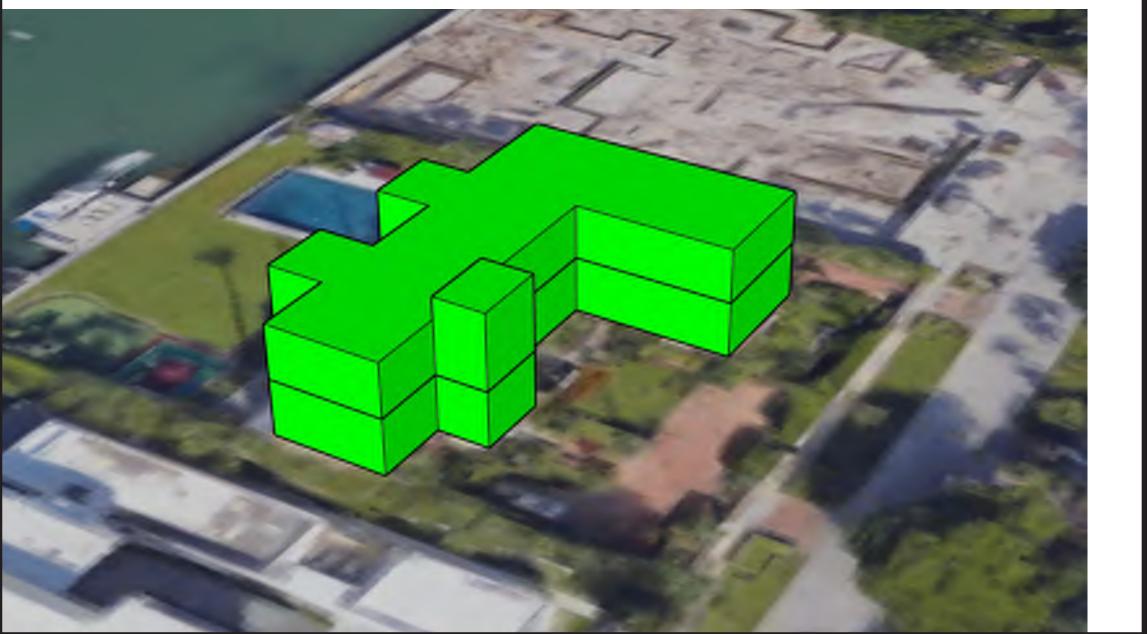

PROPOSED RESIDENCE SITE

2324 N BAY ROAD


LOT SIZE: 20,000 SQ. FT.

AREA: 6,786

LOT COVERAGE: 33.9%

FIRST-SECOND FLOOR RATIO: 97.4%



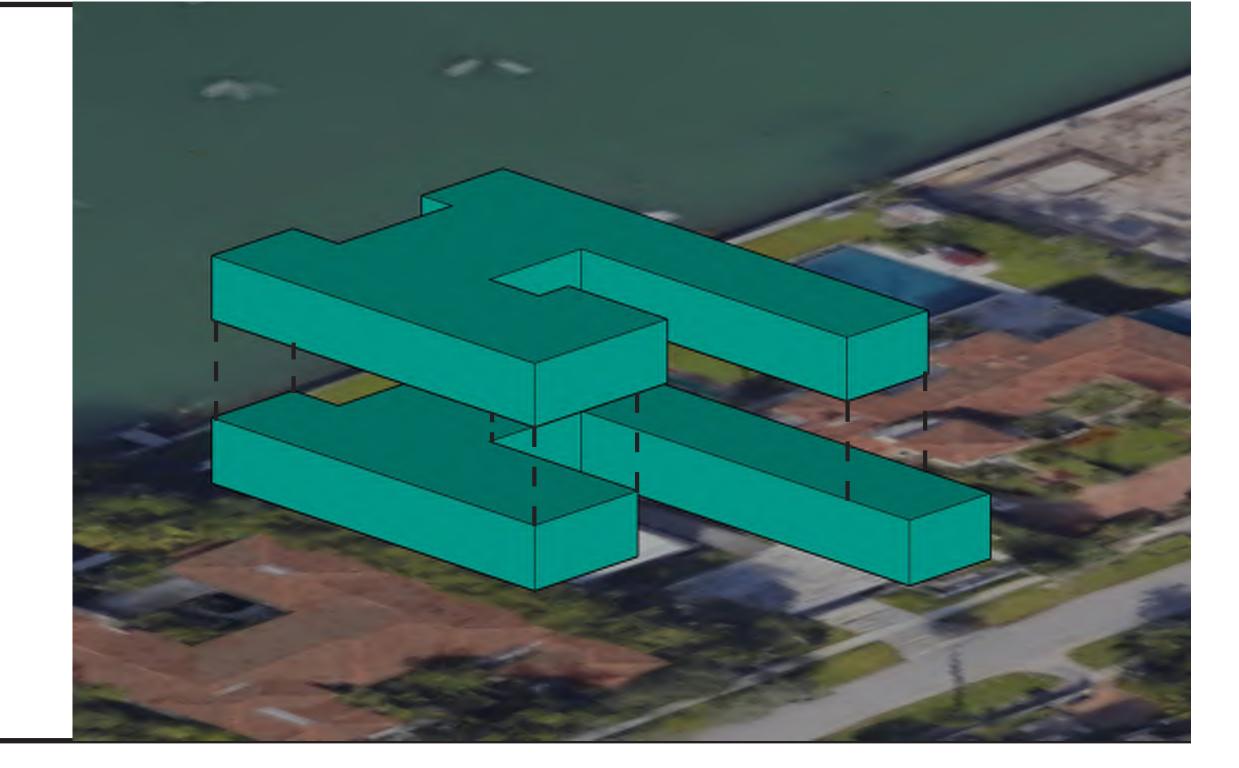

ITEM #	TEM # New Construction Floodplain Management Data		
1	Flood Zone:	AE +8	
2	FIRM Map Number	12086C0317L	
3	Base Flood Elevation (BFE):	8.00' NGVD	
4	Proposed Flood Design Elevation:		
5	Crown of Road Elevation:		
6	Classification of Structure:	Category II	
7	Building Use:	Single-Family Residence	

	SINGLE FAMILY RESIDENTIAL - ZONING DATA SHEET EXISTING CONDITIONS				
ITEM #	Zoning Information				
1	Address:	2324 North Bay Road Miami Beach, FL 33140			
		Legal Description: LOT 2, BLOCK 12, OF "AMENDED PLAT OF SUNSET LAKE SUBDIVISION", ACCORDING TO THE PLAT THEREOF, AS RECORDED IN PLAT BOOK 8, AT PAGE 52, OF THE PUBLIC RECORDS OF MIAMI-DADE COUNTY, FLORIDA			
2	Folio number(s):	02-3227-008-0680			
3	Board and file numbers :				
4	Year built:	2015	Zoning District:		RS-2
5	Based Flood Elevation:	AE 8.00	CMB grade value in NGVD:		+3.22' NGVD
6	Adjusted grade (Flood+Grade/2):	+5.61' NGVD	Free board:		+1'
7	Lot Area:	20,000 SF			
8	Lot width:	100'	Lot Depth:		200'
9	Max Lot Coverage SF and %:	6,000 SF (30%)	Lot Coverage SF and %:		6,786 SF (33.5%)
10	Front Yard Open Space SF and %:	1,451 SF (72.5%)	Rear Yard Open Space SF ar	nd %:	2,301 SF (76.7%)
11	Max Unit Size SF and %:	10,000 SF (50%)	Unit Size SF and %:		7,509 SF (37.5%)
12	First Floor Unit Size:	4,871 SF	Second Floor Unit Size:		2,530 SF
13	Cabana Unit Size:	108 SF			
14	Second to First Floor Ratio (not to exceed	58.2%	Second Floor Volumetric		2,530 SF
	70%, unless granted a waiver)		First Floor Volumetric		5,371 SF

		Required	Existing	Proposed	Deficiencie
17	Height:	24'-0" (28')	26'-4"	26'-4"	
18	Setbacks:				
19	Front First level:	20'-0"	20'-0"	20'-0"	
20	Front Second level:	30'-0"	48'-11"	41'-6"	
21	Side 1:	12'-6"	12'-6"	12'-6"	
22	Side 2 or (facing street):	12'-6"	12'-6"	12'-6"	
23	Rear:	30'-0"	43'-6"	43'-6"	
	Accessory Structure Side 1:		7'-6"	7'-6"	
24	Accessory Structure Side 2 or (facing street):		N/A	N/A	
25	Accessory Structure Rear:		19'-6"	19'-6"	
26	Sum of Side yard :	25'-0"	25'-0"	25'-0"	
27	Located within a Local Historic District?			Yes or no	
28	Designated as an individual Historic Single Family Residence Site?		Yes or no		
29	Determined to be Architecturally Significant?		Yes or no		
Notes	:				

		PROPOSED (CONDITIONS	
ITEM #	Zoning Information			
1	Address:	2324 North Bay Road Miami Beach, FL 33140		
		Legal Description: LOT 2, BLOCK 12, OF "AMENDED PLAT OF SUNSET LAKE SUBDIVISION", ACCORDING TO THE PLAT THEREOF, AS RECORDED IN PLAT BOOK 8, AT PAGE 52, OF THE PUBLIC RECORDS OF MIAMI-DADE COUNTY, FLORIDA		
2	Folio number(s):	02-3227-008-0680		
3	Board and file numbers :			
4	Year built:	2015	Zoning District:	RS-2
5	Based Flood Elevation:	AE 8.00	CMB grade value in NGVD:	+3.22' NGVD
6	Adjusted grade (Flood+Grade/2):	+5.61' NGVD	Free board:	+1'
7	Lot Area:	20,000 SF		
8	Lot width:	100'	Lot Depth:	200'
9	Max Lot Coverage SF and %:	6,000 SF (30%)	Lot Coverage SF and %:	6,786 SF (33.5%)
10	Front Yard Open Space SF and %:	1,451 SF (72.5%)	Rear Yard Open Space SF and %:	2,301 SF (76.7%)
11	Max Unit Size SF and %:	10,000 SF (50%)	Unit Size SF and %:	9,636 SF (48.2%)
12	First Floor Unit Size:	4,871 SF	Second Floor Unit Size:	4,657 SF
13	Cabana Unit Size:	108 SF		
14	Second to First Floor Ratio (not to exceed	97.4%	Second Floor Volumetric	5,234 SF
	70%, unless granted a waiver)	WAIVER REQUESTED	First Floor Volumetric	5,371 SF

SINGLE FAMILY RESIDENTIAL - ZONING DATA SHEET

		Required	Existing	Proposed	Deficiencies
17	Height:	24'-0" (28')	26'-4"	26'-4"	
18	Setbacks:				
19	Front First level:	20'-0"	20'-0"	20'-0"	
20	Front Second level:	30'-0"	48'-11"	41'-6"	
21	Side 1:	12'-6"	12'-6"	12'-6"	
22	Side 2 or (facing street):	12'-6"	12'-6"	12'-6"	
23	Rear:	30'-0"	43'-6"	43'-6"	
	Accessory Structure Side 1:		7'-6"	7'-6"	
24	Accessory Structure Side 2 or (facing street):		N/A	N/A	
25	Accessory Structure Rear:		19'-6"	19'-6"	
26	Sum of Side yard :	25'-0"	25'-0"	25'-0"	
27	Located within a Local Historic District?			Yes or no	
28	Designated as an individual Historic Single Family Residence Site?			Yes or no	
29	Determined to be Architecturally Significant?		Yes or no		
Notes					

VY FISCHMAN URE + DESIGN

F L = V Y F

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'EFANO ISAIAS RESIDENCE 2324 NORTH BAY ROAD MIAMI, FLORIDA 33140

seal


Ralph Choeff registered architect AR0009679 AA26003009 comm no.

1841 date: 08/03/2018


revised:

sheet no.

4-0.2

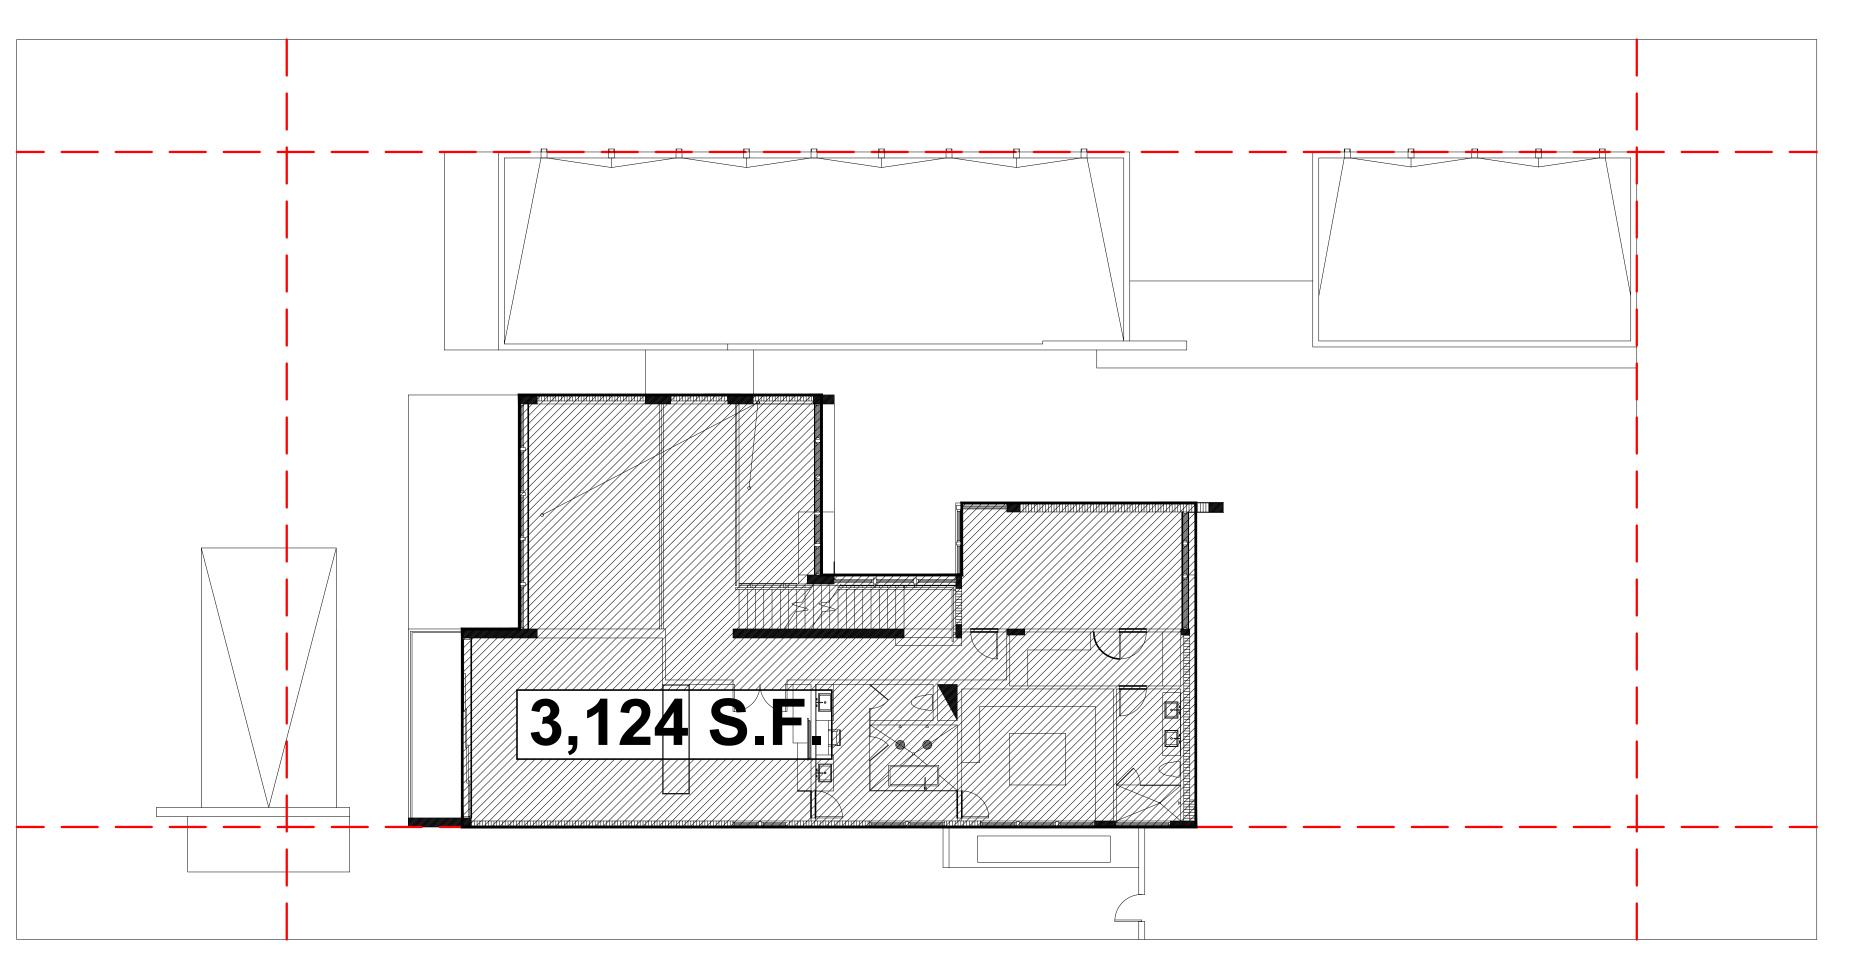



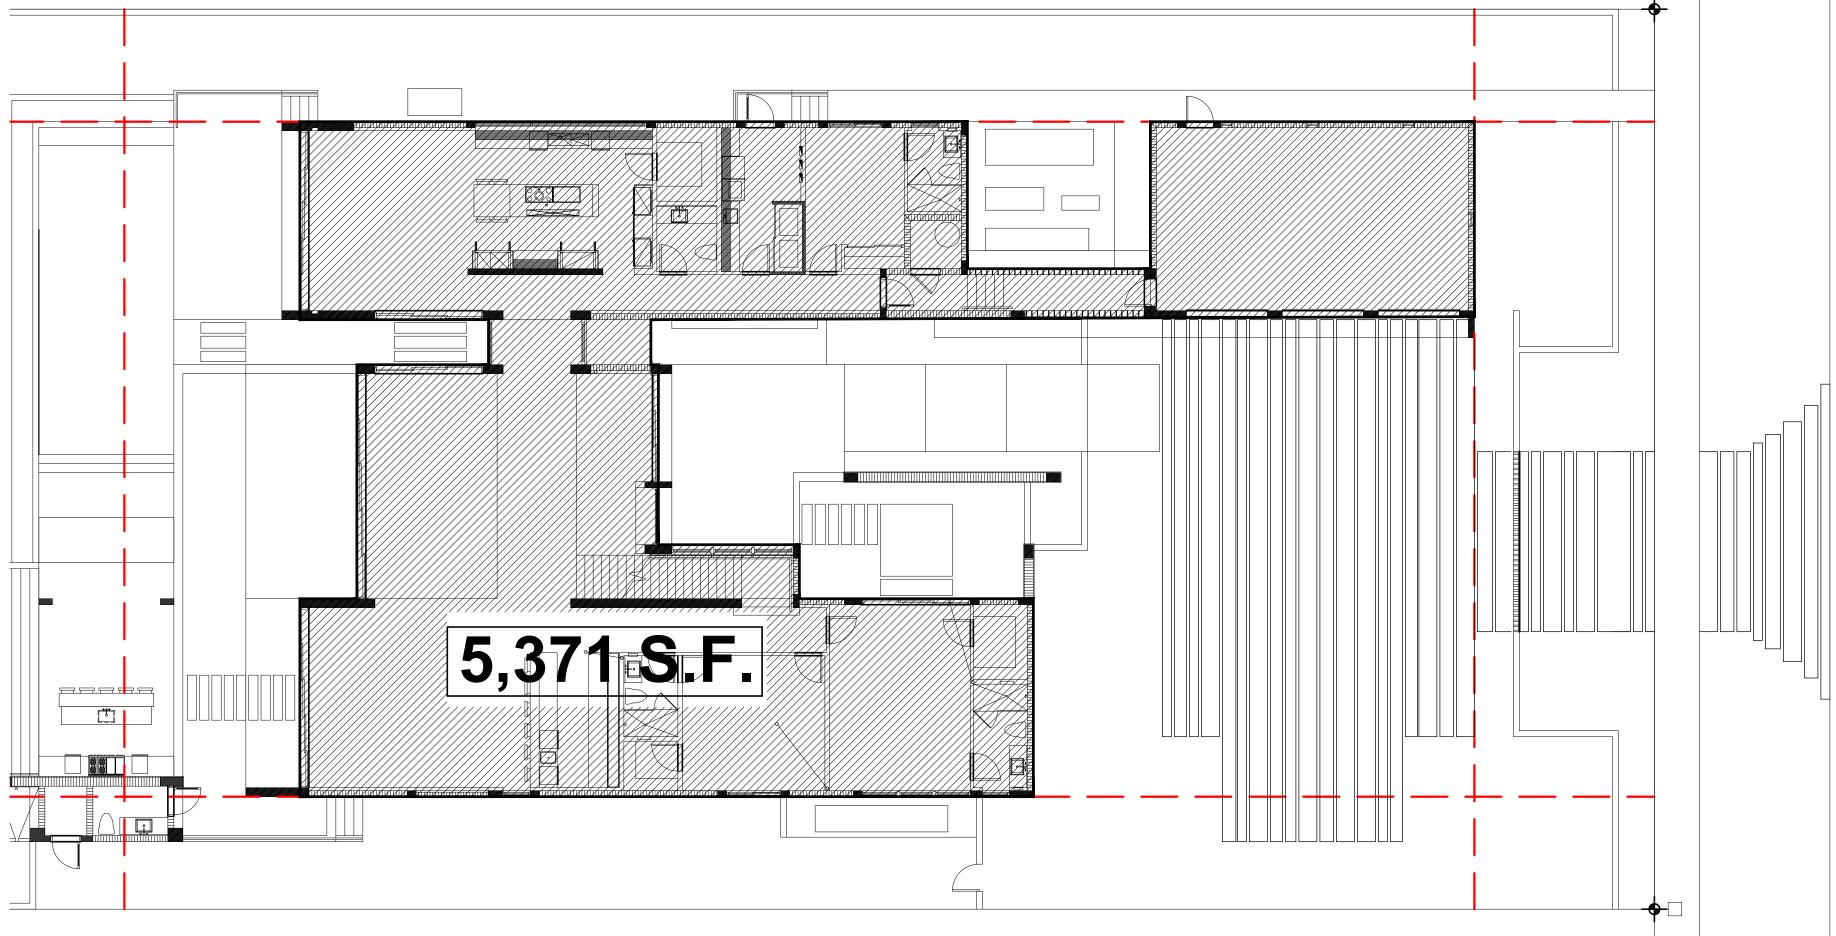

EXISTING

SECOND FLOOR IS

SECOND / FIRST FLOOR RATIO :

OT SIZE:	2 <i>Ø,ØØØ</i> S.
FIRST FLOOR ———————————————————————————————————	5,371 S. 3,124 S.

(58.2 %)

TECTU

RCHITEC

STEFANO ISAIAS RESIDENCI 2324 NORTH BAY ROAD MIAMI, FLORIDA 33140

seal

Ralph Choeff registered architect AR0009679 AA26003009

comm no. 1841


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revised:


EXISTING

A-1.0

sheet no.



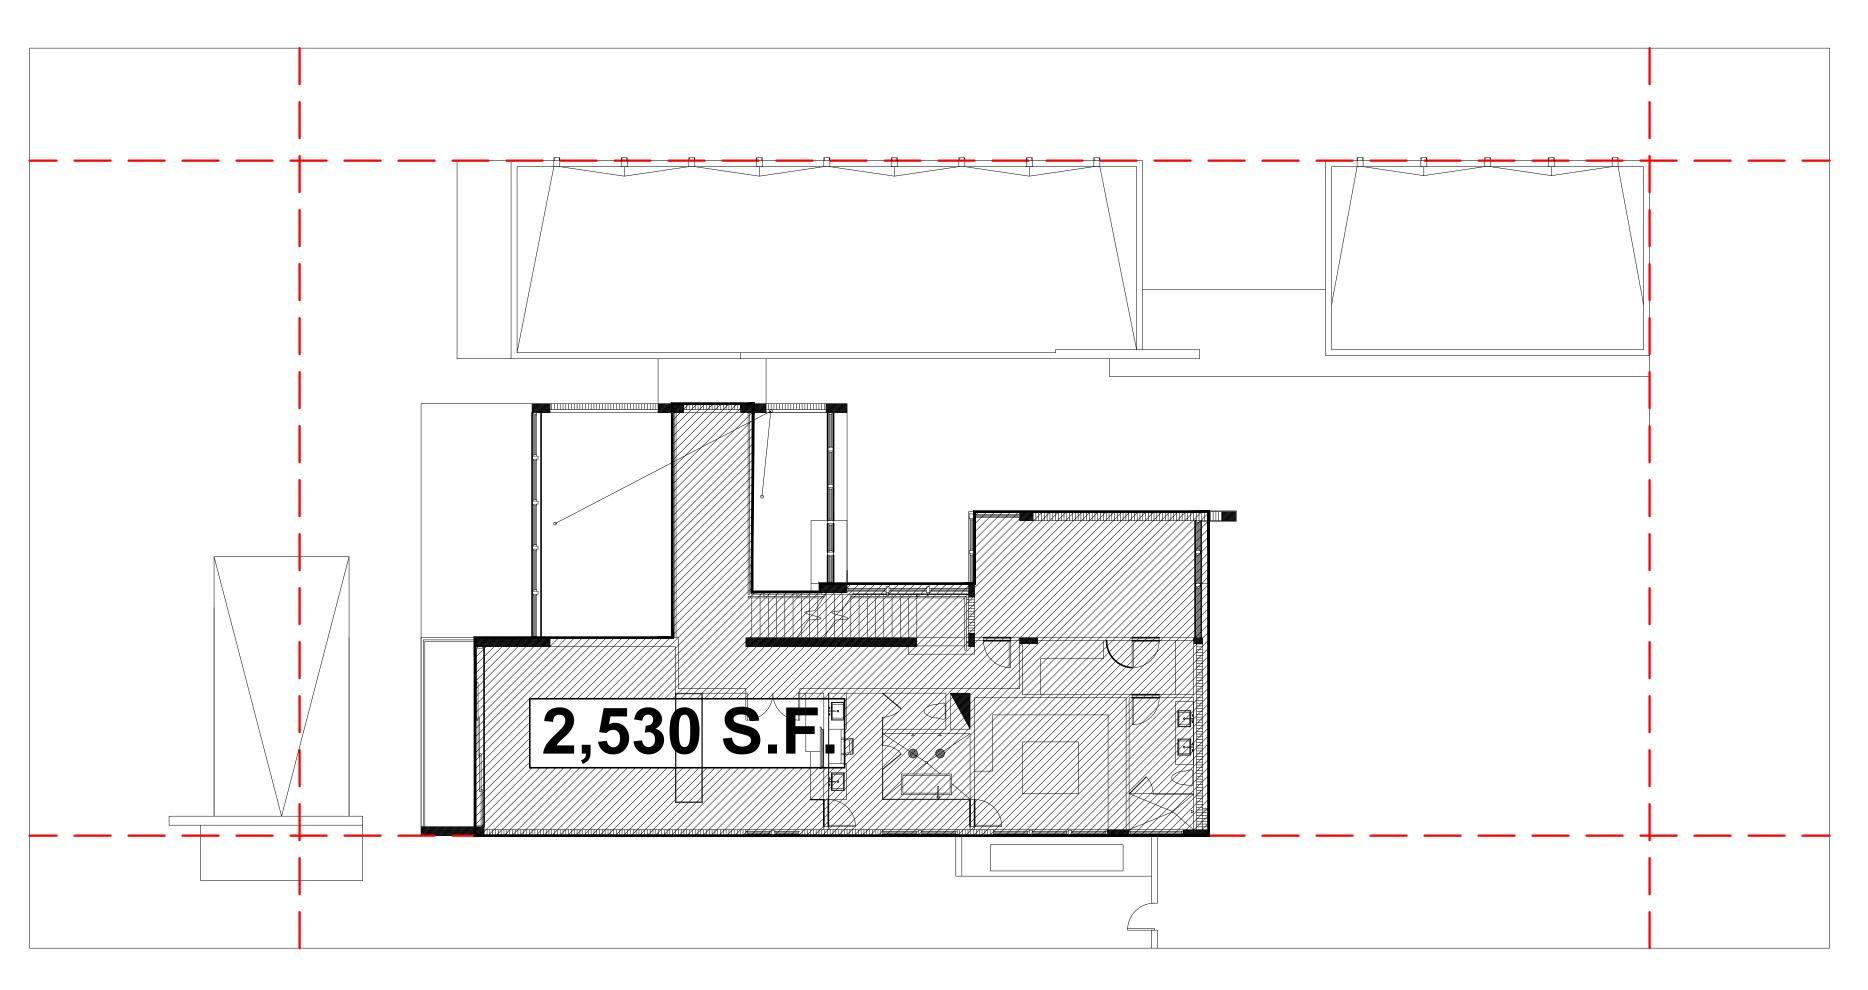

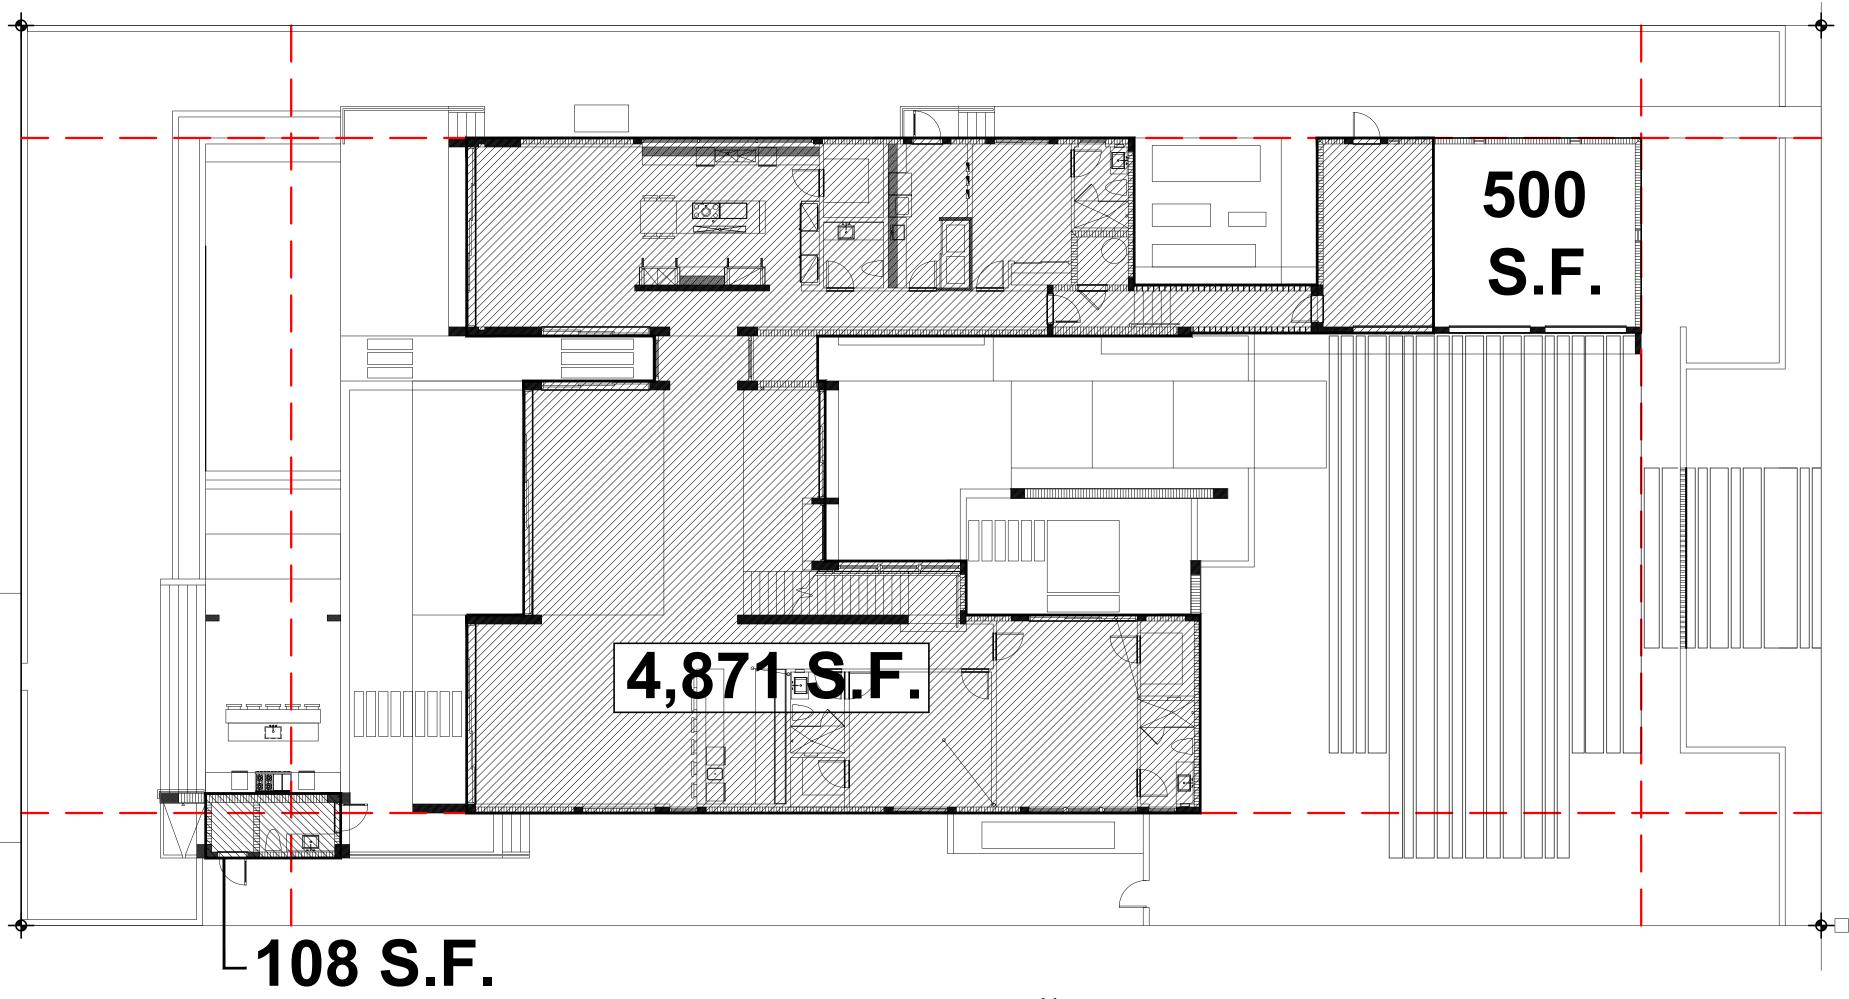

| FIRST FLOOR | 3/32' = 1'-0'

EXISTING UNIT SIZE :

LOT SIZE:	20,000
FIRST FLOOR———————————————————————————————————	
UNIT / LOT SIZE -	(37.

A R C H I T E C T U
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seal

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1841 date:

08/03/2018

revised:

EXISTING

A-1.1

sheet no.

______ 6,786 SQ. FT. (33.9 %)

U

F F 5

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2324 NORTH BAY ROAD
MIAMILEI ORIDA 33140


registered architect AR0009679 AA26003009 COMM NO.


1841 date: 08/03/2018

revised:

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ROOFING LOUNGE AREA - EXISTING

ROOF DECK AREA: 1,762 S.F. (55.7 %)

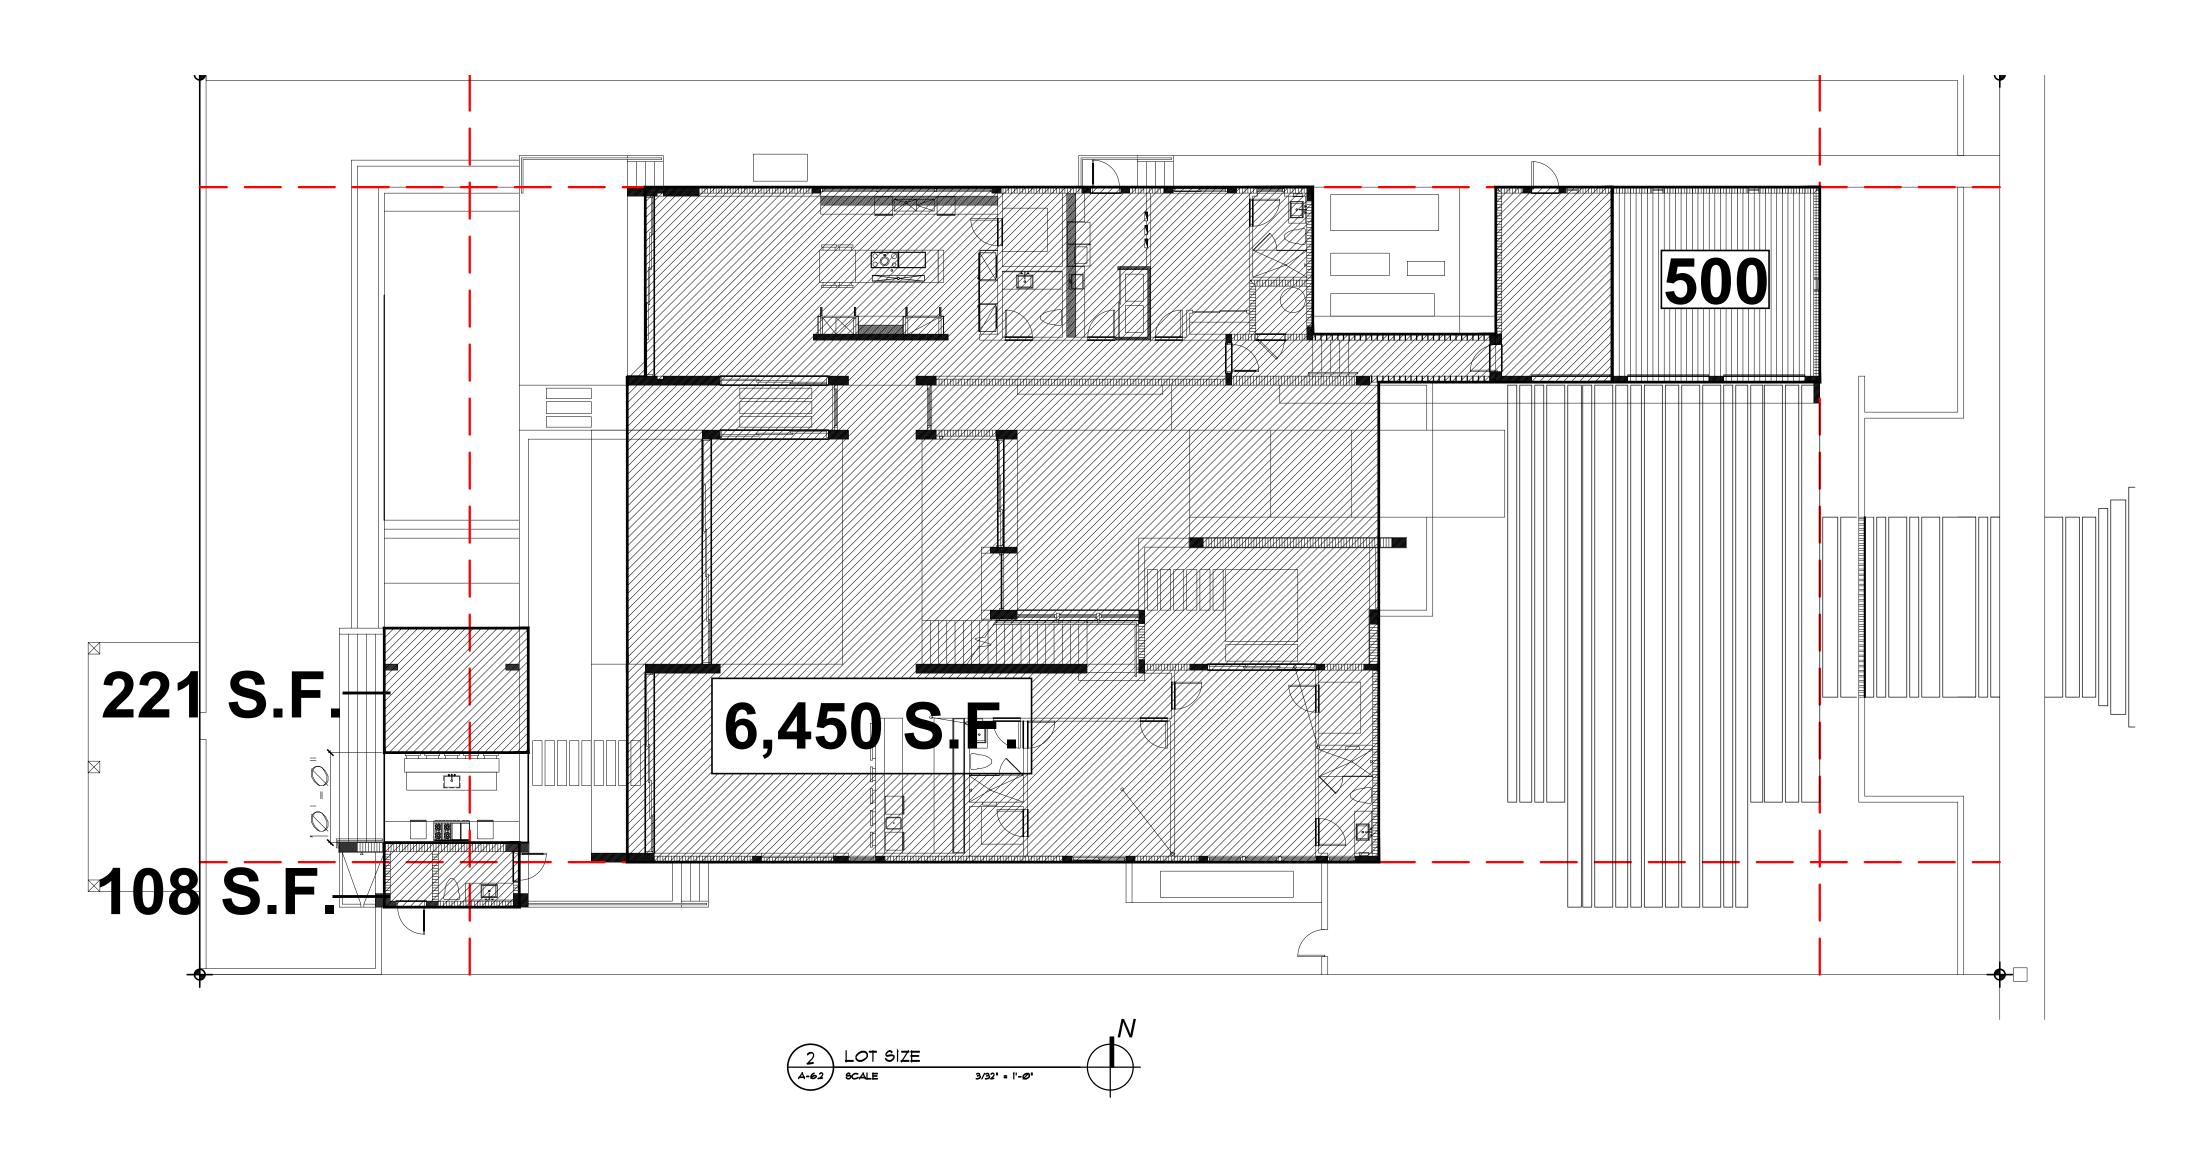EXISTING

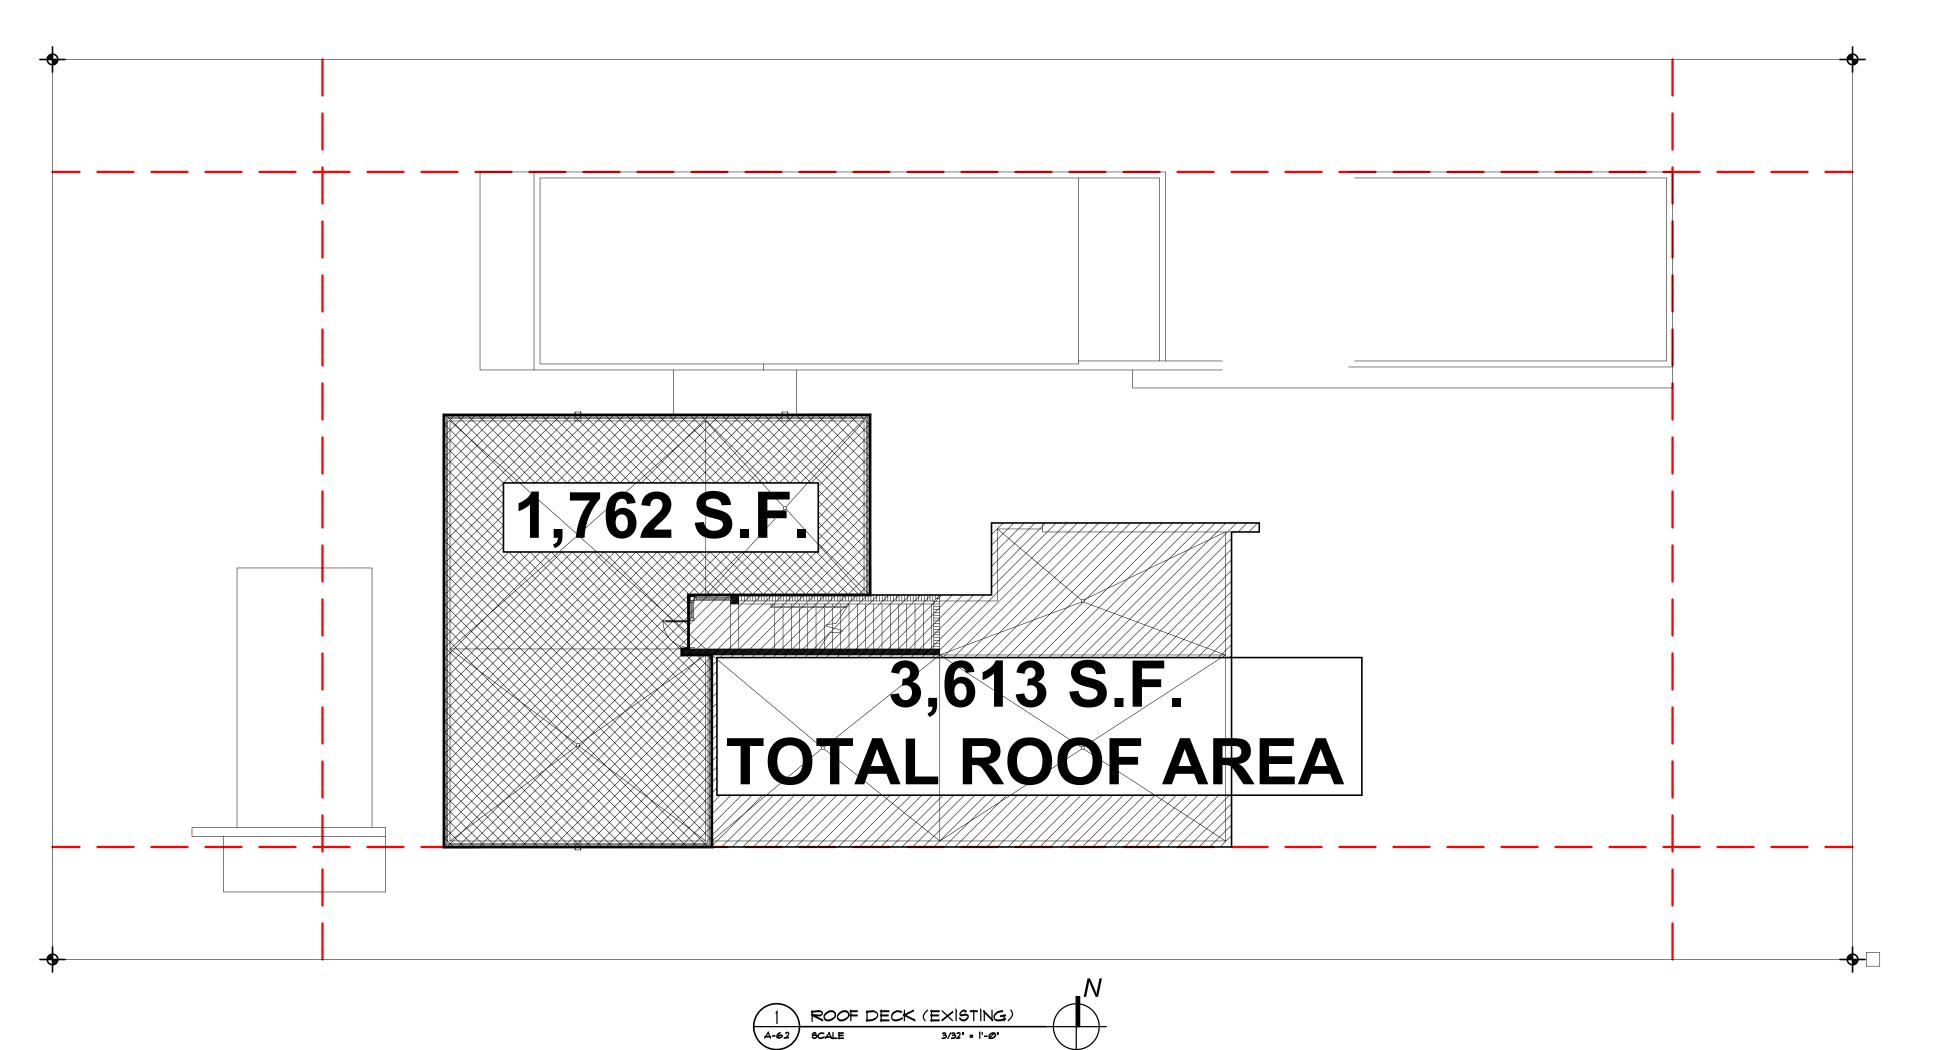IMPERVIOUS AREA


PERVIOUS / LANDSCAPE AREA


EXISTING FRONT YARD CALCULATIONS

AREA: 2,000 S.F. 100% IMPERVIOUS AREA: 549 S.F. 27.5 % 1,451 S. F. PERVIOUS AREA: 72.5%

REAR YARD CALCULATIONS

AREA: 3,**000** S.F. 100% 23.3 % 699 S.F. IMPERVIOUS AREA: 76.7 % PERVIOUS AREA: 2,3Ø1 S.F.

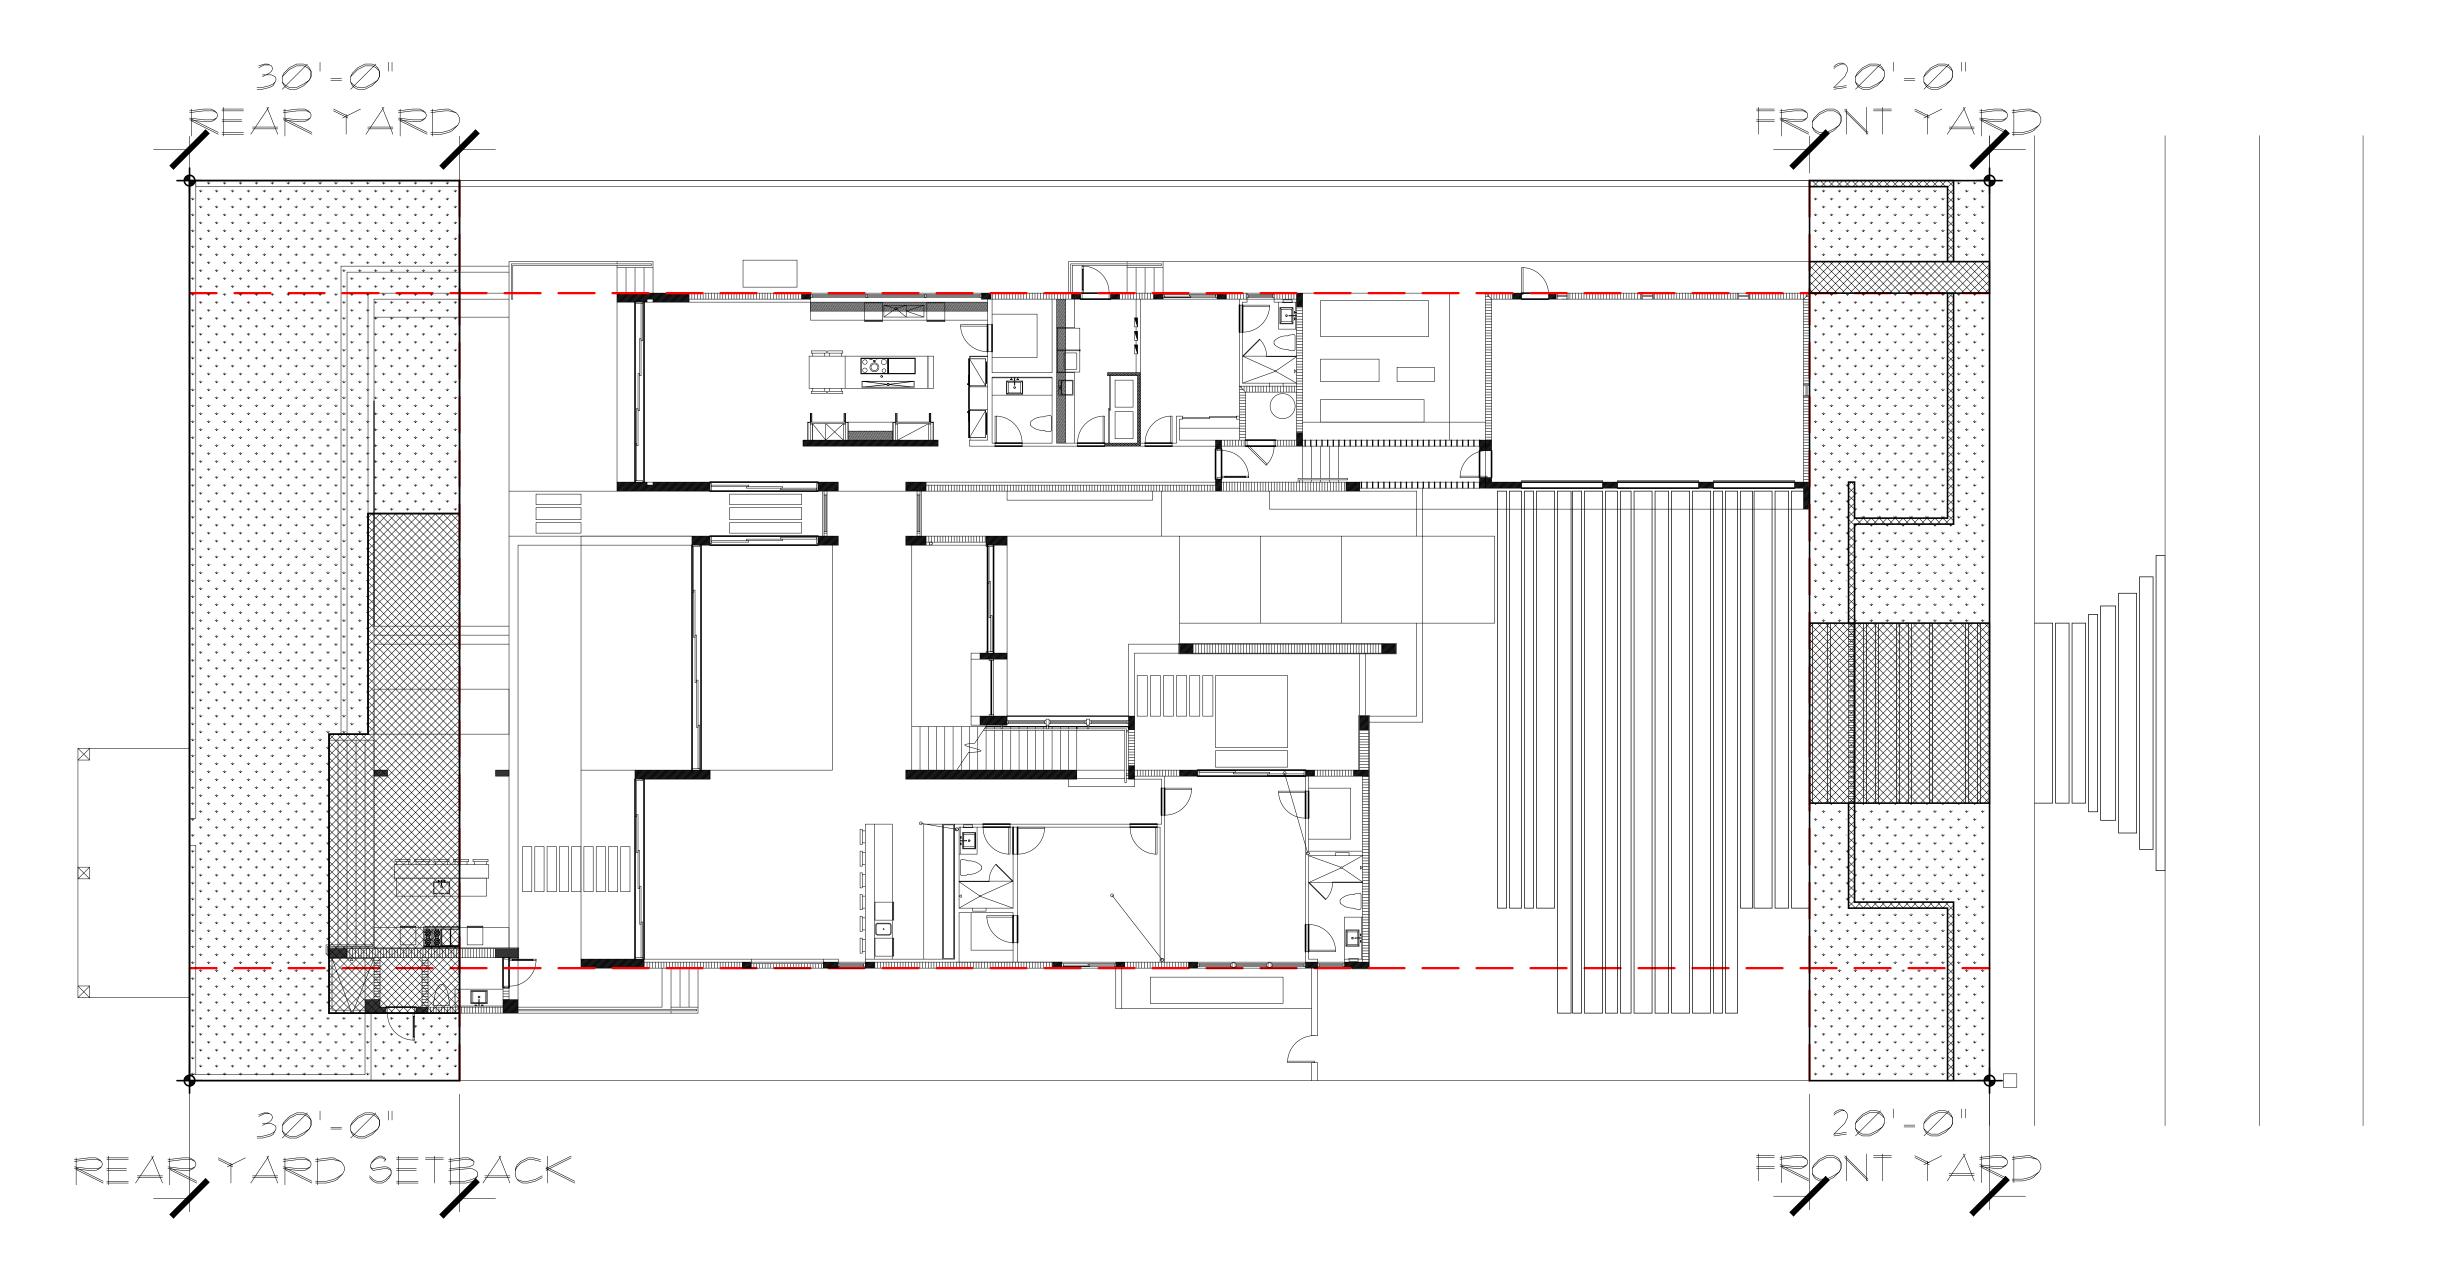

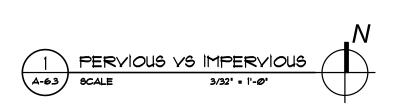


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2324 NORTH BAY ROAD
MIAMI, FLORIDA 33140

comm no. 1841 08/03/2018

revised:



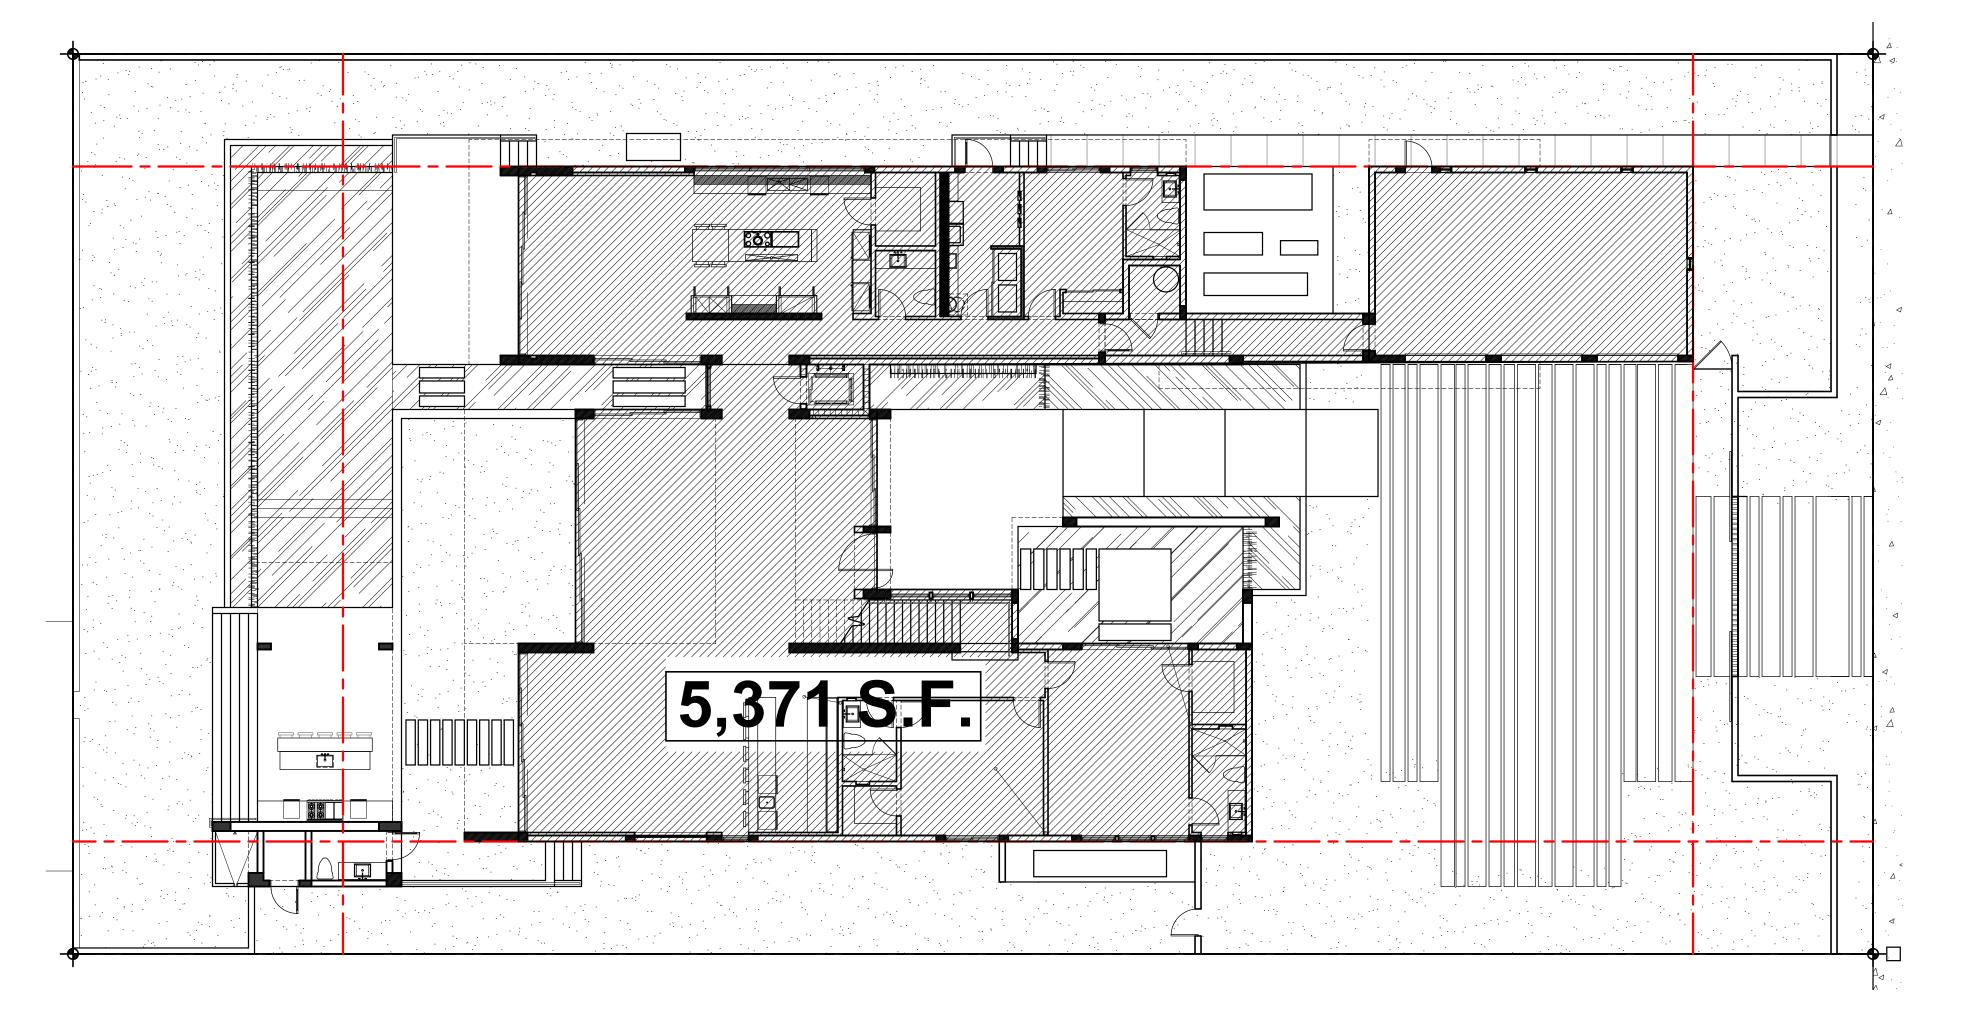

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Ralph Choeff registered architect AR0009679 AA26003009 comm no. 1841 date:

08/03/2018

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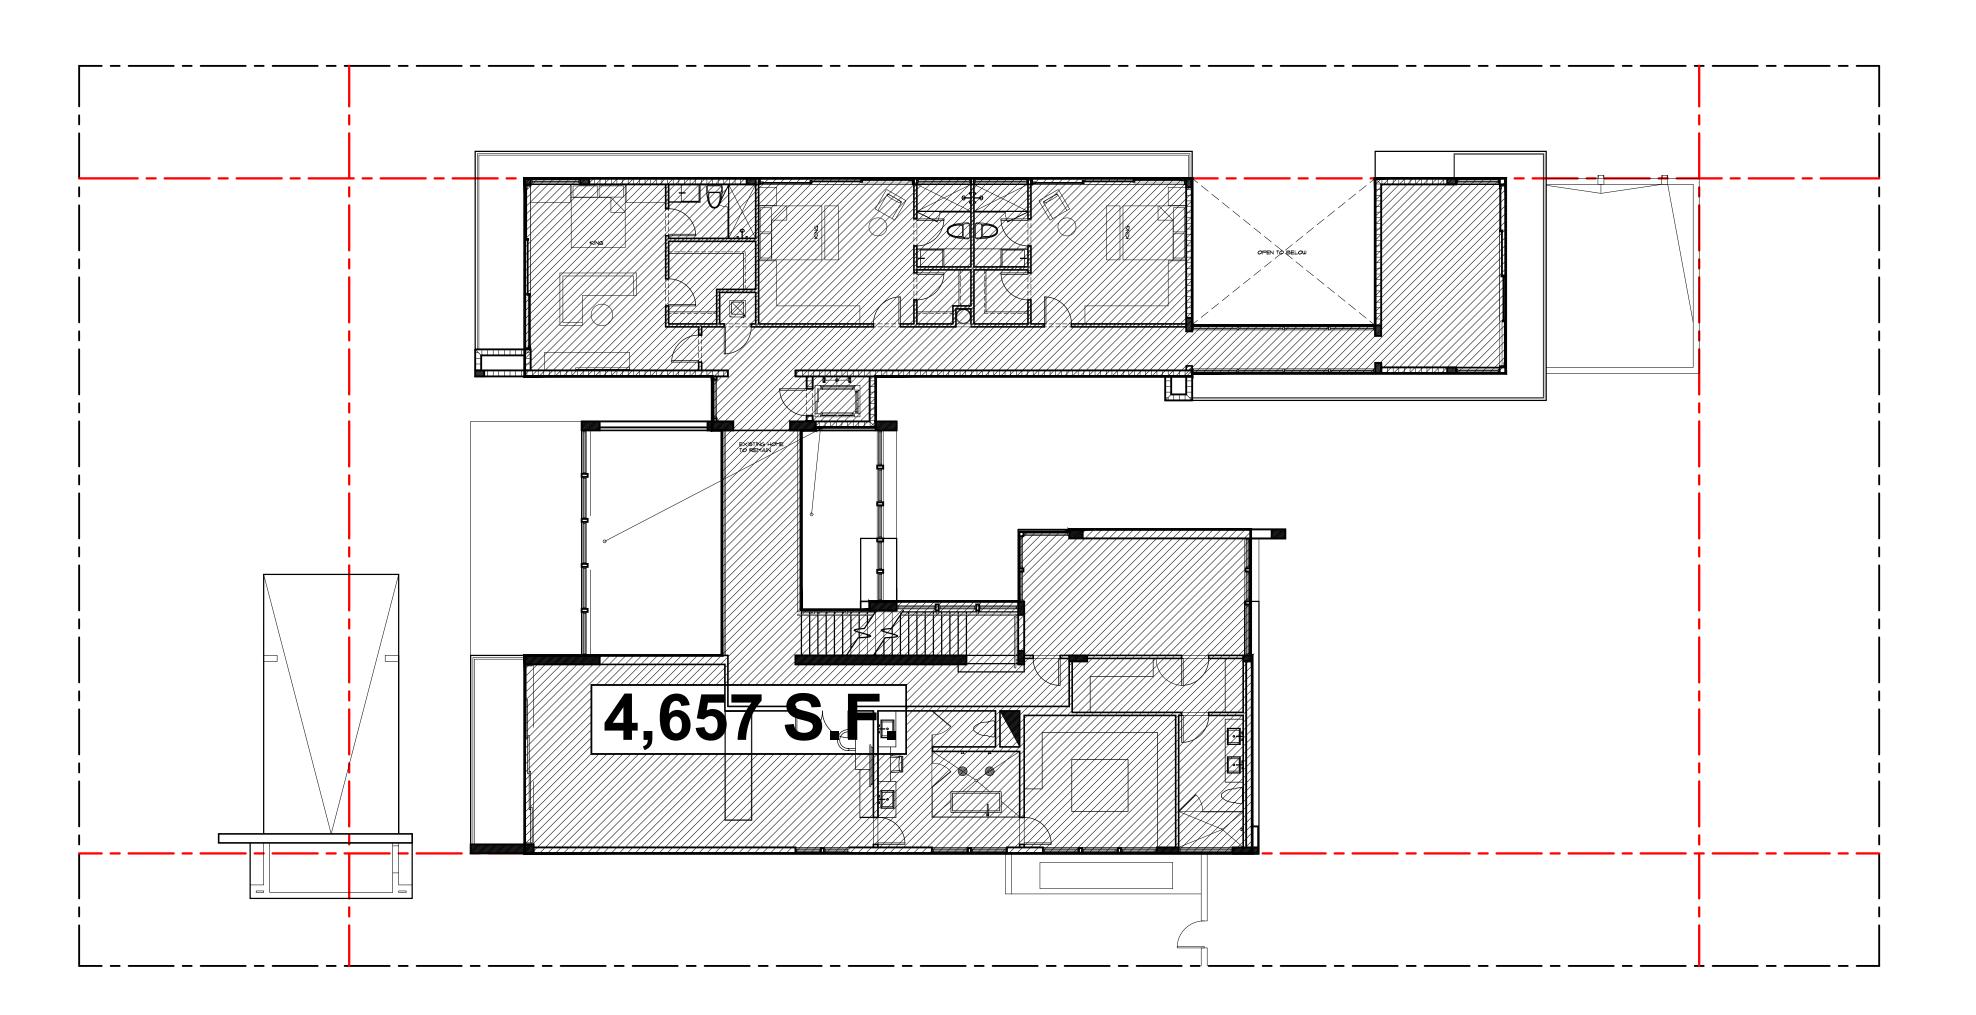
1 FIRST FLOOR


A-05 SCALE 3/32' • 1'-0'

PROPOSED

A-2.0

sheet no.



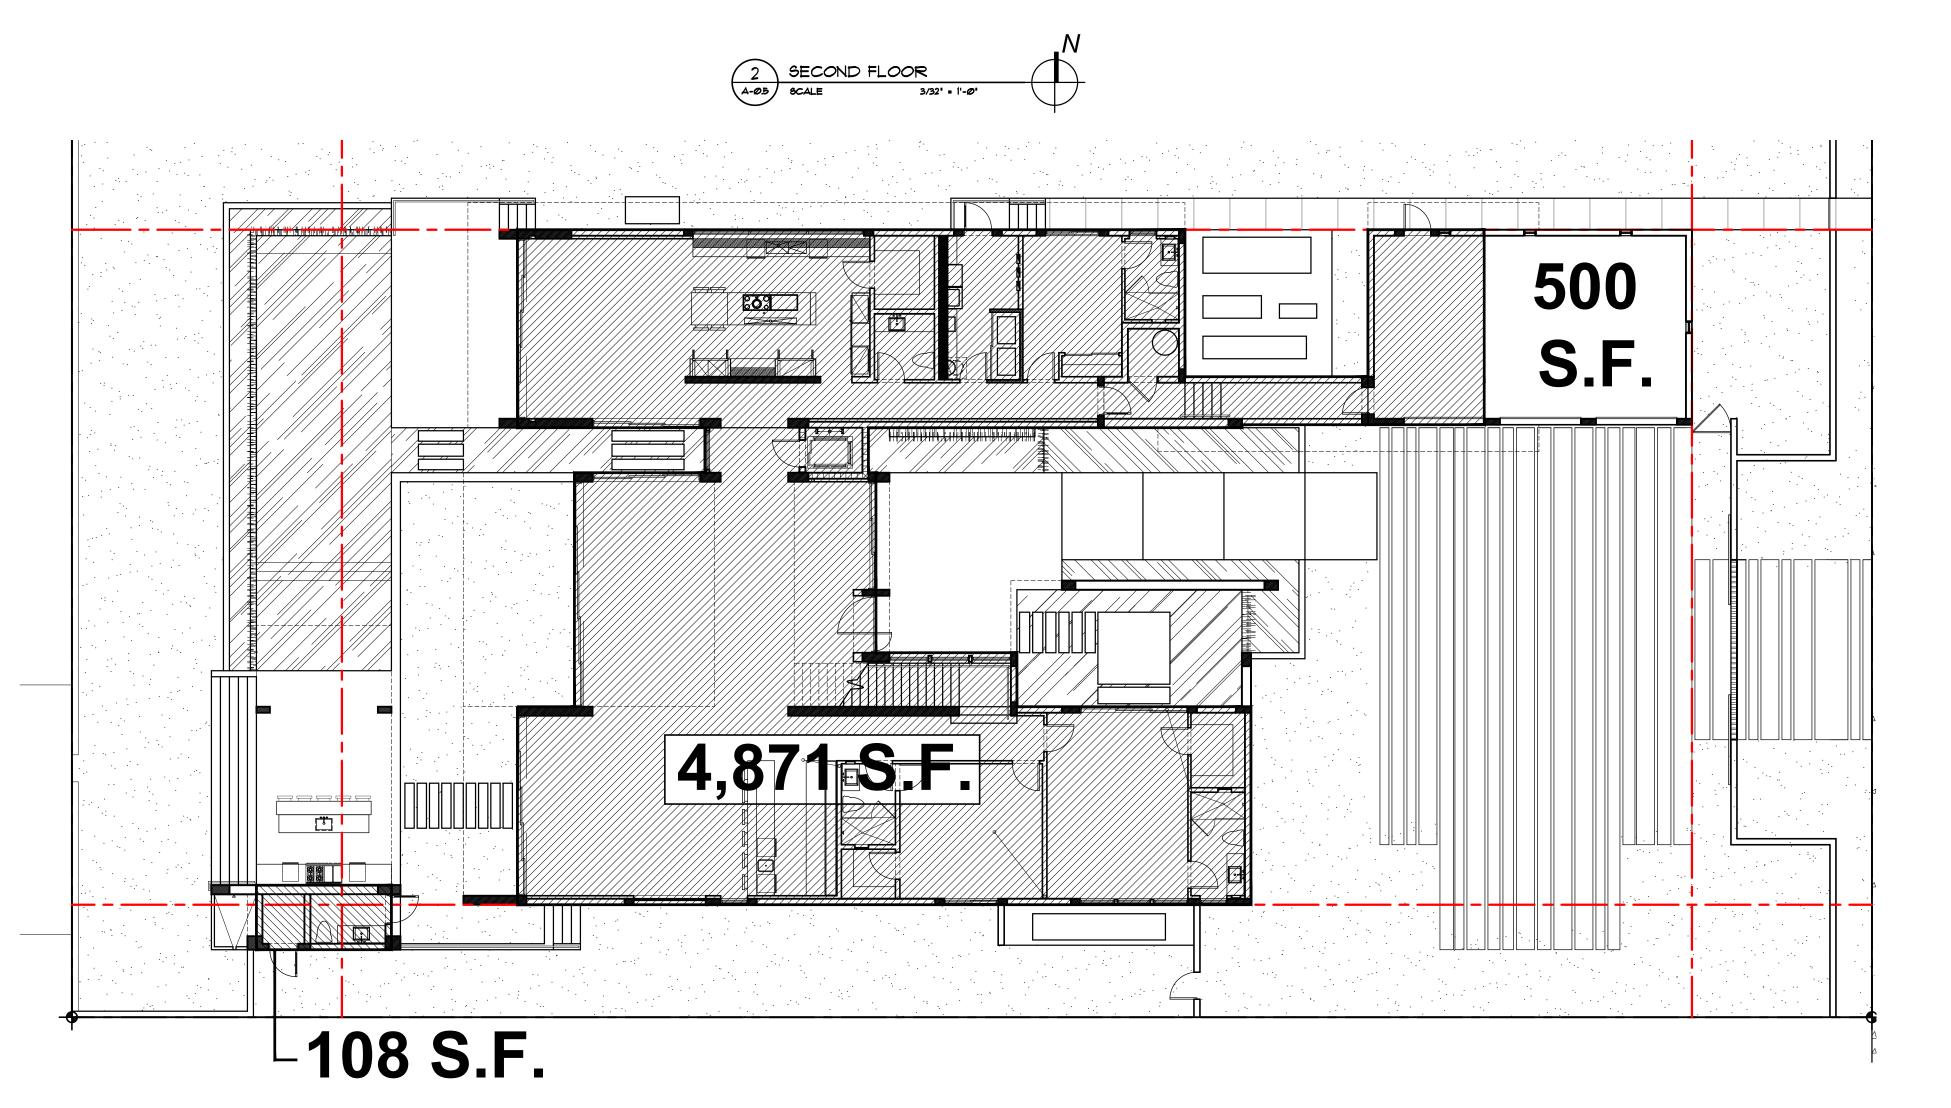

UNIT SIZE :

LOT SIZE:	2Ø,ØØØ S.F.
FIRST FLOOR———————————————————————————————————	
UNIT / LOT SIZE	(48.2%) (50% MAX)

NO ISAIAS RESIDENCE 2324 NORTH BAY ROAD MIAMI, FLORIDA 33140

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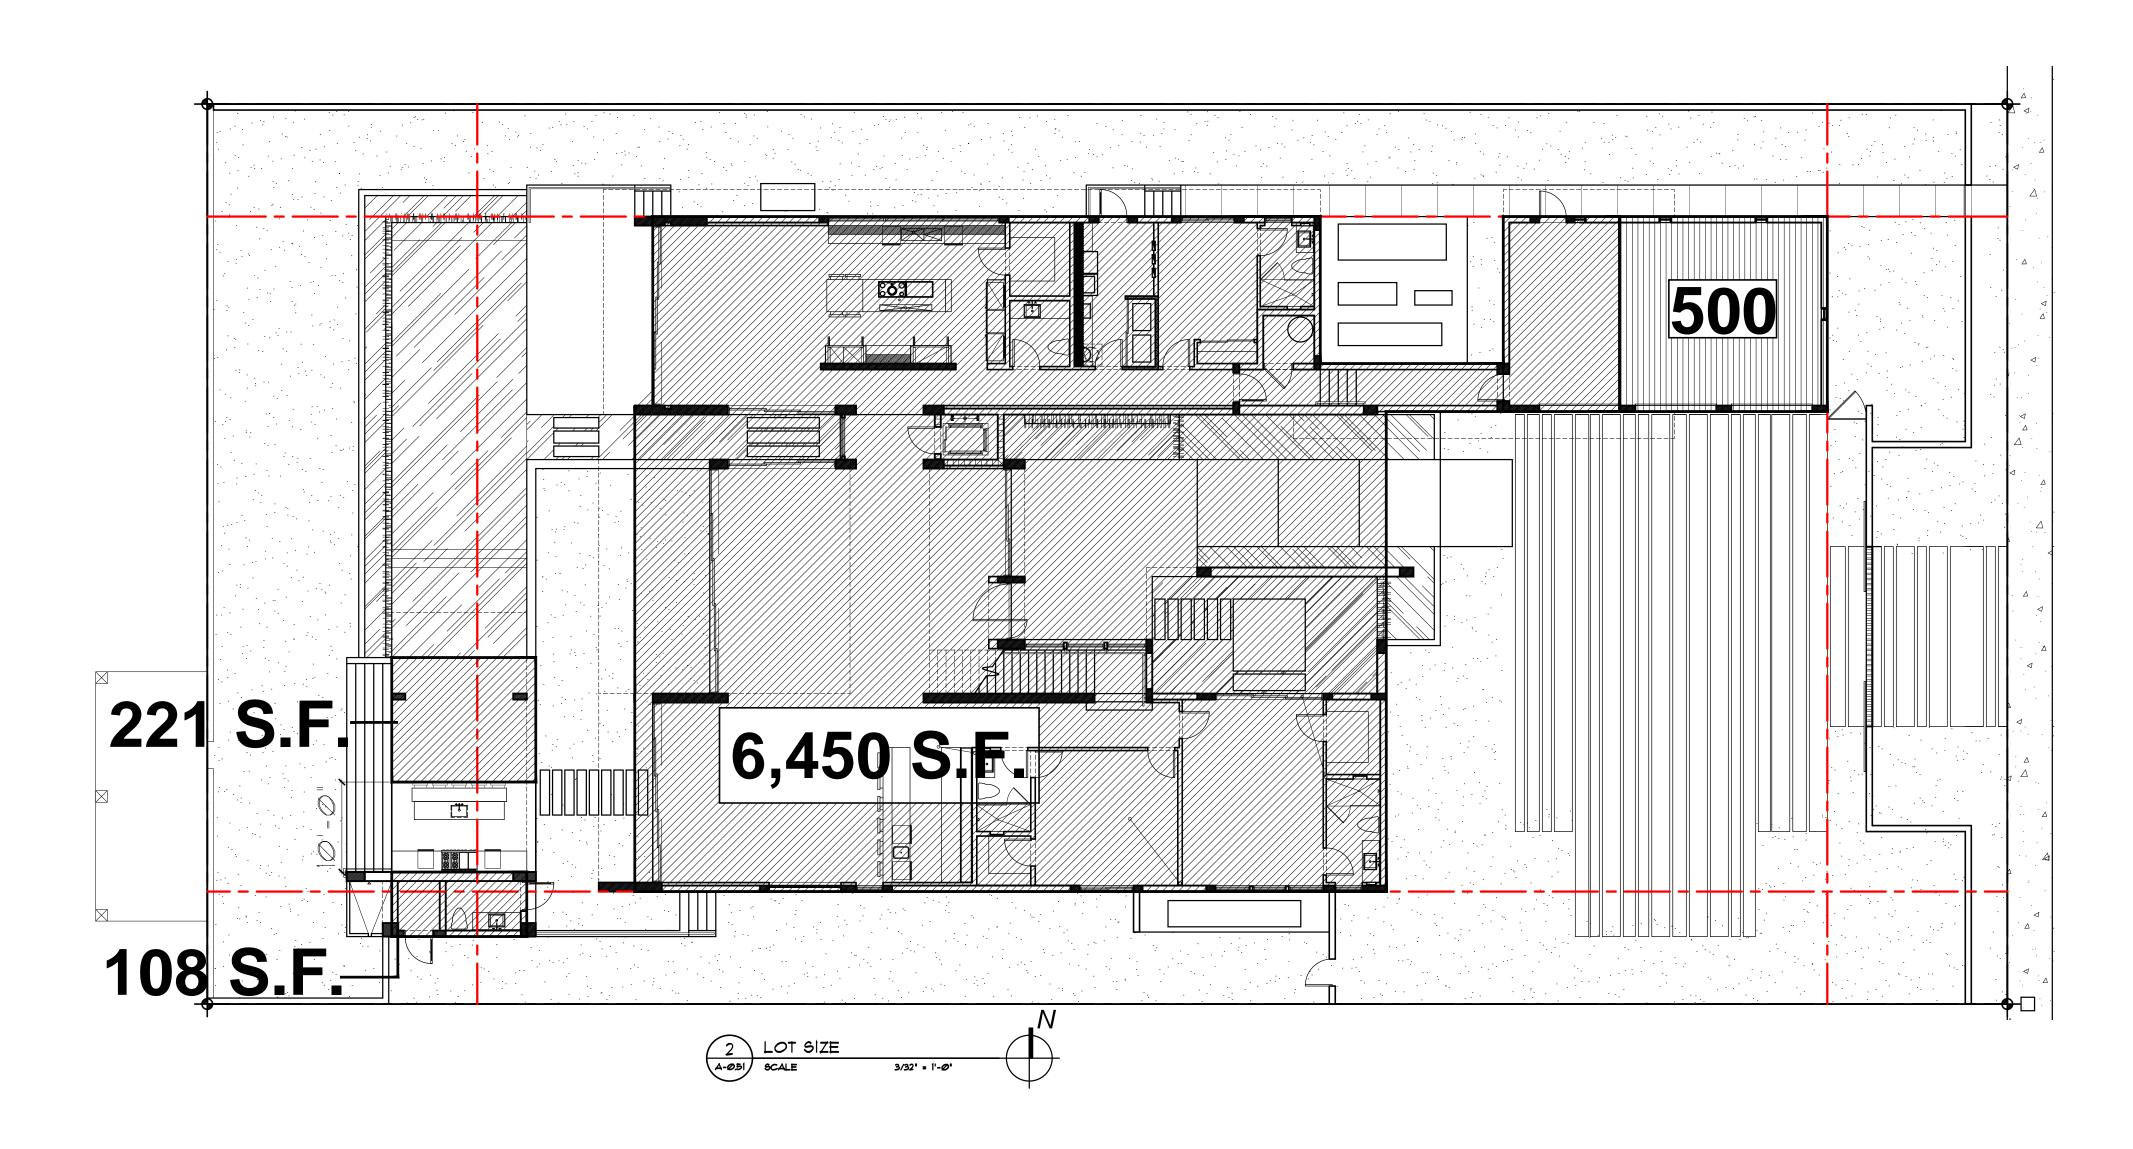
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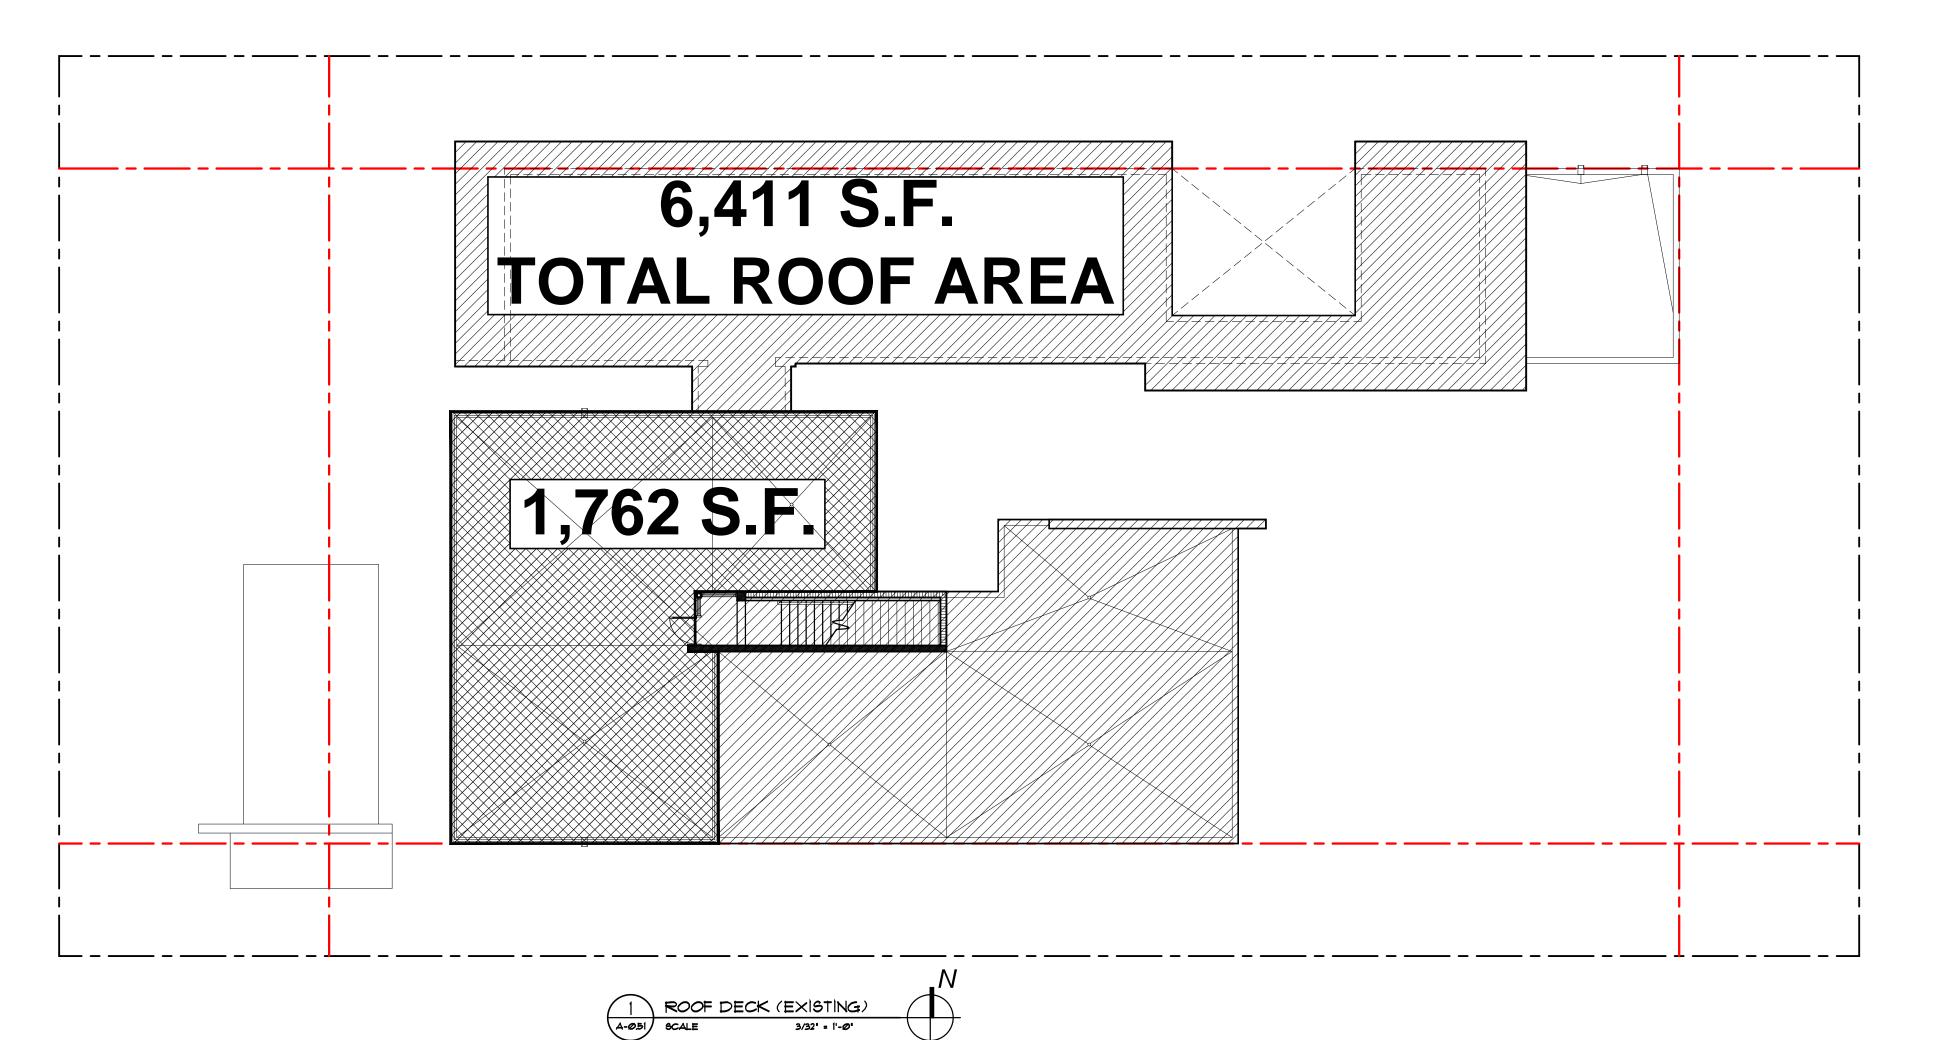
revised:

PROPOSED

A-2.1

A-2.2





ROOFING LOUNGE AREA - SAME AS EXISTING

UPPER LEVEL ROOF. _______ 6,411 S.F. (TAKEN TO OUTSIDE EDGE OF A/C SPACE BELOW)

LOT SIZE : - SAME AS EXISTING

LOT COVERED (EXISTING FOOTPRINT): ----

ROOF DECK AREA: 1,762 S.F. (27.4 %)

LEGEND

IMPERVIOUS AREA

PERVIOUS / LANDSCAPE AREA

FRONT YARD CALCULATIONS - SAME AS EXISTING

 AREA:
 2,000 S. F.
 100%

 IMPERVIOUS AREA:
 549 S. F.
 27.5 %


 PERVIOUS AREA:
 1,451 S. F.
 72.5%


REAR YARD CALCULATIONS - SAME AS EXISTING

 AREA:
 3,000 S. F.
 100 %

 IMPERVIOUS AREA:
 699 S. F.
 23.3 %

 PERVIOUS AREA:
 2,301 S. F.
 76.7 %

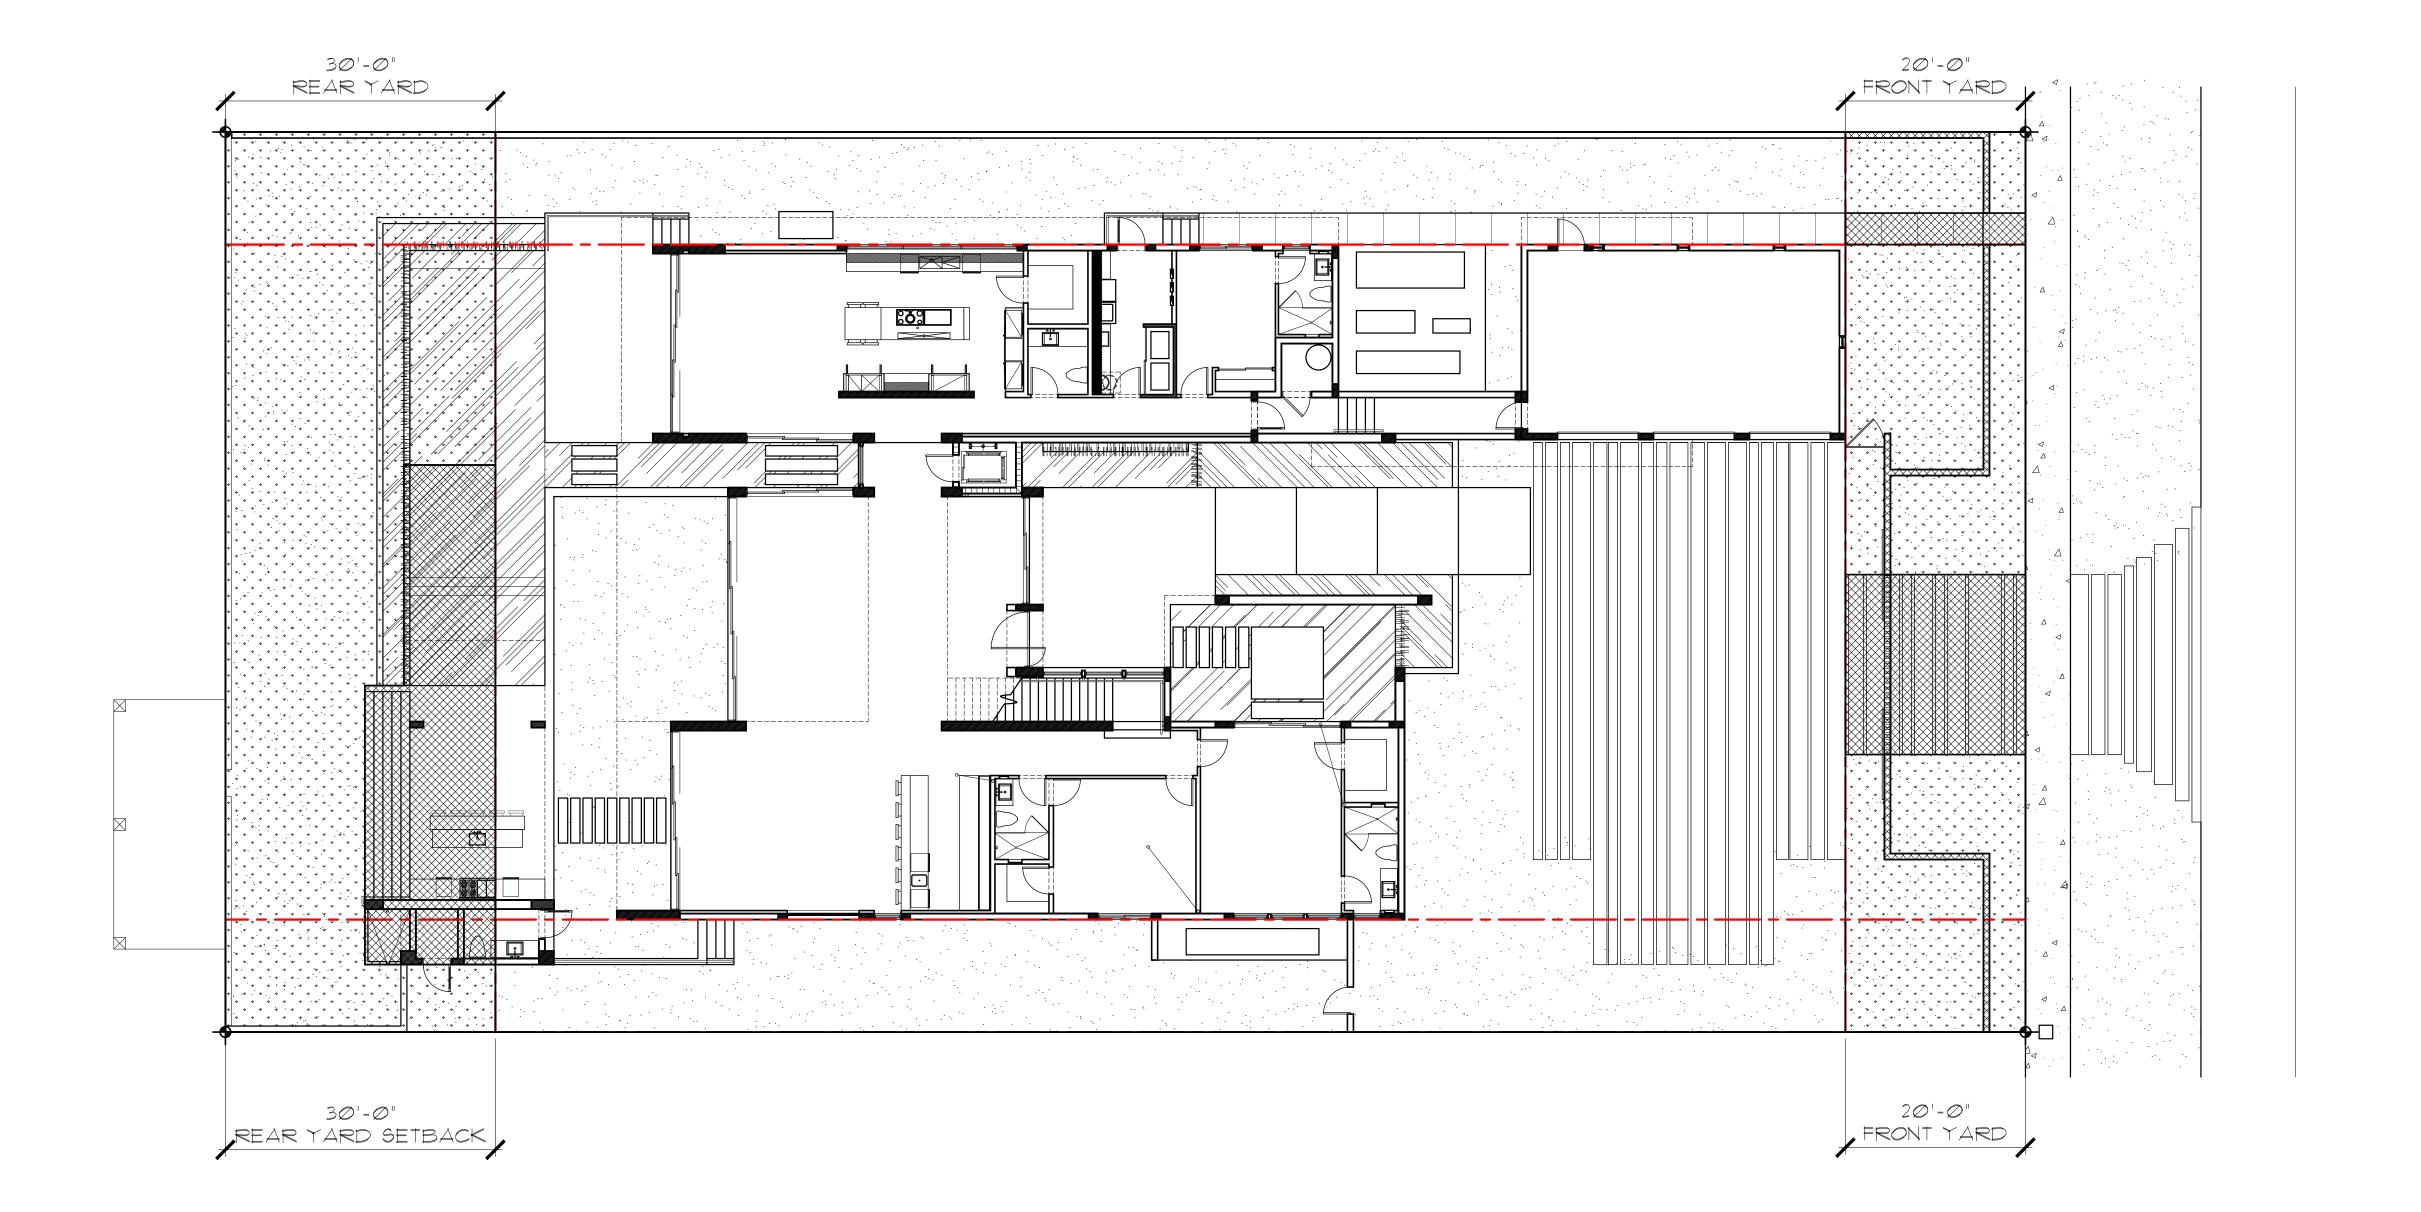

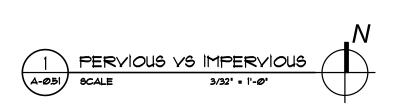

PROPOSED

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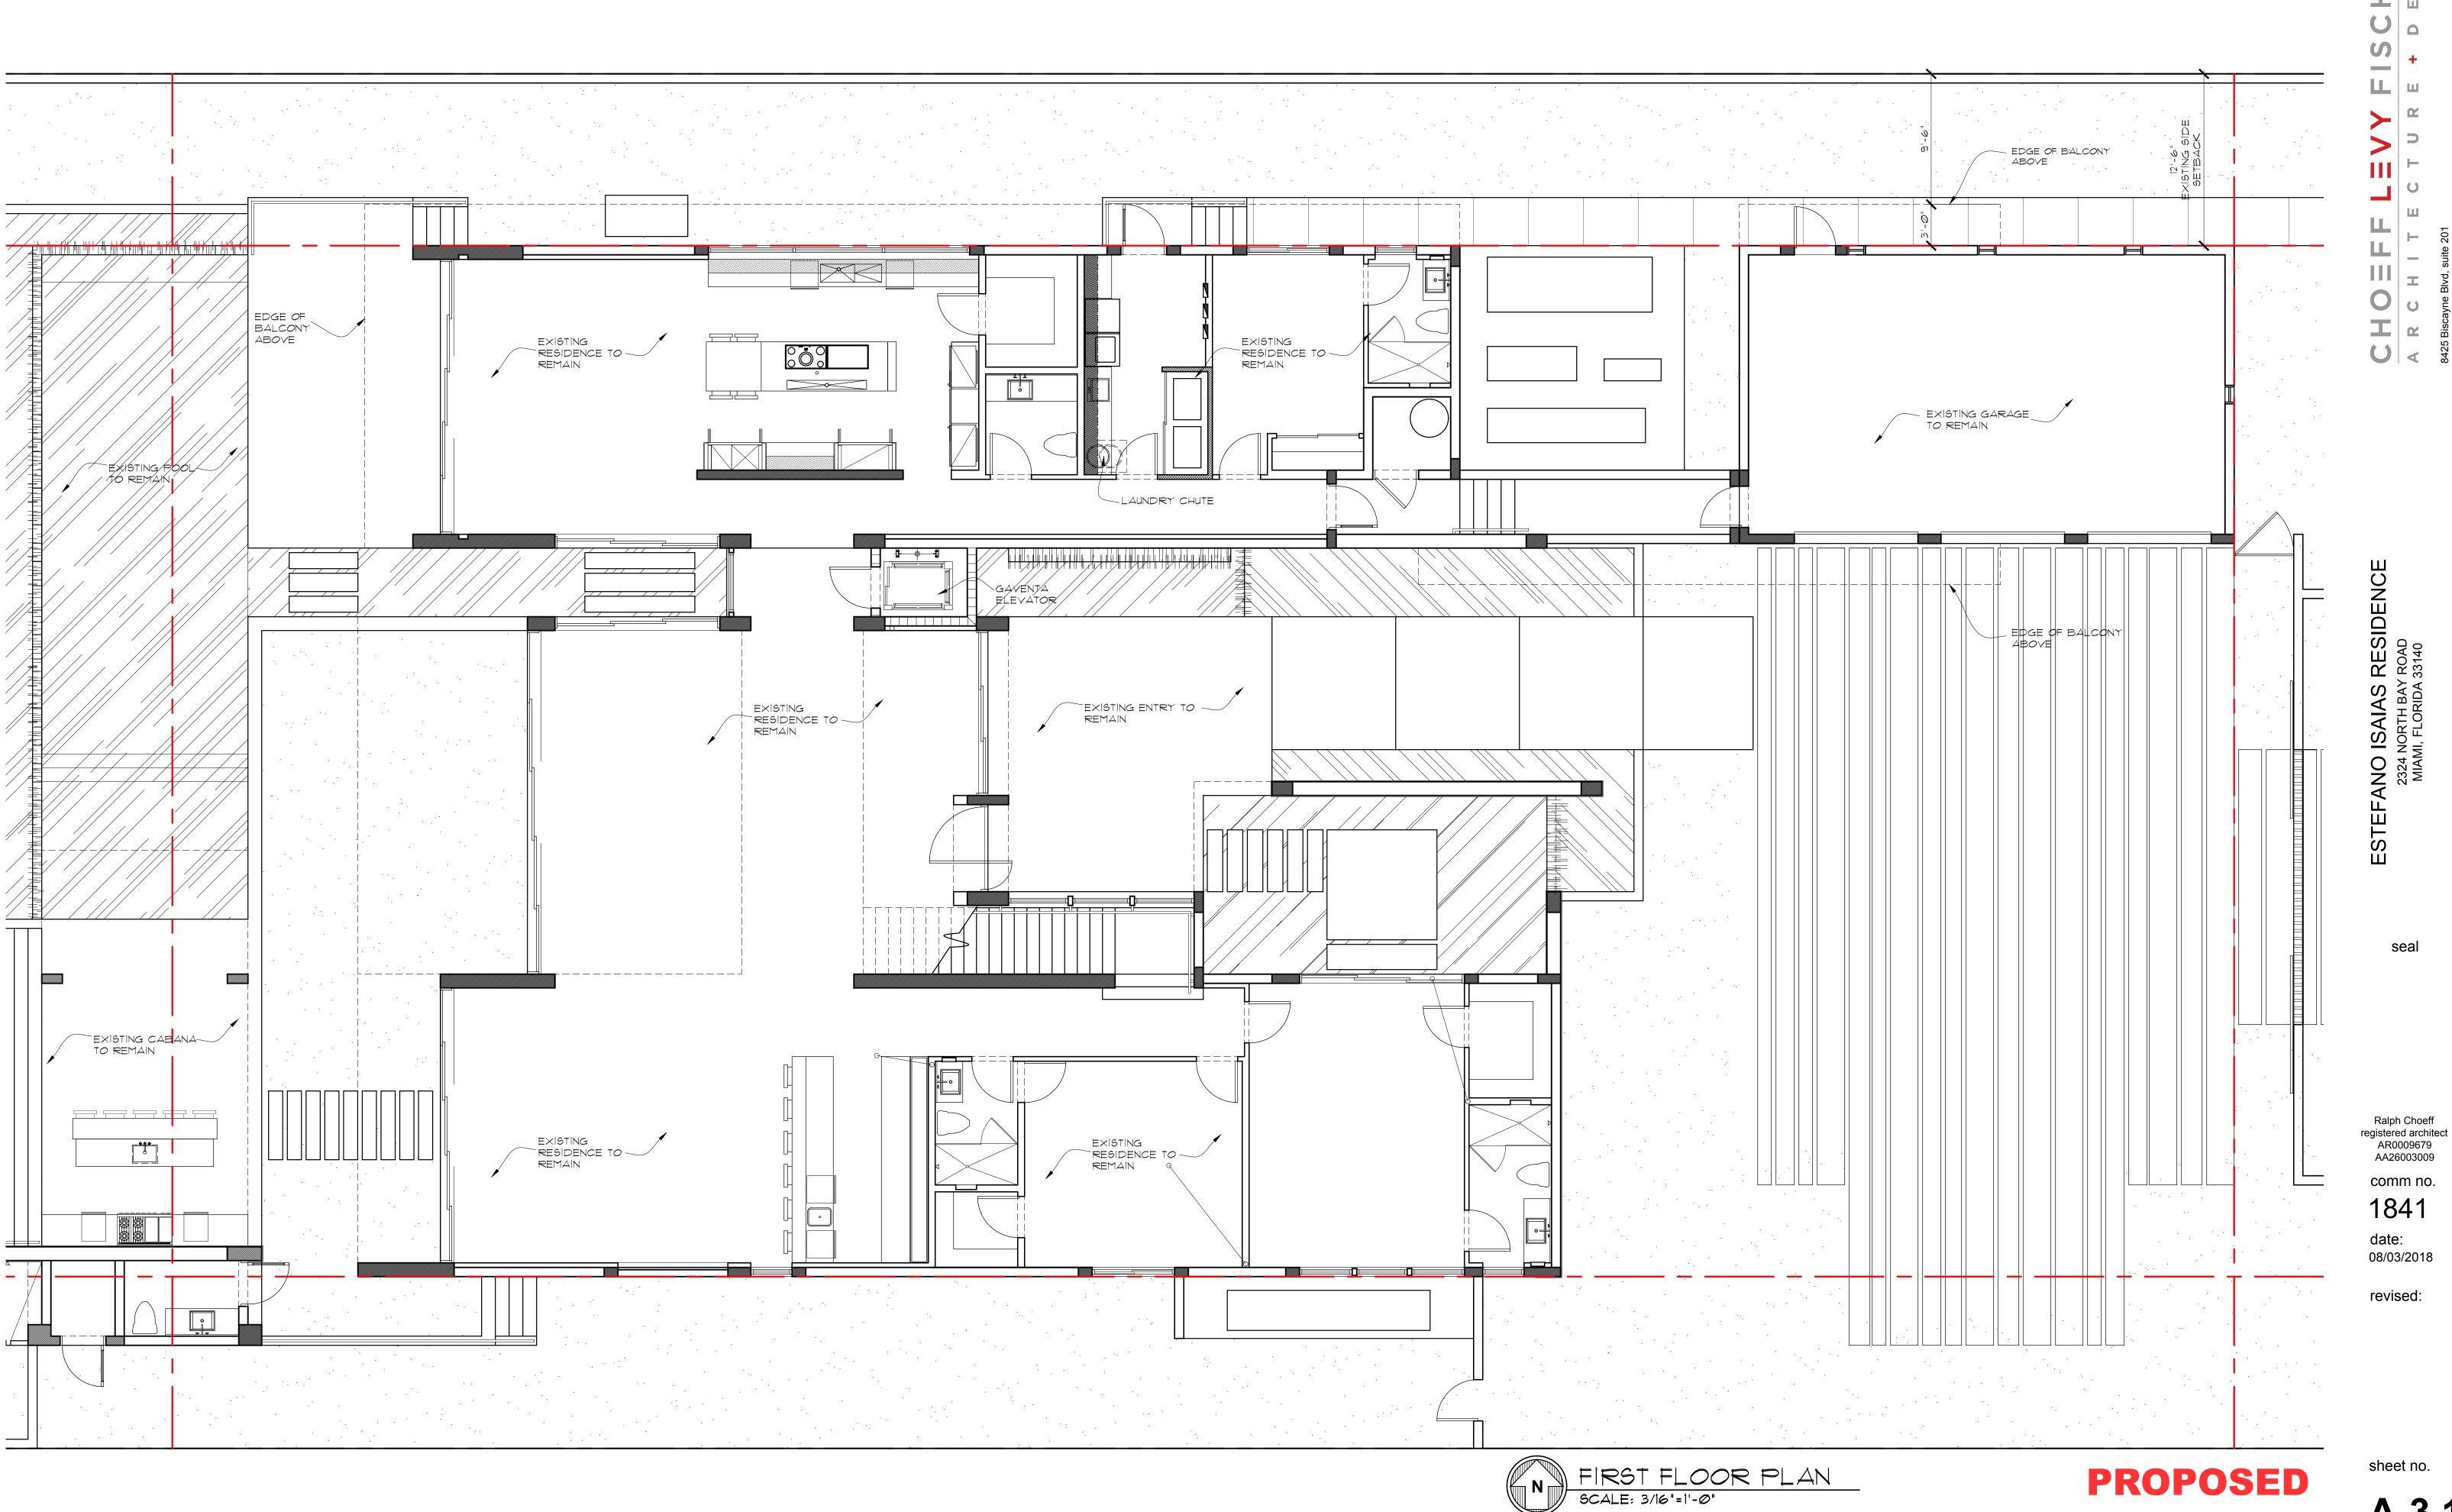
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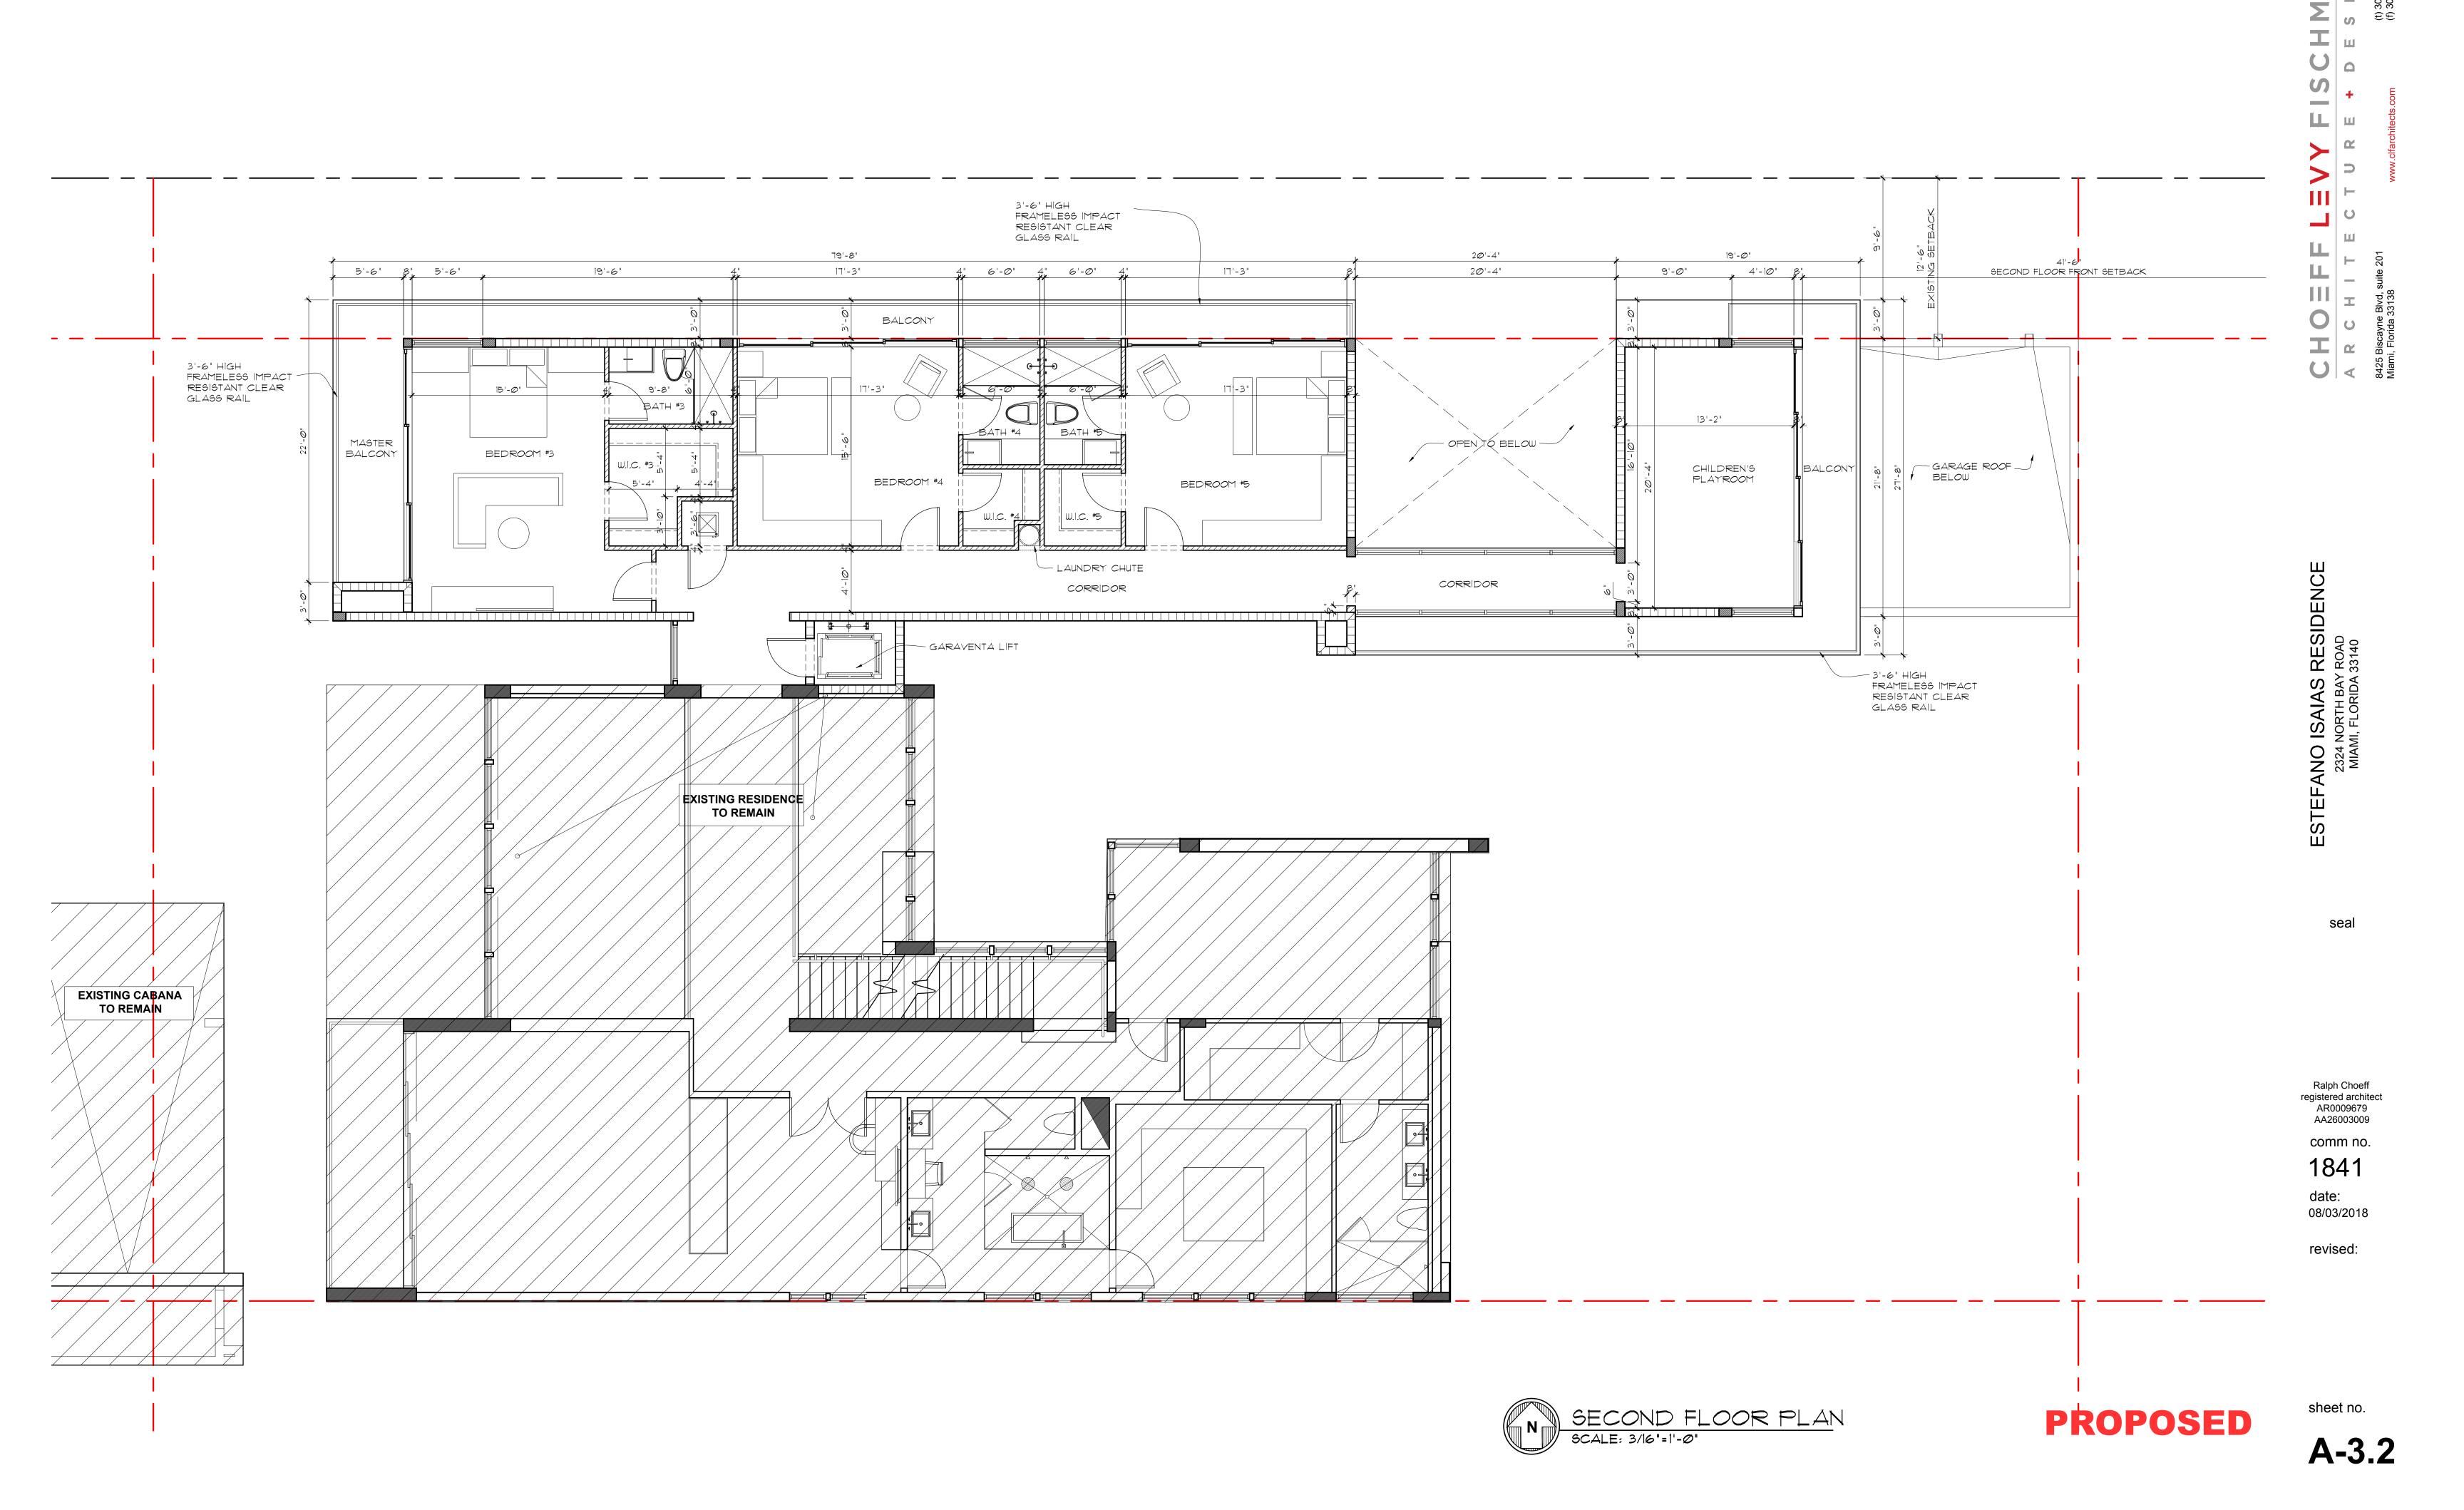
O ISAIAS RESIDENCE
24 NORTH BAY ROAD
AMI, FLORIDA 33140


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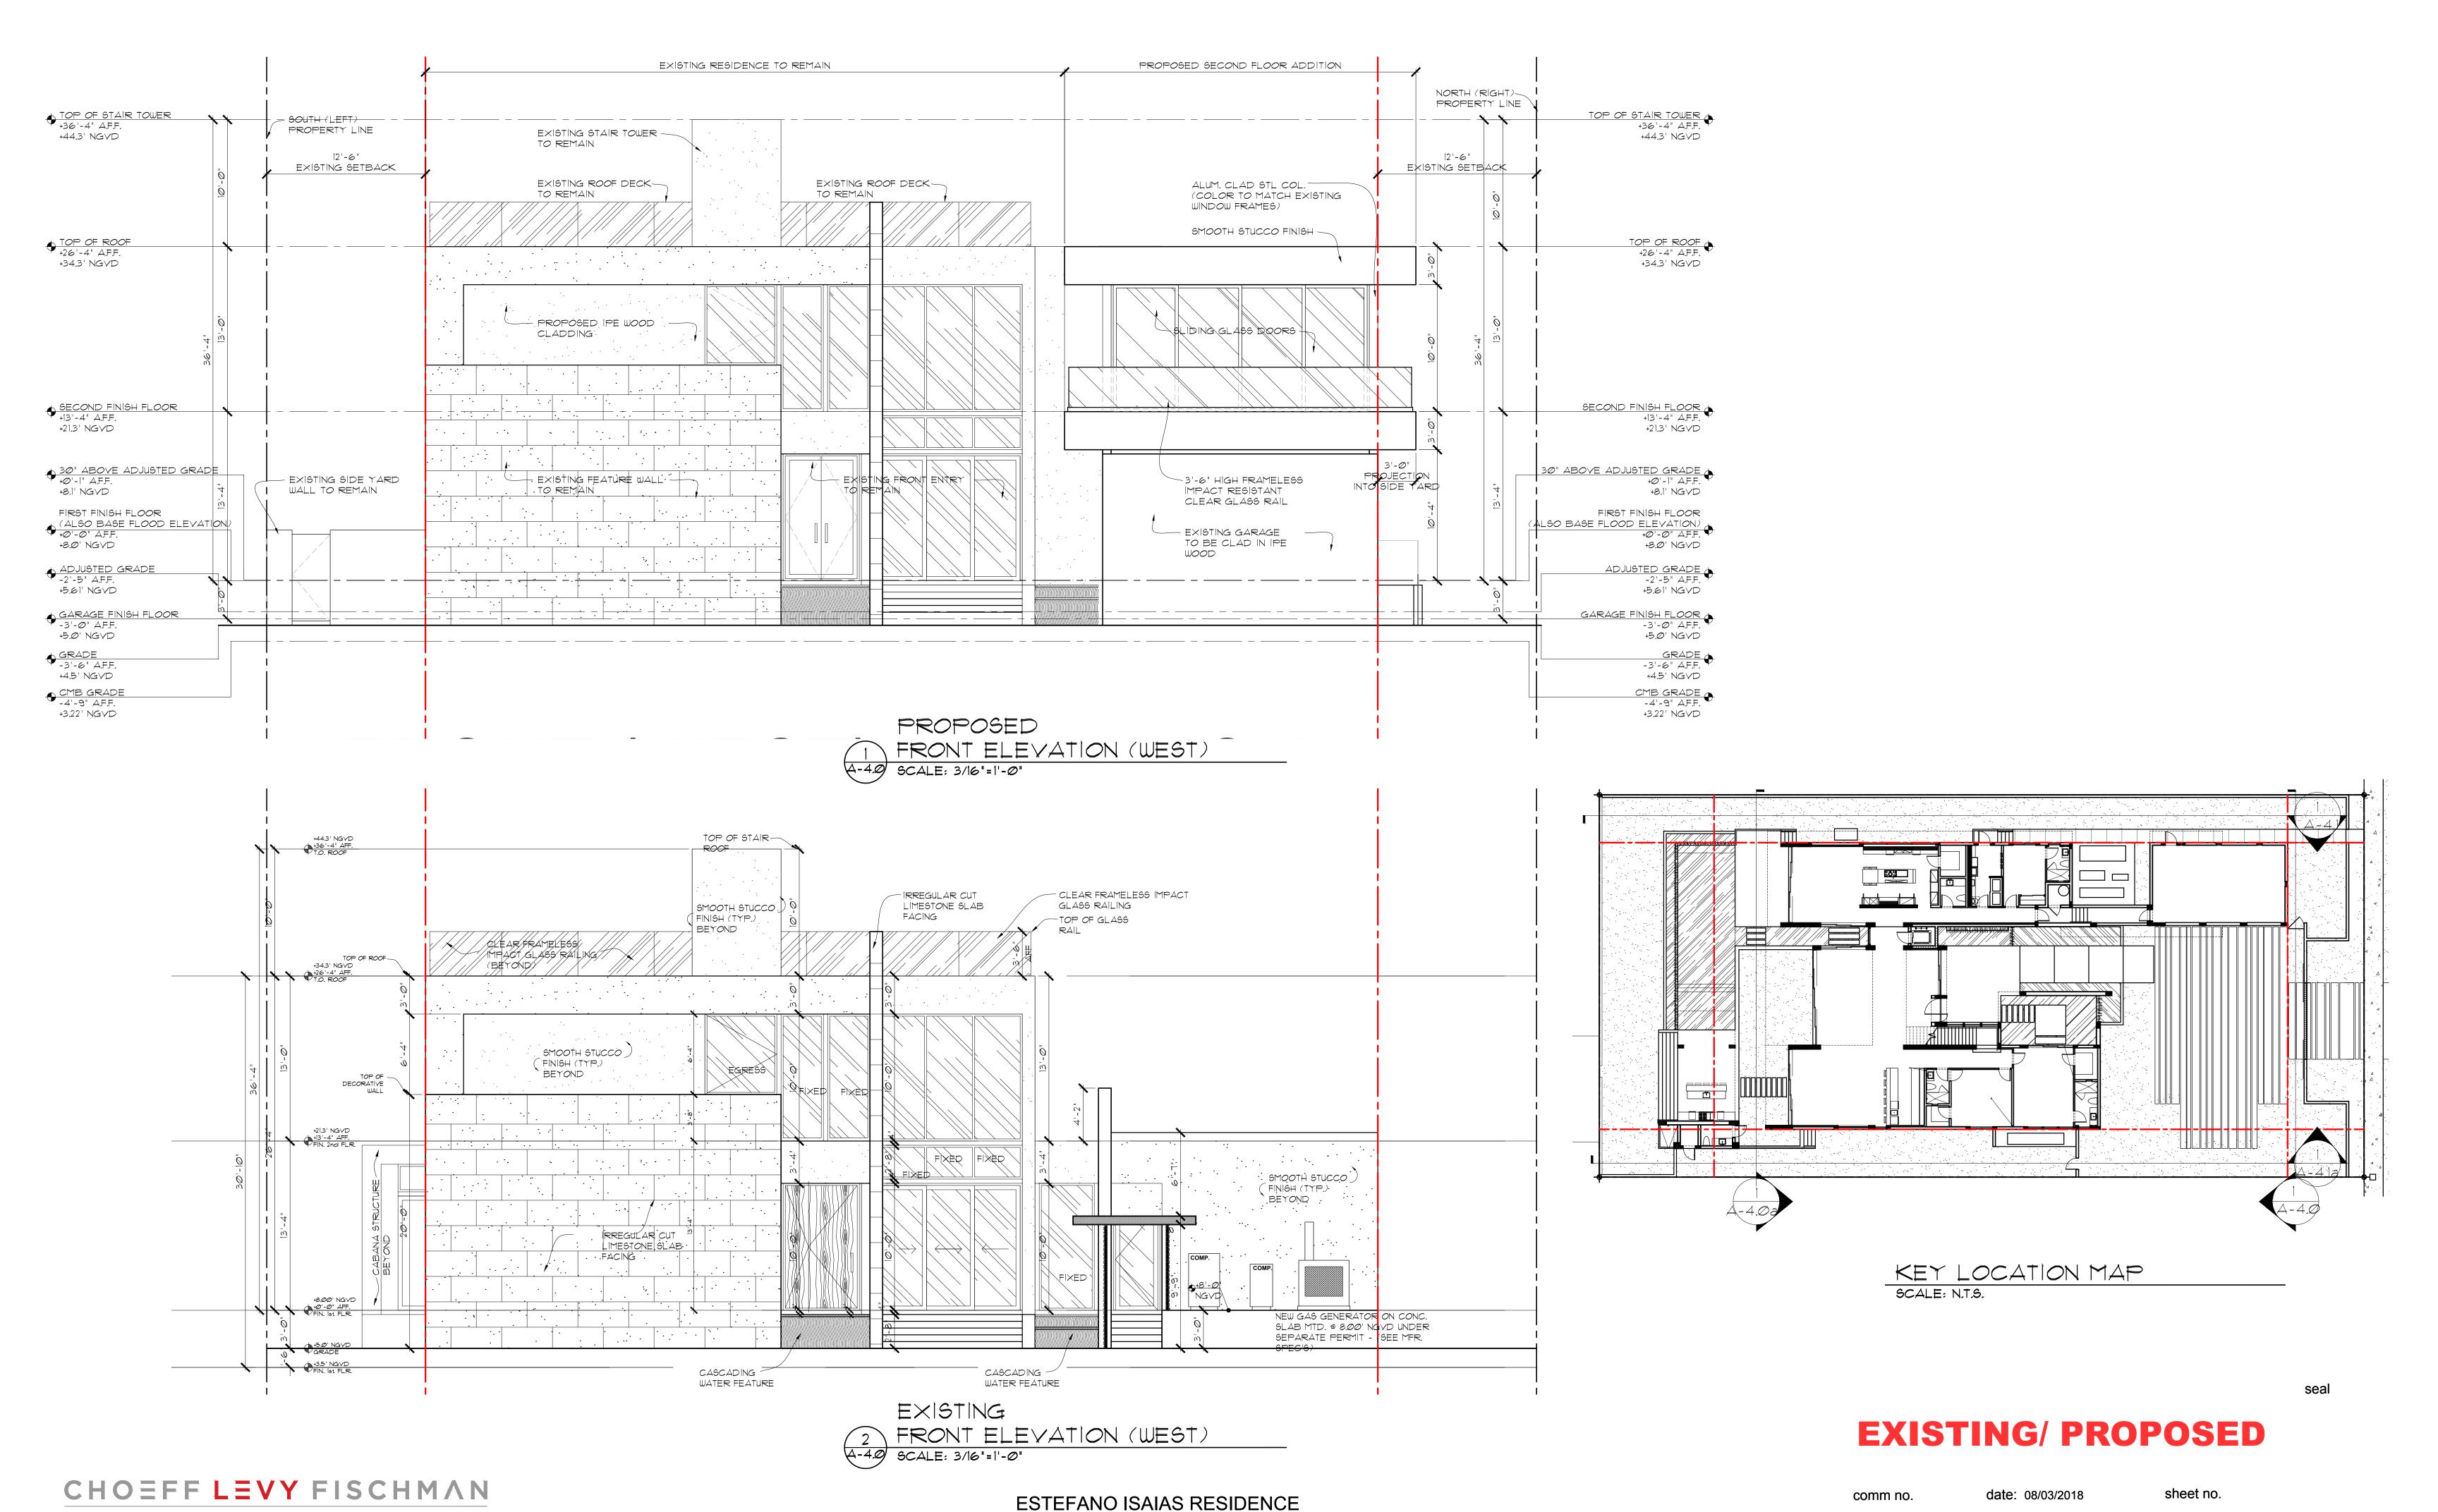
A-3.0







A-3.3

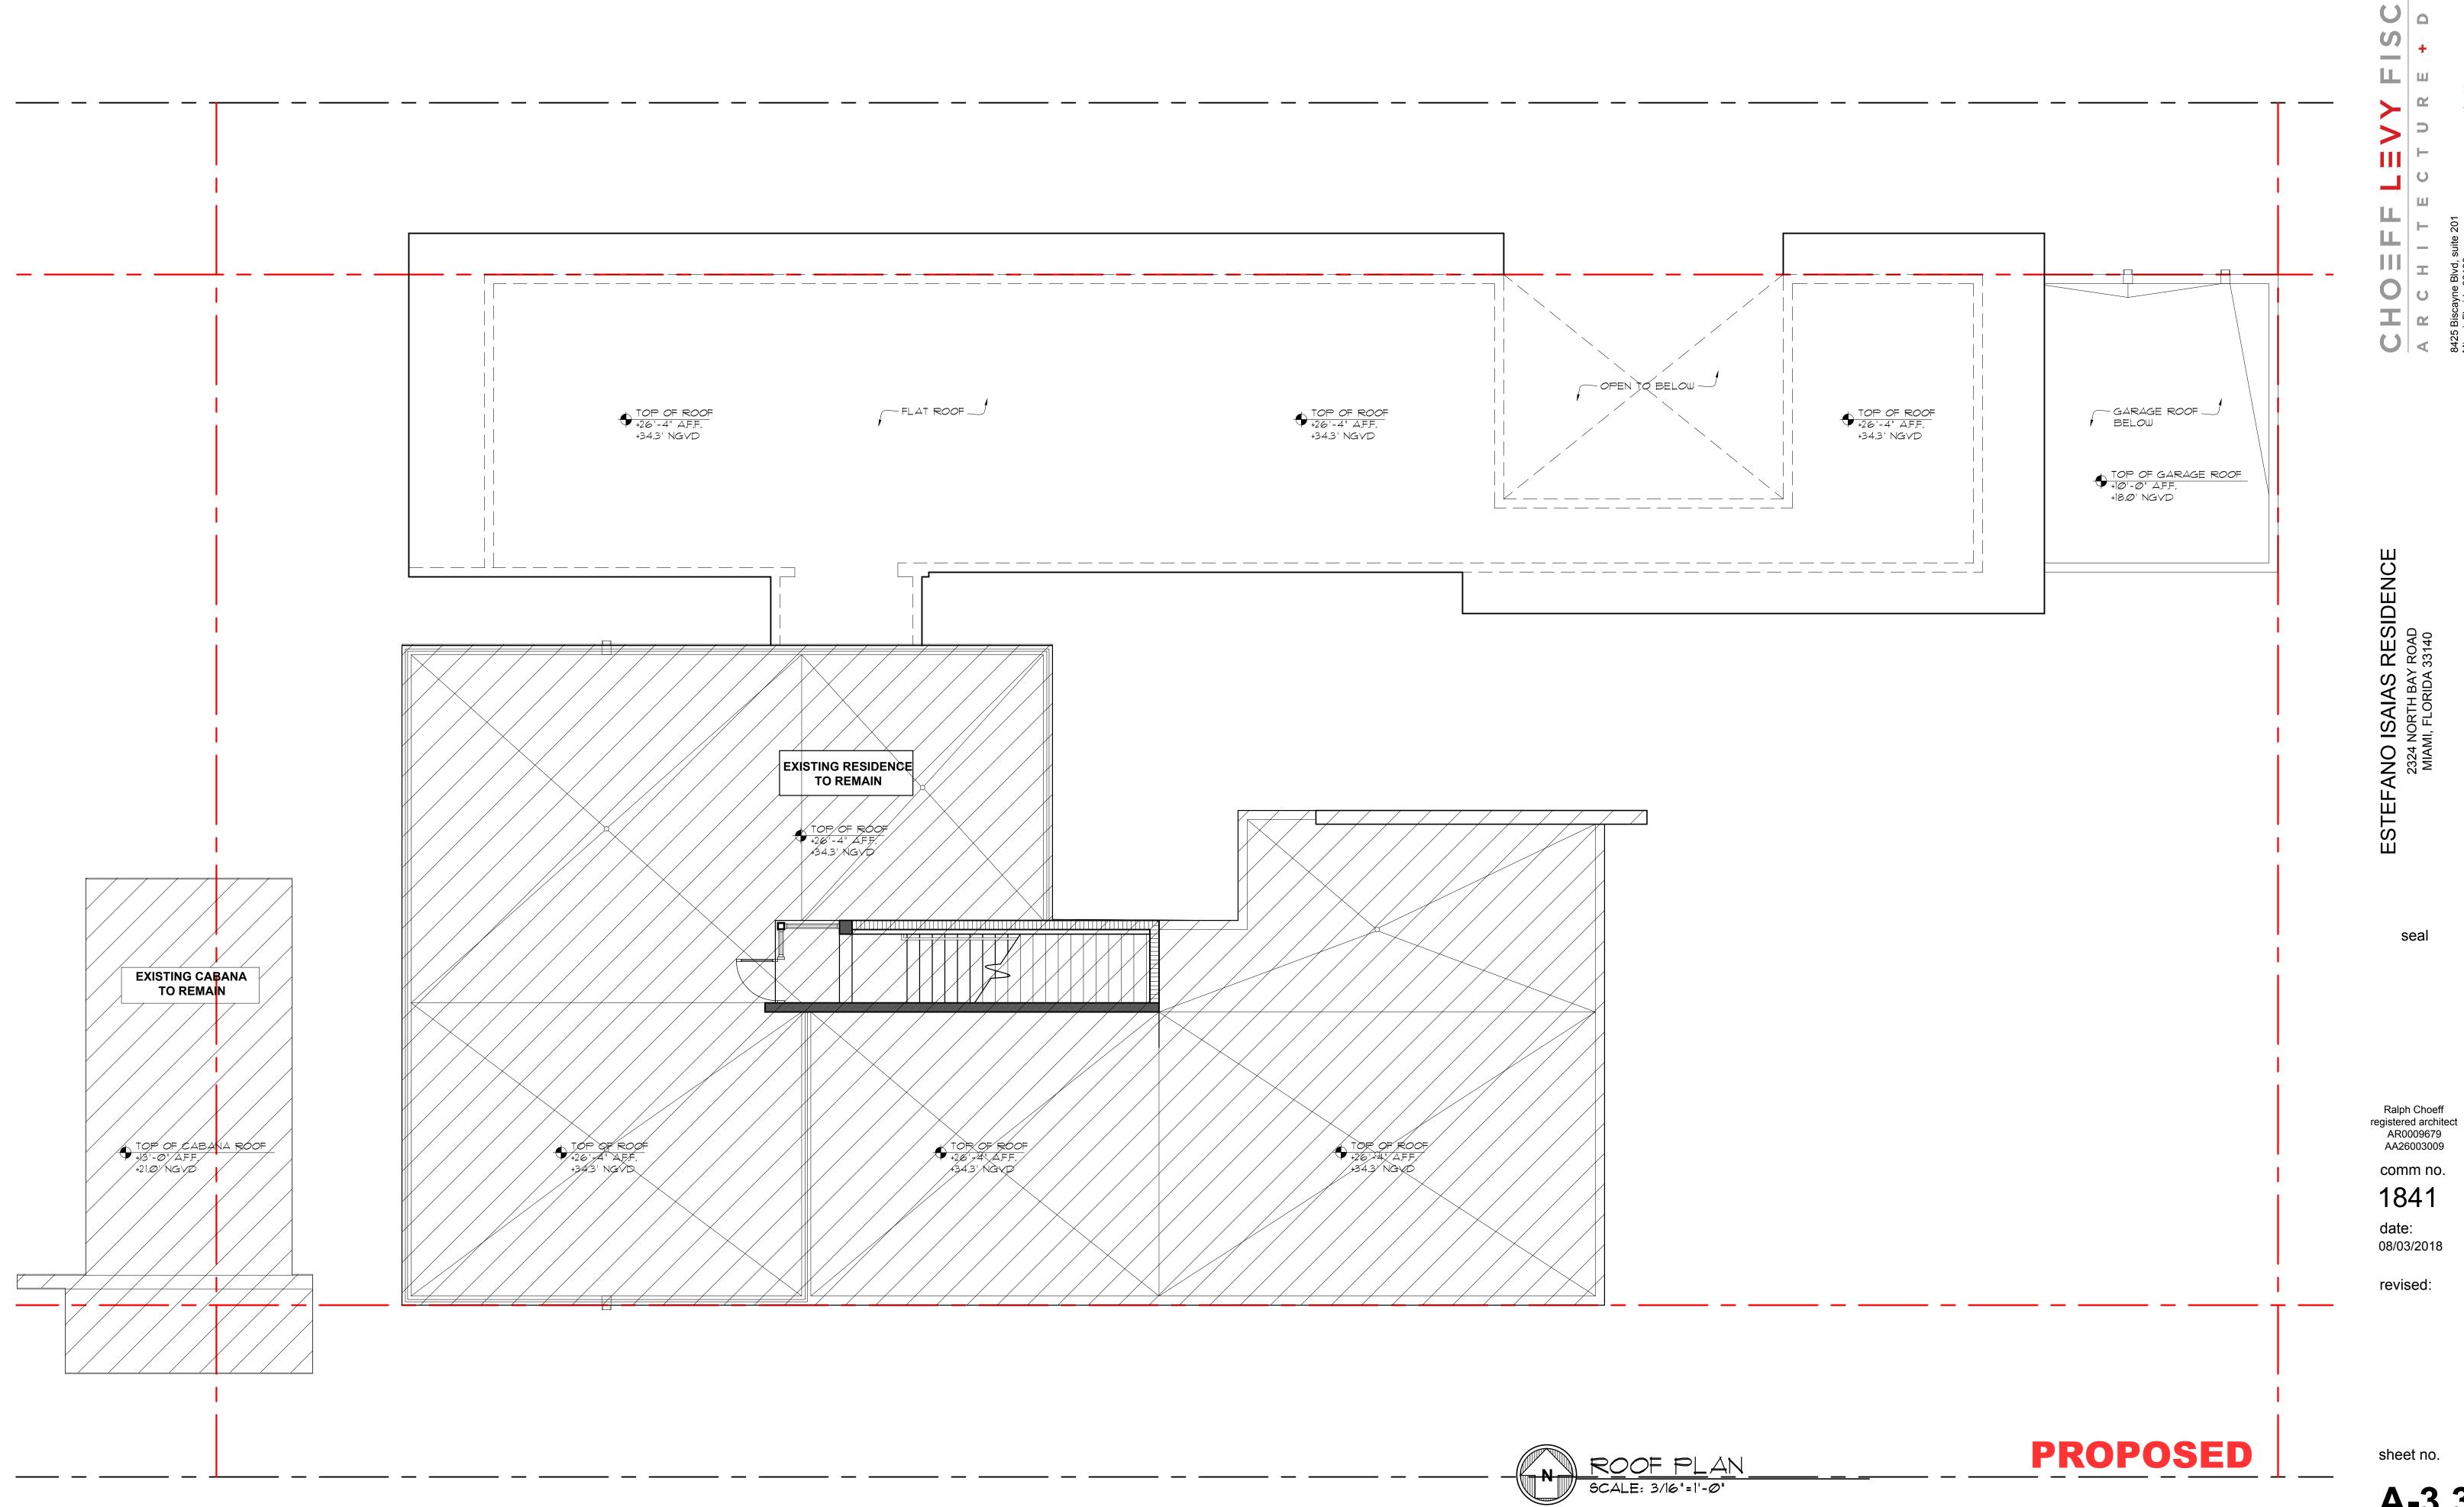

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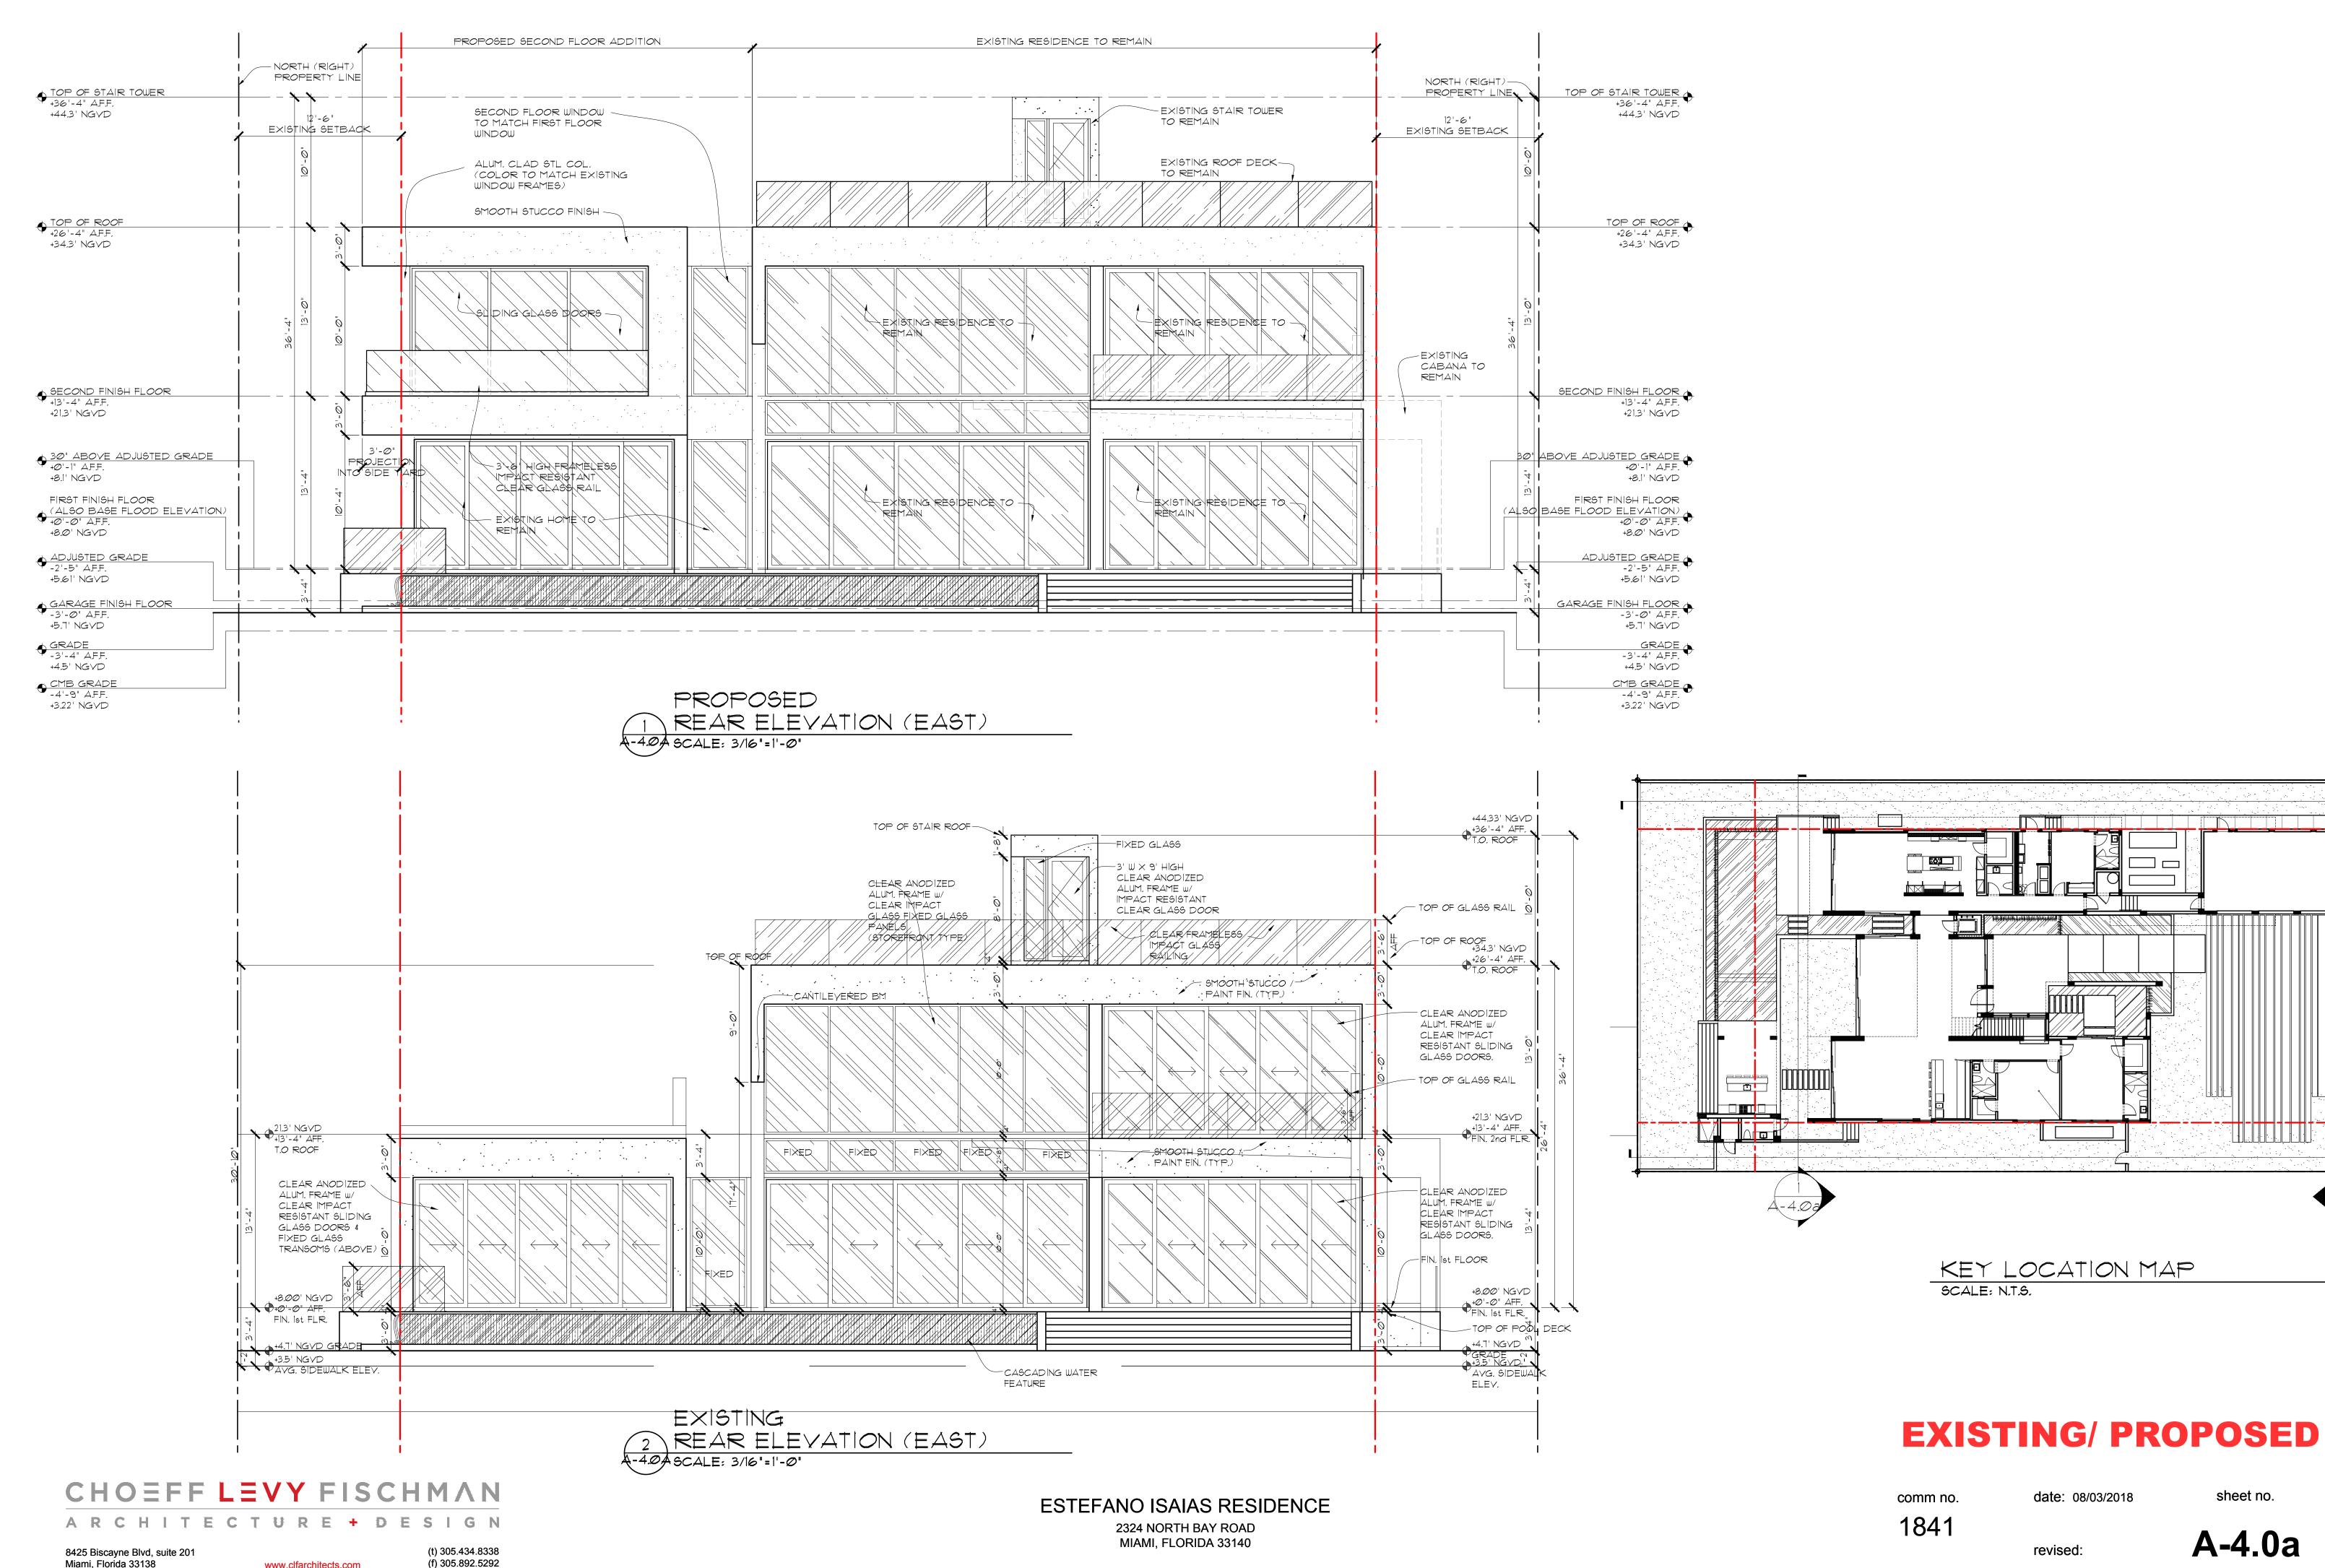
Miami, Florida 33138

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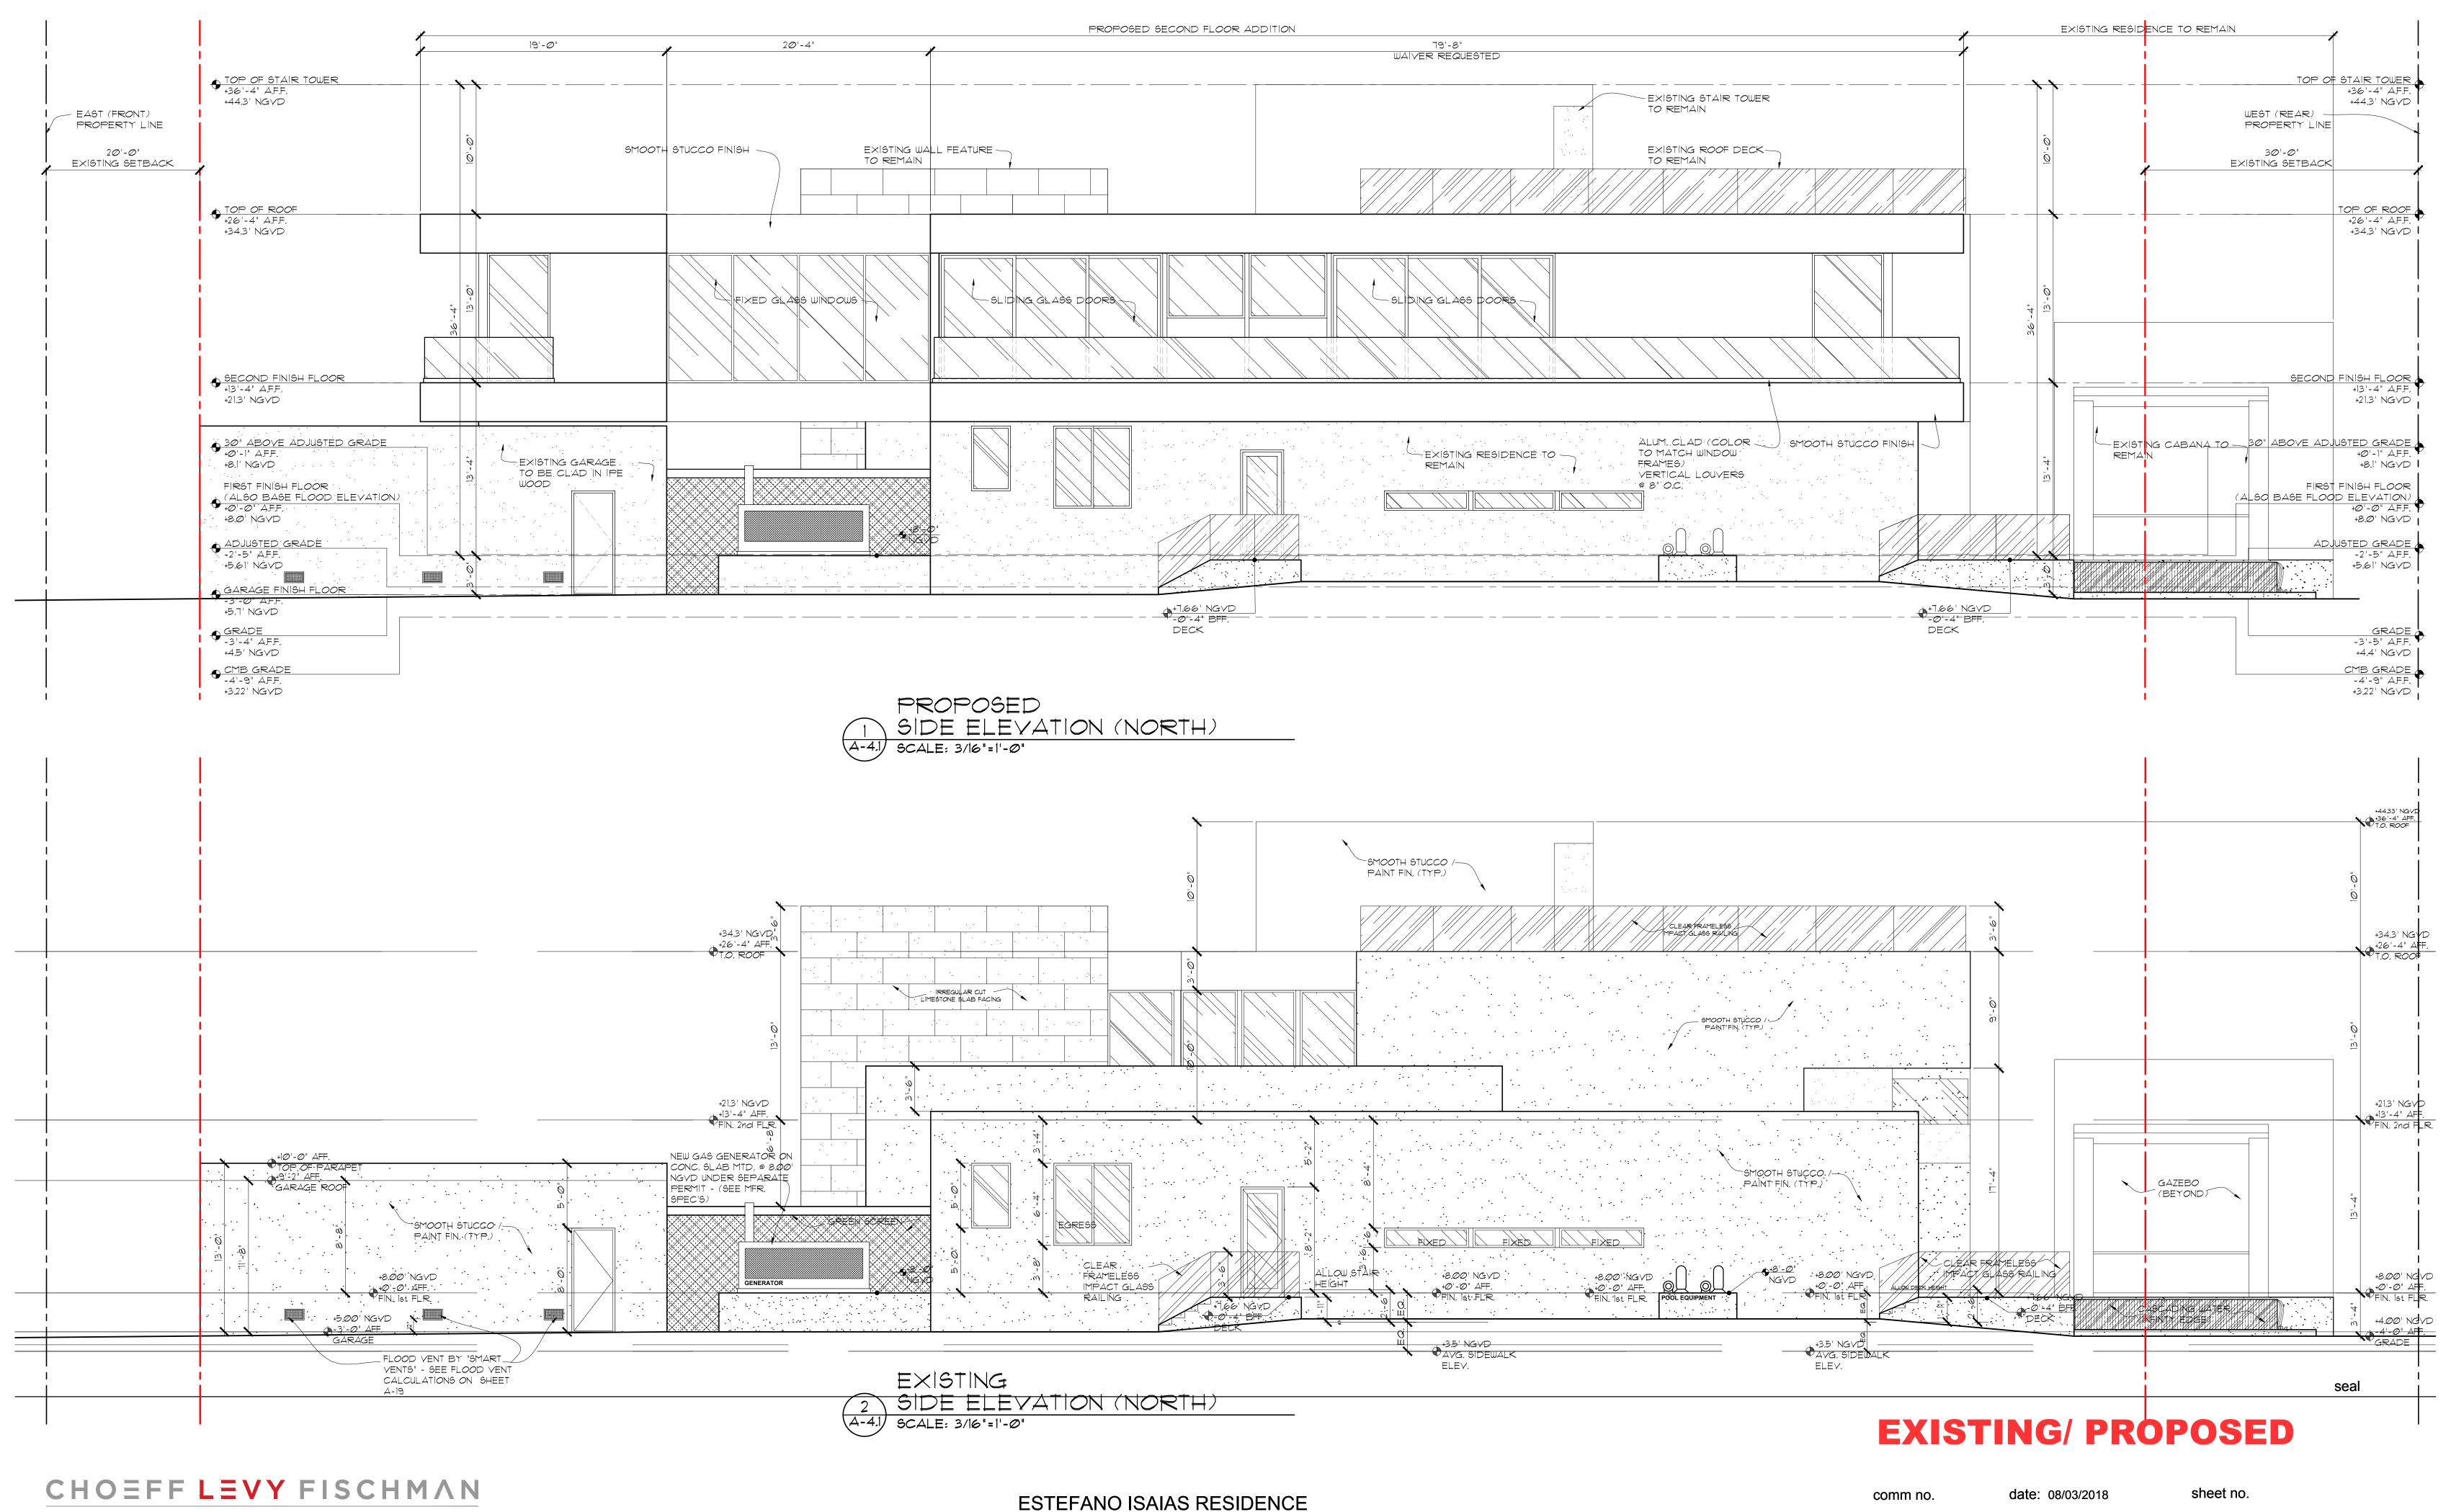
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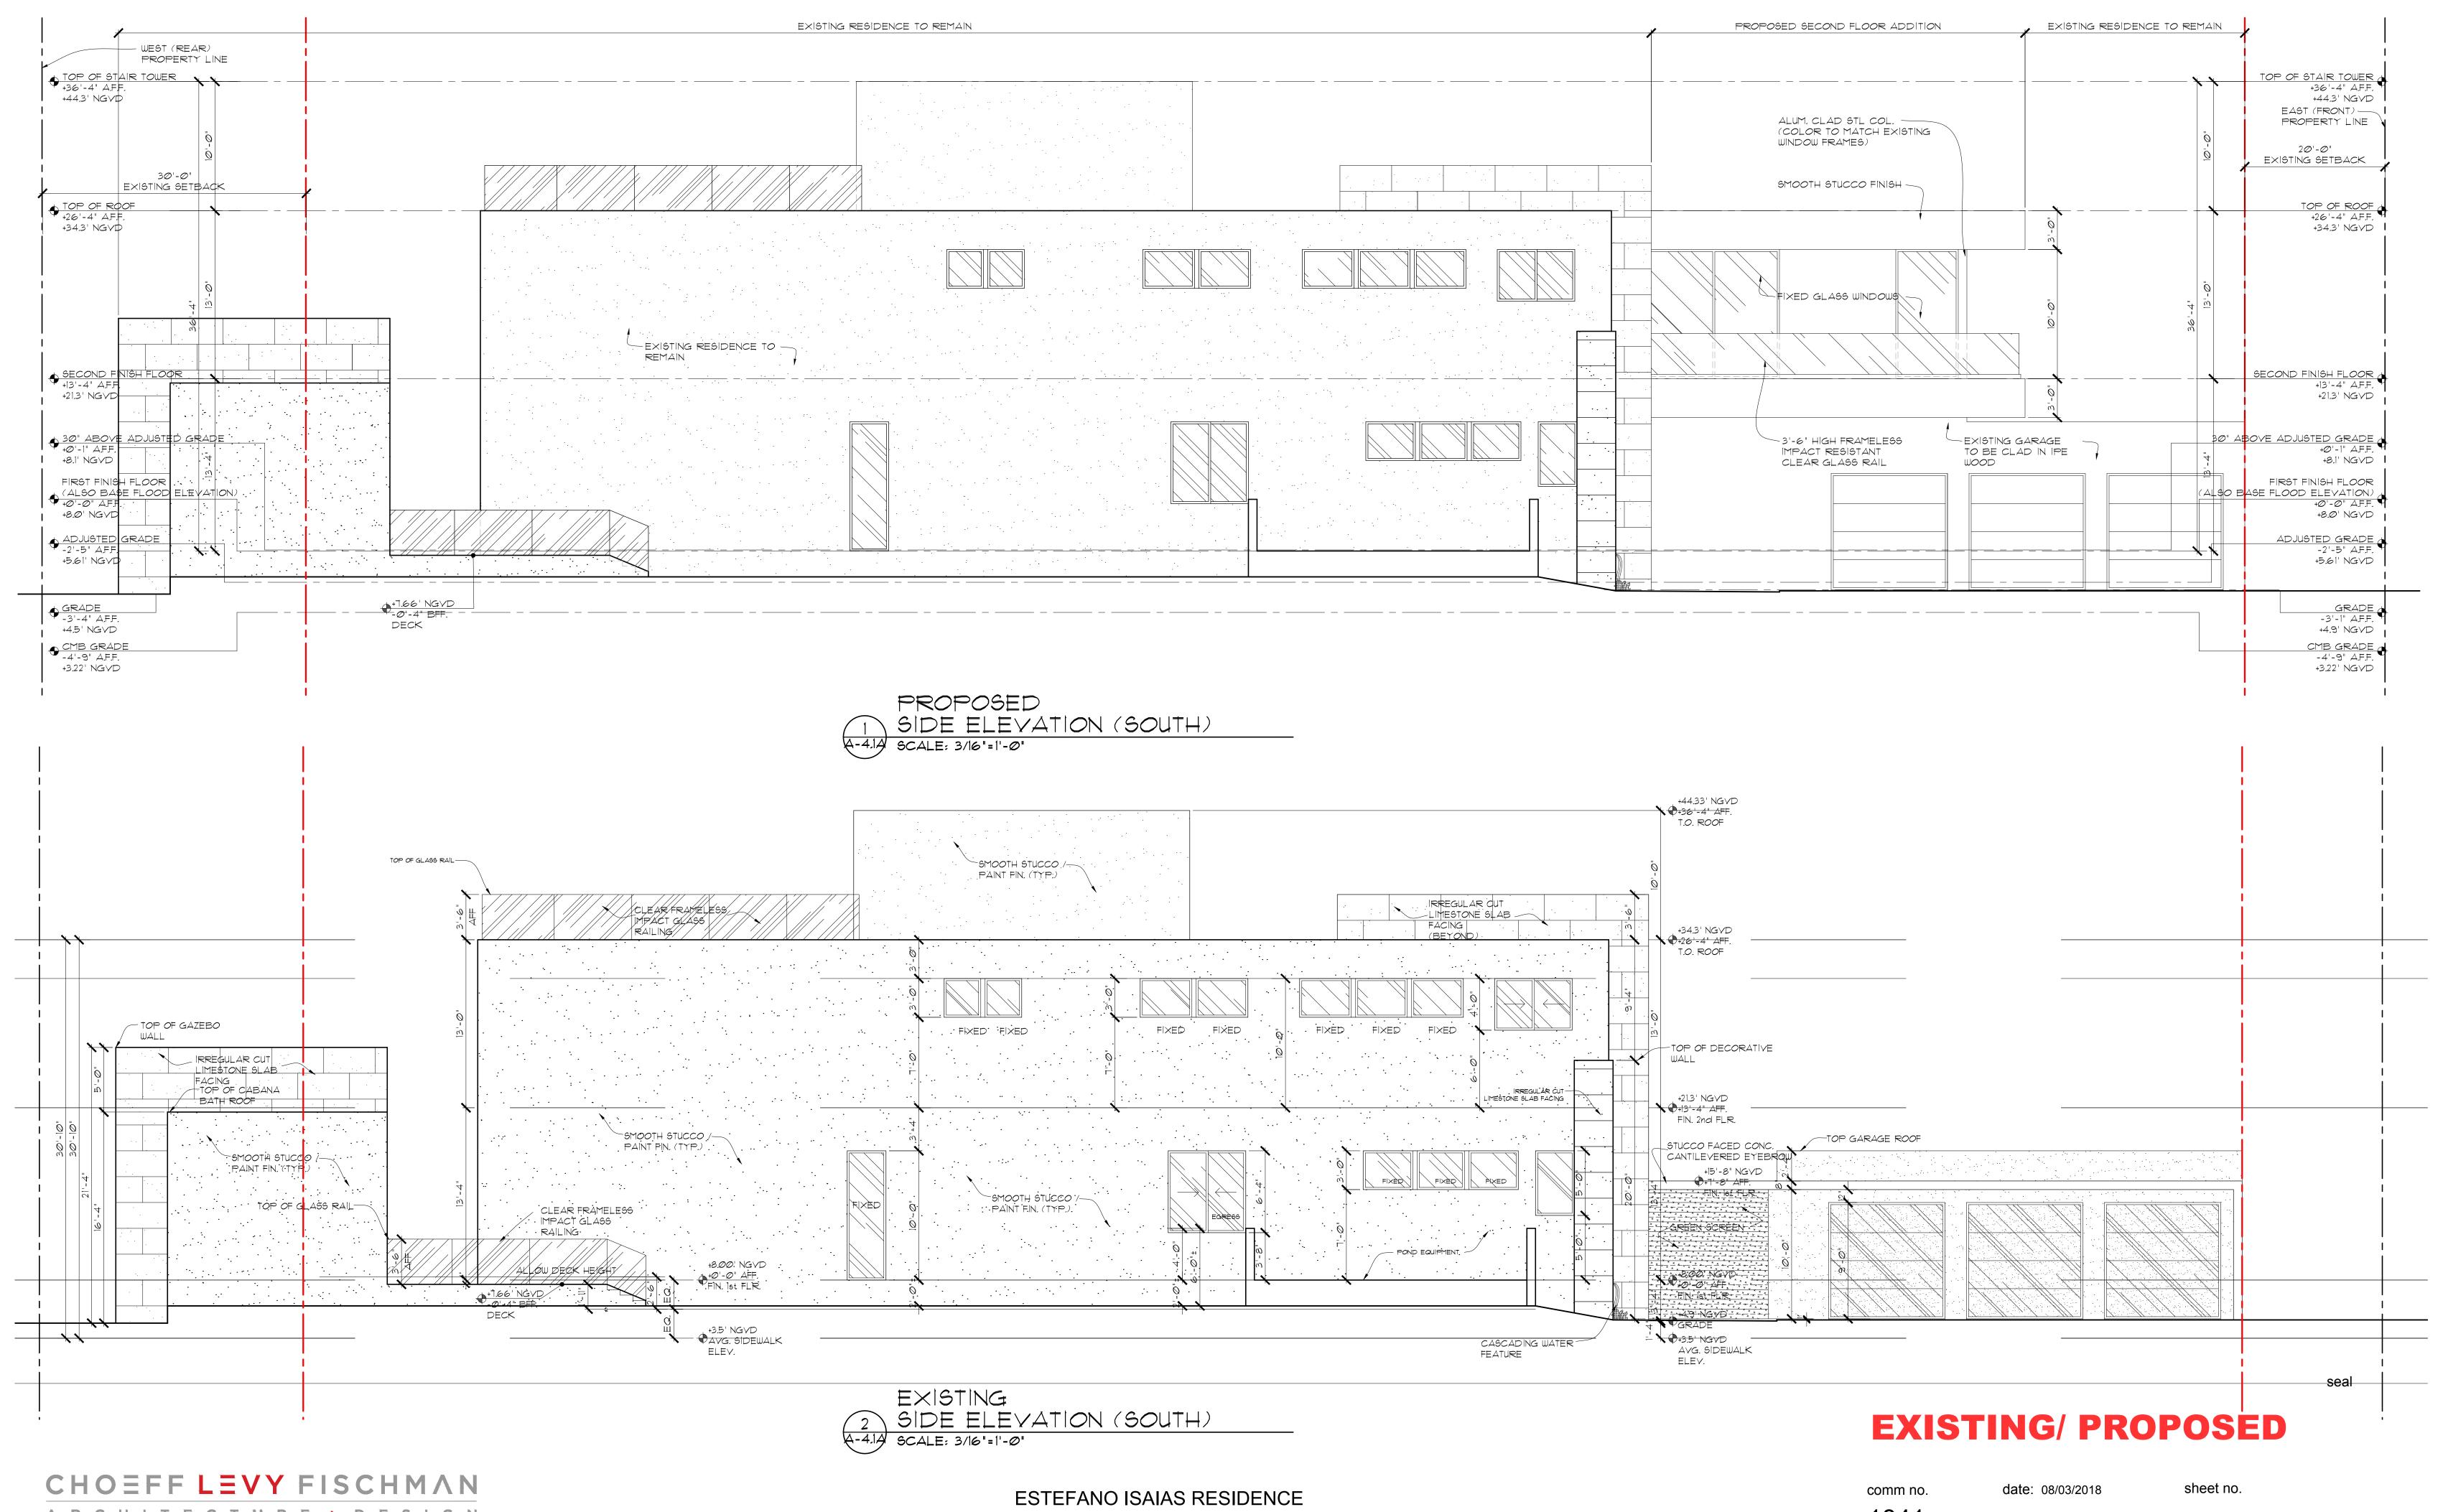
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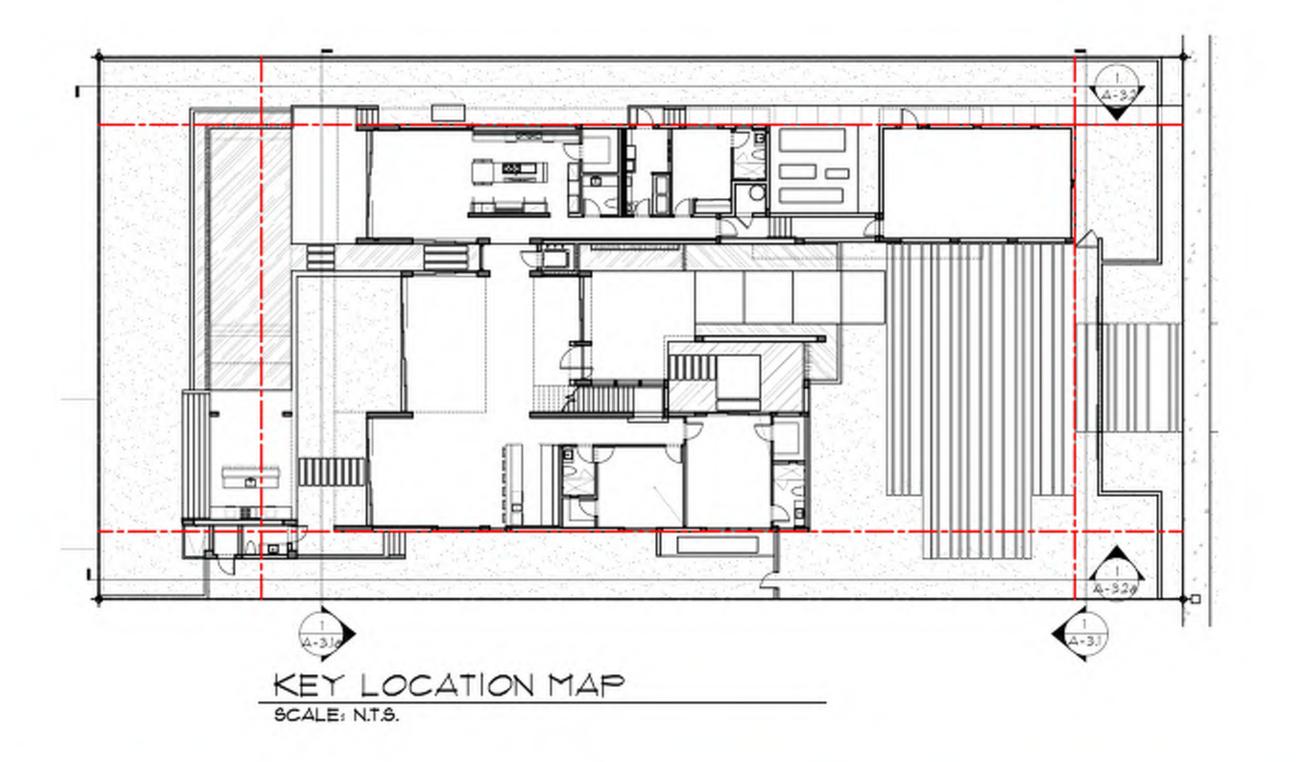
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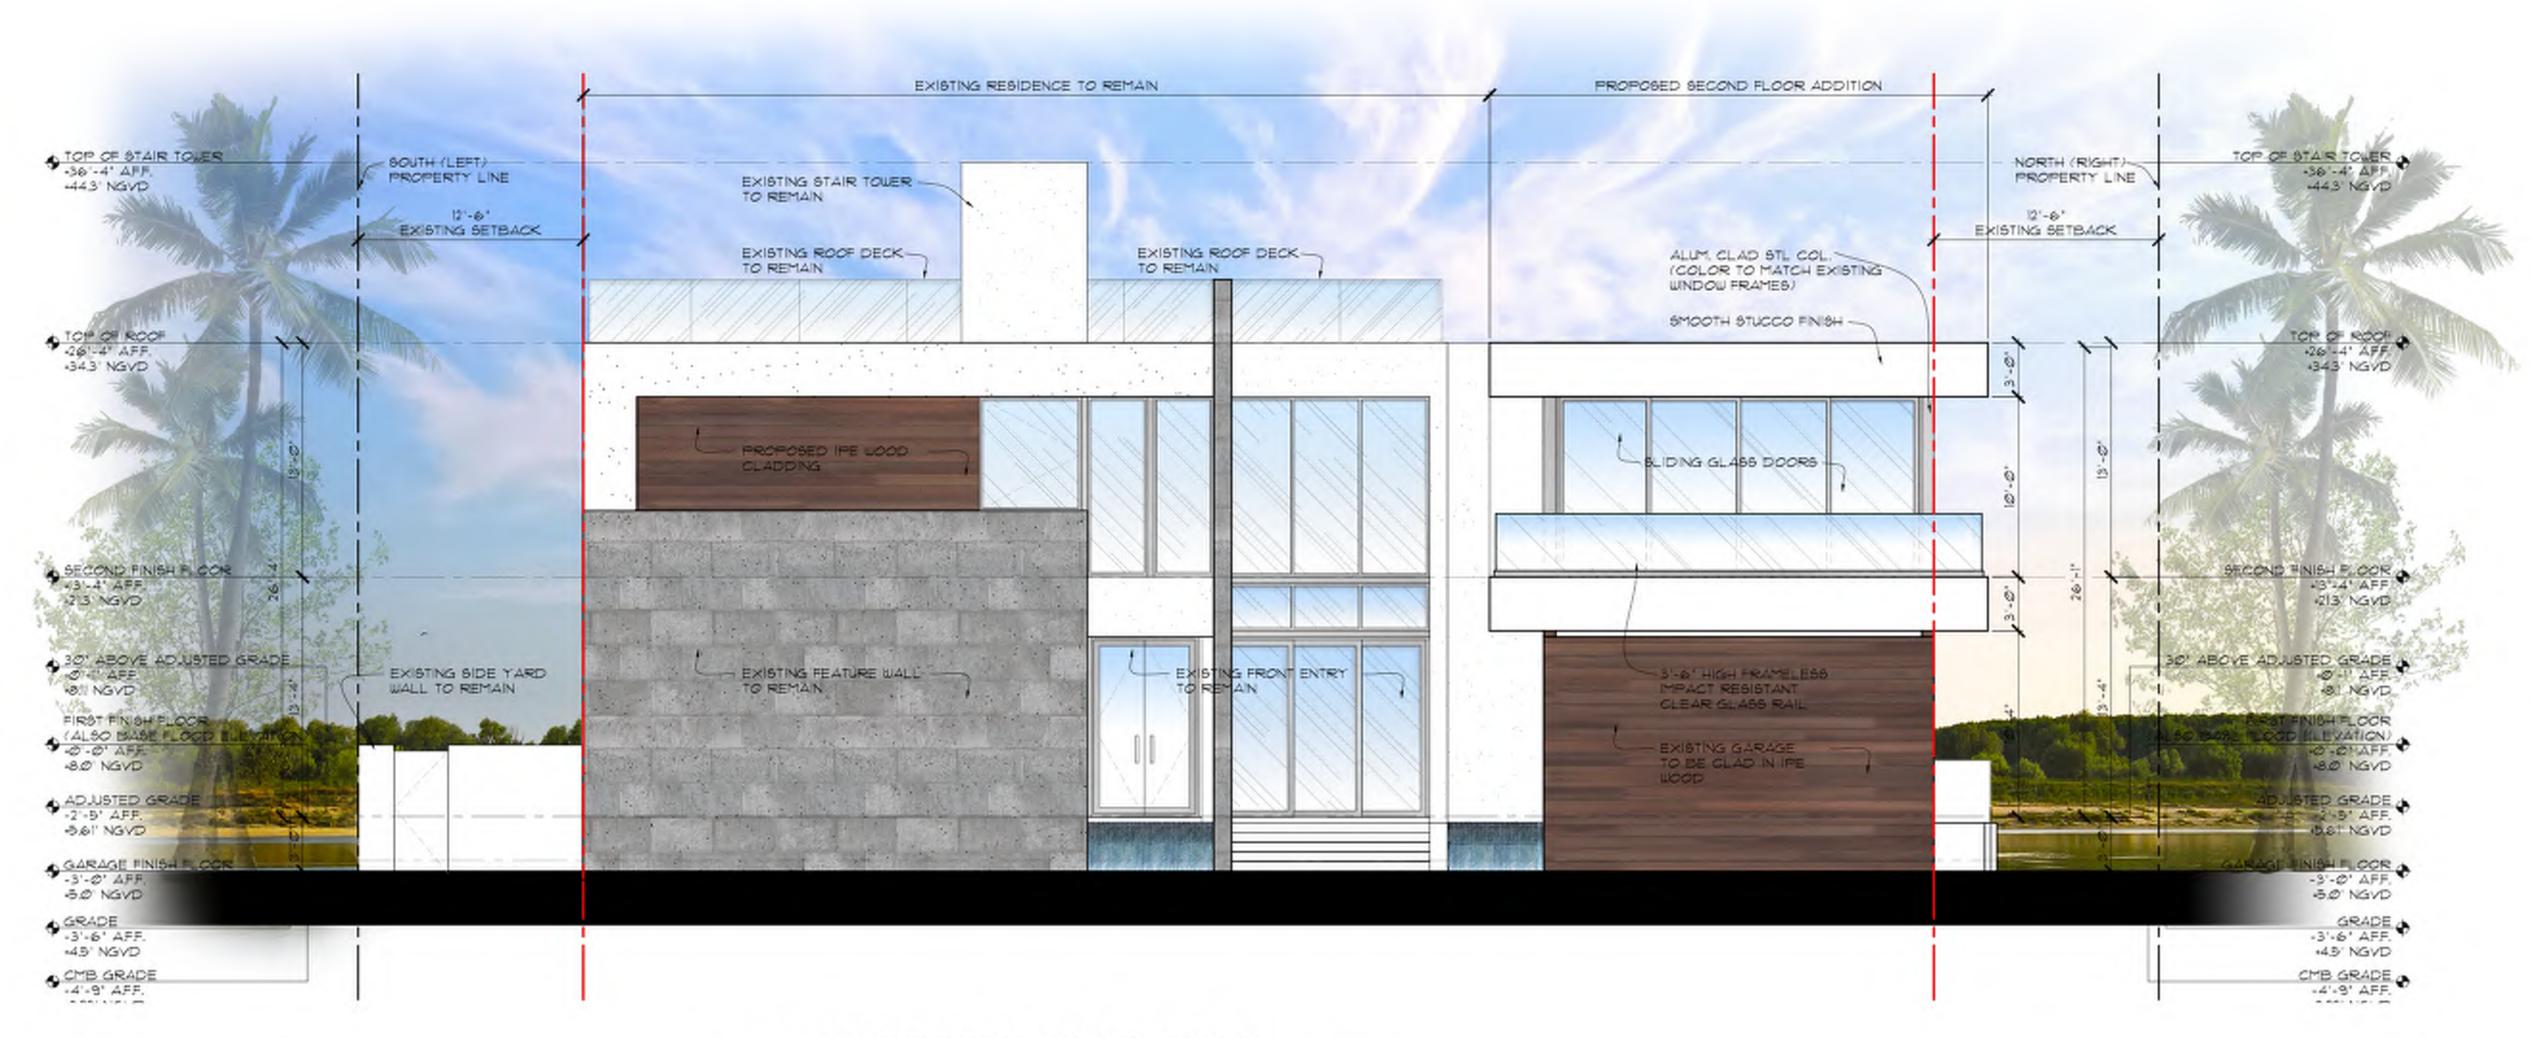
2324 NORTH BAY ROAD MIAMI, FLORIDA 33140

1841

revised:

registered architect AR0009679 AA26003009





FRONT ELEVATION (WEST)

SCALE: 3/16'=1'-0'

PROPOSED

comm no. 1841

date: 08/03/2018

revised:


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A-5.0


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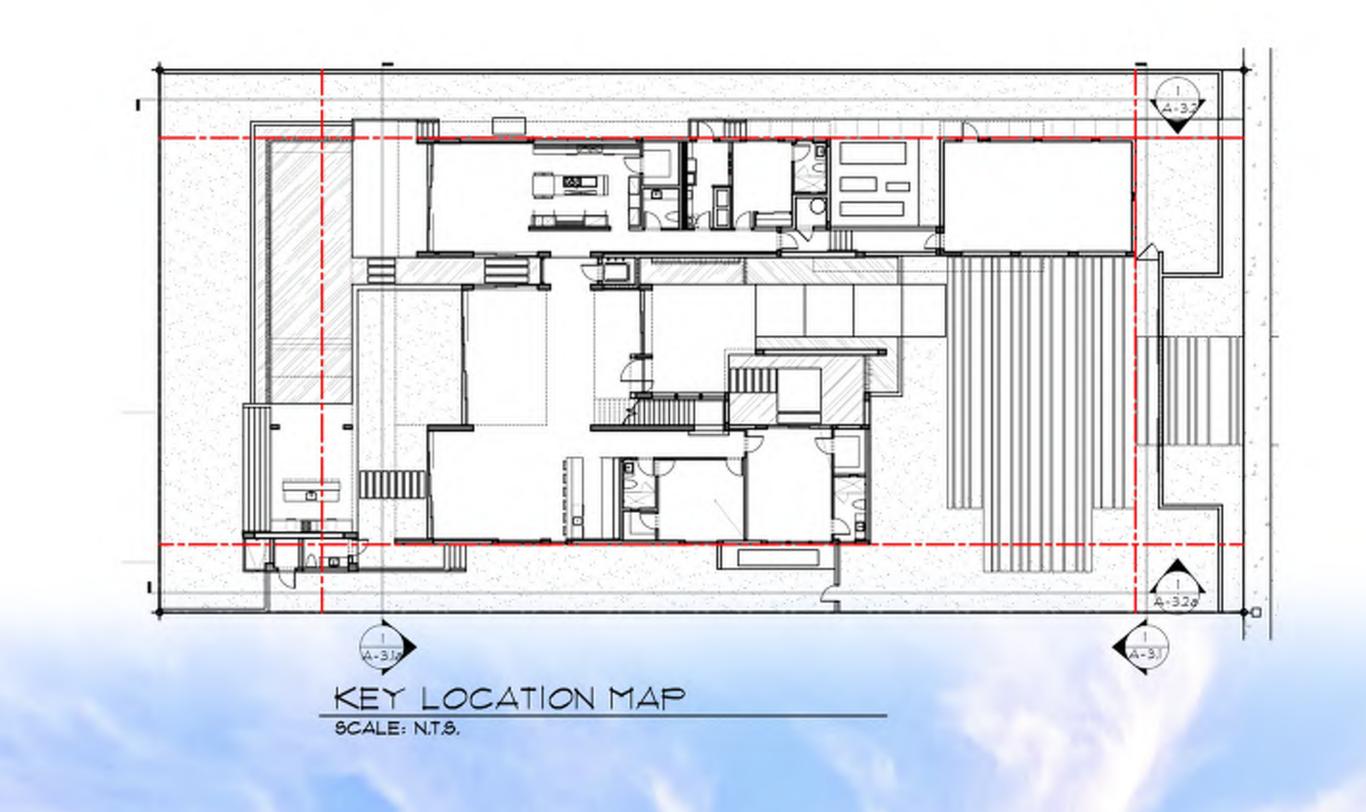
REAR ELEVATION (EAST) REAR ELEY

PROPOSED

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Miami, Florida 33138

seal

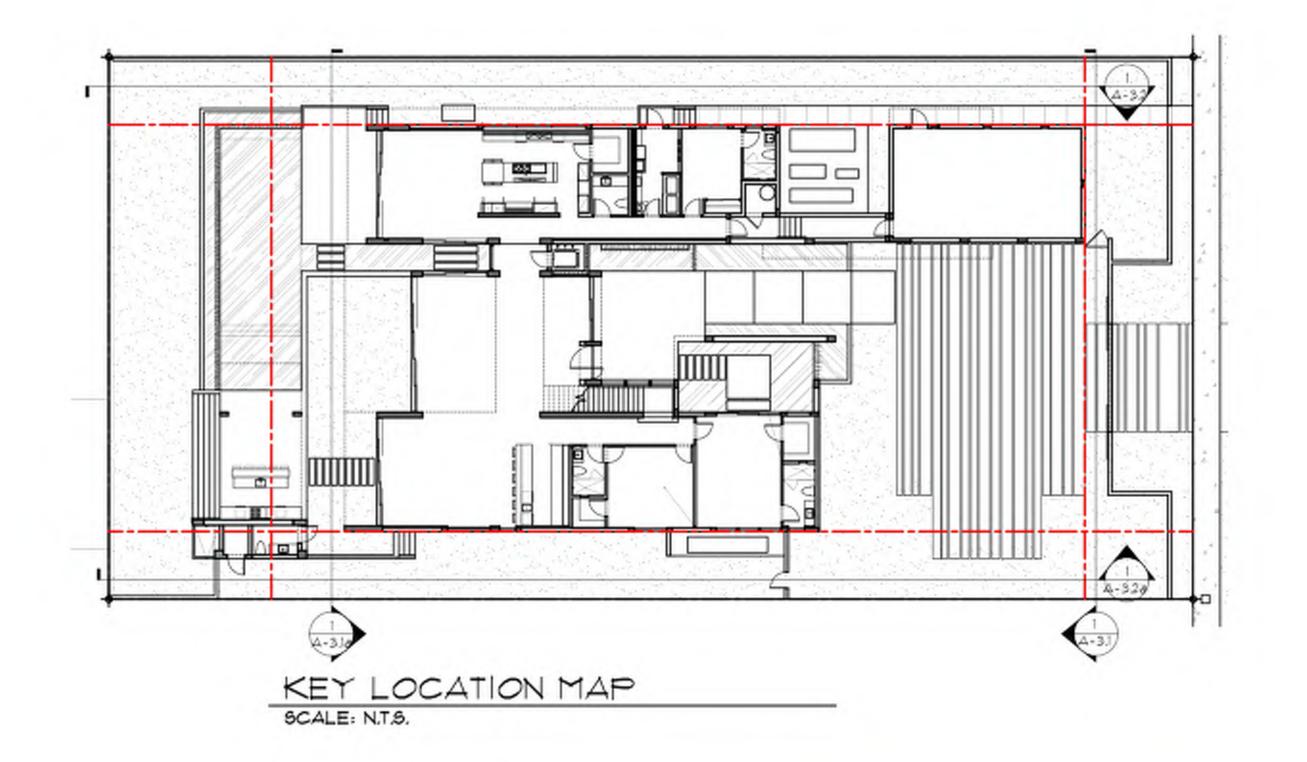

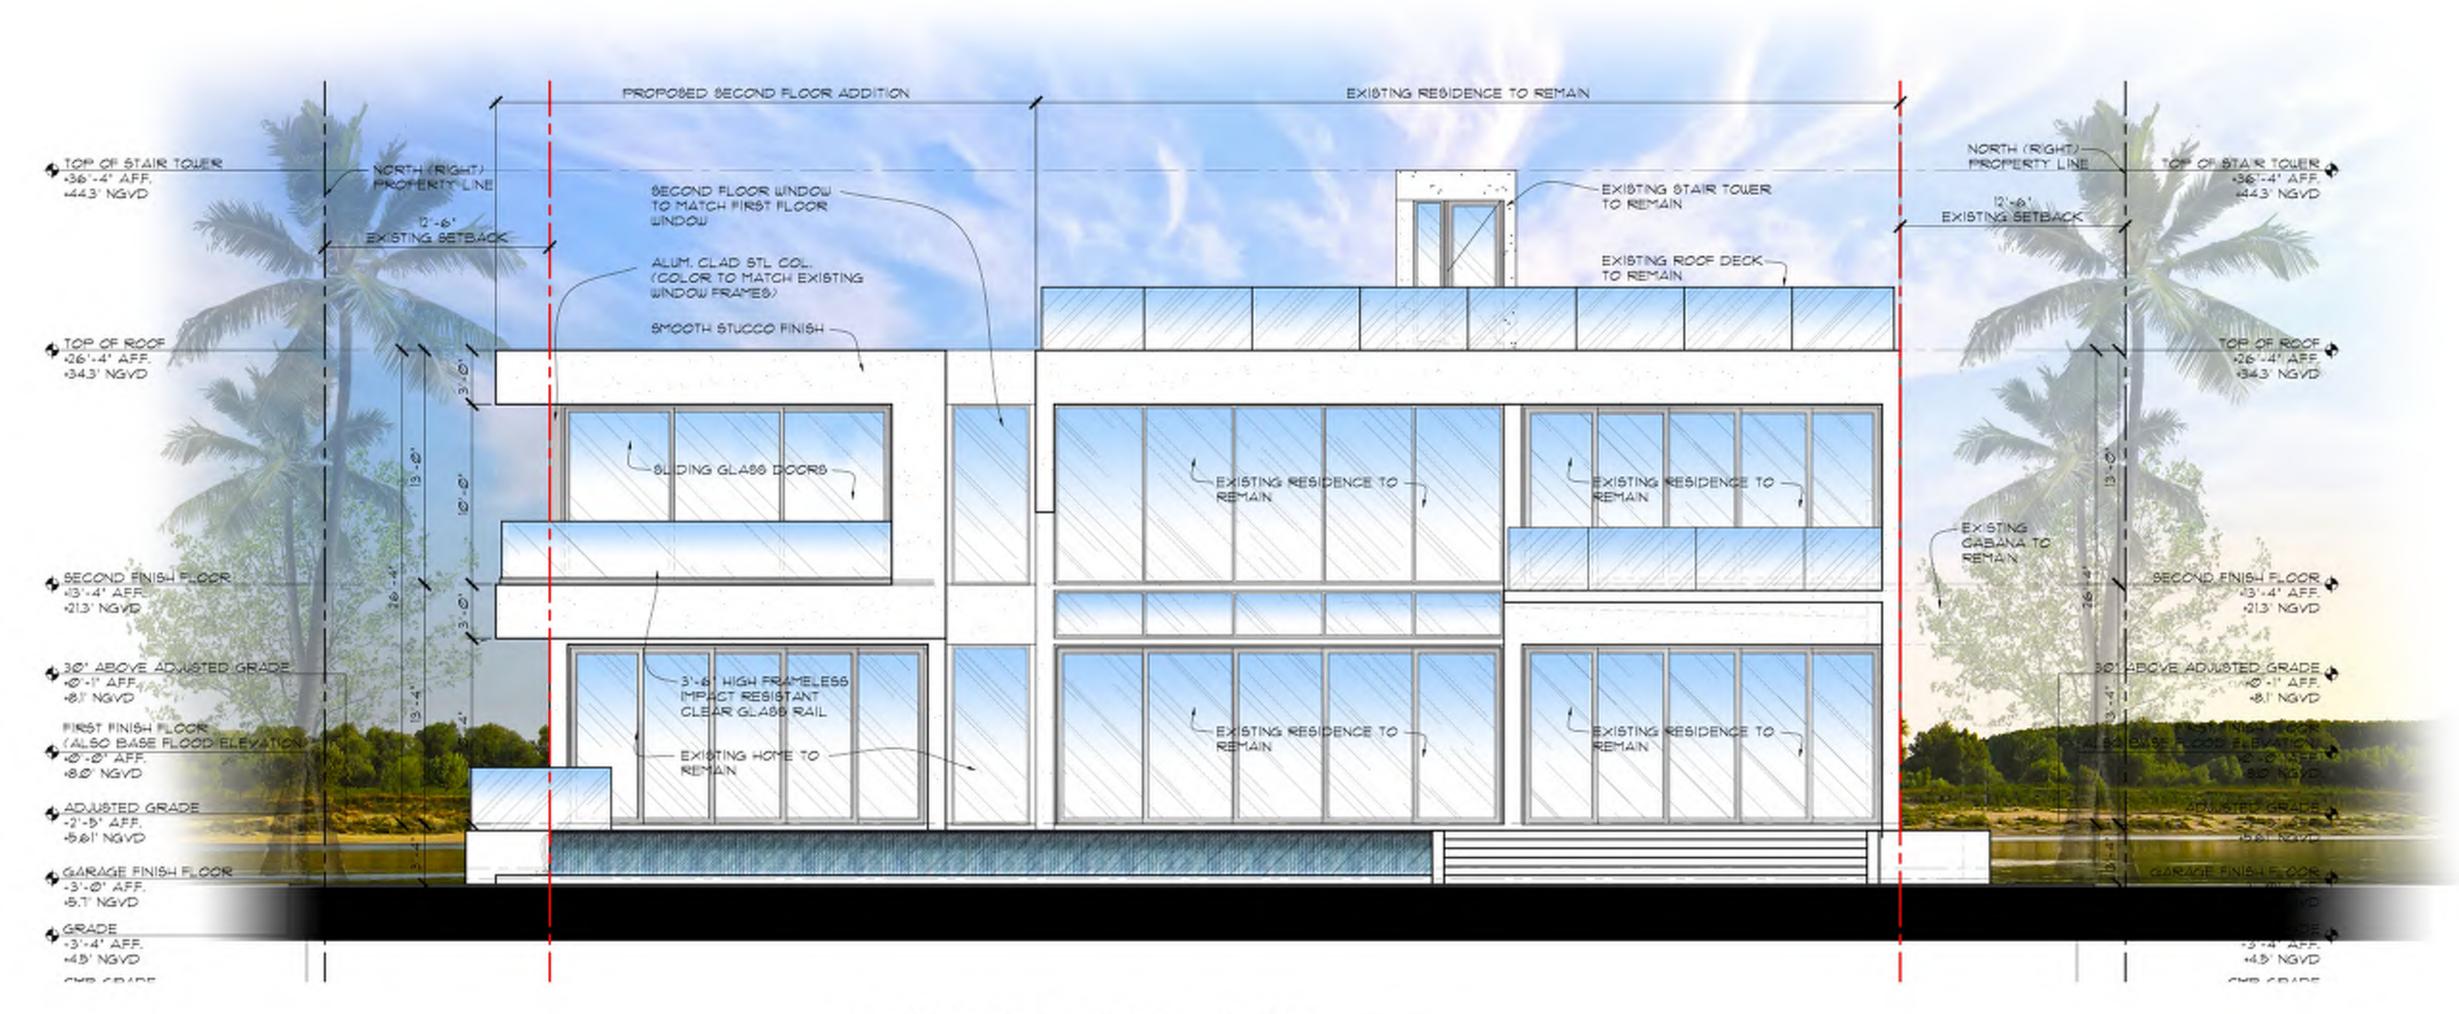

FRONT ELEVATION (WEST) FRONT ELE 4-32 SCALE: 3/16'=1'-0'

seal

Ralph Choeff registered architect

AR0009679 AA26003009

PROPOSED

date: 08/03/2018 comm no.

1841

sheet no.

revised:

A-5.1

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FRONT ELEVATION (WEST)

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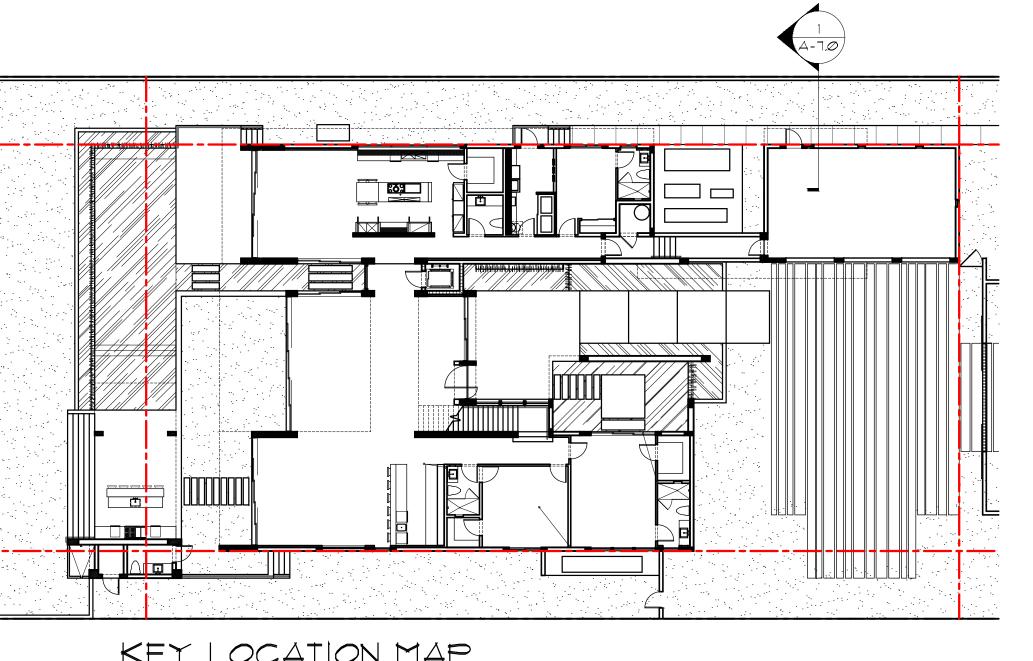
date: 08/03/2018

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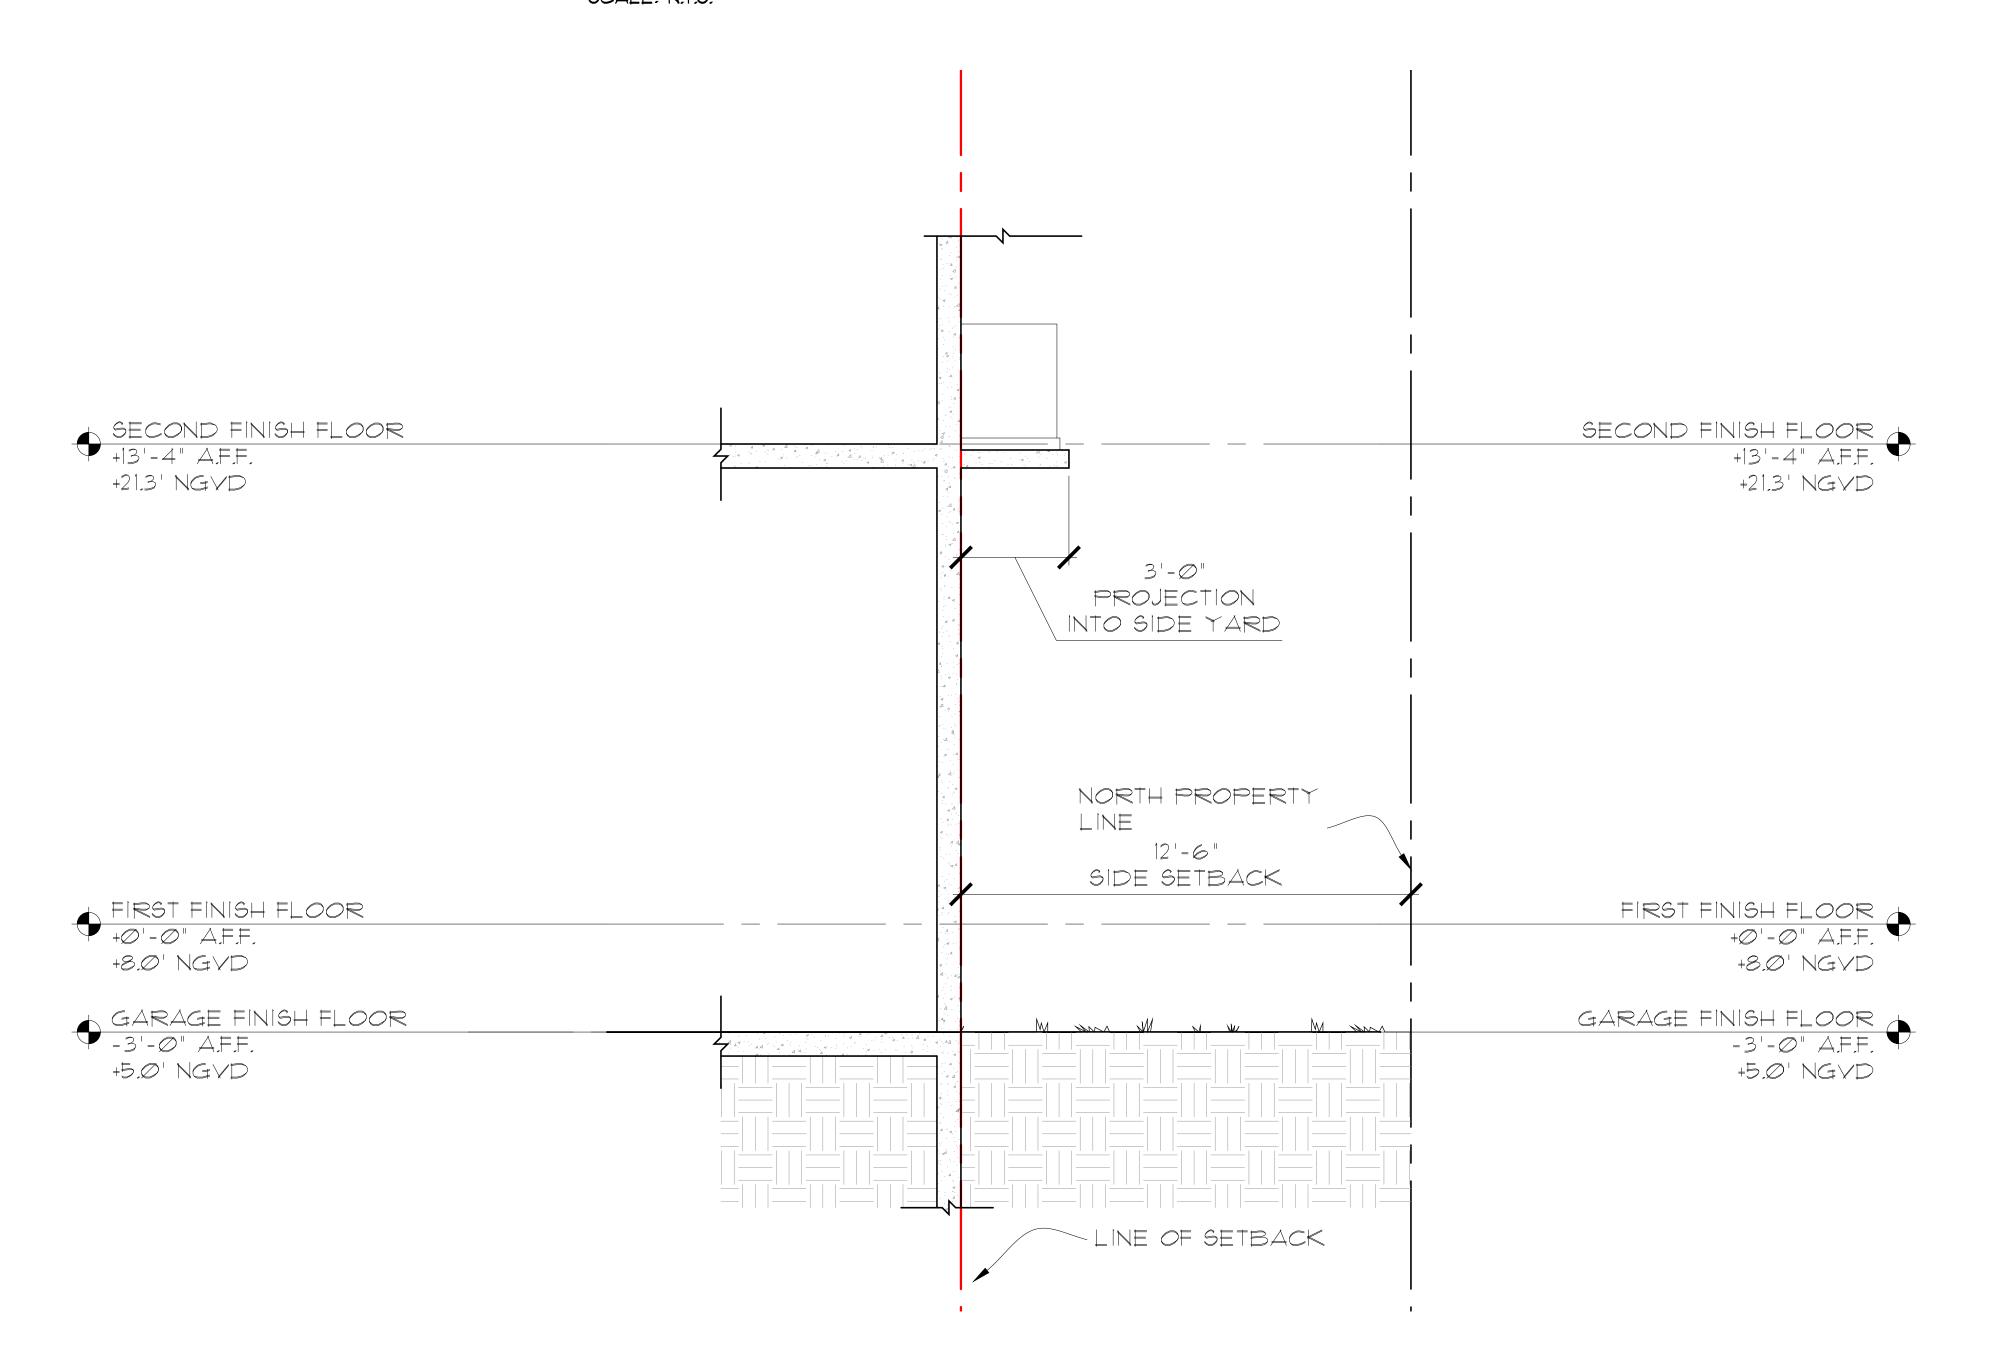
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SIDE YARD PROJECTION DIAGRAM

SCALE: 3/8"=1'-0"

Ralph Choeff registered architect AR0009679 AA26003009 comm no. 1841 date:

08/03/2018

revised:

PROPOSED

ALLOWED SECOND / FIRST FLOOR RATIO :

LOT SIZE:

FIRST FLOOR ---

SECOND FLOOR ____

SECOND FLOOR IS ____

WAIVER REQUESTED
PROPOSED:


— 2*0,000* S.F.

— 3,760 S.F.

(70,0 %)

SECOND / FIRST FLOOR RATIO :

LOT SIZE:	2 <i>Ø,ØØØ</i> S.
FIRST FLOOR ———————————————————————————————————	5,371 S. 5,234 S.
SECOND EL COR IS	(OT 4 6

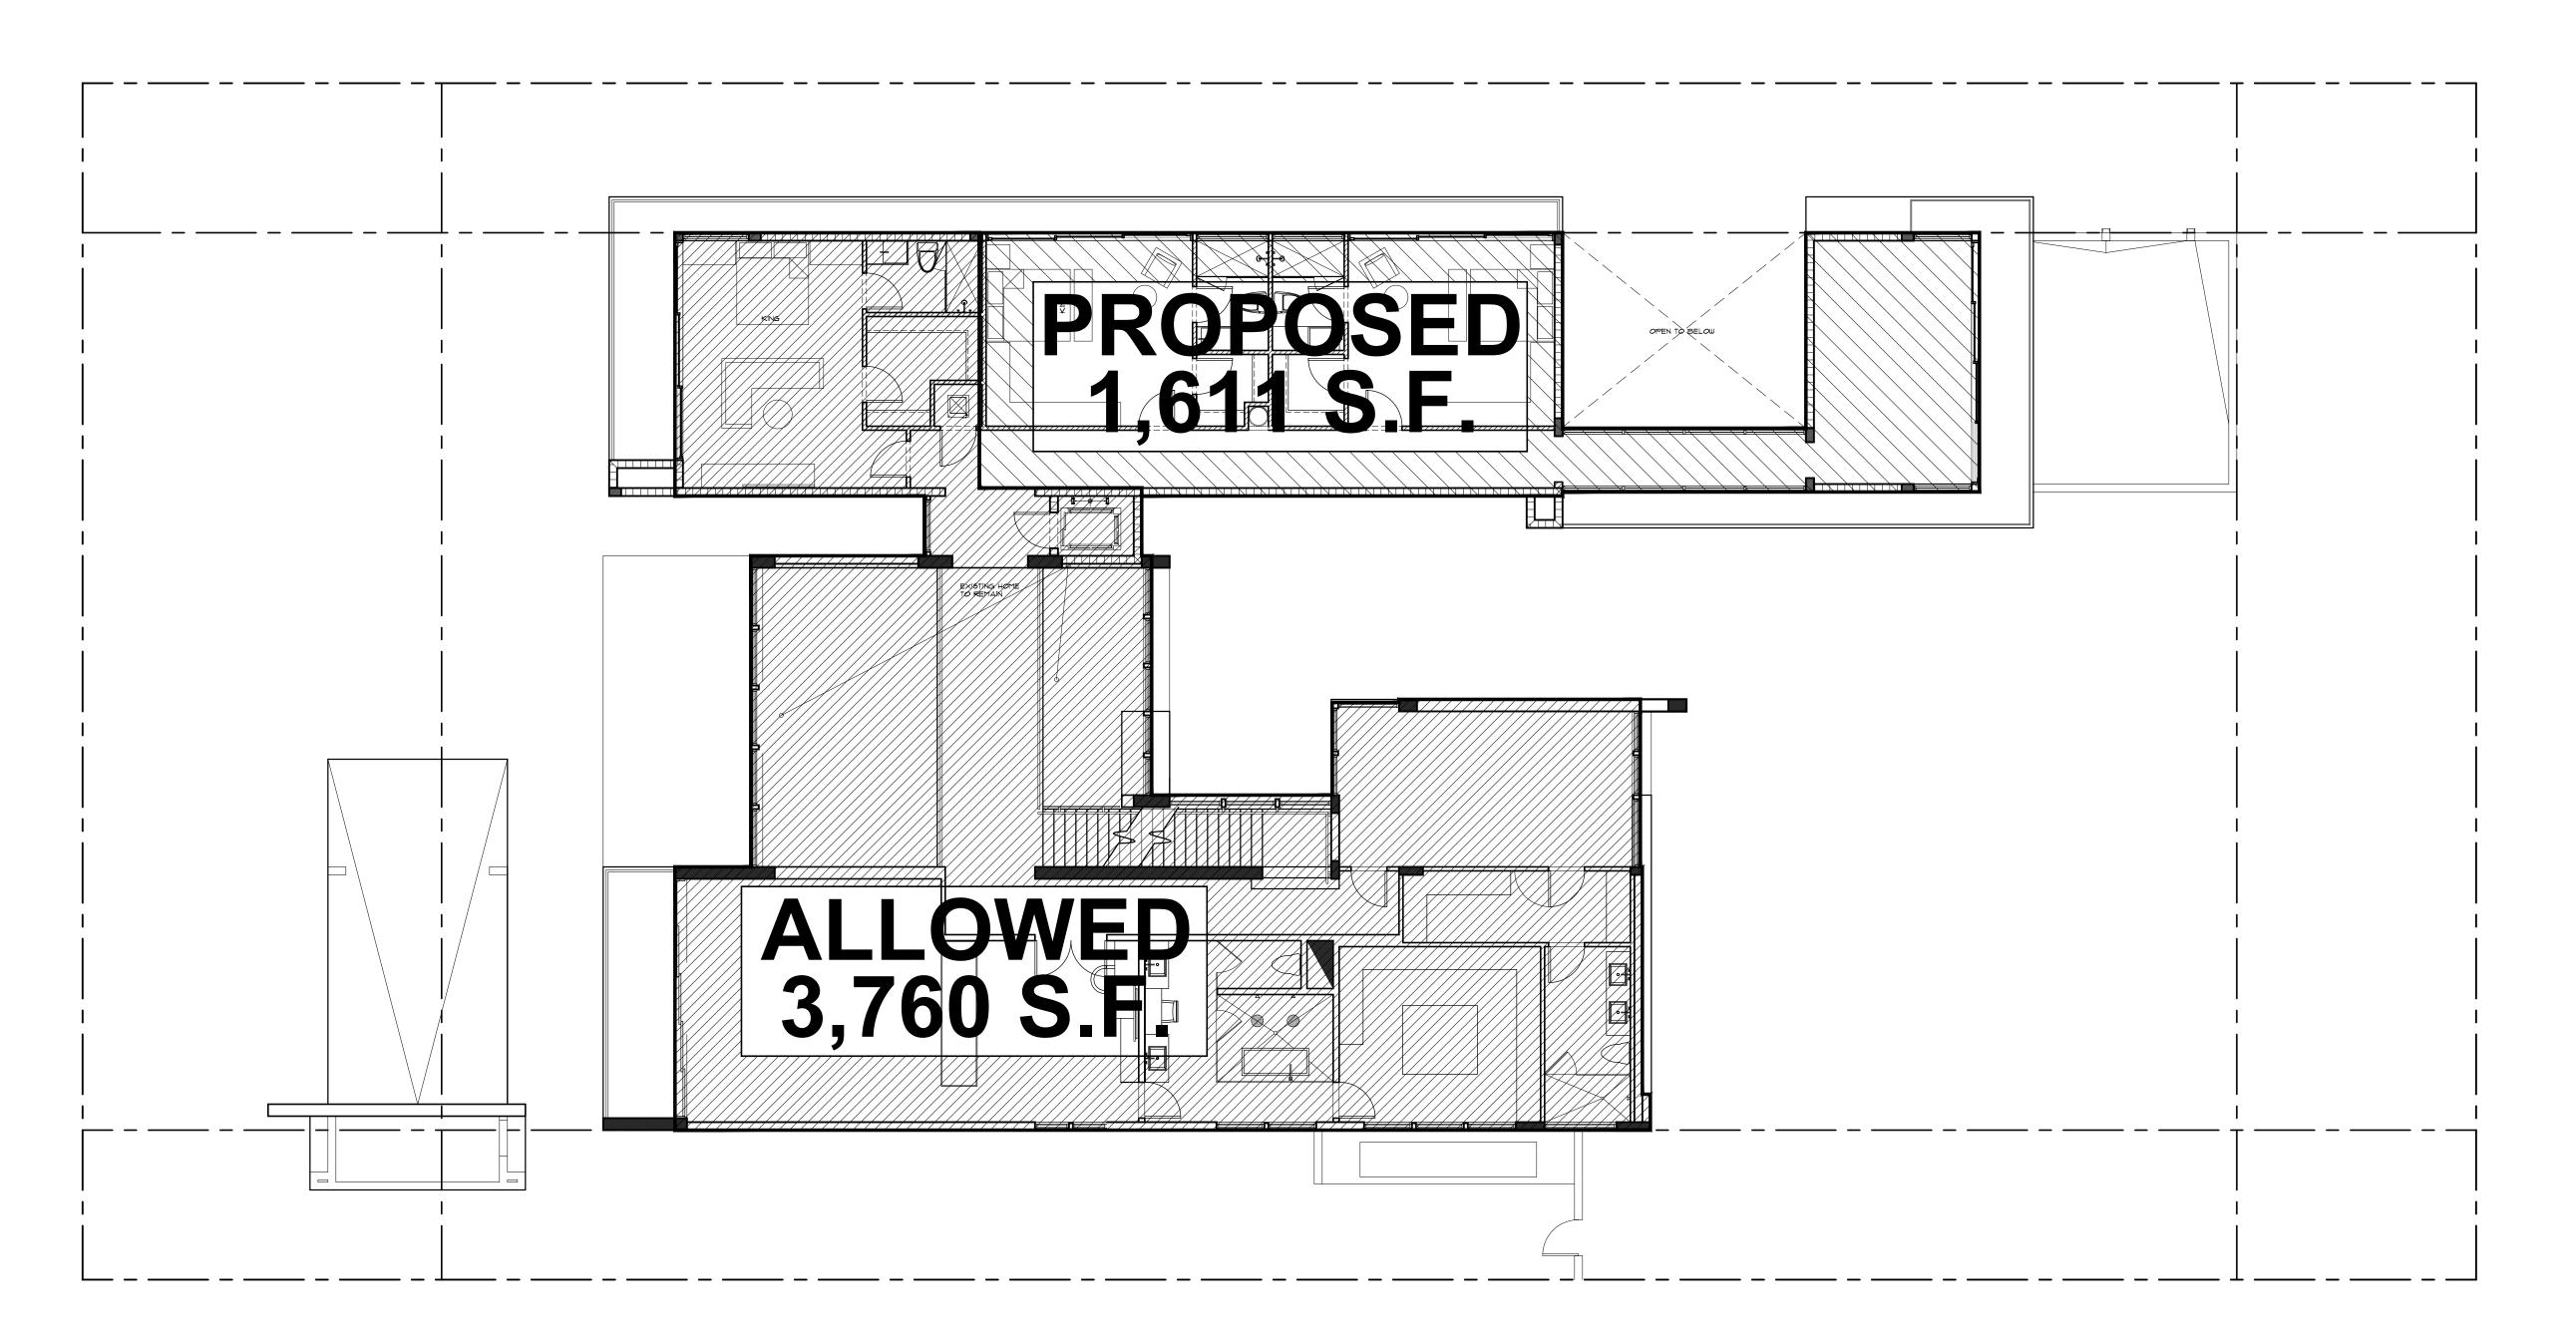

PROPOSED




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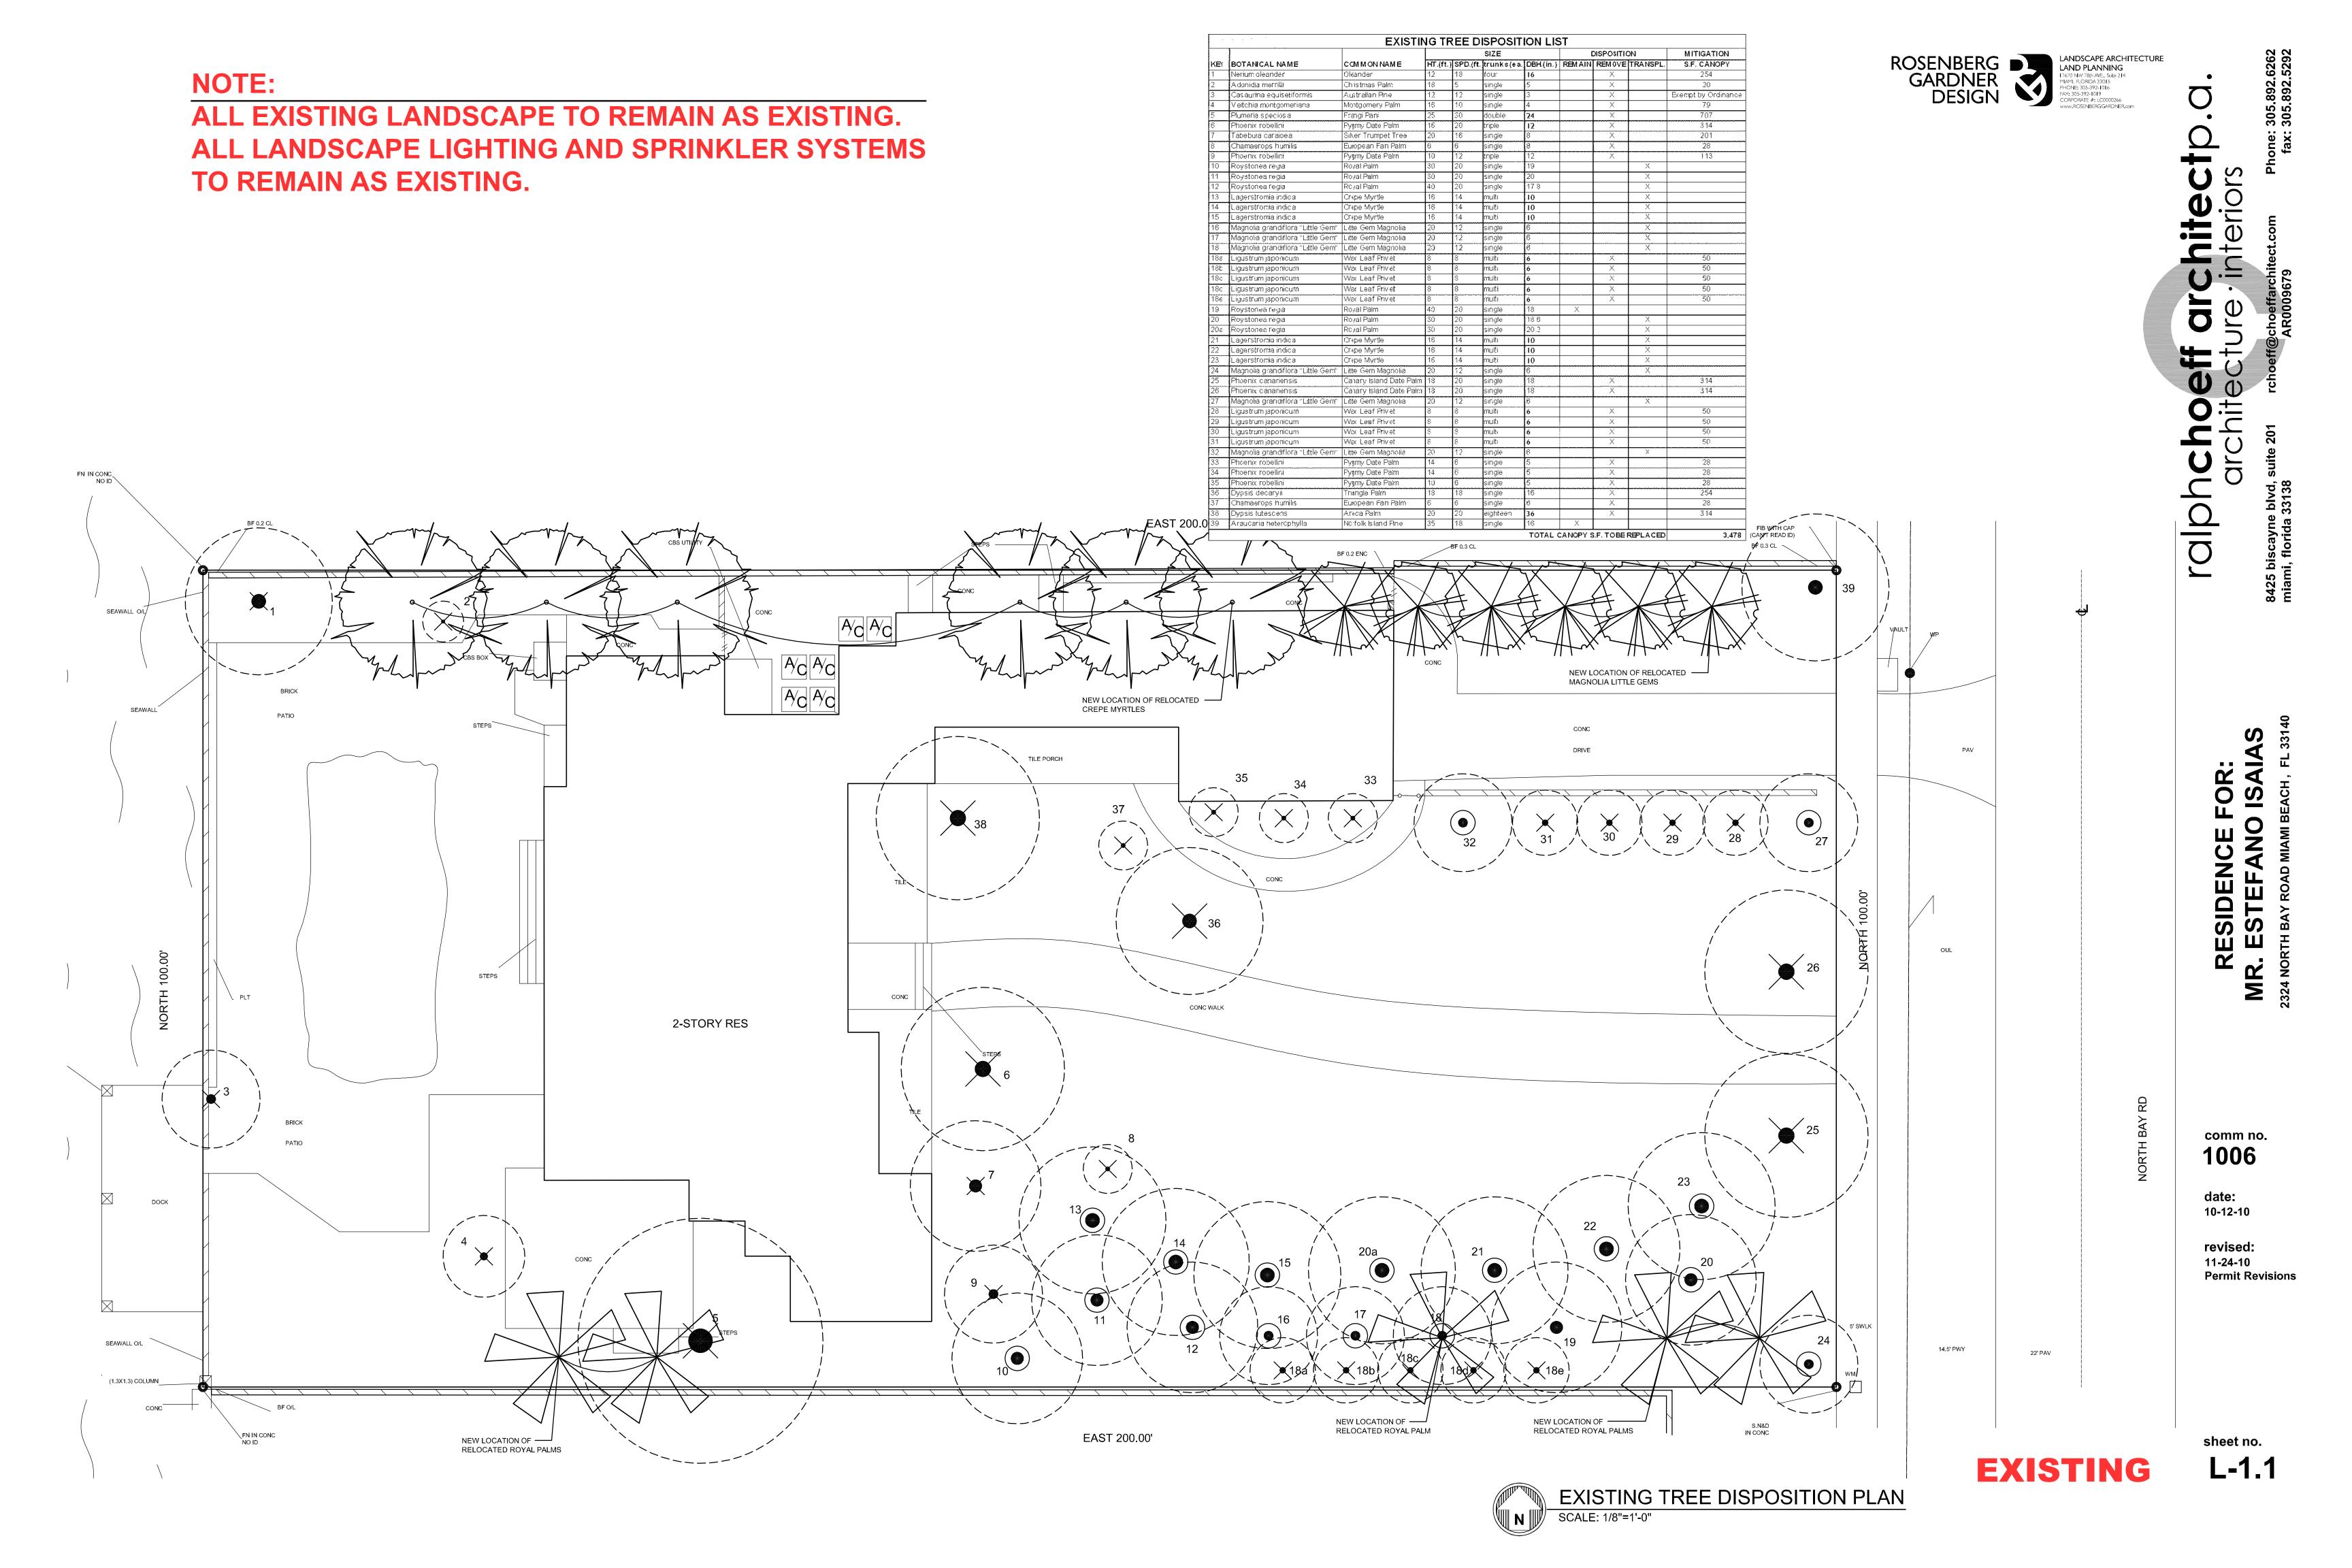
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08/03/2018

revised:

date:




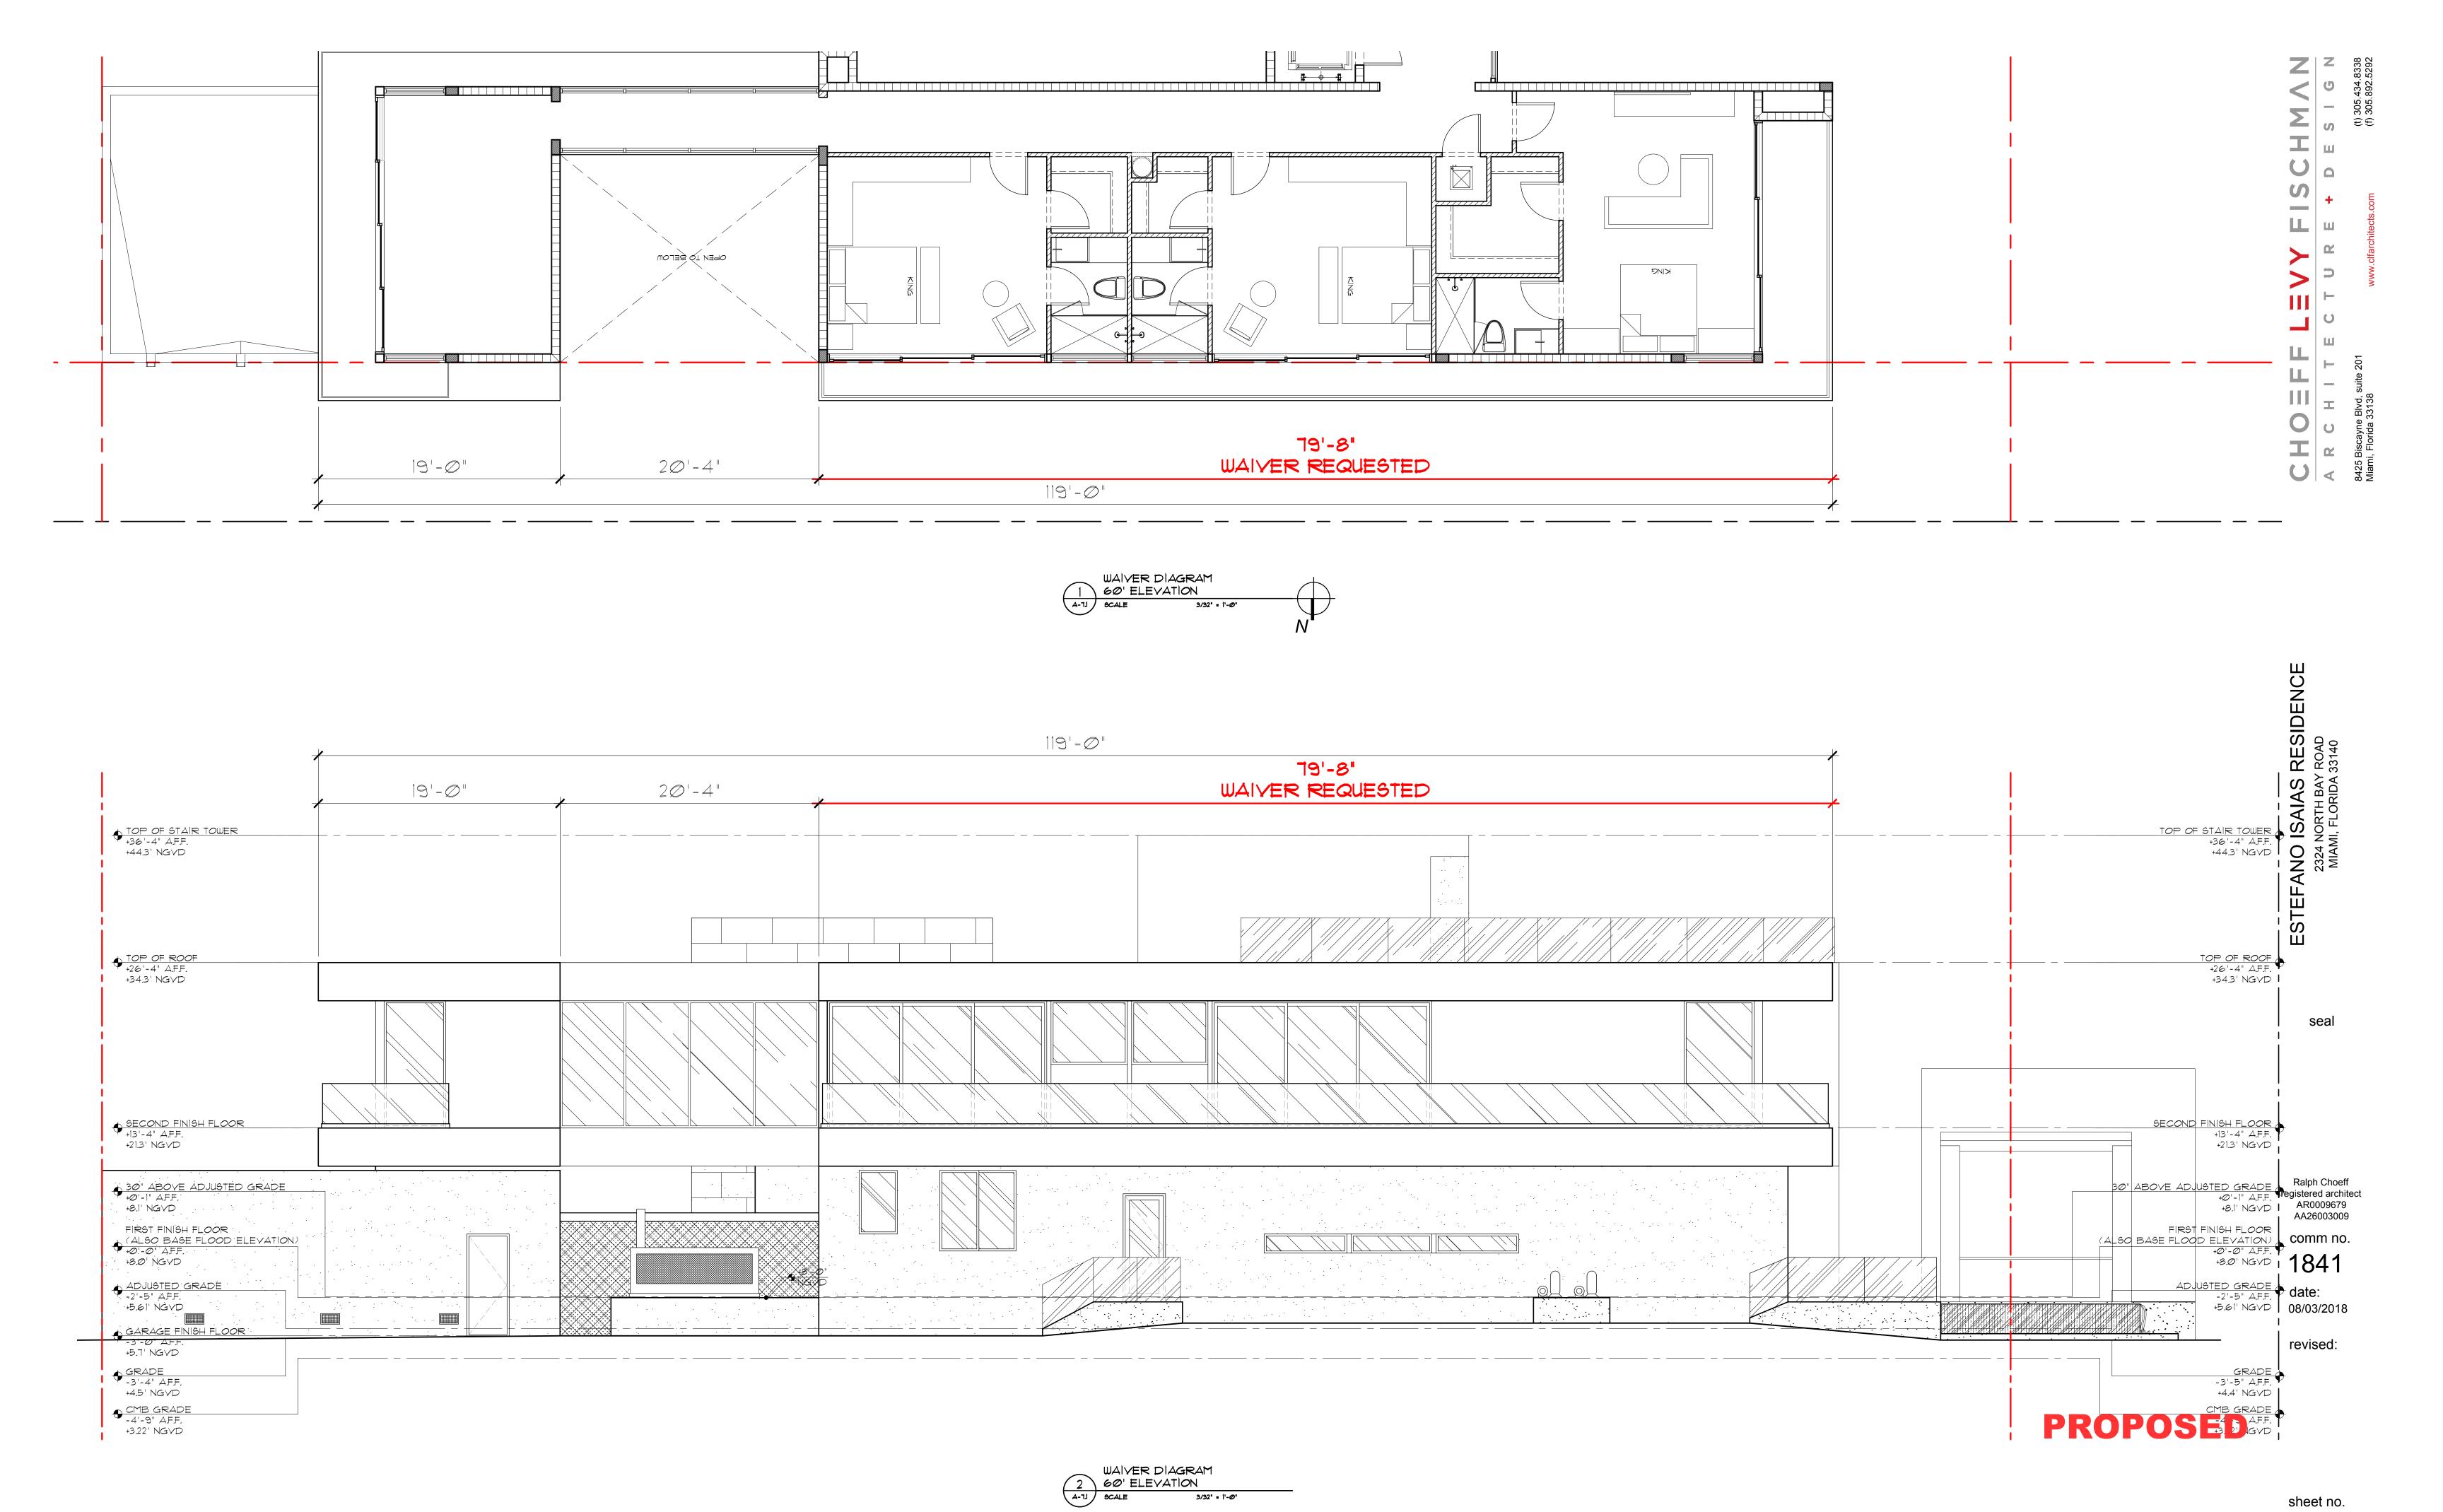

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RESIDENCE FOR: R. ESTEFANO ISAIAS

comm no. 1006

date: 10-12-10

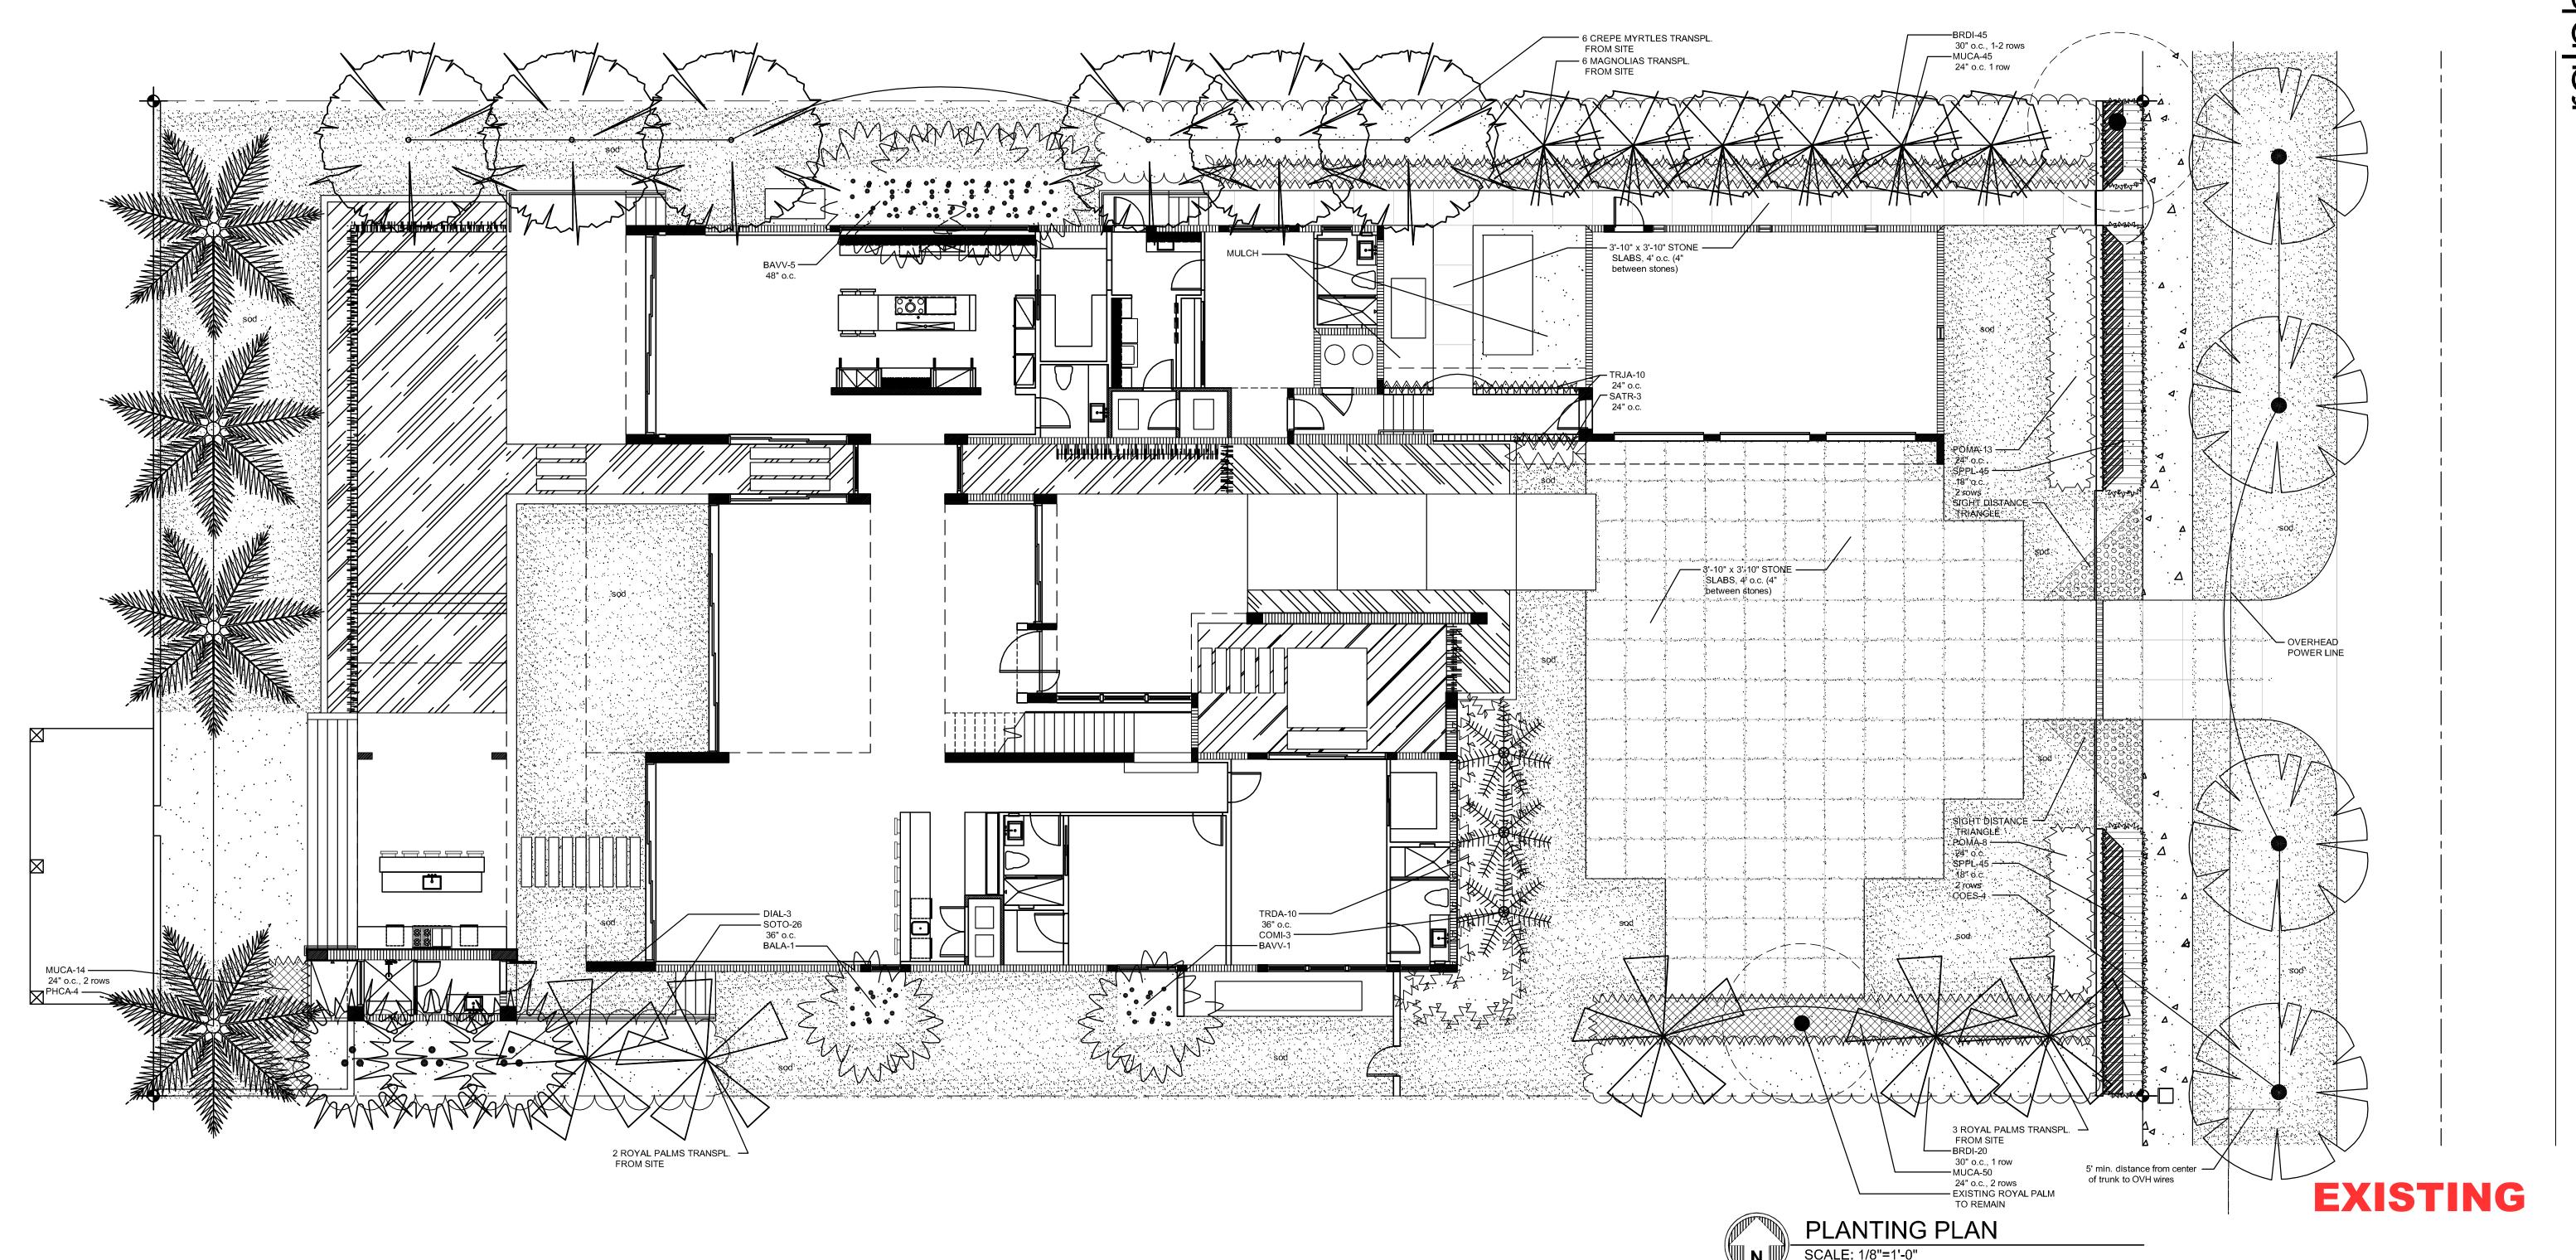revised: 11-24-10 Permit Revisions

sheet no.

L-1.2

Miami-Dade County.

1.2 CONTRACTOR QUALIFICATIONS A. Landscape installation work to be performed by a Contractor Certified by the Florida Nurserymen, Growers and Landscape Association (FNGLA) as a Certified Landscape Contractor. Any pruning to be supervised by an Arborist, certified by the International Society of Arboriculture (ISA) and licensed in

1.3 INVESTIGATION OF UTILITIES A. Prior to beginning work, the Contractor shall be responsible to locate existing underground utilities. Check with all utility companies and Sunshine

1.4 SUBSTITUTIONS A. Only materials specified will be accepted, unless approved in writing by the

Landscape Architect in advance. 1.5 PLANT SIZES

A. All plant sizes shall equal or exceed the minimum sizes as specified in the plant list. When plant sizes are specified as a range of size, installed materials shall average the mean of the range specified. Plants shall be measured following pruning, with branches in normal position. All necessary pruning shall be done at the time of planting.

1.6 PLANT QUALITY A. All plant material shall be equal to or better than Florida No. 1 as classified by "Grades and Standards for Nursery Plants" by the Division of Plant Industry. Florida Department of Agriculture. They shall have a growth habit that is normal for the species; healthy, vigorous, free from insects, disease and injury.

B. The Owner or Landscape Architect reserves the right to refuse any plant material which does not conform to the intent of the written specifications or

C. CIRCLING ROOTS FOUND ON CONTAINER-GROWN MATERIAL WILL NOT BE ACCEPTED UNLESS REMEDIAL ROOT PRUNING, APPROVED BY THE LANDSCAPE ARCHITECT IS DONE BEFORE PLANTING.

A. The plant quantities shown on the plant list are to be used only as an aid to bidders. In the case of discrepancy between the plant list and the plan, the quantity on the plan shall override the plant list.

A. The successful bidder shall furnish to the Owner and the Landscape Architect, a unit price breakdown for all materials. The Owner may, at his

submitted to and accepted by the Owner. 1.9 SUBMITTALS A. Fertilizer: The Contractor shall submit to the Owner and Landscape Architect documentation that all the fertilizer used for the project is of the

discretion, add to or delete from the materials utilizing the unit price breakdown

analysis specified and placed at the rates specified in section 2.2 FERTILIZER. B. Planting soil: The Contractor shall submit a sample of the planting soil (approximately 1 cu. Ft.) for approval by the Landscape Architect prior to

delivery to the site. 1.10 CLEAN-UP & MAINTENANCE OF TRAFFIC A. Follow procedures in FDOT Index 600 for maintenance of traffic during

B. At the end of each work day, the Contractor shall remove debris and shall barricade the un-filled holes in a manner appropriate in the path of pedestrians

C. Upon completion of the work or any major portion of the work or as directed by the Landscape Architect, all debris and surplus material from his work shall be removed from the job site.

1.11 MAINTENANCE PRIOR TO ACCEPTANCE A. The Contractor is responsible to maintain the plantings until they are accepted under the provisions of 1.12 "ACCEPTANCE OF INSTALLATION".

1. Plants: Begin maintenance immediately following the final plant installation operation for each plant and continue until all plant installation is complete and accepted. Maintenance shall include watering all plants, weeding, mulching, pest and disease control, tightening and repairing of guys, repair of braces, removal of dead growth, resetting of plants to proper grade or up-right position, operations to assure specified minimum grade of Florida No. 1.

2. Turf Areas: Begin maintenance of turf immediately following the placement of sod and continue until sod installation is complete and accepted. Maintenance shall include but not be limited to, watering, leveling, mowing weed and pest control, fungus and disease control and other necessary operations as determined by the Landscape Architect and good nursery

Re-setting or straightening trees and palms: The Contractor shall re-set and/or straighten trees and palms as required at no additional cost to the Owner unless caused by sustained winds of 75 mph or more. Then, the costs of the operations may be charged to the owner. Re-set

trees within 48 hours. 1.12 ACCEPTANCE OF INSTALLATION

A. Inspection: Inspection of the work, to determine completion of contract work, exclusive of the possible replacement of plants and turf, will be made by the Landscape Architect at the conclusion of the maintenance period. Written notice requesting such an inspection and submitted by the Contractor at least ten (10) days prior to the anticipated date.

1.13 GUARANTEE A. Guarantee all plants for a period of one year (CCD). Guarantee shall commence from the date of written acceptance. Plant material which is on the site and scheduled to be relocated is not covered by the guarantee except in the case of Contractor's negligence or work that has been done in an unworkman-like manner. The Contractor is not responsible for loss due to acts of god, (i.e.) sustained winds of 75 mph or more, floods, frost, lightning, vandalism or theft.

1 14 REPLACEMENT A. Replacement shall be made during the guarantee period as directed by the Landscape Architect within ten (10) days from time of notification. For all replacement plant material, the guarantee period shall extend for an additional forty-five (45) days beyond the original guarantee period. The Contractor shall be responsible to provide water to the replacement plants in sufficient quantity to aid in their establishment. At the end of the guarantee period, inspection will be made by the Landscape Architect, upon written notice requesting such inspection and submitted by the Contractor at least five (5) days before the anticipated date. Replacement plants must meet the requirements of Florida No. 1 at time of inspection. Remove from the site all plants that are dead or in a state of unsatisfactory growth, as determined by the Landscape Architect. Replace these and any plants missing due to the Contractor's negligence as soon as conditions permit.

1. Materials and Operations: All replacement plants shall be of the same kind and size as indicated on the plant list. The Contractor shall supply and plant the plants as specified under planting operations.

2. Cost of Replacements: A sum sufficient to cover the estimated cost of possible replacements, including material and labor will be retained by the Owner and paid to the Contractor after all replacements have been satisfactorily made and approved by the Landscape Architect

PART 2 - MATERIALS

A. Planting soil for trees, shrubs and ground covers shall be of the composition noted on the plans, measured by volume.

B. Soil for Sodded Areas: shall be coarse lawn sand.

22 FERTILIZER A. Fertilizer for trees, palms, shrubs, and groundcovers shall be as follows: LESCO Palm Special 13-3-13 or equal, Sulfur coated with iron and other minor elements and maximum of 2% chlorine, or brand with equal analysis. The fertilizer shall be uniform in composition, dry and free flowing and shall be delivered to the site in the original unopened containers, bearing the manufacturer's guaranteed analysis. Fertilizer for sod and seeded areas shall be 8-6-8, 50% organically derived nitrogen, or equal.

2.3 WATER

A. The Contractor shall provide potable water on site, available from the start of planting. The Contractor is responsible to ascertain the location and accessibility of the water source. The Contractor is responsible to provide the means of distribution (i.e. water truck, hoses, etc.) for distribution of water to the planting areas.

A. Mulch shall be shredded Melaleuca mulch (Florimulch) as manufactured by Forestry Resources, Inc., or equal.

2.5 ROOT BARRIER MATERIAL A. When specified in the plans, root barrier material shall be Biobarrier (19.5

inch width) Reemay or approved equal.

B Install per details in the plans PART 3 - INSTALLATION PROCEDURES

3.1 LAYOUT A. Verify location of all underground utilities and obstructions prior to

3.2 HERBICIDE TREATMENT

A. In all areas infected with weed and/or grass growth, a systemic herbicide, such as Roundup, shall be applied per manufacturer's rates. When it has been established where work will be done, the systemic herbicide shall be applied in accordance with manufacturer's labeling to kill all noxious growth. Contractor shall schedule his work to allow more than one application to obtain at least 95% kill of undesirable growth. If necessary, Contractor shall conduct a test to establish suitability of product and applicator to be used on this project, prior to execution of the full application.

3.3 PLANT PIT EXCAVATION AND BACKFILLING A. Trees: See the Planting and Bracing Details and notes.

setback from curb and pavements as shown in the plans.

B. All planting holes shall be hand dug where machine dug holes may adversely affect utilities or improvements.

C. Shrubs and Groundcover: Shrubs and groundcover shall be planted in a soil bed as described in the notes and details. Space shrubs and provide

D. Watering of field-grown plants: Thoroughly puddle in water to remove any

3.4 WATERING A. The Contractor is responsible to provide the water for all new plants and transplants and means of distribution (i.e. hand watering or water truck) during the maintenance period and extending into the period after acceptance until the full schedule as listed below is complete. Water for trees and other large field grown plants shall be supplemented by hand or water truck. in addition to the irrigation system, (if one is provided). Contractor can adjust watering schedule during heavy rain season upon approval of the Landscape Architect.

AMOUNT OF WATER PER APPLICATION For trees up to 5 inch caliper - 5 gallons From 5 to 8 inch caliper - 25 gallons 9 inch and up caliper - 50 gallons

FREQUENCY OF WATER Daily for the first week 3 times per week for weeks 2 - 5 2 times per week for weeks 6 - 8

1 time per week for weeks 9 - 12 B. Water in plants by thoroughly soaking of the entire root ball immediately after planting. For large trees and shrubs, add water while backfilling hole to eliminate any air pockets in the soil around the root ball.

C. Water shrubs, sod and groundcover a minimum of once daily for a week or until an irrigation system is fully operational. If no irrigation system is to be installed, the Contractor shall be responsible for watering the shrub, sod, and groundcover for the time specified above, after installation of each section of the planting installed.

A. Add fertilizer on top of the surface of shrubs beds and tree and palms root balls two (2) months after installation. Fertilize sod within two (2) days after installing after planting of each segment of the job. Fertilizer shall be applied after soil has been well moistened. Fertilizer shall be washed off of plant leaves and stems immediately after application. Apply at the following rates:

1. Trees and Large Shrubs: One (1) pound per inch of trunk diameter, spread evenly over the root ball area.

2 Shrubs: One half (1/2) handful per shrub, spread evenly over the root ball

3. Groundcover: Twelve (12) pounds per 100 sq. ft. of bed area.

4. Sod: Twelve (12) pounds per 1,000 sq. ft. Wash fertilizer off blades immediately after spreading.

3.6 MULCHING A. Spread mulch two (2) inches thick uniformly over the entire surface of shrubs and groundcover beds, depth measured after settling, unless otherwise specified in the plans. Provide 36" diameter bed of mulch, measured from outer edge of the trunk, for all trees and palms planted in sod areas. Keep mulch away from contact with the trunk. Create a 6" high ring of mulch at the outer edge of tree and palm holes.

3.7 GUYING AND BRACING A. See the details bound herewith or made part of the plans.

3.8 SODDING

A. Provide a blanket of lawn sand as described in the notes in these plans. Prior to planting, remove stones, sticks, etc. from the sub-soil surface. Excavate existing non-conforming soil as required so that the finish grade of sod is flush with adjacent pavement or top of curb as well as adjacent sod in the case of sod patching.

B. Place sod on moistened soil, with edges tightly butted, in staggered rows at right angles to slopes. The sod shall be rolled with a 500 pound hand roller immediately after placing.

C. Keep edge of sod bed a minimum of 18" away from groundcover beds and 24" away from edge of shrub beds and 36" from trees, measured from the edge of plant or tree trunk

D. Sod shall be watered immediately after installation to uniformly wet the soil

to at least two inches below the bottom of sod strips. E. Apply fertilizer to the sod as specified in Section 3.5.

F. Excavate and remove excess soil so top of sod is flush w/top of curb or adjacent pavement, or adjacent existing sod.

PLANT BED PREPARATION NOTES

1. In all areas where new sod and shrub and groundcover masses are to be planted, kill all existing weeds by treating with Round-up prior to beginning soil

2. In all shrub and groundcover beds, prepare soil as described for either condition, over the entire area to be planted:

If any compacted road base or asphalt or rocky soil is encountered, remove compacted material entirely to allow an 18" depth of planting soil. Backfill the entire area of the shrub and groundcover beds with 18" planting soil (as specified in Plans) to within 2 inches of the adjacent pavement or top of curb.

Condition B: Where no compacted soil is encountered, thoroughly mix 6 inches of planting soil into the existing soil to a depth of 18 inches. If required, excavate and remove the existing soil to lower the grade, so that the prepared mix is finished to a minimum of 2 inches below top of curb or adjacent walkway.

For all sod areas, spread a 2" deep layer of lawn sand prior to sodding. Remove all debris and rocks and pebbles larger than 1 inch in size and level the grade before sodding. Remove, if required, existing soil so that top of sod is flush with and adjacent top of curb or pavement.

SPACING OF PLANTS (SEE PLANT SPACING DETAIL)

1. Plants shall be planted sufficiently away from edges of pavements or curbs, to allow for growth toward the edges of the bed PROTECTION OF PLANTS

1. The Contractor shall be responsible to protect existing trees and shrubs in and adjacent to the area of work. Erect barriers as necessary to keen equipment and materials, any toxic material, away from the canopy drip line of trees and shrubs. DO NOT PILE SOIL OR DEBRIS AGAINST TREE TRUNKS OR DEPOSIT NOXIOUS BUILDING SUPPLIES OR CHEMICALS WITHIN THE DRIP LINE.

3'-10" x 3'-10" x 4" THICK CONC. SLAB ---

8" COMPACTED SUBGRADE _____

IS ½" BELOW TOP OF ADJACENT SLAB

AND BACKFILL WITH PLANTING SOIL

EXIST. SUBGRADE ———

SET ROOTBALL SO -

TRUNK FLARE OR TOP ROOT

IS 2" ABOVE SURROUNDING GRADE

INSTALL 2" OF MULCH OVER ---

REMOVE ANY PORTION OF WIRE -

BASKETS ABOVE THE TOP HALF OF

COMPLETE REMOVE ALL SYNTHETIC

(2)2" DIA. 8' LONG WOOD DOWELS -

BURLAP COVERINGS BELOW THE

TOP HALF OF THE ROOTBALL.

120°APART DRIVEN THROUGH

BOTTOM OF PLANTING PIT

3" DIAMETER CIRCLE AROUND

THE TRUNK DO NOT PLACE


MULCH WITHIN 3" OF THE

BERMUDA SOD, INSTALL SO THAT TOP OF SOD -

AFTER CONC. INSTALLATION, EXCAVATE 12" —

ALL EXISTING LANDSCAPE TO REMAIN AS EXISTING. ALL LANDSCAPE LIGHTING AND SPRINKLER SYSTEMS TO REMAIN AS EXISTING.




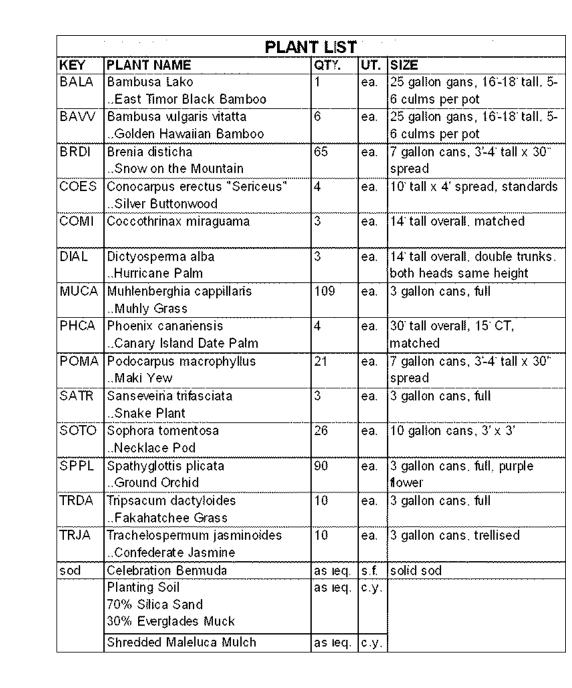


LANDSCAPE LEGEND Required Required

Street Trees


21 shrubs 145 shrubs

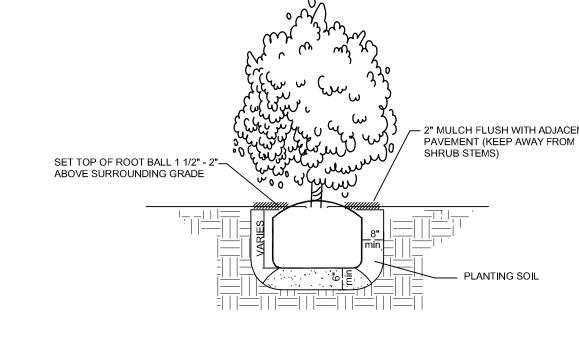




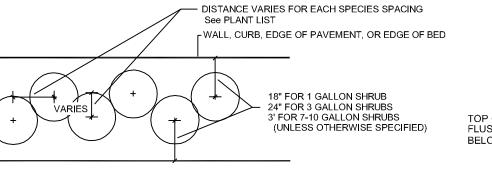

SHRUB SPACING DIAGRAM

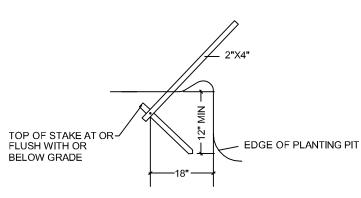

DETAIL A N.T.S.

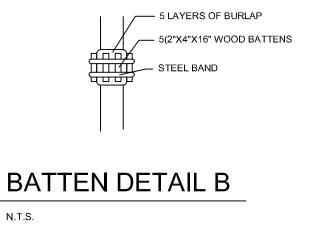

(NOT TO EXCEED 12 MONTHS FROM THE COMPLETION

6" HIGH TEMPORARY DIKE OF MULCH TO ASSIST IN

IRRIGATION OF THE TREE. REMOVE DIKE 3 MONTHS

- HOLES TO ACCOMMODATE PLANTS SHALL BE A MINIMUM

OF THREE TIMES THE SIZED OF THE PLANT ROOTBALL.



revised: 11-24-10 **Permit Revisions**

FERTILIZER SHALL BE INSTALLED AS PER THE WRITTEN SPECIFICATIONS.

ROCKS 2" OR LARGER REMOVED

ATTACHED TO EVERY STEM

OF THE PROJECT)

AFTER INSTALLATION

FINISHED GRADE

EXISTING

LANDSCAPE SPECIFICATIONS AND PLANT LIST SCALE: N.T.S.

date: 10-12-10

comm no.

- ALL BACKFILL FOR TREES SHALL BE EXISTING SOIL WITH ALL

N.T.S.

NOTE-USE 4" X 4" STAKES TREES & PALMS OVER 12" CALIPER PROVIDE THREE 2'X4' PINE STAKES -ATTACH W/NAILS TO BATTENS NO NAILS IN TREE SET ROOTBALL SO -TRUNK FLARE OR TOP ROOT IS 2" ABOVE SURROUNDING GRADE INSTALL 2" OF MULCH OVER 3" DIAMETER CIRCLE AROUND THE TRUNK. DO NOT PLACE MULCH WITHIN 3" OF THE REMOVE ANY PORTION OF WIRE -BASKETS OR BURLAP ABOVE THE TOP HALF OF THE ROOTBALL. FOLD BACK BURLAP COVERINGS BELOW THE TOP HALF OF THE ROOTBALL. COMPLETELY REMOVE ALL SYNTHETIC ROOTBALL COVERING MATERIALS. WOOD STAKES TOP OF STAKES-BELOW OR FLUSH WITH GRADE DETAIL A ---

N.T.S.

FERTILIZER SHALL BE INSTALLED AS PER THE

PLANTING & BRACING DETAIL

UNDER 3 1/2" CALIPER

— 3 TIMES ROOT BALL DIAMETER ——

N.T.S.

LIGHTLY COMPACTED SUBGRADEL

5/8" DIAMETER NYLON STRAPS WRAPPED AROUND TRUNK & PULLED TAUT, TIED TO WOOD DOWELS. 6" HIGH TEMPORARY DIKE OF MULCH TO ASSIST IN IRRIGATION OF THE TREE. REMOVE DIKE 3 MONTHS AFTER INSTALLATION

SECTION THRU SLAB & SOD DRIVEWAY

FINISHED GRADE HOLES TO ACCOMMODATE PLANTS SHALL BE A MINIMUM OF THREE TIMES THE SIZED OF

NOTE - IRREGULAR OR MULTI-STEMED TREES

SHALL HAVE A SIMILAR STAKING PATTERN AS

FROM THE TREES ONCE THE TREES HAVE

BECOME ESTABLISHED(NOT TO EXCEED 12

MONTHS FROM THE COMPLETION OF THE

ALL BE ATTACHED TO EVERY STEM

SINGLE TRUNKED TREES. STAKES NEED NOT

ALL SUPPORT MATERIALS ARE TO BE REMOVED

ALL BACKFILL FOR TREES SHALL BE AS EXISTING

SOIL WITH ALL ROCKS 2" OR LARGER REMOVED


PLANTING & BRACING DETAIL **OVER 3 1/2" CALIPER**

——— 3 TIMES ROOT BALL DIAMETER —

ROSENBERG
GARDNER
DESIGN

LANDSCAPE ARCHITECTURE
LAND PLANNING
17670 NW 78th AVE., Suite 214
MIAMI, FLORIDA 33015
PHONE: 305-392-1016
FAX: 305-392-1019
CORPORATE #: LC0000266
WWW.ROSENBERGGARDNER.com

ALL EXISTING LANDSCAPE TO REMAIN AS EXISTING.
ALL LANDSCAPE LIGHTING AND SPRINKLER SYSTEMS
TO REMAIN AS EXISTING.

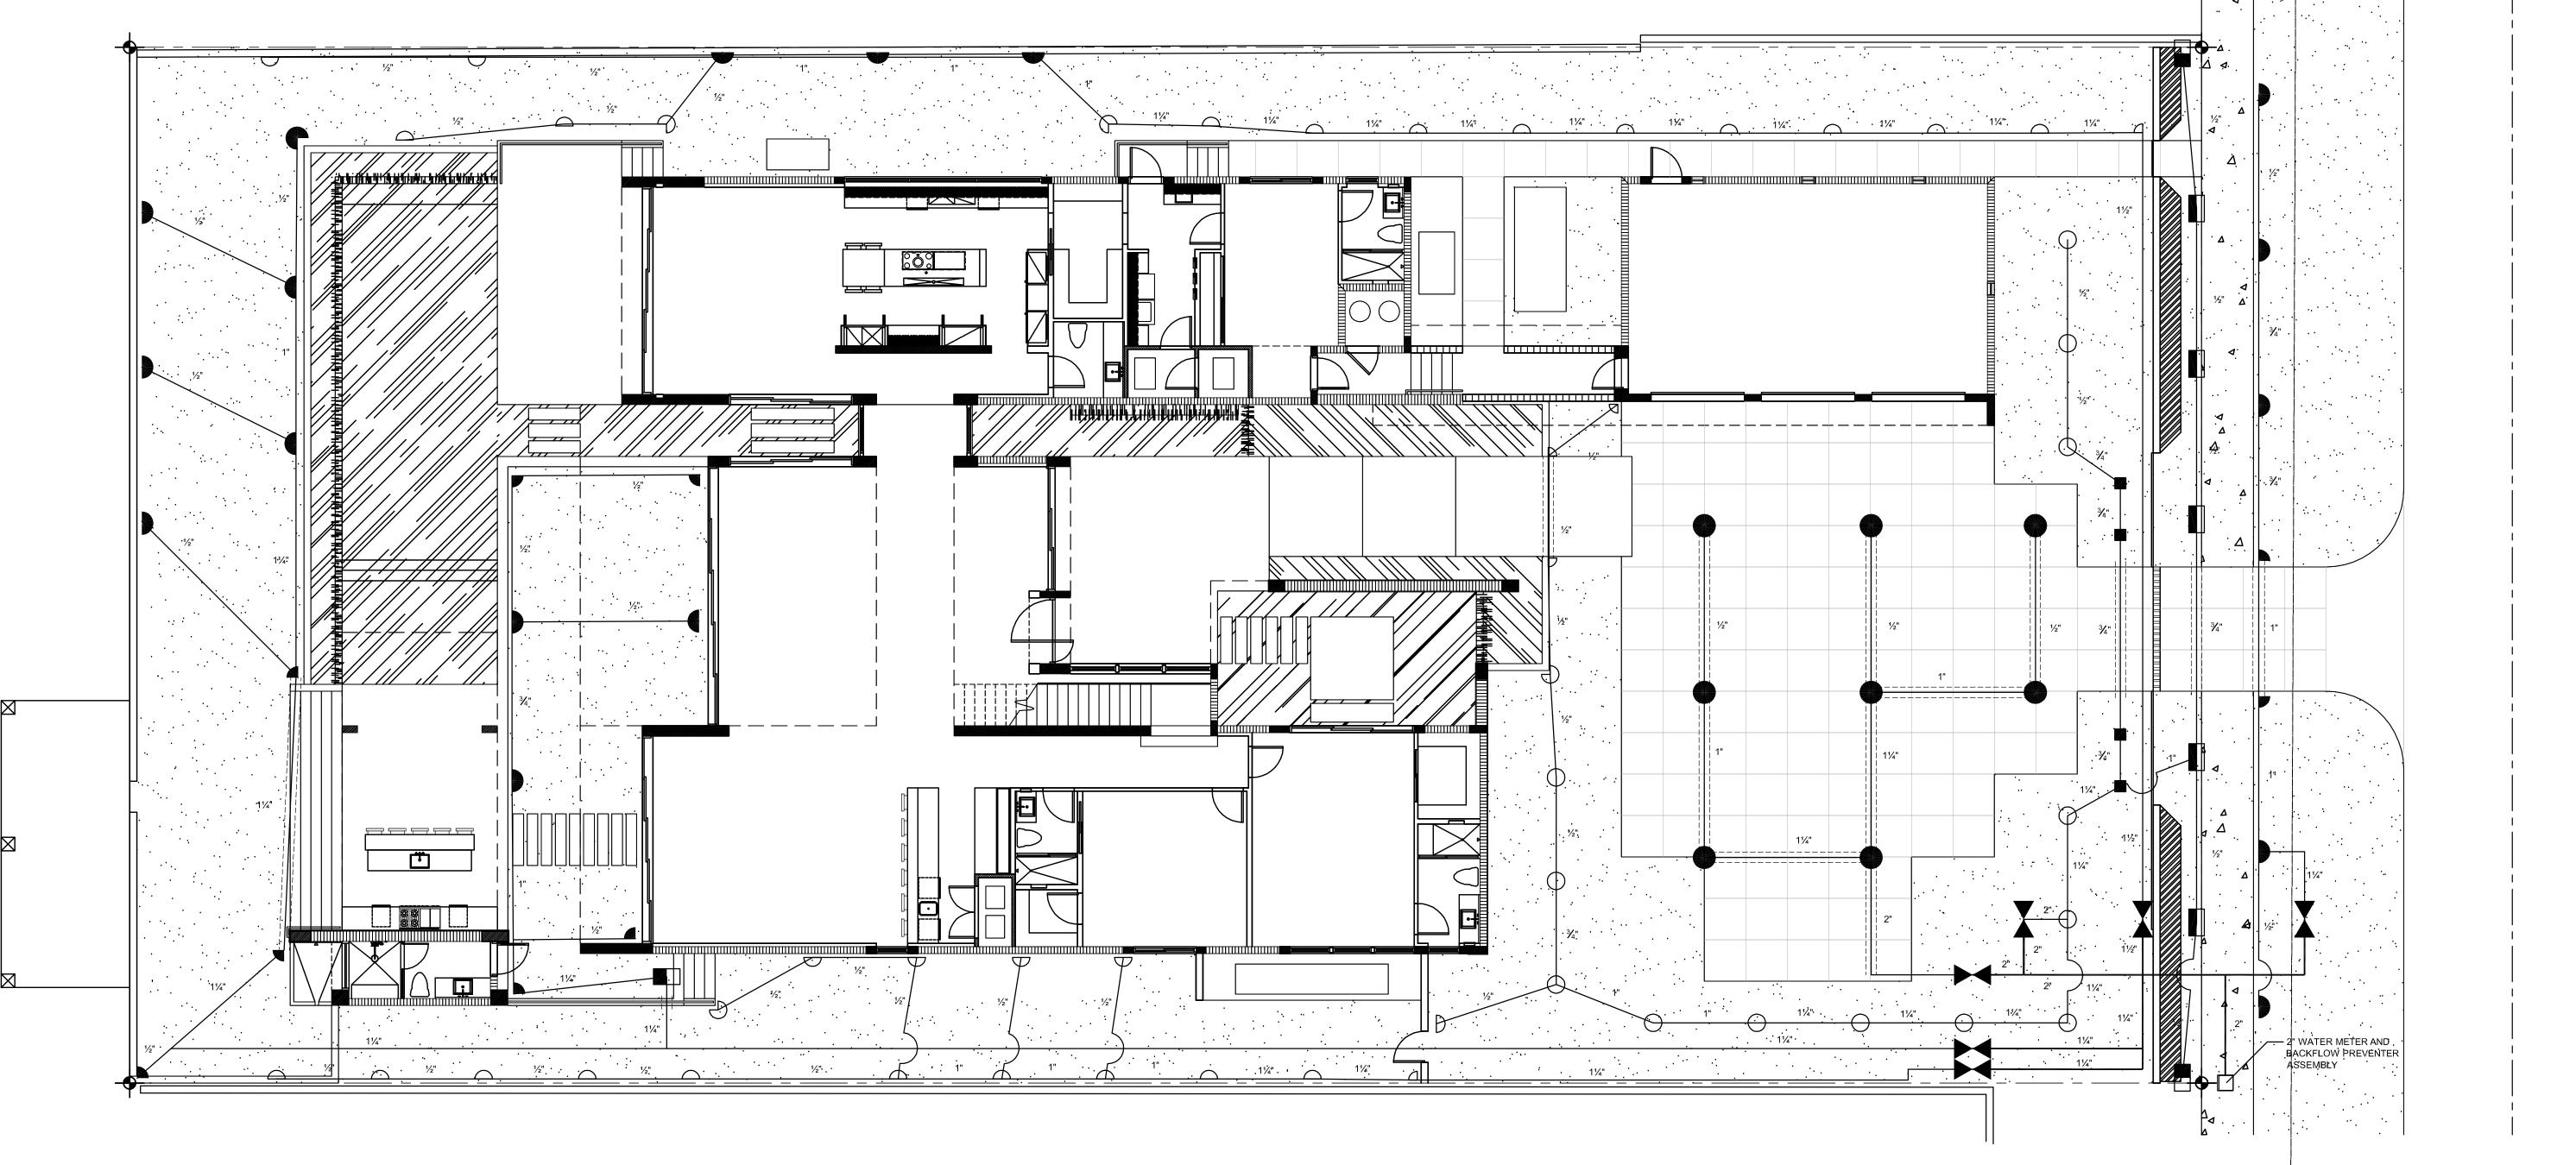

Alph**choett arch** architecture int

> RESIDENCE FOR: R. ESTEFANO ISAIAS

comm no

date: 10-12-10

revised: 11-24-10 Permit Revisions

sheet no.

EXISTING L-2.1

SCALE: 1/8"=1'-0"

2. Contractor shall coordinate with General Contractor or other pertinent Contractors on the job to insure that sleeves are provided and installed under hard surfaces to allow access to all areas to be irrigated. All sleeves shall be constructed of Schedule 40 PVC. Bury all sleeves a minimum of 24" below the surface. Sleeve to be 2 times the size if the pipe running through it. Sleeve shall extend 24" past the edge of pavement into the area to be irrigated.

3. GUARANTEE: The irrigation system shall be guaranteed for a minimum of one calendar year from the time of final acceptance.

4. REPAIR UTILITIES: The Contractor shall be responsible to verify the location of all utilities by hand excavation or other appropriate measures before performing any work that may result in damage to utilities structures, or property. The Contractor shall take immediate steps to repair, replace, or restore all services to any utilities which are disrupted due to his operations. All costs involved in disruption of service and repairs due to negligence on part of the Contractor shall be his responsibility.

5. AS-BUILT DRAWINGS: Prints of the plans will be supplied to the Contractor for recording "as-built" information. Immediately upon installation of any work which deviates from what is shown on the Plans, the Contractor shall clearly indicate such changes in red pencil on the prints. Such changes shall include, but not be limited to, changes in (1) materials; (2) sizes of material; (3) location; and (4) quantities.

6. The entire installation shall fully comply with all applicable local and state codes and ordinances. The Contractor shall take out all required plumbing and electrical applications and permits, arrange for all necessary inspections and shall pay all fees and expenses in connection with same as part of work under the contract.

7. UNIT PRICES: The successful bidder shall furnish, to the Owner, a unit price breakdown for all materials. The Owner may at his own discretion, add to or delete from the materials, using the unit price breakdown submitted to and accepted by the Owner.

8. MAINTENANCE PERIOD: The irrigation system shall be maintained for a period of 90 days after final acceptance of installation. Maintenance shall include checking of the system 2 times per week. Contractor shall be responsible to replace/repair any broken or malfunctioning parts of the system including those damaged by accidents or vandalism. Repairs shall be made immediately at the time of inspection or when notified by the Landscape

9. The irrigation system shall provide 100% coverage with a minimum of 90% overlap of water spray.

10. The system is design to provide sprinkler precipitation rates that are nearly equal in each zone. Mixing of sprinklers with widely varying precipitation rates in a zone will not be accepted.

II. All pipe shall be made of Schedule 40 PVC, except flexible PVC (or Toro funny pipe) for flexible swing joint and Schedule 80 galvanized steel pipe for all above ground fittings. Pipe locations shall be adjusted in the field. When laying out mains and laterals, locate pipe near edges of pavement or against buildings wherever possible, to allow space for plant rootballs. Coordinate pipe locations with plantings. Bury all mains 18" below surface and laterals 12". Depth shall be measured to top of pipe.


12. Keep pop-up sprinkler heads a minimum of 8" from edges of pavement and curbing, and heads on risers a minimum of 18", or as indicated in the pans.

13. All heads located in shrub or groundcover beds shall be installed on a riser as per details in the plans. All other heads shall be installed on a swing joint as per details in the plans.

14. Place irrigation control wire in conduit in the same trench as mains and under the main. ASI wire shall be #14 or larger solid copper U.L. approved underground direct burial cable and shall be continuous with no splices from controller to solenoid valve.

15. Valve locations are schematic and shall be adjusted in the field. Each valve shall be in a separate valve box $(10^{\text{II}} \times 16^{\text{II}})$ min.). When grouping valve boxes in grass or groundcover areas, set boxes a minimum of 12" apart to allow grass or groundcover to grow between them. When possible, hide valve boxes in shrub beds, a minimum of 12" from edge of beds. Set all valve boxes, concrete or plastic, in ground with cover flush with finish grade, and level, with a minimum of 6" of pea gravel at the bottom of the box, with at least 2" of clearance from the bottom of the valve to the top of the gravel.

16. TESTING: Notify the Landscape Architect in writing when testing will be conducted. Conduct test in the presence of the Landscape Architect. After all PVC assembly is completed the lines shall be flushed to insure that no rocks, sand, or other foreign debris remains in the lines. The mains shall be filled with water and all outlets shall be capped and plugged. The main shall be pressurized to 100 PSI for a minimum of one hour. No section of the main will be approved if the pressure drops more than 5 PSI at the end of the one hour period. Leaks shall be repaired immediately and the system shall be re-tested until found satisfactory by the Landscape Architect.

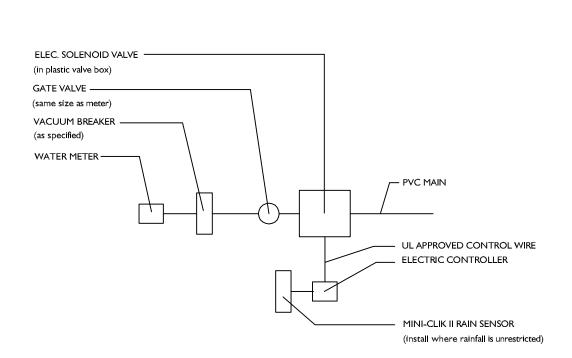


CONNECTION TO METER DETAIL

N.T.S.


ALL EXISTING LANDSCAPE TO REMAIN AS EXISTING. ALL LANDSCAPE LIGHTING AND SPRINKLER SYSTEMS TO REMAIN AS EXISTING.



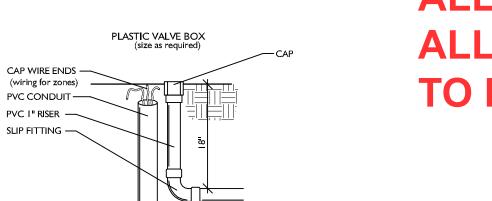

DETAIL OF STUB-OUT FOR FUTURE USE


N.T.S.

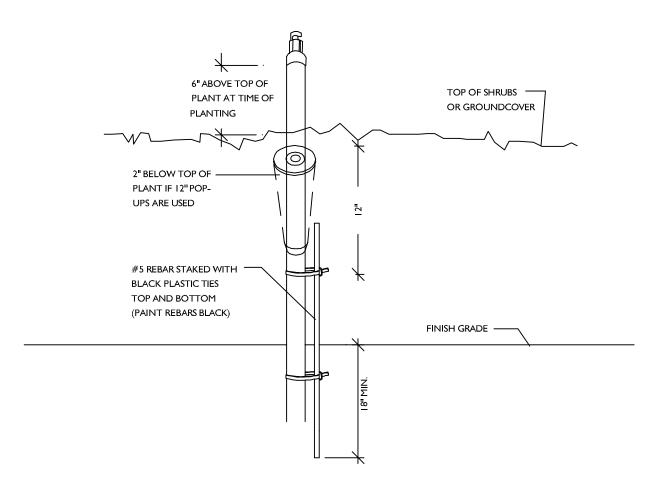

SPRINKLER ON RISER DETAIL FOR SHRUB AREAS

TO VALVES

N.T.S.

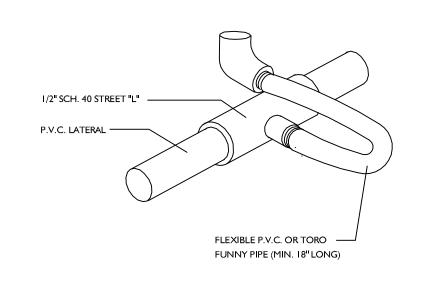

FLEXIBLE SWING JOINT DETAIL


PER LOCAL CODES AND ORDINANCES GATE VALVE -IN VALVE BOX (SAME SIZE AS ALL ABOVE GROUND PIPE AND FITTINGS TO BE GALVANIZED FROM METER

BACKFLOW PREVENTION DEVICE AS

BACKFLOW PREVENTION DETAIL


N.T.S.

ALL WIRE CONNECTIONS SHALL BE APPROVED WATERTIGHT CONNECTIONS. FINISH ENTIRE ASSEMBLY, EXCEPT FOR EQUIPMENT, WITH FLAT BLACK ACRYLIC PRIME METALLIC SURFACES WITH ZINC CHROMATE PRIOR TO FINISHING.

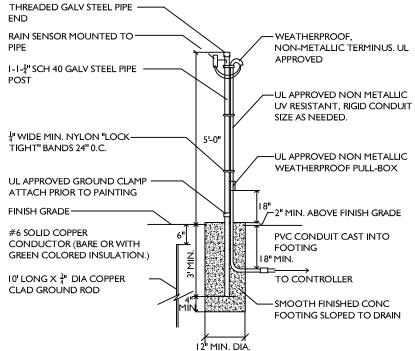


RAIN SENSOR DETAIL

N.T.S.

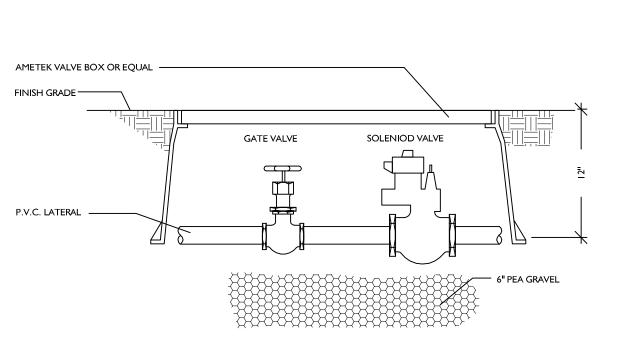

TYPICAL SOLENOID VALVE ASSEMBLY

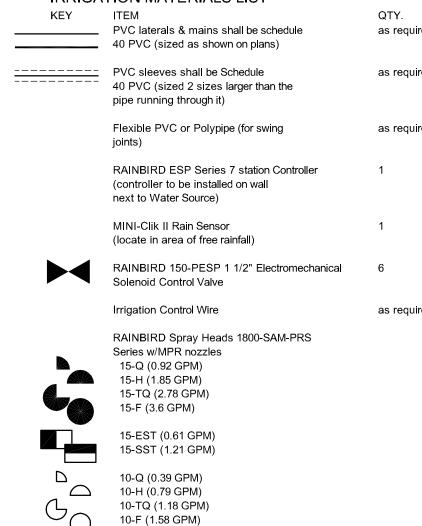


5-F (0.4 GPM)

IRRIGATION MATERIALS LIST as required as required as required as required


comm no.

date: 10-12-10

revised: 11-24-10 **Permit Revisions**

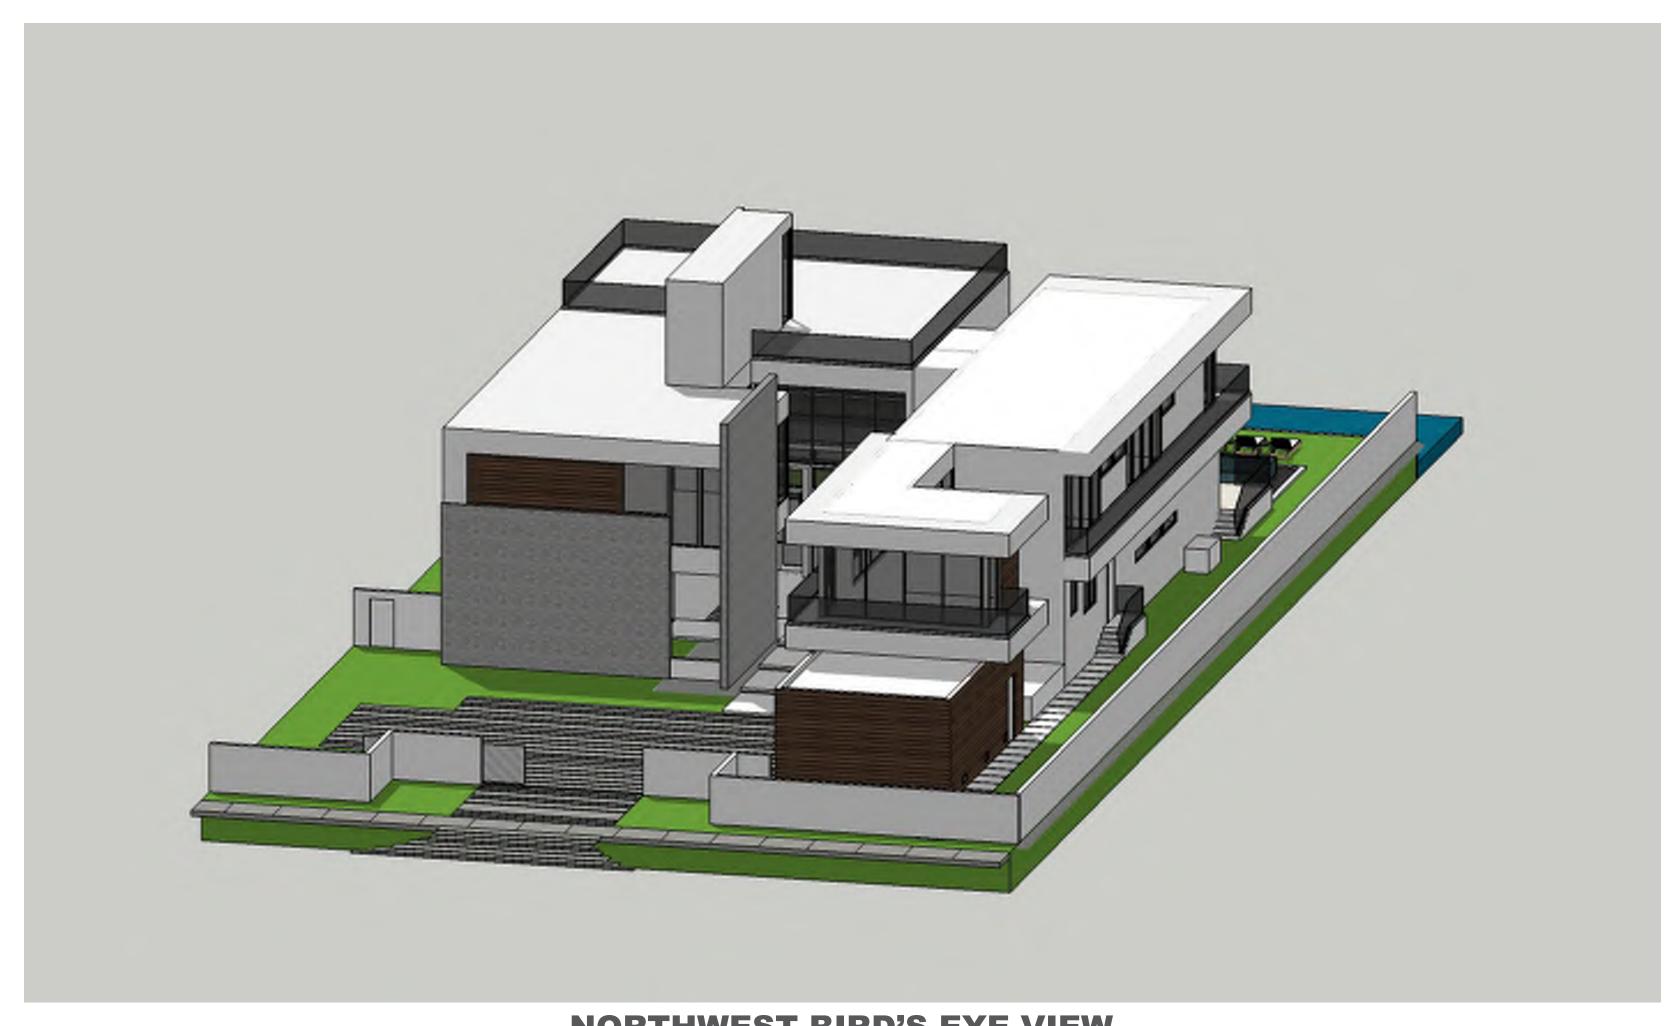

NORTHWEST BIRD'S EYE VIEW

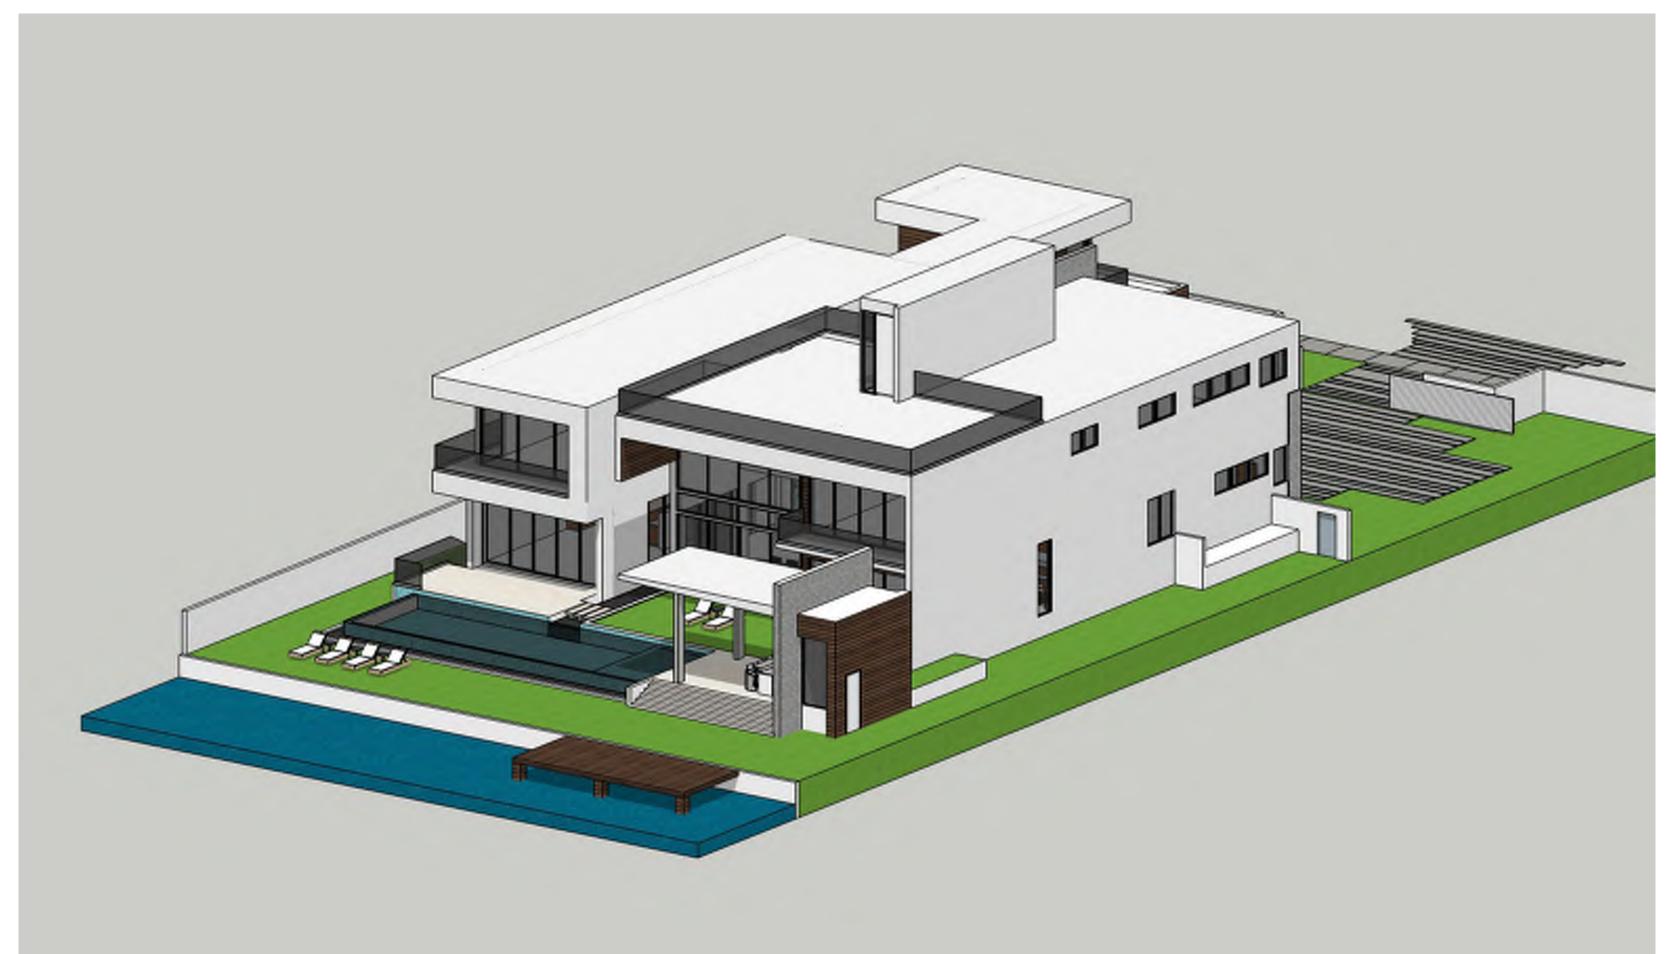

SOUTHEAST BIRD'S EYE VIEW



NORTHEAST BIRD'S EYE VIEW



SOUTHWEST BIRD'S EYE VIEW









