

ELEVATION CERTIFICATE

Important: Follow the instructions on pages 1-9.

Copy all pages of this Elevation Certificate and all attachments for (1) community official, (2) insurance agent/company, and (3) building owner.

SECTION A - PROPERTY INFORMATION				FOR INSURANCE COMPANY USE	
A1. Building Owner's Name ELIZABETH G. GALPHIN				Policy Number:	
A2. Building Street Address (including Apt., Unit, Suite, and/or Bldg. No.) or P.O. Route and Box No. 1425 CLEVELAND ROAD				Company NAIC Number:	
City MIAMI BEACH		State Florida		ZIP Code 33141	
A3. Property Description (Lot and Block Numbers, Tax Parcel Number, Legal Description, etc.) LOT 14, BLOCK 10, OF BISCAYNE POINT, PB 14-PG 35. FOLIO NO. 02-3203-001-2280					
A4. Building Use (e.g., Residential, Non-Residential, Addition, Accessory, etc.) <u>RESIDENTIAL</u>					
A5. Latitude/Longitude: Lat. <u>25.8633°N</u> Long. <u>-80.1331°W</u> Horizontal Datum: <input type="checkbox"/> NAD 1927 <input checked="" type="checkbox"/> NAD 1983					
A6. Attach at least 2 photographs of the building if the Certificate is being used to obtain flood insurance.					
A7. Building Diagram Number <u>5</u>					
A8. For a building with a crawlspace or enclosure(s):					
a) Square footage of crawlspace or enclosure(s) <u>N/A</u> sq ft					
b) Number of permanent flood openings in the crawlspace or enclosure(s) within 1.0 foot above adjacent grade <u>N/A</u>					
c) Total net area of flood openings in A8.b <u>N/A</u> sq in					
d) Engineered flood openings? <input type="checkbox"/> Yes <input checked="" type="checkbox"/> No					
A9. For a building with an attached garage:					
a) Square footage of attached garage <u>600.00</u> sq ft					
b) Number of permanent flood openings in the attached garage within 1.0 foot above adjacent grade <u>3</u>					
c) Total net area of flood openings in A9.b <u>600.00</u> sq in					
d) Engineered flood openings? <input checked="" type="checkbox"/> Yes <input type="checkbox"/> No					
SECTION B - FLOOD INSURANCE RATE MAP (FIRM) INFORMATION					
B1. NFIP Community Name & Community Number CITY OF MIAMI BEACH 120651			B2. County Name MIAMI-DADE		B3. State Florida
B4. Map/Panel Number 12086C0307	B5. Suffix L	B6. FIRM Index Date 09-11-2009	B7. FIRM Panel Effective/ Revised Date 09-11-2009	B8. Flood Zone(s) AE	B9. Base Flood Elevation(s) (Zone AO, use Base Flood Depth) +8'
B10. Indicate the source of the Base Flood Elevation (BFE) data or base flood depth entered in Item B9: <input type="checkbox"/> FIS Profile <input checked="" type="checkbox"/> FIRM <input type="checkbox"/> Community Determined <input type="checkbox"/> Other/Source: _____					
B11. Indicate elevation datum used for BFE in Item B9: <input checked="" type="checkbox"/> NGVD 1929 <input type="checkbox"/> NAVD 1988 <input type="checkbox"/> Other/Source: _____					
B12. Is the building located in a Coastal Barrier Resources System (CBRS) area or Otherwise Protected Area (OPA)? <input type="checkbox"/> Yes <input checked="" type="checkbox"/> No Designation Date: _____ <input type="checkbox"/> CBRS <input type="checkbox"/> OPA					

ELEVATION CERTIFICATE

OMB No. 1660-0008
Expiration Date: November 30, 2018

IMPORTANT: In these spaces, copy the corresponding information from Section A.			FOR INSURANCE COMPANY USE
Building Street Address (including Apt., Unit, Suite, and/or Bldg. No.) or P.O. Route and Box No. 1425 CLEVELAND ROAD			Policy Number:
City MIAMI BEACH	State Florida	ZIP Code 33141	Company NAIC Number

SECTION C – BUILDING ELEVATION INFORMATION (SURVEY REQUIRED)

C1. Building elevations are based on: ☒ Construction Drawings* ☐ Building Under Construction* ☐ Finished Construction
*A new Elevation Certificate will be required when construction of the building is complete.

C2. Elevations – Zones A1–A30, AE, AH, A (with BFE), VE, V1–V30, V (with BFE), AR, AR/A, AR/AE, AR/A1–A30, AR/AH, AR/AO. Complete Items C2.a–h below according to the building diagram specified in Item A7. In Puerto Rico only, enter meters.

Benchmark Utilized: CMB-78-02 CONVERTED NGVD Vertical Datum: NGVD 1929

Indicate elevation datum used for the elevations in items a) through h) below.

☒ NGVD 1929 ☐ NAVD 1988 ☐ Other/Source: _____

Datum used for building elevations must be the same as that used for the BFE.

Check the measurement used.

a) Top of bottom floor (including basement, crawlspace, or enclosure floor)	<u>13.00</u>	<input checked="" type="checkbox"/> feet	<input type="checkbox"/> meters
b) Top of the next higher floor	<u>N/A</u>	<input checked="" type="checkbox"/> feet	<input type="checkbox"/> meters
c) Bottom of the lowest horizontal structural member (V Zones only)	<u>N/A</u>	<input type="checkbox"/> feet	<input type="checkbox"/> meters
d) Attached garage (top of slab)	<u>6.66</u>	<input checked="" type="checkbox"/> feet	<input type="checkbox"/> meters
e) Lowest elevation of machinery or equipment servicing the building (Describe type of equipment and location in Comments)	<u>9.00</u>	<input checked="" type="checkbox"/> feet	<input type="checkbox"/> meters
f) Lowest adjacent (finished) grade next to building (LAG)	<u>6.50</u>	<input checked="" type="checkbox"/> feet	<input type="checkbox"/> meters
g) Highest adjacent (finished) grade next to building (HAG)	<u>8.50</u>	<input checked="" type="checkbox"/> feet	<input type="checkbox"/> meters
h) Lowest adjacent grade at lowest elevation of deck or stairs, including structural support	<u>6.02</u>	<input checked="" type="checkbox"/> feet	<input type="checkbox"/> meters

SECTION D – SURVEYOR, ENGINEER, OR ARCHITECT CERTIFICATION

This certification is to be signed and sealed by a land surveyor, engineer, or architect authorized by law to certify elevation information. I certify that the information on this Certificate represents my best efforts to interpret the data available. I understand that any false statement may be punishable by fine or imprisonment under 18 U.S. Code, Section 1001.

Were latitude and longitude in Section A provided by a licensed land surveyor? ☒ Yes ☐ No ☐ Check here if attachments.

Certifier's Name
WALDO F. PAEZ

License Number
LS3284

Title
LAND SURVEYOR

Company Name
DELTA MAPPING AND SURVEYING, INC.

Address
13301 SW 132 AVE, SUITE 117

City
MIAMI

State
Florida

ZIP Code
33186

Signature

Date
08-16-2018

Telephone
(786) 429-1024

Ext.

Copy all pages of this Elevation Certificate and all attachments for (1) community official, (2) insurance agent/company, and (3) building owner.

Comments (including type of equipment and location, per C2(e), if applicable)

Highest Crown of the Road Elevation = +5.48' NGVD 1929

A5. Latitude/Longitude information obtained from Google Earth.

ELEVATION CERTIFICATE

OMB No. 1660-0008
Expiration Date: November 30, 2018

IMPORTANT: In these spaces, copy the corresponding information from Section A.			FOR INSURANCE COMPANY USE
Building Street Address (including Apt., Unit, Suite, and/or Bldg. No.) or P.O. Route and Box No. 1425 CLEVELAND ROAD			Policy Number:
City MIAMI BEACH	State Florida	ZIP Code 33141	Company NAIC Number

SECTION E – BUILDING ELEVATION INFORMATION (SURVEY NOT REQUIRED) FOR ZONE AO AND ZONE A (WITHOUT BFE)

For Zones AO and A (without BFE), complete Items E1–E5. If the Certificate is intended to support a LOMA or LOMR-F request, complete Sections A, B, and C. For Items E1–E4, use natural grade, if available. Check the measurement used. In Puerto Rico only, enter meters.

- E1. Provide elevation information for the following and check the appropriate boxes to show whether the elevation is above or below the highest adjacent grade (HAG) and the lowest adjacent grade (LAG).
- a) Top of bottom floor (including basement, crawlspace, or enclosure) is _____ ☐ feet ☐ meters ☐ above or ☐ below the HAG.
- b) Top of bottom floor (including basement, crawlspace, or enclosure) is _____ ☐ feet ☐ meters ☐ above or ☐ below the LAG.
- E2. For Building Diagrams 6–9 with permanent flood openings provided in Section A Items 8 and/or 9 (see pages 1–2 of Instructions), the next higher floor (elevation C2.b in the diagrams) of the building is _____ ☐ feet ☐ meters ☐ above or ☐ below the HAG.
- E3. Attached garage (top of slab) is _____ ☐ feet ☐ meters ☐ above or ☐ below the HAG.
- E4. Top of platform of machinery and/or equipment servicing the building is _____ ☐ feet ☐ meters ☐ above or ☐ below the HAG.
- E5. Zone AO only: If no flood depth number is available, is the top of the bottom floor elevated in accordance with the community's floodplain management ordinance? ☐ Yes ☐ No ☐ Unknown. The local official must certify this information in Section G.

SECTION F – PROPERTY OWNER (OR OWNER'S REPRESENTATIVE) CERTIFICATION

The property owner or owner's authorized representative who completes Sections A, B, and E for Zone A (without a FEMA-issued or community-issued BFE) or Zone AO must sign here. The statements in Sections A, B, and E are correct to the best of my knowledge.

Property Owner or Owner's Authorized Representative's Name

Address City State ZIP Code

Signature Date Telephone

Comments

☐ Check here if attachments.

ELEVATION CERTIFICATE

OMB No. 1660-0008
Expiration Date: November 30, 2018

IMPORTANT: In these spaces, copy the corresponding information from Section A.			FOR INSURANCE COMPANY USE
Building Street Address (including Apt., Unit, Suite, and/or Bldg. No.) or P.O. Route and Box No. 1425 CLEVELAND ROAD			Policy Number:
City MIAMI BEACH	State Florida	ZIP Code 33141	Company NAIC Number

SECTION G – COMMUNITY INFORMATION (OPTIONAL)

The local official who is authorized by law or ordinance to administer the community's floodplain management ordinance can complete Sections A, B, C (or E), and G of this Elevation Certificate. Complete the applicable item(s) and sign below. Check the measurement used in Items G8–G10. In Puerto Rico only, enter meters.

- G1. ☐ The information in Section C was taken from other documentation that has been signed and sealed by a licensed surveyor, engineer, or architect who is authorized by law to certify elevation information. (Indicate the source and date of the elevation data in the Comments area below.)
- G2. ☐ A community official completed Section E for a building located in Zone A (without a FEMA-issued or community-issued BFE) or Zone AO.
- G3. ☐ The following information (Items G4–G10) is provided for community floodplain management purposes.


G4. Permit Number	G5. Date Permit Issued	G6. Date Certificate of Compliance/Occupancy Issued
-------------------	------------------------	---

- G7. This permit has been issued for: ☐ New Construction ☐ Substantial Improvement
- G8. Elevation of as-built lowest floor (including basement) of the building: _____ ☐ feet ☐ meters Datum _____
- G9. BFE or (in Zone AO) depth of flooding at the building site: _____ ☐ feet ☐ meters Datum _____
- G10. Community's design flood elevation: _____ ☐ feet ☐ meters Datum _____

Local Official's Name	Title
Community Name	Telephone
Signature	Date

Comments (including type of equipment and location, per C2(e), if applicable)



☐ Check here if attachments.

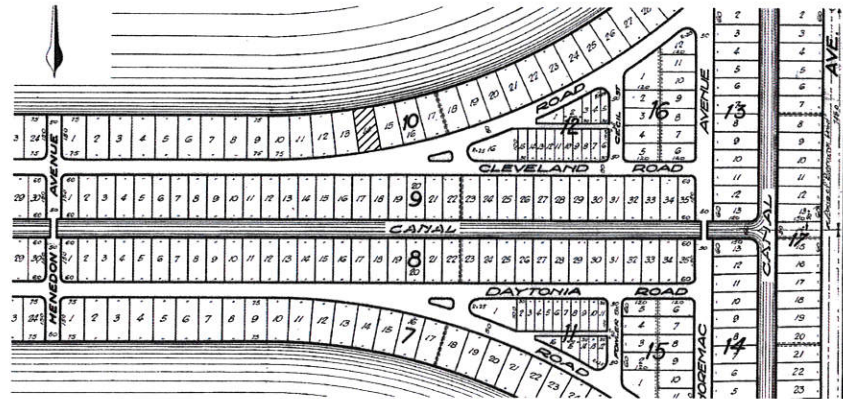

LOCATION SKETCH
NOT TO SCALE


BOUNDARY SURVEY

GRAPHIC SCALE

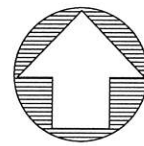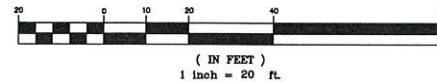

#	TREE NAME	DIAMETER(IN)	HEIGHT(FT)	SPREAD(FT)
1	CHINA PALM	10	20	15
2	BUTTERNUT	5	20	15

BISCAYNE BAY

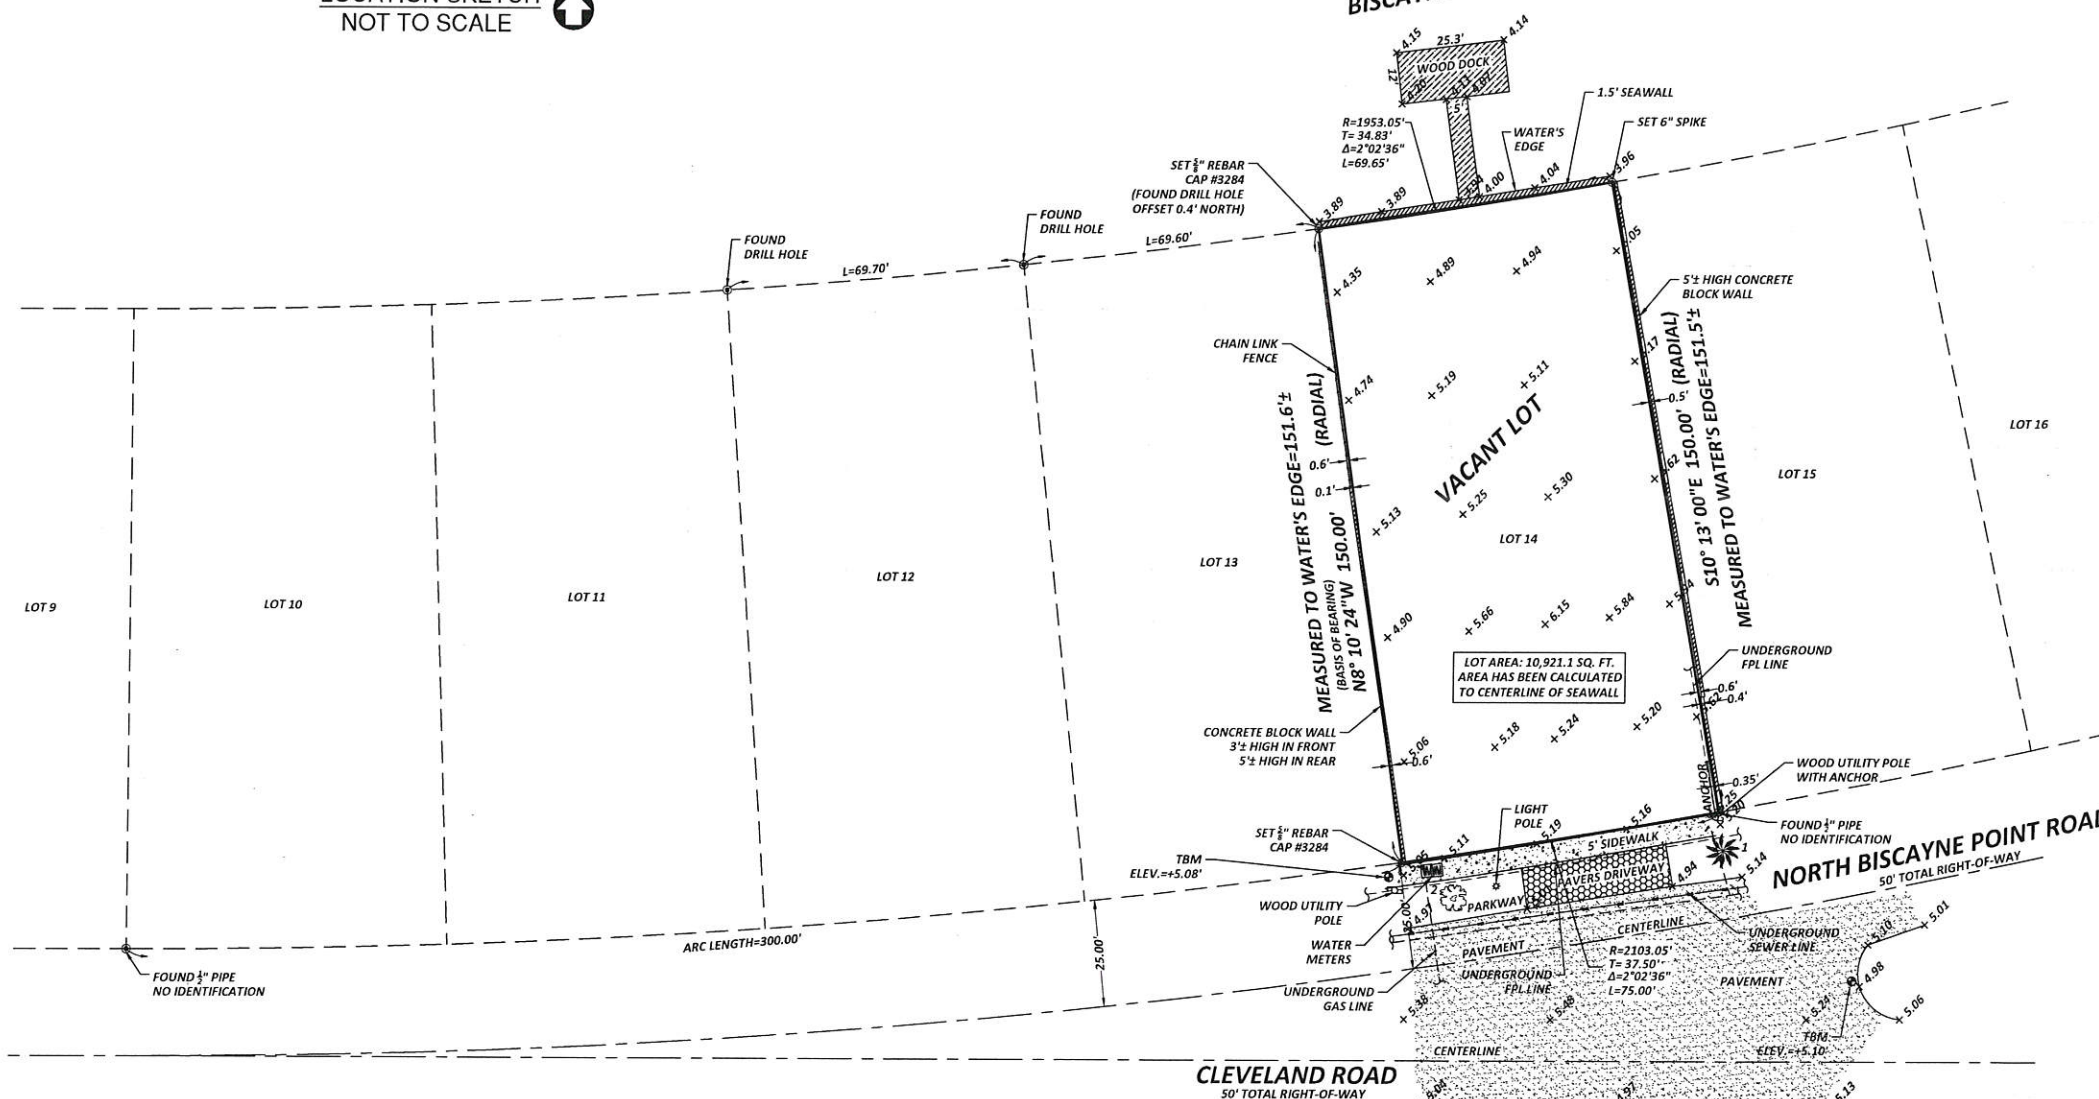

NOTE:
ALL UNDERGROUND UTILITIES SHOWN ON
SKETCH PER PAINT SHOWN ON GROUND.

LEGAL DESCRIPTION: Lot 14, in Block 10, of BISCAYNE POINT, according to the Plat thereof, as recorded in Plat Book 14, Page 35, of the Public Records of Miami-Dade County, Florida.

FOLIO NO. 02-3203-001-2280

SURVEY FOR: 1425 CLEVELAND ROAD
MIAMI BEACH, FL 33141

I HEREBY CERTIFY: That the BOUNDARY SURVEY of the above captioned property was completed under my supervision and/or direction, to the best of my knowledge and belief. This survey meets or exceeds the Standards of Practice set forth by the Florida Board of Land Surveyors in Chapter 5J-17 Florida Administrative Code. Pursuant to Section 472.027, Florida Statutes.

DELTA MAPPING AND SURVEYING, INC.

DELTA MAPPING AND SURVEYING, INC.
13301 SW 132 AVENUE, SUITE 117
MIAMI, FLORIDA 33186

WALDO F. PAEZ - DATE SIGNED: 9.05.18
PROFESSIONAL SURVEYOR AND MAPPER, NO. 3284
STATE OF FLORIDA

CERTIFICATE OF AUTHORIZATION
L.B. NO. 7950
STATE OF FLORIDA

786-429-1024
FAX: 786-592-1152

- 1) FLOOD ZONE: AE BASE: +8' PANEL NO. 12086C0307L
 - 2) THERE MAY BE ADDITIONAL RESTRICTIONS THAT ARE NOT SHOWN ON THIS SURVEY THAT MAY BE FOUND IN THE PUBLIC RECORDS OF THIS COUNTY
 - 3) EXAMINATION OF ABSTRACT OF TITLE WILL HAVE TO BE MADE TO DETERMINE RECORDED INSTRUMENTS, IF ANY, AFFECTING PROPERTY
 - 4) THIS CERTIFICATION IS ONLY FOR THE LANDS AS DESCRIBED, IT IS NOT A CERTIFICATION OF TITLE, ZONING, EASEMENTS, OR FREEDOM OF ENCUMBRANCES. ABSTRACT NOT REVIEWED
 - 5) LOCATION AND IDENTIFICATION OF UTILITIES, IF ANY ARE SHOWN IN ACCORDANCE WITH RECORDED PLAT
 - 6) OWNERSHIP IS SUBJECT TO OPINION OF TITLE
 - 7) TYPE OF SURVEY: BOUNDARY SURVEY
 - 8) THE HEREIN CAPTIONED PROPERTY WAS SURVEYED AND DESCRIBED BASED ON THE SHOWN LEGAL DESCRIPTION: PROVIDED BY CLIENT
 - 9) SURVEY MAP AND REPORT OR THE COPIES THEREOF ARE NOT VALID AND FOR REFERENCE ONLY, UNLESS SIGNED AND SEALED WITH THE ORIGINAL RAISED SEAL OF A FLORIDA LICENSED SURVEYOR AND MAPPER
 - 10) THIS PLAN OF SURVEY, HAS BEEN PREPARED FOR THE EXCLUSIVE USE OF THE ENTITIES NAMED HEREON. THE CERTIFICATE DOES NOT EXTEND TO ANY UNNAMED PARTIES
 - 11) UNDERGROUND UTILITIES ARE NOT DEPICTED HEREON, CONTACT THE APPROPRIATE AUTHORITY PRIOR TO ANY DESIGN WORK OR CONSTRUCTION ON THE PROPERTY HEREIN DESCRIBED. SURVEYOR SHALL BE NOTIFIED AS TO ANY DEVIATION FROM UTILITIES SHOWN HEREON.
 - 12) THE SURVEYOR OF RECORD DOES NOT DETERMINE OWNERSHIP OF FENCES. MEASUREMENTS SHOWN HEREON DEPICT PHYSICAL LOCATION OF FENCE
 - 13) ACCURACY: THE EXPECTED USE OF LAND AS CLASSIFIED IN THE MINIMUM TECHNICAL STANDARDS (5J-17 FAC), IS "SUBURBAN". THE MINIMUM RELATIVE DISTANCE ACCURACY FOR THE TYPE OF BOUNDARY SURVEY IS 1 FOOT IN 7,500 FEET. THE ACCURACY OBTAINED BY MEASUREMENT AND CALCULATION OF A CLOSED GEOMETRIC FIGURE WAS FOUND TO EXCEED THIS REQUIREMENT
 - 14) IN SOME INSTANCES, GRAPHIC REPRESENTATIONS HAVE BEEN EXAGGERATED TO MORE CLEARLY ILLUSTRATE RELATIONSHIPS BETWEEN PHYSICAL IMPROVEMENTS AND/OR LOT LINES. IN ALL CASES, DIMENSIONS SHOWN SHALL CONTROL THE LOCATION OF THE IMPROVEMENTS OVER SCALED POSITIONS.
 - 15) NO ATTEMPT HAS BEEN MADE TO LOCATE ANY FOUNDATION BENEATH THE SURFACE OF THE GROUND.
 - 16) CONTACT THE APPROPRIATE AUTHORITY PRIOR TO ANY DESIGN WORK ON THE HEREIN DESCRIBED PARCEL FOR BUILDING AND ZONING INFORMATION.
 - 17) ADDITIONS OR DELETIONS TO SURVEY MAPS OR REPORTS BY OTHER THAN THE SIGNING PARTY OR PARTIES IS PROHIBITED WITHOUT WRITTEN CONSENT OF THE SIGNING PARTY OR PARTIES
- IF ELEVATIONS ARE SHOWN, THEY ARE BASED ON A CLOSED LEVEL LOOP USING THIRD ORDER PROCEDURE AND ARE RELATIVE TO THE NATIONAL GEODETIC VERTICAL DATUM OF 1929.
+0.0 DENOTES EXISTING ELEVATION

BENCHMARK: CMB-78-02 LOCATOR INDEX: INT. HAWTHORNE AVE & CRESPI BLVD.
ELEVATION: +5.51' NGVD 1929 CONVERTED

BEARINGS HEREON ARE REFERRED TO AN ASSUMED VALUE OF NORTH 08 DEGREES 10 MINUTES 24 SECONDS WEST FOR THE WEST PROPERTY LINE OF LOT 14

FIELD SURVEY DATE: 6-29-18 SCALE: 1" = 20' DRAWN BY: M.G.
DRAWING DATE: 7-2-18 FB: SKETCH DRAWING NO.: 18-0286 NGVD

Delta Mapping and Surveying, Inc.
13301 SW 132ND AVENUE, SUITE 117 MIAMI FL 33186
EST. 2012
PHONE: (786) 429-1024 E-MAIL: DELTAMAPPING@GMAIL.COM



BOUNDARY SURVEY

REVISIONS
DATE

DATE: 07-02-2018
SCALE: 1" = 20'
DRAWN BY: M.G.
DRAWING NO.: 18-0286 NGVD