### SCOPE OF WORK

THE FOLLOWING DRAWINGS ILLUSTRATE THE PROPOSED LANDSCAPE SCOPE OF WORK FOR A NEW RESIDENTIAL PROJECT ON PROPERTY LOCATED IN THE NAUTILUS NEIGHBORHOOD OF THE CITY OF MIAMI BEACH.

- RESIDENTIAL TREE REMOVAL AND ON SITE MITIGATION.
- RESIDENTIAL LANDSCAPE PLANTING
- RESIDENTIAL LANDSCAPE IRRIGATION
- RESIDENTIAL LANDSCAPE SITE LIGHTING



7580 NE 4th Court Studio 100 Miami, FL 33138

> PROIECT NUMBER 1819

SUBMISSION PRELIMINARY DRB DRB

/07/18 /16/18 SHEET INDEX

COVER PAGE TREE DISPOSITION NOTES/SCHEDULE TREE DISPOSITION PLAN LCVR TD100 TD101 L200 MATERIALS NOTES AND SPECIFICATIONS L201 MATERIALS PLAN PLANTING NOTES AND SCHEDULE PLANTING PLAN L400 L401 L400.1 LANDSCAPE LEGEND L450 PLANTING DETAILS SITE LIGHTING NOTE AND SPECIFICATIONS L800 L801 SITE LIGHTING PLAN IRRIGATION DETAILS
IRRIGATION DETAILS
IRRIGATION NOTES AND PLAN IR100 IR101 IR200

LANDSCAPE DRAWINGS

**DRAWING NOTES** 

Designer/ Landscape Architect

PROJECT: **4354 ALTON** ROAD **RESIDENCES** 

4354 ALTON RD. MIAMI BEACH, FLORIDA, 33139

DRAWING:

PROJECT COVER

### SOUTH RESIDENCE



CHECK: 07/09/2018 SHEET NUMBER

### TREE DISPOSITION SCHEDULE

TREE No.	TREE - LATIN NAME	TREE - COMMON NAME	DIAMETER at BREAST HEIGHT (in inches)	MULTI TRUNK	OVERALL HEIGHT (in feet)	CANOPY DIAMETER (in feet)	CANOPY (in Sq. Ft.)	DISPOSITION	CONDITION	REMOVAL- MUNICIPAL CRITERIA AND NOTES		
										CRITERIA	CANOPY SQ. FT.	ROW CANOPY SQ. FT.
5	PTYCHOSPERMA ELEGANS	SOLITAIRE PALM	5		13	10	79	REMAIN	GOOD			
6	ADONIDIA MERRILLII	CHRISTMAS PALM	8	Х	14	14	154	REMOVE	FAIR	CONFLICTS WITH NEW CONSTRUCTION	154	
15	PERSEA AMERICANA	AVOCADO	15		22	20	314	REMOVE	FAIR	EXEMPT FROM MITIGATION		
STREET T	STREET TREES											


	UNITS REMOVED FROM ROW		-			
	UNITS REMOVED	154				
	TOTAL UNITS REMOVED:		154			
PROPOSED ON SITE MITIGATION BREAKDOWN						TREE
PROPOSED	ON SITE WITHGATION BREAKDOWN			credit/tree		CREDIT
CA	TEGORY 1 TREE 2" CAL/12' HT MIN:		3	300	Category 1 Tree = 300sf credit/tree	900
CA	TEGORY 2 TREE 2" CAL/10' HT MIN:		2	150	Category 2 Tree = 150sf credit/tree	300
C	ATEGORY 3 TREE 2" CAL/8' HT MIN:		-	100	Category 3 Tree = 100sf credit/tree	-
**FOR MITIGATION ONLY** CAT	FEGORY 4 PALM 6' CLR TRUNK MIN:		-	50	Category 4 Palm = 50sf credit/tree	-
TOTAL PROPOSED REPLACEMENT TO	REES (REFER TO PLANTING PLANS):		5	COMBINATION FU	LFILLS SITE MITIGATION OF CANOPY SF:	1,200

# TRANSPLANTING SPECIFICATIONS

- 1. Root prune all trees and palms to a minimum depth of 24° for the palms and 48° for the trees.
- 2. Trim frayed roots with clippers saws or similar and leave clean cuts.
- 3. Wrap balls with shrink wrap plastic, back filling with Shredded peat moss, fill up voids between plastic & ball, covering all cut roots.
- 4.Backfill with existing soil to hold plastic firmly against newly wrapped ball. Keep 2" deep trench exposed so as to find root ball when harvesting.
- 5. Water three times per week for next 2 months or until trees are ready to move.
- 6. Harvest palms after 5 weeks minimum and trees after 8 to 10 weeks depending on size. Consult with LA prior to moving on schedule.
- 7.Re—dig holes well outside the pastic plant wrap being careful not to disturb or tear, preserving root ball, re—wrap if needed for transplanting.
- 8. When digging trees, break off large piece of existing coral rock, +/- 36" deep as feasible, by under cutting ball.

  Do Not Peel Ball off Rock.. If necessary, the horizontal chipping or drilling may be required to break off specimen Oak ball at a minimum 30" depth
- 9. Replant transplanted trees and palms at correct height in new location, keeping original ball top exposed.
- 10. Properly wrap and hook—up trees and palms to lifting equipment in such a way as to not tear cambium layer and exessivly disfigure appearance.
- 11. Plants that are not properly lifted and die due to girdling, compression or excessive damage to the cambium layer will be charged to the G.C. and Sub—contractor at a rate of \$500 per caliper inch.
- 12. Remove plastic, backfill with 50% existing soil blended with 50% planting soil plus 1/4 bale of Canadian peat moss for palms and 1/2 bale for trees.
- 13. Backfill, sink, place in Agriform fertilizer tablets per recommendations, brace, and trim broken branches and fronds as needed. Brace per specification.
- 14. Water daily for duration of overall job will be required. Having bubblers as part of automatic irrigation system for post construction can supplement additional drenching, but are not a sustitution.



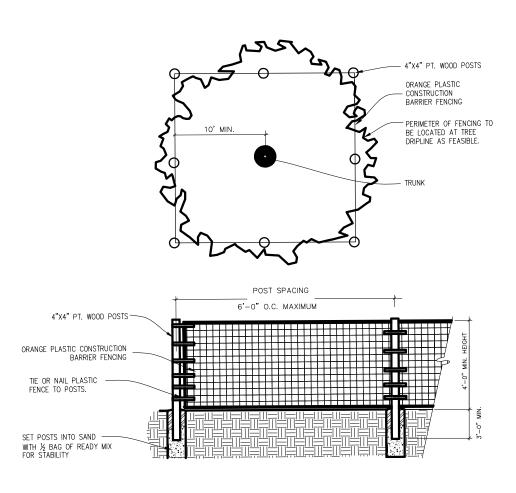



7580 NE 4th Court Studio 100 Miami, FL 33138

PROJECT NUMBER



Designer/ Landscape Architect

PROJECT:

4354 ALTON ROAD RESIDENCES

4354 ALTON RD. MIAMI BEACH, FLORIDA, 33139

DRAWING:

TREE DISPOSITION NOTES, SCHEDULE AND TREE PROTECTION DETAIL

MARSH C. KRIPLEN FLORIDA LIC# LA6667 ALL DRAWINGS AND WRITTEN MATERIAL APPEA

WORK OF McG ARCHITECTURE AND MA DUPLICATED, USED OR DISCLOSED WIT EXPRESS WRITTEN CONSENT OF McG ARCHI PLANNING, INC. (c) 2018 SCALE:

CHECK: MCK
DATE: 07/09/2018

**TD100** 





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PROJECT NUMBER









MAK

Designer/ Landscape Architect

PROJECT:
4354 ALTON
ROAD
RESIDENCES

4354 ALTON RD. MIAMI BEACH, FLORIDA, 33139

DRAWING:

TREE DISPOSITION PLAN



MARSH C. KRIPLEN FLORIDA LIC# LA66670


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SCALE

CHECK: MCk

DATE: 07/09/201

1 TREE DISPOSITION PLAN

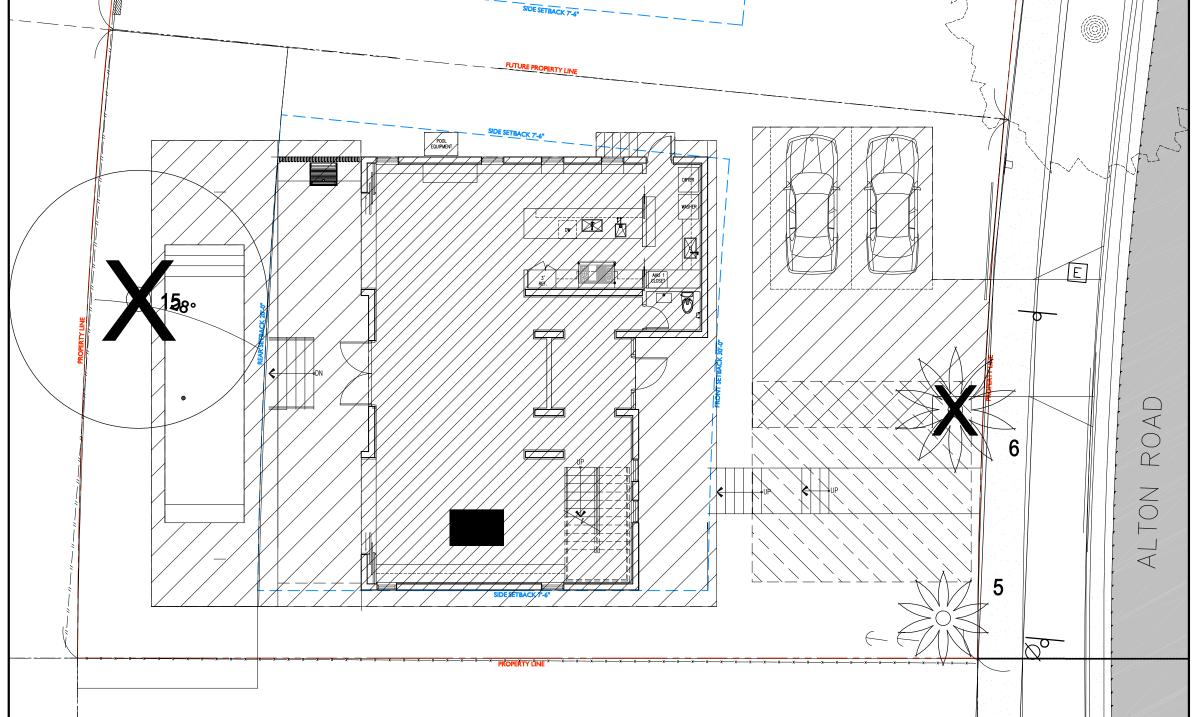

SCALE: 3/32" = 1'-0"

TD101

### MATERIALS NOTES

- CONTRACTOR TO VERIFY ALL QUANTITIES. IN CASE OF ANY DISCREPANCIES, GRAPHICALLY SHOWN MATERIAL QUANTITIES SHALL TAKE PRECEDENCE.
- ALL CONSTRUCTION AND MATERIALS NOT SPECIFICALLY ADDRESSED IN THE CONTRACT DOCUMENTS OR SPECIFICATIONS SHALL BE IN ACCORDANCE WITH LOCAL, STATE AND FEDERAL JURISDICTIONS AND GOVERNING BODIES/AGENCIES STANDARDS.
- THE CONTRACTOR SHALL PROVIDE A FULL-SCALE MOCKUP AND RECEIVE APPROVAL FROM THE LANDSCAPE ARCHITECT FOR ALL SYSTEMS BEFORE BEGINNING CONSTRUCTION OF PAVEMENT.
- 4. EXPANSION JOINTS SHALL BE PROVIDED WHERE FLATWORK MEETS VERTICAL STRUCTURES, SUCH AS WALLS, CURBS, STEPS, AND OTHER HARDSCAPE ELEMENTS. EXPANSION JOINTS SHALL ALSO BE PROVIDED AT MATERIAL CHANGES. EXPANSION JOINT MATERIALS/METHODS SHALL BE SUBMITTED TO THE LANDSCAPE ARCHITECT FOR REVIEW AND APPROVAL PRIOR TO INSTALLATION.
- CONTROL JOINTS SHOULD BE SPACED NO GREATER THAN TEN (10) LINEAR FEET MAXIMUM, UNLESS OTHERWISE SPECIFIED. EXPANSION JOINTS SHOULD BE SPACED NO GREATER THAN FORTY (40) LINEAR FEET MAXIMUM, UNLESS OTHERWISE SPECIFIED. CONTRACTOR SHALL ADVISE ON OTHER JOINTS AS NEEDED TO MINIMIZE CRACKING. THIS INFORMATION SHALL BE SUBMITTED TO THE LANDSCAPE ARCHITECT FOR REVIEW AND APPROVAL PRIOR TO INSTALLATION.
- 6. CONTROL JOINTS SHALL BE PROVIDED AS SPECIFIED IN THE CONTRACT DOCUMENTS. CONTROL JOINT MATERIALS, METHODS AND RECOMMENDATIONS ON ADDITIONAL CONTROL JOINTS TO MINIMIZE CRACKING SHALL BE SUBMITTED TO THE LANDSCAPE ARCHITECT FOR REVIEW AND APPROVAL
- 7. ALL STEPS SHALL HAVE TWELVE (12) INCH TREADS AND SIX (6) INCH RISERS, UNLESS OTHERWISE SPECIFIED.
- HOLD TOP OF WALLS AND FENCES LEVEL, UNLESS OTHERWISE SPECIFIED.
- CONTRACTOR SHALL NOT INSTALL WORK LOCATED ON TOP OF ARCHITECTURAL STRUCTURES WITHOUT FIRST REVIEWING ARCHITECTURAL DRAWINGS.
- 10. SAMPLES OF SPECIFIED MATERIALS SHALL BE SUBMITTED TO THE LANDSCAPE ARCHITECT FOR REVIEW AND APPROVAL PRIOR TO ORDERING FOR JOB.





# PAVING I: UNIT PAVERS

MATERIAL: HANOVER- PREST PLANKSTONE PAVERS

COLOR: GRAY/SLATE FINISH: STD

LOCATION: MOTORCOURT

IPE

OILED

FACTORY SANDED

PORCH, TERRACE AND DECK

7580 NE 4th Court Studio 100 Miami, FL 33138

1819



Designer/ Landscape Architect

PROJECT:

# **4354 ALTON** ROAD **RESIDENCES**

4354 ALTON RD. MIAMI BEACH, FLORIDA, 33139

**DRAWING:** 

MATERIALS NOTES AND **SPECIFICATIONS** 



## PAVING III: CRUSHED SHELL

MATERIAL: OLIMAR STONE, FLORIDA MIX

COLOR: STANDARD

FINISH:

LOCATION: SERVICE WALKWAY




L200

# SIDE SETBACK 7'-6" EL. +6.4' NGVD EL. +6.4' NGVD T.O.FENCE +6' NGVD EL. +6' NGVD EL. +5' NGVDEL. +5' NGVD LAWN 370SF TERRACE DW DW E L. +3.9' NGVD EL. +4.5' NGVD EL. +9.00' NGVD PO OFIN.FLR. EL. +8.5' NGVD FIN.FLR. FIN.FLR. LAWN 55SF EL. +3.9' NGVD LAWN 275SF

MATERIALS PLAN

### MATERIALS LEGEND

3/32" = 1"-0"

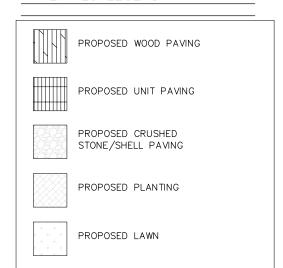



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PROJECT NUMBER



Designer/ Landscape Architect


PROJECT:

# 4354 ALTON ROAD RESIDENCES

4354 ALTON RD. MIAMI BEACH, FLORIDA, 33139

DRAWING:

MATERIALS PLAN

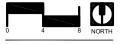

MARSH C. KRIPLEN FLORIDA LIC# LA66670

ALL DRAWINGS AND WRITTEN MATERIAL APPEAR
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SCALE

CHECK:

L201

### PLANTING NOTES

- PLANT MATERIAL IS TO BE HEALTHY SPECIMENS FREE FROM DISEASE OR DAMAGE, AND IS TO BE MAINTAINED IN EXCELLENT CONDITION WHILE ON THE JOBSITE. LANDSCAPE ARCHITECT SHALL INSPECT PLANT MATERIAL UPON ARRIVAL TO JOBSITE AND WILL REJECT PLANT MATERIAL THAT DOES NOT MEET THE STANDARDS DESCRIBED WITHIN THE CONTRACT DOCUMENTS.
- THE LANDSCAPE ARCHITECT WILL PERIODICALLY INSPECT PLANT MATERIAL STOCKPILED AND/OR PLANTED ON SITE DURING THE COURSE OF CONSTRUCTION. PLANT MATERIAL NOT MEETING THE STANDARDS CONTAINED WITHIN CONTRACT DOCUMENTS SHALL BE REPLACED AT NO COST TO THE OWNER
- PRESERVE & PROTECT ALL EXISTING VEGETATION INDICATED TO REMAIN AT ALL TIMES.
- PROVIDE MATCHING SIZES AND FORMS FOR EACH PLANT OF THE SAME SPECIES UNLESS OTHERWISE INDICATED.
- CONTRACTOR TO VERIFY ALL QUANTITIES. IN CASE OF DISCREPANCIES, GRAPHICALLY SHOWN QUANTITIES SHALL TAKE PRECEDENCE.
- ALL MATERIALS USED SHALL CONFORM TO THE GUIDELINES ESTABLISHED BY THE CURRENT AMERICAN STANDARDS FOR NURSERY STOCK, PUBLISHED BY THE AMERICAN ASSOCIATION OF NURSERYMEN.
- ALL PLANT MATERIAL SHALL BE INSTALLED PLUMB AND PER THE SPECIFICATIONS CONTAINED WITHIN THE CONTRACT DOCUMENTS. ANY NECESSARY STAKING AND/OR OTHER SUPPORTS MATERIALS/METHODS SHALL BE SUBMITTED TO THE LANDSCAPE ARCHITECT FOR REVIEW AND APPROVAL PRIOR TO INSTALLATION.
- THE CONTRACTOR SHALL PRUNE EXISTING AND/OR NEW TREES ONLY PER LANDSCAPE ARCHITECT DIRECTION.
- THE CONTRACTOR SHALL STAKE THE LOCATIONS OF ALL TREES AND B&B SHRUBS FOR LANDSCAPE ARCHITECT REVIEW AND APPROVAL, PRIOR TO
- 10. ALL ROOT-WRAPPING MATERIALS THAT ARE NOT BIO-DEGRADABLE SHALL BE REMOVED FROM THE ROOT BALL. ROOT BALLS SHALL BE FREE OF WEEDS.
- 11. SPECIFIED PLANT MATERIAL SIZES SHALL BE CONSIDERED MINIMUM SIZES.
- FINISH GRADE OF PLANTING BEDS SHALL BE TWO (2) INCHES BELOW 12. ADJACENT FLATWORK, UNLESS SPECIFIED OTHERWISE.
- 13. MULCH OR PLANTING BED DRESSING SHALL BE PLACED IN ALL PLANTING AREAS AS SPECIFIED. MULCH OR PLANTING BED DRESSING SHALL NOT BE PLACED WITHIN SIX (6) INCHES OF TREE TRUNKS. MULCHING SHOULD BE REPEATED ANNUALLY DURING THE AUTUMN TO A THREE (3) INCH DEPTH.
- ALL PLANT MATERIAL SHOULD RECEIVE AN ORGANIC FERTILIZER IN LIMITED APPLICATION FOLLOWING INSTALLATION. TYPE AND APPLICATION RATE AND METHOD OF APPLICATION TO BE SPECIFIED BY THE CONTRACTOR AND APPROVED BY THE LANDSCAPE ARCHITECT.
- 15. EXCESS FERTILIZER SHALL BE DISPOSED OF PROPERLY OFF-SITE. IT SHALL NOT BE DISPOSED OF IN STORM DRAINS AND/OR DRYWELLS.
- STOCKPILED PLANT MATERIAL TO BE PLACED IN THE SHADE AND PROPERLY HAND-WATERED UNTIL PLANTED
- MULCH ALL BEDS WITH 2-3" AT TIME OF PLANTING. REFER TO PLANTING DETAILS FOR MULCH SPECIFICATIONS. REPLENTISH MULCH AS REQUIRED OVER THE COURSE OF THE GUARANTEE PERIOD TO ENSURE ADEQUATE
- SIX (6) INCH PLANT MIX SHALL BE PROVIDED FOR ALL LAWN, TURF, AND NATIVÉ PLANTING ZONES. 18 INCH PLANT MIX SHALL BE PROVIDED FOR ALL PERENNIAL PLANTING BEDS UNLESS OTHERWISE NOTED.
- 19. LANDSCAPE CONTRACTOR TO PAINT ALL TREE & PALM SUPPORTS WITH BENJAMIN MOORE ARBORCOAT ASHLAND SLATE EXTERIOR WOOD PAINT. ALL BRACING CUTS TO BE NEAT AND CLEAN, NO CHAINSAW CUTS.
- 20. GUARANTEE PERIOD: CONTRACTOR IS RESPONSIBLE FOR SITE MAINTENANCE AND MATERIAL REPLACEMENT FOR ONE YEAR FROM THE DATE OF SUBSTANTIAL COMPLETION. REMOVE AND REPLACE ALL DEAD PLANT MATERIAL OR MATERIAL WHICH IS FAILING AS DETERMINED BY ARBORIST AND LANDSCAPE ARCHITECT. CORRECT DEFICIENCIES WITH MULCH AND IRRIGATION.
- 21. MAINTENANCE PLAN: DURING THE GUARANTEE PERIOD CONTRACTOR SHALL PERFORM THE FOLLOWING TASKS ON A REGULARLY SCHEDULED BASIS. WEEKLY WATERING (JAN-APR) WHEN IRRIGATION SYSTEMS ARE NOT OPERATIONAL WEEKLY SITE INSPECTION FOR PLANT HEALTH, TREE/PALM GUYING,
  - IRRIGATION OPERATION.
  - QUARTERLY FERTILIZATION (MAR-SEPT) APPROPRIATE FOR MATERIAL (REF IFAS PUBLICATION ENH858)
  - WEEKLY MOWING OF LAWNS AND PLANT BED WEEDING DURING THE GROWING AND SHOULDER SEASONS. MONTHLY VISITS FOR SAME OVER WINTER.

### PLANTING SCHEDULE

TYPE	ABR.	QUANTITY	BOTANICAL NAME	COMMON NAME	SPECIFICATIONS			
PALMS	PALMS							
	BNO	2	BISMARCKIA NOBILIS	BISMARCK PALM	10' GW, MATCHED			
	DCA	3	DYPSIS CABADAE	CABADA PALM	45 GAL			
	DCAa	3	DYPSIS CABADAE	CABADA PALM	100 GAL			

TREES	TREES						
*/***	ACH	2	ACACIA CHORIOPHYLLA	CINNECORD	2" CAL. & 12' HT. MIN.		
**	CGR	3	CAESALPINIA GRANADILLO	BRIDAL VEIL- 4' CLR TRUNK	3" CAL. & 14' HT. MIN.		
*/***	CRO	1	CLUSIA ROSEA	AUTOGRAPH TREE	4" CAL. & 16' HT. MIN		
*/***	CUV	1	COCOLOBA UVIFERA	SEA GRAPE- MULTI-TRUNK SPECIMEN	3" CAL. & 14' HT. MIN		
*/***	PPT	1	PELTOPHORUM PTERCARPUM	COPPER POD	2" CAL. & 12' HT. MIN.		
*/***	QVI	1	QUERCUS VIRGINIANA	LIVE OAK- SPECIMEN	3" CAL. & 14' HT. MIN.		

UNDERS	TORY	TREES /	LARGE SHRUBS						
	GLU	2	GYMNANTHES LUCIDA	CRABWOOD- MULTI TRUNK	6' HT.	&	4'	SPREAD	MIN
	MFR	5	MYRCIANTHES FRAGRANS	SIMPSON STOPPER- LOW BRANCHING	6' HT.	&	4'	SPREAD	MIN

ACCENTS /	SHRUBS			
AG	12	ARGUSIA GNAPHALODES	SEA LAVANDER	7 GAL
BA	7	BRUNFELSIA AMERICANA	LADY OF THE NIGHT	3 GAL
CWI	8	CANELLA WINTERANA	CINNAMON BARK	15 GAL
CO	11	COLOCASIA 'BLACK MAGIC'	BLACK TARO	7 GAL
Cs	8	COLOCASIA SPECIES	TARO	7 GAL
EFE	1	ENCEPHALARTOS FEROX	ZULULAND CYCAD	15 GAL
EAX	2	EUGENIA AXILLARIS	WHITE STOPPER	15 GAL, BUSH FORM
ECO	4	EUGENIA CONFUSA	REDBERRY STOPPER	15 GAL, BUSH FORM
MD	7	MONSTERA DELICIOUSA	MONSTERA	3 GAL
HC	3	HELICONIA CARIBAEA	WILD PLANTAIN	7 GAL
HR	6	HELICONIA ROSTRATA	LOBSTER CLAW	15 GAL
PM	23	PODOCARPUS MACROPHYLLUS	JAPANESE YEW	25 GAL. 6' HT MIN., MATCHE
RE	11	RUSSELIA EQUISETIFORMIS	FIRECRACKER	3 GAL
ZI	2	ZAMIA INTEGRIFOLIA (FLORIDANA)	COONTIE	7 GALLON

GROUNCOVER						
	LM	56	LIRIOPE MUSCARI	LILY TURF	1 GALLON	
	MS	96	MICROSORUM SCOLOPENDRIA	WART FERN	1 GALLON	
	РВ	84	PHILODENDRON BURLE MARX	PHILODENDRON BURLE MARX	1 GALLON	
	TA	57	TRACHELOSPERMUM ASIATICUM	CREEPING JASMINE	1 GALLON	

ORNAMEN	NTAL	GRASSES			
S	SBA	4	SPARTINA BAKERI	SAND CORDGRASS	7 GALLON
	TDA	3	TRIPSACUM DACTYLOIDES	FAKAHATCHEE GRASS	7 GALLON

LAWN			
LAWN 690 SF	STENOTAPHRUM SECUNDATUM	ST. AUGUSTINE GRASS	SOD

# TREE AND PALM ALLOCATION LEGEND

- MITIGATION
- STREET TREE
- \*\*\* SITE LANDSCAPE

### DEFINITIONS

- 1. TREE: ANY SELF SUPPORTING WOODY PLANT OR PALM WHICH USUALLY HAS A MAIN AXIS OR TRUNK. 12' HT, 6' CANOPY DIA. AND 2" CAL. TRUNK MINIMUM AT TIME OF PLANTING.
- STREET TREE: A SPECIES TYPICALLY GROWN IN MIAMI BEACH WHICH NORMALLY MATURES TO A HEIGHT OF AT LEAST 20'. 12' HT., 3" CAL. TRUNK AND 4' CLR TRUNK MINIMUM AT TIME OF PLANTING. MAXIMUM AVERAGE TREE SPACING 20' O.C. (CITY DISCRETION ALLOWED DEPENDING ON SITE CONDITIONS).
- PALMS (STREET TREES): SINGLE TRUNK SPECIES. 15' CLEAR WOOD AND 10" DBH TRUNK MINIMUM AT TIME OF PLANTING. PALMS SHALL NOT COUNT TOWARD THE REQUIRED STREET TREES.

4. LARGE SHRUB - SMALL TREE: NORMALLY MATURES AT MINIMUM HEIGHT OF 10'. 6' HT. AND 4' CANOPY DIA. MINIMUM AT TIME OF PLANTING.



7580 NE 4th Court Studio 100 Miami, FL 33138

1819



Designer/ Landscape Architect

PROJECT: **4354 ALTON** ROAD

4354 ALTON RD. MIAMI BEACH, FLORIDA, 33139

RESIDENCES

DRAWING:

PLANTING NOTES & SCHEDULE

CHECK

SHEET NUMBER

I 400

MEG
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7580 NE 4th Court Studio 100 Miami, FL 33138

PROJECT NUMBER

MAK	
Designer/ Landscape Architect	

PROJECT: **4354 ALTON** ROAD RESIDENCES

4354 ALTON RD. MIAMI BEACH, FLORIDA, 33139

DRAWING:

LANDSCAPE LEGEND

SCALE:	
CHECK:	MCk
DATE:	07/09/2018
SHEET	NUMBER


# LANDSCAPE LEGEND

MUNICIPALITY: City of Miami Beach

ZONING CLASS: RS-4 LOT AREA: 6,500 ACRES: 0.1492

Multiplier: 50%

				ORI	DINANCE/CODE SECTION: CITY OF MIAMI BEACH SECTION 126	·	
						REQUIRED/	
STREET TREES			OPEN SPACE		PACE	ALLOWED	PROVIDED
				A.	Sq. Ft. of required Open Space	4,550	4,857
A.	Street trees (maximum average spacing of 30' o.c.)	2	2		Lot area:6,500		
	Linear ft of street frontage: 60				Multiplier: 70%		
	Multiplier: 30			В.	Sq. Ft. of parking lot open space	20	0
	Percentage of Palms counted toward Street Trees on 1:1 basis	1	1		Parking Spaces:2		
	Multiplier: 30%				Multiplier:10sf/space		
3.	Street trees directly below power lines	0	0				
	Linear ft of street frontage:0			C.	Total Sq. Ft. of landscaped Open Space required	4,570	4,857
	Multiplier: 25						
'*One s	site tree (CUV) being counted toward street tree requirements)**			LAWN A	REA		
				Α.	Total Sq. Ft. of landscaped Open Space	4,570	4,857
SHRU	BS			В.	Maximum Lawn Area (sod) permitted-	2,285	690
٩.	Number of shrubs required	72	72		Open space required:4,570		
Lo	ot and street trees required: 6		-	<del></del>	Multiplier: 50%		
	Multiplier: 12						
В.	% Native species required	36	36	TREES			
	Shrubs provided: 72			A.	Number of trees required per lot, less existing trees	6	6
	Multiplier: 50%			<i>.</i>	Required Trees/Lot: 6		
					Net lot acres: 0.1492		
LARGE	E SHRUBS OR SMALL TREES				Required Trees: 6		
4.	Number of large shrubs or small tree required	7	7		Existing trees: 0		
•	Shrubs required: 72			— В.	% Palms allowed	na	na
	Multiplier: 10%				Palms allowed 1:1 for mitigation only.	-	
В.	% Native species required	4	4	C.	% Native required	2	1
	Shrubs provided: 7	<u> </u>	·		Trees provided: 5		_
	Multiplier: 50%				Multiplier: 30%		
				D.	% Drought tolerant and low maintenance species required	3	1
					Trees provided: 5		

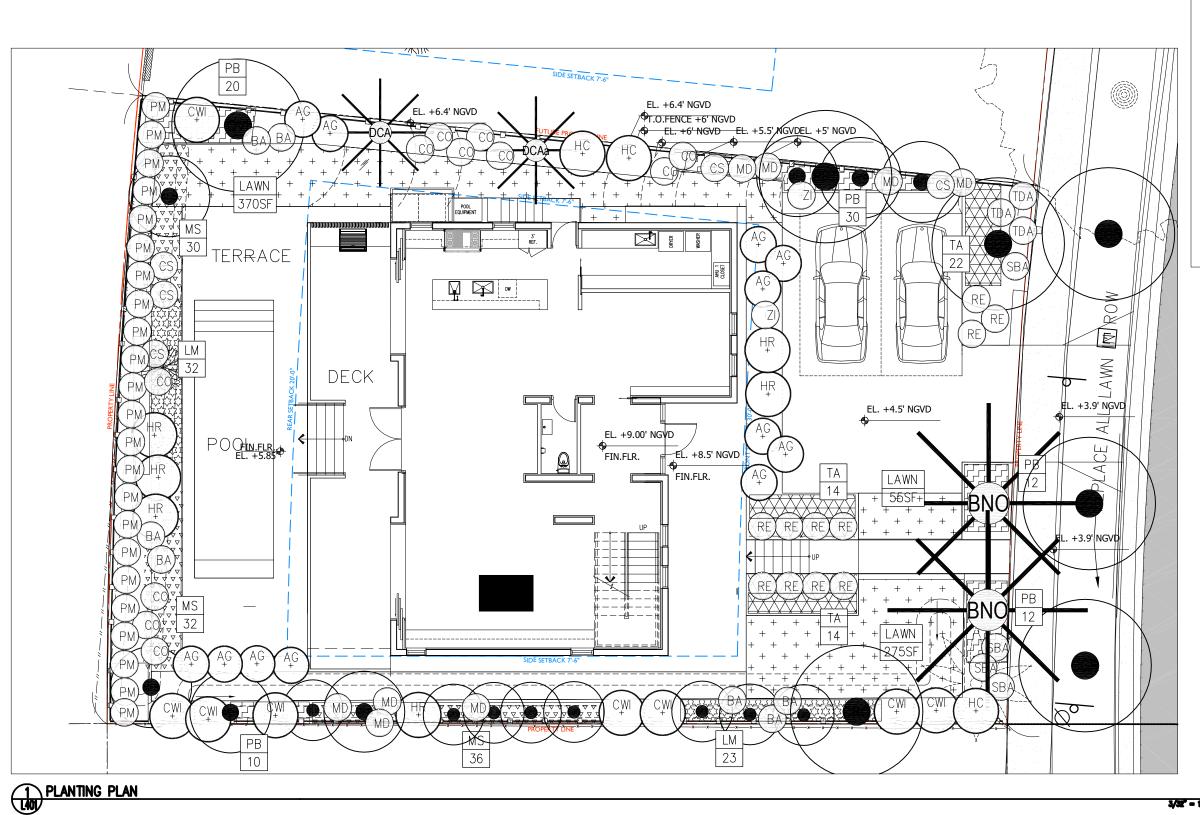

PLANTING LEGEND



EXISITNG TREE



PROPOSED TREE



EXISTING



PROPOSED PALM



PROPOSED SHRUBS— ACCENTS



PROPOSED GROUNDCOVER



PROPOSED LAWN



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DRAWING:


PLANTING PLAN



CHECK: 07/09/2018

L401

3/32" = 1'-0"

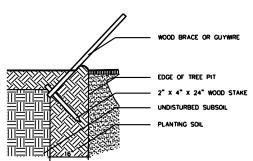

TOP OF STAKE MUST BE MINIMUM OF 3" BELOW FINISHED GRADE

STAKING NOTES:
1. SAW CUT ALL WOOD STAKING MATERIALS LEAVE ENDS NEAT AND TRIM.
2. PAINT ALL WOOD STAKING MATERIALS HUNTER GREEN.

9 STAKING DETAIL & NOTES SCALE: NOT TO SCALE

PREPARATION:
STORE ALL MATERIAL IN DRY, CLEAN AREA, COVER TO PROTECT FROM RAIN AND MINIMIZE DUST. COORDINATE RUN-OFF
CONTROL WITH CENERAL CONTRACTOR.
IEST EXISTING SOIL TO ENSURE IT IS FREE OF EXCESSIVE CLAY OR SALT AND ANY CHEMICALS/PETROCHEMICALS WHICH
MAY HAMBY PLANT FEALTH.

EXISTING MATERIAL:

# INCORPORATING EXISTING SITE SOIL REMOVE ALL ROOTS, AND ROCK LARGER THAN 2" IN SIZE. REMOVE ALL PLASTIC, METAL AND MANAGE DETRITUS.

MIX: 50% EXISTING SOIL 10% COCO PEAT 10% COMPOST 20% CLEAN SAND 10% PERLITE

BLEND QUANTITIES NEEDED BY HAND OR MACHINE

INSTALLATION:
REFER TO APPROPRIATE DETAILS FOR AMENDMENTS, COMPACTION DEPTHS ETC.

GENERAL: REFER TO LANDSCAPE NOTES FOR ADDITIONAL INFORMATION

10 PLANTING SOIL- TYPICAL

MULCH A: PINE STRAW, FOR USE IN CENERAL PLANTING AREAS AND ON SLOPES GREATER THAN 10%

MULCH 8: OPTION, MELALEUCA MULCH, FOR USE IN GENERAL PLANTING AREAS AND ON SLOPES GREATER THAN 10%

MULCH C: IF SPECIFIED, MINI PINE BARK NUGGETS, FOR USE IN SPECIALTY AREAS

# INSTALLATION: REFER TO APPROPRIATE DETAILS FOR EXTENTS AND DEPTHS.


11 MULCH- TYPICAL

### MIX: # 5050- MUCK AND FINE SAND


SUPPLIER: ATLAS PEAT AND SOIL 561,734,7300


12 PLANTING SOIL- LAWN TOP DRESSING



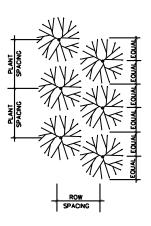

PLANT SPACING	ROW SPACING
12"	10.4"
18"	15.6"
24"	20.8"
30"	26.0"
36"	31.2"
48"	41.6"
60"	52.0"

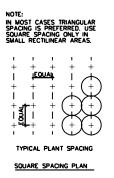


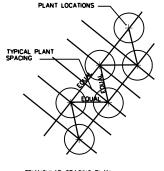

TRIANGULAR SPACING PLAN


PLANT SPACING

SCALE: NOT TO SCALE

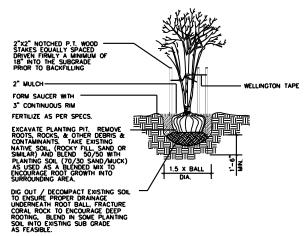


7 MULTI TRUNK TREE - PLANTNG & STAKING


CALIPER	TIES	STRANDS	STAKES
1" - 1 1/2"	2	1 # 12	2 - 2 × 2
1 1/2" - 2"	3	1 # 12	3 - 2 × 2
2" - 3"	3	2 # 12	2 - 2 × 2

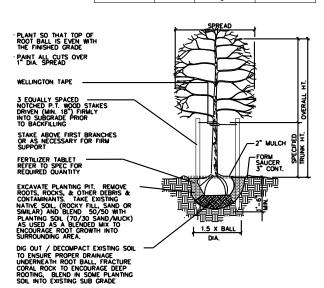

NOTE: USE FOR 3" OR LESS SINGLE STEM TREES & PALMS

8 CANOPY AND PALM TREE - PLANTING & VERTICAL STAKING SCALE: NOT TO SCALE

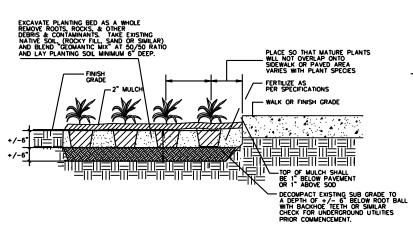

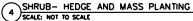

8" - 10"   2 x 4 x 12"   1 # 12   3 - 2 X 4	3 - 16d
10" - 16" 2 x 4 x 12" 2 # 12 4 - 2 X 4	3 - 16d
* SPREAD	
PLANT SO THAT TOP OF ROOT BALL IS EVEN WITH THE FINISHED GRADE  WRAP TRUNK W/ 5 LAYERS OF BURLAP, IF SOFT SKIN BARK  WOODEN CLEATS WILL BE EQUALLY SPACED OVER PADDING & SECURED	NOTE: STAKE TO FIRST BRANCHE: AS NECESSARY FOR FIRM SUPPORT WIRE SHALL NOT TOUCH OR RUB ADJACENT TRUNKS OR BRANCHES
W/ STEEL BANDS	
EQUALLY SPACED 2" X 4" P.T. WOOD STAKES NAILED TO CLEATS, DO NOT HAIL TO TRUNK	
FORM SAUCER WITH 5" CONTINUOUS RIM 5 5 5 5 5 72" MULCH SE	
FERTILIZER TABLET REFER TO SPEC FOR REGUIRED QUANTITY	-
EXCAVATE PLANTING PIT. REMOVE ROOTS, ROCKS, & OTHER DEBIS & CONTAMINANTS. TAKE EXISTING NATIVE SOLL (ROCKY FILL SAND OR SIMILAR) AND BLEND 50/50 WITH PLANTING SOLL (70/30 SAND/WICK) AS USED AS A BLENDED MIX TO ENCOURAGE ROOT GROWTH INTO SURROUNDING AREA.	ER TO STAKING DETAIL
DIG OUT / DECOMPACT EXISTING SOIL  TO ENSURE PROPER DRAMAGE UNDERNEATH ROOT BALL, FRACTURE CORAL, ROOK TO ENCOURAGE DEEP ROOTING, BLEND IN SOME PLANTING SOIL INTO EXISTING SUB GRADE AS FEASIBLE.	

CLEATS STRAPS BRACES 3" - 8" 2 x 4 x 8" 1 # 12 3 - 2 x 4 2 - 16d

NOTE: USE FOR 3" TO 12" SINGLE TRUNK TREES

5 CANOPY TREE - PLANTING & TRIPLE BRACE STAKING SCALE: NOT TO SCALE



FERTILIZE PER SPECIFICATIONS

EXCAVATE PLANTING PIT. REMOVE ROOTS, ROCKS, & OTHER DEBRIS & CONTAMINANTS. TAKE EXISTING NATIVE SOIL, (ROCKY FILL, SAND OR SIMILAR) AND BLEND 50/50 WITH SPECIFIED PLANTING SOIL

DIG OUT / DECOMPACT EXISTING SOIL TO ENSURE PROPER DRAINAGE UNDERNEATH ROOT BALL, FRACTURE CORAL ROCK TO ENCOURAGE DEEP ROOTING, BLEND IN SOME PLANTING SOIL INTO EXISTING SUB GRADE AS FEASIBLE.

SHRUB PLANTING
SCALE: NOT TO SCALE

EXCAVATE PLANTING PIT. REMOVE ROOTS, ROCKS, & OTHER DEBRIS & CONTAMINANTS. TAKE EXISTING NATIVE SOIL, (ROCKY FILL, SAND OR SMILAR) AND BLEND 50/50 WITH PLANTING SOIL (70/30 SAND/MUCK) AS USED AS A BLENDED MIX TO ENCOURAGE ROOT GROWTH INTO SURROUNDING AREA.


-FINISH GRADE / SOD OR PAVING

1.5 X BALL DIA.

CONTAINER GROWN SHRUB

-2" LAYER OF MULCH

SHRUB- HEDGE AND MASS PLANTING
SCALE: NOT TO SCALE

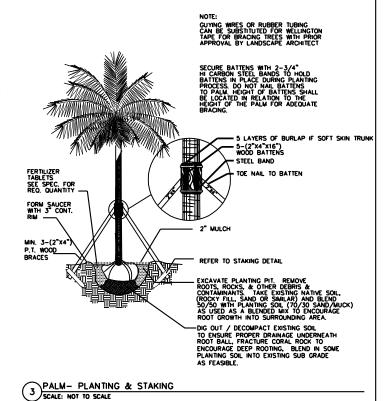



7580 NE 4th Court Studio 100 Miami, FL 33138

1819



Designer/ Landscape Architect

PROJECT: **4354 ALTON ROAD** 

> 4354 ALTON RD. MIAMI BEACH, FLORIDA, 33139

**RESIDENCES** 

DRAWING:

PLANTING DETAILS

MARSH C. KRIPLEN FLORIDA LIC# LA666700

CHECK: DATE:

07/09/2018 SHEET NUMBER

L450

[McG

### **LIGHTING NOTES**

- 1. PRIMARY CONTROLLERS AND GENERAL FIXTURE LOCATIONS SHOWN ONLY. CONTRACTOR TO SUBMIT SHOP DRAWINGS FOR COMPLETE SYSTEM DESIGN FOR APPROVAL BY LANDSCAPE ARCHITECT PRIOR TO INSTALLATION.
- 2. CONTRACTOR TO PROVIDE CODE COMPLIANT SYSTEM DESIGN INCLUDING FOOT CANDLE COVERAGE AND SEA TURTLE REQUIREMENTS FOR ENTIRE SITE.
- 3. COORDINATE LANDSCAPE LIGHTING WITH INTERIOR AND EXTERIOR ARCHITECTURAL LIGHTING. ENSURE COMPATIBILITY WITH ARCHITECTURAL LIGHTING SYSTEM CONTROLLERS.
- 4. PROVIDE NEMA RATED EQUIPMENT AND ENCLOSURES FOR SYSTEM CONTROLLERS EXPOSED TO THE ELEMENTS. SUBMIT PROPOSED MOUNTING SYSTEM, ENCLOSURES AND LOCATIONS AS PART OF THE SUBMISSION PROCESS.

# AMP® ONE ControlPro™ 200 LED Down Light AMP® ControlPro™ 200 LED Down Light

### Product Description


The AMP® ControlPro  $^{\rm IM}$  200 LED Down Light is a low voltage, professional grade landscape light, designed specifically for downlighting. Featuring integrated LED's with interchangeable optics, as well as an extra-long, adjustable glare guard, the AMP® ControlPro™ 200 LED Down Light is available in both a dimmable and non-dimmable version and can be easily adjusted to fit the needs of the most discerning designers.

Designed with a solid brass, offset tripod tree mount with nylon spacers, the down light can be mounted to uneven surfaces and will not cause damage to trees typically caused by mold

25' of UL approved lead wire eliminates visible splices up the tree, and the downward facing wire port is an added safeguard against water ingress.

Built to last a lifetime, the AMP® ONE ControlPro™ 200 LED Down Light is backed by the AMP® lifetime warranty.

### Product Dimensions

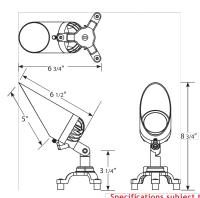



### Features & Benefits

- ▶ Solid Cast Brass Construction
- · Resistant to corrosio
- · Will not break or bend
- · Weathers to a beautiful patina
- Adjustable Extra Long Glare Guard · Prevents direct glare, light trespass and light pollution
- High Performance LED Chips and Engine
- · Warm White (2700K) color temperatur
- USA-made high performance Cree LED's and USA-made AMP<sup>a</sup>
   -engineered boards and drivers
- High-lumen output Interchangeable Optics for Adjustable Beam Spread
- ▶ Tripod Tree Mount with Nylon Spacers and Stainless
- Offset mounting to minimize damage to tree · Tripod can be removed to allow for surface mounting

pecifications subject to change without notice. \_\_\_


©Copyright 2017, AMP® Lighting, Lutz FL 33549 - All rights reserved. Patents pending.









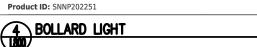





FLORIDA, 33139 **DRAWING:** LIGHTING NOTES & **SPECIFICATIONS** 

7580 NE 4th Court

Studio 100

Miami, FL 33138

1819

Designer/

Landscape Architect

PROJECT:

**4354 ALTON** 

ROAD

**RESIDENCES** 4354 ALTON RD.

MIAMI BEACH,



CHECK



LIGHTING CONTROLLER AND LIGHT SENSOR

**TRANSFORMER** 



7580 NE 4th Court Studio 100 Miami, FL 33138

PROJECT NUMBER



Designer/ Landscape Architect

PROJECT:

4354 ALTON ROAD RESIDENCES

4354 ALTON RD. MIAMI BEACH, FLORIDA, 33139

DRAWING:

LIGHTING PLAN





MARSH C. KRIPLEN FLORIDA LIC# LA666700'
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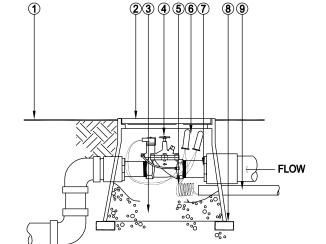
SCALE

CHECK:
DATE: 07/09

L801



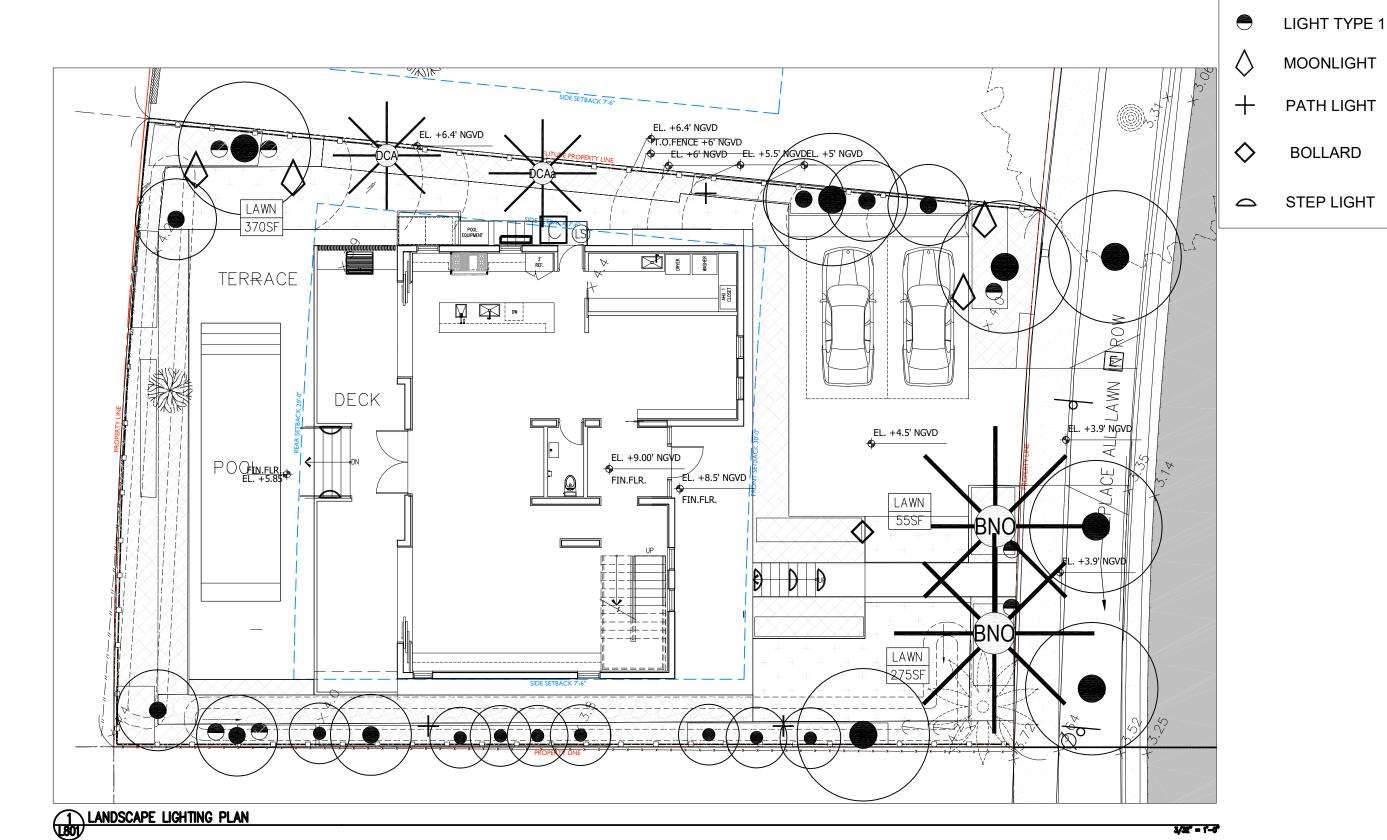

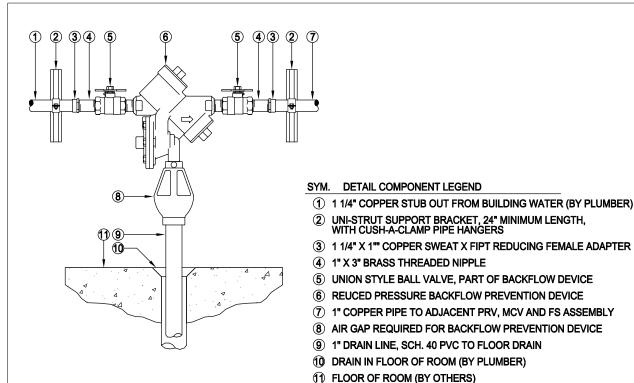

### SYM. DETAIL COMPONENT LEGEND

- 1 GROUND LEVEL
- (2) VALVE BOX COVER LABELED IRRIGATION CONTROL VALVE GREEN
- 3 GRAVEL 30 IN. MINIMUM DEPTH
- 4 REMOTE CONTROL VALVE RAINBIRD PGA
- **5** 12 IN. WIRE COIL EACH WIRE
- **6** WATER PROOF CONNECTION
- 7 SCH 80 NIPPLE
- 8 BRICK (1 0F 4)
- 9 ELECTRIC CONDUIT UL APPROVED

SECTION VIEW



IRRIGATION CONTROLLER , SEE LEGEND FOR ALL MODELS, SIZES AND OPTIONS,

**SECTION VIEW** 

NTS

NTS

- ELECTRICAL JUNCTION BOX FOR 120V POWER SUPPLY DROP, IRRIGATION CONTRACTOR TO MAKE FINAL ELECTRICAL CONNECTION TO CONTROLLER

IN COLD ROLLED STEEL CABINET

-STEEL CONDUIT AND 120V POWER SUPPLY AS PROVIDED ON MEP DRAWINGS AND INSTALLED BY ELECTRICIAN

1" CONDUIT AND SWEEPS FOR THHN WIRES FROM MCV, FS AND CONTROL VALVES TO THE CONTROLLER

FINISH GRADE

SECTION VIEW


CONTROLLER INSTALLATION

IION

2 SLEEVE INSTALLATION

ELECTRIC REMOTE CONTROL VALVE WITH VALVE BOX

NTS

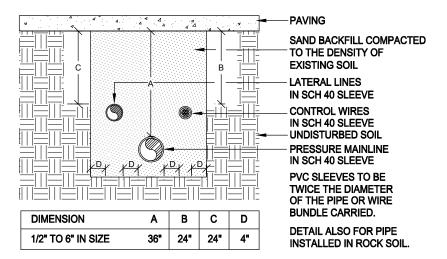

NOTE: SLEEVES TO EXTEND AT LEAST 12" PAST THE EDGE OF THE PAVING.

SECTION VIEW

NTS

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RCHITECTURE + PLANNING

7580 NE 4th Court

Studio 100 Miami, FL 33138

1819



Designer/ Landscape Architect

PROJECT:

4354 ALTON ROAD RESIDENCES

4354 ALTON RD. MIAMI BEACH, FLORIDA, 33139

DRAWING:

IRRIGATION DETAILS


MARSH C. KRIPLEN FLORIDA LIC# LAG


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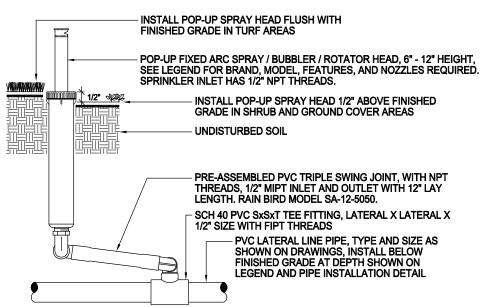
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DATE: 07/09/2018

IR100





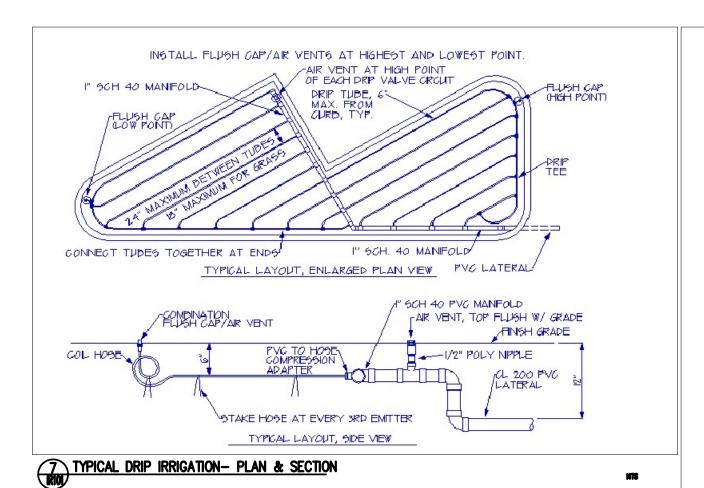

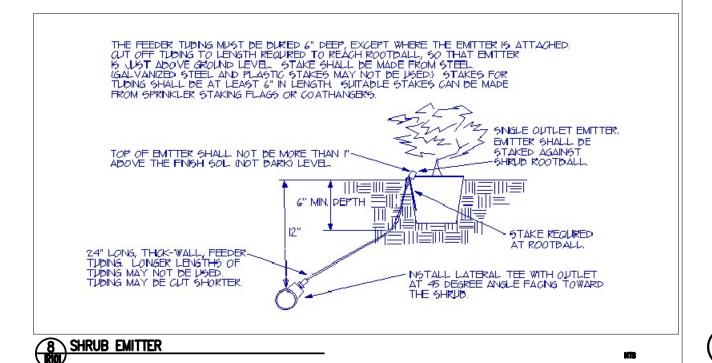
### **SECTION VIEW**

NOTE:
INSTALL SPRAY HEADS 4" FROM PAVING EDGE IN TURF AREAS.
INSTALL SPRAY HEADS 6" FROM PAVING EDGE IN SHRUB AND GROUND COVER AREAS.
INSTALL SPRAY HEADS 12" FROM THE FACE OF BUILDING WALLS OR WINDOWS.
INSTALL SPRAY HEADS PLUMB. ADJUST NOZZLE SPRAY TO COVER THE LANDSCAPE
AREA WITHOUT OVERSPRAY ONTO PAVING, FENCES, WALLS OR BUILDINGS.
SPRINKLER, SWING JOINT, AND PVC FITTINGS SHALL ALL HAVE "NPT" STYLE THREADS.



NTS

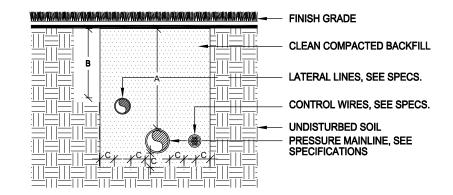

DIMENSION	Α	В	С
1/2" TO 2" IN SIZE	18"	12"	4"

SECTION VIEW

NTS

6 PIPE INSTALLATION

MCG ARCHITECTURE + PLANNING

7580 NE 4th Court Studio 100 Miami, FL 33138

1819



Designer/ Landscape Architect

PROJECT:

# 4354 ALTON ROAD RESIDENCES

4354 ALTON RD. MIAMI BEACH, FLORIDA, 33139

DRAWING:

IRRIGATION NOTES & DETAILS

MARSH C. KRIPLEN FLORIDA LIC# LA

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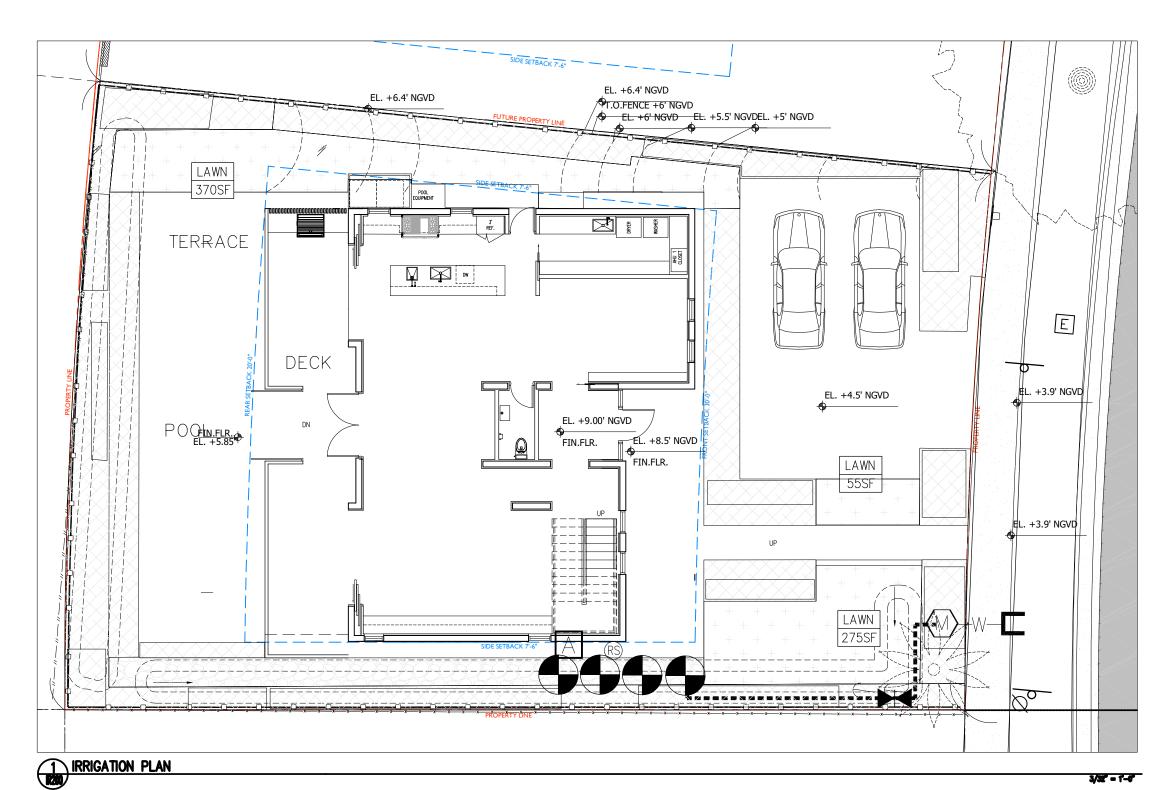
SCALE:

 CHECK:
 MCK


 DATE:
 07/09/2018

**IR101** 

 INFORMATION ON DRAWINGS FOR POINT OF CONNECTION, CONTROLLER, VALVE AND MAIN LINE ONLY. CONTRACTOR TO PROVIDE FINAL DRAWINGS AND SPECIFICATIONS FOR PERMIT.



# IRRIGATION LEGEND

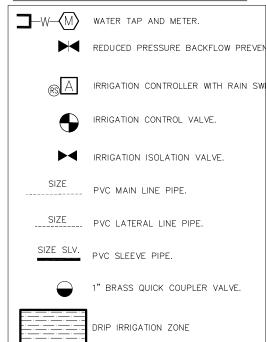



7580 NE 4th Court Studio 100 Miami, FL 33138

PROJECT NUMBER



Designer/ Landscape Architect

PROJECT: 4354 ALTON ROAD RESIDENCES

4354 ALTON RD. MIAMI BEACH, FLORIDA, 33139

DRAWING:

IRRIGATION PLAN



MARSH C. KRIPLEN FLORIDA LIC# LA66670
ALL DRAWINGS AND WRITTEN MATERIAL APPEAR

SCALE:

CHECK:

: 07/09/201 SHEET NUMBER

**IR200**