### SCOPE OF WORK

THE FOLLOWING DRAWINGS ILLUSTRATE THE PROPOSED LANDSCAPE SCOPE OF WORK FOR A NEW RESIDENTIAL PROJECT ON PROPERTY LOCATED IN THE NAUTILUS NEIGHBORHOOD OF THE CITY OF MIAMI BEACH.

- RESIDENTIAL TREE REMOVAL AND ON SITE MITIGATION.
- RESIDENTIAL LANDSCAPE PLANTING
- RESIDENTIAL LANDSCAPE IRRIGATION
- RESIDENTIAL LANDSCAPE SITE LIGHTING



7580 NE 4th Court Studio 100 Miami, FL 33138

1819

SUBMISSION 09/07/18 DRB 9 08/16/18 DRB F

SHEET INDEX

IR200

LANDSCAPE DRAWINGS **DRAWING NOTES** 

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Designer/ Landscape Architect

PROJECT: **4354 ALTON** ROAD **RESIDENCES** 

4354 ALTON RD. MIAMI BEACH, FLORIDA, 33139

DRAWING:

PROJECT COVER

### NORTH RESIDENCE





CHECK: MCK 07/09/2018 DATE: SHEET NUMBER

MARSH C. KRIPLEN FLORIDA LIC# LA666700

**LCVR** 

### TREE DISPOSITION AND MITIGATION SCHEDULE

| TREE No. | TREE - LATIN NAME    | TREE - COMMON NAME | DIAMETER at<br>BREAST HEIGHT<br>(in inches) | MULTI<br>TRUNK | OVERALL<br>HEIGHT<br>(in feet) | CANOPY<br>DIAMETER<br>(in feet) | CANOPY<br>(in Sq. Ft.) | DISPOSITION | CONDITION | REMOVA<br>MUNICIPAL CRITERIA    |                |                   |
|----------|----------------------|--------------------|---|----------------|--------------------------------|---------------------------------|------------------------|-------------|-----------|---------------------------------|----------------|-------------------|
|          |                      |                    |   |                |                                |                                 |                        |             |           | CRITERIA                        | CANOPY SQ. FT. | ROW CANOPY SQ. FT |
| 7        | COCUS NUCIFERA       | COCONUT PALM       | 14  |                | 28                             | 17                              | 227                    | REMAIN      | FAIR      |                                 |                |                   |
| 8        | WASHINGTONIA ROBUSTA | MEXICAN FAN PALM   | 20  |                | 32                             | 16                              | 201                    | REMOVE      | FAIR      | EXEMPT FROM MITIGATION          |                |                   |
| 9        | COCUS NUCIFERA       | COCONUT PALM       | 14  |                | 27                             | 16                              | 201                    | REMAIN      | FAIR      |                                 |                |                   |
| 10       | COCUS NUCIFERA       | COCONUT PALM       | 14  |                | 27                             | 16                              | 201                    | REMAIN      | FAIR      |                                 |                |                   |
| 11       | FICUS RELIGIOSA      | BODHI TREE         | 46  |                | 35                             | 40                              | 1257                   | REMAIN      | FAIR      |                                 |                |                   |
| 12       | ADONIDIA MERRILLII   | CHRISTMAS PALM     | 8   |                | 12                             | 10                              | 79                     | REMOVE      | FAIR      | CONFLICTS WITH NEW CONSTRUCTION | 79             |                   |
| 13       | ADONIDIA MERRILLII   | CHRISTMAS PALM     | 8   | Х              | 14                             | 12                              | 113                    | REMOVE      | FAIR      | CONFLICTS WITH NEW CONSTRUCTION | 113            |                   |
| 14       | LAGERSTROEMIA INDICA | CRAPE MYRTLE       | 10  |                | 18                             | 18                              | 254                    | REMOVE      | FAIR      | CONFLICTS WITH NEW CONSTRUCTION | 254            |                   |
| STREET T | REES                 |                    | T   |                |                                |                                 |                        | T           |           |                                 | T              | T                 |
| 1        | PHOENIX DACTYLIFERA  | DATE PALM          | 24  |                | 14                             | 14                              | 154                    | REMAIN      | FAIR      |                                 |                |                   |
| 2        | PHOENIX DACTYLIFERA  | 20                 | 24  |                | 14                             | 14                              | 154                    | TRANSPLANT  | FAIR      | CONFLICTS WITH PROPOSED DRIVE   |                |                   |
| 3        | PHOENIX DACTYLIFERA  | DATE PALM          | 24  |                | 14                             | 14                              | 154                    | REMAIN      | FAIR      |                                 |                |                   |
| 4        | SWIETENIA MAHAGONI   | MAHOGANY           | 24  |                | 35                             | 38                              | 1134                   | REMAIN      | FAIR      |                                 |                |                   |
|          |                      |                    |   |                |                                |                                 |                        |             |           |                                 |                |                   |
|          |                      |                    |   |                |                                |                                 |                        |             |           |                                 |                |                   |
|          | I .                  |                    |   |                | l                              |                                 |                        |             |           |                                 |                |                   |


| UNITS REMOVED FROM ROW                                      |     | -   |                |                                      |        |
|---|-----|-----|----------------|--------------------------------------|--------|
| UNITS REMOVED   | 446 |     |                |                                      |        |
| TOTAL UNITS REMOVED:  |     | 446 |                |                                      |        |
| PROPOSED ON SITE MITIGATION BREAKDOWN                       |     |     |                |                                      | TREE   |
| PROPOSED ON SITE WITHOUT BREAKDOWN                          |     |     | credit/tree    |                                      | CREDIT |
| CATEGORY 1 TREE 2" CAL/12' HT MIN:                          |     | 3   | 300            | Category 1 Tree = 300sf credit/tree  | 900    |
| CATEGORY 2 TREE 2" CAL/10' HT MIN:                          |     | 1   | 150            | Category 2 Tree = 150sf credit/tree  | 150    |
| CATEGORY 3 TREE 2" CAL/8' HT MIN:                           |     | -   | 100            | Category 3 Tree = 100sf credit/tree  | -      |
| CATEGORY 4 PALM 6' CLR TRUNK MIN:                           | _   | -   | 50             | Category 4 Palm = 50sf credit/tree   |        |
| TOTAL PROPOSED REPLACEMENT TREES (REFER TO PLANTING PLANS): |     | 4   | COMBINATION FU | LFILLS SITE MITIGATION OF CANOPY SF: | 1,050  |


## TRANSPLANTING SPECIFICATIONS

- 1. Root prune all trees and palms to a minimum depth of 24" for the palms and 48" for the trees.
- 2. Trim frayed roots with clippers saws or similar and leave clean cuts.
- 3. Wrap balls with shrink wrap plastic, back filling with Shredded peat moss, fill up voids between plastic & ball, covering all cut roots.
- 4. Backfill with existing soil to hold plastic firmly against newly wrapped ball. Keep 2" deep trench exposed so as to find root ball when harvesting.
- 5. Water three times per week for next 2 months or until trees are ready to move.
- 6. Harvest palms after 5 weeks minimum and trees after 8 to 10 weeks depending on size. Consult with LA prior to moving on schedule.
- 7.Re-dig holes well outside the pastic plant wrap being careful not to disturb or tear, preserving root ball, re-wrap if needed for transplanting.
- 8. When digging trees, break off large piece of existing coral rock, +/- 36" deep as feasible, by under cutting ball.

  Do Not Peel Ball off Rock.. If necessary, the horizontal chipping or drilling may be required to break off specimen Oak ball at a minimum 30" depth
- 9.Replant transplanted trees and palms at correct height in new location, keeping original ball top exposed.
- 10. Properly wrap and hook—up trees and palms to lifting equipment in such a way as to not tear cambium layer and exessivly disfigure appearance.
- 11. Plants that are not properly lifted and die due to girdling, compression or excessive damage to the cambium layer will be charged to the G.C. and Sub-contractor at a rate of \$500 per caliper inch.
- 12. Remove plastic, backfill with 50% existing soil blended with 50% planting soil plus 1/4 bale of Canadian peat moss for palms and 1/2 bale for trees.
- 13. Backfill, sink, place in Agriform fertilizer tablets per recommendations, brace, and trim broken branches and fronds as needed. Brace per specification.
- 14. Water daily for duration of overall job will be required. Having bubblers as part of automatic irrigation system for post construction can supplement additional drenching, but are not a sustitution.



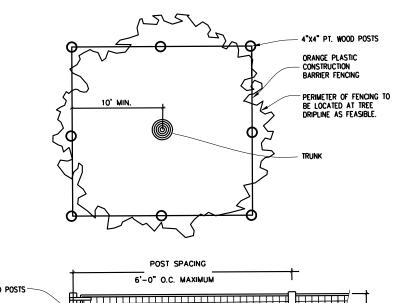

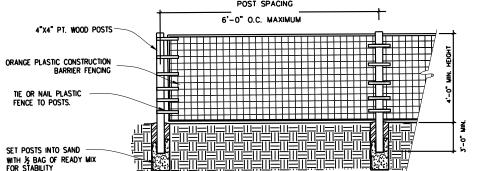

1 TREE PROTECTION FENCE DETAIL
TD100 SCALE: NTS



7580 NE 4th Court Studio 100 Miami, FL 33138

PROJECT NUMBER



Designer/ Landscape Architect

PROJECT: 4354 ALTON

ROAD RESIDENCES

4354 ALTON RD. MIAMI BEACH, FLORIDA, 33139

DRAWING:

TREE DISPOSITION NOTES, SCHEDULE AND TREE PROTECTION DETAIL

MARSH C. KRIPLEN FLORIDA LIC# LA666700

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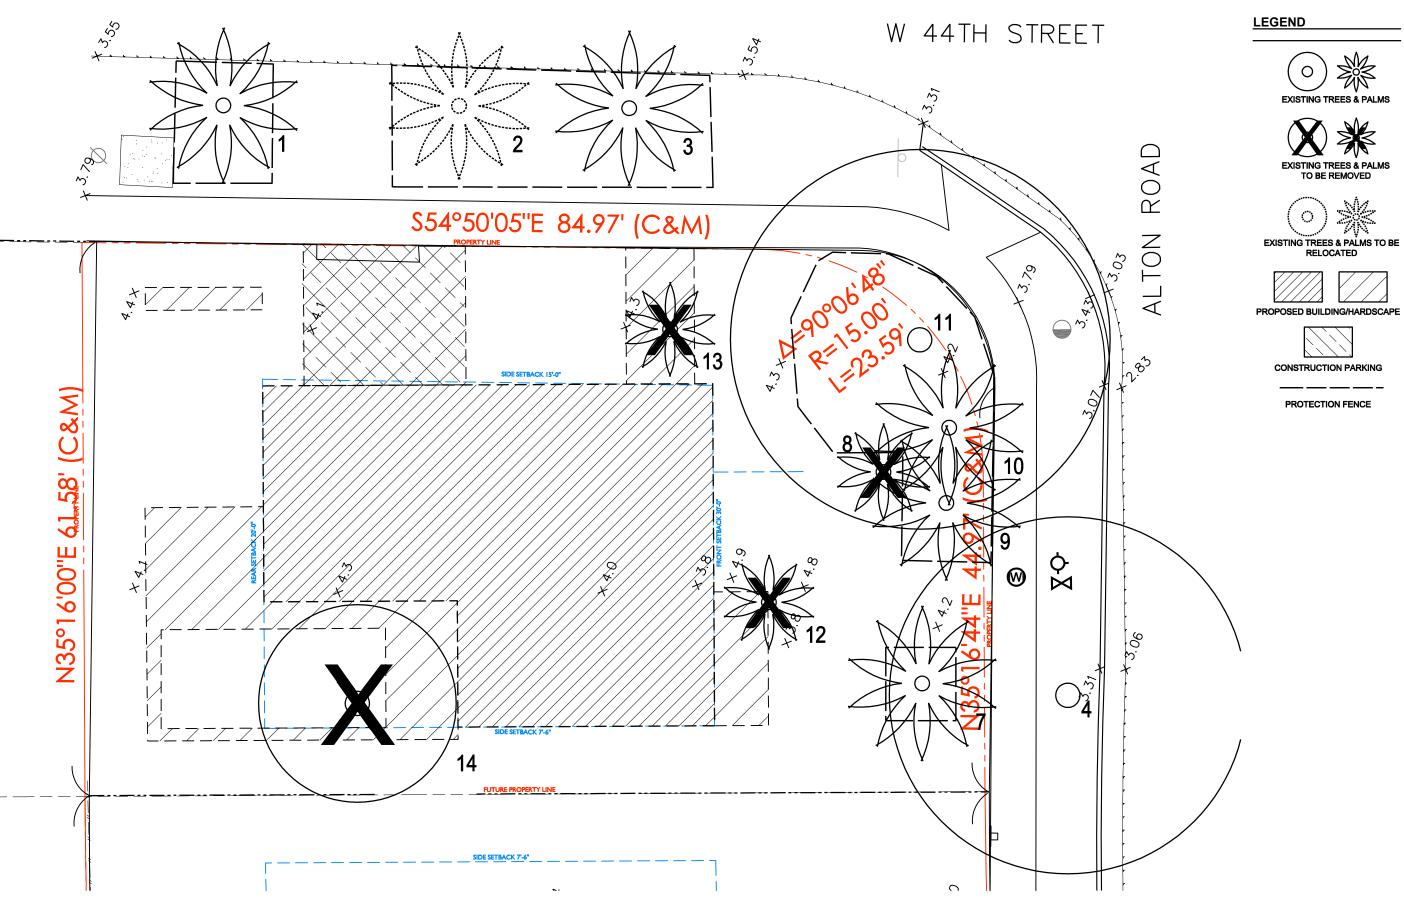
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DATE: 07/09/2018

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**TD100** 



**LEGEND** 

EXISTING TREES & PALMS
TO BE REMOVED

CONSTRUCTION PARKING

PROTECTION FENCE



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PROJECT: **4354 ALTON** ROAD **RESIDENCES** 

4354 ALTON RD. MIAMI BEACH, FLORIDA, 33139

DRAWING:

TREE DISPOSITION PLAN



07/09/2018

## MATERIALS NOTES

- CONTRACTOR TO VERIFY ALL QUANTITIES. IN CASE OF ANY DISCREPANCIES, GRAPHICALLY SHOWN MATERIAL QUANTITIES SHALL TAKE PRECEDENCE.
- ALL CONSTRUCTION AND MATERIALS NOT SPECIFICALLY ADDRESSED IN THE CONTRACT DOCUMENTS OR SPECIFICATIONS SHALL BE IN ACCORDANCE WITH LOCAL, STATE AND FEDERAL JURISDICTIONS AND GOVERNING BODIES/AGENCIES STANDARDS.
- THE CONTRACTOR SHALL PROVIDE A FULL-SCALE MOCKUP AND RECEIVE APPROVAL FROM THE LANDSCAPE ARCHITECT FOR ALL SYSTEMS BEFORE BEGINNING CONSTRUCTION OF PAVEMENT.
- 4. EXPANSION JOINTS SHALL BE PROVIDED WHERE FLATWORK MEETS VERTICAL STRUCTURES, SUCH AS WALLS, CURBS, STEPS, AND OTHER HARDSCAPE ELEMENTS. EXPANSION JOINTS SHALL ALSO BE PROVIDED AT MATERIAL CHANGES. EXPANSION JOINT MATERIALS/METHODS SHALL BE SUBMITTED TO THE LANDSCAPE ARCHITECT FOR REVIEW AND APPROVAL PRIOR TO INSTALLATION.
- CONTROL JOINTS SHOULD BE SPACED NO GREATER THAN TEN (10) LINEAR FEET MAXIMUM, UNLESS OTHERWISE SPECIFIED. EXPANSION JOINTS SHOULD BE SPACED NO GREATER THAN FORTY (40) LINEAR FEET MAXIMUM, UNLESS OTHERWISE SPECIFIED. CONTRACTOR SHALL ADVISE ON OTHER JOINTS AS NEEDED TO MINIMIZE CRACKING. THIS INFORMATION SHALL BE SUBMITTED TO THE LANDSCAPE ARCHITECT FOR REVIEW AND APPROVAL PRIOR TO INSTALLATION.
- CONTROL JOINTS SHALL BE PROVIDED AS SPECIFIED IN THE CONTRACT DOCUMENTS. CONTROL JOINT MATERIALS, METHODS AND RECOMMENDATIONS ON ADDITIONAL CONTROL JOINTS TO MINIMIZE CRACKING SHALL BE SUBMITTED TO THE LANDSCAPE ARCHITECT FOR REVIEW AND APPROVAL
- 7. ALL STEPS SHALL HAVE TWELVE (12) INCH TREADS AND SIX (6) INCH RISERS, UNLESS OTHERWISE SPECIFIED.
- HOLD TOP OF WALLS AND FENCES LEVEL, UNLESS OTHERWISE SPECIFIED.
- CONTRACTOR SHALL NOT INSTALL WORK LOCATED ON TOP OF ARCHITECTURAL STRUCTURES WITHOUT FIRST REVIEWING ARCHITECTURAL DRAWINGS.
- 10. SAMPLES OF SPECIFIED MATERIALS SHALL BE SUBMITTED TO THE LANDSCAPE ARCHITECT FOR REVIEW AND APPROVAL PRIOR TO ORDERING FOR JOB.





## PAVING I: UNIT PAVERS

MATERIAL: HANOVER- PREST PLANKSTONE PAVERS

COLOR: GRAY/SLATE FINISH: STD

LOCATION: MOTORCOURT

IPE

OILED

7580 NE 4th Court Studio 100 Miami, FL 33138

1819



Designer/ Landscape Architect

PROJECT:

**4354 ALTON** ROAD **RESIDENCES** 

4354 ALTON RD. MIAMI BEACH, FLORIDA, 33139

**DRAWING:** 

**MATERIALS NOTES** AND **SPECIFICATIONS** 



FACTORY SANDED

PORCH, TERRACE AND DECK


MATERIAL: OLIMAR STONE

COLOR: STANDARD- GRAY


FINISH:

LOCATION: SERVICE WALKWAY



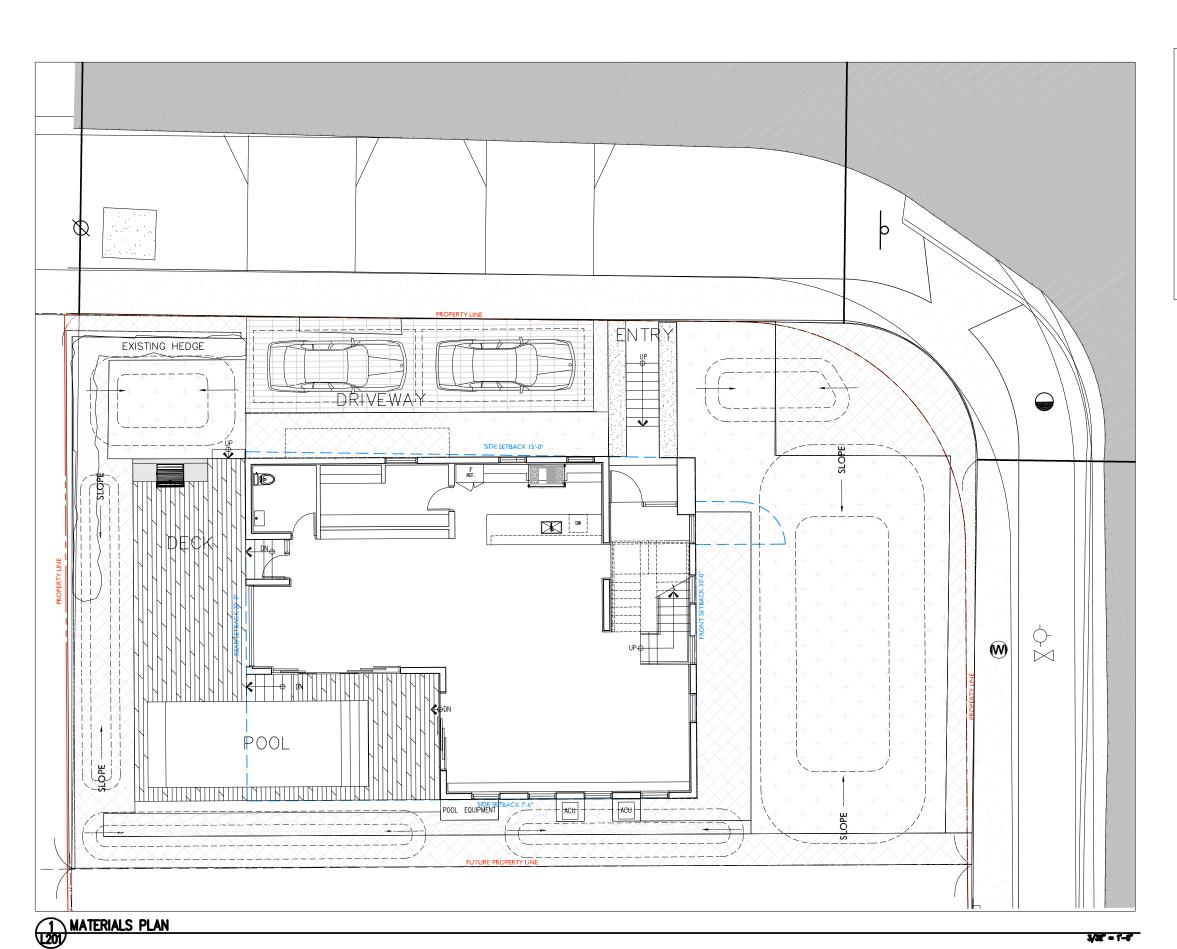

# MATERIALS LEGEND

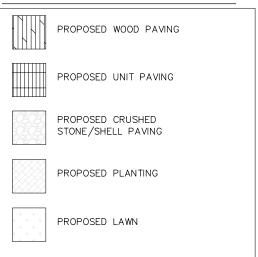



7580 NE 4th Court Studio 100 Miami, FL 33138

PROJECT NUMBER



Designer/ Landscape Architect

PROJECT:

# 4354 ALTON ROAD RESIDENCES

4354 ALTON RD. MIAMI BEACH, FLORIDA, 33139

DRAWING:

MATERIALS PLAN



MARSH C. KRIPLEN FLORIDA LIC# LA666700

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CHECK:

DATE: 07/09/2

### PLANTING NOTES

- 1. PLANT MATERIAL IS TO BE HEALTHY SPECIMENS FREE FROM DISEASE OR DAMAGE, AND IS TO BE MAINTAINED IN EXCELLENT CONDITION WHILE ON THE JOBSITE. LANDSCAPE ARCHITECT SHALL INSPECT PLANT MATERIAL UPON ARRIVAL TO JOBSITE AND WILL REJECT PLANT MATERIAL THAT DOES NOT MEET THE STANDARDS DESCRIBED WITHIN THE CONTRACT DOCUMENTS.
- THE LANDSCAPE ARCHITECT WILL PERIODICALLY INSPECT PLANT MATERIAL STOCKPILED AND/OR PLANTED ON SITE DURING THE COURSE OF CONSTRUCTION. PLANT MATERIAL NOT MEETING THE STANDARDS CONTAINED WITHIN CONTRACT DOCUMENTS SHALL BE REPLACED AT NO COST TO THE OWNER.
- PRESERVE & PROTECT ALL EXISTING VEGETATION INDICATED TO REMAIN AT ALL TIMES.
- 4. PROVIDE MATCHING SIZES AND FORMS FOR EACH PLANT OF THE SAME SPECIES UNLESS OTHERWISE INDICATED.
- CONTRACTOR TO VERIFY ALL QUANTITIES. IN CASE OF DISCREPANCIES, GRAPHICALLY SHOWN QUANTITIES SHALL TAKE PRECEDENCE.
- 6. ALL MATERIALS USED SHALL CONFORM TO THE GUIDELINES ESTABLISHED BY THE CURRENT AMERICAN STANDARDS FOR NURSERY STOCK, PUBLISHED BY THE AMERICAN ASSOCIATION OF NURSERYMEN.
- 7. ALL PLANT MATERIAL SHALL BE INSTALLED PLUMB AND PER THE SPECIFICATIONS CONTAINED WITHIN THE CONTRACT DOCUMENTS. ANY NECESSARY STAKING AND/OR OTHER SUPPORTS MATERIALS/METHODS SHALL BE SUBMITTED TO THE LANDSCAPE ARCHITECT FOR REVIEW AND APPROVAL PRIOR TO INSTALLATION.
- 8. THE CONTRACTOR SHALL PRUNE EXISTING AND/OR NEW TREES ONLY PER LANDSCAPE ARCHITECT DIRECTION.
- 9. THE CONTRACTOR SHALL STAKE THE LOCATIONS OF ALL TREES AND B&B SHRUBS FOR LANDSCAPE ARCHITECT REVIEW AND APPROVAL, PRIOR TO INSTALL ATION
- 10. ALL ROOT-WRAPPING MATERIALS THAT ARE NOT BIO-DEGRADABLE SHALL BE REMOVED FROM THE ROOT BALL. ROOT BALLS SHALL BE FREE OF WEEDS.
- 11. SPECIFIED PLANT MATERIAL SIZES SHALL BE CONSIDERED MINIMUM SIZES.
- FINISH GRADE OF PLANTING BEDS SHALL BE TWO (2) INCHES BELOW ADJACENT FLATWORK, UNLESS SPECIFIED OTHERWISE.
- 13. MULCH OR PLANTING BED DRESSING SHALL BE PLACED IN ALL PLANTING AREAS AS SPECIFIED. MULCH OR PLANTING BED DRESSING SHALL NOT BE PLACED WITHIN SIX (6) INCHES OF TREE TRUNKS. MULCHING SHOULD BE REPEATED ANNUALLY DURING THE AUTUMN TO A THREE (3) INCH DEPTH.
- 14. ALL PLANT MATERIAL SHOULD RECEIVE AN ORGANIC FERTILIZER IN LIMITED APPLICATION FOLLOWING INSTALLATION. TYPE AND APPLICATION RATE AND METHOD OF APPLICATION TO BE SPECIFIED BY THE CONTRACTOR AND APPROVED BY THE LANDSCAPE ARCHITECT.
- 15. EXCESS FERTILIZER SHALL BE DISPOSED OF PROPERLY OFF-SITE. IT SHALL NOT BE DISPOSED OF IN STORM DRAINS AND/OR DRYWELLS.
- 16. STOCKPILED PLANT MATERIAL TO BE PLACED IN THE SHADE AND PROPERLY HAND-WATERED UNTIL PLANTED.
- 17. MULCH ALL BEDS WITH 2-3" AT TIME OF PLANTING. REFER TO PLANTING DETAILS FOR MULCH SPECIFICATIONS. REPLENTISH MULCH AS REQUIRED OVER THE COURSE OF THE GUARANTEE PERIOD TO ENSURE ADEQUATE COVERAGE.
- 18. SIX (6) INCH PLANT MIX SHALL BE PROVIDED FOR ALL LAWN, TURF, AND NATIVE PLANTING ZONES. 18 INCH PLANT MIX SHALL BE PROVIDED FOR ALL PERENNIAL PLANTING BEDS UNLESS OTHERWISE NOTED.
- 19. LANDSCAPE CONTRACTOR TO PAINT ALL TREE & PALM SUPPORTS WITH BENJAMIN MOORE ARBORCOAT ASHLAND SLATE EXTERIOR WOOD PAINT. ALL BRACING CUTS TO BE NEAT AND CLEAN, NO CHAINSAW CUTS.
- 20. GUARANTEE PERIOD: CONTRACTOR IS RESPONSIBLE FOR SITE MAINTENANCE AND MATERIAL REPLACEMENT FOR ONE YEAR FROM THE DATE OF SUBSTANTIAL COMPLETION. REMOVE AND REPLACE ALL DEAD PLANT MATERIAL OR MATERIAL WHICH IS FAILING AS DETERMINED BY ARBORIST AND LANDSCAPE ARCHITECT. CORRECT DEFICIENCIES WITH MULCH AND IRRIGATION.
- 21. MAINTENANCE PLAN: DURING THE GUARANTEE PERIOD CONTRACTOR SHALL PERFORM THE FOLLOWING TASKS ON A REGULARLY SCHEDULED BASIS. WEEKLY WATERING (JAN-APR) WHEN IRRIGATION SYSTEMS ARE NOT OPERATIONAL. WEEKLY SITE INSPECTION FOR PLANT HEALTH, TREE/PALM GUYING, IRRIGATION OPERATION.

QUARTERLY FERTILIZATION (MAR-SEPT) APPROPRIATE FOR MATERIAL (REF IFAS PUBLICATION ENH858)

WEEKLY MOWING OF LAWNS AND PLANT BED WEEDING DURING THE GROWING AND SHOULDER SEASONS. MONTHLY VISITS FOR SAME OVER WINTER.

### PLANTING SCHEDULE

| TYPE | ABR. | QUANTITY | BOTANICAL NAME          | COMMON NAME   | SPECIFICATIONS |
|------|------|----------|-------------------------|---------------|----------------|
| PALM | IS   |          |                         |               |                |
|      | DCA  | 2        | DYPSIS CABADAE          | CABADA PALM   | 45 GAL         |
|      | PSA  | 1        | PSEUDOPHOENIX SARGENTII | BUCANEER PALM | FG 7' CT MIN   |

| TREES |      |   |                        |                                |                        |
|-------|------|---|------------------------|--------------------------------|------------------------|
| **    | CGR  | 1 | CAESALPINIA GRANADILLO | BRIDAL VEIL- 4' CLR TRUNK      | 3" CAL. & 14' HT. MIN. |
| */*** | CRO  | 1 | CLUSIA ROSEA           | AUTOGRAPH TREE                 | 2" CAL. & 12' HT. MIN. |
| */*** | MFRa | 1 | MYRCIANTHES FRAGRANS   | SIMPSON STOPPER- LOW BRANCHING | 2" CAL. & 12' HT. MIN. |
| */*** | PPT  | 2 | PELTOPHORUM PTERCARPUM | COPPER POD                     | 2" CAL. & 12' HT. MIN. |
| */*** | TCA  | 2 | TABEBUIA CARAIBA       | YELLOW TABEBUIA                | 4" CAL. & 16' HT. MIN. |

| UNDERS | STORY | TREES / | LARGE SHRUBS         |                                |        |     |            |
|--------|-------|---------|----------------------|--------------------------------|--------|-----|------------|
|        | GLU   | 5       | GYMNANTHES LUCIDA    | CRABWOOD- MULTI TRUNK          | 6' HT. | & 4 | SPREAD MIN |
|        | MFR   | 2       | MYRCIANTHES FRAGRANS | SIMPSON STOPPER- LOW BRANCHING | 6' HT. | & 4 | SPREAD MIN |

| ACCENTS / | / SHRUBS     |                                |                    |                             |
|-----------|--------------|--------------------------------|--------------------|-----------------------------|
| AAN       | <b>v</b> I 1 | AGAVE AMERICANA                | CENTURY PLANT      | 7 GAL                       |
| AA        | . 3          | AGAVE ATTENUATA                | SPINELESS AGAVE    | 7 GAL                       |
| AM        | 1 2          | ALOCASIA MACRORRI              | GIANT ELEPHANT EAR | 7 GAL                       |
| AP        | 2            | ALPINIA PURPURATA              | DWARF RED GINGER   | 7 GAL                       |
| CC,       | Y 4          | CAPPARIS CYNOPHALLOPHORA       | JAMAICA CAPER      | 30 GAL- BUSH FORM           |
| CO        | 7            | COLOCASIA 'BLACK MAGIC'        | BLACK TARO         | 7 GAL                       |
| Cs        | 3            | COLOCASIA SPECIES              | TARO               | 7 GAL                       |
| EFE       | 1            | ENCEPHALARTOS FEROX            | ZULULAND CYCAD     | 15 GAL                      |
| HR        | ! 1          | HELICONIA ROSTRATA             | LOBSTER CLAW       | 15 GAL                      |
| PO        | 5            | PHILODENDRON 'ROJO CONGO'      | PHILODENDRON       | 3 GAL                       |
| PM        | 1 10         | PODOCARPUS MACROPHYLLUS        | JAPANESE YEW       | 25 GAL. 6' HT MIN., MATCHED |
| ZI        | 9            | ZAMIA INTEGRIFOLIA (FLORIDANA) | COONTIE            | 7 GALLON                    |

| GROUNG | COVER | ?   |                           |                         |          |
|--------|-------|-----|---------------------------|-------------------------|----------|
|        | EL    | 45  | ERNODEA LITTORALIS        | GOLDEN BEACH CREEPER    | 1 GALLON |
|        | MS    | 68  | MICROSORUM SCOLOPENDRIA   | WART FERN               | 1 GALLON |
|        | PB    | 130 | PHILODENDRON BURLE MARX   | PHILODENDRON BURLE MARX | 1 GALLON |
|        | TA    | 145 | TRACHELOSPERMUM ASIATICUM | CREEPING JASMINE        | 1 GALLON |

| [ | ORNAME | ENTAL | GRASSES |                       |                   |          |
|---|--------|-------|---------|-----------------------|-------------------|----------|
|   |        | SBA   | 10      | SPARTINA BAKERI       | SAND CORDGRASS    | 7 GALLON |
| Ī |        | TDA   | 5       | TRIPSACUM DACTYLOIDES | FAKAHATCHEE GRASS | 7 GALLON |
| Ī |        | UPA   | 9       | UNIOLA PANICULATA     | SEA OATS          | 5 GAL    |

| LAWN |               |                |            |                     |     |
|------|---------------|----------------|------------|---------------------|-----|
|      | LAWN 1,400 SF | STENOTAPHRUM S | SECUNDATUM | ST. AUGUSTINE GRASS | SOD |

### TREE AND PALM ALLOCATION LEGEND

- \* MITIGATION
- \*\* STREET TREE

  \*\*\* SITE LANDSCAPE

### **DEFINITIONS**

- TREE: ANY SELF SUPPORTING WOODY PLANT OR PALM WHICH USUALLY HAS A MAIN AXIS OR TRUNK. 12' HT, 6' CANOPY DIA. AND 2" CAL. TRUNK MINIMUM AT TIME OF PLANTING.
- STREET TREE: A SPECIES TYPICALLY GROWN IN MIAMI BEACH WHICH NORMALLY MATURES TO A HEIGHT OF AT LEAST 20'. 12' HT., 3" CAL. TRUNK AND 4' CLR TRUNK MINIMUM AT TIME OF PLANTING. MAXIMUM AVERAGE TREE SPACING 20' O.C. (CITY DISCRETION ALLOWED DEPENDING ON SITE CONDITIONS).
- PALMS (STREET TREES): SINGLE TRUNK SPECIES. 15'
  CLEAR WOOD AND 10" DBH TRUNK MINIMUM AT TIME OF
  PLANTING. PALMS SHALL NOT COUNT TOWARD THE
  REQUIRED STREET TREES.

 LARGE SHRUB — SMALL TREE: NORMALLY MATURES AT MINIMUM HEIGHT OF 10'. 6' HT. AND 4' CANOPY DIA. MINIMUM AT TIME OF PLANTING.



7580 NE 4th Court Studio 100 Miami, FL 33138

PROJECT NUMBER



Designer/ Landscape Architect

PROJECT:

# 4354 ALTON ROAD RESIDENCES

4354 ALTON RD. MIAMI BEACH, FLORIDA, 33139

DRAWING:

PLANTING NOTES & SCHEDULE

MARSH C. KRIPLEN FLORIDA LIC# LA66670

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PLANNING, NC. (c) 2013

SCALE:

CHECK: MCK

DATE: 07/09/2018

SHEET NUMBER

| M         | <del>(</del> G |
|-----------|----------------|
| ARCHITECT | URE + PLANNING |

7580 NE 4th Court Studio 100 Miami, FL 33138

PROJECT NUMBER



Designer/ Landscape Architect

# PROJECT: **4354 ALTON** ROAD **RESIDENCES**

4354 ALTON RD. MIAMI BEACH, FLORIDA, 33139

DRAWING:

LANDSCAPE LEGEND

MUNICIPALITY: City of Miami Beach

ORDINANCE/CODE SECTION: CITY OF MIAMI BEACH SECTION 126

Multiplier: 50%

ZONING CLASS: RS-4


LOT AREA:

6,030

ACRES:

0.1384

| STREET TREES   |    |    | OPEN S  | PACE  | REQUIRED/<br>ALLOWED | PROVIDED |
|--|----|----|---------|---|----------------------|----------|
|  |    |    | A.      | Sq. Ft. of required Open Space                          | 4,221                | 4,430    |
| A. Street trees (maximum average spacing of 30' o.c.)        | 8  | 3  |         | Lot area: 6,030_  |                      |          |
| Linear ft of street frontage:160                             |    |    |         | Multiplier: 70%   |                      |          |
| Multiplier: 20   |    |    | B.      | Sq. Ft. of parking lot open space                       | 20                   | 0        |
| Percentage of Palms counted toward Street Trees on 1:1 basis | 0  | 0  |         | Parking Spaces:2  |                      |          |
| Multiplier: <u>30%</u>                                       |    |    |         | Multiplier:10sf/space                                   |                      |          |
| B. Street trees directly below power lines                   | 0  | 0  | C.      | Total Sq. Ft. of landscaped Open Space required         | 4,241                | 4,430    |
| Linear ft of street frontage: 0                              |    |    |         |   |                      |          |
| Multiplier: 30   |    |    | LAWN A  | AREA  |                      |          |
|  |    |    | Α.      | Total Sq. Ft. of landscaped Open Space                  | 4,241                | 4,430    |
| HRUBS  |    |    | B.      | Maximum Lawn Area (sod) permitted-                      | 2,121                | 1,400    |
| Number of shrubs required                                    | 72 | 72 |         | Open space required:4,241                               |                      |          |
| Lot and street trees required: 6                             |    |    |         | Multiplier:50%  |                      |          |
| Multiplier: 12   |    |    |         |   |                      |          |
| . % Native species required                                  | 36 | 36 | TREES   |   |                      |          |
| Shrubs provided:72   |    |    | A.      | Number of trees required per lot, less existing trees   | 5                    | 5        |
| Multiplier:50%   |    |    | Α.      | Required Trees/Lot: 6                                   |                      |          |
|  |    |    |         | Net lot acres: 0.1384                                   |                      |          |
| ARGE SHRUBS OR SMALL TREES                                   |    |    |         | Required Trees: 6                                       |                      |          |
| Number of large shrubs or small tree required                | 7  | 7  |         | Existing trees:   |                      |          |
| Shrubs required: 72  |    |    | —<br>В. | % Palms allowed   | na                   | na       |
| Multiplier: 10%  |    |    |         | Palms allowed 1:1 for mitigation only.                  |                      |          |
| % Native species required                                    | 4  | 4  | C.      | % Native required                                       | 1                    | 1        |
| Shrubs provided: 7   |    |    |         | Trees provided: 3                                       |                      |          |
| Multiplier: 50%  |    |    |         | Multiplier: 30%   |                      |          |
| ·  |    |    | D.      | % Drought tolerant and low maintenance species required | 2                    | 1        |
|  |    | -  |         | Trees provided: 3                                       |                      |          |

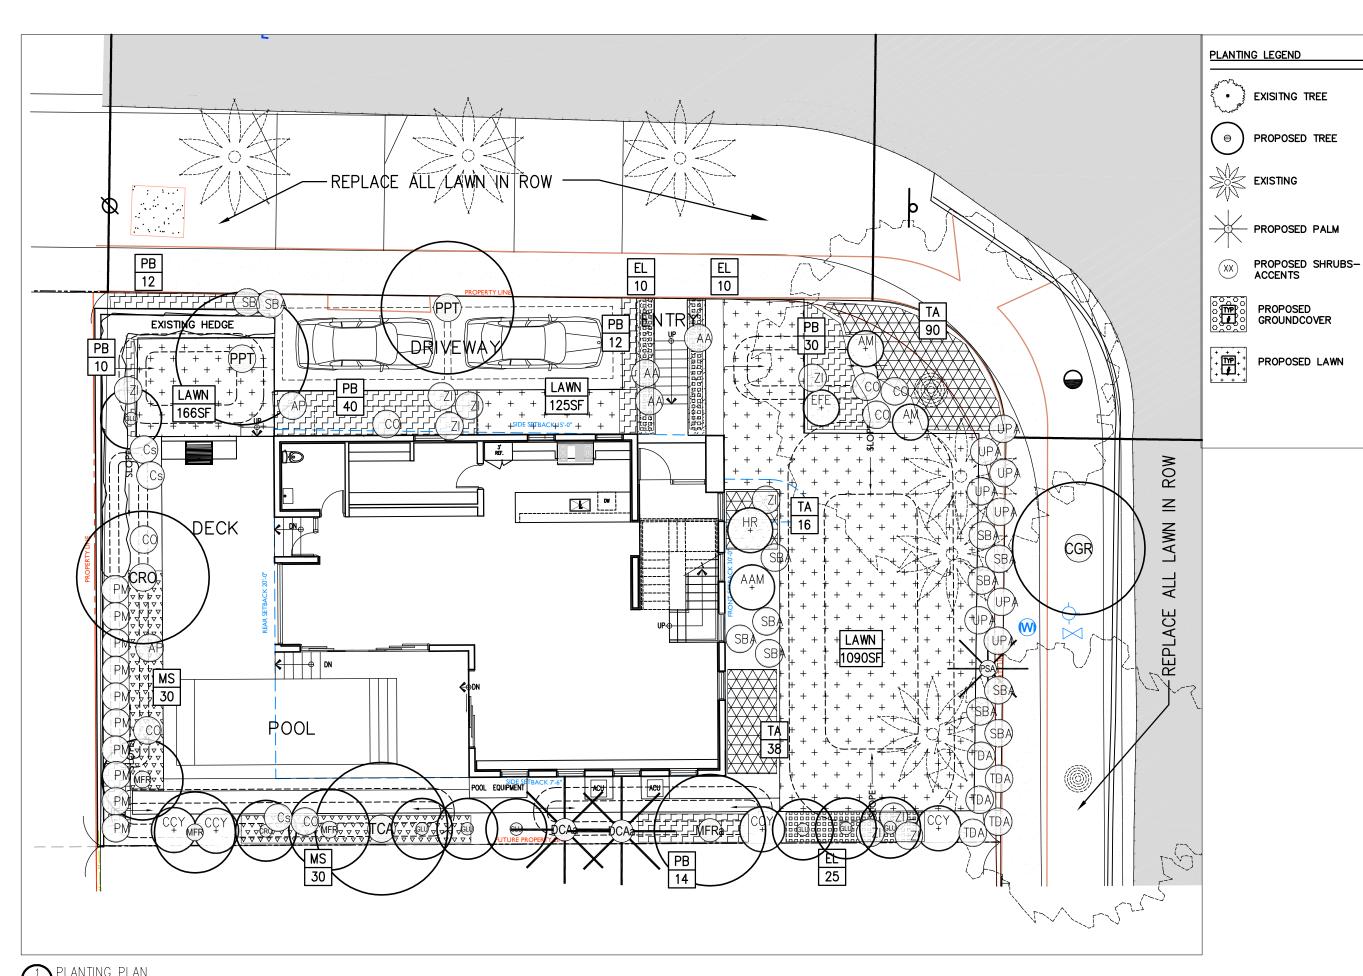



7580 NE 4th Court Studio 100 Miami, FL 33138

PROJECT NUMBER



Designer/ Landscape Architect

PROJECT: 4354 ALTON ROAD RESIDENCES

4354 ALTON RD. MIAMI BEACH, FLORIDA, 33139

DRAWING:

PLANTING PLAN




MARSH C. KRIPLEN FLORIDA LIC# LA666700

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SCALE

CHECK: MCK
DATE: 07/09/2018
SHEET NUMBER

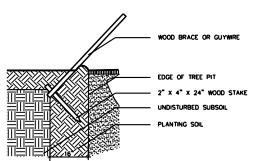

TOP OF STAKE MUST BE MINIMUM OF 3" BELOW FINISHED GRADE

STAKING NOTES:
1. SAW CUT ALL WOOD STAKING MATERIALS LEAVE ENDS NEAT AND TRIM.
2. PAINT ALL WOOD STAKING MATERIALS HUNTER GREEN.

9 STAKING DETAIL & NOTES SCALE: NOT TO SCALE

PREPARATION:
STORE ALL MATERIAL IN DRY, CLEAN AREA, COVER TO PROTECT FROM RAIN AND MINIMIZE DUST. COORDINATE RUN-OFF
CONTROL WITH CENERAL CONTRACTOR.
IEST EXISTING SOIL TO ENSURE IT IS FREE OF EXCESSIVE CLAY OR SALT AND ANY CHEMICALS/PETROCHEMICALS WHICH
MAY HAMBY PLANT FEALTH.

EXISTING MATERIAL:

# INCORPORATING EXISTING SITE SOIL REMOVE ALL ROOTS, AND ROCK LARGER THAN 2" IN SIZE. REMOVE ALL PLASTIC, METAL AND MANAGE DETRITUS.

MIX: 50% EXISTING SOIL 10% COCO PEAT 10% COMPOST 20% CLEAN SAND 10% PERLITE

BLEND QUANTITIES NEEDED BY HAND OR MACHINE

INSTALLATION:
REFER TO APPROPRIATE DETAILS FOR AMENDMENTS, COMPACTION DEPTHS ETC.

GENERAL: REFER TO LANDSCAPE NOTES FOR ADDITIONAL INFORMATION

10 PLANTING SOIL- TYPICAL

MULCH A: PINE STRAW, FOR USE IN CENERAL PLANTING AREAS AND ON SLOPES GREATER THAN 10%

MULCH 8: OPTION, MELALEUCA MULCH, FOR USE IN GENERAL PLANTING AREAS AND ON SLOPES GREATER THAN 10%

MULCH C: IF SPECIFIED, MINI PINE BARK NUGGETS, FOR USE IN SPECIALTY AREAS

# INSTALLATION: REFER TO APPROPRIATE DETAILS FOR EXTENTS AND DEPTHS.


11 MULCH- TYPICAL

### MIX: # 5050- MUCK AND FINE SAND


SUPPLIER: ATLAS PEAT AND SOIL 561,734,7300


12 PLANTING SOIL- LAWN TOP DRESSING



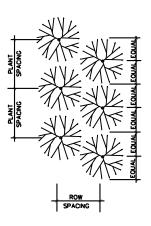

| PLANT SPACING | ROW SPACING |
|---------------|-------------|
| 12"           | 10.4"       |
| 18"           | 15.6"       |
| 24"           | 20.8"       |
| 30"           | 26.0"       |
| 36"           | 31.2"       |
| 48"           | 41.6"       |
| 60"           | 52.0"       |

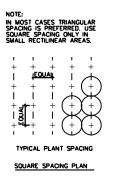


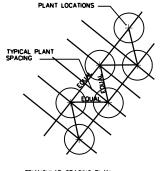

TRIANGULAR SPACING PLAN


PLANT SPACING

SCALE: NOT TO SCALE

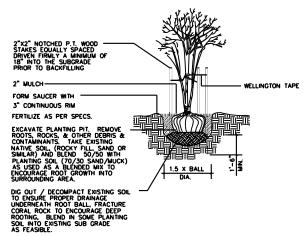


7 MULTI TRUNK TREE - PLANTNG & STAKING


| CALIPER     | TIES | STRANDS | STAKES    |
|-------------|------|---------|-----------|
| 1" - 1 1/2" | 2    | 1 # 12  | 2 - 2 × 2 |
| 1 1/2" - 2" | 3    | 1 # 12  | 3 - 2 × 2 |
| 2" - 3"     | 3    | 2 # 12  | 2 - 2 × 2 |

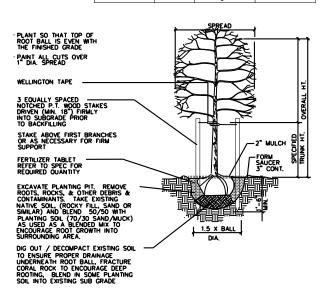

NOTE: USE FOR 3" OR LESS SINGLE STEM TREES & PALMS

8 CANOPY AND PALM TREE - PLANTING & VERTICAL STAKING SCALE: NOT TO SCALE

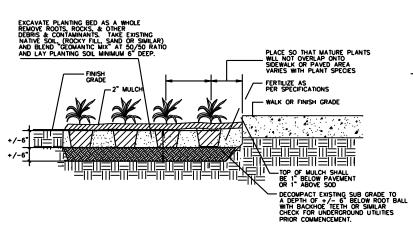

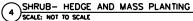

| 8" - 10"   2 x 4 x 12"   1 # 12   3 - 2 X 4  | 3 - 16d   |
|--|---|
| 10" - 16" 2 x 4 x 12" 2 # 12 4 - 2 X 4   | 3 - 16d   |
| * SPREAD   |   |
| PLANT SO THAT TOP OF ROOT BALL IS EVEN WITH THE FINISHED GRADE  WRAP TRUNK W/ 5 LAYERS OF BURLAP, IF SOFT SKIN BARK  WOODEN CLEATS WILL BE EQUALLY SPACED OVER PADDING & SECURED   | NOTE: STAKE TO FIRST BRANCHE: AS NECESSARY FOR FIRM SUPPORT WIRE SHALL NOT TOUCH OR RUB ADJACENT TRUNKS OR BRANCHES |
| W/ STEEL BANDS   |   |
| EQUALLY SPACED 2" X 4" P.T. WOOD STAKES NAILED TO CLEATS, DO NOT HAIL TO TRUNK   |   |
| FORM SAUCER WITH 5" CONTINUOUS RIM 5 5 5 5 5 72" MULCH SE  |   |
| FERTILIZER TABLET REFER TO SPEC FOR REGUIRED QUANTITY  | -   |
| EXCAVATE PLANTING PIT. REMOVE ROOTS, ROCKS, & OTHER DEBIS & CONTAMINANTS. TAKE EXISTING NATIVE SOLL (ROCKY FILL SAND OR SIMILAR) AND BLEND 50/50 WITH PLANTING SOLL (70/30 SAND/WICK) AS USED AS A BLENDED MIX TO ENCOURAGE ROOT GROWTH INTO SURROUNDING AREA. | ER TO STAKING DETAIL  |
| DIG OUT / DECOMPACT EXISTING SOIL  TO ENSURE PROPER DRAMAGE UNDERNEATH ROOT BALL, FRACTURE CORAL, ROOK TO ENCOURAGE DEEP ROOTING, BLEND IN SOME PLANTING SOIL INTO EXISTING SUB GRADE AS FEASIBLE.   |   |

CLEATS STRAPS BRACES 3" - 8" 2 x 4 x 8" 1 # 12 3 - 2 x 4 2 - 16d

NOTE: USE FOR 3" TO 12" SINGLE TRUNK TREES

5 CANOPY TREE - PLANTING & TRIPLE BRACE STAKING SCALE: NOT TO SCALE



FERTILIZE PER SPECIFICATIONS

EXCAVATE PLANTING PIT. REMOVE ROOTS, ROCKS, & OTHER DEBRIS & CONTAMINANTS. TAKE EXISTING NATIVE SOIL, (ROCKY FILL, SAND OR SIMILAR) AND BLEND 50/50 WITH SPECIFIED PLANTING SOIL

DIG OUT / DECOMPACT EXISTING SOIL TO ENSURE PROPER DRAINAGE UNDERNEATH ROOT BALL, FRACTURE CORAL ROCK TO ENCOURAGE DEEP ROOTING, BLEND IN SOME PLANTING SOIL INTO EXISTING SUB GRADE AS FEASIBLE.

SHRUB PLANTING
SCALE: NOT TO SCALE

EXCAVATE PLANTING PIT. REMOVE ROOTS, ROCKS, & OTHER DEBRIS & CONTAMINANTS. TAKE EXISTING NATIVE SOIL, (ROCKY FILL, SAND OR SMILAR) AND BLEND 50/50 WITH PLANTING SOIL (70/30 SAND/MUCK) AS USED AS A BLENDED MIX TO ENCOURAGE ROOT GROWTH INTO SURROUNDING AREA.


-FINISH GRADE / SOD OR PAVING

1.5 X BALL DIA.

CONTAINER GROWN SHRUB

-2" LAYER OF MULCH

SHRUB- HEDGE AND MASS PLANTING
SCALE: NOT TO SCALE

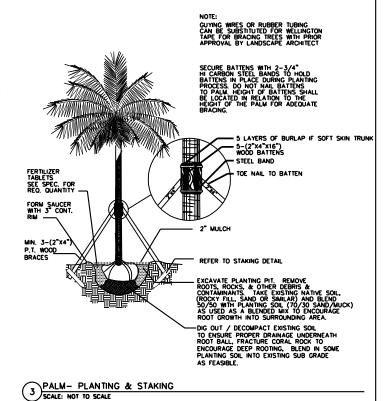



7580 NE 4th Court Studio 100 Miami, FL 33138

1819



Designer/ Landscape Architect

PROJECT: **4354 ALTON ROAD** 

> 4354 ALTON RD. MIAMI BEACH, FLORIDA, 33139

**RESIDENCES** 

DRAWING:

PLANTING DETAILS

MARSH C. KRIPLEN FLORIDA LIC# LA666700

CHECK: DATE:

07/09/2018 SHEET NUMBER

L450

[McG

## **LIGHTING NOTES**

- 1. PRIMARY CONTROLLERS AND GENERAL FIXTURE LOCATIONS SHOWN ONLY. CONTRACTOR TO SUBMIT SHOP DRAWINGS FOR COMPLETE SYSTEM DESIGN FOR APPROVAL BY LANDSCAPE ARCHITECT PRIOR TO INSTALLATION.
- 2. CONTRACTOR TO PROVIDE CODE COMPLIANT SYSTEM DESIGN INCLUDING FOOT CANDLE COVERAGE AND SEA TURTLE REQUIREMENTS FOR ENTIRE SITE.
- 3. COORDINATE LANDSCAPE LIGHTING WITH INTERIOR AND EXTERIOR ARCHITECTURAL LIGHTING. ENSURE COMPATIBILITY WITH ARCHITECTURAL LIGHTING SYSTEM CONTROLLERS.
- 4. PROVIDE NEMA RATED EQUIPMENT AND ENCLOSURES FOR SYSTEM CONTROLLERS EXPOSED TO THE ELEMENTS. SUBMIT PROPOSED MOUNTING SYSTEM, ENCLOSURES AND LOCATIONS AS PART OF THE SUBMISSION PROCESS.

| Landscape Lighting LED Horizontal   |                      |  |  |
|---|----------------------|--|--|
| Step Light  By WAC Lighting   | Call Us 866 428 9289 |  |  |
| by WAC Lighting   |                      |  |  |
| Product Options   |                      |  |  |
| Finish: Black on Aluminum, Bronze on Aluminum, Bronze on Brass, Cast Stainless Steel,   |                      |  |  |
| White on Aluminum   |                      |  |  |
| Light Option: Amber, Warm White, White  |                      |  |  |
| Details   |                      |  |  |
| Designed in 2016  |                      |  |  |
| Shade Material: Glass   |                      |  |  |
| Protected against high-pressure water jets  |                      |  |  |
| Rated Hours: 60,000 hours   |                      |  |  |
| • 10%-100% dimming  |                      |  |  |
| 50° beam spread   |                      |  |  |
| Features frosted glass diffuser   |                      |  |  |
| Solid diecast brass, corrosion resistant aluminum alloy or cast stainless steel         |                      |  |  |
| construction  |                      |  |  |
| Dimmable when used with Electronic low voltage (ELV) dimmer dimmers(not included)       |                      |  |  |
| Title 24 compliant  | Notes:               |  |  |
| UL Listed Wet   | Notes:               |  |  |
| <ul> <li>Warranty: 10 Years Functional / 5 Years Functional for Black Finish</li> </ul> |                      |  |  |
| Made In China   |                      |  |  |
| Dimensions  |                      |  |  |
| Fixture: Length 5*, Height 3*, Depth 1.93*  |                      |  |  |
| Lighting  |                      |  |  |
| 2 Watt (68 Lumens) 12 Volt Integrated LED: CRI: 90 Lifespan: 60000 hours                |                      |  |  |
| Additional Details  |                      |  |  |
| Product URL:  |                      |  |  |
| https://www.ylighting.com/led-12v-ledme-step-light-by-wac-lighting-WACP138098.html      |                      |  |  |
| Rating: UL Listed Wet   |                      |  |  |











7580 NE 4th Court Studio 100

Miami, FL 33138

1819

Designer/


Landscape Architect

PROJECT: **4354 ALTON** 

**ROAD RESIDENCES** 4354 ALTON RD. MIAMI BEACH,


FLORIDA, 33139

### LIGHTING NOTES & **SPECIFICATIONS**

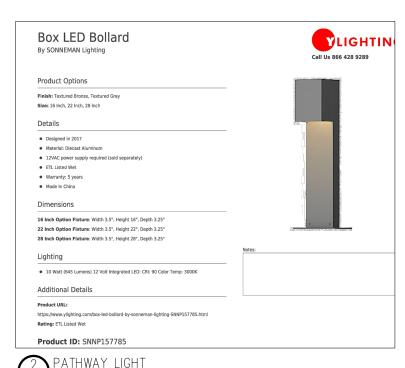

MARSH C. KRIPLEN FLORIDA LIC# LA666700

CHECK: MCK 07/09/2018 DATE: SHEET NUMBER

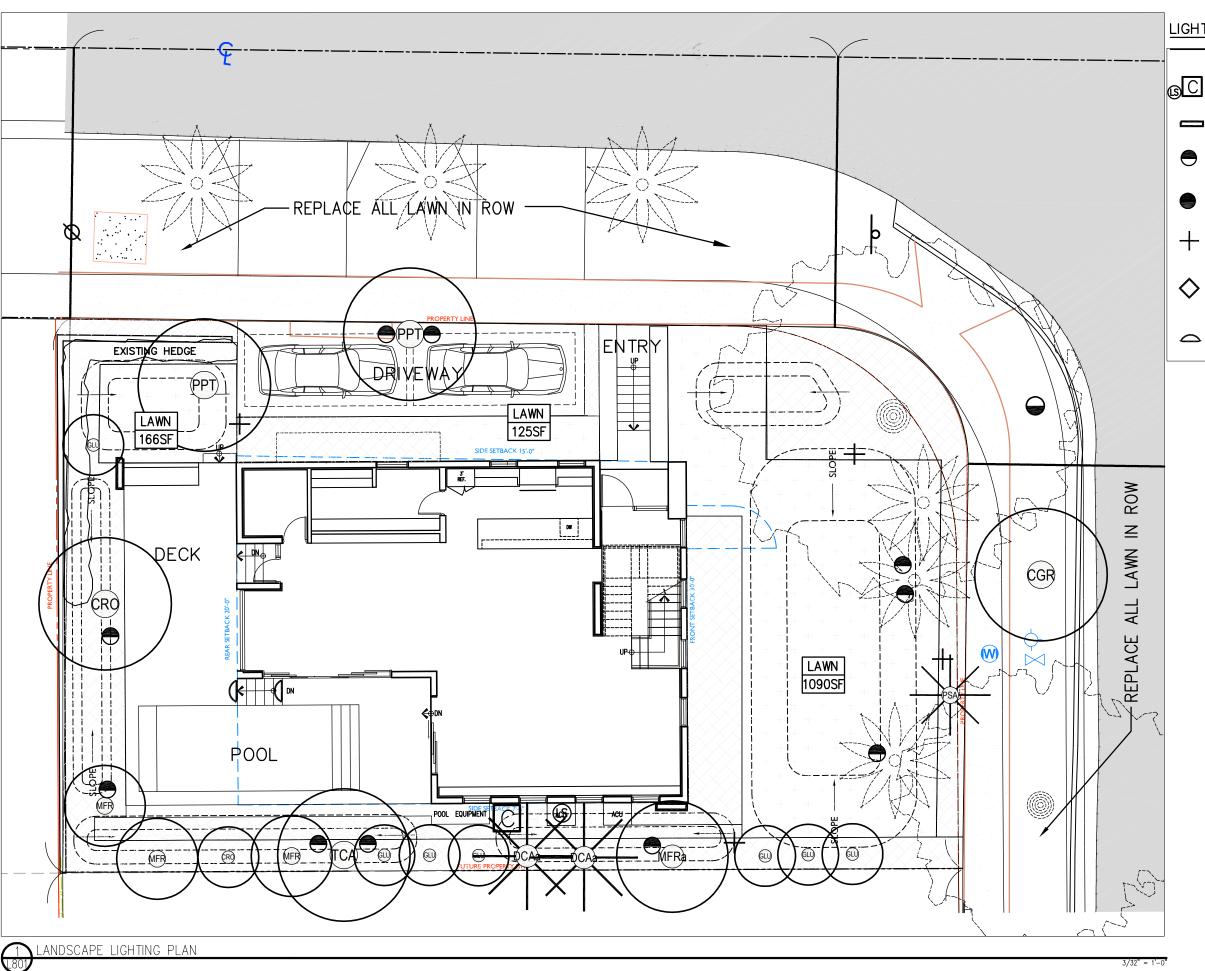

LIGHTING LEGEND

LIGHTING CONTROLLER

AND LIGHT SENSOR

**TRANSFORMER** 

**LIGHT TYPE 1** 

LIGHT TYPE 2

**PATH LIGHT** 

**BOLLARD** 

STEP LIGHT

ARCHITECTURE + PLANNIN

7580 NE 4th Court Studio 100 Miami, FL 33138

PROJECT NUMBER



Designer/ Landscape Architect

PROJECT:

4354 ALTON ROAD RESIDENCES

4354 ALTON RD. MIAMI BEACH, FLORIDA, 33139

DRAWING:

LIGHTING PLAN



MARSH C. KRIPLEN FLORIDA LIC# LA6667


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SCALE

CHECK: MCK


DATE: 07/09/2018


SHEET NUMBER

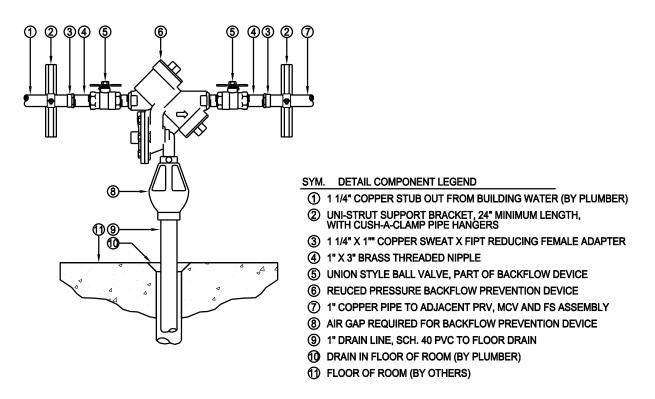

### **SECTION VIEW**

NTS

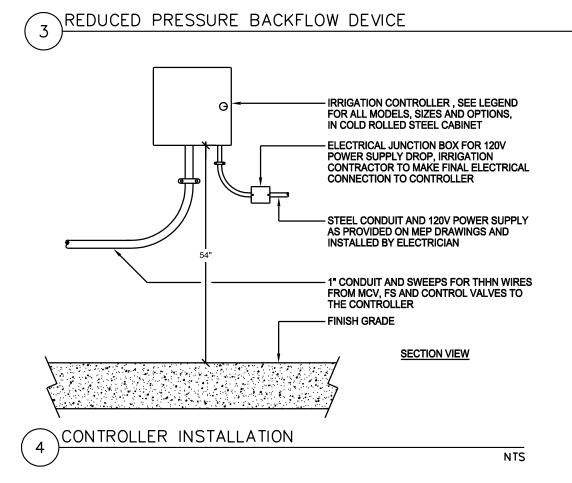

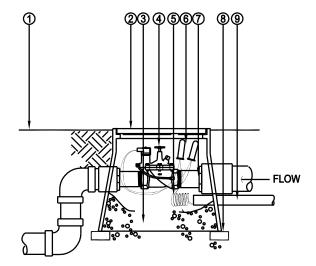


### SYM. DETAIL COMPONENT LEGEND

- ① GROUND LEVEL
- ② VALVE BOX COVER LABELED IRRIGATION CONTROL VALVE GREEN
- ③ GRAVEL 30 IN. MINIMUM DEPTH
- 4 REMOTE CONTROL VALVE RAINBIRD PGA
- (5) 12 IN. WIRE COIL EACH WIRE
- **(6) WATER PROOF CONNECTION**
- (7) SCH 80 NIPPLE
- 8 BRICK (1 0F 4)

### SECTION VIEW



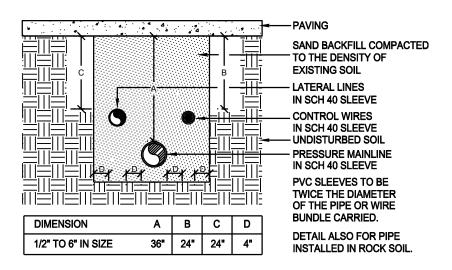

NOTE: SLEEVES TO EXTEND AT LEAST 12" PAST THE EDGE OF THE PAVING.

SECTION VIEW

NTS

SLEEVE INSTALLATION

MCG ARCHITECTURE + PLANNING

7580 NE 4th Court Studio 100 Miami, FL 33138

PROJECT NUMBER



Designer/ Landscape Architect

PROJECT: 4354 ALTON ROAD

4354 ALTON RD. MIAMI BEACH, FLORIDA, 33139

**RESIDENCES** 

DRAWING:


IRRIGATION DETAILS


MARSH C. KRIPLEN FLORIDA LIC# LA66670
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SCALE:

CHECK: JMcG
DATE: 07/09/2018
SHEET NUMBER


**IR100** 



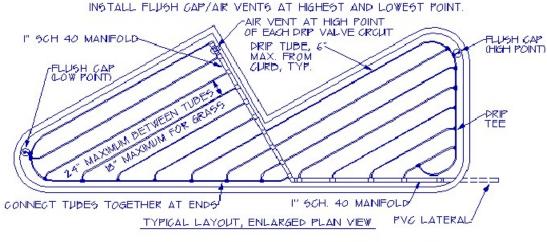

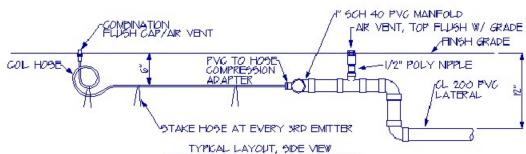TYPICAL DRIP IRRIGATION - PLAN & SECTION

NTS

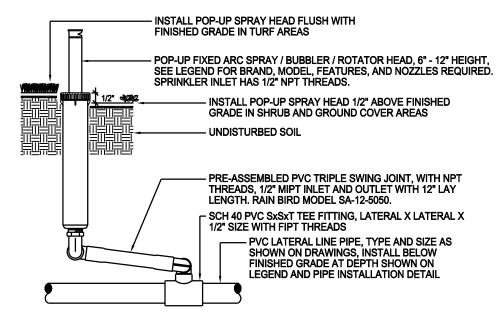

### **SECTION VIEW**

INSTALL SPRAY HEADS 4" FROM PAVING EDGE IN TURF AREAS. INSTALL SPRAY HEADS 6" FROM PAVING EDGE IN SHRUB AND GROUND COVER AREAS. INSTALL SPRAY HEADS 12" FROM THE FACE OF BUILDING WALLS OR WINDOWS. INSTALL SPRAY HEADS PLUMB. ADJUST NOZZLE SPRAY TO COVER THE LANDSCAPE AREA WITHOUT OVERSPRAY ONTO PAVING, FENCES, WALLS OR BUILDINGS. SPRINKLER, SWING JOINT, AND PVC FITTINGS SHALL ALL HAVE "NPT" STYLE THREADS.

POP - UP SPRINKLER HEAD 5

NTS

- FINISH GRADE **CLEAN COMPACTED BACKFILL** LATERAL LINES, SEE SPECS. CONTROL WIRES, SEE SPECS. **UNDISTURBED SOIL** PRESSURE MAINLINE, SEE **SPECIFICATIONS** 

| DIMENSION          | Α   | В   | С  |
|--------------------|-----|-----|----|
| 1/2" TO 2" IN SIZE | 18" | 12" | 4" |

**SECTION VIEW** 

Landscape Architect PROJECT:

# **4354 ALTON** ROAD **RESIDENCES**

Designer/

7580 NE 4th Court

Studio 100

Miami, FL 33138

1819

4354 ALTON RD. MIAMI BEACH, FLORIDA, 33139

DRAWING:

**IRRIGATION NOTES** & DETAILS

CHECK: IMcG 07/09/2018 DATE: SHEET NUMBER

MARSH C. KRIPLEN FLORIDA LIC# LA666700

SNIGLE OUTLET EMITTER. EMITTER SHALL DE STAKED AGAINST -SHKUD KOOTDALL TOP OF BUTTER SHALL NOT BE MORE THAN I' ABOVE THE FNIGH SOL (NOT BARK) LEVEL. 6" MIN. PEPTH =|| STAKE REQUIRED AT ROOTBALL.

THE FEEDER TUDING MUST DE BURED (" DEEP, EXCEPT WHERE THE EMITTER IS ATTACHED. CUT OFF TUDING TO LENGTH REQUIRED TO REACH ROOTBALL, SO THAT EMITTER IS JUST ABOVE CROUND LEVEL. STAKE SHALL DE MADE FROM STEEL.

(GALVANIZED STEEL AND PLASTIC STAKES MAY NOT DE USED). STAKES FOR TUDING SHALL DE AT LEAST (" IN LENGTH. SUITADLE STAKES CAN DE MADE.

FROM SPRNKLER STAKING FLAGS OR COATHANGERS.

24" LONG, THOK-WALL, FEEDER TUDING. LONGER LENGTHS OF TUDING MAY NOT BE USED. TUDING MAY BE CUT SHORTER.


NGTALL LATERAL TEE WITH OUTLET AT 45 DEGREE ANGLE FACING TOWARD

SHRUB EMITTER


PIPE INSTALLATION

**IR101** 

NTS

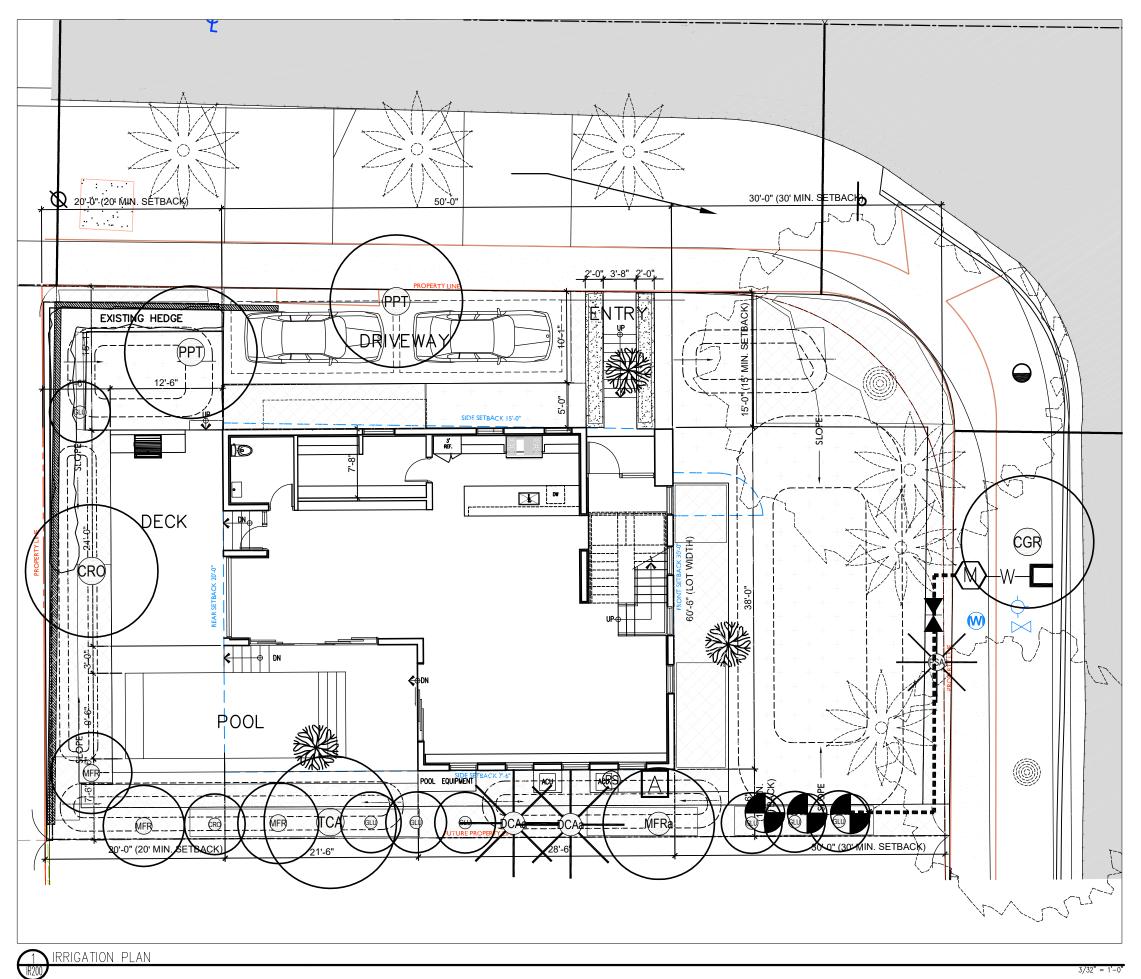

## IRRIGATION LEGEND

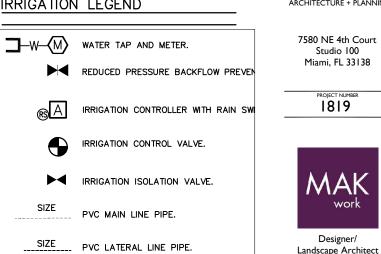

Studio 100 Miami, FL 33138 PROJECT NUMBER

Designer/ Landscape Architect

PROJECT: **4354 ALTON** ROAD **RESIDENCES** 

4354 ALTON RD. MIAMI BEACH, FLORIDA, 33139

DRAWING:

IRRIGATION PLAN

# IRRIGATION NOTES

INFORMATION ON DRAWINGS FOR POINT OF CONNECTION, CONTROLLER, VALVE AND MAIN LINE ONLY. CONTRACTOR TO PROVIDE FINAL DRAWINGS AND SPECIFICATIONS FOR PERMIT.

PVC SLEEVE PIPE.

DRIP IRRIGATION ZONE

1" BRASS QUICK COUPLER VALVE.



MARSH C. KRIPLEN FLORIDA LIC# LA666700

CHECK:

MCK 07/09/2018 DATE: SHEET NUMBER

**IR200**