

EXISTING TREE DISPOSITION LIST									
KEY	BOTANICAL NAME	COMMON NAME	SIZE		DISPOSITION			MITIGATION	
			HT.(ft.)	SPD.(ft.)	DBH.(in.)	REMAIN	REMOVE	TRANSPL.	S.F. CANOPY
1	Conocarpus erectus "Sericeus"	Silver Buttonwood	10	8	3.8		x		50
2	Conocarpus erectus "Sericeus"	Silver Buttonwood	10	10	4.5		x		79
3	Conocarpus erectus "Sericeus"	Silver Buttonwood	10	10	5		x		79
4	Conocarpus erectus "Sericeus"	Silver Buttonwood	10	8	4.1		x		50
5	Conocarpus erectus "Sericeus"	Silver Buttonwood	10	10	4.6		x		79
6	Ficus refusa exotica	Indian Laurel	14	18	Multi		x		EXEMPT
7	Ficus refusa exotica	Indian Laurel	14	18	Multi		x		EXEMPT
8	Ficus refusa exotica	Indian Laurel	14	18	Multi		x		EXEMPT
9	Ficus refusa exotica	Indian Laurel	14	18	Multi		x		EXEMPT
10	Pythospermum elegans	Solitaire Palm	14	6	4		x		28
11	Mangifera indica	Mango Tree	18	10	5		x		
12	Veitchia montgomeryana	Montgomery Palm	24	15	8		x		
13	Coccoloba diversifolia	Pigeon Plum	10	12	4		x		
14	Sabal palmetto	Sabal Palm	28	10	18		x	x	79
15	Sabal palmetto	Sabal Palm	28	10	18		x		
16	Sabal palmetto	Sabal Palm	28	10	18		x		
17	Sabal palmetto	Sabal Palm	28	10	18		x		
18	Conocarpus erectus	Green Buttonwood	14	5	Multi			x	
19	Conocarpus erectus	Green Buttonwood	14	5	Multi			x	
20	Conocarpus erectus	Green Buttonwood	14	5	Multi			x	
21	Conocarpus erectus	Green Buttonwood	14	5	Multi			x	
22	Conocarpus erectus	Green Buttonwood	14	5	Multi			x	
23	Conocarpus erectus	Green Buttonwood	14	5	Multi			x	
24	Conocarpus erectus	Green Buttonwood	14	5	Multi			x	
25	Conocarpus erectus	Green Buttonwood	14	5	Multi			x	
26	Conocarpus erectus	Green Buttonwood	14	5	Multi			x	
27	Conocarpus erectus	Green Buttonwood	14	5	Multi			x	
28	Conocarpus erectus	Green Buttonwood	14	5	Multi			x	
29	Conocarpus erectus	Green Buttonwood	14	5	Multi			x	
30	Conocarpus erectus	Green Buttonwood	14	5	Multi			x	
31	Conocarpus erectus	Green Buttonwood	14	5	Multi			x	
32	Conocarpus erectus	Green Buttonwood	14	5	Multi			x	
33	Conocarpus erectus	Green Buttonwood	14	5	Multi			x	
34	Conocarpus erectus	Green Buttonwood	14	5	Multi			x	
35	Conocarpus erectus	Green Buttonwood	14	5	Multi			x	
36	Conocarpus erectus	Green Buttonwood	14	5	Multi			x	
37	Conocarpus erectus	Green Buttonwood	14	5	Multi			x	
38	Conocarpus erectus	Green Buttonwood	14	5	Multi			x	
39	Conocarpus erectus	Green Buttonwood	14	5	Multi			x	
40	Conocarpus erectus	Green Buttonwood	14	5	Multi			x	
41	Conocarpus erectus	Green Buttonwood	14	5	Multi			x	
42	Conocarpus erectus	Green Buttonwood	14	5	Multi			x	
43	Conocarpus erectus	Green Buttonwood	14	5	Multi			x	
TOTAL CANOPY S.F. TO BE REPLACED									443
TOTAL CANOPY S.F. TO BE PROVIDED									3,200


- LEGEND
- EXISTING TREE TO REMAIN
 - EXISTING TREE TO BE REMOVED
 - EXISTING TREE TO BE TRANSPLANTED



MIAMI BEACH
CAPITAL IMPROVEMENT PROJECTS

CITY MANAGER: JIMMY L. MORALES
CITY DIRECTOR: ROY COLEY, P.E.
CITY ENGINEER: DAVID MARTINEZ, P.E.
CITY ENGINEER: LUIS SOTO, P.E.

Schwabke
Shiskin &

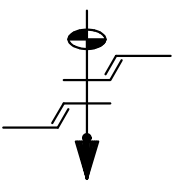

Associates, Inc.
LAND SURVEYORS
CIVIL ENGINEERS
LAND PLANNERS
LB#87 CA#87

3240 CORPORATE WAY
MIRAMAR, FL 33025
TEL: (305)652-7010
FAX: (305)652-8284

No.	Date	Revision	App'd By
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NEIGHBORHOOD:
Surface Lot at Biscayne Beach - 8100 Hawthorne Avenue

TITLE:
Existing Tree Disposition Plan

DRB FINAL

ENG. OF RECORD: Ken Gardner
TITLE: President
ENGINEER No.: FL LA 1569
DRAWN BY: HM
CHECKED BY: KEG
SCALE: As Noted
FIELD BOOK: _____
PAGE: _____
PURCHASE ORDER: 20181531-00
FILE NAME: GS LA - SHEETS.dwg
ISSUE DATE: 08.03.18

Dwg. No:
L-1
OF:

LANDSCAPE SPECIFICATIONS
PART 1 - GENERAL

1.1 SCOPE

A. Contractor shall provide all labor, materials, equipment, supervision, and related work necessary to complete the landscape work in accordance with the intent of the landscape plans, schedules and these specifications. The extent of work is shown on the drawings which are a part of this document.

1.2 CONTRACTOR QUALIFICATIONS

A. Landscape installation work to be performed by a Contractor Certified by the Florida Nurserymen, Growers and Landscape Association (FNLGA) as a Certified Landscape Contractor. Any pruning to be supervised by an Arborist, certified by the International Society of Arboriculture (ISA) and licensed in Miami-Dade County.

1.3 INVESTIGATION OF UTILITIES

A. Prior to beginning work, the Contractor shall be responsible to locate existing underground utilities. Check with all utility companies and Sunshine State, call (811).

1.4 SUBSTITUTIONS

A. Only materials specified will be accepted, unless approved in writing by the Landscape Architect in advance.

1.5 PLANT SIZE

A. All plant sizes shall equal or exceed the minimum sizes as specified in the plant list. When plant sizes are specified on a range of size, installed materials shall average the mean of the range specified. Plants shall be measured following pruning, with branches in normal position. All necessary pruning shall be done at the time of planting.

1.6 PLANT QUALITY

A. All plant material shall be equal to or better than Florida No. 1 as classified by "Grades and Standards for Nursery Plants" by the Division of Plant Industry, Florida Department of Agriculture. They shall have a growth habit that is normal for the species, healthy, vigorous, free from insect, disease and injury.

B. The Owner or Landscape Architect reserves the right to refuse any plant material which does not conform to the intent of the written specifications or design.

C. CIRCUMFERENCE OF ROOTS FOUND ON CONTAINER-GROWN MATERIAL WILL NOT BE ACCEPTED UNLESS REMEDIAL ROOT PRUNING, APPROVED BY THE LANDSCAPE ARCHITECT IS DONE BEFORE PLANTING.

1.7 PLANT QUANTITY

A. The plant quantities shown on the plant list are to be used only as an aid to bidders. In the case of discrepancy between the plant list and the plan, the quantity on the plan shall override the plant list.

1.8 UNIT PRICES

A. The successful bidder shall furnish to the Owner and the Landscape Architect, a unit price breakdown for all materials. The Owner may, at his discretion, add to or delete from the materials utilizing the unit price breakdown submitted to and accepted by the Owner.

1.9 SUBMITTALS

A. The Contractor shall submit to the Owner and the Landscape Architect documentation that all the fertilizer used for the project is of the analysis specified and placed at the rates specified in section 2.2 FERTILIZER.

B. Planting soil: The Contractor shall submit a sample of the planting soil (approximately 1 cu. ft.) for approval by the Landscape Architect prior to delivery to the site.

1.10 CLEAN-UP & MAINTENANCE OF TRAFFIC

A. Follow procedures in FDOT Index 600 for maintenance of traffic during construction.

B. At the end of each work day, the Contractor shall remove debris and shall backfill the un-filled holes in a manner appropriate to the path of pedestrians and motorists.

C. Upon completion of the work or any major portion of the work or as directed by the Landscape Architect, all debris and surplus material from his work shall be removed from the job site.

1.11 MAINTENANCE PRIOR TO ACCEPTANCE

A. The Contractor is responsible to maintain the plantings until they are accepted under the provisions of 1.12 "ACCEPTANCE OF INSTALLATION".

1. Plants: Begin maintenance immediately following the final plant installation operation for each plant and continue until all plant installation is complete and accepted. Maintenance shall include watering of plants, weeding, mulching, pest and disease control, lightening and repairing of guys, repair of braces, removal of dead growth, resetting of plants to proper grade or up-right position, restoration of plant anchor, litter pick-up in plant beds and other necessary operations to ensure specified minimum grade of Florida No. 1.

2. Turf Areas: Begin maintenance of turf immediately following the placement of soil and continue until soil installation is complete and accepted. Maintenance shall include but not be limited to, watering, leveling, mowing, weed and pest control, fungus and disease control and other necessary operations as determined by the Landscape Architect and good nursery practice.

3. Re-setting or straightening trees and palms: The Contractor shall re-set and/or straighten trees and palms as required at no additional cost to the Owner unless caused by sustained winds of 75 mph or more. Then, the costs of the operations shall be charged to the owner. Re-set trees within 48 hours.

1.12 ACCEPTANCE OF INSTALLATION

A. Inspection: Inspection of the work, to determine completion of contract work, exclusive of the possible replacement of plants and turf, will be made by the Landscape Architect at the conclusion of the maintenance period. Written notice requesting such inspection and submitted by the Contractor at least ten (10) days prior to the anticipated date.

1.13 GUARANTEE

A. Guarantee all plants for a period of one year (CCD). Guarantee shall commence from the date of written acceptance. Plant material which is on the site and scheduled to be relocated is not covered by the guarantee except in the case of Contractor's negligence or work that has been done in an unworkmanlike manner. The Contractor is not responsible for loss due to acts of god, (i.e.) sustained winds of 75 mph or more, floods, frost, lightning, vandalism or theft.

1.14 REPLACEMENT

A. Replacement shall be made during the guarantee period as directed by the Landscape Architect within ten (10) days from time of notification. For all replacement plant material, the guarantee period shall extend for an additional forty-five (45) days beyond the original guarantee period. The Contractor shall be responsible to provide water to the replacement plants in sufficient quantity to soil in their establishment. At the end of the guarantee period, inspection will be made by the Landscape Architect, upon written notice requesting such inspection and submitted by the Contractor at least five (5) days before the anticipated date. Replacement plants must meet the requirements of Florida No. 1 at time of inspection. Remove from the site all plants that are dead or in a state of unsatisfactory growth, as determined by the Landscape Architect. Replace these and any plants missing due to the Contractor's negligence as soon as conditions permit.

1. Materials and Operations: All replacement plants shall be of the same kind and age as indicated on the plant list. The Contractor shall supply and plant the plants as specified under planting operations.

2. Cost of Replacements: A sum sufficient to cover the estimated cost of possible replacements, including material and labor will be retained by the Owner and paid to the Contractor after all replacements have been satisfactorily made and approved by the Landscape Architect.

PART 2 - MATERIALS

2.1 PLANTING SOIL

A. Planting soil for trees, shrubs and ground covers shall be of the composition noted on the plans, measured by volume.

B. Soil for Soddied Areas: shall be coarse lawn sand.

2.2 FERTILIZER

A. Fertilizer for trees, palms, shrubs, and groundcovers shall be as follows: LESCO Palm Special 13-3-13 or equal, Sulfur coated with iron and other minor elements and maximum of 2% chlorine, or brand with equal analysis. The fertilizer shall be uniform in composition, dry and free flowing and shall be delivered to the site in the original unopened containers, bearing the manufacturer's guaranteed analysis. Fertilizer for soil and seeded areas shall be 8-8-8, 50% organically derived nitrogen, or equal.

2.3 WATER

A. The Contractor shall provide potable water on site, available from the start of planting. The Contractor is responsible to ascertain the location and availability of the water source. The Contractor is responsible to provide the means of distribution (i.e. water truck, hoses, etc.) for distribution of water to the planting areas.

2.4 MULCH

A. Mulch shall be shredded Mulchwood mulch (Florimulch) as manufactured by Forestry Resources, Inc., or equal.

2.5 ROOT BARRIER MATERIAL

A. Root barrier material shall be 24" deep polypropylene panels by DeepRoot or approved equal.

B. Install per details in the plans.

PART 3 - INSTALLATION PROCEDURES

3.1 LAYOUT

A. Verify location of all underground utilities and obstructions prior to excavation.

3.2 HERBICIDE TREATMENT

A. In all areas infected with weed and/or grass growth, a systemic herbicide, such as Roundup, shall be applied per manufacturer's rates. When it has been established where work will be done, the systemic herbicide shall be applied in accordance with manufacturer's labeling to kill all noxious growth. Contractor shall schedule his work to allow more than one application to obtain at least 95% kill of undesirable growth. If necessary, Contractor shall conduct a test to establish suitability of product and applicable to be used on this project, prior to execution of the full application.

3.3 PLANT PIT EXCAVATION AND BACKFILLING

A. Trees: See the Planting and Bracing Details and notes.

B. All planting holes shall be hand dug where machine dug holes may adversely affect utilities or improvements.

C. Shrubs and Groundcover: Shrubs and groundcover shall be planted in a soil bed as described in the notes and details. Space shrubs and groundcover setback from curbs and pavements as shown in the plans.

D. Watering of field-grown plants: Thoroughly puddle in water to remove any air pockets in the plant hole.

3.4 WATERING

A. The Contractor is responsible to provide the water for all new plants and transplants and means of distribution (i.e. hand watering or water truck) during the maintenance period and extending into the period after acceptance until the full schedule as listed below is complete. Water for trees and other large field grown plants shall be supplemented by hand or water truck, in addition to the irrigation system, (if one is provided). Contractor can adjust watering schedule during heavy rain season upon approval of the Landscape Architect.

AMOUNT OF WATER PER APPLICATION
For trees up to 5 inch caliper - 5 gallons
From 5 to 8 inch caliper - 25 gallons
9 inch and up caliper - 50 gallons

FREQUENCY OF WATER

Daily for the first week
3 times per week for weeks 2 - 5
2 times per week for weeks 6 - 8
1 time per week for weeks 9 - 12

B. Water in plants by thoroughly soaking of the entire root ball immediately after planting. For large trees and shrubs, add water while backfilling to eliminate any air pockets in the soil around the root ball.

C. Water shrubs, sod and groundcover a minimum of once daily for a week or until an irrigation system is fully operational. If no irrigation system is to be installed, the Contractor shall be responsible for watering the shrubs, sod, and groundcover for the time specified above, after installation of each section of the planting installed.

3.5 FERTILIZING

A. Add fertilizer on top of the surface of shrub beds and tree and palms root balls two (2) months after installation. Fertilize soil within two (2) days after installing after planting of each segment of the job. Fertilizer shall be applied after soil has been well moistened. Fertilizer shall be washed off of plant leaves and stems immediately after application. Apply at the following rates:

1. Trees and Large Shrubs: One (1) pound per inch of trunk diameter, spread evenly over the root ball area.

2. Shrubs: One half (1/2) handful per shrub, spread evenly over the root ball area.

3. Groundcover: Twelve (12) pounds per 100 sq. ft. of bed areas.

4. Sod: Twelve (12) pounds per 1,000 sq. ft. Wash fertilizer off blades immediately after spreading.

3.6 MULCHING

A. Spread mulch two (2) inches thick uniformly over the entire surface of shrubs and groundcover beds, depth measured after settling, unless otherwise specified in the plans. Provide 36" diameter bed of mulch, measured from outer edge of the trunk, for all trees and palms planted in soil areas. Keep mulch away from contact with the trunk. Create a 6" high ring of mulch at the outer edge of tree and palm holes.

3.7 GUYING AND BRACING

A. See the details bound herewith or made part of the plans.

3.8 SODDING

A. Provide a blanket of lawn sand as described in the notes in these plans. Prior to planting, remove stones, sticks, etc. from the sub-soil surface. Excavate existing non-conforming soil as required so that the final grade of the soil is flush with adjacent pavement or top of curb as well as adjacent soil in the case of sod planting.

B. Place sod on moistened soil, with edges tightly butted, in staggered rows at right angles to slopes. The sod shall be rolled with a 500 pound hand roller immediately after placing.

C. Keep edge of sod bed a minimum of 18" away from groundcover beds and 24" away from edge of shrub beds and 36" from trees, measured from the edge of plant or tree trunk.

D. Sod shall be watered immediately after installation to uniformly wet the soil to at least two inches below the bottom of sod strips.

E. Apply fertilizer to the sod as specified in Section 3.5.

F. Excavate and remove excess soil so top of sod is flush w/top of curb or adjacent pavement, or adjacent existing sod.

PLANT BED PREPARATION NOTES

1. In all areas where new sod and shrub and groundcover masses are to be planted, kill all existing weeds by treating with Round-up prior to beginning soil preparation.

2. In all shrub and groundcover beds, prepare soil as described for either condition, over the entire area to be planted.

Condition A:

If any compacted road base or asphalt or rocky soil is encountered, remove compacted material entirely to allow an 18" depth of planting soil. Backfill the entire area of the shrub and groundcover beds with 18" planting soil (as specified in Plans) to within 2 inches of the adjacent pavement or top of curb. Remove all debris and rocks and pebbles larger than 1 inch in size and level the grade before planting.

Condition B:

Where no compacted soil is encountered, thoroughly mix 6 inches of planting soil into the existing soil to a depth of 18 inches. If required, excavate and remove the existing soil to lower the grade, so that the prepared mix is finished to a minimum of 2 inches below top of curb or adjacent walkway. Remove all debris and rocks and pebbles larger than 1 inch in size and level the grade before planting.


For all sod areas, spread a 2" deep layer of lawn sand prior to sodding. Remove all debris and rocks and pebbles larger than 1 inch in size and level the grade before sodding. Remove, if required, existing soil so that top of sod is flush with and adjacent top of curb or pavement.

SPACING OF PLANTS (SEE PLANT SPACING DETAIL)



1. Plants shall be planted sufficiently away from edges of pavements or curbs, to allow for growth toward the edges of the bed.

PROTECTION OF PLANTS

1. The Contractor shall be responsible to protect existing trees and shrubs in and adjacent to the area of work. Erect barriers as necessary to keep equipment and materials, any toxic material, away from the canopy drip line of trees and shrubs. DO NOT PILE SOIL OR DEBRIS AGAINST TREE TRUNKS OR DEPOSIT NOXIOUS BUILDING SUPPLIES OR CHEMICALS WITHIN THE DRIP LINE.

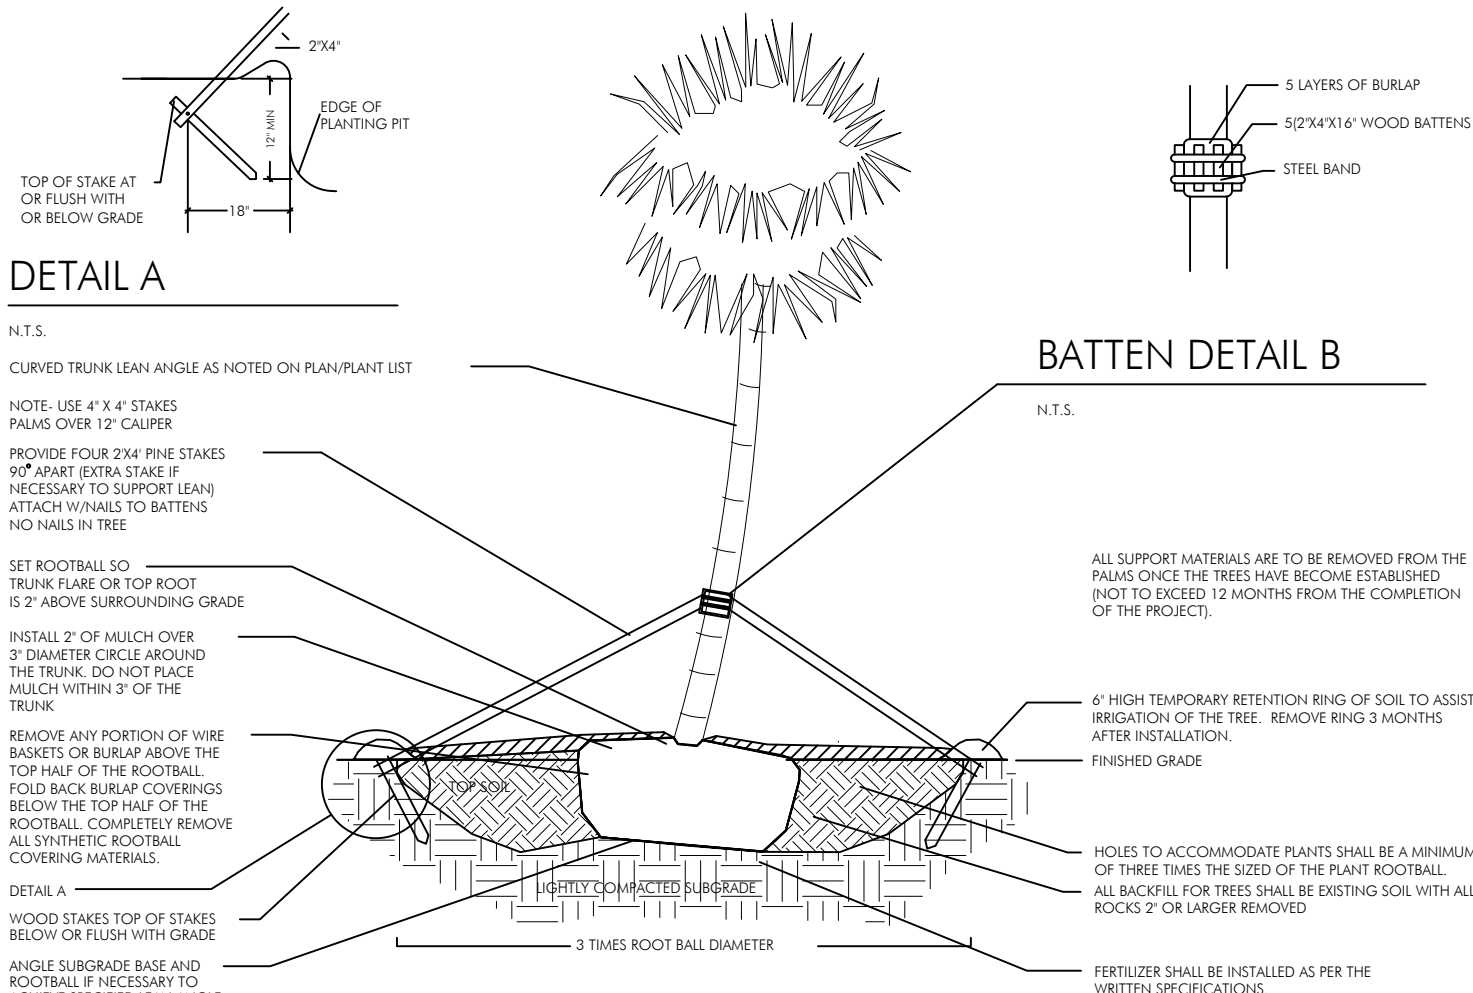

PLANTING & BRACING DETAIL
FOR LEANING/CROOKED PALMS

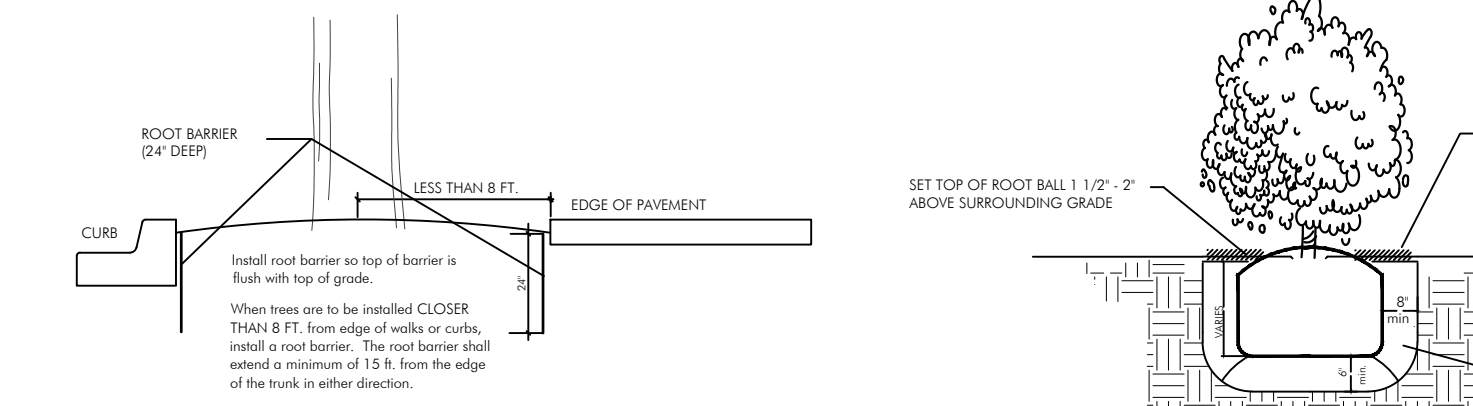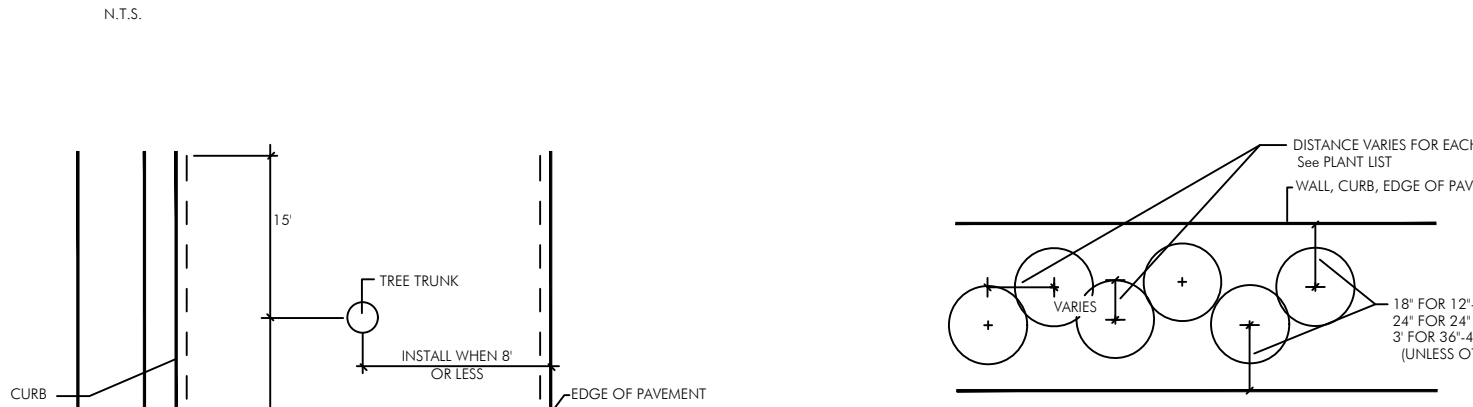

ROOT BARRIER INSTALLATION DETAIL

1. In all areas where new sod and shrub and groundcover masses are to be planted, kill all existing weeds by treating with Round-up prior to beginning soil preparation.

2. In all shrub and groundcover beds, prepare soil as described for either condition, over the entire area to be planted.

Condition A:
If any compacted road base or asphalt or rocky soil is encountered, remove compacted material entirely to allow an 18" depth of planting soil. Backfill the entire area of the shrub and groundcover beds with 18" planting soil (as specified in Plans) to within 2 inches of the adjacent pavement or top of curb. Remove all debris and rocks and pebbles larger than 1 inch in size and level the grade before planting.

Condition B:
Where no compacted soil is encountered, thoroughly mix 6 inches of planting soil into the existing soil to a depth of 18 inches. If required, excavate and remove the existing soil to lower the grade, so that the prepared mix is finished to a minimum of 2 inches below top of curb or adjacent walkway. Remove all debris and rocks and pebbles larger than 1 inch in size and level the grade before planting.


For all sod areas, spread a 2" deep layer of lawn sand prior to sodding. Remove all debris and rocks and pebbles larger than 1 inch in size and level the grade before sodding. Remove, if required, existing soil so that top of sod is flush with and adjacent top of curb or pavement.

SPACING OF PLANTS (SEE PLANT SPACING DETAIL)

1. Plants shall be planted sufficiently away from edges of pavements or curbs, to allow for growth toward the edges of the bed.

PROTECTION OF PLANTS

1. The Contractor shall be responsible to protect existing trees and shrubs in and adjacent to the area of work. Erect barriers as necessary to keep equipment and materials, any toxic material, away from the canopy drip line of trees and shrubs. DO NOT PILE SOIL OR DEBRIS AGAINST TREE TRUNKS OR DEPOSIT NOXIOUS BUILDING SUPPLIES OR CHEMICALS WITHIN THE DRIP LINE.

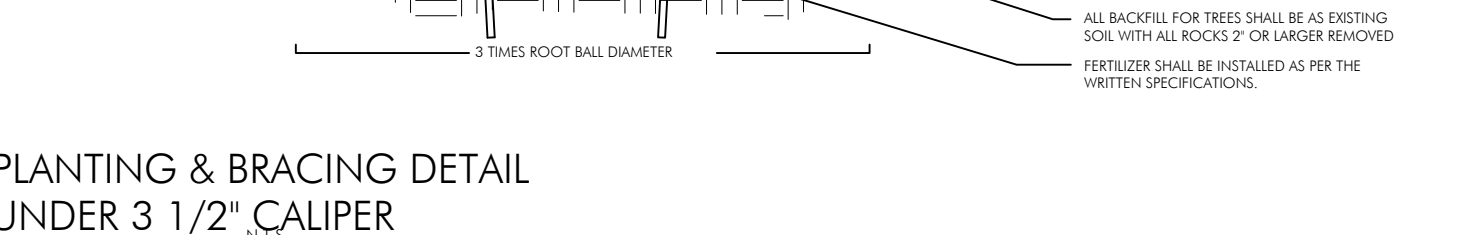

PLANTING & BRACING DETAIL
UNDER 3 1/2\"/>

CITY OF MIAMI BEACH
LANDSCAPE LEGEND
INFORMATION REQUIRED TO BE PERMANENTLY AFFIXED TO PLANS
Zoning District GLU Lot Area 0.56 Acres 24,285

OPEN SPACE

- A. Square feet of required Open Space as indicated on site plan:
Lot Area = 24,285 s.f. x 20% = 4,857 s.f.
- B. Square feet of parking lot open space required as indicated on site
- C. Total square feet of landscaped open space required: A+B=

LAWN AREA CALCULATION

- A. Square feet of landscaped open space required
- B. Maximum lawn area (sod) permitted= 50% x _____ s.f.

TREES

- A. Number of trees required per lot or net lot acres, less existing number of trees meeting minimum requirements=
- B. % Natives required: Number of trees provided x 30% =
- C. % Low maintenance / drought and salt tolerant required: Number of trees provided x 50% =
- D. Street Trees (maximum average spacing of 20' o.c.)
- E. Street tree species allowed directly beneath power lines: (maximum average spacing of 20' o.c.):
- 279 linear feet along street divided by 20' =

SHRUBS

- A. Number of shrubs required: Sum of lot and street trees required x
- B. % Native shrubs required: Number of shrubs provided x 50% =

LARGE SHRUBS OR SMALL TREES

- A. Number of large shrubs or small trees required: Number of required shrubs x 30% =
- B. % Native large shrubs or small trees required: Number of large shrubs or small trees provided x 50% =

NEIGHBORHOOD: Surface Lot at Biscayne Beach - 8100 Hawthorne Avenue

TITLE: Landscape Specifications and Planting Details

DRB FINAL

ENG. OF RECORD: Ken Gardner

TITLE: President

ENGINEER No.: FL LA 1569

DRAWN BY: HM

CHECKED BY: KEK

SCALE: As Noted

FIELD BOOK: _____

PAGE: _____

PURCHASE ORDER: 20181531-00


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17670 NW 78th AVE., SUITE 214
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Associates, Inc.


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CIVIL ENGINEERS
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LB#87 CA#87

3240 CORPORATE WAY
MIRAMAR, FL 33025
TEL: (305)652-7010
FAX: (305)652-8284

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NOTE: IRREGULAR OR MULTI-STEMMED TREES SHALL HAVE A SIMILAR STAKING PATTERN AS SINGLE TRUNKED TREES. STAKES NEED NOT ALL BE ATTACHED TO EVERY STEM

ALL SUPPORT MATERIALS ARE TO BE REMOVED FROM THE TREES ONCE THE TREES HAVE BECOME ESTABLISHED (NOT TO EXCEED 12 MONTHS FROM THE COMPLETION OF THE PROJECT).

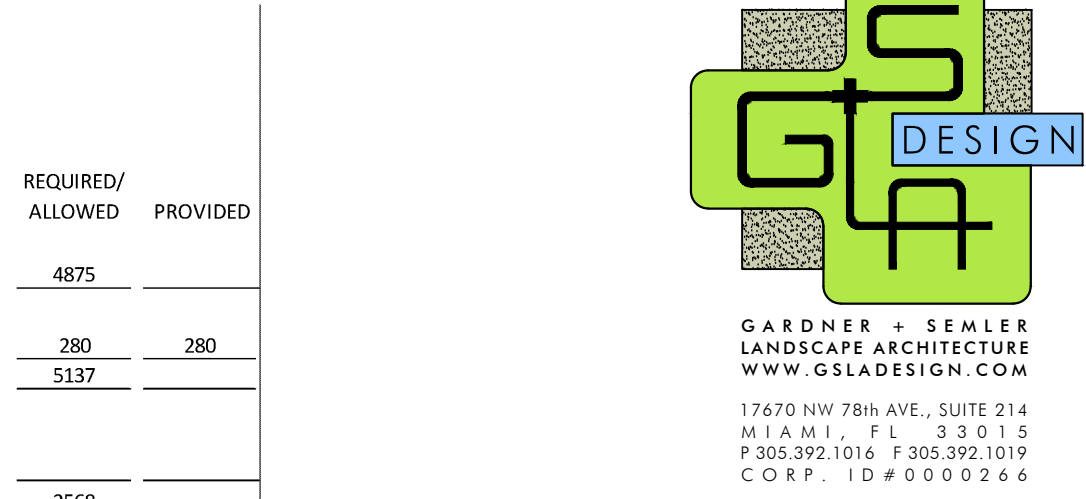

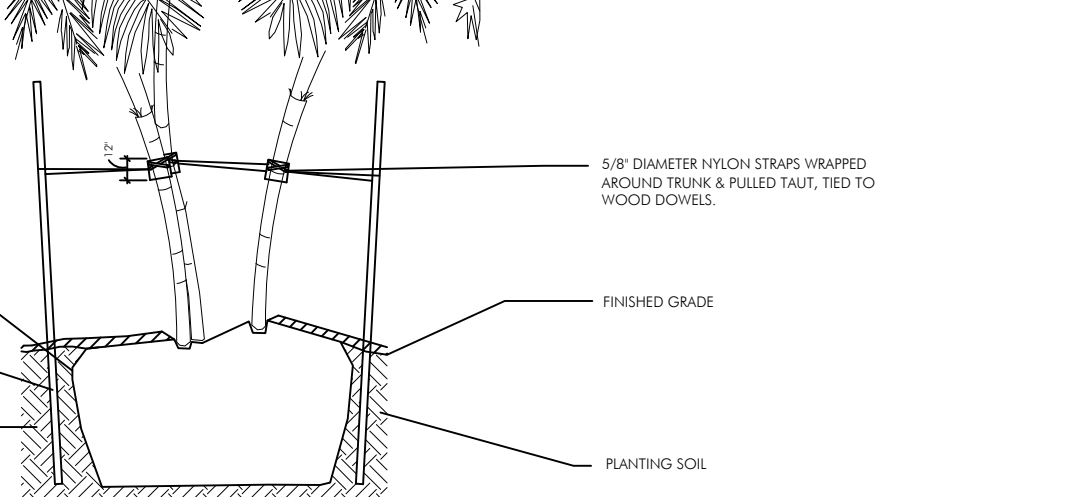BATTEN DETAIL B

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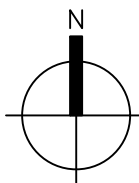
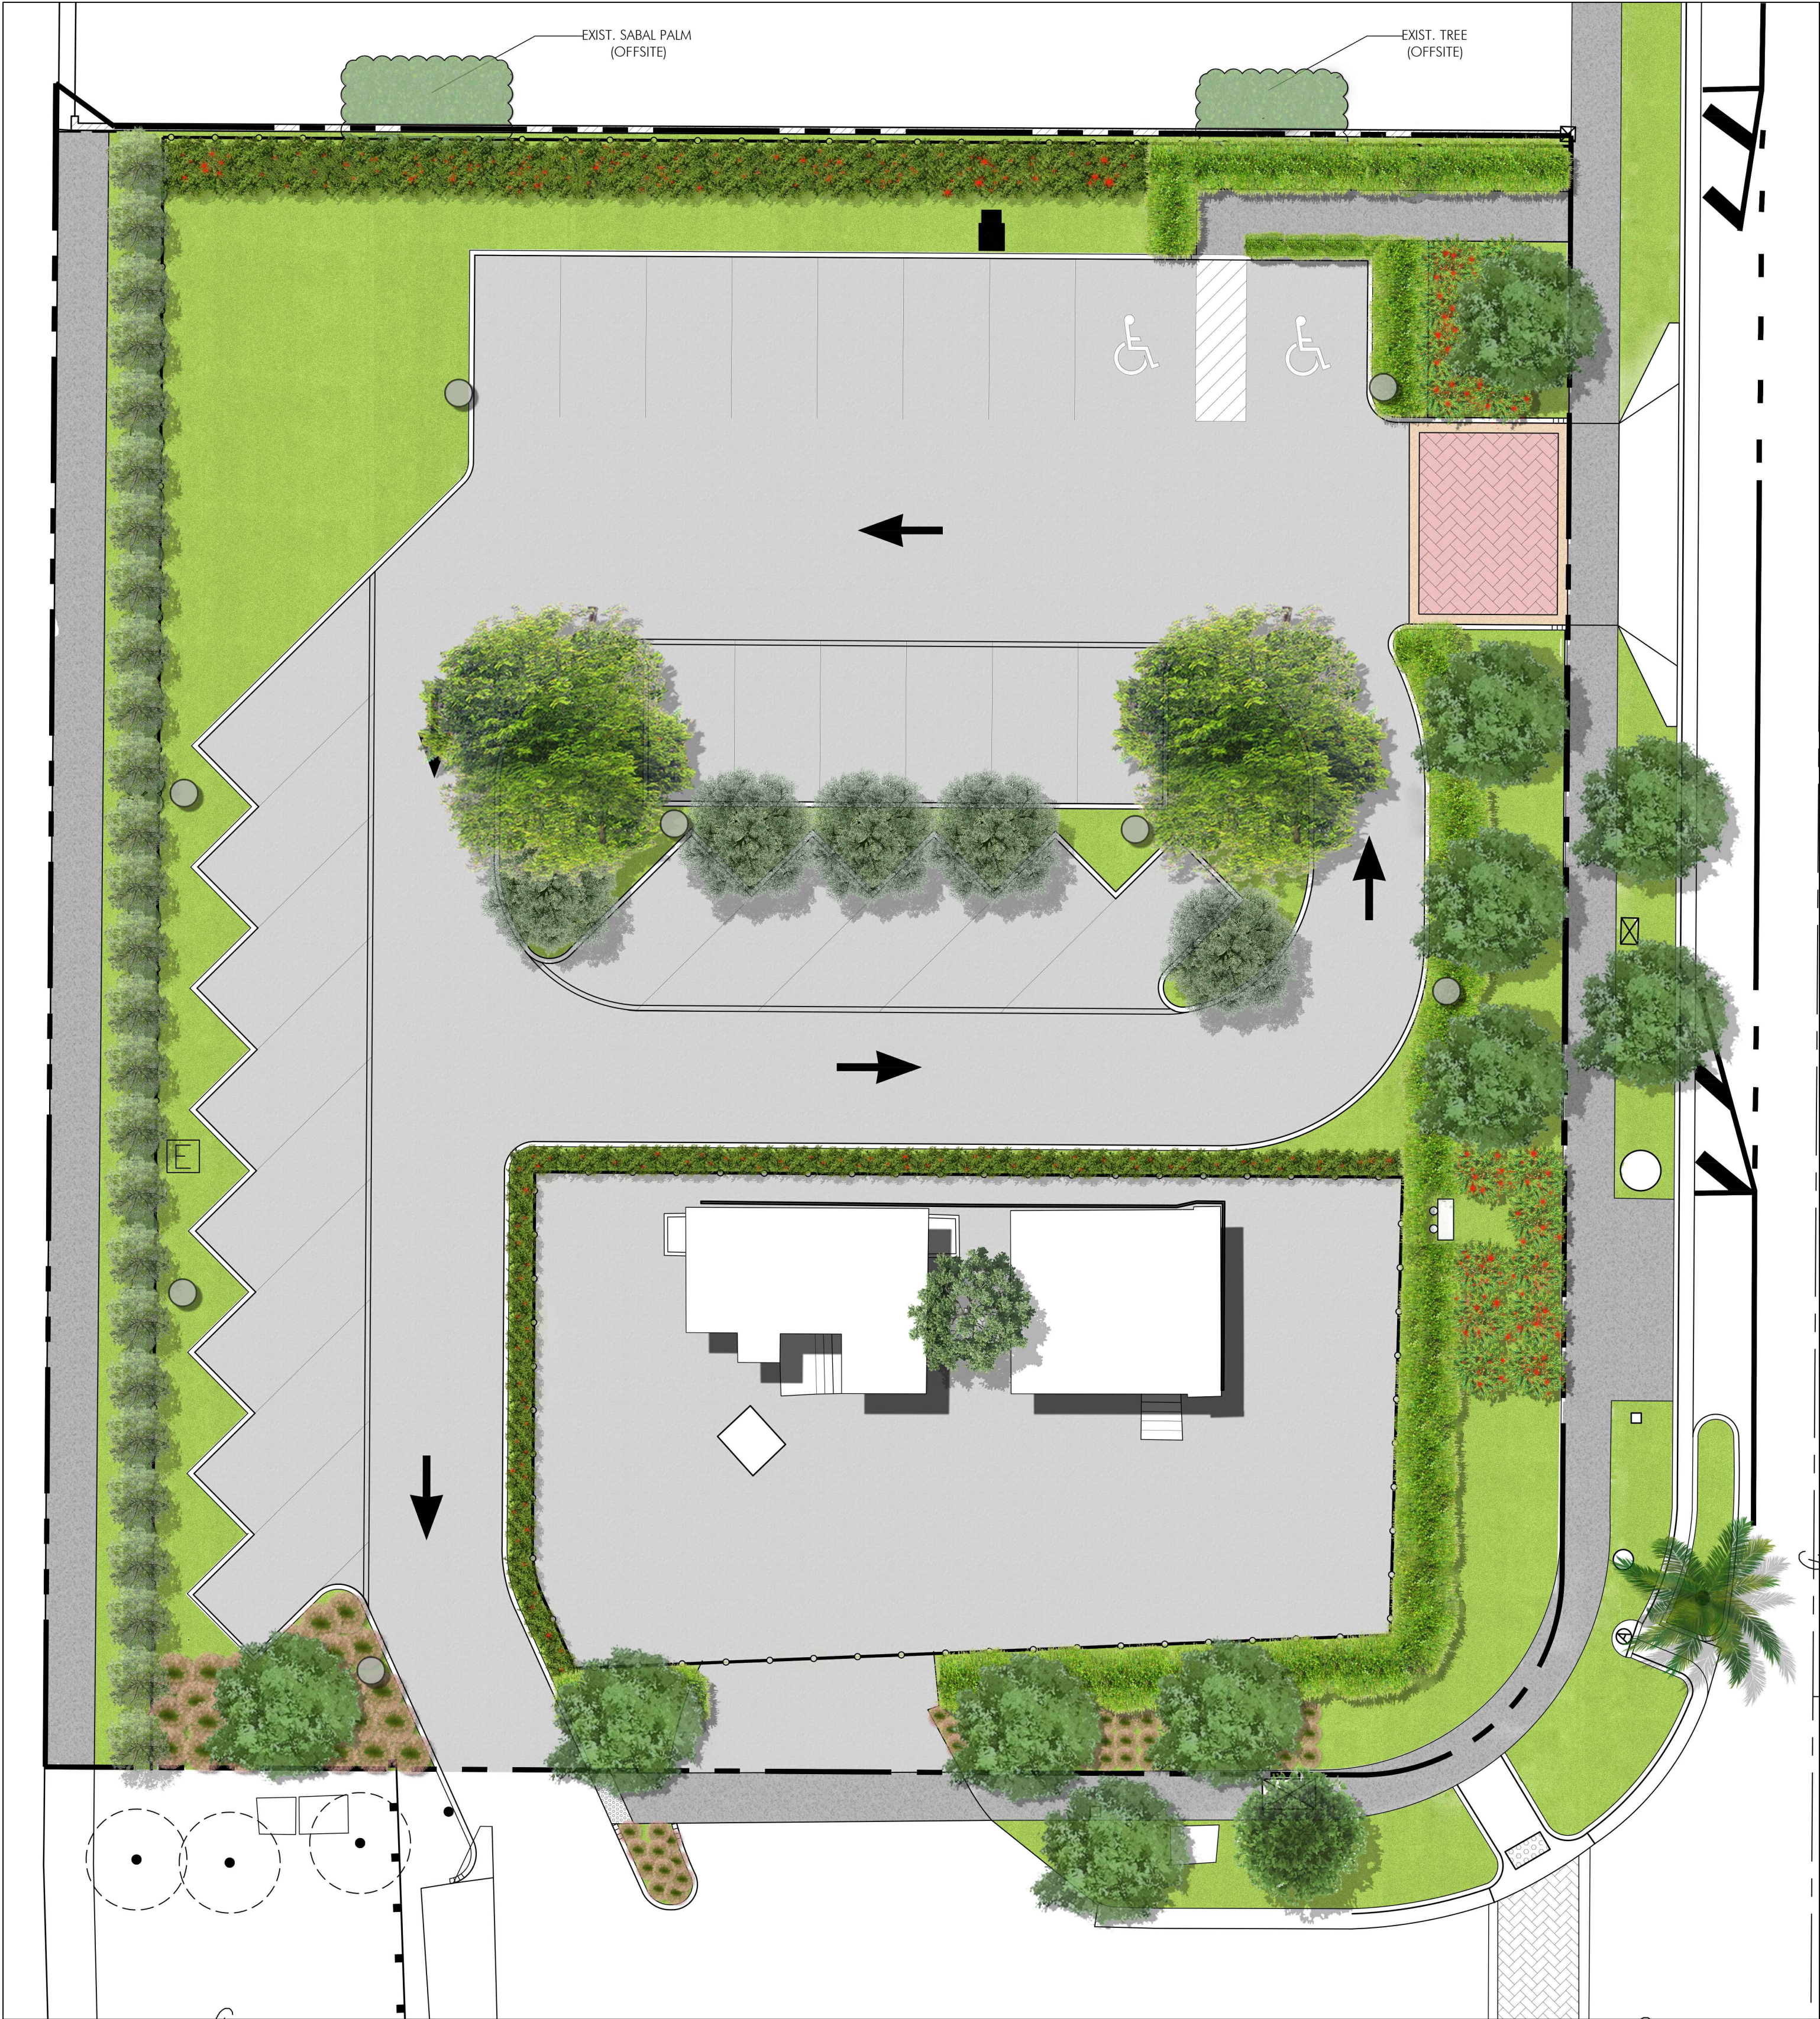
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PLAN RENDERING

SCALE: N.T.S.

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L-4




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MIAMI BEACH
CAPITAL IMPROVEMENT PROJECTS

CITY MANAGER: JIMMY L. MORALES
PW DIRECTOR: ROY COOLEY, P.E.
CIP DIRECTOR: DAVID MARTINEZ, P.E.
CITY ENGINEER: LUIS SOTO, P.E.

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LB#87 CA#87

3240 CORPORATE WAY
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No.	Date	Revision	App'd By
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NEIGHBORHOOD:
Surface Lot at Biscayne Beach - 8100 Hawthorne Avenue

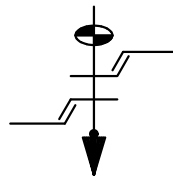TITLE:
Plan Rendering


DRB FINAL

ENG. OF RECORD: Ken Gardner
TITLE: President
ENGINEER No.: FL LA 1569
DRAWN BY: HM
CHECKED BY: KEG
SCALE: As Noted
FIELD BOOK: _____
PAGE: _____
PURCHASE ORDER: 20181531-00
FILE NAME: GS LA - SHEETS.dwg
ISSUE DATE: 08.03.18

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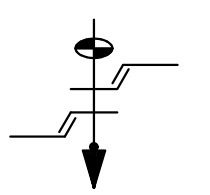
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MIAMIBEACH
CAPITAL IMPROVEMENT PROJECTS
PLANS CONSULTING CENTER 8001 BAYVIEW BLVD. MIAMI BEACH, FL 33154

CITY MANAGER: JIMMY L. MORALES
PW DIRECTOR: ROY COOLEY, P.E.
CIP DIRECTOR: DAVID MARTINEZ, P.E.
CITY ENGINEER: LUIS SOTO, P.E.

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LAND SURVEYORS
CIVIL ENGINEERS
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TEL: (305)652-7010
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NEIGHBORHOOD: Surface Lot at Biscayne Beach - 8100 Hawthorne Avenue	TITLE: Existing Tree Disposition Plan
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DRB FINAL

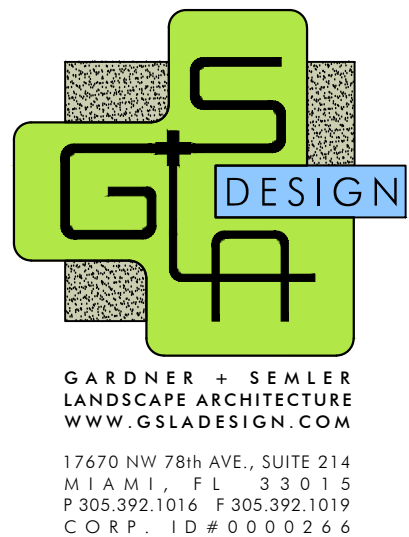ENG. OF RECORD: Ken Gardner
TITLE: President
ENGINEER No.: FL LA 1569
DRAWN BY: HM
CHECKED BY: KEG
SCALE: As Noted
FIELD BOOK: ---
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PLANNING AND DESIGN CENTER 8001 BAYVIEW BLVD. FL 33156

CITY MANAGER: JIMMY L. MORALES
PW DIRECTOR: ROY COOLEY, P.E.
CIP DIRECTOR: DAVID MARTINEZ, P.E.
CITY ENGINEER: LUIS SOTO, P.E.

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NEIGHBORHOOD:
Surface Lot at Biscayne Beach - 8100 Hawthorne Avenue

TITLE:
Perspective Drawing - Aerial View

DRB FINAL

ENG. OF RECORD: Ken Gardner
TITLE: President
ENGINEER No.: FL LA 1569
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