2499 NORTH MERIDIAN RESIDENCE

2499 N. MERIDIAN AVE., MIAMI BEACH FL. 33140



2499 NORTH MERIDIAN RESIDENCE - MIAMI BEACH, FLORIDA FINAL SUBMITTAL: NOV DRB (DRB18-0310) - DESIGN REVIEW BOARD

SCOPE OF WORK

- 1. DESCRIPTION OF WORK: NEW CONSTRUCTION 2 STORY SINGLE FAMILY RESIDENCE.
- 2. SCOPE OF WORK INCLUDES:
- 2.1 DEMOLITION OF EXISTING STRUCTURE.
- 2.2 NEW CONSTRUCTION 2 STORY SINGLE FAMILY RESIDENCE.

FINAL DRB SUBMITTAL DEADLINE DATE: 09/07/2018



PROJECT TITLE:

2499 N. MERIDIAN RESIDENCE

ISSUE DATE: SEPTEMBER 07, 2018 (FINAL SUBMITTAL: NOV DRB)

2499 N MERIDIAN AVE., MIAMI BEACH FL. 33140 FOLIO NUMBER: 02-3227-006-0460

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SCALE:	
DRAWN BY: YH/SW	
APPR BY:	
DATE:	

SHEET TITLE:


COVER SHEET

SHEET NO:

A0.0

THIS DRAWING IS PROPERTY OF HISW INTERNATIONAL AND MAY NOT

SKETCH of BOUNDARY SURVEY

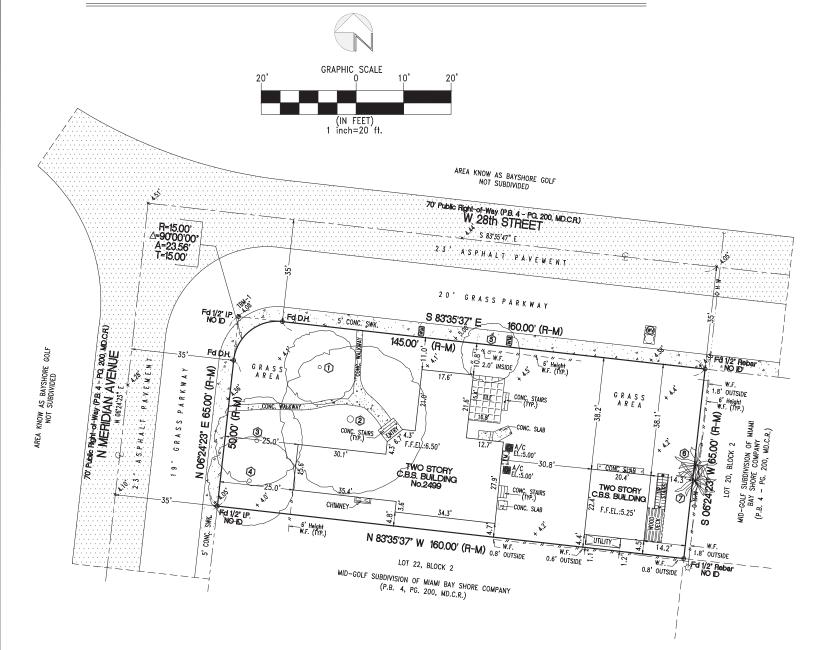

E	GEND	(SYM	MBOL)
/c	-ARC LENGTH DISTANCE -AIR CONDITIONING PAD	WM	-WATER MET
()	-CALCULATED	\Box	-FIRE HYDRA
B.S.	-CENTERLINE -CONCRETE BLOCK STUCCO	₩	-WATER VAL

-WATER METER

-FIRE HYDRANT

-WATER VALVE

-WOOD POLE

-ELECTRIC METER (on wall)

-EXISTING TREE

1 -TREE NUMBER

-EXISTING PALM

-CONCRETE CONC. SWK.-CONCRETE SIDEWALK -ELEVATION E.E.EL. -FINISH FLOOR FLEVATION

-FOUND NAIL Fd NAIL -FOUND DRILL HOLE Fd 1/2" IP -FOUND 1/2" IRON PIPE NO ID NO IDENTIFICATION -MEASURED

-MIAMI-DADE COUNTY RECORDS -OVERHEAD WIRES LINE P.B. -PLAT BOOK

-RADIUS -RECORD -TANGENT -TYPICAL

-TEMPORARY BENCHMARK ELEVATION W.F. -WOOD FENCE -INTERNAL ANGLE (DELTA) -FLEVATION ON PAVEMENT -FLEVATION ON GROUND

TREE LIST

No.	DIAMETER	<u>HEIGHT</u>	SPREAD	COMMON NAME	SCIENTIFIC NAME	CURRENT CONDITION
1	14.5"	25'	25'	LIVE OAK TREE	QUERCUS VIRGINIANA	DAMAGED BRANCHES-POOR STRUCTURE
2	28.5"	40'	50'	BLACK OLIVE	BUCIDA BUCERAS	FAIR-POOR STRUCTURE
3	25.5"	30'	30'	MAHOGANY	SWIETENIA MAHOGONI	FAIR-POOR FORM
4	23"	30'	30'	MAHOGANY	SWIETENIA MAHOGONI	DAMAGED BRANCHES-POOR FORM
5	14.5'&16"	25'	20'	AVOCADO	PERSEA AMERICANA	FAIR-POOR SHAPE
6	14"	20'	15'	SABAL PALM	SABAL PALMETTO	GOOD-EXCELLENT SHAPE
7	12.5"	20'	15'	SABAL PALM	SABAL PALMETTO	GOOD-EXCELLENT SHAPE

** TREE INFORMATION AND CLASSIFICATION, ACCORDING ARBORIST REPORT PREPARED BY: RAINER W. SCHAEL FL-5375 A, AND SENT BY THE

LEGAL DESCRIPTION

LOT 21, BLOCK 2, MID GOLF SUBDIVISION, ACCORDING TO THE PLAT THEREOF, AS RECORDED IN PLAT BOOK 4, AT PAGE 200, OF THE PUBLIC RECORDS OF MIAMI-DADE COUNTY, FLORIDA.



SURVEYOR REPORT and NOTES

- 1. THE LEGAL DESCRIPTION USED IN THE PREPARATION OF THIS SURVEY WERE FURNISHED BY THE CLIENT.
- 2. THERE MAY BE ADDITIONAL RESTRICTIONS THAT ARE NOT SHOWN ON THIS SURVEY THAT MAY BE FOUND IN THE PUBLIC RECORDS OF THIS COUNTY
- 3. THIS SKETCH OF BOUNDARY SURVEY WAS PREPARED IN ACCORDANCE WITH CURRENT STANDARDS OF PRACTICE SET FORTH BY THE FLORIDA STATE BOARD OF PROFESSIONAL SURVEYORS AND MAPPERS, PURSUANT TO RULE 5J-17 OF THE FLORIDA ADMINISTRATIVE CODE AND ITS IMPLEMENTING LAW, CHAPTER 472.027 OF THE FLORIDA STATUTES.
- 4. THE ACCURACY OBTAINED FOR ALL HORIZONTAL CONTROL MEASUREMENTS AND OFFICE CALCULATIONS OF CLOSED GEOMETRIC FIGURES. MEETS OR EXCEEDS THE CURRENT STANDARDS OF PRACTICE SET FORTH BY THE FLORIDA BOARD OF PROFESSIONAL SURVEYORS AND MAPPERS AS CONTAINED IN CHAPTER 5J-17.051(3)(b), 15.b.II OF 1 FOOT IN 7,500 FEET FOR SUBURBAN AREAS.
- 5. THE SURVEY MAP IS INTENDED TO BE DISPLAYED AT THE STATED GRAPHIC SCALES IN US SURVEY FOOT OF MEASUREMENT AS DEPICTED ON THE SURVEY MAP ATTENTION IS DIRECTED TO THE FACT THAT SAID SURVEY MAP MAY BE ALTERED IN SCALE BY REPRODUCTION AND MUST BE CONSIDERED WHEN OBTAINING SCALED DATA.
- 6. NOT VALID WITHOUT THE SIGNATURE AND ORIGINAL RAISED SEAL OF A FLORIDA LICENSED SURVEYOR AND MAPPER. ADDITIONS OR DELETIONS TO SURVEY MAPS AND REPORTS BY OTHER THAN THE SIGNING PARTY OR PARTIES ARE PROHIBITED WITHOUT THE WRITTEN CONSENT OF THE SIGNING PARTY OR PARTIES.
- 7. THE RECORD DESCRIPTION OF THE SUBJECT PROPERTY FORMS A MATHEMATICALLY CLOSED FIGURE.
- 8. UNLESS OTHERWISE NOTED. THIS SURVEY HAS NOT ATTEMPTED TO LOCATE ANY FOOTING AND/OR UNDERGROUND UTILITIES ON AND/OR ADJACENT TO THE PROPERTY.
- 9. THE LEGAL OWNERSHIP OF THE FENCES AND/OR WALLS (IF ANY) WAS NOT DETERMINED, AND THE LOCATIONS SHOWN HEREON ARE BASED, ON THE RECOVERED BOUNDARY MONUMENTATION.
- 10. BUILDING DIMENSIONS AND BUILDING SETBACKS SHOWN HEREON AS BEING ROUNDED TO THE NEAREST ONE-TENTH (0.1') OF A FOOT
- 11. BEARINGS SHOWN HEREON ARE RELATIVE TO THE STATE PLANE COORDINATE SYSTEM, FLORIDA EAST ZONE (0901), NORTH AMERICAN DATUM (N.A.D.) OF 1983, ADJUSTMENT OF 2011 (N.A.D. 83/2011) EPOCH 2010.0000; WITH A BEARING OF N 06°24'23" E, BEING ESTABLISHED FOR THE CENTERLINE OF N MERIDIAN AVENUE.
- 12. THIS SURVEY HAS BEEN PREPARED FOR THE EXCLUSIVE USE OF THE ENTITIES NAMED HEREON.
- 13. THE FINISH FLOOR FLEVATIONS WERE TAKEN AT THE EXISTING DOORS FROM THE OUTSIDE OF THE BUILDING. AS
- 14. THE SUBJECT PROPERTY CONTAINS 10,351.7 SQUARE FEET OR 0.238 ACRES MORE OR LESS.

ELEVATIONS SHOWN HEREON ARE RELATIVE TO THE 1929 N.G.V.D. OF MEAN SEA LEVEL AND ARE BASED ON A BENCHMARK SUPPLIED BY THE ENGINEERING DEPARTMENT OF MIAMI-DADE COUNTY, FLORIDA.

BENCHMARK: D-182 (PK NAIL AND ALUMINUM WASHER SET ON CONC FLOW OF CATCH BASIN). MERIDIAN AVE --- 20' EAST OF C/L

W 23 ST --- 36' SOUTH OF C/L

ELEVATION(NGVD29): 3.42 (In Feet)
FOR TBM INFORMATION SEE SKETCH OF SURVEY. ELEVATION(NAVD88): 1.87 (In Feet) LOCATOR: 4325 W.

(FLOOD INFORMATION

THE SUBJECT PROPERTY LIES WITHIN A FLOOD HAZARD HAVING A FLOOD DESIGNATION OF AF. WITH A BASE FLOOD ELEVATION: 8.0, PURSUANT TO THE FLOOD INSURANCE RATE MAPS PUBLISHED BY THE UNITED STATES FEDERAL EMERGENCY MANAGEMENT AGENCY UNDER COMMUNITY No: 120651 (CITY OF MIAMI BEACH) AND PANEL NUMBER: 0317, SUFFIX: L. AS LAST REVISED IN SEPTEMBER 11, 2009.

SURVEYOR'S CERTIFICATION

I HEREBY CERTIFY THAT THIS "SKETCH OF BOUNDARY SURVEY" WAS PREPARED UNDER MY DIRECT SUPERVISION AND THAT IT IS TRUE AND CORRECT TO THE BEST OF MY KNOWLEDGE AND BELIEF.

Fréncisco L: Nunez Jr.
PROFESSIONAL SURVEYOR AND MAPPER No.6382
STAFFOR FLADINA

desin_roup SURVEYORS MAPPERS | LAND PLANNERS (305) 551-8511 (786) 877-7176 bmdesigngroup@gmail.com BOUNDARY SURVEY With ELEVATIONS (TREES LOCATION-CMB GRADE) MIAMI AVENUE, MERIDIAN z As shown ВМ hecked By ield Date: July 20/2018

rawn Date: July 23/2018 F.B./PG.: FILE/RAC-RM repared for:

Project No.: 18-4799

NOT VALID WITHOUT THE ORIGINAL RAISED SEAL OF A FLORIDA SURVEYOR AND MAPPER

TABLE OF CONTENTS

COVER SHEET

LOCATION MAP, ZONIN CHART & DRAWING SCHEDULE A0.1

A0.2 NARRATIVE RESPONSE SHEET

A0.3 **EXISTIN SITE CONTEXT (1)**

A0.4 **EXISTIN SITE CONTEXT (2)**

A0.5 NEIGHBORHOOD CONTEXT

A0.5A CONTEXT PHOTOMONTAGE

EXISTING LOT COVERAGE & UNIT SIZE A0.6

A0.7 DEMOLITION PLAN

A0.8 LOT COVERAGE & OPEN SPACE DATA

A0.9 **UNIT SIZE DATA**

A0.10 AXONOMETRIC DIAGRAM & WAIVER DIAGRAM

WAIVER DIAGRAM-SIDE ELEVATION ADDITIONAL OPEN SPA A0.11

WAIVER DIAGRAM-ROOF DECK SETBACK A0.12

ARCHITECTURAL

A2.0 PROPOSED SITE PLAN

A2.1 PROPOSED GROUND FLOOR PLAN

A2.2 PROPOSED FIRST FLOOR PLAN

A2.3 PROPOSED ROOF PLAN

A3.1 PROPOSED MAIN HOUSE NORTH ELEVATION

A3.2 PROPOSED MAIN HOUSE WEST ELEVATION

A3.3 PROPOSED MAIN HOUSE SOUTH ELEVATION

A3.4 PROPOSED MAIN HOUSE EAST ELEVATION

PROPOSED SITE SECTION A A4.1

PROPOSED SECTION A (ENLARGED) A4.1A

PROPOSED SECTION A (ENLARGED) A4.1B

A4.2 PROPOSED SITE SECTION B

A4.2A PROPOSED SECTION B (ENLARGED)

A4.2B PROPOSED SECTION B (ENLARGED)

A4.3 PROPOSED SECTION C

A4.4 PROPOSED SECTION D

A4.5 PROPOSED SECTION E

A10.1 RENDERING-FRONT VIEW

A10.2 RENDERING-FRONT VIEW

A10.3 RENDERING-SIDE VIEW

RENDERING-REAR VIEW A10.4

A10.5 RENDERING-PERSPECTIVE VIEW

LANDSCAPE

LA1.01 EXISTING TREE DISPOSITION PLAN

LA2.01 PLANTING PLAN

LA3.01 PLANTING SPECS AND DETAILS

HARDSCAPE PLAN L0-1

ZONING DATA

PROJECT DESCRIPTION: NEW CONSTRUCTION-SINGLE FAMILY MUNICIPALITY: MIAMI BEACH STREET ADDRESS: 2499 N. MERIDIAN AVENUE, MIAMI BEACH,


FL33140-3402 FOLIO NUMBER: 02-3227-006-0460

ZONING DISTRICT: RS-3 FEMA ZONE:AE BFE: 8' NGVD

LEGAL DESCRIPTION:

MID GOLF SUB PB 4-200 LOT 21 BLK 2 LOT SIZE 65.000 X 160 OR 19357-3007 10 2000 5 COC 25290-2315 01 2007 5

CODE OD ORDINANCE' REFERENCES: LOT AREA: 142-105 MINIMUM LOT WIDTH: 104-105 GROSS BUILDING AREA: 142-105 LOT COVERAGE 142-105 BUILDING HEIGHT: 54-35 BUILDING SET BACK: 142-106 FENCE HEIGHT: 142-1132 POOL SETBACK: 142-1133 PROJECTIONS: 142-1132, 142-105 OTHER DIMENSIONAL REQUIREMENTS: 142-105

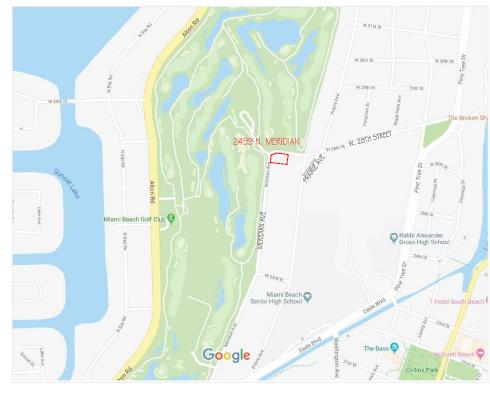

* FOR NARRATIVE REPONSE SHEET, SEE





SINGLE FAMILY RESIDENTIAL - ZONING DATA SHEET

ITEM #	Zoning Information				
1	Address:	2499 N MERIDIAN A	2499 N MERIDIAN AVE		
2	Folio number(s):	02-3227-006-0460			
3	Board and file numbers :	N/A			
4	Year built:	1928	Zoning District:	RS-3	
5	Based Flood Elevation:	8' NGVD	Grade value in NGVD:	4.36' NGVD	
6	Adjusted grade (Flood+Grade/2):	8'+4.36'/2=6.18'	Free board:	1'-0"	
7	Lot Area:	10,351.7 SF			
8	Lot width:	65 Ft.	Lot Depth:	160 Ft.	
9	Max Lot Coverage SF and %:	3,105 SF (30%)	Proposed Lot Coverage SF and %:	3,055 SF (29.5%)	
10	Existing Lot Coverage SF and %:	2,378 SF (22.9%)	Lot coverage deducted (garage-storage) SF:	271 SF (GARAGE)	
11	Front Yard Open Space SF and %:	1,112 SF (88.8%)	Rear Yard Open Space SF and %:	1,093 SF (70.06%)	
12	Max Unit Size SF and %:	5,175 Sq.Ft. (50%)	Proposed Unit Size SF and %:	5,174Sq.Ft. (49.99%)	
13	Existing First Floor Unit Size:	N/A	Proposed First Floor Unit Size:	2,932 Sq.Ft. (28.3%)	
14	Existing Second Floor Unit Size	N/A	Proposed Second Floor volumetric Unit Size SF and % (Note: to exceed 70% of the first floor of the main home require DRB Approval)	2,187 SF (74.5% OF FIRST FLOOR)	
15			Proposed Second Floor Unit Size SF and %:	2,187 SF (74.5%)	
16			Proposed Roof Deck Area SF and % (Note: Maximum is 25% of the enclosed floor area immediately below):	335 SF (15.3 %)	

		Required	Existing	Proposed	Deficiencies
17	Height:	24 Ft.	N/A	24 Ft.	
18	Setbacks:				
19	Front First level:	30 Ft.	25 Ft.	30 Ft.	
20	Front Second level:	30 Ft.	N/A	30 Ft.	
21	Side 1:	10 Ft.	4.8 Ft.	10 Ft.	
22	Side 2 or (facing street):	15 Ft.	11 Ft.	15 Ft.	
23	Rear:	24 Ft.	65.5 Ft.	24 Ft.	
	Accessory Structure Side 1:	10 Ft.	4.4 Ft.	24.8 Ft.	
24	Accessory Structure Side 2 or (facing street):	15 Ft.	38.1 Ft.	20 Ft.	
25	Accessory Structure Rear:	7.5 Ft.	14.2 Ft.	7.5 Ft.	
26	Sum of Side yard :	25 Ft.	15.8 Ft.	25 Ft.	
27	Located within a Local Historic District?			NO	
28	Designated as an individual Historic Single Family Residence Site?			NO	
29	Determined to be Architecturally Significant		NO		

Notes:

If not applicable write N/A

All other data information should be presented like the above format

YIMING HO

DRAWING NO. A0.2



H&W INTERNATIONAL

419 NE 19TH ST. APT 501 MIAMI. FL. 33132 P. 786.253.6013

2499 N. MERIDIAN RESIDENCE

2499 N MERIDIAN AVE., MIAMI BEACH FL. 33140 ISSUE DATE: SEPTEMBER 07, 2018 (FINAL SUBMITTAL: NOV DRB)

REVISIONS:	
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PROJECT N.: HW4-10 SEAL: SCALE: DRAWN BY: YH/SW APPR BY: DATE:

LOCATION MAP, ZONING CHART & DRAWIG SCHEDULE

SHEET NO:

A0.1

MIAMIBEACH

PLANNING DEPARTMENT

Staff First Submittal Review Comments Design Review Board

SUBJECT: Comments Issued:

Final CAP/PAPER Submittal: Notice to Proceed: Tentative Board Meeting Date:

DRB18-0310 | 2499 North Meridian Avenue 08/31/18 | 08/29/18 JGM IV FSC

> 1:00 PM on 09/07 09/17/18 11/06/18

PERTINENT INFO

The CAP <u>and</u> Paper Final submittal deadline is 1:00 PM on 09/07/18 for the NOVEMBER 06, 2018 meeting.

- Fifteen (15) 11x17 drawing sets (in color) labeled Final Submittal, including one (1) original set of 11x17 architectural plans dated, signed and sealed.
- A cd/dvd containing a digital version of the documents and plans submitted. The CD must be in the proper format specified by the Planning Department.
- All other associated fees due 09/19/18

NOTE: <u>Application</u> may still move forward for NOVEMBER, but recommended to resubmit for DECEMBER using deadlines: DEC First Submittal Deadline: 09/17/2018 | DEC Final Submittal Deadline: 10/05/2018

This is based on the amount of application deficiencies found within the submittal and overall number of applicants that have applied for the NOVEMEBR DRB meeting. Please note that only complete applications are scheduled for consideration by Land Use Boards and the number of applications placed on an agenda may not exceed 15 in order to allow sufficient time for the applicants to present, and the board to duly consider each item during the scheduled meeting.

DRAFT NOTICE:

DRB18-0310 2499 North Meridian Avenue. The applicant, Harriet L Feuerman TRS, is requesting Design Review Approval for the construction of a new two-story single-family residence to replace an existing two-story architecturally significant pre-1942 residence including one or more waivers, and variances to exceed the maximum height elevation of encroachments within required yards and to exceed the maximum building height.

1. APPLICATION COMMENTS

- a. Applicant is owner of land/not permit expediter, HARRIET L FEUERMAN TRS?
- b. Use updated application
- Refer to CAP system for additional Application comments.

2. DEFICIENCIES IN ARCHITECTURAL PRESENTATION

- a. Applicant is encouraged to provide rendered images of proposal to abutting properties.
 A/: please see sheet A0.5A
- b. Survey not legible. DO not place survey within title block of architecture firm. Survey: Missing CMB Grade (cl of sidewalk along Meridian property line), Missing Lot area.
 - A/: Please see Survey sheet. Sidewalk grade @4.36' marked on Meridian Ave. Lot area: 13,351.7 square feet (line 14 of survey note).
- c. A4.1 and A4.2 Sections. Separate and enlarge. Revise include a mini plan of where section is taken; include all property lines; include setback lines (red dashed lines); include standard elevation datum marks on BOTH sides of elevation (in NGVD: IDENTIFY CMB Grade,

Adjusted Grade, BFE, FFE, 30" above Adjusted Grade), include overall height of roof elements; include projection distances into required yards. Increase size of measurements.

A/: Please see sections sheets. In order to enlarge we must divide the sections in different sheets. Elevation datum revised as per request in this line.

- d. A10.0 and A10.1 Separate rendered elevations one to page, include mini plan of where elevation is taken, include property lines, include material legend.
 - A/: revised as per request.
- e. Missing waiver diagrams
 - A/: please see sheet A0.10 for 70% second /ground floor ratio waiver diagram.

 Please see sheet A0.11 for side elevation open space waiver diagram.

 Please see sheet A0.12 for roof deck waiver diagram.
- f. Missing contour plan

A/: Currently we are not involved with any engineering consultant as engineering design is not part of the list of documents or drawings to present for DRB process.

- g. Add "FINAL SUBMITTAL: NOV DRB" to front cover title for heightened clarity of reference for next deadline.
 - A/: "Final Submital: Nov DRB" note added in cover sheet and all sheets of the set.
- h. Add narrative response sheet.
 - A/: Please see sheet A0.02

i. ZONING/VARIANCE COMMENTS

- V #1 Pool deck 8.66 in rear and side yard. Max elevation is 6.850
- V #2 Rear yard open space does not meet 1138SF.
- V #3 Height 1'-0 variance
- a. Survey is not clear in electronic file or when printed in 11x17 format. Revise survey. Grade is not clear.
 - A/: Survey revised.
- b. Higher roof on the family room area cannot exceed 18'-0" in height from finish floor elevation to count as a one-story volume. Provide elevation of the roof on section drawings.
 - A/: please see elevation datum in Elevation and Sections sheets A3.3; A3.4; A4.2; A4.4. Family room top of slab is 15.83' from freeboard (24.83' NGVD, 8'BFE + 1' FREEBORD + 15.83'=24.83')
- c. The maximum building height allowed is 24'-0" from BFE+ freeboard. A 1-foot roof curb is allowed. The higher ceiling/roof above 24' shall be reduced or request a variance.
 A/: building height revised. Rood deck F.F.E. is 24' from freeboard (33' NGVD, 8'BFE + 1'
- d. Maximum height of the garage building is 12'-0" from adjusted grade. Indicate height on garage elevation/section.
 - A:/ Please see elevation and sections elevation datum for garage. Maxim garage height 12' from adjusted grade (18.18' NGVD).
- e. Fence height is measured from grade elevation (elevation of the sidewalk at the center of the property). Plans indicate grade and elevation of the sidewalk shall be the same number. See section c, page A4.2.
 - A/: Fence in all elevations and sections revised to 5° from grade. Grade is 4.36° NGVD as per survey elevation datum on the walkway on Meridian Ave.
- f. Revise title of drawing on page A2.2 to be second floor plan.

FREEBORD + 24'= 33'), please see elevations and sections.

A/: Title of drawing revised, please see sheet A2.2

- g. Cantilevered balcony on the southeast side exceeds 6'-0". Portion exceeding 6'-0" (4'-0") counts in unit size. To be considered as part of a covered terrace, allowed up to 10' in length, the slab shall have supporting elements at the ground floor.
 - A/: column supporting slab for covered terrace added on the southeast point. Please see ground floor plan in sheet A2.1
- h. Calculations of open space in the rear yard are applicable only in the required rear yard (24'-0" X 65'-0"). It appears that the project does not comply with the required open space. Revise open space calculations or request a variance.
 - A/: Rear setback revised to 24'-00" from 25'-00", pool length has been shorten and now green space area meets the required 70% of the rear yard. Please see A0.8.
- The proposed roof deck complies with the 10'-0" setback requirements from the side exterior walls.
 - A/: Ok and thank you.
- j. Maximum elevation for the portions of the pool retaining walls encroaching on the side and rear yard is 6.86' NGVD (maximum yard elevation allowed). Proposed: 8.66' NGVD. Reduce height of pool or 2 variances are required.
 - A/: Pool retaining walls revised to 6.86' NGVD (maximum yard elevation allowed) as well as the pool deck level, please see sheet A2.1
- k. If variances are requested, revise letter of intent to indicate type and number of variances. Clearly explain how the variances satisfy the practical difficulties criteria on section 118-353 (d) of the City Code. Please note that staff will not be supportive of variances associated with the design of the home.
 - A/: no variance has been requested for this project.
- 1. Provide a narrative responding to staff comments.
 - A/: please see sheet A0.2

4. DESIGN/APPROPRIATENESS COMMENTS

- a. Waiver #1: 70% second floor ratio
- b. Waiver #2: Open Space waiver. North elevation (street side)
- c. Garage height issue: garage should be removed from required rear yard plans, as its minimum clearance height is at conflict with accessory structures' maximum height. Garage should be eliminated or relocated to front or side of structure. OR redesign as accessory structure and count towards unit size.
 - A/: Garage height is set @ 18.18' NGVD, 12' from Adjusted Grade (6.18' NGVD) and ceiling of the garage is 17.01' NGVD meeting the requirement of MIN. 17' garage ceiling height. The garage is set back 5' from main façade and garage area is 271 SF., Therefore garage area is not included in the area calculations. Please see A08; A09; Elevations and Sections
- d. Walkway width
 - A/: Main walkway accessing the residence on 28th street revised and reduced to 5'. Please see A2.1

5. LANDSCAPE COMMENTS

a. Refer to CAP system for Landscape comments.

These comments have been provided as a preliminary review of the documents and plans submitted and are subject to additions and/or deletions pending further review.

H&W INTERNATIONAL

419 NE 19TH ST. APT 501 MIAMI. FL. 33132 P. 786 253 6013 ROJECT TITLE:

2499 N. MERIDIAN RESIDENCE

2499 N MERIDIAN AVE., MIAMI BEACH FL. 33140 FOLIO NUMBER: 02-3227-006-0460 ISSUE DATE: SEPTEMBER 07, 2018 (FINAL SUBMITTAL: NOV DRB)

REVISIONS

PROJECT N. : HW4-10 SE
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DRAWN BY: YH/SW
APPR BY:
DATE:

SHEET TITLE:

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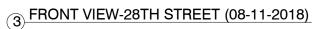
NARRATIVE RESPONSE SHEET

A0.2

SHEET NO:

HIS DRAWING IS PROPERTY OF HISW INTERNATIONAL AND MAY NOT BE IEPRODUCED IN WHOLE OR PART, WITHOUT PERMISSION OF HISW INT.







(2) FRONT CORNER VIEW (08-11-2018)




1 FRONT VIEW-MERIDIAN AVE (08-11-2018)



(4) FRONT VIEW- 28TH STREET (08-11-2018)



<u>5</u> REAR VIEW (08-11-2018)

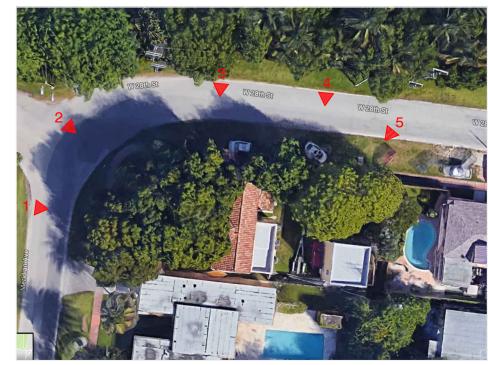

KEY PLAN (08-11-2018)



ROJECT TITLE:

2499 N. MERIDIAN RESIDENCE

2499 N MERIDIAN AVE., MIAMI BEACH FL. 33140 FOLIO NUMBER: 02-3227-006-0460

FOLIO NUMBER: 02:3227-006-0460

ISSUE DATE: SEPTEMBER 07, 2018 (FINAL SUBMITTAL: NOV DRB)

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PROJECT N. : HW4-10 SEAL:

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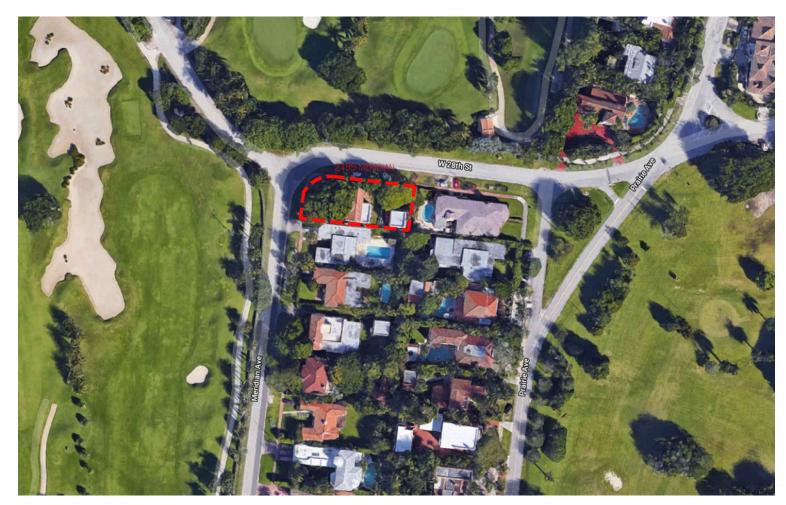
SHEET TITLE

EXISTING SITE CONTEXT (1)

SHEET NO:

AO.3





1 AERIAL VIEW

② SKY VIEW

PROJECT TITLE:

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2499 N MERIDIAN AVE., MIAMI BEACH FL. 33140 FOLIO NUMBER: 02-3227-006-0460 ISSUE DATE: SEPTEMBER 07, 2018 (FINAL SUBMITTAL: NOV DRB) A _______

PROJECT N.: HW4-10

SCALE:

DRAWN BY: YH/SW

APPR BY:

DATE:

SHEET TITLE:

EXISTING SITE CONTEXT (2)

SHEET NO:

A0.4

S DRAWING IS PROPERTY OF HISW INTERNATIONAL AND MAY NOT E





2: 2485 N MERIDIAN AVE





1 KEY PLAN





6: 2502 PRARIE AVE



5: 2499 N MERIDIAN AVE



4: 2491 N MERIDIAN AVE



ROJECT TITLE:

2499 N. MERIDIAN RESIDENCE

2499 N MERIDIAN AVE., MIAMI BEACH FL. 33140 FOLIO NUMBER: 02-3227-006-0460

FOLIO NUMBER: 02-3227-006-0460

ISSUE DATE: SEPTEMBER 07, 2018 (FINAL SUBMITTAL: NOV DRB)

<u>^</u>

PROJECT N.: HW4-10
SCALE:
DRAWN BY: YH/SW
APPR BY:
DATE:

SEAL:

SHEET TITL

NEIGHBORHOOD CONTEXT

SHEET NO:

A0.5

S DRAWING IS PROPERTY OF HISW INTERNATIONAL AND MAY NOT E

N. MERIDIAN AVE SIDE



EXISTING



PROPOSED

28TH STREET SIDE



EXISTING



PROPOSED

H&W INTERNATIONAL

2499 N. MERIDIAN RESIDENCE

ISSUE DATE: SEPTEMBER 07, 2018 (FINAL SUBMITTAL: NOV DRB)

REVISI	ONS:		
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PROJECT N : HW4-10	SE
SCALE:	
DRAWN BY: YH/SW	
APPR BY:	
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YIMING HO AR99574

CONTEXT PHTOMONTAGE

SHEET NO:

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28TH STREET LAWN LAWN CONC. DECK 65.00, NORTH MERIDIAN AVENUE CONC. WALKWAY PROPERTY LINE CONC. DECK TWO STORY C.B.S. BUILDING TWO STORY C.B.S. BUILDING LAWN MOODEN DECK CONC. DECK PROPERTY LINE 160.00' <u>IOT COVERAGE & UNIT SIZE</u> LOT SIZE =10,351 SF LOT COVERAGE =2,378 SF (22.9%) UNIT SIZE =3,392 SF EXISTING LOT COVERAGE & UNIT SIZE SCALE: 3/32" = 1'-0" SHEET NO: REVISIONS: PROJECT N.: HW4-10 SEAL: **H&W INTERNATIONAL** SCALE: 2499 N. MERIDIAN RESIDENCE A0.6 **EXISTING LOT COVERAGE & UNIT SIZE** 419 NE 19TH ST. APT 501 DRAWN BY: YH/SW 2499 N MERIDIAN AVE., MIAMI BEACH FL. 33140 MIAMI. FL. 33132 APPR BY: YIMING HO AR99574 ISSUE DATE: SEPTEMBER 07, 2018 (FINAL SUBMITTAL: NOV DRB) DATE:

28TH STREET EXISTING STRUCTURE TO BE DEMOLISHED LAWN LAWN EXISTING CONCRETE WALKWAY TO BE REMOVED EXISTING CONCRETE SLAB & STAIRS TO BE EXISTING STRUCTURE TO NORTH MERIDIAN AVENUE DEMOLISHED BE DEMOLISHED EXISTING CONCRETE SLAB TO BE DEMOLISHED EXISTING CONCRETE SLAB & STAIRS TO BE EXISTING UTILITY TO BE DEMOLISHED REMOVED TWO STORY C.B.S. BUILDING TWOSTORY EXISTING C.B.S. BUILDING WOODEN LAWN DECK 4 EXISTING CONCRETE STAIRS TO SLAB & STAIRS TO BE DEMOLISHED DEMOLISHED EXISTING CHIMNEY TO BE DEMOLISHED EXISTING UTILITY TO BE REMOVED

① DEMOLITION PLAN SCALE: 3/32" = 1'-0"



FROJECT TITLE.	TIEVISIONS.	
2499 N. MERIDIAN RESIDENCE 2499 N MERIDIAN AVE., MIAMI BEACH FL. 33140		
FOLIO NUMBER: 02-3227-006-0460	<u>/3\</u>	
ISSUE DATE: SEPTEMBER 07, 2018 (FINAL SUBMITTAL: NOV DRB)	<u>4</u>	

DEMISIONS:


PROJECT N.: HW4-10	SEAL:
SCALE:	
DRAWN BY: YH/SW	
APPR BY:	
DATE:	

DEMOLITION PLAN

SHEET TITLE:

YIMING HO AR99574

SHEET NO: A0.7

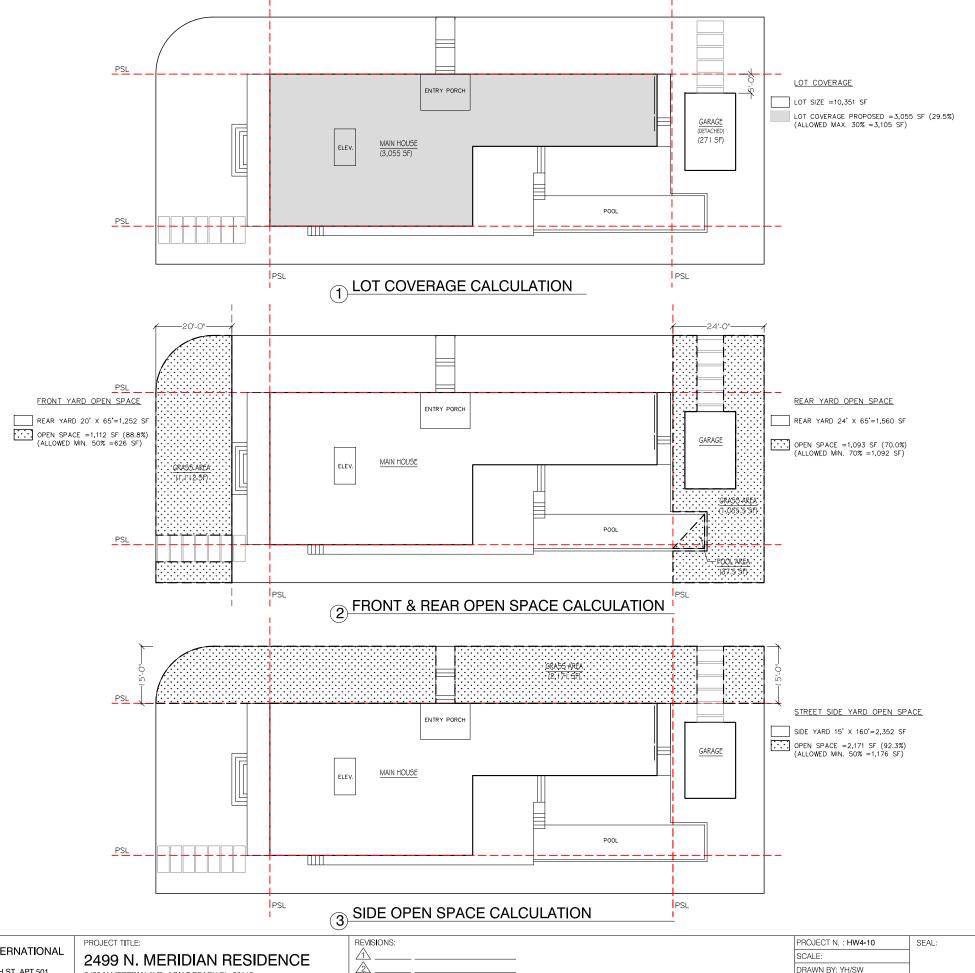

2499 N MERIDIAN AVENUE ZONING & BUILDING DATA				
ZONING DISTRICT:	Municipal Code, RS3			
PROPOSED USE:	NEW SINGLE RESIDENTIAL HOME			
GROSS LOT AREA:	65' (Lot Width) x 160'			
SETBACKS:		Allowed	Proposed	
	Front:	30 Feet	30 Feet	
	North Side:	15 Feet	15 Feet	
	South Side:	10 Feet	10 Feet	
	Rear:	24 Feet (25% of lot depth)	24 Feet	
LOT COVERAGE AREA:	ALLOWED: 30% OF 10,351 SF (G	GROSS LOT AREA) = 3,105 SF	Proposed	
	MAIN BUILING LOT ((DETACHED GARAG	COVERAGE: SE: 271 SF IS NOT APPLICABLE)	3,055 SF (29.5%)	
UNIT SIZE AREA:	ALLOWED: 50% OF	10,351 SF (GROSS LOT AREA) = 5,7	175 SF	
l 7777		, , , , , , , , , , , , , , , , , , , ,	Proposed	
	GROUND FL		2,932 SF	
	2ND FL		2,187 SF	
	ROOF (ELEVATOR)		55 SF	
	TOTAL:	5,174 SF(100%)		
	2nd FL to GROUND I	2,187 / 2,932 =74.6% * REQUIRING WAIVER		
OPEN SPACE:	REQUIRED: MIN. 50% OF 20' FRONT AREA MIN. 70% OF 24' REAR AREA		Proposed	
	Front Yard: 1,252 X 50	1,112 SF (88.8%)		
	Rear Yard: 1,560X 70	1,093SF (70.06%)		
	Slde Yard (Street): 2,352 X 50% =1,176 SF		2,171 SF (92.3%)	
ROOF DECK	MAXIMUM ALLOWED 25% OF THE ENCLOSED FLOOR AREA IMMEDIATELY BELOW		Proposed	
	2,187 SF (2nd FL) x 2	25%= 547 SF	335 SF (15.3%)	
		CKS SHALL BE SETBACK A	FRONT: 22.25 FT	
	EXTERIOR OUTER W FRONT OR SIDE ELE	/ALLS, WHEN LOCATED ALONG A VATION, AND FROM THE REAR	NORTH SIDE: 10 FT	
	OR HPB MAY FOREG	SOUTH SIDE: 10 FT		
	SETBACK, IN ACCOR DESIGN REVIEW OR	RDANCE WITH THE APPLICABLE APPROPRIATENESS CRITERIA.	BACK: 0 FT *REQUIRING WAIVER	
		RES WHICH ARE OPEN ON ALL OWED 20% OF THE ENCLOSED IATELY BELOW		
	2,187 SF (2nd FL) x 2	20%= 437 SF.	55 SF (2.5%)	
HEIGHT:	24 Feet from flood leve = 24ft + 8 ft + 1 ft= 33 f	el (+8.0 feet) + freeboard ft NGVD	Proposed	
			33' FT NGVD	
OCCUPANCY GROUP: RS-3		ZONING	ORDINANCE No: 2014-3835	

COURTESY GRADE CALCULATION FROM CMB	
GRADE	4.36
ADJUSTED GRADE	6.18
30" ABOVE GRADE	6.86
FUTURE CROWN OF ROAD	5.25
FUTURE ADJUSTED GRADE	7.125
MIN. FREEBOARD ELEV.	9.000
MAX. FREEBOARD ELEV.	13.000
MIN. YARD ELEV.	6.56
MIN. GARAGE ELEV. (FOR A DETACHED OR ATTACHED GARAGE, NOT UNDER THE HOUSE)	6.18
MIN. GARAGE CEILING ELEV.	17.000

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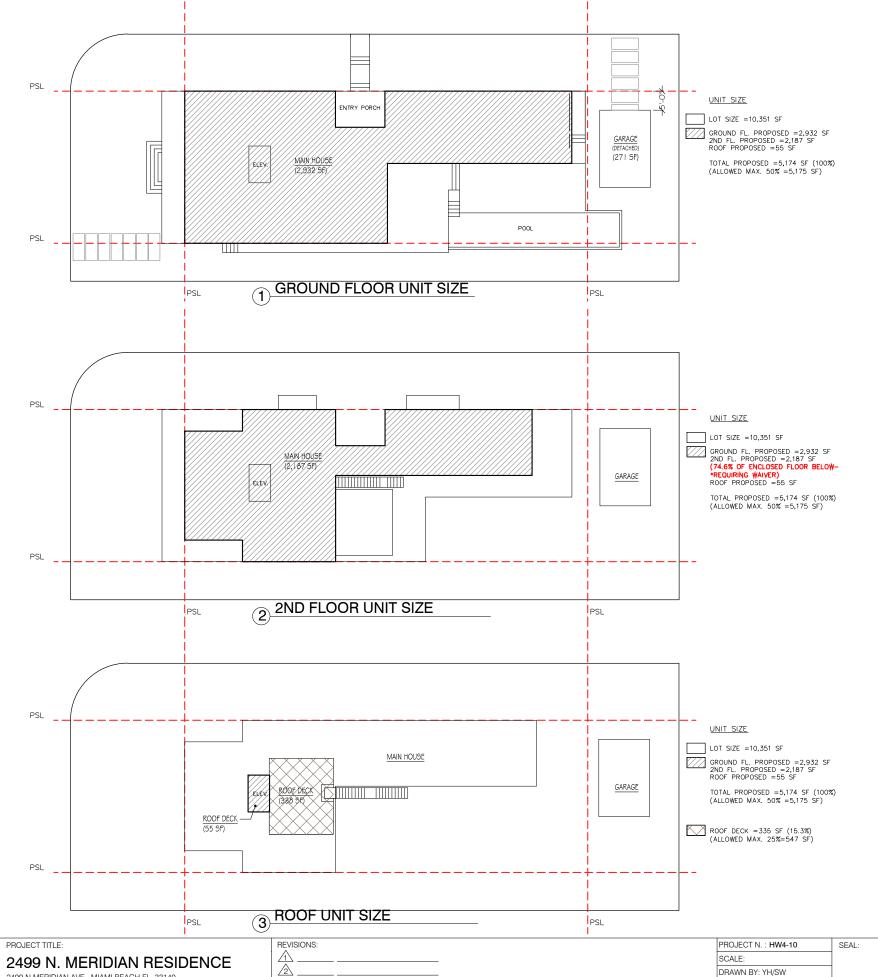
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DRAWN BY: YH/SW APPR BY: YIMING HO AR99574 DATE:

LOT COVERAGE & OPEN SPACE DATA

SHEET NO:

8.0A



2433 N ML	UDIAN AVEI	NUE ZONING & BUILD	ING DATA
ZONING DISTRICT:	Municipal Code, RS3		
PROPOSED USE:	NEW SINGLE RES	SIDENTIAL HOME	
GROSS LOT AREA:	65' (Lot Width) x 1	60' (Lot Depth) = 10,351 SF. (By Survey)	
SETBACKS:		Allowed	Proposed
	Front:	30 Feet	30 Feet
	North Side:	15 Feet	15 Feet
	South Side:	10 Feet	10 Feet
	Rear:	24 Feet (25% of lot depth)	24 Feet
LOT COVERAGE AREA:	ALLOWED: 30% OF 10,351 SI	F (GROSS LOT AREA) = 3,105 SF	Proposed
	MAIN BUILING LO (DETACHED GAR	OT COVERAGE: RAGE: 271 SF IS NOT APPLICABLE)	3,055 SF (29.5%)
UNIT SIZE AREA:	ALLOWED: 50%	OF 10,351 SF (GROSS LOT AREA) = 5	175 SF
777		, ,	Proposed
	GROUND FL		2,932 SF
	2ND FL		2,187 SF
	ROOF (ELEVATO	DR)	55 SF
	TOTAL:		5,174 SF(100%)
	2nd FL to GROUND FL RATIO (MAX. 70%)		2,187 / 2,932 =74.6% * REQUIRING WAIVER
OPEN SPACE:		50% OF 20' FRONT AREA 70% OF 24' REAR AREA	Proposed
	Front Yard: 1,252 X 50% = 626 SF		1,112 SF (88.8%)
	Rear Yard: 1,560X 70% =1,092 SF		1,093SF (70.06%)
	Side Yard (Street): 2,352 X 50% =1,176 SF		2,171 SF (92.3%)
ROOF DECK	MAXIMUM ALLOWED 25% OF THE ENCLOSED FLOOR AREA IMMEDIATELY BELOW		Proposed
	2,187 SF (2nd FL) x 25%= 547 SF		335 SF (15.3%)
		SET BACK: ROOF DECKS SHALL BE SETBACK A	
	IMINIMUM OF TEN FEET FROM EACH SIDE OF THE EXTERIOR OUTER WALLS, WHEN LOCATED ALONG A FRONT OR SIDE ELEVATION, AND FROM THE REAR ELEVATION FOR NON-WATERFRONT LOTS, THE DRB OR HPB MAY FOREGO THE REQUIRED REAR DECK		NORTH SIDE: 10 FT
			SOUTH SIDE: 10 FT
	DESIGN REVIEW	SETBACK, IN ACCORDANCE WITH THE APPLICABLE DESIGN REVIEW OR APPROPRIATENESS CRITERIA.	
	SIDES MAXIMUM	CTURES WHICH ARE OPEN ON ALL ALLOWED 20% OF THE ENCLOSED MEDIATELY BELOW	
	2,187 SF (2nd FL) x 20%= 437 SF.		55 SF (2.5%)
HEIGHT:	24 Feet from flood = 24ft + 8 ft + 1 ft=	level (+8.0 feet) + freeboard 33 ft NGVD	Proposed
			33' FT NGVD

GRADE	4.36
ADJUSTED GRADE	6.18
30" ABOVE GRADE	6.86
FUTURE CROWN OF ROAD	5.25
FUTURE ADJUSTED GRADE	7.125
MIN. FREEBOARD ELEV.	9.000
MAX. FREEBOARD ELEV.	13.000
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MIN. GARAGE ELEV. (FOR A DETACHED OR ATTACHED GARAGE, NOT UNDER THE HOUSE)	6.18
MIN. GARAGE CEILING ELEV.	17.000

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2499 N MERIDIAN AVE., MIAMI BEACH FL. 33140 ISSUE DATE: SEPTEMBER 07, 2018 (FINAL SUBMITTAL: NOV DRB) 4

APPR BY: YIMING HO DATE: AR99574

UNIT SIZE DATA

SHEET NO:

A0.9

RELEVANT CODE INFORMATION

"FOR TWO STORY HOMES WITH AN OVERALL LOT COVERAGE OF 25% OR GREATER, PHYSICAL VOLUME OF THE SECOND FLOOR SHALL NOT EXCEED 70% OF THE SECOND FLOOR ON THE MAIN HOME, INCLUSIVE OF ANY ENCLOSED PARKING STRUCTURE. "142-105 (b) (4) c.




PHYSICAL VOLUME OF SECOND FLOOR: 2,187 SF 74.5% OF GROUND FLOOR (2,932 SF)

* REQUIRING WAIVER



PHYSICAL VOLUME OF GROUND FLOOR: 2,932 SF

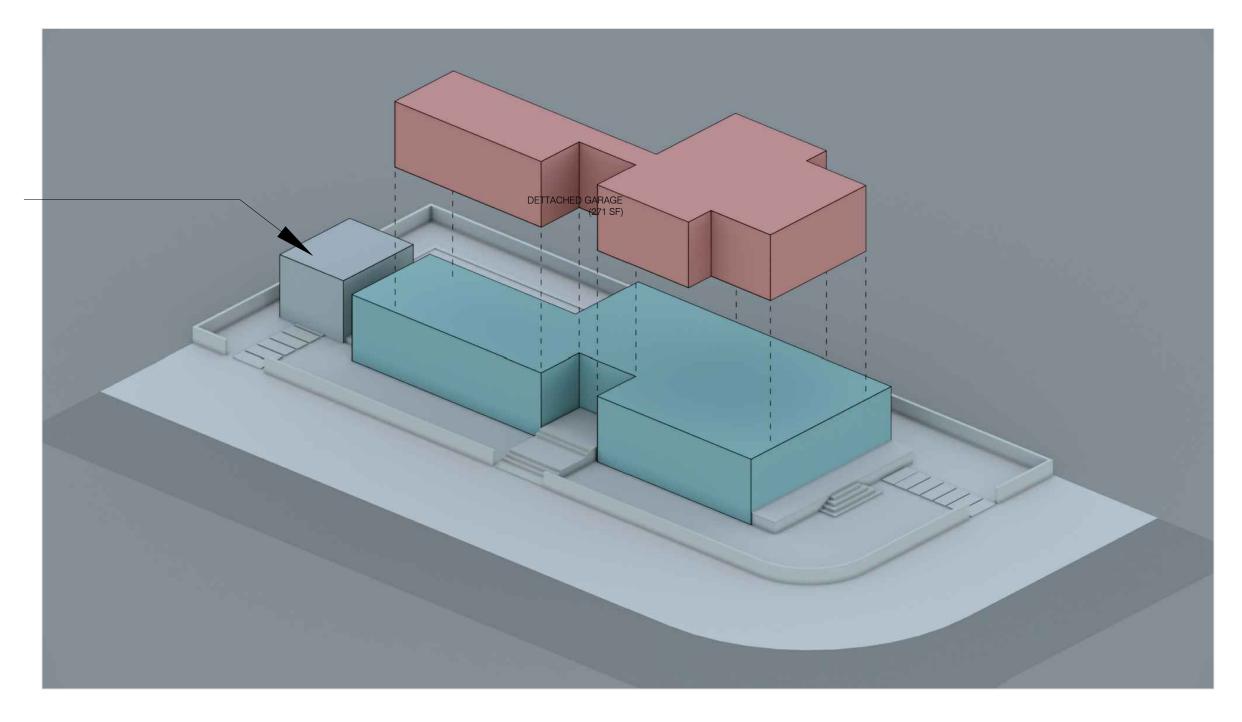

1 EXPLODED AXONOMETRIC DIAGRAM



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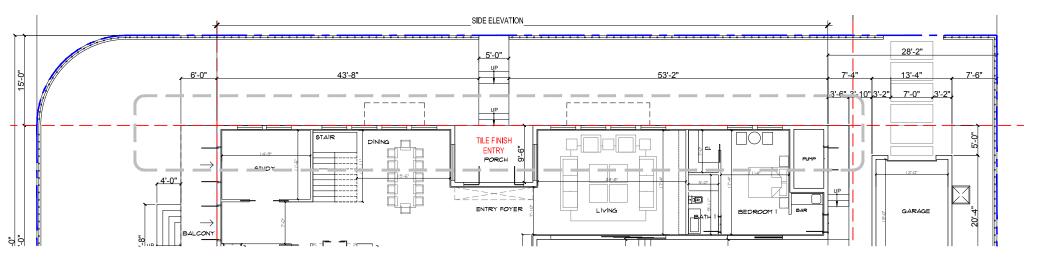
 APPR BY:
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 DATE:
 AR99574


AXONOMETRIC DIAGRAM & WAIVER DIAGRAM SHEET NO:

A0.10


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SIDE ELEVATION- GROUND FLOOR
SCALE: 1/16" = 1'-0"




2 SIDE ELEVATION- SECOND FLOOR SCALE: 1/16" = 1'-0"

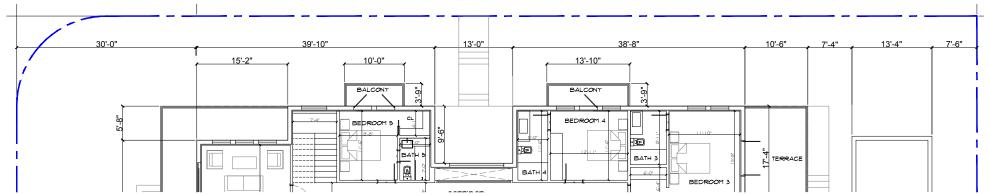

3 SIDE ELEVATION- ROOF PLAN
SCALE: 1/16" = 1'-0"
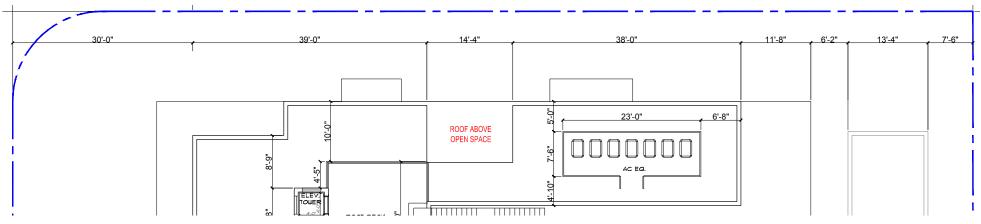
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2499 N. MERIDIAN RESIDENCE
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WAIVER DIAGRAM-SIDE ELEVATION ADDITIONAL OPEN SPACE

design review or appropriateness criteria.

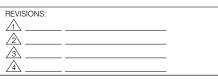FENCE 5' FR 4.36' NGVD PORCH 142-106 (2) d: NEED DRB APPROVAL IN UNDERLINE SECTIONS Two-story side elevations located parallel to a side property line shall not exceed 50 percent of the lot depth, or 60 feet, whichever is less, without incorporating additional open space, in excess of the minimum required side yard, directly adjacent to the required side yard. The additional open space shall be regular in shape, open to the sky from grade, and at least eight feet in depth, measured perpendicular from the minimum required side setback line. The square footage of the additional open space shall not be less than one percent of the lot area. The open space provided along a side elevation in accordance with this subsection, whether required or not, shall not be included in the lot coverage calculation provided that the combined depth of the open space,

as measured from the required side setback line(s), is less than 30 percent of the maximum developable building width of the property, as measured from the interior setback lines, and the total open space provided does not exceed five percent of the lot area. Any portions of the interior side yard open space in excess of five percent of the lot area shall be included in the total lot

coverage calculation. The elevation (height) of the open space

break up long expanses of uninterrupted two-story volume at or near the required side yard setback line and exception from the


approval, as may be applicable, in accordance with the applicable

minimum requirements of this provision may be granted only through historic preservation board, or design review board

provided shall not exceed the maximum permitted elevation height of the required side yard, and at least 75 percent of the required interior open space area shall be sodded or landscaped previous open space. The intent of this regulation shall be to

A0.11

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142-105 (b) (6): NEED DRB APPROVAL IN <u>UNDERLINE</u> SECTIONS

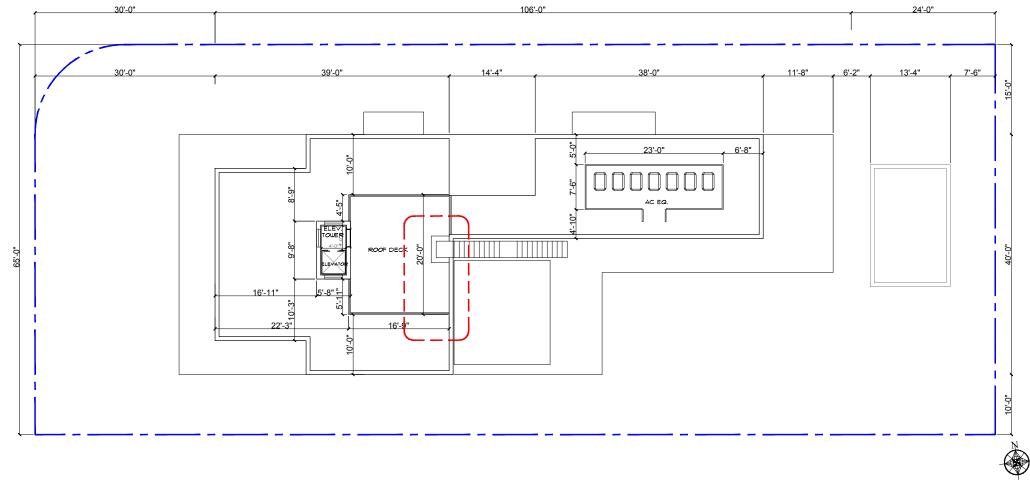Roof decks. Roof decks shall not exceed six inches above the main roofline and shall not exceed a combined deck area of 25 percent of the enclosed floor area immediately one floor below, regardless of deck height. Roof decks shall be setback a minimum of ten feet from each side of the exterior outer walls, when located along a front or side elevation, and from the rear elevation for non-waterfront lots. The DRB or HPB may forego the required rear deck setback, in accordance with the applicable design review or appropriateness criteria.

1 ROOF DECK SETBACK
SCALE: 1/16" = 1'-0"

ROJECT TITLE:

2499 N. MERIDIAN RESIDENCE 2499 N MERIDIAN AVE., MIAMI BEACH FL. 33140

POLIO NUMBER: 03-9227-006-0460

ISSUE DATE: SEPTEMBER 07, 2018 (FINAL SUBMITTAL: NOV DRB)

PROJECT N.: HW4-10 SEAL:

SCALE:

DRAWN BY: YH/SW

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DATE:


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YIMING HO AR99574 WAIVER DIAGRAM-ROOF DECK SETBACK

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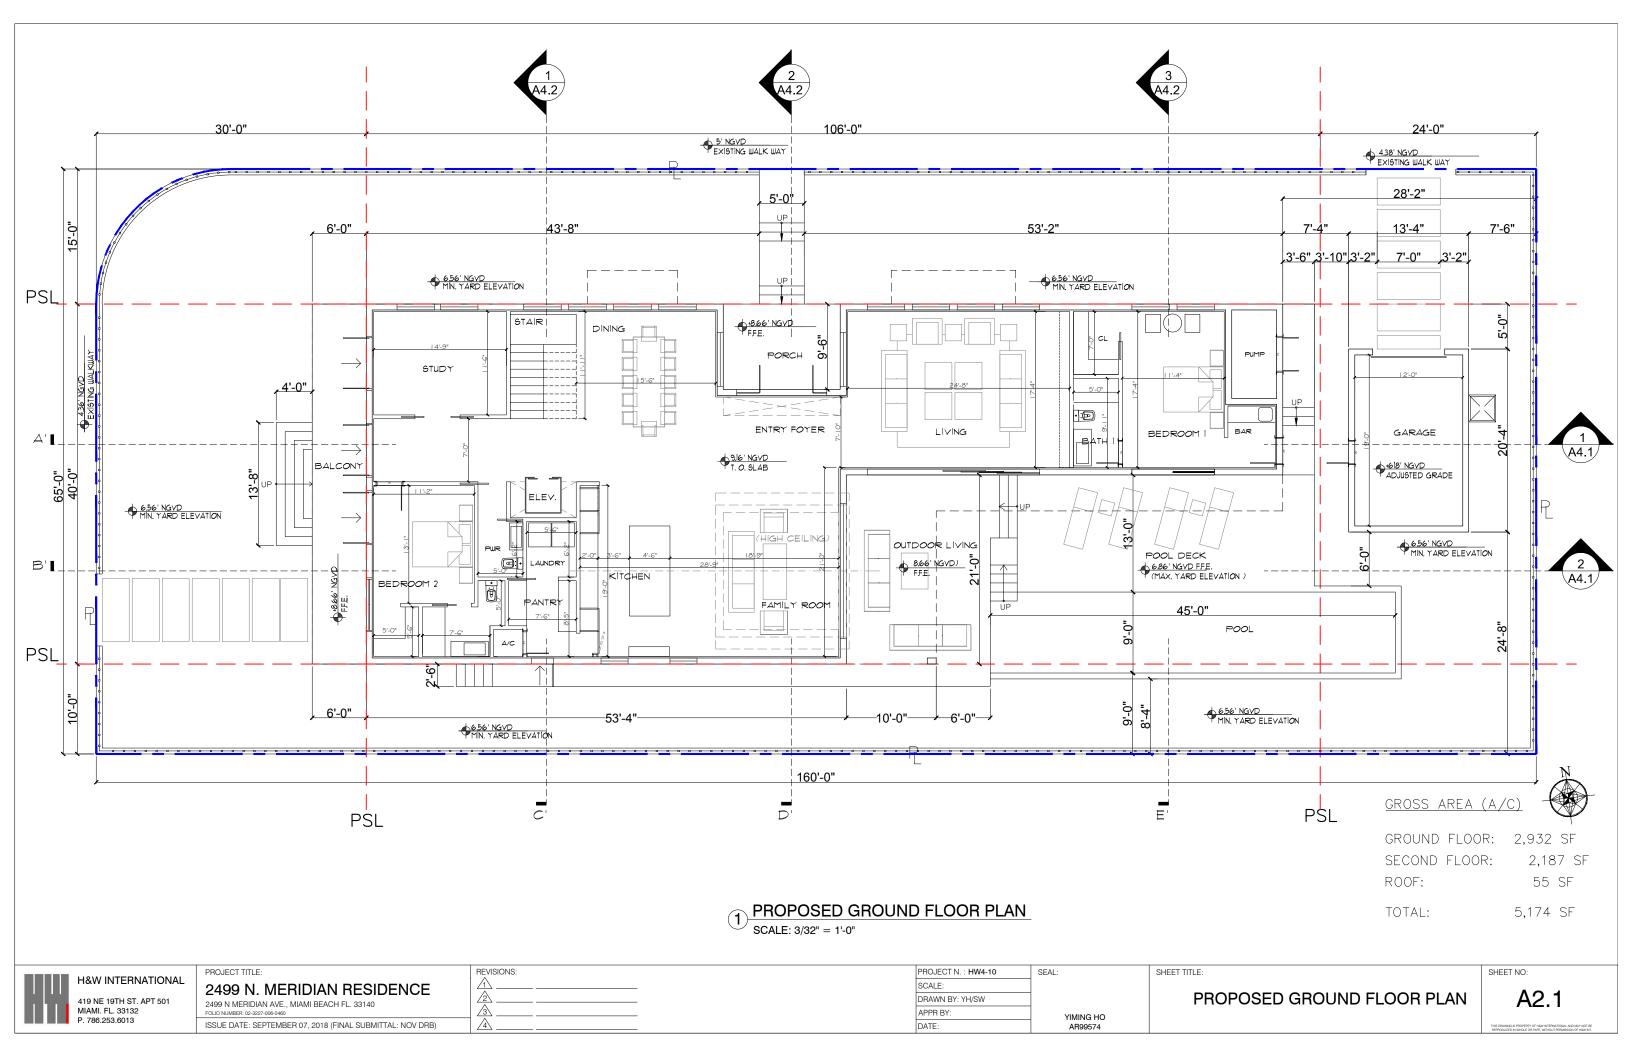
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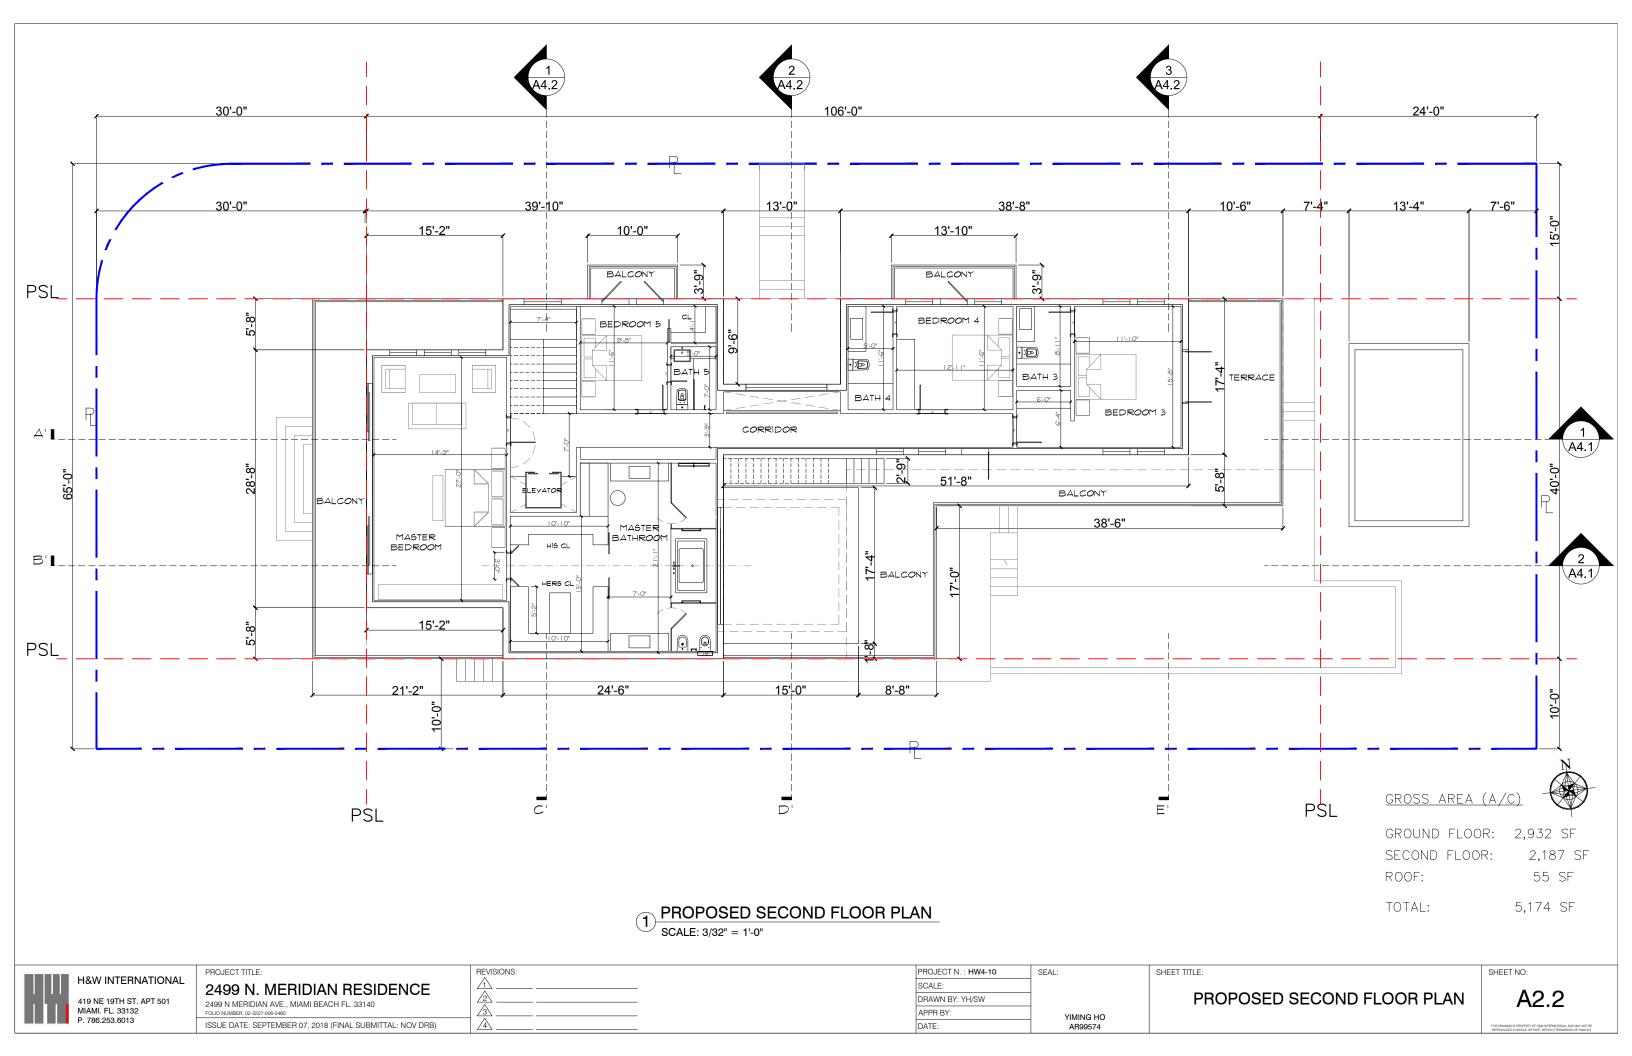
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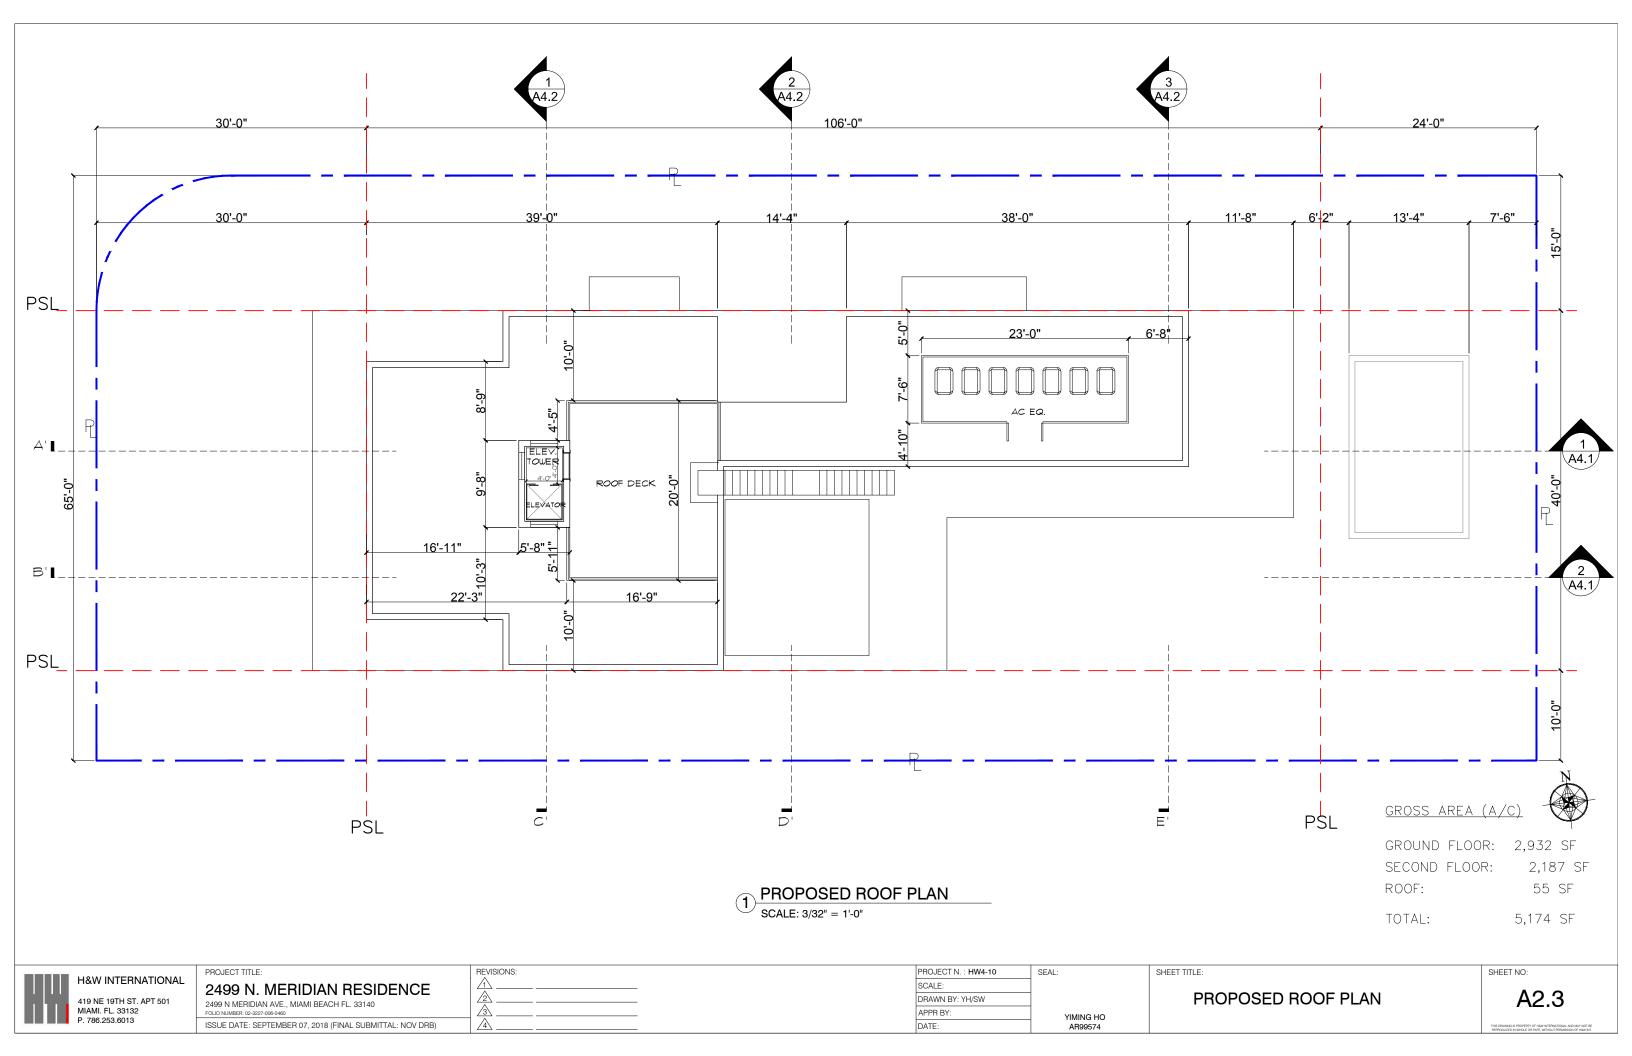
SCALE: DRAWN BY: YH/SW APPR BY:

PROPOSED SITE PLAN

A2.0



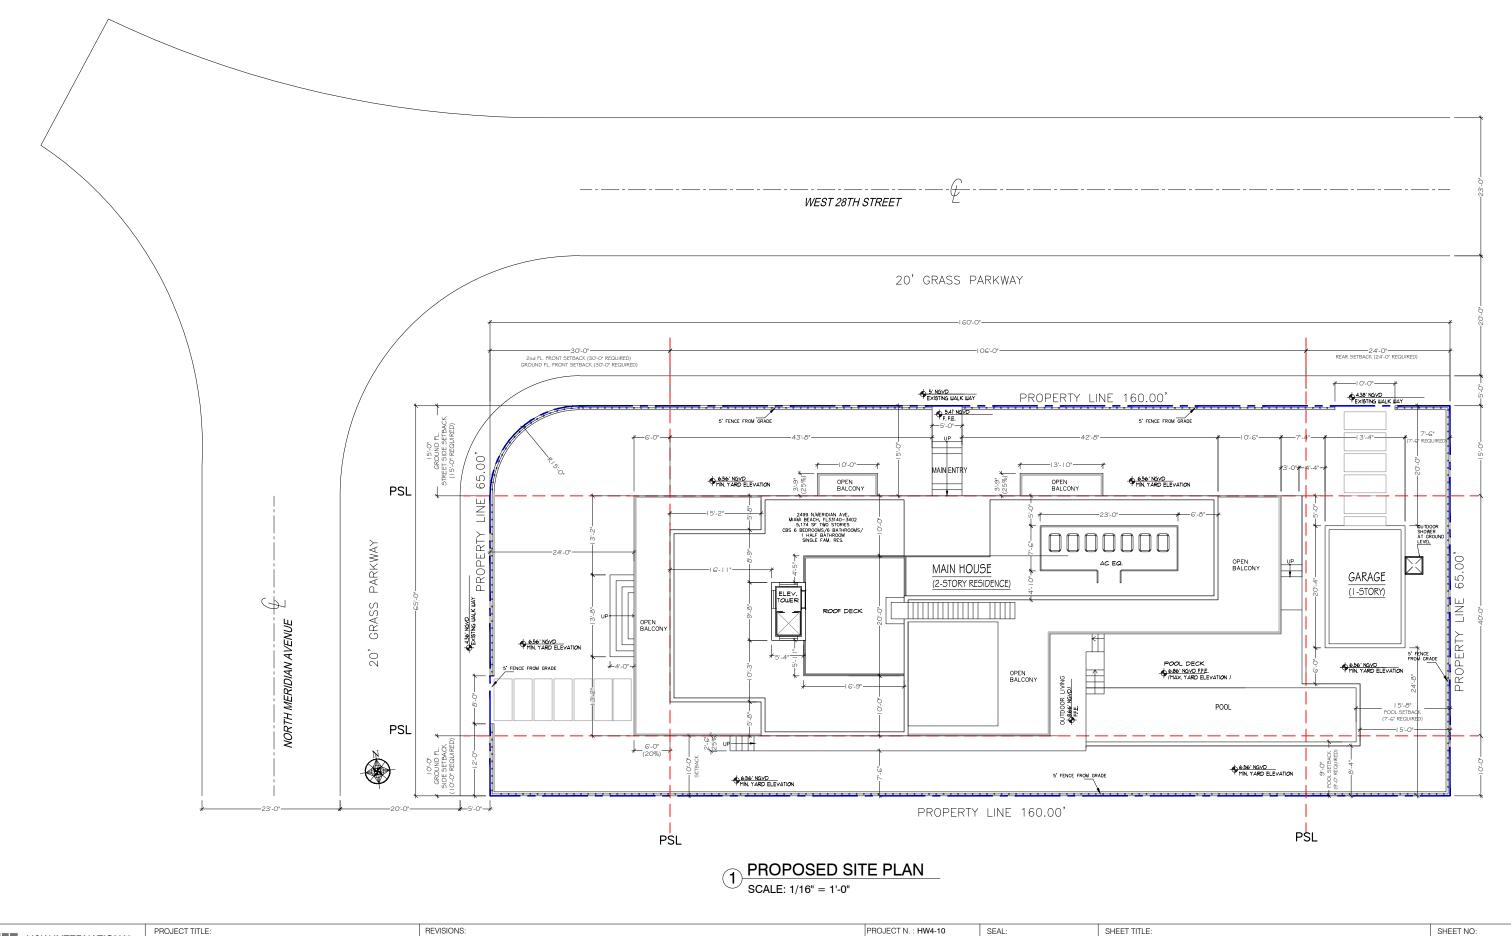





1 PROPOSED NORTH ELEVATION

SCALE: 3/32" = 1'-0"

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2499 N. MERIDIAN RESIDENCE

2499 N MERIDIAN AVE., MIAMI BEACH FL. 33140 FOLIO NUMBER: 02-3227-006-0460 ISSUE DATE: SEPTEMBER 07, 2018 (FINAL SUBMITTAL: NOV DRB)

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PROJECT N.: HW4-10

SCALE:

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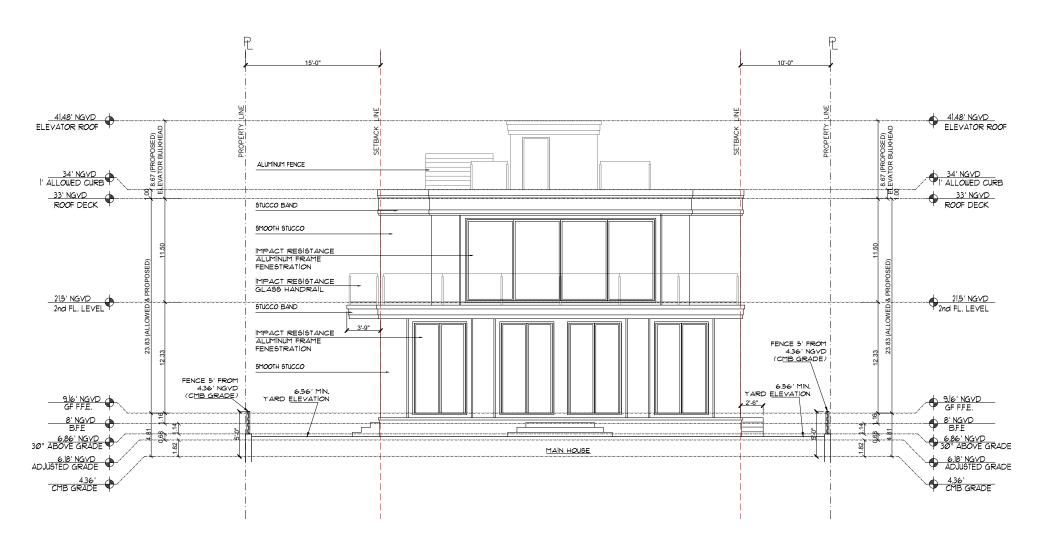
YIMING HO AR99574 SHEET TILE:

PROPOSED NORTH ELEVATION

SHEET NO:

A3.1

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PROPOSED WEST ELEVATION

SCALE: 3/32" = 1'-0"

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 APPR BY:
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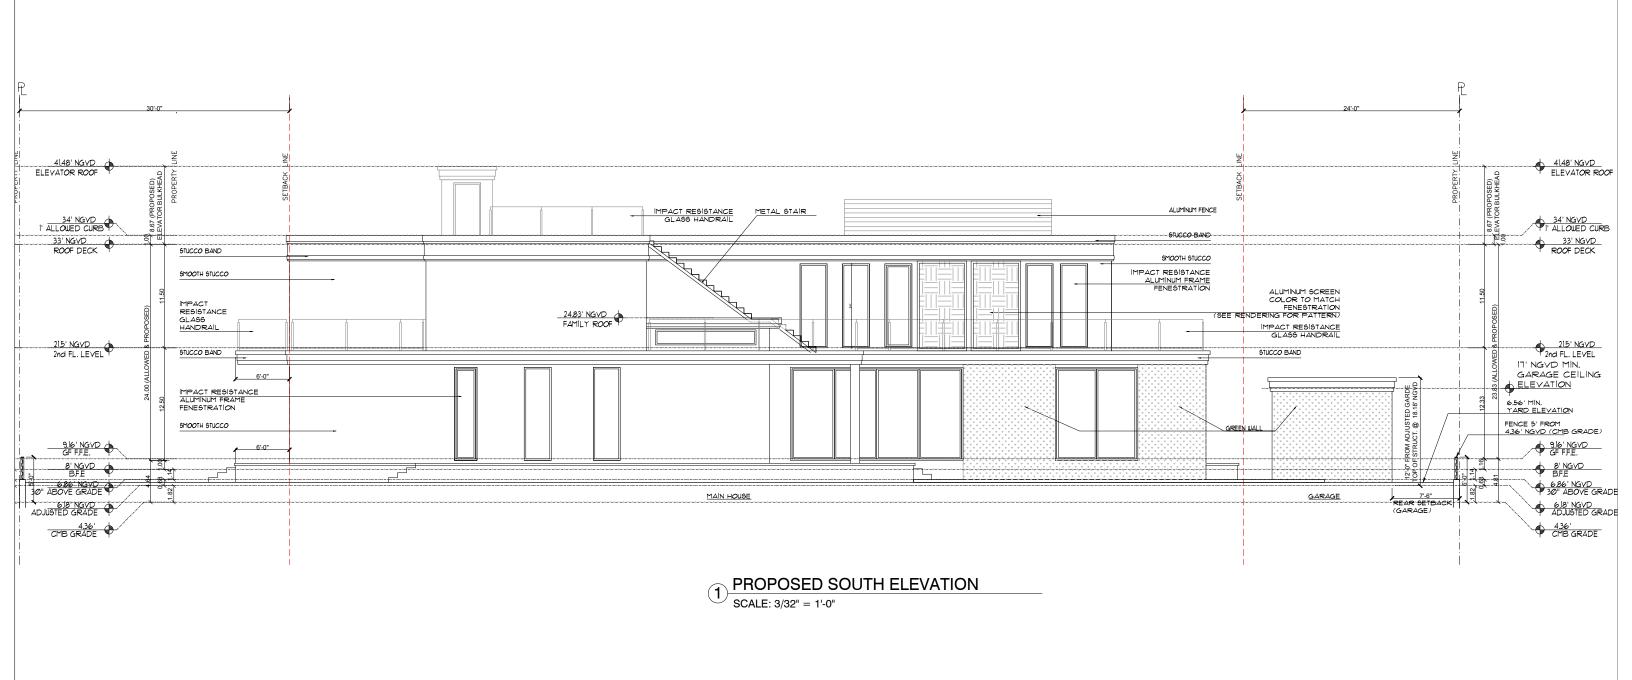
SHEET TITLE:

PROPOSED WEST ELEVATION

SHEET NO:

A3.2

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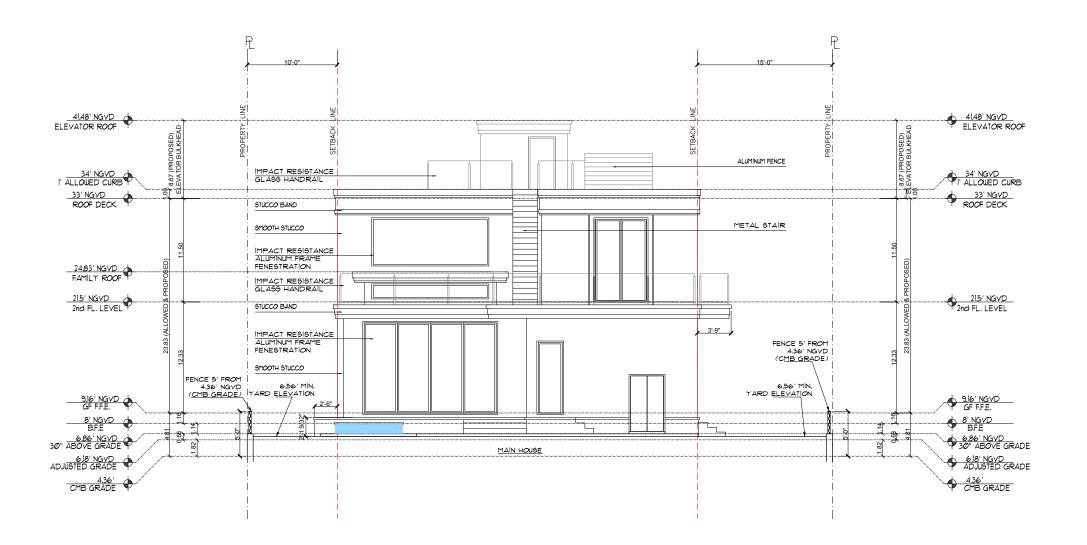
YIMING HO AR99574 SHEET TITLE:

PROPOSED SOUTH ELEVATION

SHEET NO:

A3.3

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PROPOSED EAST ELEVATION

SCALE: 3/32" = 1'-0"

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 SCALE:
 DRAWN BY: YH/SW


 APPR BY:
 YIMING HO


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PROPOSED EAST ELEVATION

SHEET NO: **A3.4**

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 SCALE:
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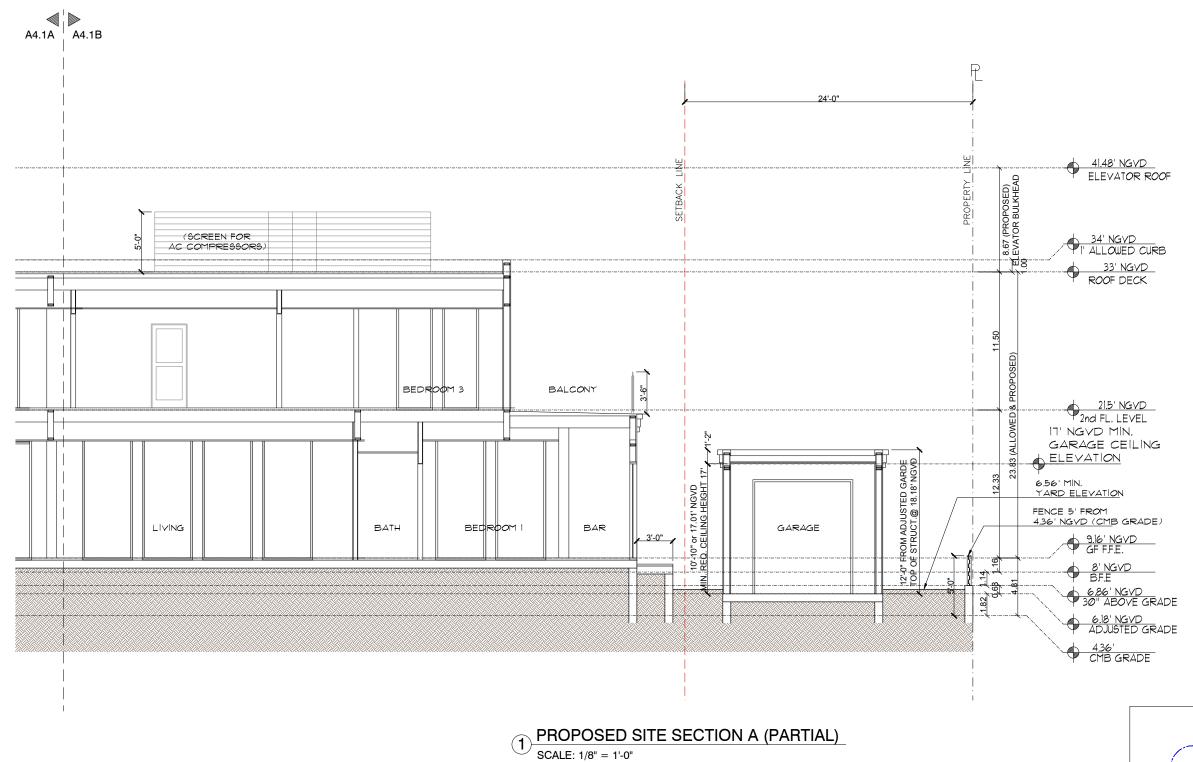
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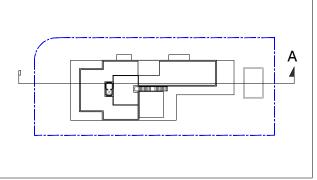
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PROPOSED SITE SECTION A (PARTIAL)

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2 KEY PLAN

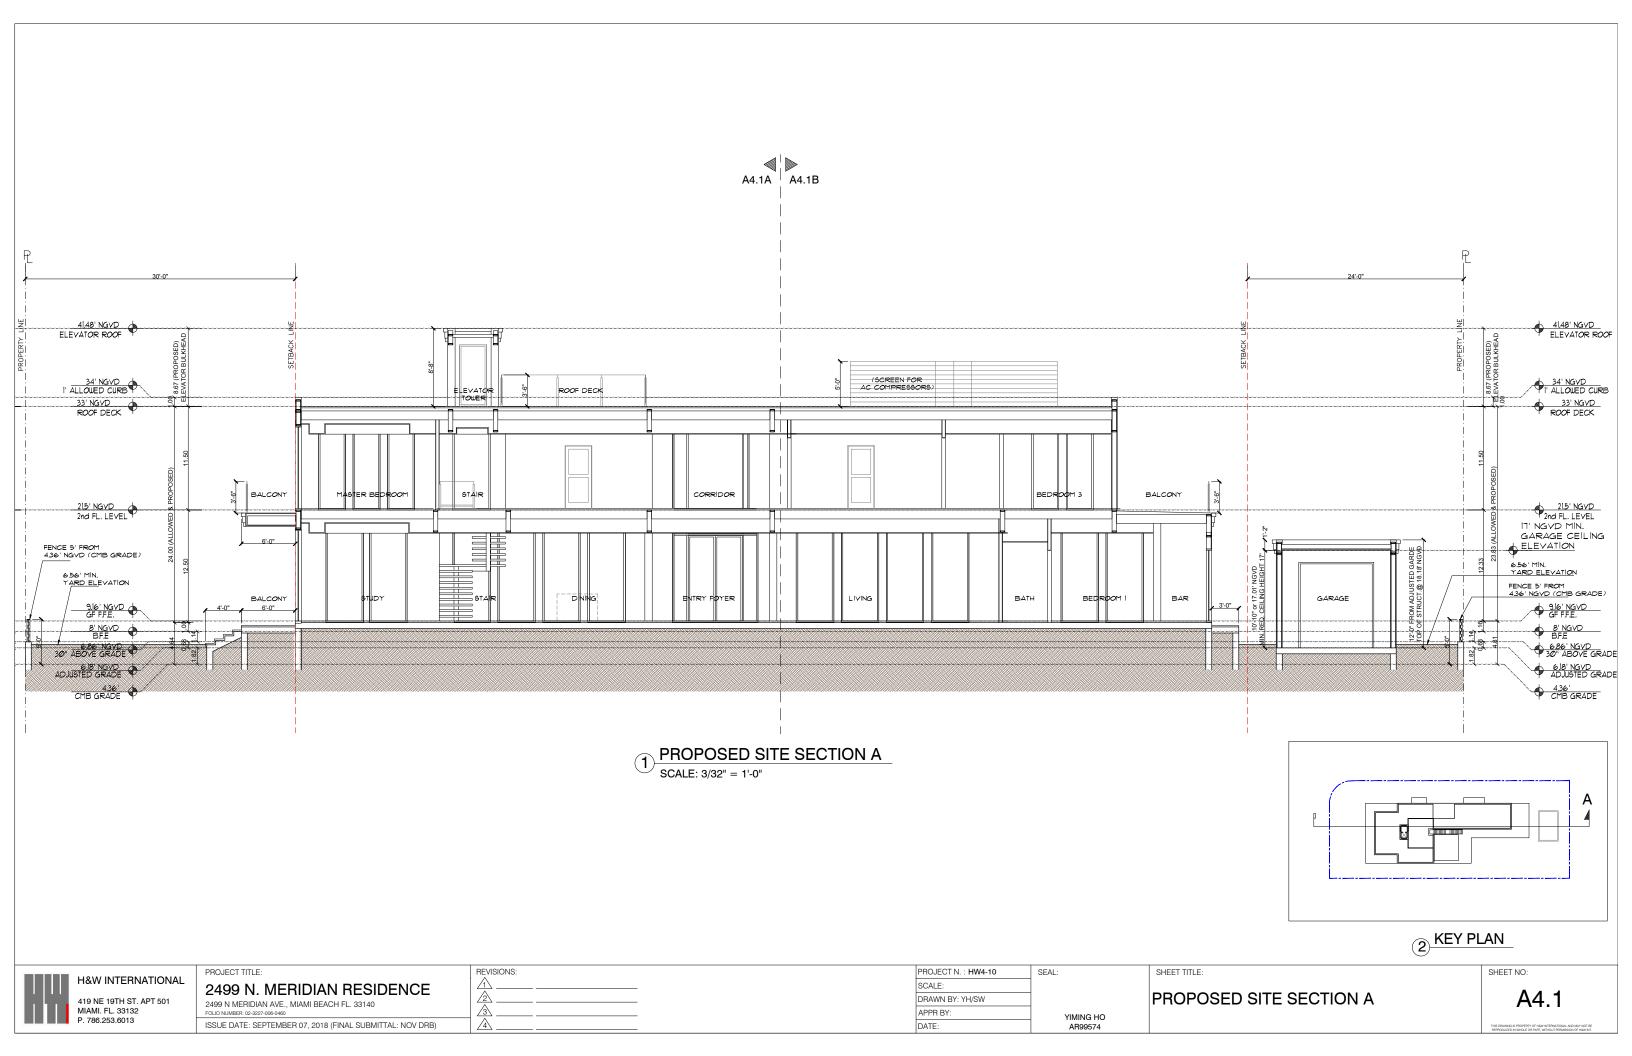

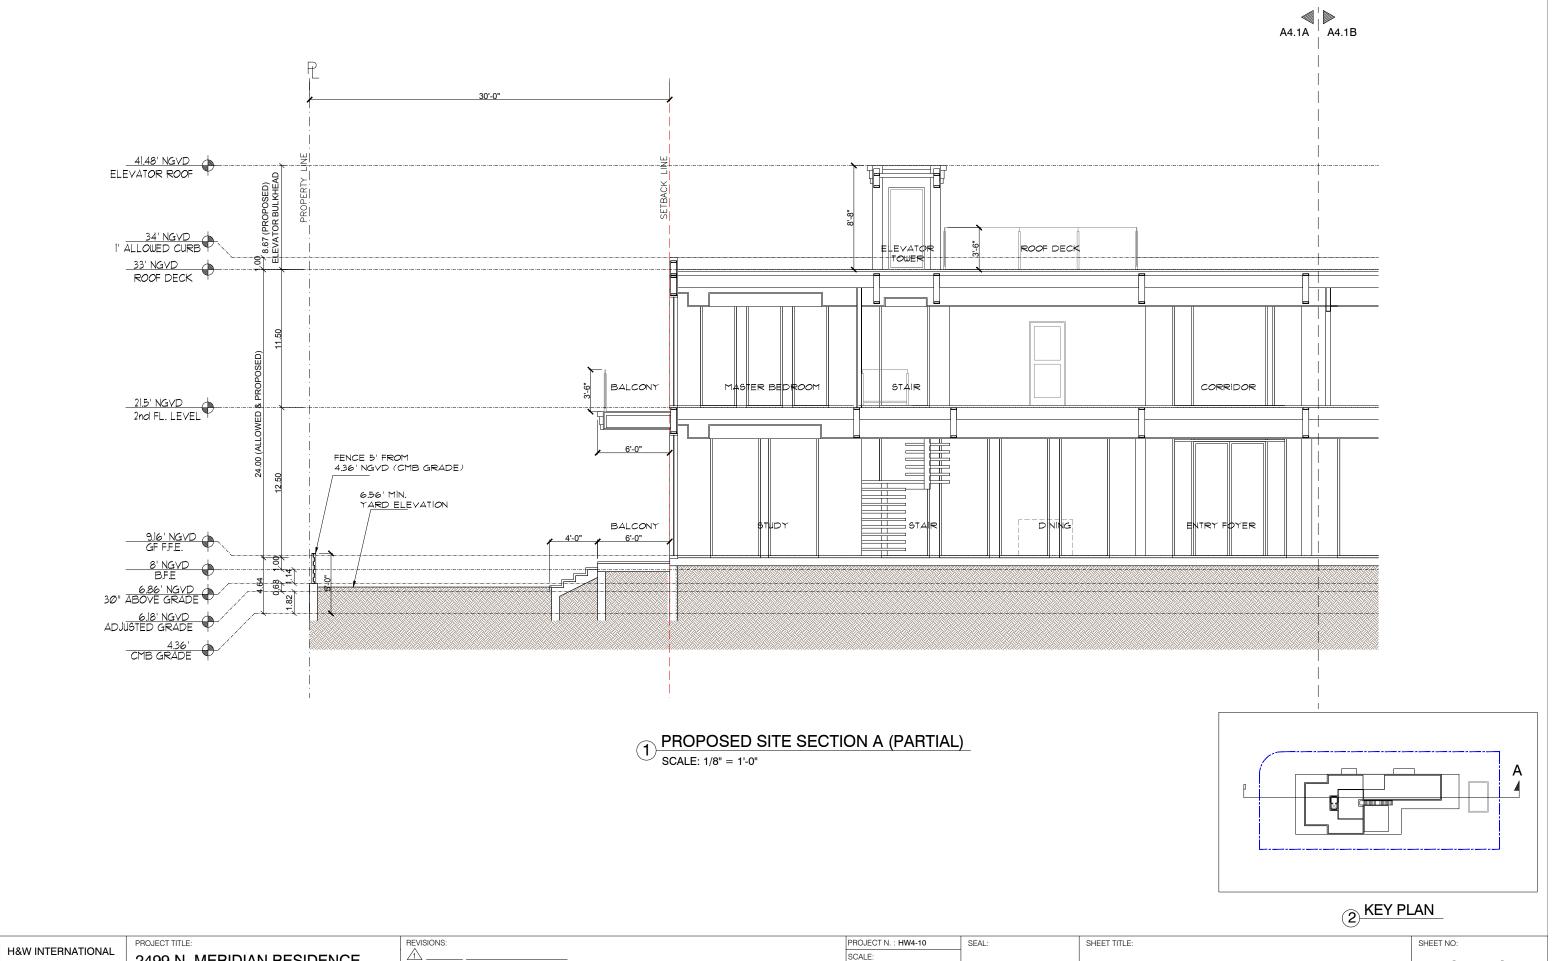PROJECT TITLE:

2499 N. MERIDIAN RESIDENCE


2499 N MERIDIAN AVE., MIAMI BEACH FL. 33140 ISSUE DATE: SEPTEMBER 07, 2018 (FINAL SUBMITTAL: NOV DRB)


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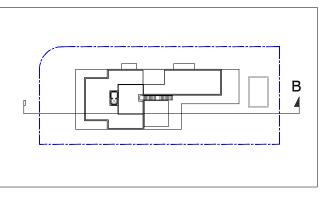
PROJECT N.: HW4-10 SEAL: SCALE: DRAWN BY: YH/SW APPR BY: YIMING HO AR99574 DATE:

PROPOSED SITE SECTION A (PARTIAL)

SHEET NO: A4.1B



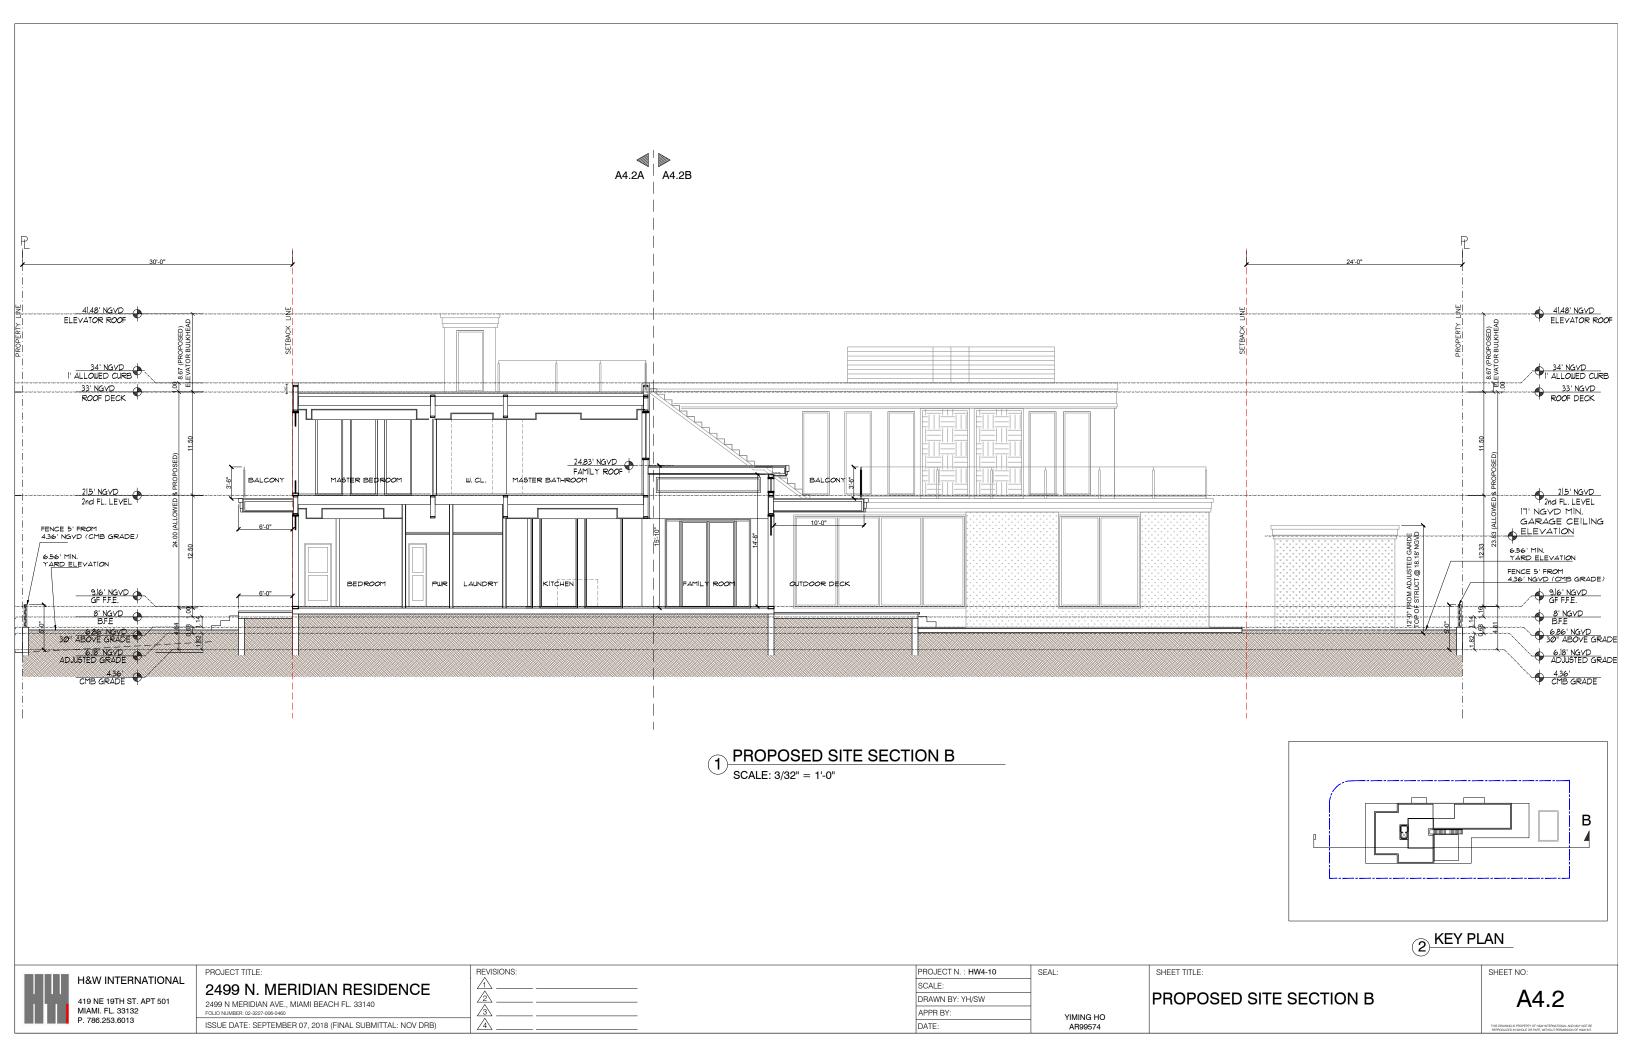

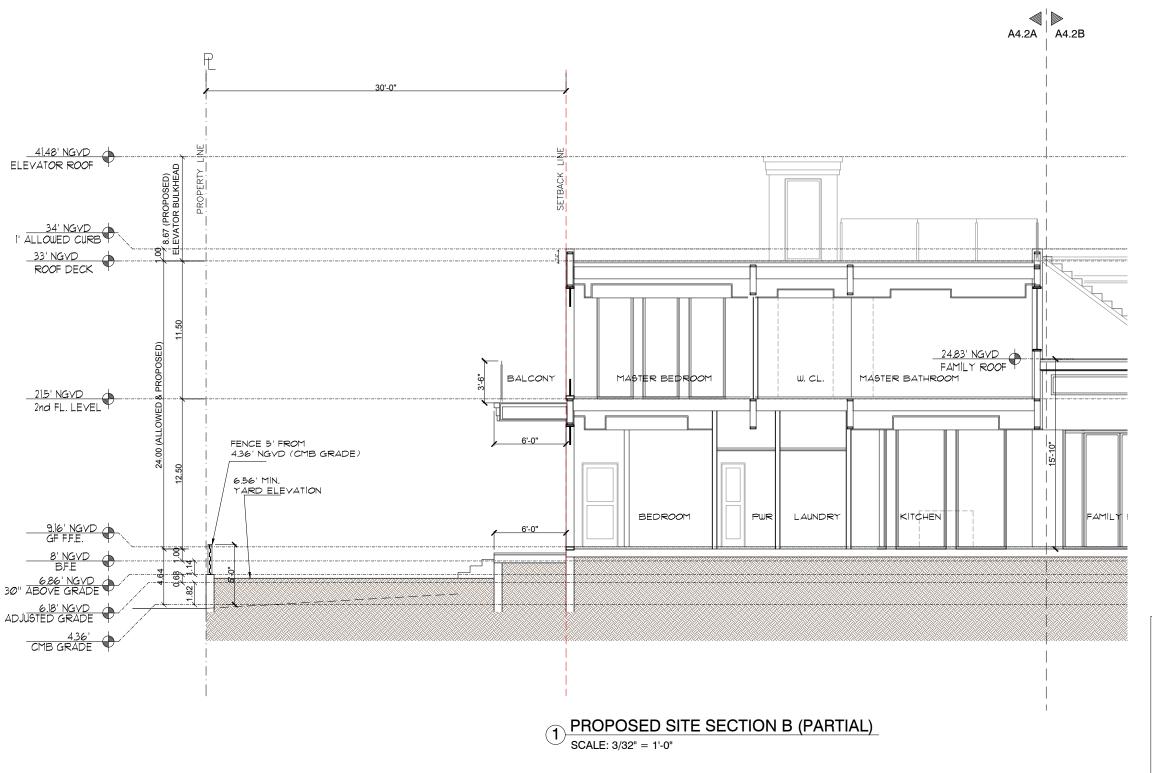

2 KEY PLAN

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 SEAL:


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 DRAWN BY: YH/SW

 APPR BY:
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PROPOSED SITE SECTION B (PARTIAL)

A4.2A



419 NE 19TH ST. APT 501 MIAMI. FL. 33132

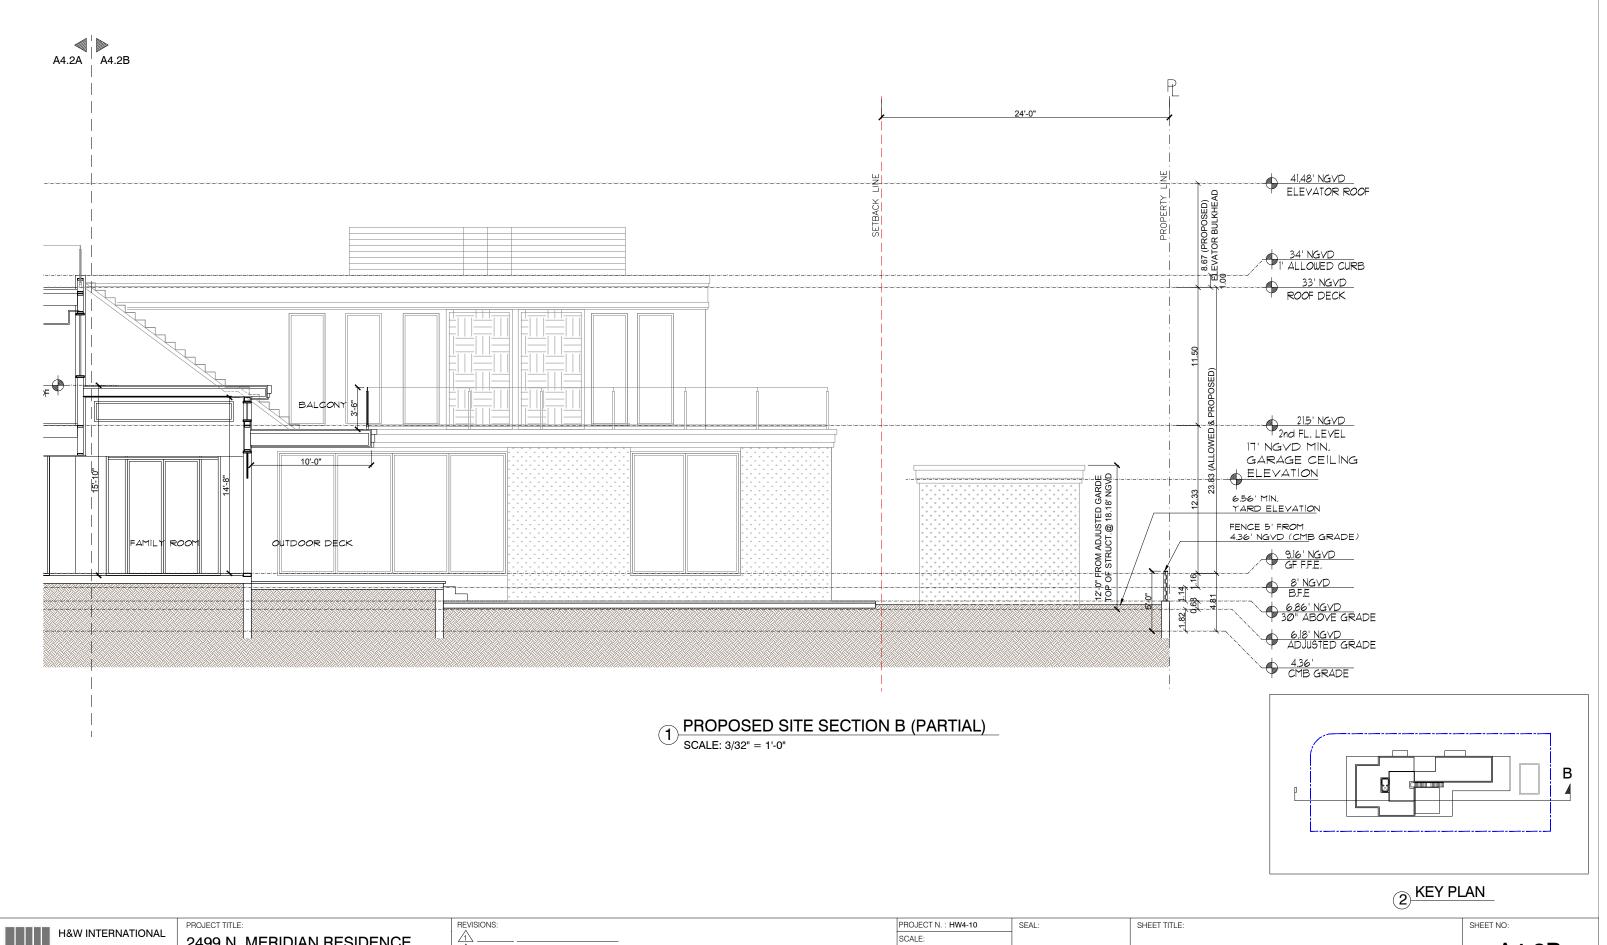
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ISSUE DATE: SEPTEMBER 07, 2018 (FINAL SUBMITTAL: NOV DRB)

DRAWN BY: YH/SW APPR BY: YIMING HO AR99574

PROPOSED SITE SECTION B (PARTIAL)

A4.2B

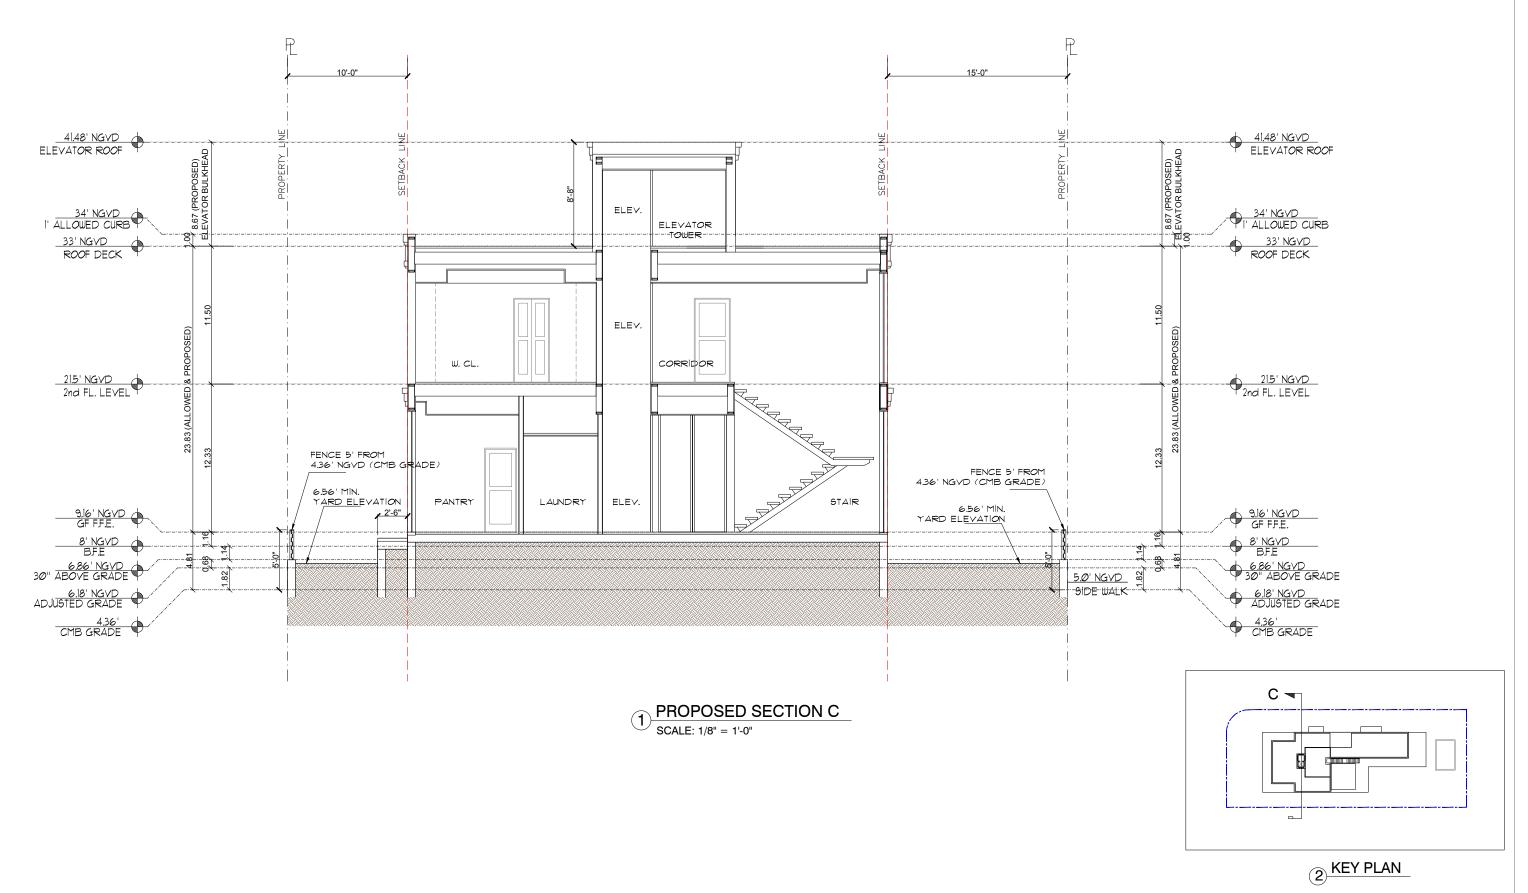

H&W INTERNATIONAL 419 NE 19TH ST. APT 501 MIAMI. FL. 33132 P. 786.253.6013

2499 N. MERIDIAN RESIDENCE

2499 N MERIDIAN AVE., MIAMI BEACH FL. 33140 ISSUE DATE: SEPTEMBER 07, 2018 (FINAL SUBMITTAL: NOV DRB)

REVISIONS: 1 2 3 4


PROJECT N.: HW4-10 SEAL: SCALE: DRAWN BY: YH/SW APPR BY: DATE:

PROPOSED SECTION C

SHEET TITLE:

YIMING HO AR99574

SHEET NO: A4.3

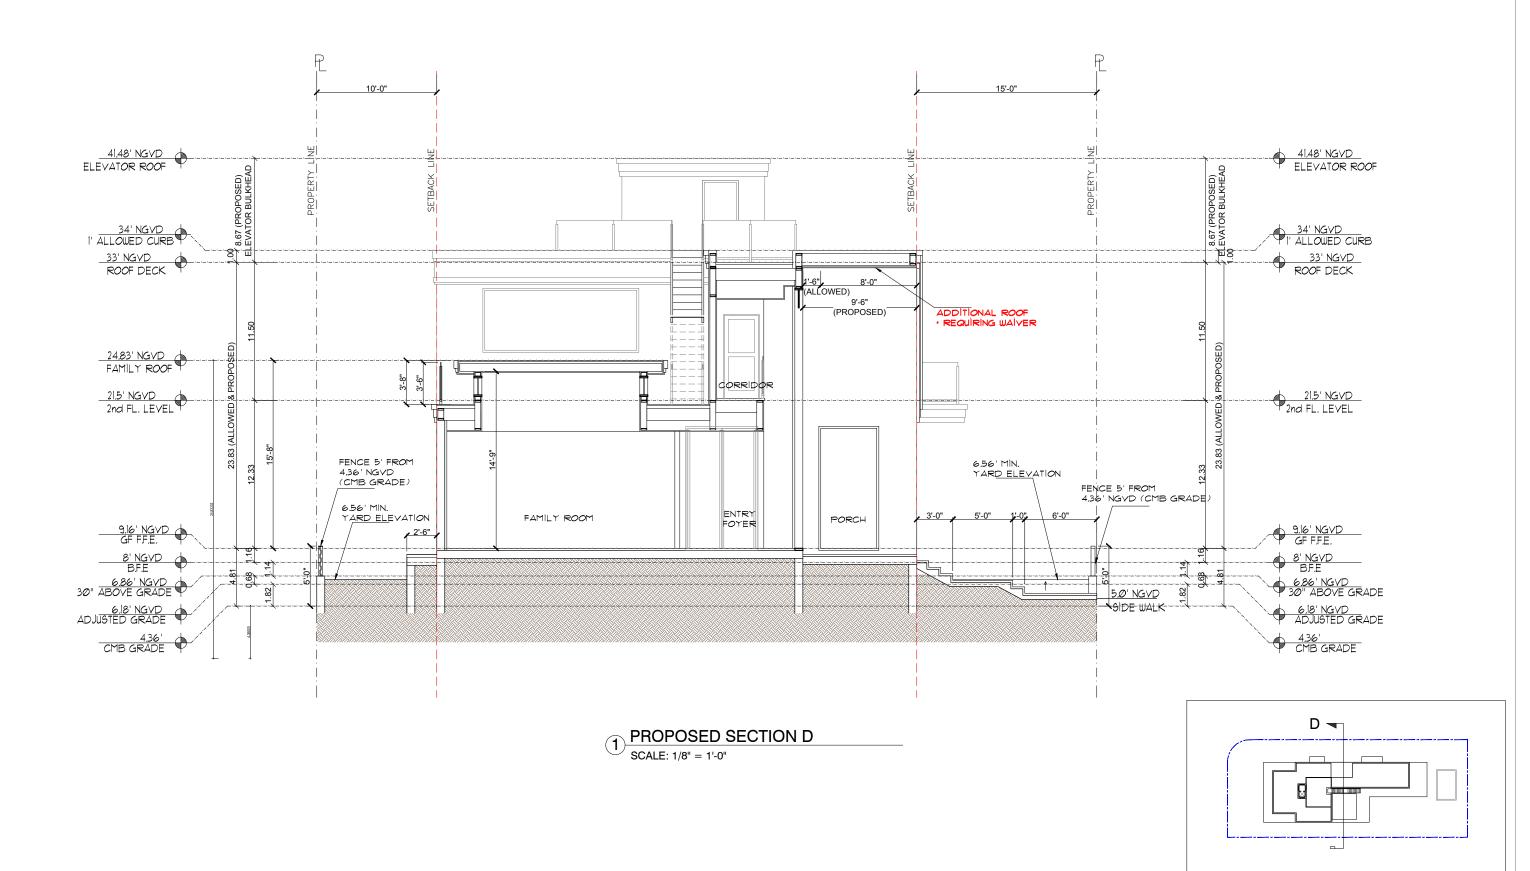

2 KEY PLAN



PROJECT TITLE:

2499 N. MERIDIAN RESIDENCE

2499 N MERIDIAN AVE., MIAMI BEACH FL. 33140 FOLIO NUMBER: 02:3227-006-0460 ISSUE DATE: SEPTEMBER 07, 2018 (FINAL SUBMITTAL: NOV DRB)

 PROJECT N. : HW4-10
 SEAL:

 SCALE:
 DRAWN BY: YH/SW

 APPR BY:
 YIMING HO


 DATE:
 AR99574

PROPOSED SECTION D

SHEET TITLE:


SHEET NO: **A4.4**

RAWING IS PROPERTY OF HEW INTERNATIONAL AND MAY NOT BE

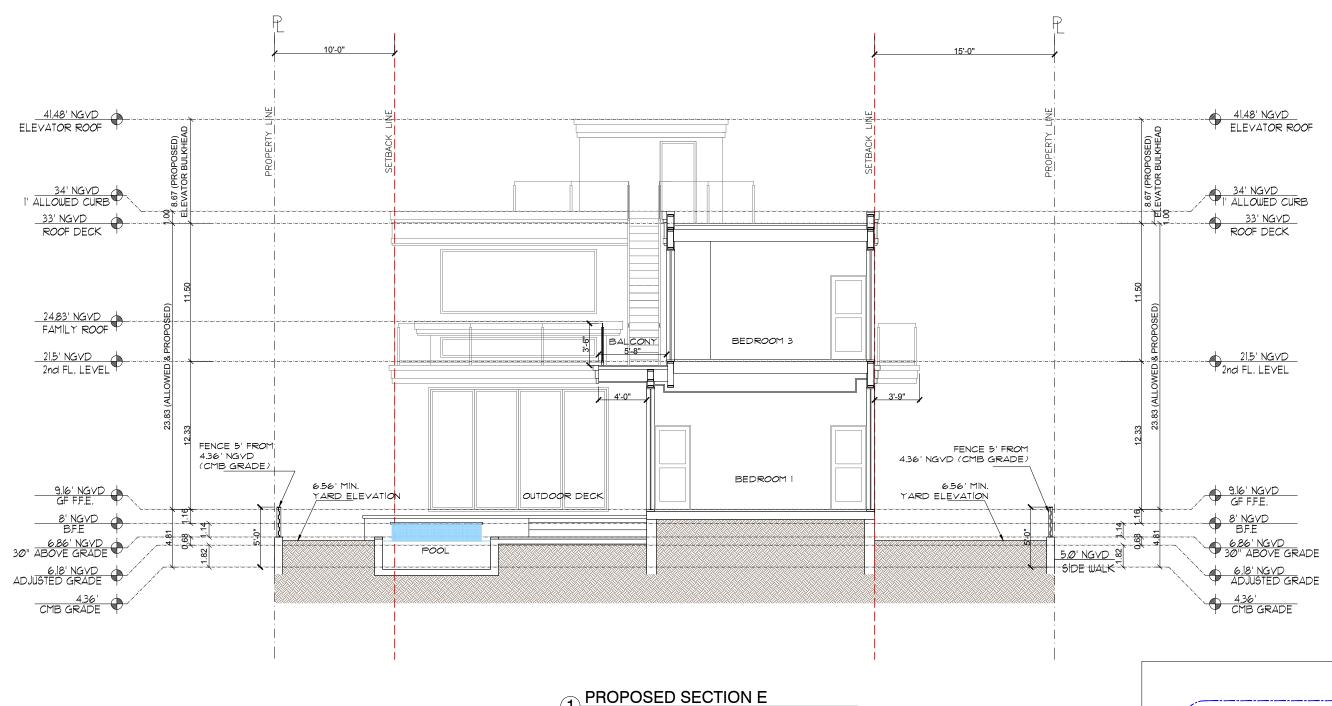

PROPOSED SECTION E

SCALE: 1/8" = 1'-0"

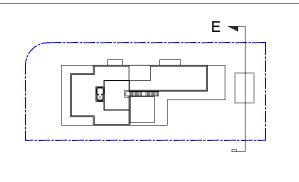

2 KEY PLAN



PROJECT TITLE:

2499 N. MERIDIAN RESIDENCE 2499 N MERIDIAN AVE., MIAMI BEACH FL. 33140

2 3 2 ISSUE DATE: SEPTEMBER 07, 2018 (FINAL SUBMITTAL: NOV DRB) 4

REVISIONS:

PROJECT N.: HW4-10 SEAL: SCALE: DRAWN BY: YH/SW APPR BY: YIMING HO AR99574 DATE:


PROPOSED SECTION E

SHEET TITLE:

SHEET NO: A4.5



1 FRONT VIEW (28TH STREET SIDE)

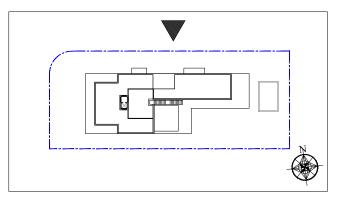

2 KEY PLAN

MATERIAL LEGEND			
ITEM	LOCATION	MATERIAL	NOTE
Α	WALLS	STUCCO W/ PAINT	
В	MOLDINGS	STUCCO W/ PAINT	
С	WINDOWS	ALUMINUM W/ GLASS	
D	GUARD RAILS	ALUMINUM W/GLASS	
E	BALCONY FLOOR	TILE	
F	FENCE	ALUMINUM ABOVE MASONY WALL	
G	GARAGE DOOR	ALUMINUM	
Н	DECORATIVE PANEL	ALUMINUM	

H&W INTER	RNATIONA
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419 NE 19TH ST. APT 501 MIAMI. FL. 33132 P. 786.253.6013 PROJECT TITLE:

2499 N. MERIDIAN RESIDENCE

ISSUE DATE: SEPTEMBER 07, 2018 (FINAL SUBMITTAL: NOV DRB)

2499 N MERIDIAN AVE., MIAMI BEACH FL. 33140 FOLIO NUMBER: 02-3227-006-0460

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PROJECT N.: HW4-10	SEAL:
SCALE:	
DRAWN BY: YH/SW	
APPR BY:	YIMING HO
DATE:	AR99574

RENDERING- FRONT VIEW


SHEET NO:

A10.1

CRAWING IS PROPERTY OF HEW INTERNATIONAL AND MAY NOT



	MATER	RIAL LEGEND	
ITEM	LOCATION	MATERIAL	NOTE
Α	WALLS	STUCCO W/ PAINT	
В	MOLDINGS	STUCCO W/ PAINT	
С	WINDOWS	ALUMINUM W/ GLASS	
D	GUARD RAILS	ALUMINUM W/GLASS	
Е	BALCONY FLOOR	TILE	
F	FENCE	ALUMINUM ABOVE MASONY WALL	
G	GARAGE DOOR	ALUMINUM	
Η	DECORATIVE PANEL	ALUMINUM	

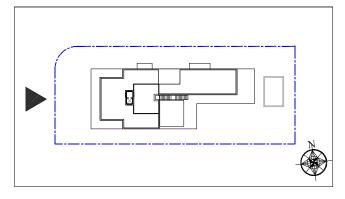

1 FRONT VIEW (N. MERIDIAN AVE SIDE)

2 KEY PLAN



H&W INTERNATIONAL

419 NE 19TH ST. APT 501 MIAMI. FL. 33132 P. 786.253.6013

2499 N. MERIDIAN RESIDENCE

2499 N MERIDIAN AVE., MIAMI BEACH FL. 33140

ISSUE DATE: SEPTEMBER 07, 2018 (FINAL SUBMITTAL: NOV DRB)

PROJECT N.: HW4-10 SEAL: DRAWN BY: YH/SW

SCALE:


APPR BY: DATE:

RENDERING- FRONT VIEW

A10.2



SIDE VIEW (SOUTH SIDE)

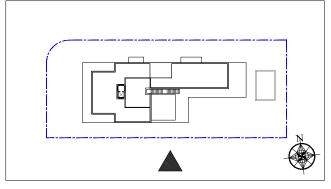

2 KEY PLAN

H&W INTERNATIONA
419 NE 19TH ST. APT 501 MIAMI. FL. 33132 P. 786.253.6013

2499 N. MERIDIAN RESIDENCE

2499 N MERIDIAN AVE., MIAMI BEACH FL. 33140
FOLIO NUMBER: 02-3227-006-0460

ISSUE DATE: SEPTEMBER 07, 2018 (FINAL SUBMITTAL: NOV DRB)

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<u></u>	
4	

PROJECT N.: HW4-10	SEAL:
SCALE:	
DRAWN BY: YH/SW	
APPR BY:	YIMING HO
DATE:	AR99574

SHEET TITLE:

RENDERING- SIDE VIEW

SHEET NO:

MATERIAL LEGEND

LOCATION

WALLS

MOLDINGS WINDOWS

GUARD RAILS

FENCE GARAGE DOOR

DECORATIVE PANEL

E BALCONY FLOOR

ITEM

MATERIAL STUCCO W/ PAINT

STUCCO W/ PAINT

ALUMINUM W/ GLASS

ALUMINUM W/GLASS

TILE

ALUMINUM ABOVE MASONY WALL ALUMINUM

ALUMINUM


NOTE

A10.3

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	MATERIAL LEGEND			
ITEM	LOCATION	MATERIAL	NOTE	
Α	WALLS	STUCCO W/ PAINT		
В	MOLDINGS	STUCCO W/ PAINT		
С	WINDOWS	ALUMINUM W/ GLASS		
D	GUARD RAILS	ALUMINUM W/GLASS		
Е	BALCONY FLOOR	TILE		
F	FENCE	ALUMINUM ABOVE MASONY WALL		
G	GARAGE DOOR	ALUMINUM		
Н	DECORATIVE PANEL	ALUMINUM		



1 REAR VIEW (EAST SIDE)

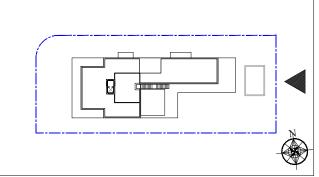2 KEY PLAN

H&W INTERNATIONAL 419 NE 19TH ST. APT 501 MIAMI. FL. 33132 P. 786.253.6013

2499 N. MERIDIAN RESIDENCE

2499 N MERIDIAN AVE., MIAMI BEACH FL. 33140

ISSUE DATE: SEPTEMBER 07, 2018 (FINAL SUBMITTAL: NOV DRB)

PROJECT N.: HW4-10 SEAL: SCALE: DRAWN BY: YH/SW APPR BY: DATE:

RENDERING- REAR VIEW

SHEET NO:

A10.4





2 PERSPECTIVE VIEW (28TH STREET- MERIDIAN AVE CORNER)



3 PERSPECTIVE VIEW (SE CORNER)



PERSPECTIVE VIEW (SE AVE CORNER)

YIMING HO AR99574



H&W INTERNATIONAL 419 NE 19TH ST. APT 501 MIAMI. FL. 33132

AL PROJECT TI

2499 N. MERIDIAN RESIDENCE

POLIO NUMBER: 02-3227-006-0460

ISSUE DATE: SEPTEMBER 07, 2018 (FINAL SUBMITTAL: NOV DRB)

PROJECT N. : HW4-10 SCALE:
DRAWN BY: YH/SW
APPR BY:
DATE:


SHEET TITLE:

RENDERINGS- PERSPECTIVE VIEW

SHEET NO:


A10.5

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	PLA	NT LIST		
TREES				
KEY	PLANT NAME	QTY.	UT.	SIZE
BUSI	Bursea simaruba	9	ea.	14' x 6', 3" DBH
	Gumbo Limbo			AND WAS ON SO ABUSEY OF AND YOUR TEST.
COER	Conocarpus erectus	8	ea.	12' x 5', 2" DBH
	Green Buttonwood	100	10000	
COES	Conocarpus erectus "Sericeus"	3	ea.	10' x 6', Multitrunk, Treeform
	Silver Buttonwood	100	10000	
PIDI	Pimenta dioica	1	ea.	10' x 5', 2" DBH
350	Allspice Tree	15		,
QUVI	Quercus virginiana	2	ea.	14' x 6', 3" DBH
	Live Oak	1		
PALMS			-	
KEY	PLANT NAME	IOT/	LIT	SIZE
CONG		QTY.		10° CW
CONG		5	ea.	10 CW
DVDF	Maypan Coconut Palm	-		CT II
DYDE	Dypsis decaryi	2	ea.	6' CT, align as shown on plan
D/1 A	Triangle Palm	1	-	67.11.0.4
HYLA	Hyophorbe lagenicaulis	1	ea.	5' Tall O.A
DTE	Bottle Palm	9	-	0// 0
PTEL	Ptychosperma elegans	9	ea.	26' Tall O.A
2116:	Solitare palm	-	-	10.011
PHCA	Phoenix canariensis	1	ea.	10' CW
	Canary Island Date Palm		₩	
THRA	Thrinax radiata	3	ea.	5' Tall O.A
	Thatch Palm		_	
VEMO	Veitchia montgomeryana	4	ea.	26' Tall O.A
	Montgomery Palm			
SHRUB	IS AND GROUNDCOVERS			
KEY	PLANT NAME	QTY.	UT.	SIZE
ARES	Ardesia escallanoides	27	ea.	6' Tall O.A
	Marlberry			
ALPU	Alpinia purpurata	13	ea.	24" x 24"
	Red Shell Ginger			
BATG	Bambusa textilis gracilis	12	ea.	8' Tall O.A, 7 culms min. per
	Graceful Bamboo	1		pot
CHIC	Chrysobalanus icaco	48	ea.	24" x 24", @ 30" O.C
	Cocoplum		1	, , ,
ERLI	Ernodea littoralis	216	ea.	18" x 18", @ 18" O.C
	Golden Creeper	1	-	
IXNG	Ixora chinensis 'Nora Grant'	48	ea.	18" x 18"
	Nora Grant Ixora	10.20	-	ATOMOTO .
NEBM	Nephrolepis biserrata "Macho"	16	ea.	3 Gal. Cans, Full
	Macho Fern	1,0	1	
NEEX	Nephrolepsis exaltata	87	ea.	1 Gal., 12" O.C
	Boston Fern	0,	-	
PSBA	Psychotria bahamensis	16	eg.	18" x 18"
July	Bahamas Wild Coffee	1,0		
РОМА	Podocarpus macrophylla	61	eq.	24" x 18"
5,704	Maki Yew	101	-	- 1 0 10
STJA	Stachytarpheta jamaicensis	8	eg.	24" x 18", @ 30" O.C
313A	Blue Porterweed	١	00.	2. 110, 6 50 0.0
TRDA	Tripsacum datyloides	2	ea.	3 gal cans, full
	Fakahatchee Grass	ľ	eu.	o gai cans, ion
MICCE			-	
	LLANEOUS	The same of the same of		I to be a control
sod	St. Augustine "Floratam"	as req.	s.f.	solid sod
	Planting Soil	as req.	c.y.	
	80% Silica Sand			
	20% Everglades Muck		4	1

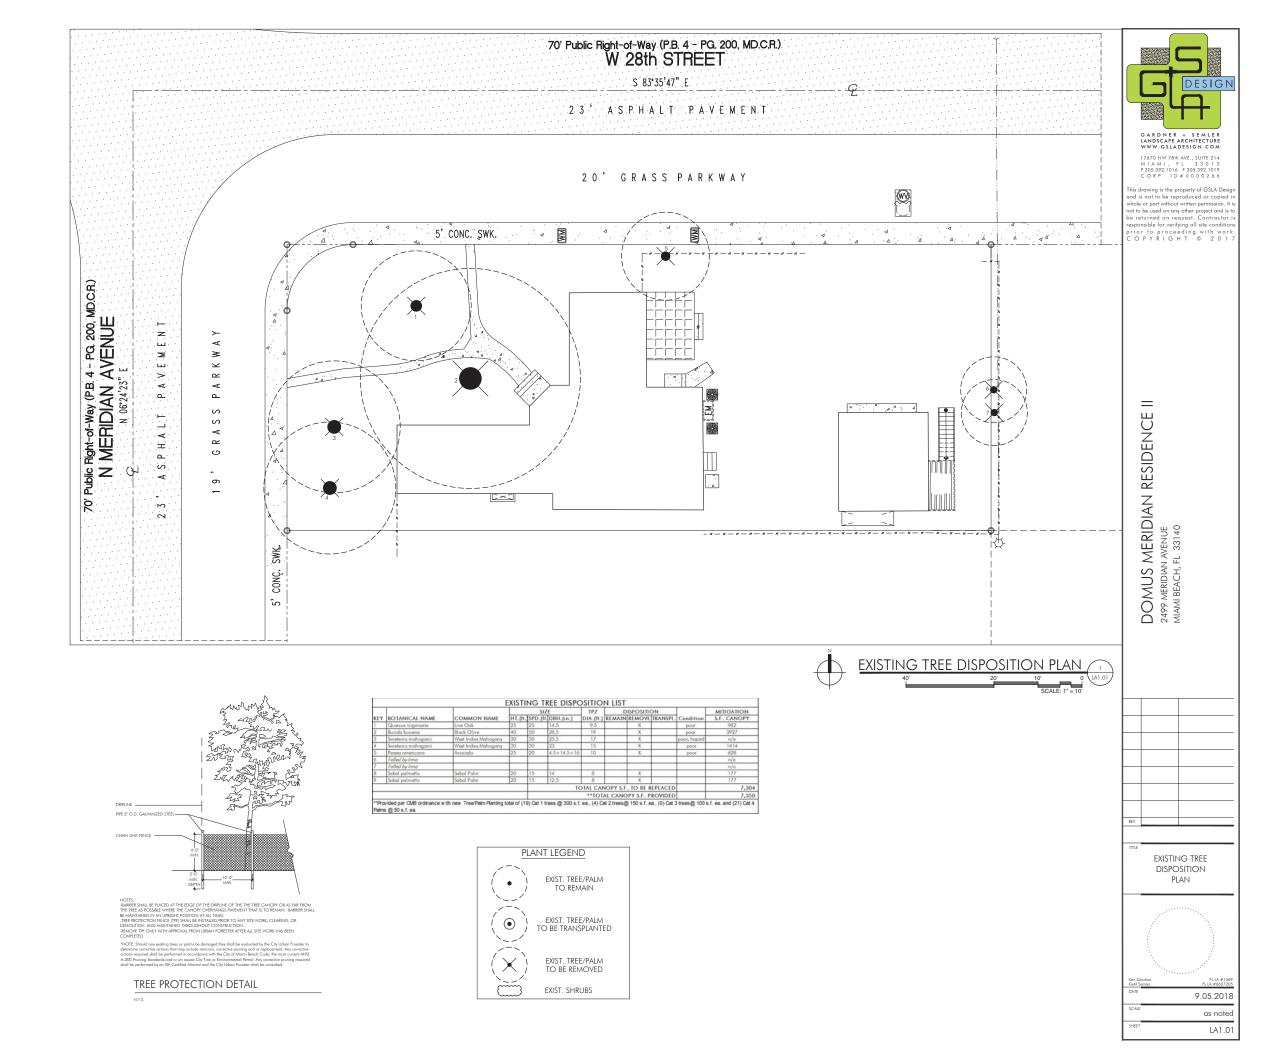CITY OF MIAMI BEACH LAN DSCAPE LEGEND INFORMATION REQUIRED TO BE PERMANENTLY AFFIXED TO PLANS Zoning DistrictRS-3				
INFORMATION REQUIRED TO BE PERMANENTLY AFFIXED TO PLANS Zoning DistrictRS-3Lot Area10,352Acres24 PERQUIRED/ ALLOWED		CITY OF MIAMI BEACH		
INFORMATION REQUIRED TO BE PERMANENTLY AFFIXED TO PLANS Zoning DistrictRS-3Lot Area10,352Acres24 PERQUIRED/ ALLOWED		LANDSCAPE LEGEND		
Zoning District RS-3 Lot Area 10,352 Acres 24 REQUIRED/ ALLOWED PROVIDED DPEN SPACE A. Square feet of required Open Space as indicated on site plan: Lot Area = 10,352 s.f.x % = s.f. 0 4524 (44%) B. Square feet of parking lot open space required as indicated on site Number of parking spaces 0 x 10 s.f. parking space = 0 0 0 C. Total square feet of landscaped open space required: A+B= 0 4524 (44%) LAWN AREA CALCULATION A. Square feet of landscaped open space required B. Maximum lawn area (sod) permitted = 50 % x 4,524 s.f. 2,262 2,256 TREES A. Number of trees required per lot (2 front yard + 3 back yard + 1 per 1000 s.f. above 6000 s.f. yard, less existing number of trees meeting minimum requirements = 10 12 B. % Natives required: Number of trees provided x 30% = 3 22 C. % Low maintenance / drought and salt tolerant required: Number of trees provided x 50% = 5 23 D. Street Trees (maximum average spacing of 20 o.c.) 205 linear feet along street divided by 20° = 11 11 E. Street tree species allowed directly beneath power lines: (maximum average spacing of 20 o.c.) 205 linear feet along street divided by 20° = 1 1 SHRUBS A. Number of shrubs required: Sum of lot and street trees req x 12 264 467 B. % Native shrubs required: Sum of lot and street trees req x 12 264 333 LARGE SHRUBS OR SMALL TREES A. Number of large shrubs or small trees required: Number of required shrubs x 10% = 27 39 B. % Native large shrubs or small trees required: Number of large shrubs or small trees required: Numbe				
ALLOWED PROVIDED A. Square feet of required Open Space as indicated on site plan: Lot Area = 10,352 _ s.f.x		•	res24	
A. Square feet of required Open Space as indicated on site plan: Lot Area =			REQUIRED/	
Lot Area =10,352s.f.x		OPEN SPACE	ALLOWED	PROVIDED
B. Square feet of parking lot open space required as indicated on site Number of parking spaces	Α.	Square feet of required Open Space as indicated on site plan:		
Number of parking spaces0 x 10 s.f. parking space = 0 0 4524 (44%) LAWN AREA CALCULATION A. Square feet of landscaped open space required B. Maximum lawn area (sod) permitted =50 % x4,524 s.f. 2,262 2,256 TREES A. Number of trees required per lot (2 front yard + 3 back yard + 1 per 1000 s.f. above 6000 s.f. yard, less existing number of trees meeting minimum requirements = 10 12 B. % Natives required: Number of trees provided x 30% = 3 222 C. % Low maintenance / drought and salt tolerant required: Number of trees provided x 50% = 5 23 D. Street Trees (maximum average spacing of 20' o.c.) 205 linear feet along street divided by 20° = 11 11 E. Street tree species allowed directly beneath power lines: (maximum average spacing of 20' o.c.): 20 linear feet along street divided by 20° = 1 1 SHRUBS A. Number of shrubs required: Sum of lot and street trees req x 12= 264 467 B. % Native shrubs required: Number of shrubs provided x 50% = 234 333 LARGE SHRUBS OR SMALL TREES A. Number of large shrubs or small trees required: Number of required shrubs x 10% = 27 39 B. % Native large shrubs or small trees required: Number of large		Lot Area =10,352 s.f.x % = s.f.	0	4524 (44%)
C. Total square feet of landscaped open space required: A+B= 0 4524 (44%) LAWN AREA CALCULATION A. Square feet of landscaped open space required B. Maximum lawn area (sod) permitted= _50% x _4,524s.f. 2,262 2,256 TREES A. Number of trees required per lot (2 front yard + 3 back yard + 1 per 1000 s.f. above 6000 s.f. yard, less existing number of trees meeting minimum requirements= 10 12 B. % Natives required: Number of trees provided x 30% = 3 22 C. % Low maintenance / drought and salt tolerant required: Number of trees orovided x 50% = 5 23 Number of trees rovided x 50% = 5 23 D. Street Trees (maximum average spacing of 20' o.c.) 205	В.	Square feet of parking lot open space required as indicated on site		
LAWN AREA CALCULATION A. Square feet of landscaped open space required B. Maximum lawn area (sod) permitted=50% x4,524s.f.		Number of parking spaces0 x 10 s.f. parking space =	0	0
A. Square feet of landscaped open space required B. Maximum lawn area (sod) permitted=50% x4,524s.f2,2622,256 TREES A. Number of trees required per lot (2 front yard + 3 back yard + 1 per 1000 s.f. above 6000 s.f. yard, less existing number of trees meeting minimum requirements=	C.	Total square feet of landscaped open space required: A+B=	0	4524 (44%)
A. Square feet of landscaped open space required B. Maximum lawn area (sod) permitted=50% x4,524s.f2,2622,256 TREES A. Number of trees required per lot (2 front yard + 3 back yard + 1 per 1000 s.f. above 6000 s.f. yard, less existing number of trees meeting minimum requirements=				
B. Maximum lawn area (sod) permitted=50 % x4,524 s.f.				
TREES A. Number of trees required per lot (2 front yard + 3 back yard + 1 per 1000 s.f. above 6000 s.f. yard, less existing number of trees meeting minimum requirements= 10 12 B. % Natives required: Number of trees provided x 30% = 3 22 C. % Low maintenance / drought and salt tolerant required: Number of trees provided x 50% = 5 23 D. Street Trees (maximum average spacing of 20' o.c.) 205 linear feet along street divided by 20' = 11 11 E. Street tree species allowed directly beneath power lines: (maximum average spacing of 20' o.c.): 20 linear feet along street divided by 20' = 1 1 SHRUBS A. Number of shrubs required: Sum of lot and street trees req x 12 = 264 467 B. % Native shrubs required: Number of shrubs provided x 50% = 234 333 LARGE SHRUBS OR SMALL TREES A. Number of large shrubs or small trees required: Number of large shrubs or small trees required: Number of large shrubs or small trees required: Number of large				
A. Number of trees required per lot (2 front yard + 3 back yard + 1 per 1000 s.f. above 6000 s.f. yard, less existing number of trees meeting minimum requirements= 8. % Natives required: Number of trees provided x 30% = 3 22 C. % Low maintenance / drought and salt tolerant required: Number of trees provided x 50% = 5 23 D. Street Trees (maximum average spacing of 20' o.c.) 205 linear feet along street divided by 20° = 11 11 E. Street tree species allowed directly beneath power lines: (maximum average spacing of 20' o.c.): 20 linear feet along street divided by 20° = 1 1 SHRUBS A. Number of shrubs required: Sum of lot and street trees req x 12° 264 467 B. % Native shrubs required: Number of shrubs provided x 50% = 234 333 LARGE SHRUBS OR SMALL TREES A. Number of large shrubs or small trees required: Number of required shrubs x 10% = 27 39 B. % Native large shrubs or small trees required: Number of large	В.	Maximum lawn area (sod) permitted=50 % x4,524 s.t.	2,262	2,256
A. Number of trees required per lot (2 front yard + 3 back yard + 1 per 1000 s.f. above 6000 s.f. yard, less existing number of trees meeting minimum requirements= 8. % Natives required: Number of trees provided x 30% = 3 22 C. % Low maintenance / drought and salt tolerant required: Number of trees provided x 50% = 5 23 D. Street Trees (maximum average spacing of 20' o.c.) 205 linear feet along street divided by 20° = 11 11 E. Street tree species allowed directly beneath power lines: (maximum average spacing of 20' o.c.): 20 linear feet along street divided by 20° = 1 1 SHRUBS A. Number of shrubs required: Sum of lot and street trees req x 12° 264 467 B. % Native shrubs required: Number of shrubs provided x 50% = 234 333 LARGE SHRUBS OR SMALL TREES A. Number of large shrubs or small trees required: Number of required shrubs x 10% = 27 39 B. % Native large shrubs or small trees required: Number of large				
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minimum requirements= 10 12 B. % Natives required: Number of trees provided x 30% = 3 22 C. % Low maintenance / drought and salt tolerant required: Number of trees provided x 50% = 5 23 D. Street Trees (maximum average spacing of 20' o.c.) 205_ linear feet along street divided by 20'= 11 11 E. Street tree species allowed directly beneath power lines: (maximum average spacing of 20' o.c.): 20_ linear feet along street divided by 20'= 1 1 SHRUBS A. Number of shrubs required: Sum of lot and street trees req x 12= 264 467 B. % Native shrubs required: Number of shrubs provided x 50% = 234 333 LARGE SHRUBS OR SMALL TREES A. Number of large shrubs or small trees required: Number of required shrubs x 10% = 27 39 B. % Native large shrubs or small trees required: Number of large Shrubs x 10% = 27 39	Α.			
B. % Natives required: Number of trees provided x 30% = 3 22 C. % Low maintenance / drought and salt tolerant required: Number of trees provided x 50% = 5 23 D. Street Trees (maximum average spacing of 20' o.c.) 205 linear feet along street divided by 20' = 11 11 E. Street tree species allowed directly beneath power lines: (maximum average spacing of 20' o.c.): 20 linear feet along street divided by 20' = 1 1 SHRUBS A. Number of shrubs required: Sum of lot and street trees req x 12 = 264 467 B. % Native shrubs required: Number of shrubs provided x 50% = 234 333 LARGE SHRUBS OR SMALL TREES A. Number of large shrubs or small trees required: Number of required shrubs x 10% = 27 39 B. % Native large shrubs or small trees required: Number of large 8. % Native large shrubs or small trees required: Number of large			10	12
C. % Low maintenance / drought and salt tolerant required: Number of trees provided x 50%= Street Trees (maximum average spacing of 20' o.c.)	B	·		
Number of trees provided x 50%= 5 23 D. Street Trees (maximum average spacing of 20' o.c.) _205_ linear feet along street divided by 20'= 11 11 E. Street tree species allowed directly beneath power lines: (maximum average spacing of 20' o.c.): _20_ linear feet along street divided by 20'= 1 1 1 SHRUBS A. Number of shrubs required: Sum of lot and street trees req x 12= 264 467 B. % Native shrubs required: Number of shrubs provided x 50%= 234 333 LARGE SHRUBS OR SMALL TREES A. Number of large shrubs or small trees required: Number of required shrubs x 10%= 27 39 B. % Native large shrubs or small trees required: Number of large K Native large shrubs or small trees required: Number of large		· · · · · · · · · · · · · · · · · · ·		
205 linear feet along street divided by 20' = 11 11 E. Street tree species allowed directly beneath power lines: (maximum average spacing of 20' o.c.): 20 linear feet along street divided by 20' = 1 1 SHRUBS A. Number of shrubs required: Sum of lot and street trees req x 12 = 264 467 B. % Native shrubs required: Number of shrubs provided x 50% = 234 333 LARGE SHRUBS OR SMALL TREES A. Number of large shrubs or small trees required: Number of required shrubs x 10% = 27 39 B. % Native large shrubs or small trees required: Number of large			5	23
E. Street tree species allowed directly beneath power lines: (maximum average spacing of 20' o.c.): 20 linear feet along street divided by 20'= 1 1 SHRUBS A. Number of shrubs required: Sum of lot and street trees req x 12= 264 467 B. % Native shrubs required: Number of shrubs provided x 50%= 234 333 LARGE SHRUBS OR SMALL TREES A. Number of large shrubs or small trees required: Number of required shrubs x 10%= 27 39 B. % Native large shrubs or small trees required: Number of large	D.	Street Trees (maximum average spacing of 20' o.c.)		
(maximum average spacing of 20' o.c.):		205 linear feet along street divided by 20'=	11	11
SHRUBS A. Number of shrubs required: Sum of lot and street trees req x 12= 264 467 B. % Native shrubs required: Number of shrubs provided x 50%= 234 333 LARGE SHRUBS OR SMALL TREES A. Number of large shrubs or small trees required: Number of required shrubs x 10%= 27 39 B. % Native large shrubs or small trees required: Number of large	E.			
SHRUBS A. Number of shrubs required: Sum of lot and street trees req x 12= 264 467 B. % Native shrubs required: Number of shrubs provided x 50%= 234 333 LARGE SHRUBS OR SMALL TREES A. Number of large shrubs or small trees required: Number of required shrubs x 10%= 27 39 B. % Native large shrubs or small trees required: Number of large		, , , ,		
A. Number of shrubs required: Sum of lot and street trees req x 12= 264 467 B. % Native shrubs required: Number of shrubs provided x 50%= 234 333 LARGE SHRUBS OR SMALL TREES A. Number of large shrubs or small trees required: Number of required shrubs x 10%= 27 39 B. % Native large shrubs or small trees required: Number of large		20 linear feet along street divided by 20'=	1	1
A. Number of shrubs required: Sum of lot and street trees req x 12= 264 467 B. % Native shrubs required: Number of shrubs provided x 50%= 234 333 LARGE SHRUBS OR SMALL TREES A. Number of large shrubs or small trees required: Number of required shrubs x 10%= 27 39 B. % Native large shrubs or small trees required: Number of large				
B. % Native shrubs required: Number of shrubs provided x 50%= 234 333 LARGE SHRUBS OR SMALL TREES A. Number of large shrubs or small trees required: Number of required shrubs x 10%= 27 39 B. % Native large shrubs or small trees required: Number of large		SHRUBS		
B. % Native shrubs required: Number of shrubs provided x 50%= 234 333 LARGE SHRUBS OR SMALL TREES A. Number of large shrubs or small trees required: Number of required shrubs x 10%= 27 39 B. % Native large shrubs or small trees required: Number of large	Α.	Number of shrubs required: Sum of lot and street trees reg x 12=	264	467
LARGE SHRUBS OR SMALL TREES A. Number of large shrubs or small trees required: Number of required shrubs x 10%= 27 39 B. % Native large shrubs or small trees required: Number of large	B.	% Native shrubs required: Number of shrubs provided x 50%=		
A. Number of large shrubs or small trees required: Number of required shrubs x 10%= 27 39 B. % Native large shrubs or small trees required: Number of large			234	
A. Number of large shrubs or small trees required: Number of required shrubs x 10%= 27 39 B. % Native large shrubs or small trees required: Number of large		LARGE SHRUBS OR SMALL TREES		
B. % Native large shrubs or small trees required: Number of large	Α.			
· · · · · · · · · · · · · · · · · · ·		shrubs x 10%=	27	39
shrubs or small trees provided x 50%=1427	В.	, ,		
		shrubs or small trees provided x 50%=	14	27



MITIGATION PLANTING: -(19) Cat 1 trees @ 300 s.f. ea. -(4) Cat 2 trees@ 150 s.f. ea. -(0) Cat 3 trees@ 100 s.f. ea. -(21) Cat 4 Palms @ 50 s.f. ea.

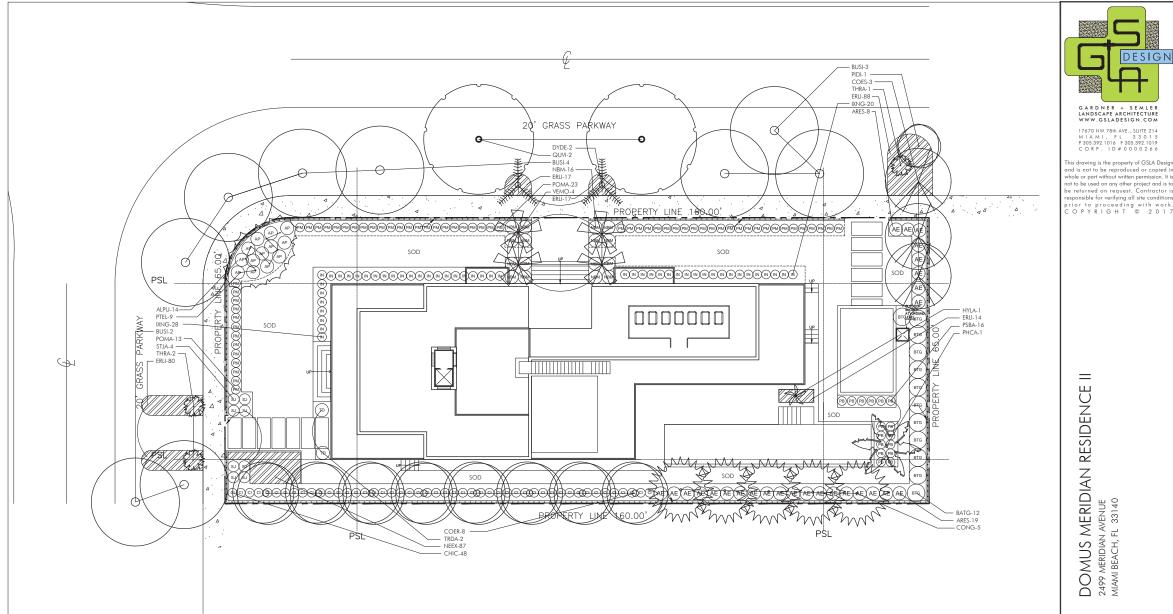



LANDSCAPE SPECIFICATIONS PART 1 - GENERAL

1.1 SCOPE A. Contractor shall provide all labor, materials, equipment, supervision, and related work necessary to complete the landscape work in accordance with the intent of the landscape plans, schedules and these specifications. The extent of work is shown on the drawings which are a part of this document.

1.2 CONTRACTOR QUALIFICATIONS

1.2 CONTINUE TO COMMITTICATION.

A Landscape installation work to be performed by a Contractor Certified by the Florida
Nurseymen, Growers and Landscape Association (FNGLA) as a Certified Landscape
Contractor. Any gruning to be supervised by an Arboris, certified by the International Sor
of Arboriculture (ISA) and licensed in Miami-Dade County.

A. Only materials specified will be accepted, unless approved in writing by the Landscape

1.5 PLANT SIZES

A. All plant sizes shall equal or exceed the minimum sizes as specified in the plant list. Wher plant sizes are specified as a range of size, installed materials shall average the mean of the range specified. Plants shall be measured following pruning, with branches in normal position. All necessary pruning shall be done at the time of planting.

1.6 PLANT QUALITY A. All plant material shall be equal to or better than Florida No. 1 as classified by "Grades and Standards for Nursery Flants" by the Division of Plant Industry, Florida Department of Agriculture. They shall have a gra

C. CIRCLING ROOTS FOUND ON CONTAINER-GROWN MATERIAL WILL NOT BE ACCEPTED UNLESS REMEDIAL ROOT PRUNING, APPROVED BY THE LANDSCAPE ARCHITECT IS DONE BEFORE PLANTING.

A. The plant quantities shown on the plant list are to be used only as an aid to bidders. In the case of discrepancy between the plant list and the plan, the quantity on the plan shall override the plant list.

1.8 UNIT PRICES

1.8 UNIT PRICES
A. The successful bidder shall furnish to the Owner and the Landscape Architect, a unit price breakdown for all materials. The Owner may, at his discretion, add to or delete from the materials utilizing the unit price breakdown submitted to and accepted by the Owner.

A. Fertilizer: The Contractor shall submit to the Owner and Landscape Architect documentation that all the fertilizer used for the project is of the analysis specified and place at the rates specified in section 2.2 FERT

cu. Ft.) for approval by the Landscape Architect prior to delivery to the site

1.10 CLEAN-UP & MAINTENANCE OF TRAFFIC A. Follow procedures in FDOT Index 600 for mainter

1.11 MAINTENANCE PRIOR TO ACCEPTANCE
A. The Contractor is responsible to maintain the plantings until they are accepted under the provisions of 1.12 "ACCEPTANCE OF INSTALLATION".

1. Plants: Begin maintenance immediately following the final plant installation operation for each plant and continue until all plant installation is complete and accepted. Maintenance with linclude wetering all plants, weeting, mulching, peat and disease control, fightening and repairing of guys, repair of braces, removal of dead growth, resetting of plants to proper grade or up-right position, restoration of plant soucer, litter pick-up in plant beds and other necessary operations to assure specified minimum grade of Florida No. 1.

2. Turf Areas: Begin maintenance of turf immediately following the placement of sod and confinue until sod installation is complete and accepted. Maintenance shall include but not be limited to, valering, leveling, moving, weed and pest control, fungus and disease control and other necessary operations as determined by the Landscape Architect and good nursery practice.

3. Re-setting or straightening trees and palms: The Contractor shall re-set and/or straighten trees and palms as required at no additional cost to the Owner unless caused by sustained winds of 75 mph or more. Then, the costs of the operations may be charged to the owner. Re-set trees within 48 hours.

submitted by the Contractor at least ten (10) days prior to the anticipated date.

1.13 GUARANTEE
A. Guarantee all plants for a period of one year (CCD). Guarantee shall commence from the date of within coceptance. Plant material which is on the site and scheduled to be relocated is not covered by the guarantee except in the case of Contractor's negligence or work that has been done in an unworkman-like manner. The Contractor is not responsible for loss due to acts of god, (i.e.) sustained winds of 75 mph or more, floods, frost, lightning, vandalism or their.

1.14 REPLACEMENT

A. Replacement shall be mode during the guarantee period as directed by the Landscape
Architect within ten (10) days from time of notification. For all replacement plant material,
the guarantee period shall extend for an additional forty-five (45) days beyond the original
guarantee period. The Contractor shall be responsible to provide water to the replacement
plants in sufficient quantity to aid in their establishment. At the end of the guarantee period,
inspection and submitted by the Contractor of least five (5) days before the anticipated date.
Replacement plants must meet the requirements of Florida Nb. 1 after of inspection.
Replacement plants must need the requirement of Florida Nb. 1 after of inspection,
determined by the Landscape Architect. Replace these and any plants misking due to the
Contractor's needlosnes as soon as conditions certifi-

indicated on the plant list. The Contractor shall supply and plant the plants as specified

2. Cost of Replacements: A sum sufficient to cover the estimated cost of possible replacements, including material and labor will be retained by the Owner and paid to the Contractor after all replacements have been satisfactorily made and approved by the

PART 2 - MATERIALS

2.1 PLANTING SOIL
A. Planting soil for trees, shrubs and ground covers shall be of the composition noted of

B. Soil for Sodded Areas: shall be coarse lawn sand.

2.2 FERTILIZER
A. Fertilizer for trees, polms, shrubs, and groundcovers shall be as follows: LESCO Palm Special 13-3-13 or equal, Suffer coated with into and other minor elements and maximum of 2% chlorine, or brand with equal analysis. The fertilizer shall be uniform in composition, dry and free flowing and shall be delivered to the site in the original unopened containers, bearing the manufacturer's guaranteed analysis. Fertilizer for sod and seeded areas shall be 8-6-8, 50% organically derived nitrogen, or equal.

2.3 WALEX
A. The Controctor shall provide potable water on site, available from the start of planting. The Controctor is responsible to ascertain the location and accessibility of the water source. The Controctor is responsible to provide the means of distribution (i.e. water truck, hoses, etc.) for distribution of water to the planting areas.

2.5 ROOT BARRIER MATERIAL
A. Root barrier material shall be 24" deep polypropolylene panels by DeepRoot or approved equal.

B. Install per details in the plans.

PART 3 - INSTALLATION PROCEDURES

Verify location of all underground utilities and obstructions prior to excauntion

3.2 HERBICIDE TREATMENT

A. In all areas infected with weed and/or grass growth, a systemic herbicide, such as
Roundup, shall be applied per manufacturer's rates. When it has been established where
work will be done, the systemic herbicide shall be applied in accordance with manufacturer's
labeling to kill all nacious growth. Contractors that sheaked his twork to allow more than or
application to a obtain at least 95% kill of undestrable prowth. If necessary, Contractors shall applicate to the consolibility and the second-traced professors to be successful.

3.3 PLANT PIT EXCAVATION AND BACKFILLING A. Trees: See the Planting and Bracing Details and notes.

B. All planting holes shall be hand dug where machine dug holes may adversely affect C. Shrubs and Groundcover: Shrubs and groundcover shall be planted in a soil bed as described in the notes and details. Space shrubs and provide setback from curb and povements as shown in the plans.

D. Watering of field-grown plants: Thoroughly puddle in water to remove any air pockets in

3.4 WALKING.
A. The Controtor is responsible to provide the water for all new plants and transplants and means of distribution (i.e. hand watering or water truck) during the maintenance period and reactioning into the period offer acception will the full schedule as listed below is complete. Water for trees and other longe field grown plants shall be supplemented by hand or water truck, in addition to the irrigidation system, (if one is provided). Contractor can adjust waterin schedule during heavy rain season upon approval of the Landscape Architect.

AMOUNT OF WATER PER APPLICATION For trees up to 5 inch caliper - 5 gallons From 5 to 8 inch caliper - 25 gallons

9 inch and up caliper - 50 gallons

FREQUENCY OF WATER

time per week for weeks 9 - 12

soil around the root ball.

C. Water shrubs, sod and groundcover a minimum of once daily for a week or until an irrigation system is fully operational. If no irrigation system is to be installed, the Contract shall be responsible for watering the shrub, sod, and groundcover for the time specified above, after installation of each section of the planting installed.

.3. TEXTILLING.
Add fertilizer on top of the surface of shrubs beds and tree and polms root balls two [2].
Add fertilizer on top of the surface of shrubs beds and tree and polms root balls two [2] on the installation. Fertilize shall be applied after soil has been well moistened. Fertilizer shall be washed off of plant leaves and stems immediately after application. Apply at the additional posters.

Trees and Large Shrubs: One (1) pound per inch of trunk digmeter, spread evenly over

3. Groundcover: Twelve (12) pounds per 100 sq. ft. of bed area.

3.6 MULL-HING
A. Spread mulch the (2) inches thick uniformly over the entire surface of shrubs and groundcover beds, depth measured after settling, unless otherwise specified in the plans. Provide 36" diameter bed of mulch, measured from outer edge of the trunk, for all trees and palms planted in sod areas. Keep mulch away from contact with the trunk. Create a 6" high ring of mulch at the outer edge of tree and palm holes.

3.8 SODDING A. Provide a blanket of lawn sand as described in the notes in these plans. Prior to planting, remove stones, stacks, etc. from the sub-soil surface. Excavate existing non-conforming soil as required so that the finish grade of soil as flush with adjacent powement or top of curb as well as adjacent soil in the case of soil parching.

C. Keep edge of sod bed a minimum of 18" away from groundcover beds and 24" away from edge of shrub beds and 36" from trees, measured from the edge of plant or tree trunk

D. Sod shall be watered immediately after installation to uniformly wet the soil to at least two inches below the bottom of sod strips.

E. Apply fertilizer to the sod as specified in Section 3.5.

F. Excavate and remove excess soil so top of sod is flush w/top of curb or adjacent

PLANT BED PREPARATION NOTES

1. In all areas where new sod and shrub and groundcover masses are to be plante kill all existing weeds by treating with Round-up prior to beginning soil preparation.

2. In all shrub and groundcover beds, prepare soil as described for either condition over the entire area to be planted:

Common of the date and base or asphalt or rocky soil is encountered, remove compacted that after a lentiley to allow an 15° depth of parting soil. Backfill the entire area of the shrut and groundcover beds with 15° planting soil, as specified in Plans) to within 2 hence of the adjacent pavener or top of cut. Remove all debris and rocks and pebbes larger than 2 linches in size and level the grade before planting.

Whereion or compacted soil is encountered, thoroughly mix 6 inches of planting soil into the existing soil to a depth of 18 inches. If required, excavate and remove the existing soil to lower the grade, so that the prepared mix is finished to a minimum or 2 inches below top of curb or adjacent walkway. Remove all debris and rocks and peobles larger than 2 inches in size and level the grade before planting.

For all sod areas, spread a 2" deep layer of lawn sand prior to sodding. Remove all debris and rocks and pebbles larger than 2 inchs in size and level the grade before sodding. Remove, if required, existing soil so that top of sod is flush with and adjacent top of curb or pavement.

Plants shall be planted sufficiently away from edges of pavements or curbs, to allow for growth toward the edges of the bed.

NOXIOUS BUILDING SUPPLIES OR CHEMICALS WITHIN THE DRIP LINE.

CLEAN LINE ALUMINUM LANDSCAPE EDGING

□ ½" X 5½" (3.2MM X 140MM). w/ 0.135" (3.43MM) EXPOSED TOP LIP

0.072" (1.82MM) THICK FINISH LEGEND:

NOTES:


INSTALL PER MANUFACTURER'S "INSTALLATION GUIDELINES"

- "INSTALLATION GUIDELINES"

 2. 8'-0" (2.44 M) SECTIONS TO INCLUDE


 2. (3) 12" (305 MM) ALUMINUM STAKES.
 16:0" (4.88 M) SECTIONS TO
 INCLUDE (5) 12" (305 MM)

 ALUMINUM STAKES.
 CORNERS CUT BASE EDGING UP
 HAI EWAY AMD
- 5. PERMALOC CLEANLINE AS MANUFACTURED BY FERMALOC CORPORATION, HOLLAND MI. (800) 356-9660,

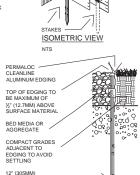


ALUMINUM STAKES -TO LOCK INTO

ALUMINUM EDGING DETAIL

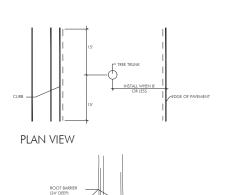


ROOT BARRIER INSTALLATION DETAIL

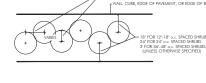

SHRUB SPACING DIAGRAM

SHRUB INSTALLATION DETAIL

FERTILIZER SHALL BE INSTALLED AS PER THE
 WRITTEN SPECIFICATIONS

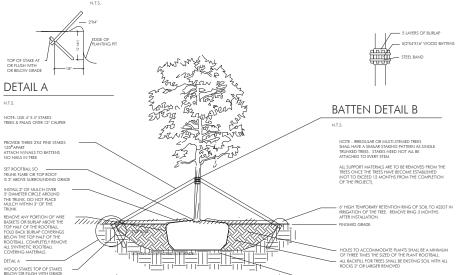


PLANTING & BRACING DETAIL UNDER 3 1/2" CALIPER

SET KOUTBALL SO
TRUNK FLARE OR TOP ROOT
IS 2" ABOVE SURROUNDING GRADE

IGHTLY COMPACTED SUBGRADE DETAIL A PLANTING & BRACING DETAIL FOR LEANING/CROOKED PALMS

BATTEN DETAIL B

MULTI-TRUNKED TREE/PALM BRACING DETAIL

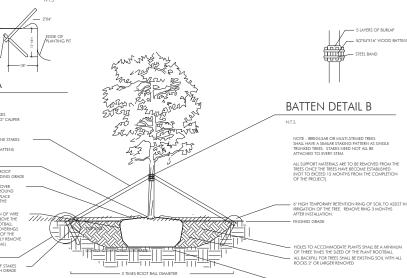

PLANTING & BRACING DETAIL OVER 3 1/2" CALIPER

DETAIL A

CURVED TRUNK LEAN ANGLE

NOTE- USE 4" X 4" STAKES PALMS OVER 12" CALIPER

N.T.S.

DESIGN GARDNER + SEMLER LANDSCAPE ARCHITECTURE WWW.GSLADESIGN.COM 17670 NW 78th AVE., SUITE 214 M | A M | , F L 3 3 0 1 5 P 305.392.1016 F 305.392.1019 C O R P . | | D # 0 0 0 0 2 6 6

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RESIDENCE MERIDIAN

DOMUS

PLANTING SPECS AND DETAILS

9.05.2018

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