

	PLANTING SCHEDULE				
KEY	TAG	QTY	LATIN NAME	COMMON NAME	SPECS
\Diamond	SB	4*	Conocarpus erectus	Silver Buttonwood	6'sp, 12'-14'oa, 3"caliper
\otimes	CD	4*	Cocoloba diversifolia	Pigeon Plum	6'sp 12'-14'oa, 3" caliper
*	CN	6	Cocos nucifera	Coconut Palm	12'sp, 25'oa
	MF	6*	Myrcianthes fragrans	Simpson Stopper	6'sp, 12'-14'oa, 3" caliper
0	НР (16*	Hamelia patens	Firebush	10'ht., 4'spr., 4' c.t.
\odot	MD	24	Monstera deliciosa	Monstera	3g, 18" oa, 24"oc
	cc	07	Chamaedorea cataractarum	Cat Palm	7g, 30"sp, 30"oc
	CE {	146*	Conocarpus erectus	Silver Buttonwood	3g, 24"sp, 24"oc
	FM {	206	Ficus microcarpa	Green Island Ficus	3g, 12"oa, 18"oc
	MC {	44*	Muhlenbergia capillaris	Muhly Grass	3g, 24"oa, 24"oc
	HD	152*	Helianthus debilis	Beach Dune Sunflower	1g, 12"sp, 12"oc
	EL	120*	Ernodea littoralis	Beach Creeper	1g, 12"sp, 12"oc
* * * * * * * * * * * * * * * * * * *	AG {	316	Arachis glabrata	Perennial Peanut	1g, 12"sp, 12oc
	SOD {	472 SF	St. Augustine Palmetto Sod		

PLANT SCHEDULE

		CITY OF MIAMI BEACH LANDSCAPE LEGEND		
Zoning	g District RM-1 Lot Area 11500 SF	Acres 0.26		
		OPEN SPACE	REQUIRED/ALLOWED	PROPOSED
A	Square feet of required open space as indicated on plan:	Lot area = <u>11500</u> s.f. x <u>30</u> % = <u>3450</u> s.f.	3450	3634
В	Square feet of parking lot open space required as indicated on site plan:	Number of parking spaces $\frac{14}{}$ x 10 s.f. parking space =	140	184
С	Total square feet of landscaped open space required:	A + B =	3590	3818
	LA	WN AREA CALCULATION		
Α	Square feet of landscaped open space required:	3450	3450	2781
В	Maximum lawn (sod) permitted:	60_ % x <u>3450</u> _s.f.	2070	472
		REQUIRED/ALLOWED	PROPOSED	
Α	Number of trees required per lot or net lot acre, less existing number of trees meeting minimum requirements (2 palms = 1 tree):	28_ trees x26_ net lot acres - number of existing trees =	8	8
В	% Natives required:	Number of trees provided x 30% =	5	6
С	% Low maintenance / drought and salt tolerant required:	Number of trees provided x 50% =	8	8
D	Street trees (maximum average spacing of 20' o.c.):	NA linear feet along street /20' =	NA	NA
E	Street tree species allowed directly beneath power lines (maximum average spacing of 20' o.c.):	$_{100}$ linear feet along street/20' =	5	6
F	Total number of trees provided:		13	14
		SHRUBS		
Α	Number of shrubs required:	Sum of lot and street trees required x 12 =	156	420
В	% Native shrubs required:	Number of shrubs provided x 50% =	78	190
		LARGE SHRUBS OR SMALL TREES		
Α	Number of large shrubs required	Number of required shrubs * 10% =	16	16
В	% Native required	Number of large shrubs or small trees provided * 50%=	8	16





ALL IDEAS DESIGNS, ARRANGEMENTS AND PLANS INDICATED OR REPRESENTED BY THIS DRAWINGS ARE OWNED BY, AND THE PROPERTY OF THIS OFFICE AND WERE CREATED, EVOLVED AND DEVELOPED, USE ON, AND IN CONNECTION WITH THE SPECIFIED PROJECT. NONE OF SUCH IDEAS, DESIGNS, ARRANGEMENTS OR PLANS SHALL BE USED BY OR DISCLOSED TO ANY PERSON, FIRM OR CORPORATION FOR ANY PURPOSE WHATSOEVER WITHOUT THE EXPRESSLY WRITTEN PERMISSION OF Plantaysia LLC

HAEL THIEL DSCAPE DESIGNER

OJECT TITLE

7925-7935 CRESPI BLVD.

7925-7935 Crespi Blvd. Miami Beach, FL 33141

SHEET INDEX

L1.0 LANDSCAPE PLAN

L2.0 DETAILS

SHEET TITLE

LANDSCAPE PLAN


DATE 05/04/18

DRAWN BY MH

CHECKED BY MT


SHEET NUMBER


L1.0
REV A 07/16/18

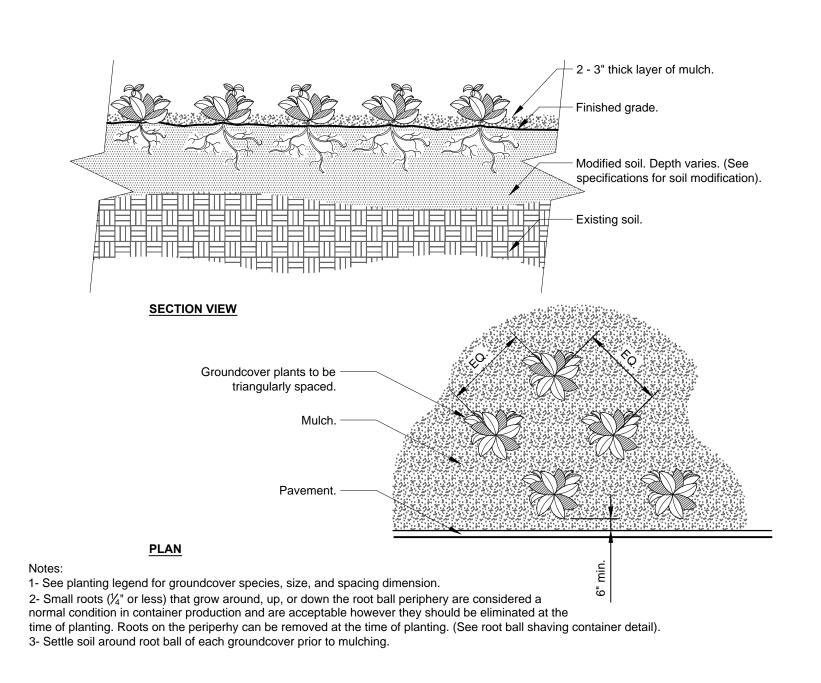

GROUND COVER PLANTING DETAIL

SCALE: 3/4" =1'-0"

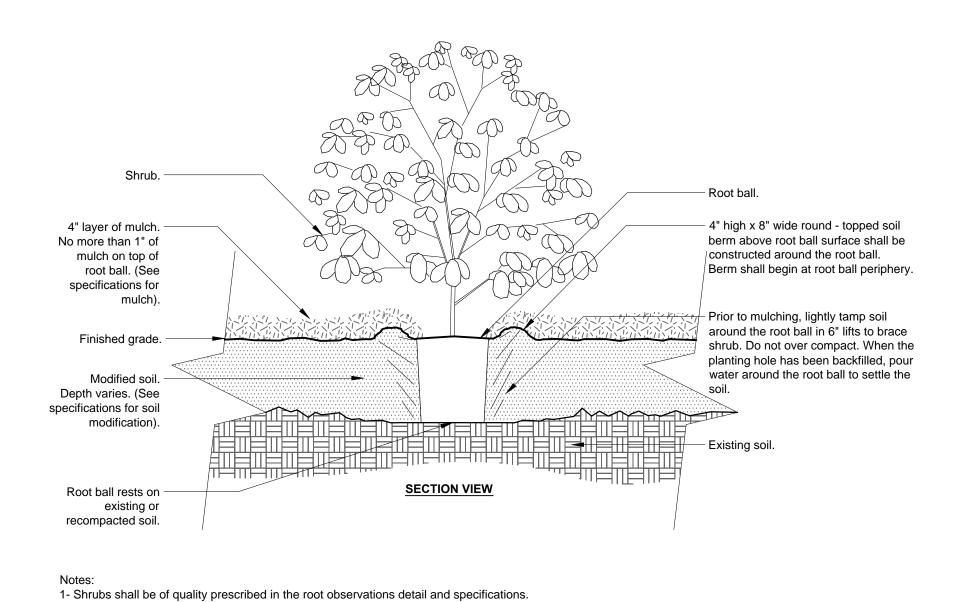


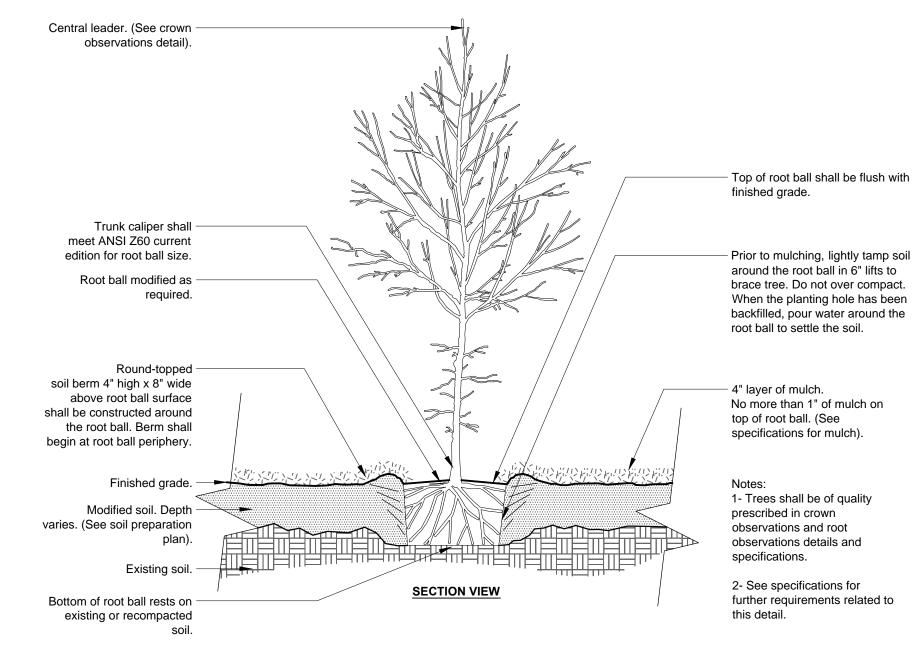



2- See specifications for further requirements related to this detail.



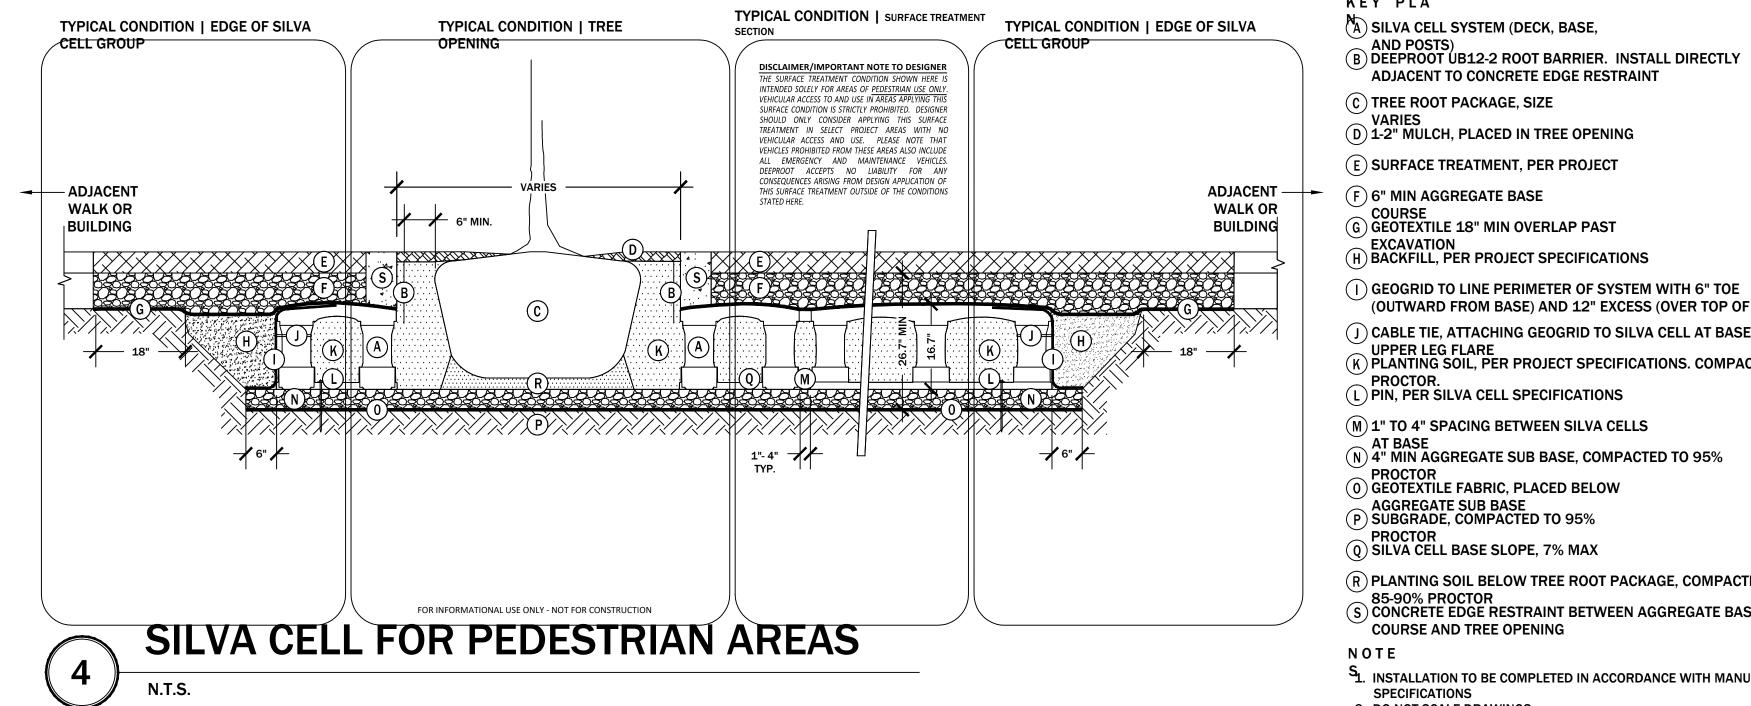

ADJACENT TO CONCRETE EDGE RESTRAINT (C) TREE ROOT PACKAGE, SIZE (D) 1-2" MULCH, PLACED IN TREE OPENING **E** SURFACE TREATMENT, PER PROJECT (F) 6" MIN AGGREGATE BASE COURSE
(G) GEOTEXTILE 18" MIN OVERLAP PAST **EXCAVATION** (H) BACKFILL, PER PROJECT SPECIFICATIONS () GEOGRID TO LINE PERIMETER OF SYSTEM WITH 6" TOE (OUTWARD FROM BASE) AND 12" EXCESS (OVER TOP OF DECK) (J) CABLE TIE, ATTACHING GEOGRID TO SILVA CELL AT BASE OF UPPER LEG FLARE

(K) PLANTING SOIL, PER PROJECT SPECIFICATIONS. COMPACTED TO 70-80% L) PIN, PER SILVA CELL SPECIFICATIONS M) 1" TO 4" SPACING BETWEEN SILVA CELLS AT BASE
(N) 4" MIN AGGREGATE SUB BASE, COMPACTED TO 95% PROCTOR

O GEOTEXTILE FABRIC, PLACED BELOW AGGREGATE SUB BASE
P SUBGRADE, COMPACTED TO 95% PROCTOR

SILVA CELL BASE SLOPE, 7% MAX (R) PLANTING SOIL BELOW TREE ROOT PACKAGE, COMPACTED TO 85-90% PROCTOR
S CONCRETE EDGE RESTRAINT BETWEEN AGGREGATE BASE COURSE AND TREE OPENING NOTE S₁. INSTALLATION TO BE COMPLETED IN ACCORDANCE WITH MANUFACTURER'S 2. DO NOT SCALE DRAWINGS 3. PROVIDE SUPPLEMENTAL IRRIGATION FOR SEASONAL DROUGHT SUPPORT **OF TREES & SOIL**

plantasia

OFFICE AND WERE CREATED, EVOLUED AND
DEVELOPED, USE ON, AND IN CONNECTION
WITH THE SPECIFIED PROJECT. NONE OF SUCH
IDEAS, DESIGNS, ARRANGEMENTS OR PLANS
SHALL BE USED BY OR DISCLOSED TO ANY
PERSON, FIRM OR CORPORATION FOR ANY
PURPOSE WHATSOEVER WITHOUT THE EXPRESSLY
WRITTEN PERMISSION OF Plantaysia LLC

MICHAEL THIEL LANDSCAPE DESIGNER

7925-7935 CRESPI BLVD.

7925-7935 Crespi Blvd. Miami Beach, FL 33141


L1.0 LANDSCAPE PLAN

L2.0 DETAILS

SHEET TITLE

DEATILS

DATE	05/04/18	
DRAWN BY	МН	
CHECKED BY	MT	
SHEET NUMBER		

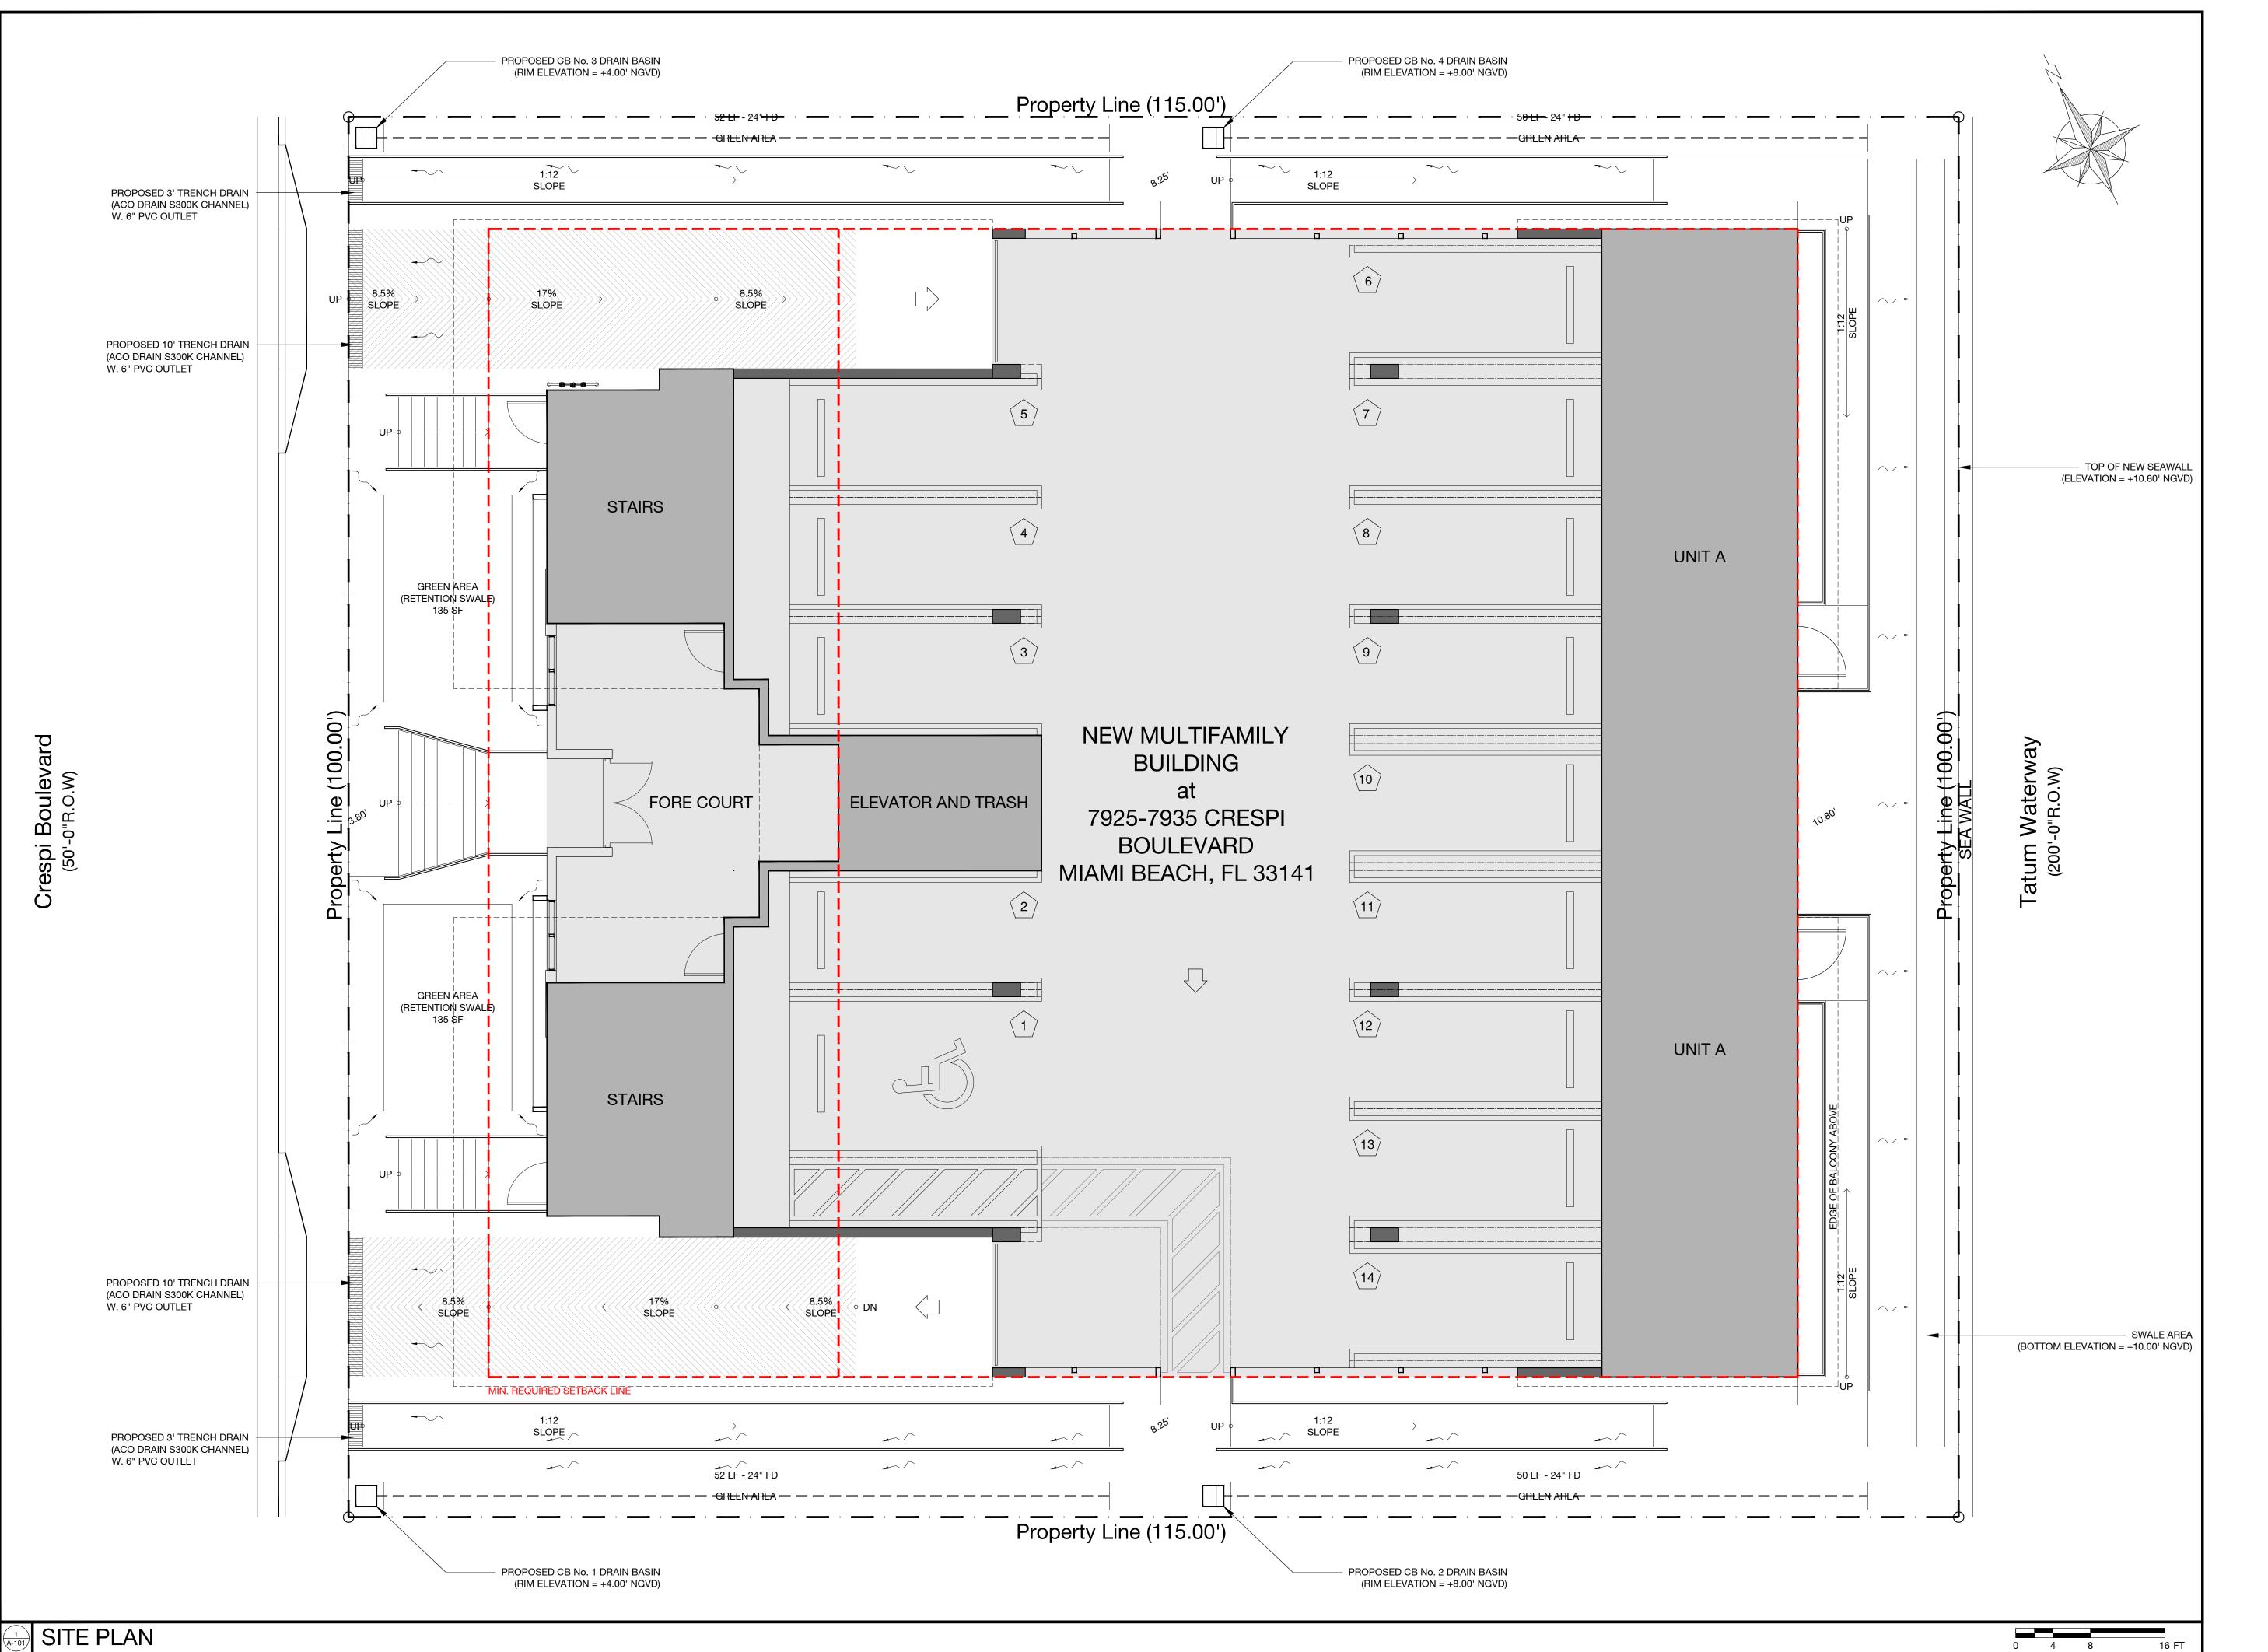

NOBE