



CITY MAP SCALE : N.T.S.


	DRAWING INDEX					
SHEET NUMBER	SHEET NAME	SHEET NUMBER	SHEET NAME	SHEET NUMBER	SHEET NAME	SHEET
DØ.Ø	COVER	D2.1.1	LOT COVERAGE	D3.Ø	GROUND FLOOR PLAN	
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DØ.2	SURVEY			D3.2	ROOF DECK PLAN	D6.Ø
				D3.3	ROOF PLAN	
				D4.Ø	FRONT ELEVATION (NORTHEAST)	
				D4.Ø.2	ENTRY ELEVATION/SECTION (SOUTHWEST)	D6.3
DØ.4	EXISTING AERIAL CONTEXT					L1.1
DØ.5	NEIGHBORHOOD CONTEXT					L2.1
DØ.6	EXISTING STREETSCAPE					L2.2
DØ.6.1	PROPOSED STREETSCAPE					
DØ.1	AERIAL SITE CONTEXT	D2.3	AREA CALCULATION AND KEY PLANS			
		D2.4	UNIT SIZE - GROUND FLOOR	D4.2.3	ENTRY SIDE ELEVATION (SOUTHEAST)	
D1.Ø	FRONT RENDERING A	D2.5	UNIT SIZE - SECOND FLOOR	D4.3	RIGHT SIDE ELEVATION (NORTHWEST)	
D1.1	FRONT RENDERING B	D2.6	UNIT SIZE - ROOF PLAN	D4.3.1	PARTIAL RIGHT SIDE ELEVATION (NORTHWEST)	
		D2.7	AXONOMETRIC DIAGRAM			
		D2.8	WAIVER DIAGRAM - MAXIMUM SECOND FL. UNIT SIZE			
D2.Ø	ZONING DATA & CALCS. /COD REFERENCES					
D2.1	SETBACKS DIAGRAM					

SITE LOCATION AND INDEX

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STUDIO INC. ARCHITECTURE REGISTRATION NO. : AA 0002588 ANTONIO E. RODRIGUEZ, ARCHITECT AR93309 4808 southwest 72nd Ave. miami florida 33155 telephone (305)662-1008

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]
	SHEET		-
ET NAME	NUMBER	SHEET NAME	
IND FLOOR PLAN]
ND FLOOR PLAN			1
DECK PLAN	D6.Ø	NORTH AXONOMETRIC VIEW	
PLAN			
T ELEVATION (NORTHEAST)			-
Y ELEVATION/SECTION (SOUTHWEST)	D6.3	EAST AXONOMETRIC VIEW	1
	L1.1	EXISTING TREE DISPOSITION PLAN	-
	L2.1	PROPOSED SITE LANDSCAPE PLAN	-
	L2.2	LANDSCAPE DETAILS	-
			-
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IAL RIGHT SIDE ELEVATION (NORTHWEST)			-
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ΤΛ			
RESIDENCE FOR :			
INC. MR. &	MP	S. SARRIA date 1/	
INC. MR. X	$\bot \mathbb{A} T \to \mathbb{A}$	$\bigcirc \cdot \bigcirc \vdash \blacksquare \lor \blacksquare \lor \blacksquare \land \blacksquare \land$	et no.
64 PALM AVENUE		MIAMI BEACH, FLORIDA 🛛 🛌	\sim 1
362-1008			arphi.

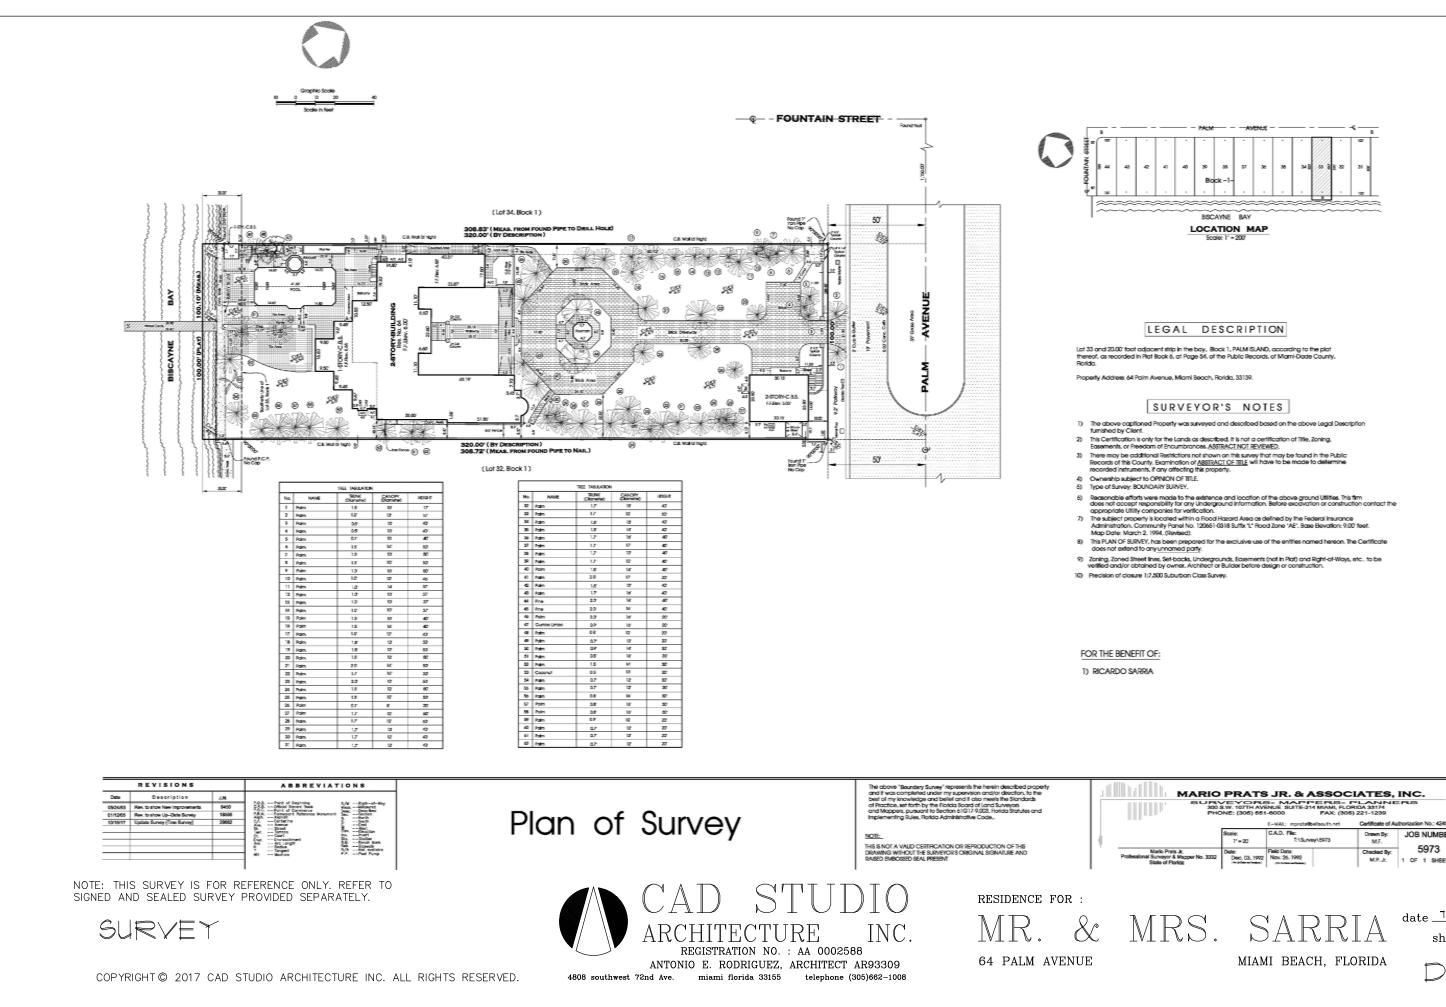

ī	MARIO PRATS JR. & ASSOCIATES, INC.
ľ	SURVEYORS- MAPPERS- PLANNERS 300 S.W. 107TH AVENUE SUITE-214 MIAMI, FLORIDA 33174 PHONE: (305) 551-6000 FAX: (305) 221-1239

		E-WAL: mprots@bellsouth.net	Certificate of Au	thon2stion No.: 4249
	Scale: 1'=20	C.A.D. File: T:\Suivey\S973	Drawn By: M.F.	JOB NUMBER
lario Prats Jr. unveyor & Mapper No. 3332 talle of Florida		Field Date: Nov. 25. 1992	Checked By: M.P.Jr.	5973 1 OF 1 SHEETS

date <u>7 / 6</u> / 18

sheet no. DØ.2









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RESIDENCE FOR : 64 PALM AVENUE

REAR AERIAL VIEW

SCALE : N.T.S.



date <u>7 / 6 / 18</u> sheet no.

DØ.4











3 64 PALM AVENUE

PALM-AVENUE





49 PALM AVENUE



9 55 PALM AVENUE



8 65 PALM AVENUE



73 PALM AVENUE









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6 BI PALM AVENUE







48 PALM AVENUE



64 PALM AVENUE 56 PALM AVENUE



PALM AVENUE



49 PALM AVENUE



55 PALM AVENUE



65 PALM AVENUE





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10 PALM AVENUE

80 PALM AVENUE



13 PALM AVENUE

81 PALM AVENUE





date <u>7/6/</u>18 sheet no.

DØ.6





48 PALM AVENUE





55 PALM AVENUE









49 PALM AVENUE



65 PALM AVENUE




INDICATES AREA OF MODIFICATION FROM PREVIOUSLY APPROVED DRB 17-0201







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70 PALM AVENUE

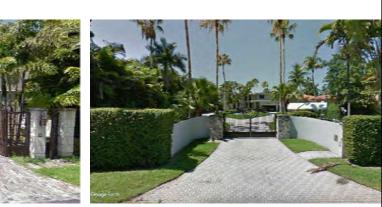80 PALM AVENUE



13 PALM AVENUE


81 PALM AVENUE



sheet no.





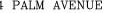













ZONING DATA:

PROJECT DESCRIPTION: NEW CONSTRUCTION - SINGLE FAMILY MUNICIPALITY: MIAMI BEACH STREET ADDRESS: 64 PALM AVENUE, MIAMI BEACH, FL 33139-5138 FOLIO NUMBER: 02-4205-001-0300 ZONING DISTRICT: RS-1 FEMA ZONE: AE-9 BFE: 9 N.G.V.D.

CODE OF ORDINANCES' REFERENCES:

LOT AREA: 142-105

MINIMUM LOT WIDTH: 142-105 GROSS BUILDING AREA: 142-105 LOT COVERAGE: 142-105 BUILDING HEIGHT: 142-105 BUILDING SETBACKS: 142-106 FENCE HEIGHT: 142-1132 DRIVEWAYS: 142-1132 POOL SETBACK: 142-1132 PROJECTIONS: 142-105, 142-1132 OTHER DIMENSIONAL REQUIREMENTS: 142-105

ZONING AREA CALCULATIONS DRB18-0274:

ALLOWED	PROVIDED	
30,000 S.F. MIN.	30,872-5.F.	
9,261 S.F MAX.(30%)	8,632 S.F. (27.96%)))
15,436 S.F. (50%)	14,459 S.F (46.83%))
	8,256 S.F.)
5,779 S.F. MAX. (70% GROUND)	6,203 S.F. (75.1%)) / /.
-	75 S.F.	; <u>∠</u>
1,401 S.F. MAX. (25% OF ROOF AREA (5,606 S.F.) OF FLOOR AREA DIRECTLY BELOW)	768 S.F. (13.6%))))
	30,000 S.F. MIN. 9,261 S.F MAX.(30%) 15,436 S.F. (50%) - 5,779 S.F. MAX. (70% GROUND) - 1,401 S.F. MAX. (25% OF ROOF AREA (5,606 S.F.) OF	30,000 S.F. MIN. 30,872-S.F. 9,261 S.F MAX.(30%) 8,632 S.F. (27.96%) 15,436 S.F. (50%) 14,459 S.F (46.83%) - 8,256 S.F. 5,779 S.F. MAX. (70% GROUND) 6,203 S.F. (75.1%) - 75 S.F. 1,401 S.F. MAX. (25% OF ROOF AREA (5,606 S.F.) OF 768 S.F. (13.6%)

ZONING AREA CALCULATIONS DRB17-0201:

	ALLOWED	PROVIDED
LOT SIZE	30,000 S.F. MIN.	
LOT COVERAGE	9,261 S.F MAX.(30%)	7,653 S.F (24.79%)
UNIT SIZE	15,436 S.F. (50%)	14,233 S.F (46.10%)
GROUND LEVEL	-	7,706 S.F.
SECOND LEVEL	5,394 S.F. MAX. (70% GROUND)	6,452 S.F. (83.72%)
ROOF	-	
ROOF TERRACE	1,019 S.F. MAX. (25% OF ROOF AREA (4,833 S.F.) OF FLOOR AREA DIRECTLY BELOW)	704 S.F. (14.5%)

MIAMIBEACH

Planning Department, 1700 Convention Center Drive Miami Beach, Florida 33139, www.miamibeachfl.gov 305.673.7550

SINGLE FAMILY RESIDENTIAL - ZONING DATAS

INDICATES AREA OF MODIFICATION FROM PREVIOUSLY APPROVED DRB 17-0201

ITEM#	ZONING INFORMATION	DRB17-0201	DRB18-0274	
1	ADDRESS:		64 PALM AVENUE	
2	FOLIO NUMBER(S):		02-4205-001-0300	
3	BOARD AND FILE NUMBERS:			
4	YEAR BUILT:		1932	ZONING DISTRICT:
5	BASE FLOOD ELEVATION:		9'-0" N.G.V.D.	GRADE VALUE IN N.G.V.D.:
6	ADJUSTED GRADE (FLOOD+GRADE/2):		7.35' N.G.V.D.	FREE BOARD:
7	LOT AREA:		30,872 S.F.	
8	LOT WIDTH:		100.00	LOT DEPTH:
9	MAX. LOT COVERAGE S.F. AND %:	9,261 S.F. (30%)	9,261 S.F. (30%)	PROPOSED LOT COVERAGE S.F. AND
10	EXIST. LOT COVERAGE AND %:	5,868 S.F. (19%)	5,868 S.F. (19%)	LOT COVERAGE DEDUCTED (GARAGE,
1	FRONT YARD OPEN SPACE S.F. AND %:	1,437 S.F. (71.8%) 🔿 (954 S.F. (47.7%)	REAR YARD OPEN SPACE S.F. AND
12	UNIT SIZE S.F. AND %:	15,436 S.F. (50%) / 🗌	15,436 S.F. (50%)	PROPOSED UNIT SIZE S.F. AND %:
13	EXISTING FLOOR UNIT SIZE:	N/A	N/A	PROPOSED FIRST FLOOR UNIT SIZE:
14	EXISTING SECOND FLOOR UNIT SIZE:	N/A	N/A	PROPOSED SECOND FLOOR VOLUMET
				% (NOTE: TO EXCEED 70% OF THE F
				MAIN HOME REQUIRES DRB APPROVA
15				PROPOSED SECOND FLOOR UNIT SIZE
16				PROPOSED ROOF DECK AREA S.F. A
				MAXIMUM IS 25% OF THE ENCLOSED
				DIRECTLY BELOW):
			DEOLUDED	EV/OTINO
			REQUIRED:	EXISTING:
17	HEIGHT:		31'	
18	SETBACKS:			
19	FRONT FIRST LEVEL:		20'	153'-4"'
2	FRONT SECOND LEVEL:		30'	153'-4"'
21	RIGHT SIDE:		10'	5'-3"
2	LEFT SIDE:		10'	8'-4"
23	REAR (15% OF LOT DEPTH):		46'-4"	57'-8"
	ACCESSORY STRUCTURE REAR:		23'-2"	N/A
24	ACCESSORY STRUCTURE LEFT SIDE:		7'-6"	N/A
25	ACCESSORY STRUCTURE RIGHT SIDE:		7'-6"	N/A
26	SUM OF SIDE YARD:		20'	N/A
27	LOCATED WITHIN A LOCAL HISTORIC DIST	TRICT?		


28 DESIGNATED AS AN INDIVIDUAL HISTORIC SINGLE FAMILY RESIDENCE SITE?

29 DETERMINED TO BE ARCHITECTURALLY SIGNIFICANT?








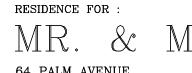

64 PALM AVENUE

	0004	00040 0074
	DRB17-0201	DRB18-0274
		RS-1
		5.47' N.G.V.D. 1'-0"
- <i></i>		E=308.72/W=308.83
D %: E/STORAGE) S.F.:	7,653 S.F. (24.79%) 500 S.F. (GARAGE)	8,632 S.F. (27.96%) /1
%:	3,263 S.F. (70.3%)	3,263 S.F. (70.3%)
	14,233 S.F. (46.10%)	14,459 S.F. (46.83%)
TRIC UNIT SIZE S.F. AN	7,706 S.F.	8,256 S.F.
FIRST FLOOR OF THE		{∑ <u>``</u>
AL)	6,665 S.F. (86.49%)	6,640 S.F. (80.42%)
E S.F. AND %:	6,472 S.F. (83.72%)	6,203 S.F. (75.1%)
) FLOOR AREA		8 B
	704 S.F. (14.5%)	
	/ 01 0.1.1 (11.0.0)	768 S.F. (13.6%)
DBODOCED		
PROPOSED	:	DEFICIENCIES:
	:	DEFICIENCIES:
32' (V 30' 30'	: WAIVER)	DEFICIENCIES: N/A N/A N/A N/A
32' (V 30' 30' 15'-2"	: WAIVER)	DEFICIENCIES: N/A N/A N/A N/A N/A
32' (V 30' 30' 15'-2" 10'-0"	: NAIVER)	DEFICIENCIES: N/A N/A N/A N/A N/A
32' (V 30' 30' 15'-2" 10'-0" 64'-11	: WAIVER) , , ,	DEFICIENCIES: N/A N/A N/A N/A N/A N/A N/A N/A
32' (V 30' 30' 15'-2" 10'-0" 64'-11 23'-11	: WAIVER) , , , , , , , , , , , , , , , , , , ,	DEFICIENCIES: N/A N/A N/A N/A N/A N/A N/A N/A
32' (V 30' 30' 15'-2" 10'-0" 64'-11 23'-11 10'-0"	: WAIVER) , , , , , , , , , , , , ,	DEFICIENCIES: N/A N/A
32' (V 30' 30' 15'-2" 10'-0" 64'-11 23'-11 10'-0" 66'-8'	: NAIVER) , , , , , , , , , , , , , , , , , , ,	DEFICIENCIES: N/A N/A N/A N/A N/A N/A N/A N/A
32' (V 30' 30' 15'-2" 10'-0" 64'-11 23'-11 10'-0" 66'-8' 25'-2'	: VAIVER) , , , , , , , , , , , , , , , , , , ,	DEFICIENCIES: N/A N/A N/A N/A N/A N/A N/A N/A N/A N/A
32' (V 30' 30' 15'-2" 10'-0" 64'-11 23'-11 10'-0" 66'-8' 25'-2' YE	: NAIVER) , , , , , , , , , , , , , , , , , , ,	DEFICIENCIES: N/A N/A N/A N/A N/A N/A N/A N/A N/A N/A

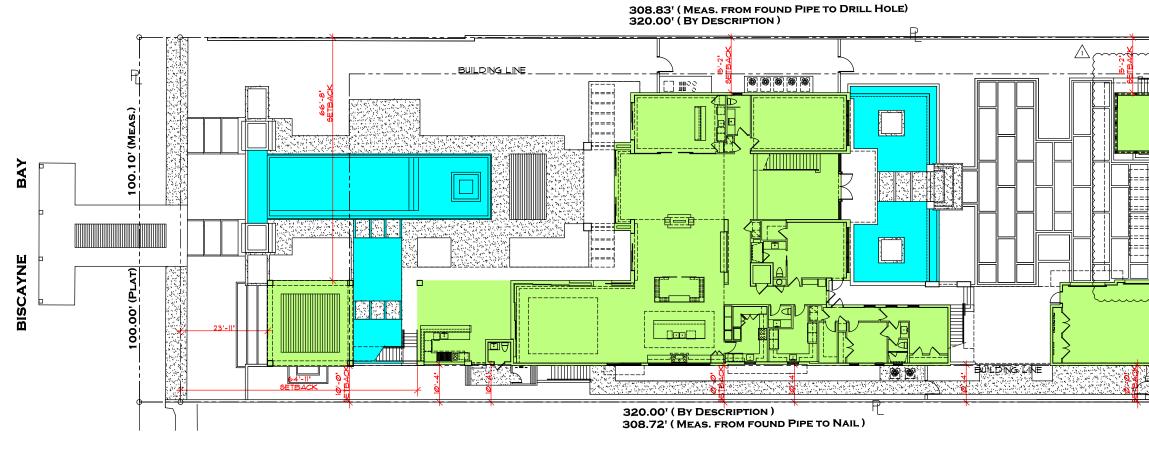






SETBACKS DIAGRAM

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AREA CALCULATION :

GROUND FL. A/C AREA : (CARETAKER'S COTTAGE A/C AREA : SECOND FL. A/C AREA : DOUBLE HEIGHT AREA : SECOND FL. GYM A/C AREA : ROOF DECK ELEVATOR & LOBBY A/C AREA :	5 192 5Q FT. 318 5Q. FT. 4,96 1 5Q. FT. 431 5Q. FT. 930 5Q. FT. 75 5Q. FT.
TOTAL A/C AREA :	12,579 SQ. FT.) /1
COVERED ENTRY	178 SQ. FT.
COVERED TERRACES :	745 SQ. FT.
CARPORT AND WALKWAY :	786 SQ.FT.
3 CAR GARAGE:	913 SQ. FT.
TOTAL:	2,622 SQ. FT.

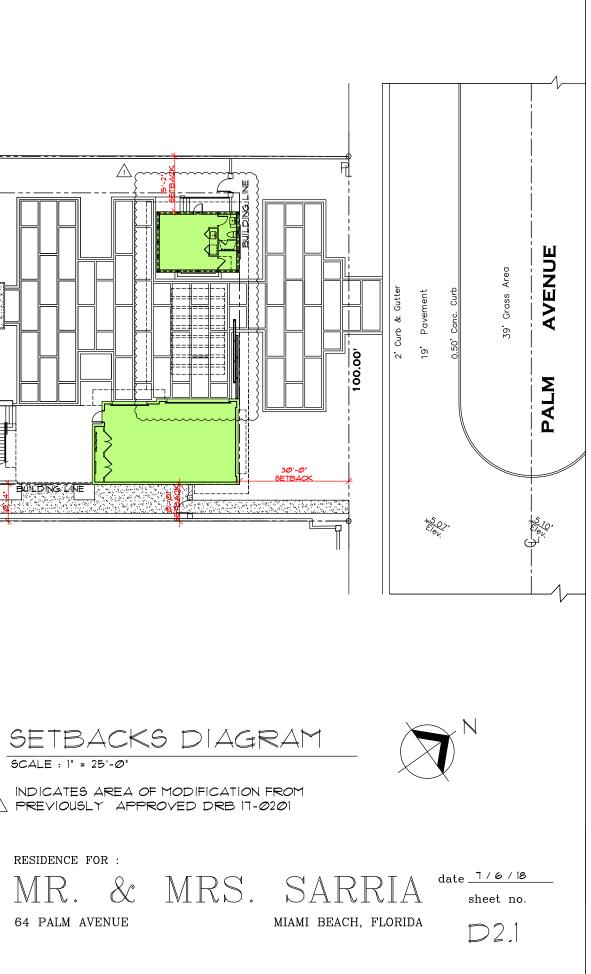SECOND FL. FRONT SUNDECKS & COV. WALKWAY: 1,036 SQ. FT. SECOND FLOOR MASTER SUNDECK: 530 SQ. FT. SECOND FL. MASTER COV. TERRACE & BALCONY: 435 SQ. FT. SECOND FL. LUCIANA'S BALCONY: 2Ø1 SQ. FT. SECOND FL. RICHI'S BALCONY: 70 SQ. FT. ROOF SUNDECK : 768 SQ. FT. TOTAL: 3,040 SQ. FT. GAZEBO : 544 SQ. FT. GAZEBO SUNDECK : 544 SQ. FT.

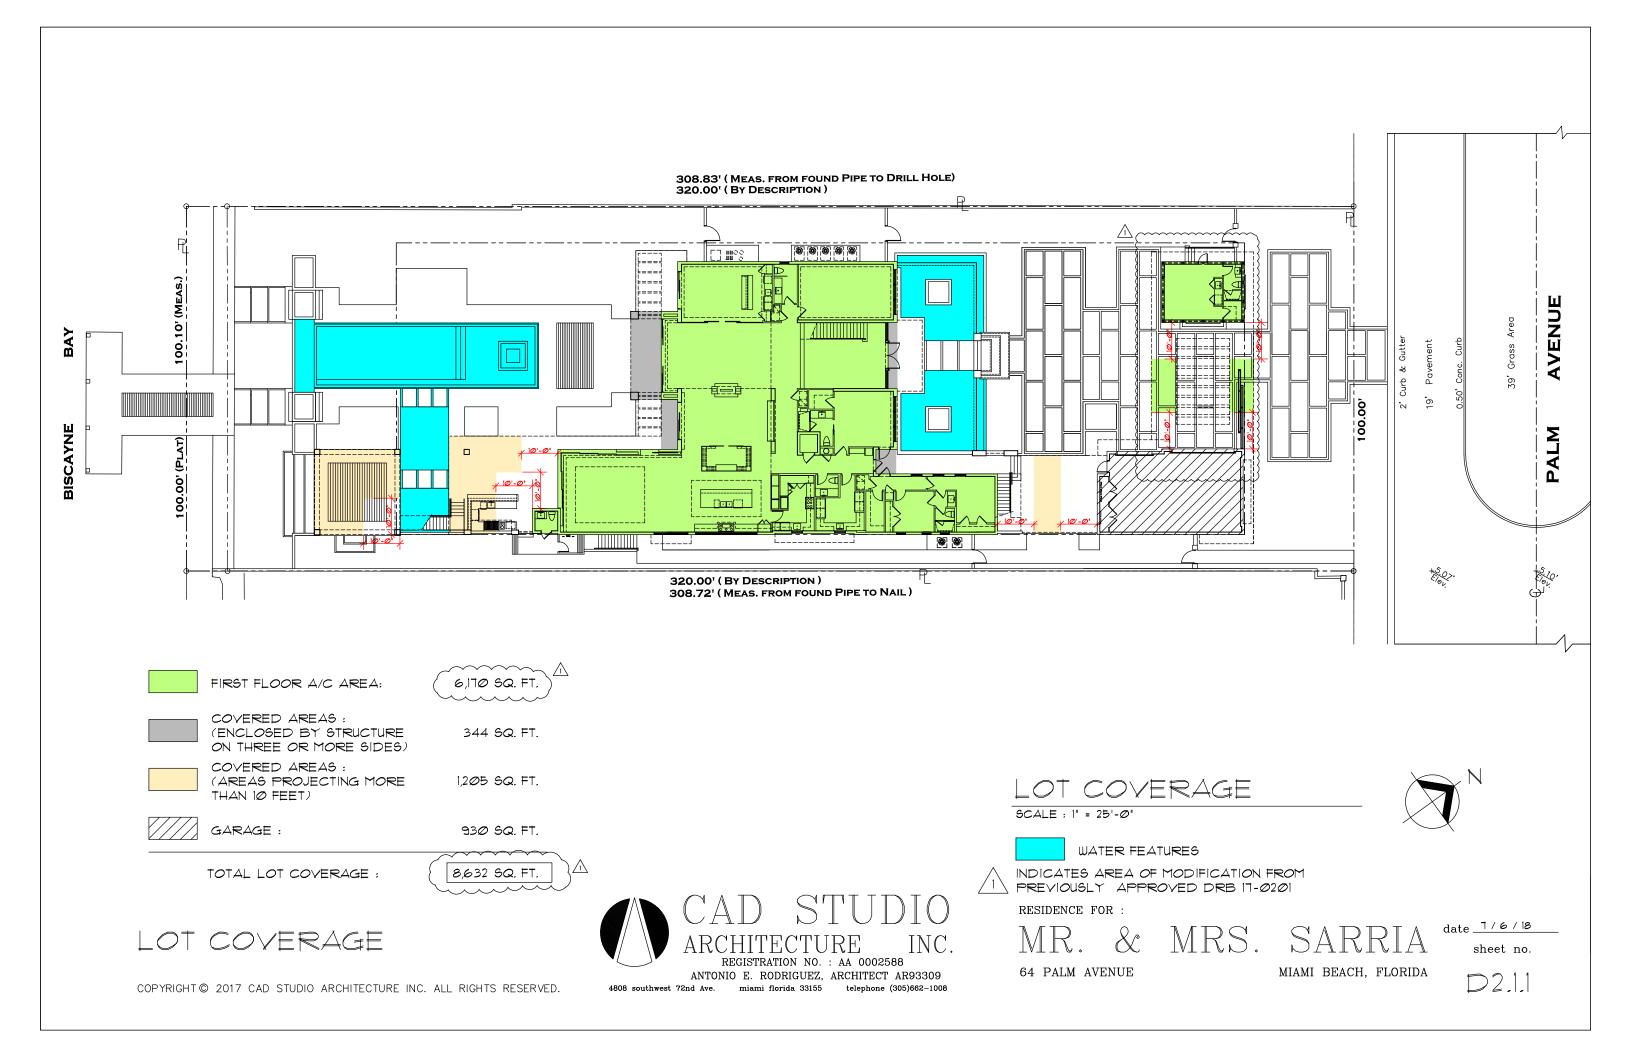TOTAL AREA:

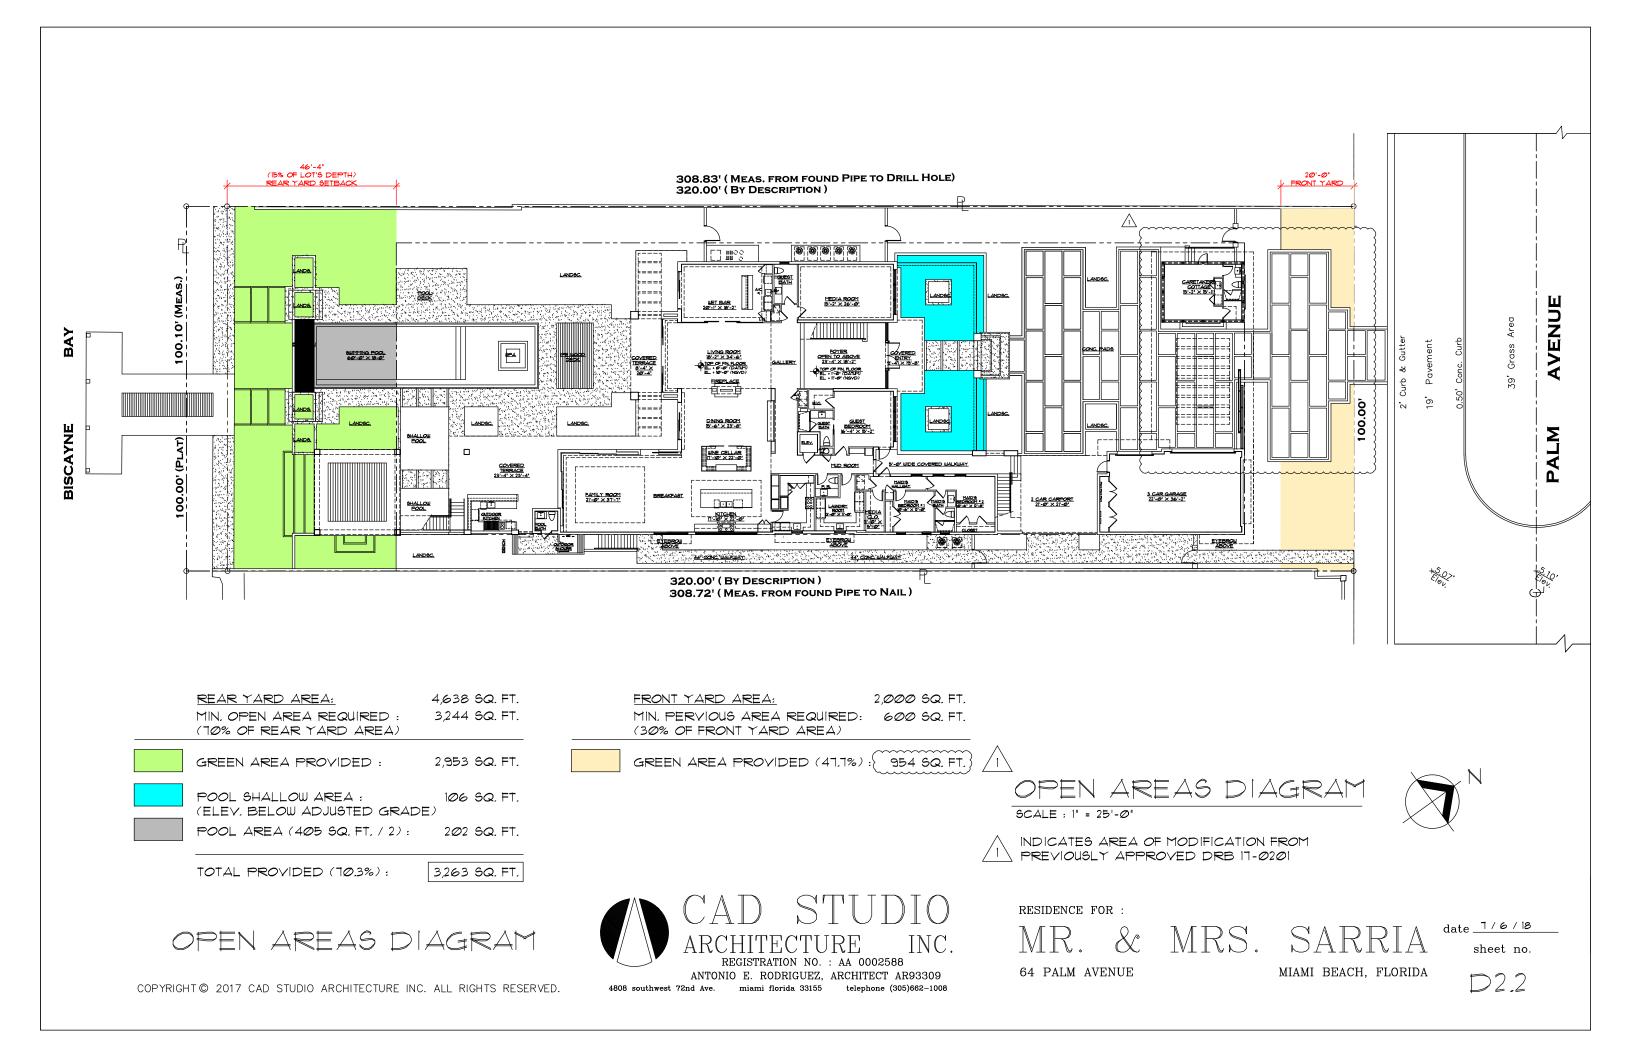
19,329 SQ. FT.











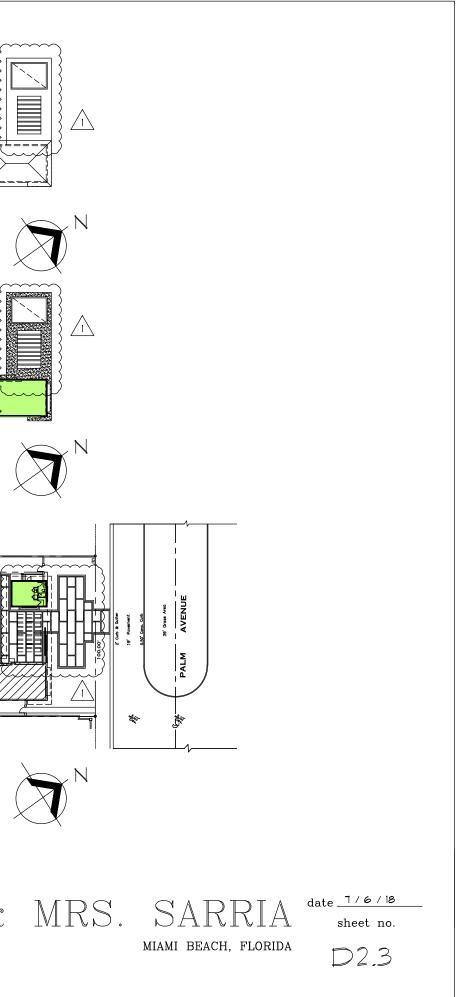

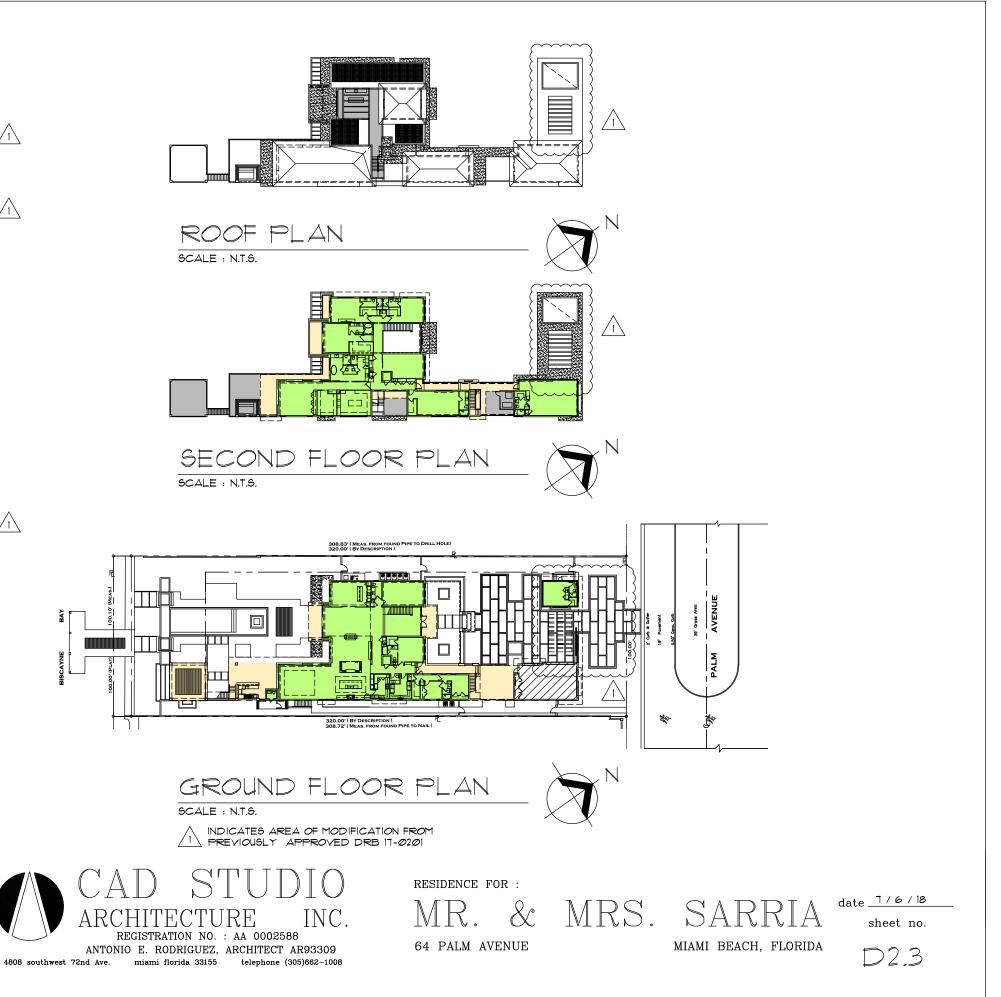

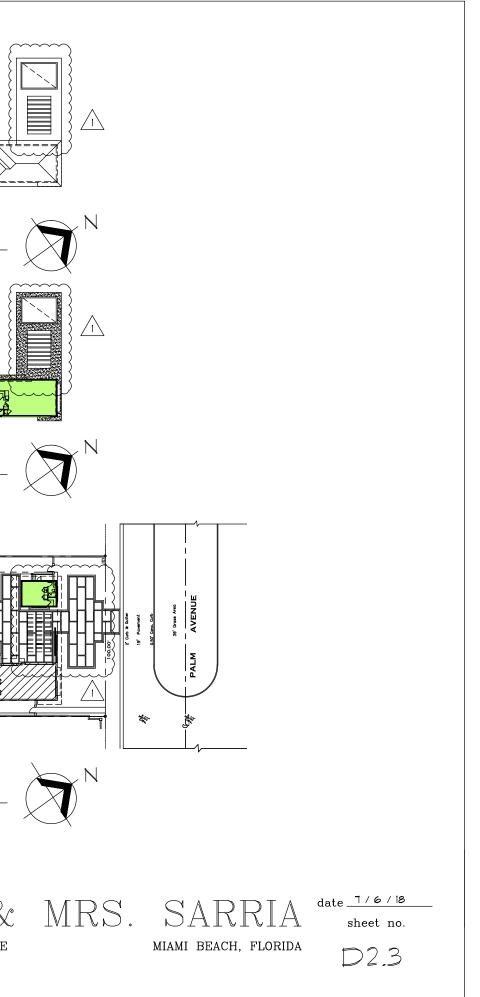

A/C AREAS DOUBLE HT. AREAS


GARAGE


COVERED AREAS


SUNDECKS/ OPEN TO THE SKY


IMPERVIOUS AREAS/ CONC. SLABS/ CONC. EYEBROWS

AREA CALCULATION

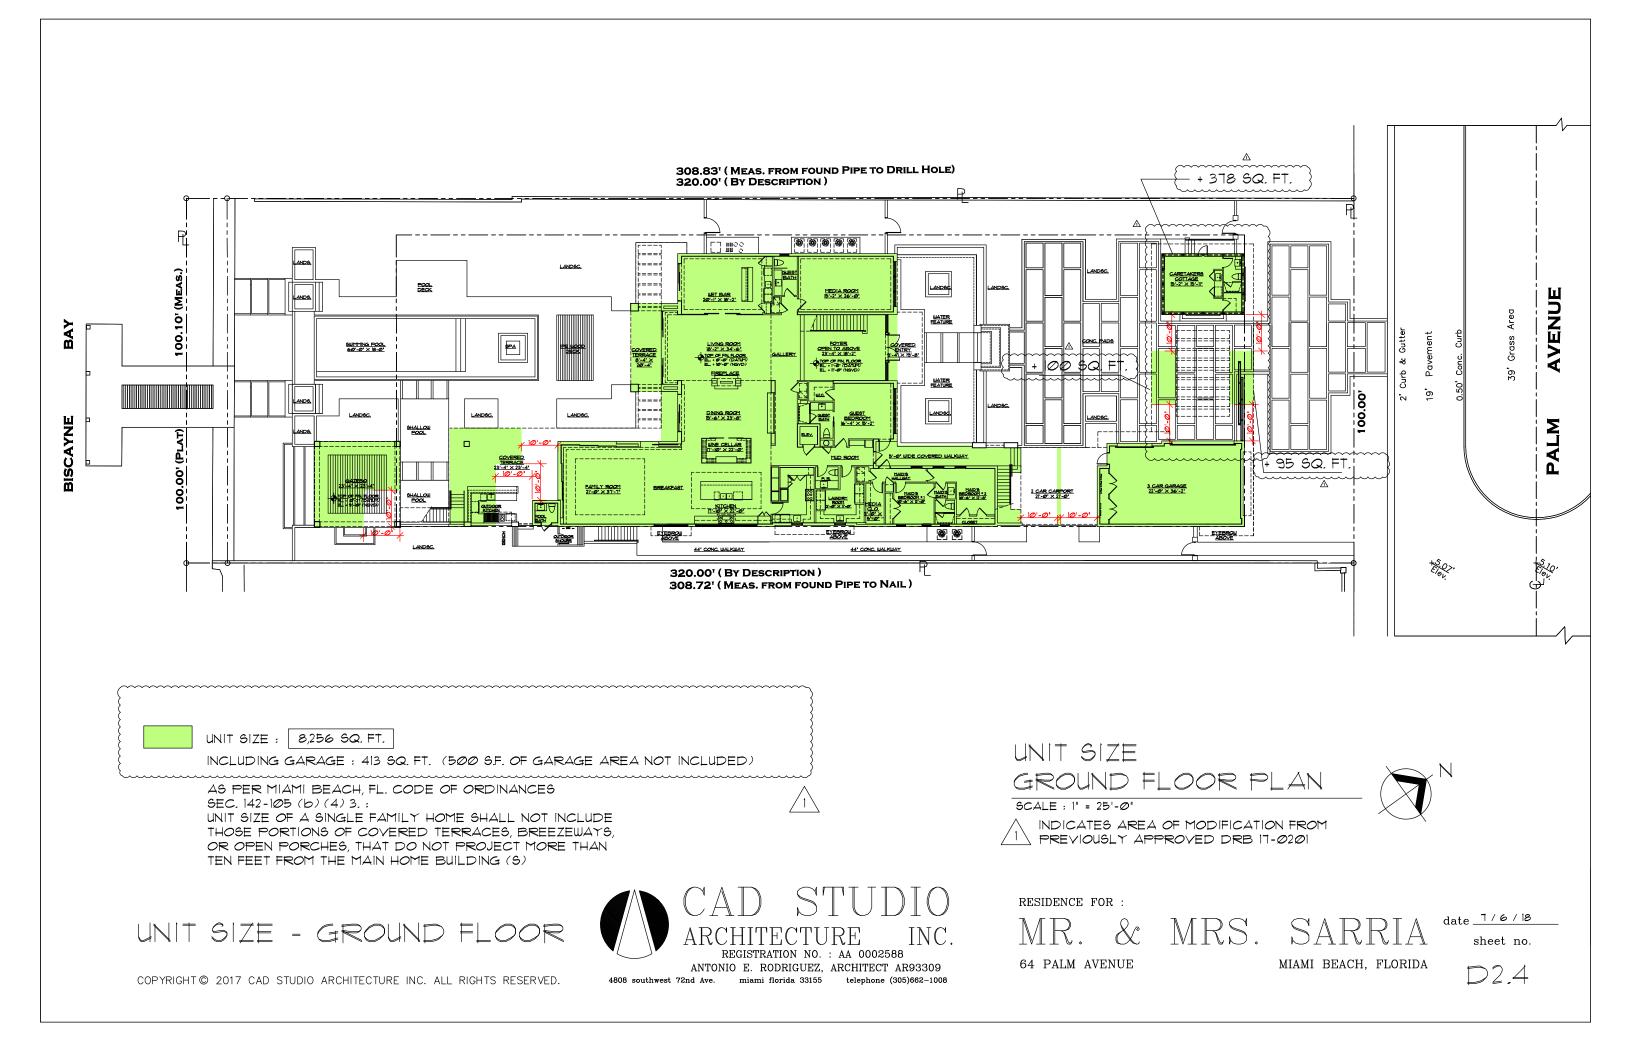

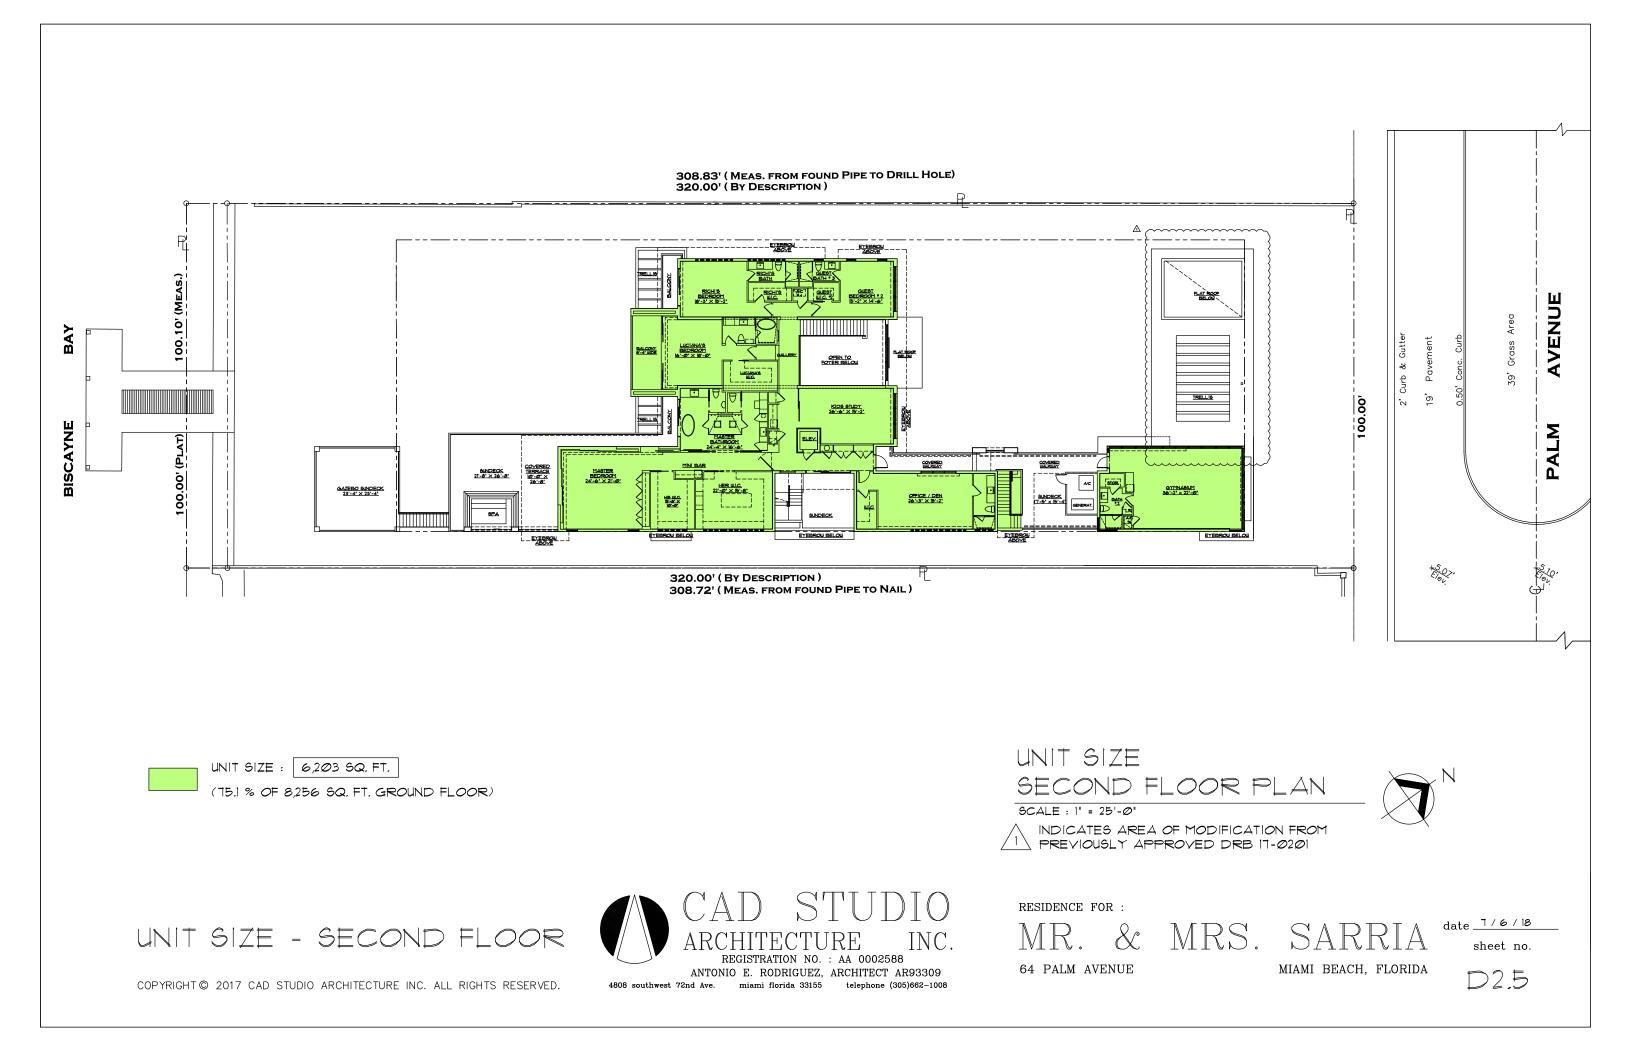

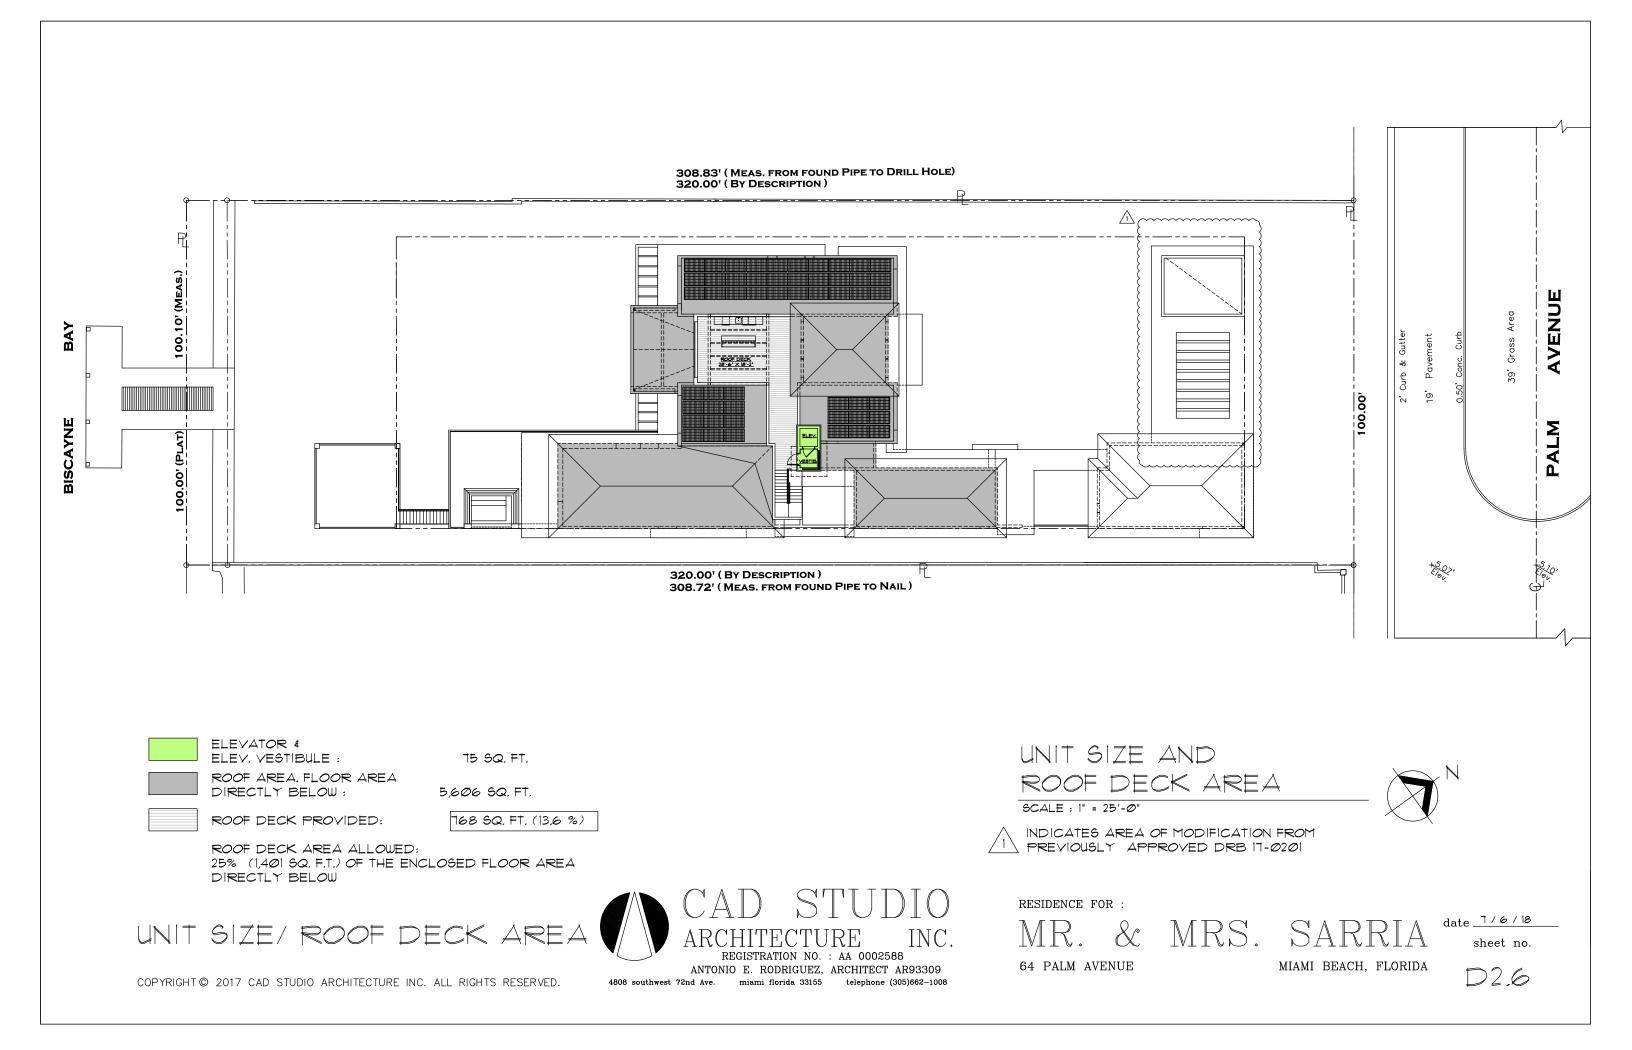


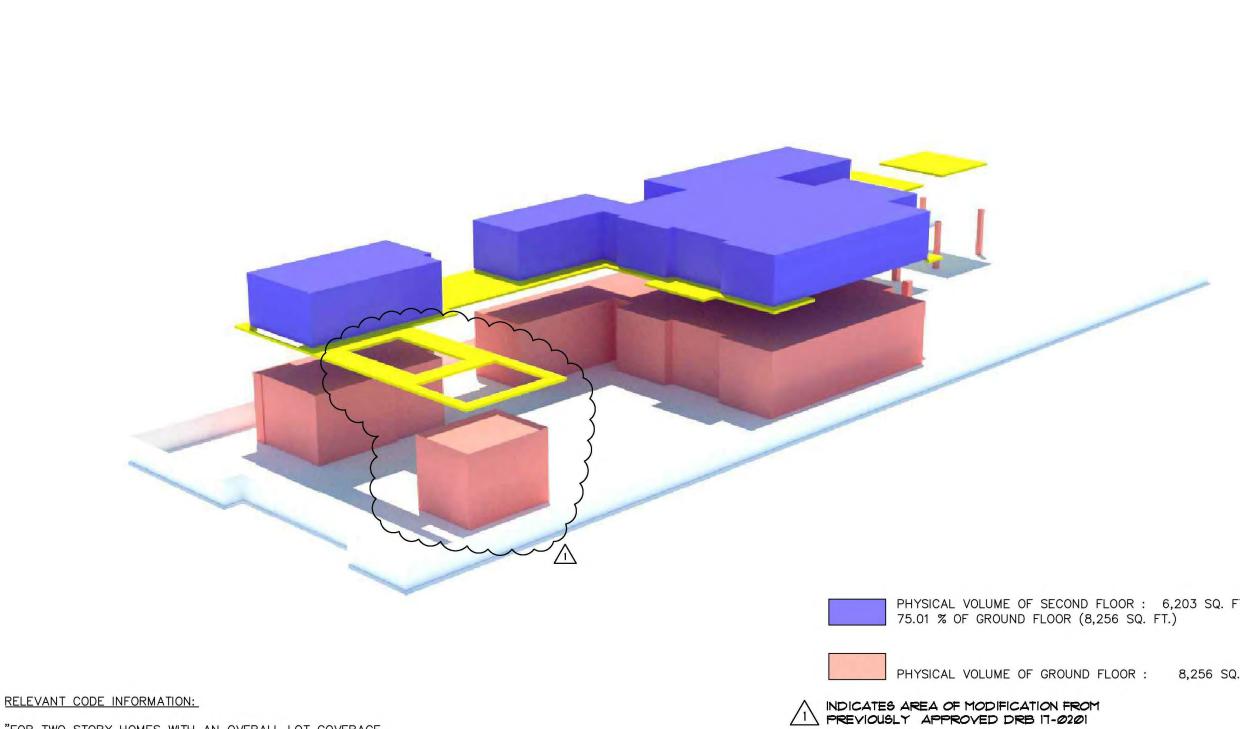


"FOR TWO STORY HOMES WITH AN OVERALL LOT COVERAGE OF 25% OR GREATER, PHYSICAL VOLUME OF THE SECOND FLOOR SHALL NOT EXCEED 70% OF THE FIRST FLOOR OF THE MAIN HOME, INCLUSIVE OF ANY ENCLOSED PARKING STRUCTURE." (142-105 (b) (4) C.




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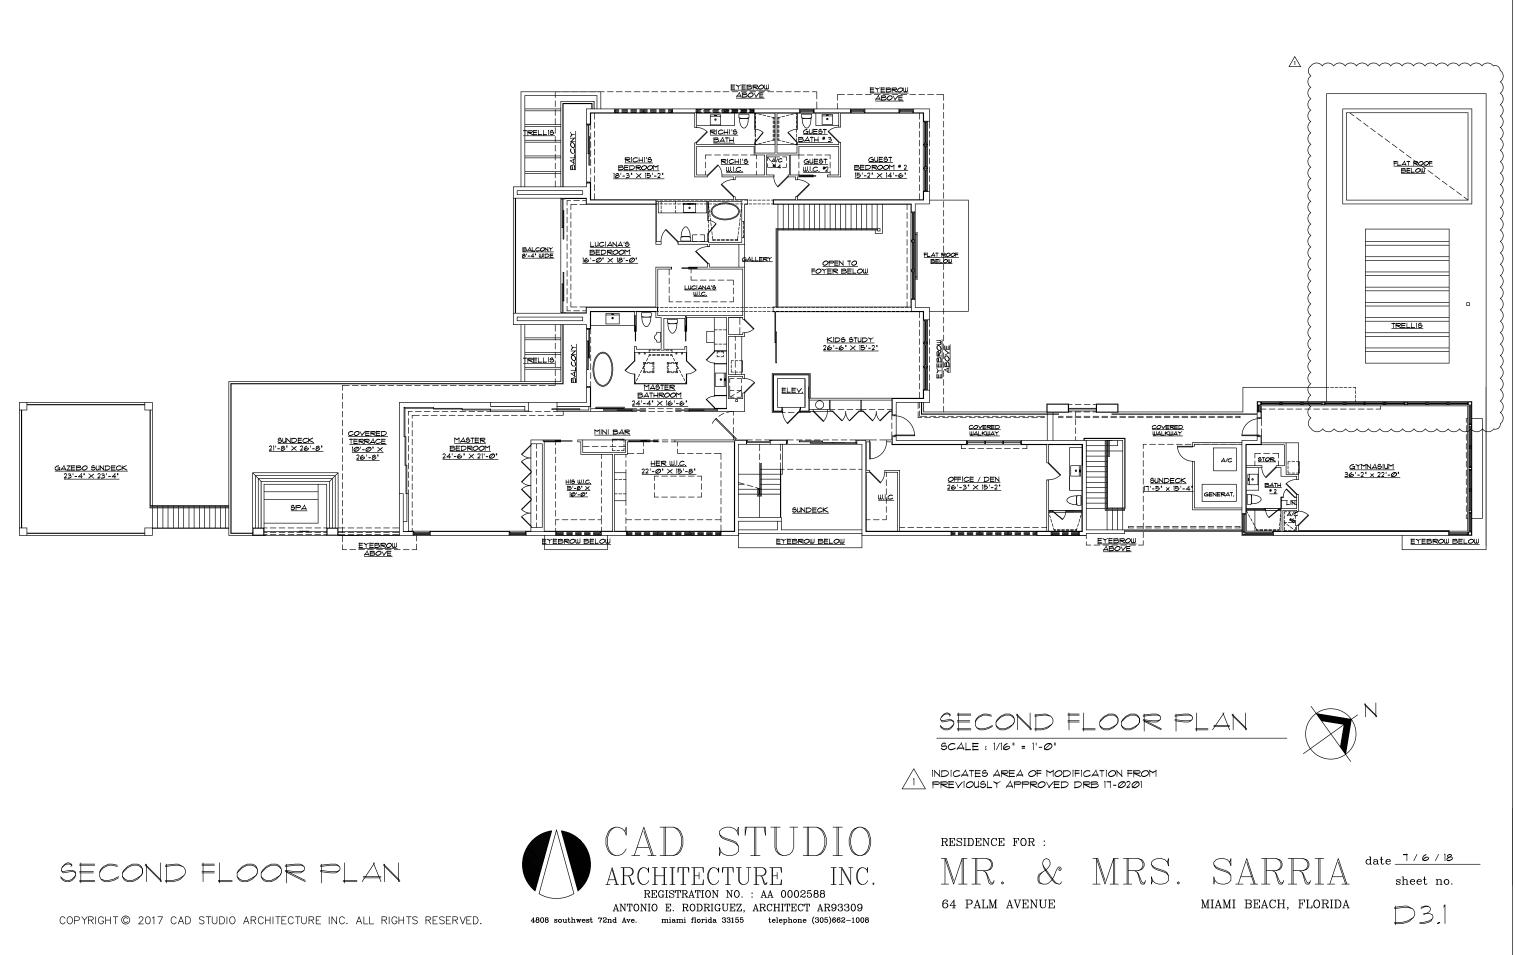


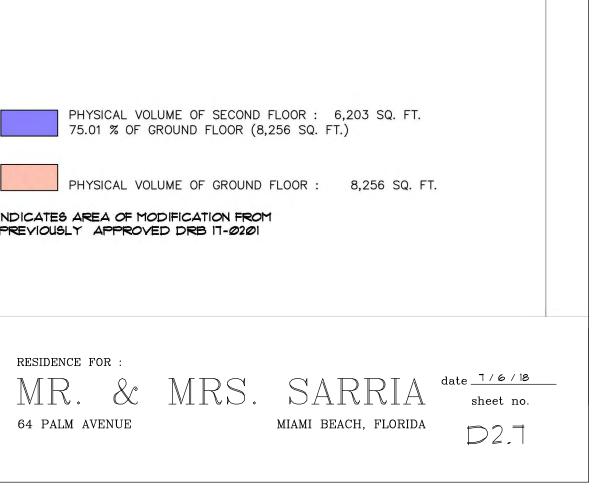
AXONOMETRIC DIAGRAM



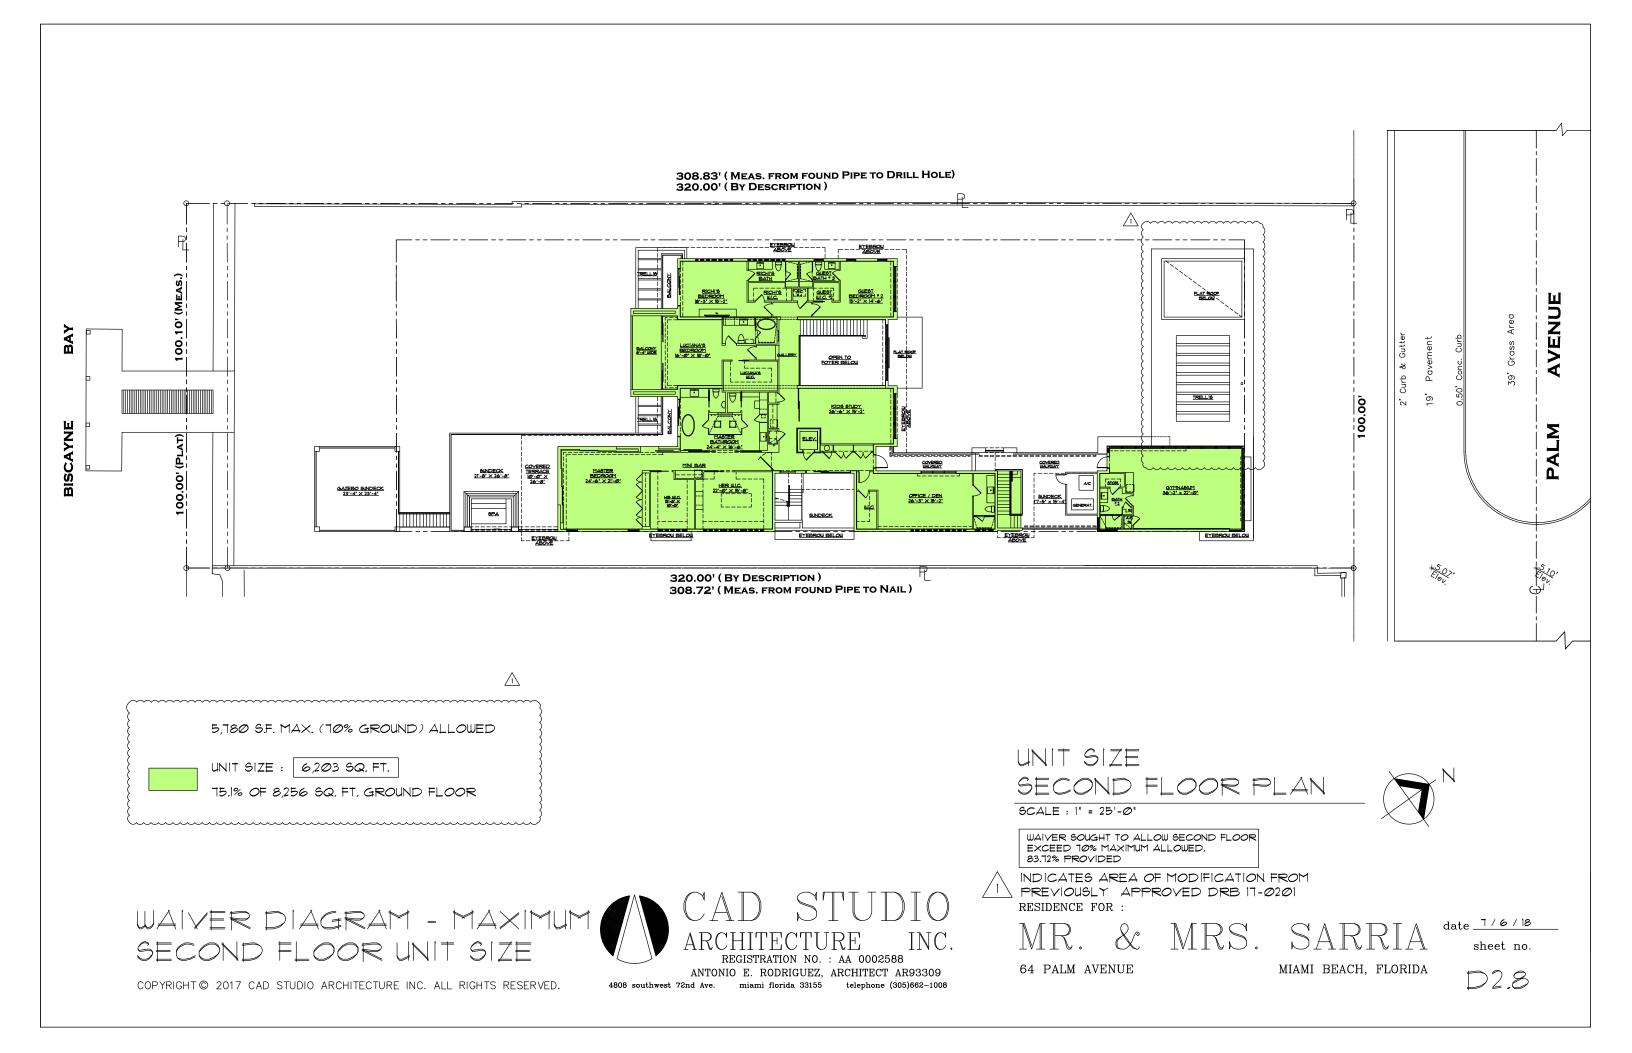

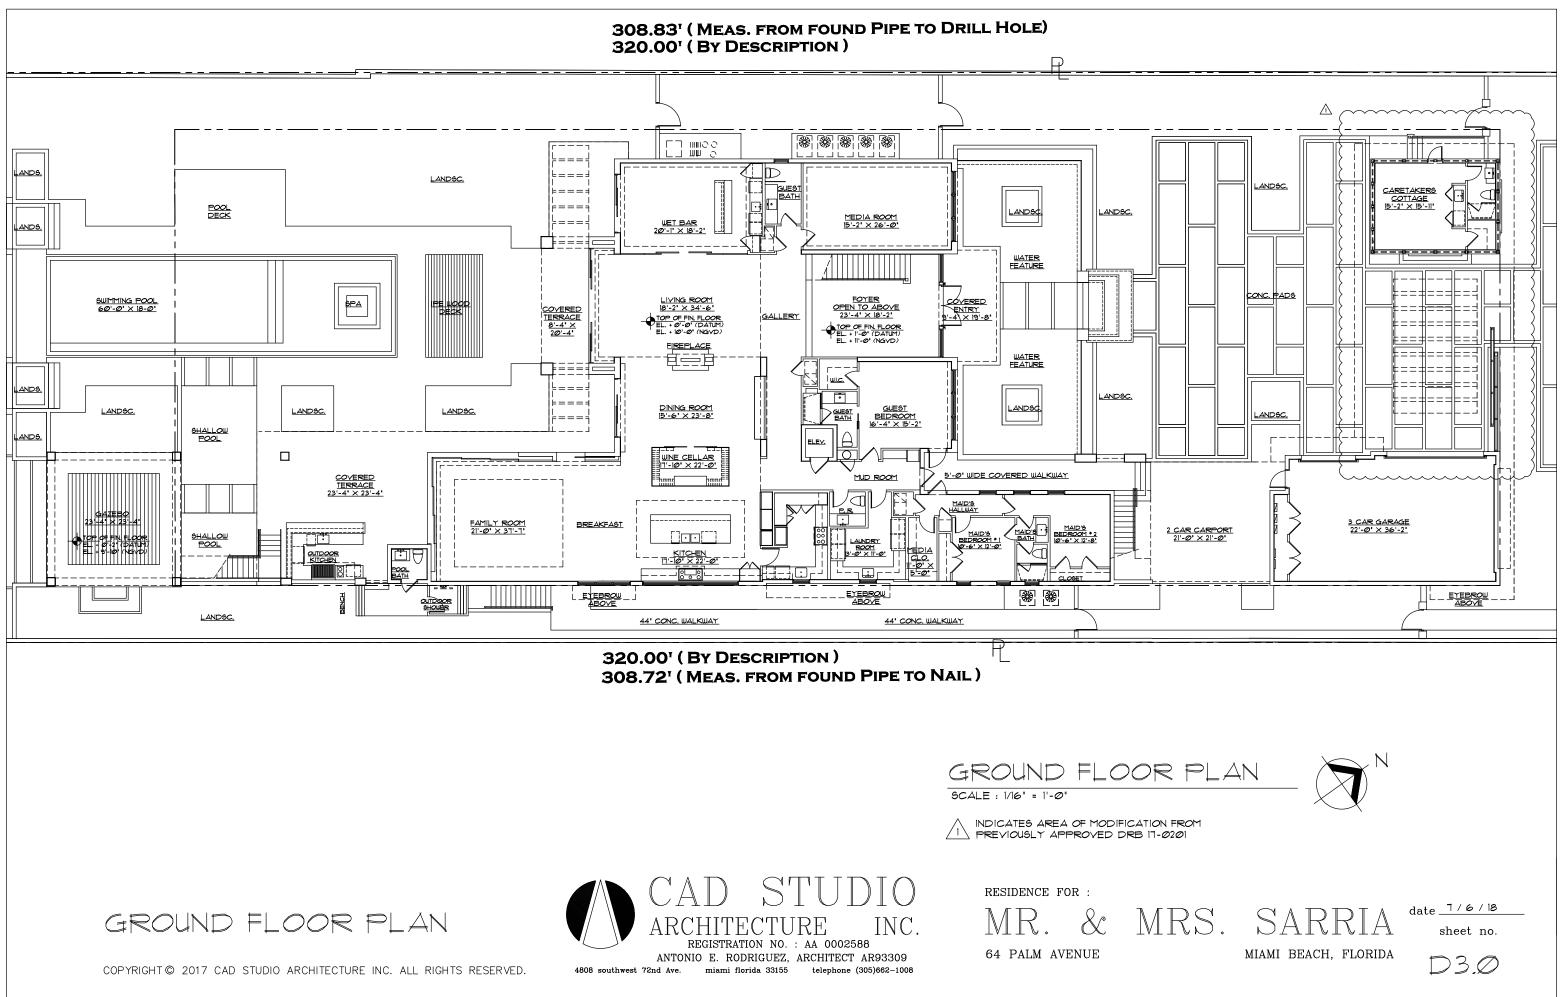



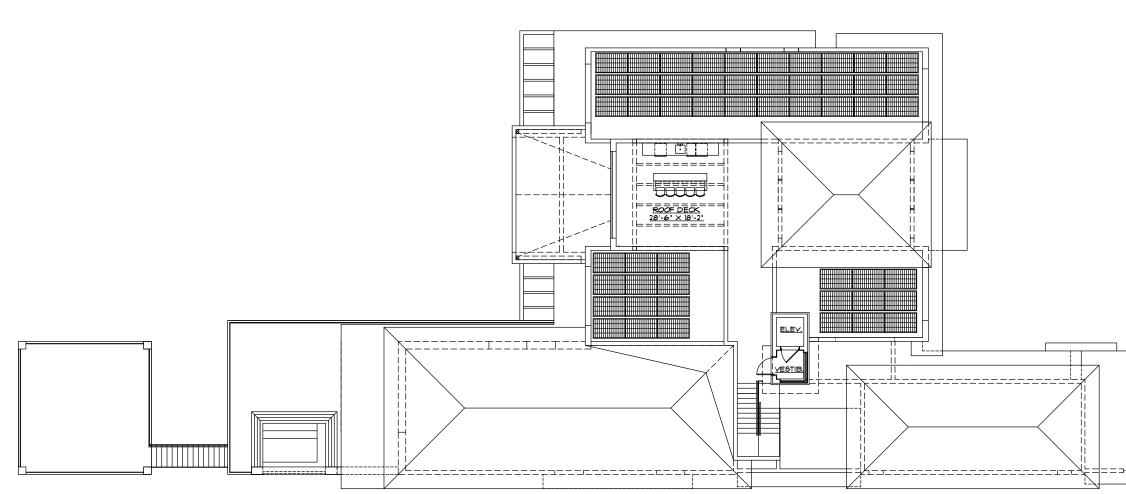


SCALE : 1/16" = 1'-0"


RESIDENCE FOR :



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ROOF PLAN SCALE : 1/16" = 1'-0"

INDICATES AREA OF MODIFICATION FROM PREVIOUSLY APPROVED DRB 17-0201

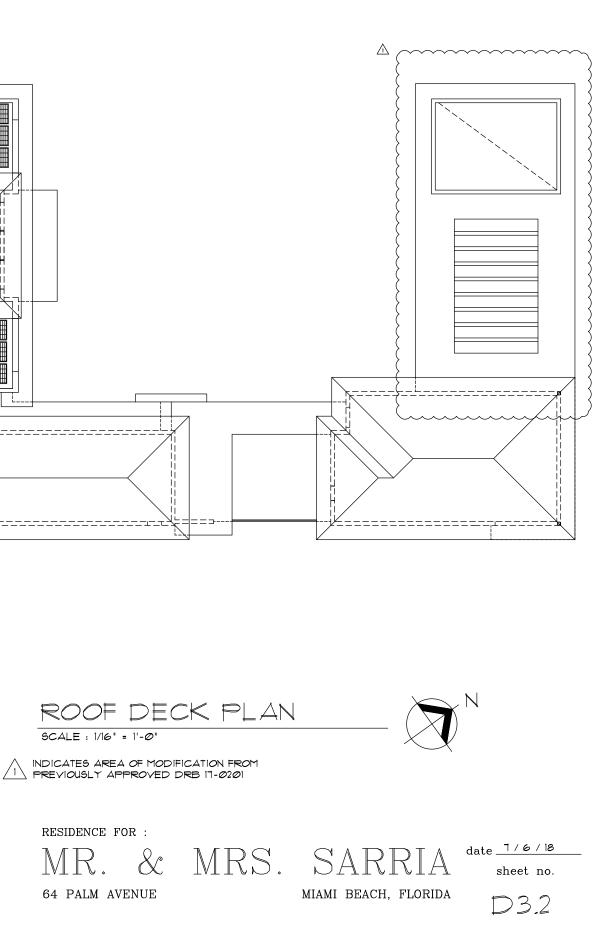
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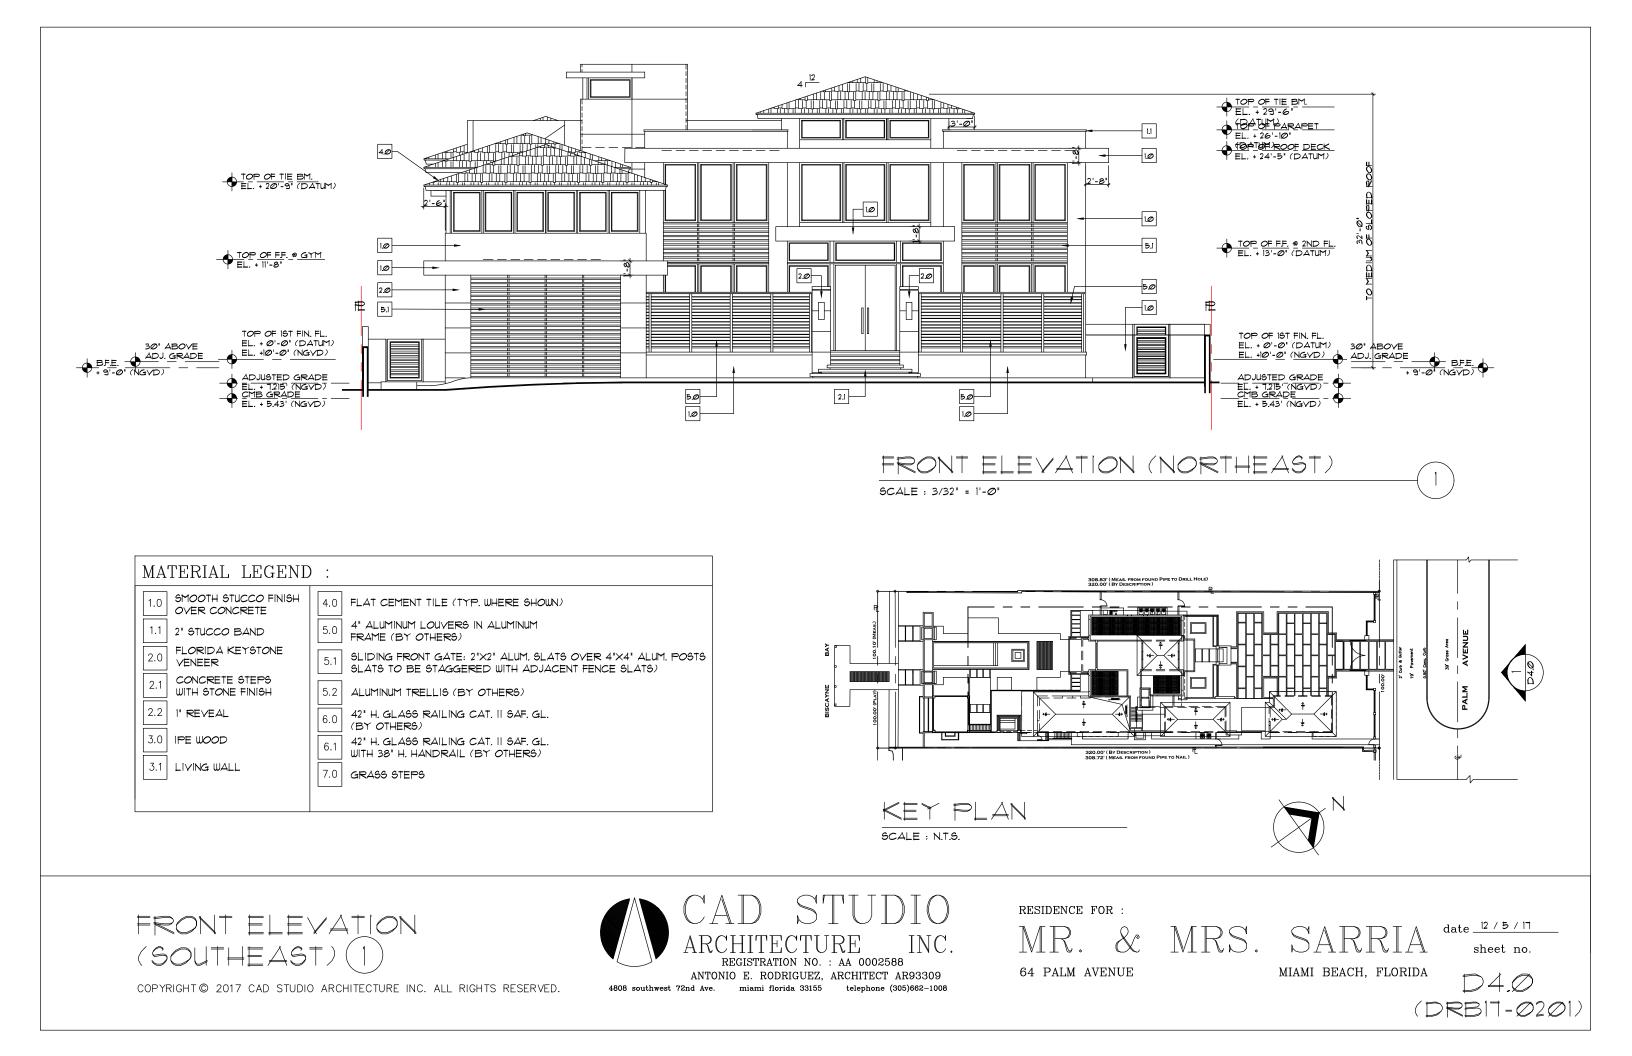
64 PALM AVENUE

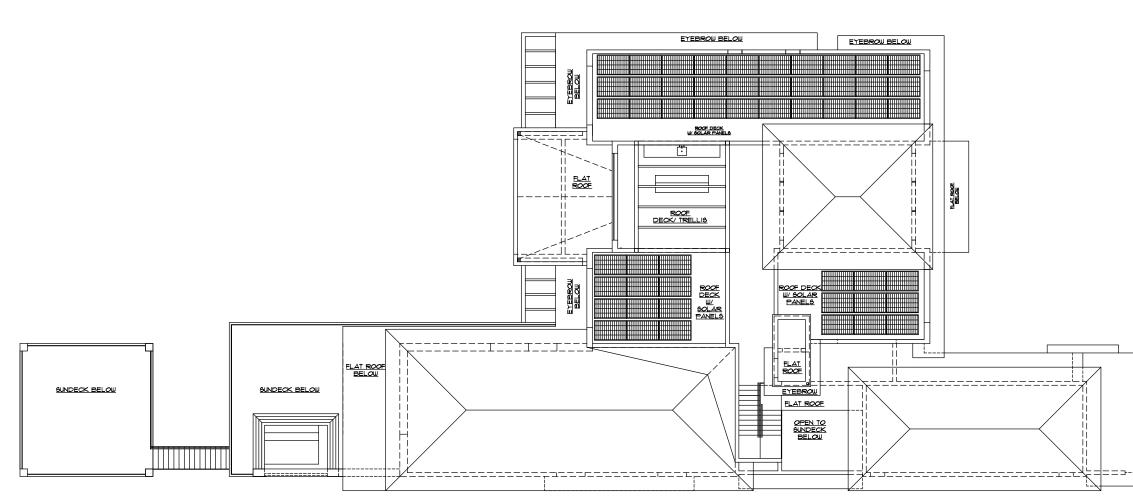


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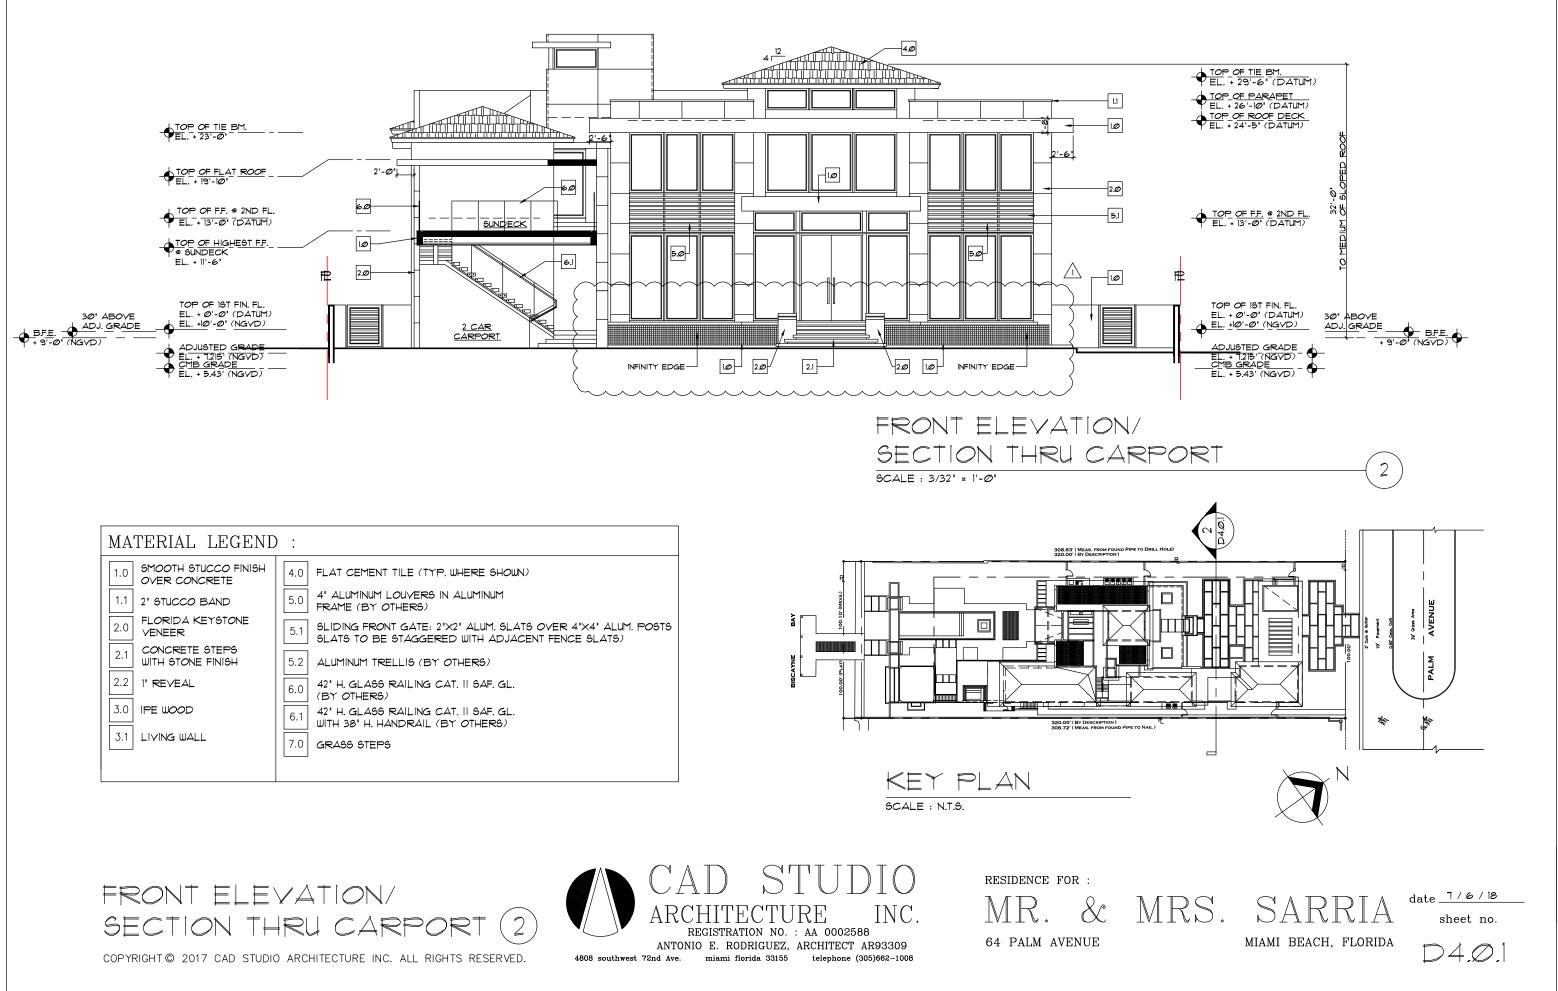
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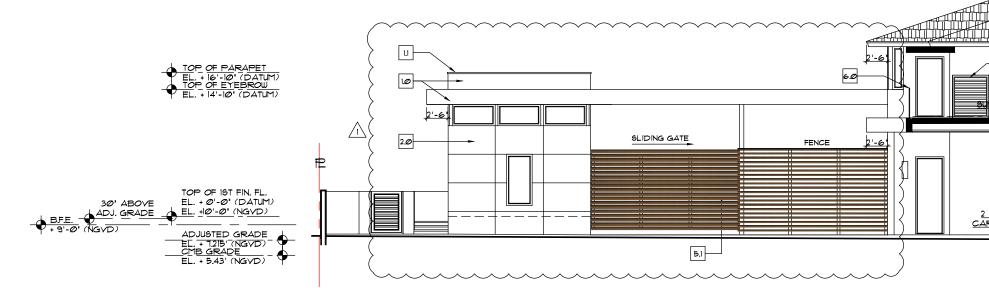







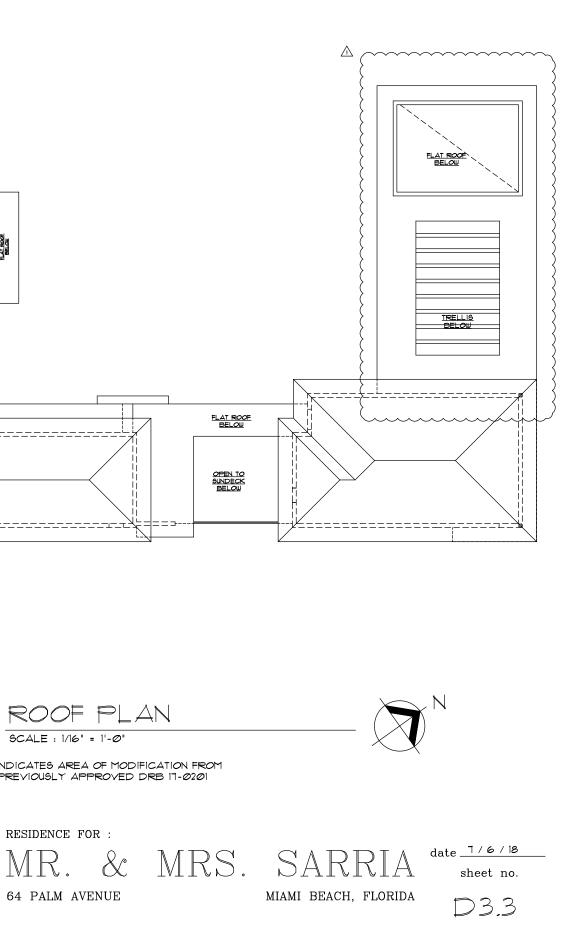


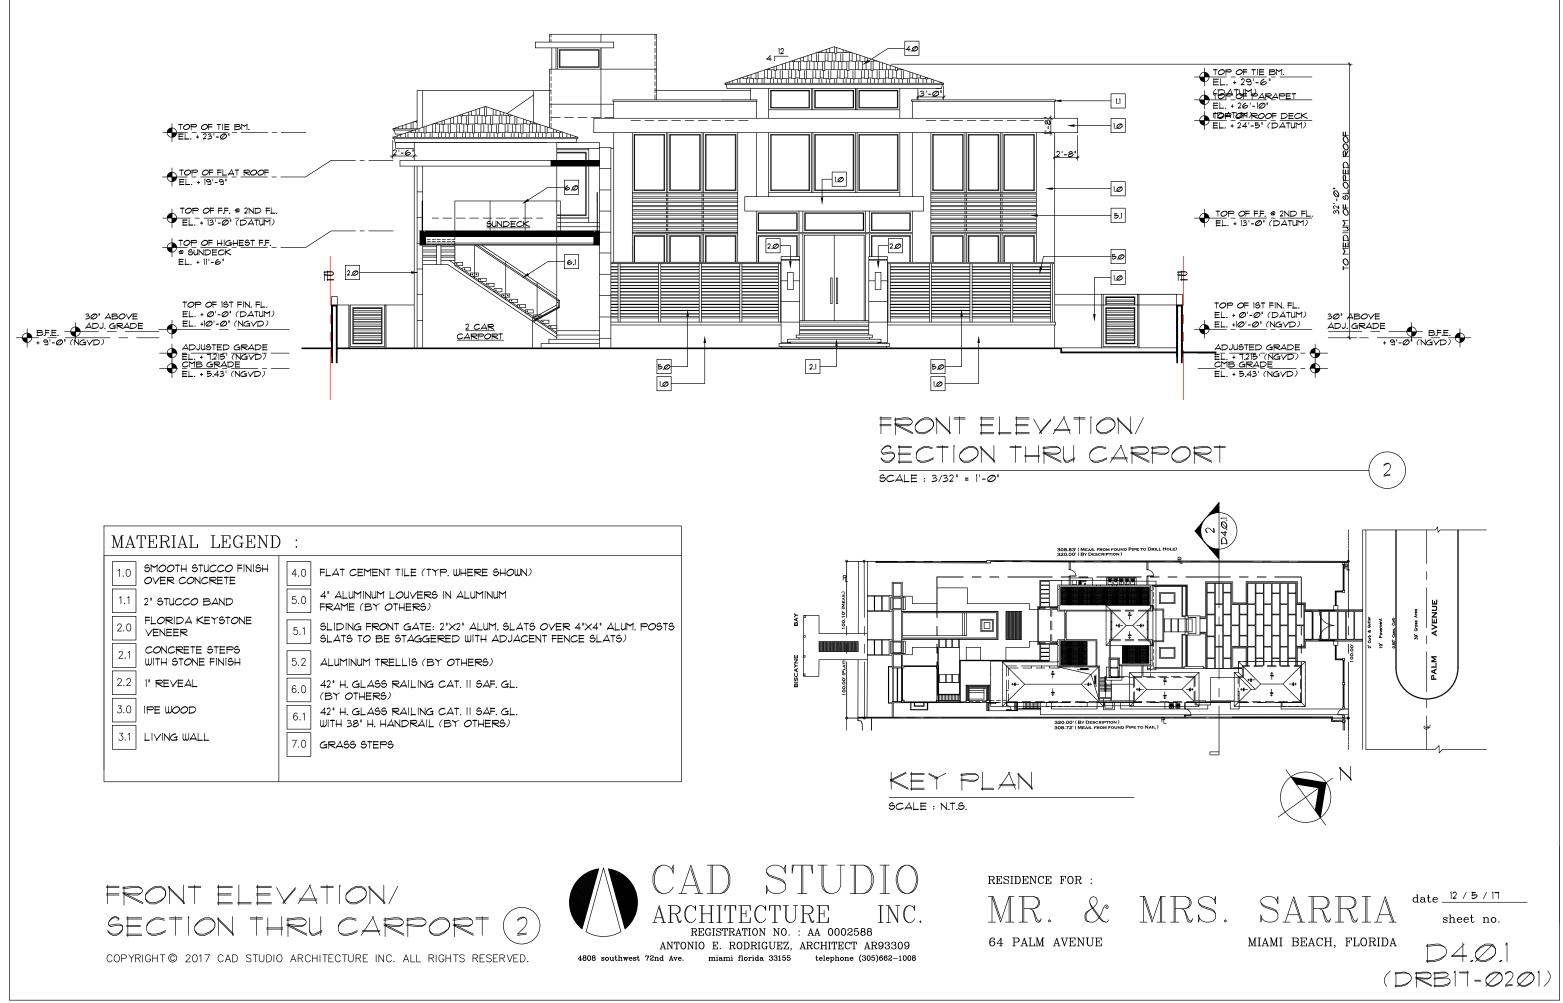



(SOUTHWEST) SCALE : 3/32" = 1'-Ø"

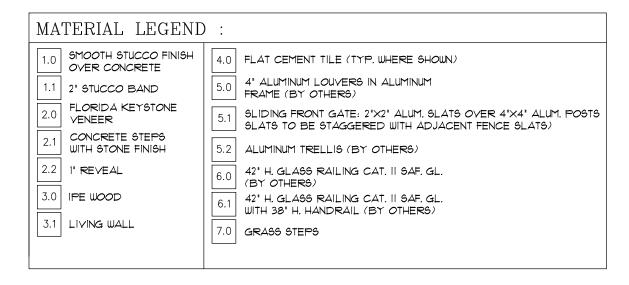


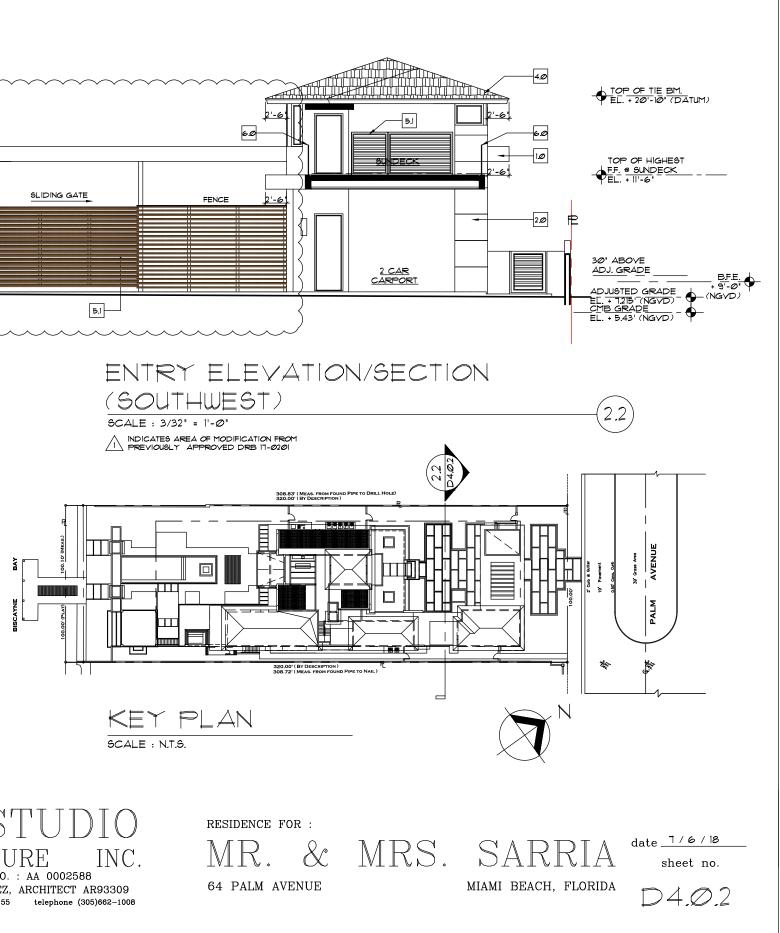








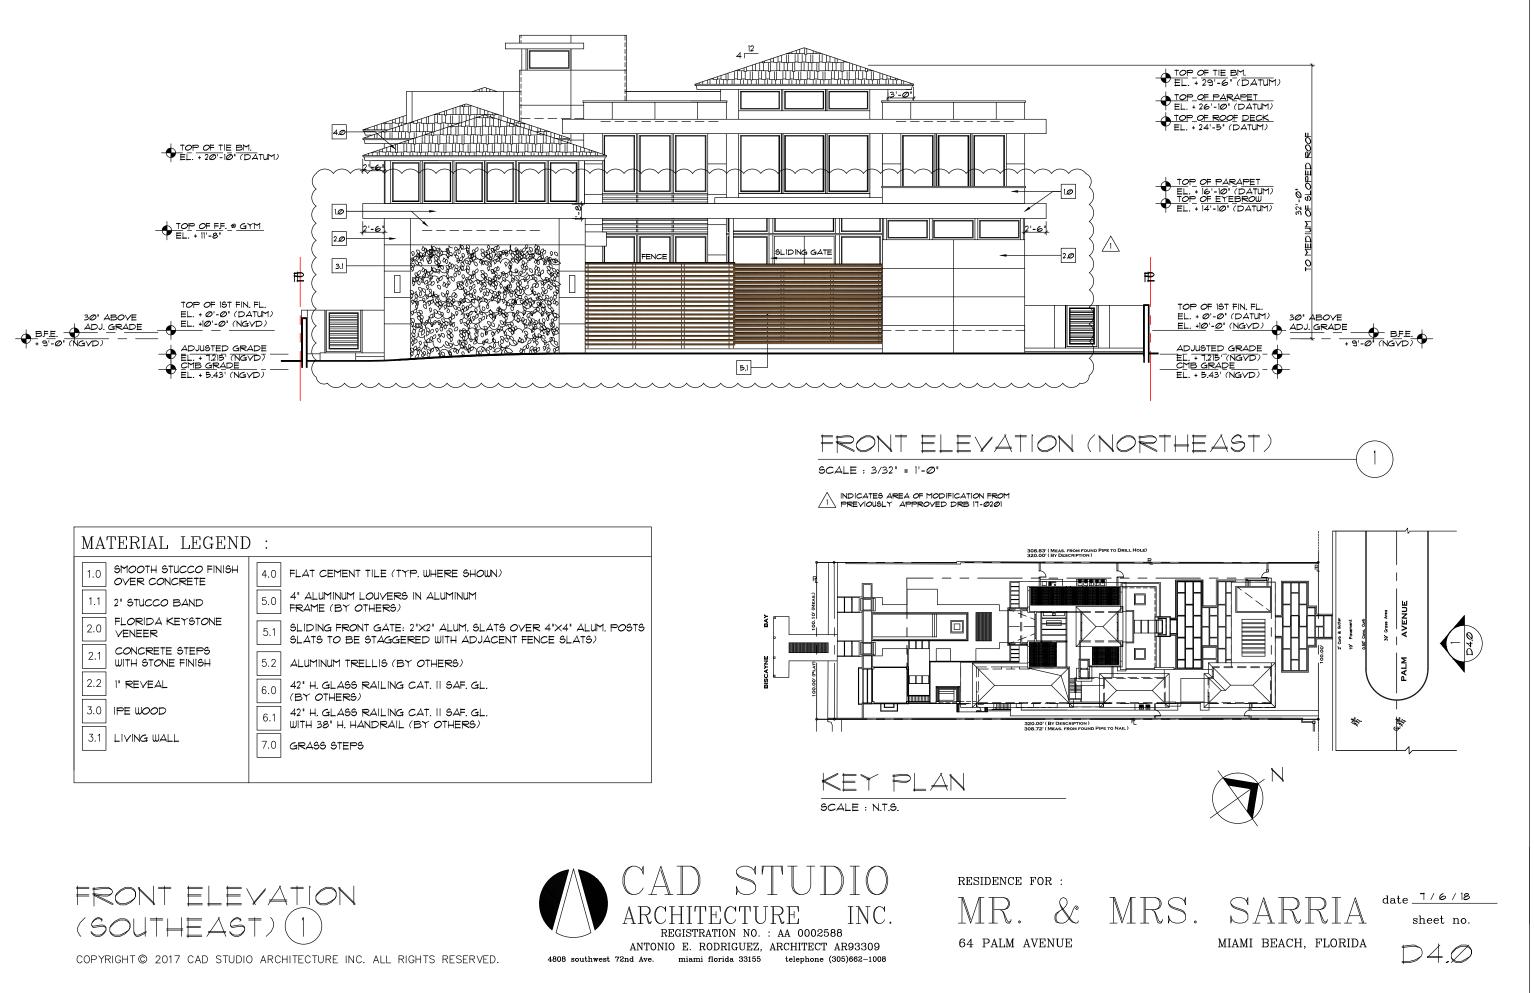








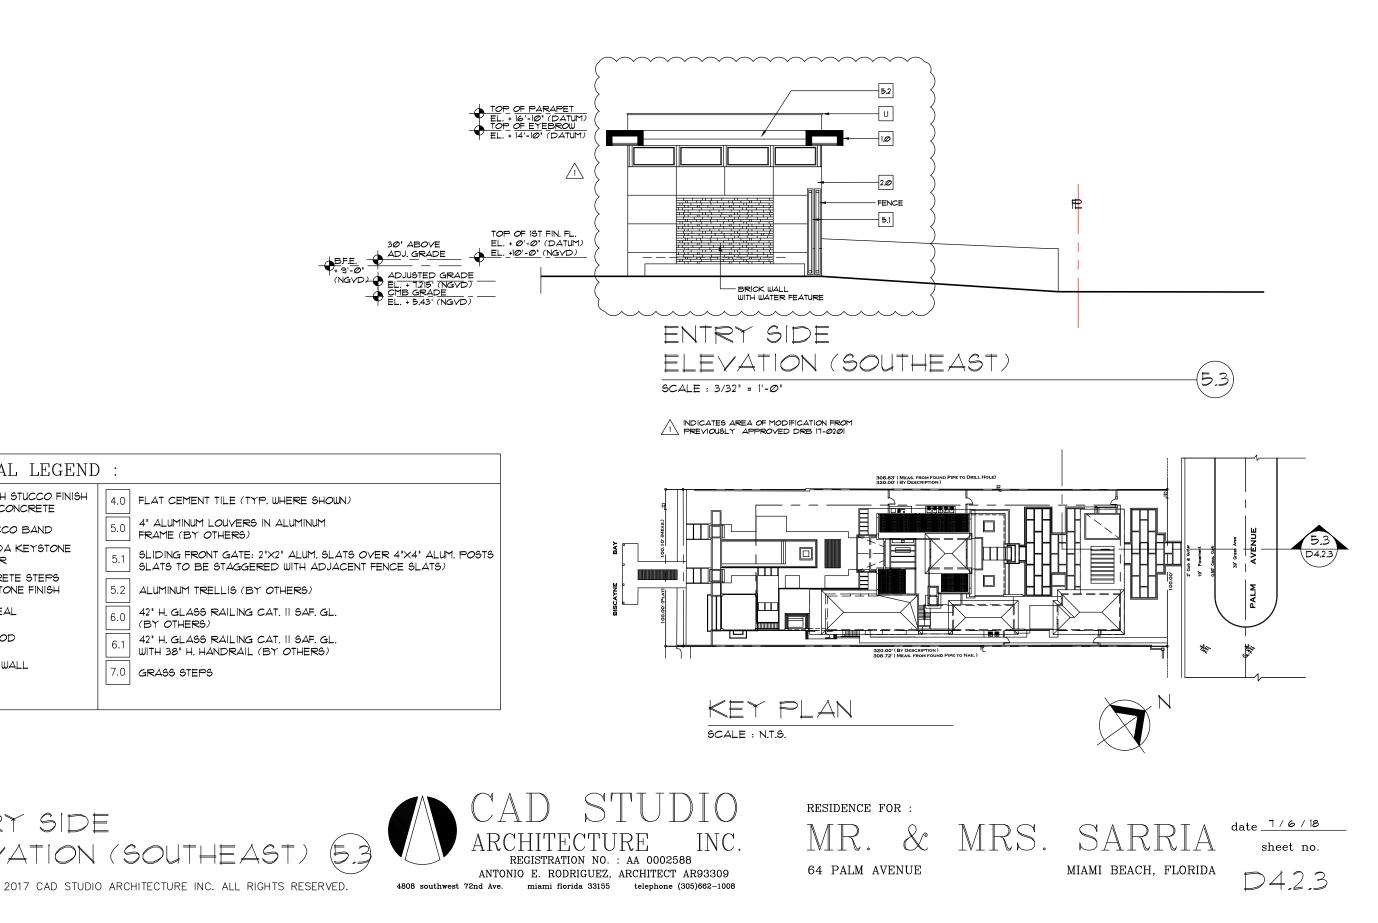



MATERIAL LEGEND :				
1.0 SMOOTH STUCCO FINISH OVER CONCRETE	4.0 FLAT CEMENT TILE (TYP. WHERE SHOWN)			
1.1 2' STUCCO BAND	5.0 4" ALUMINUM LOUVERS IN ALUMINUM FRAME (BY OTHERS)			
2.0 FLORIDA KEYSTONE VENEER	5.1 SLIDING FRONT GATE: 2"X2" ALUM. SLATS OVER 4"X4" ALUM. POSTS SLATS TO BE STAGGERED WITH ADJACENT FENCE SLATS)			
2.1 CONCRETE STEPS WITH STONE FINISH	5.2 ALUMINUM TRELLIS (BY OTHERS)			
2.2 I' REVEAL	6.0 42" H. GLASS RAILING CAT. II SAF. GL. (BY OTHERS)			
3.0 IPE WOOD	6.1 42" H. GLASS RAILING CAT. II SAF. GL. WITH 38" H. HANDRAIL (BY OTHERS)			
3.1 LIVING WALL	7.0 GRASS STEPS			

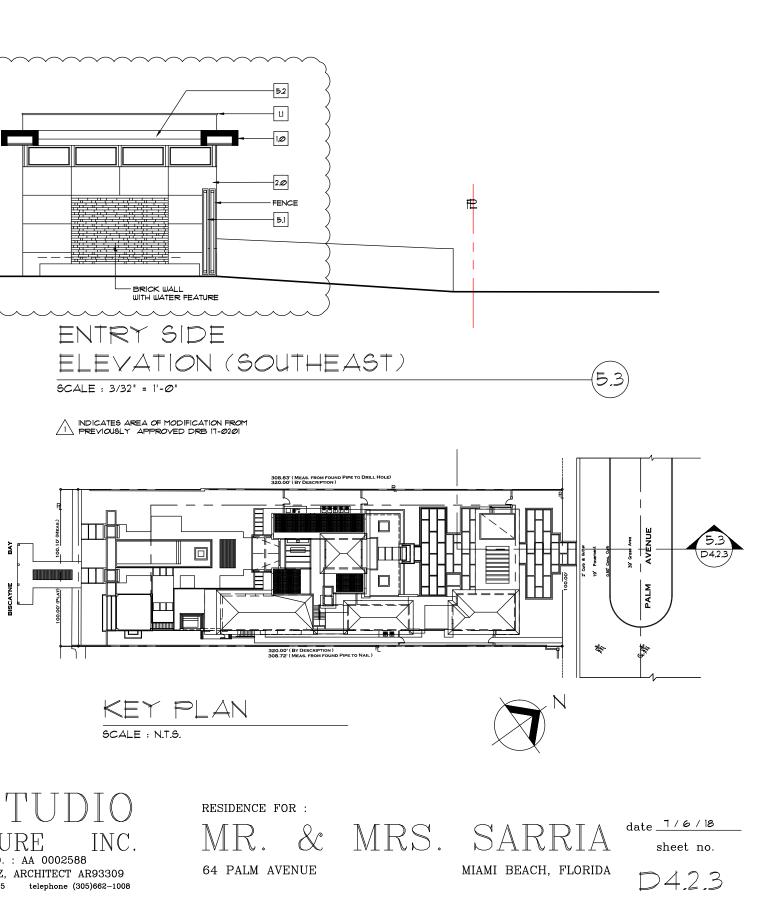



ENTRY SIDE ELEVATION (SOUTHEAST)

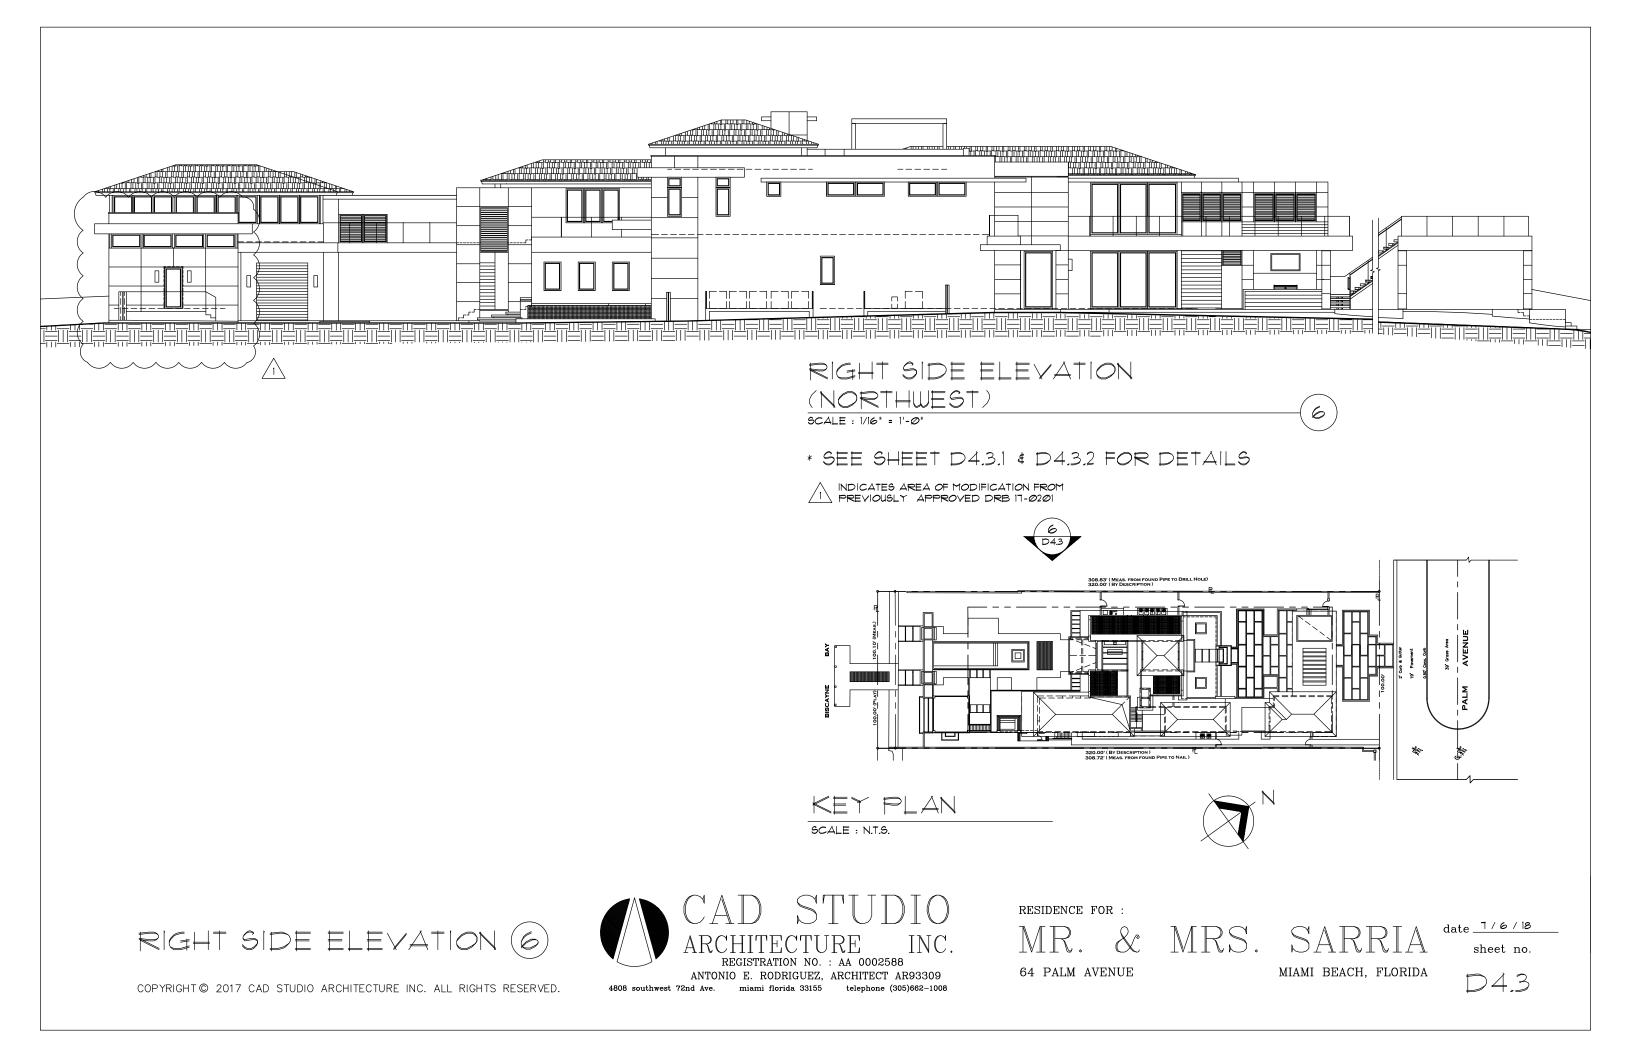


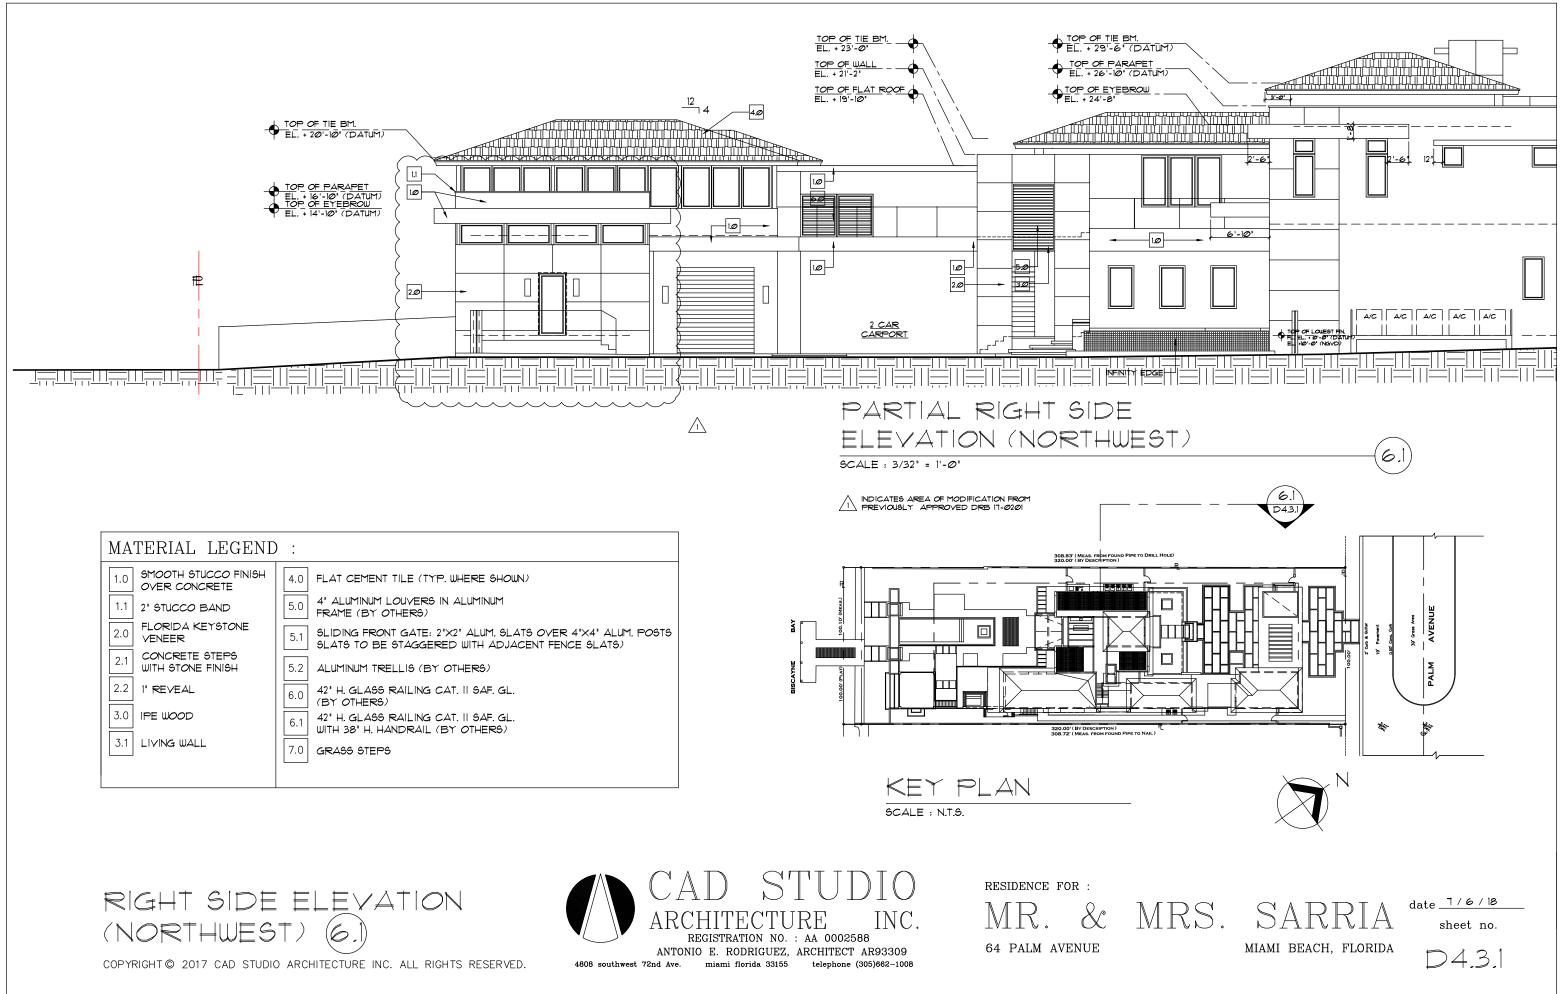










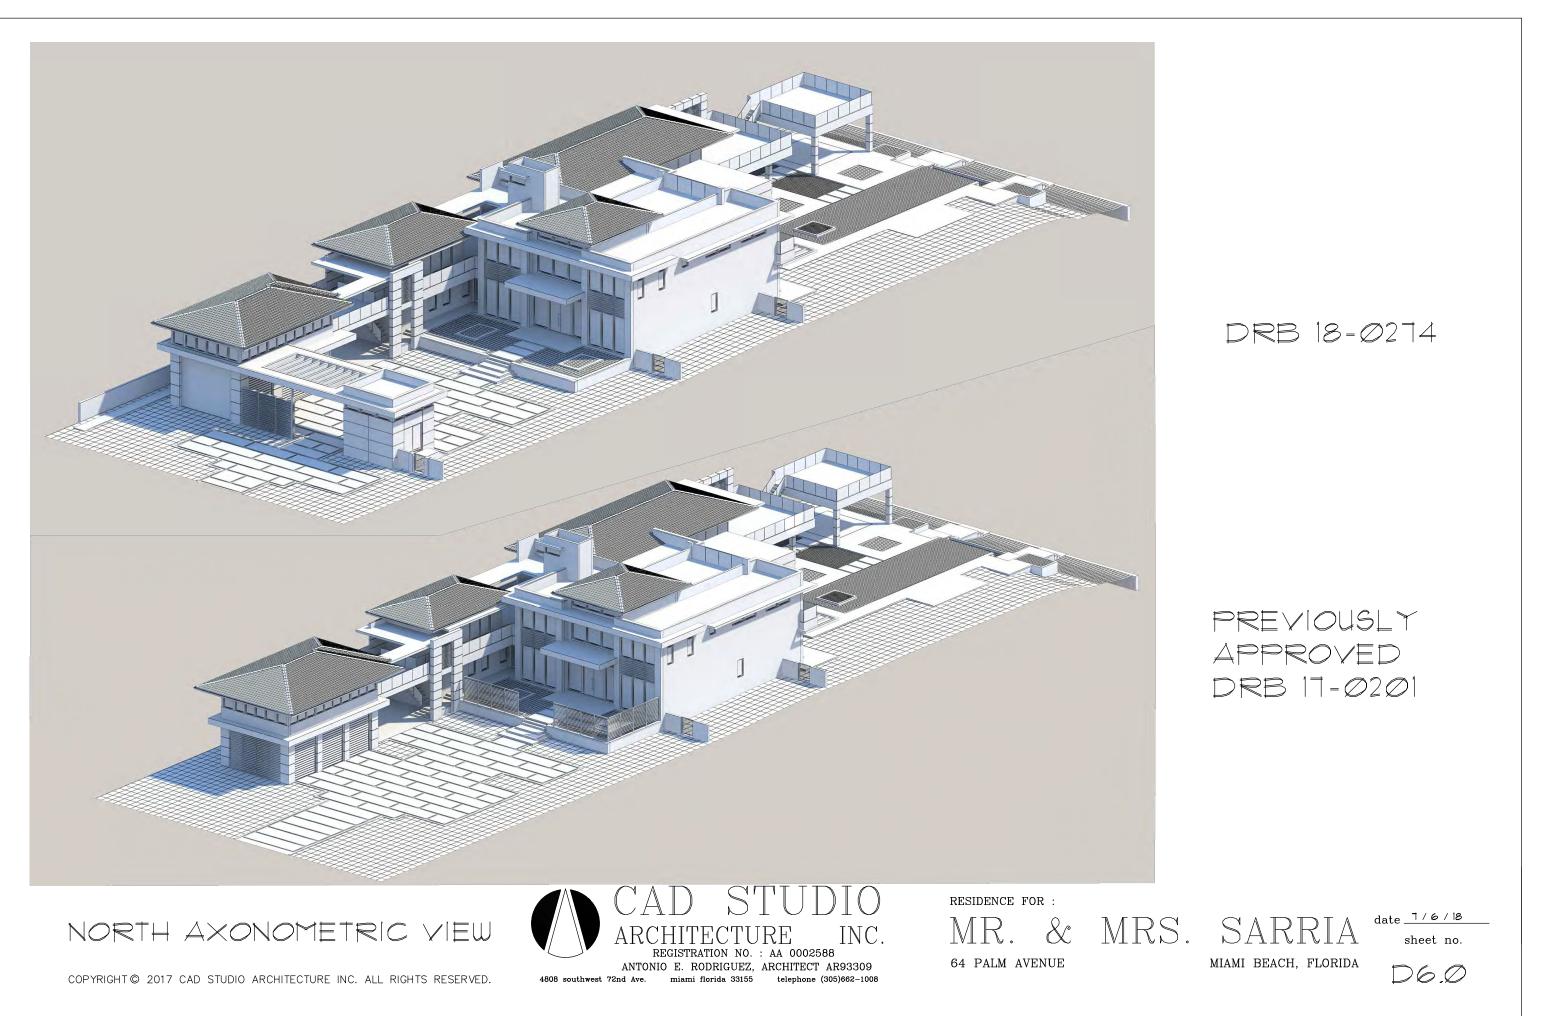

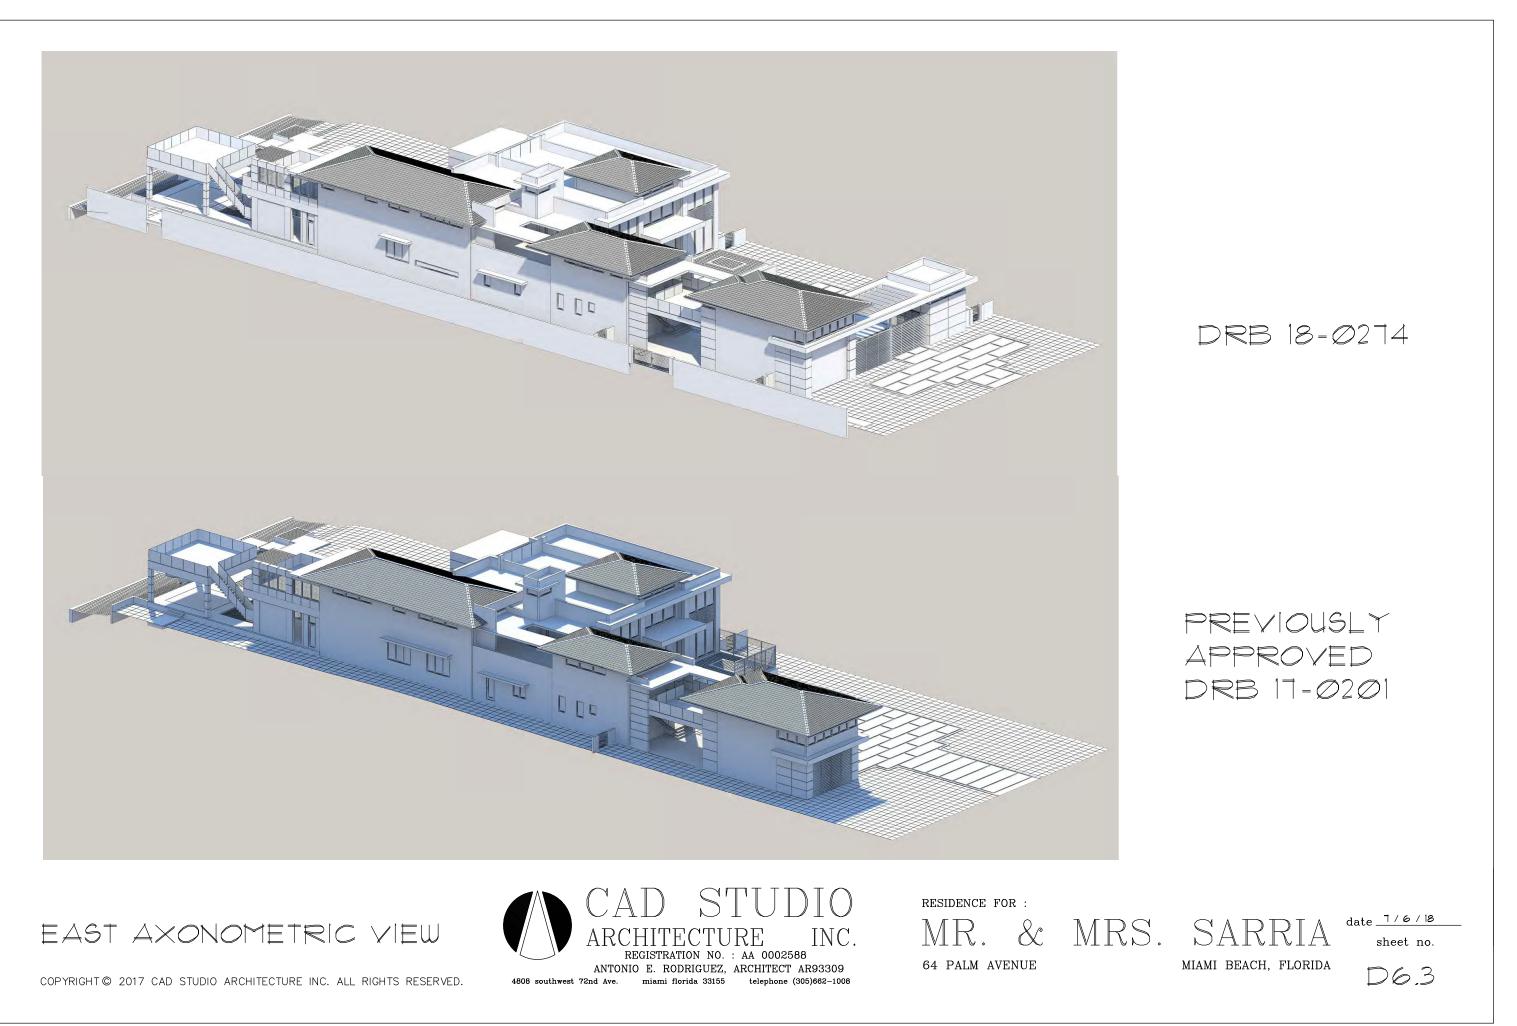



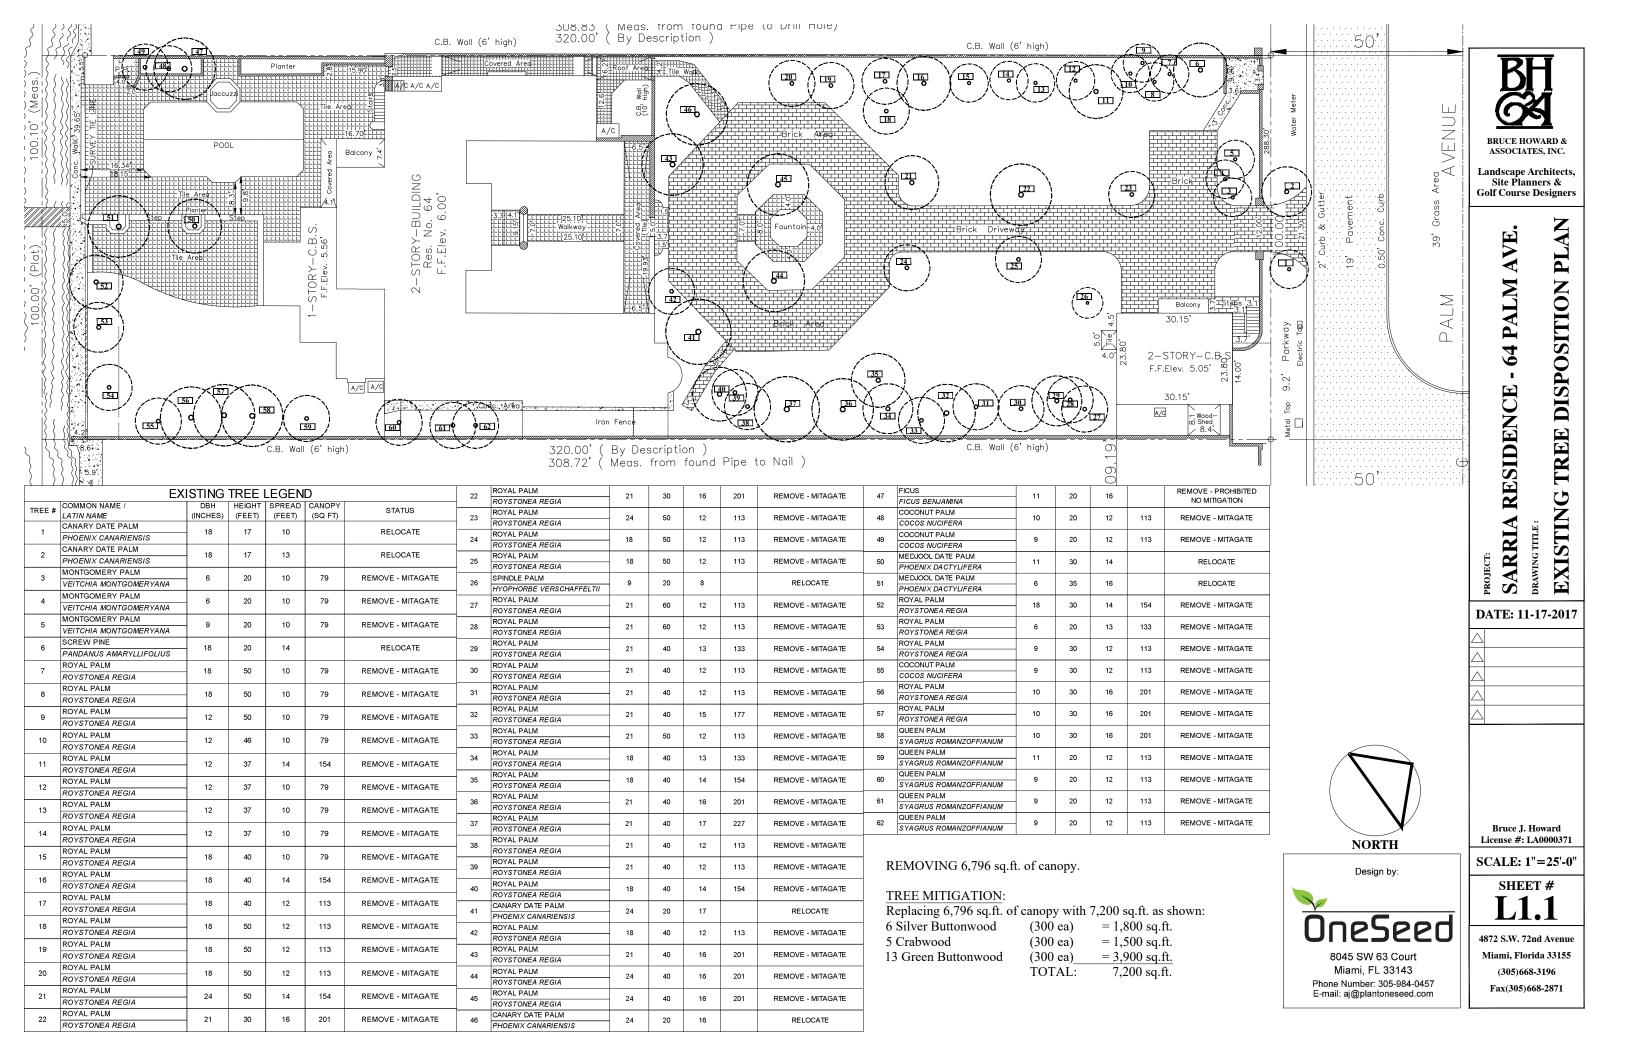

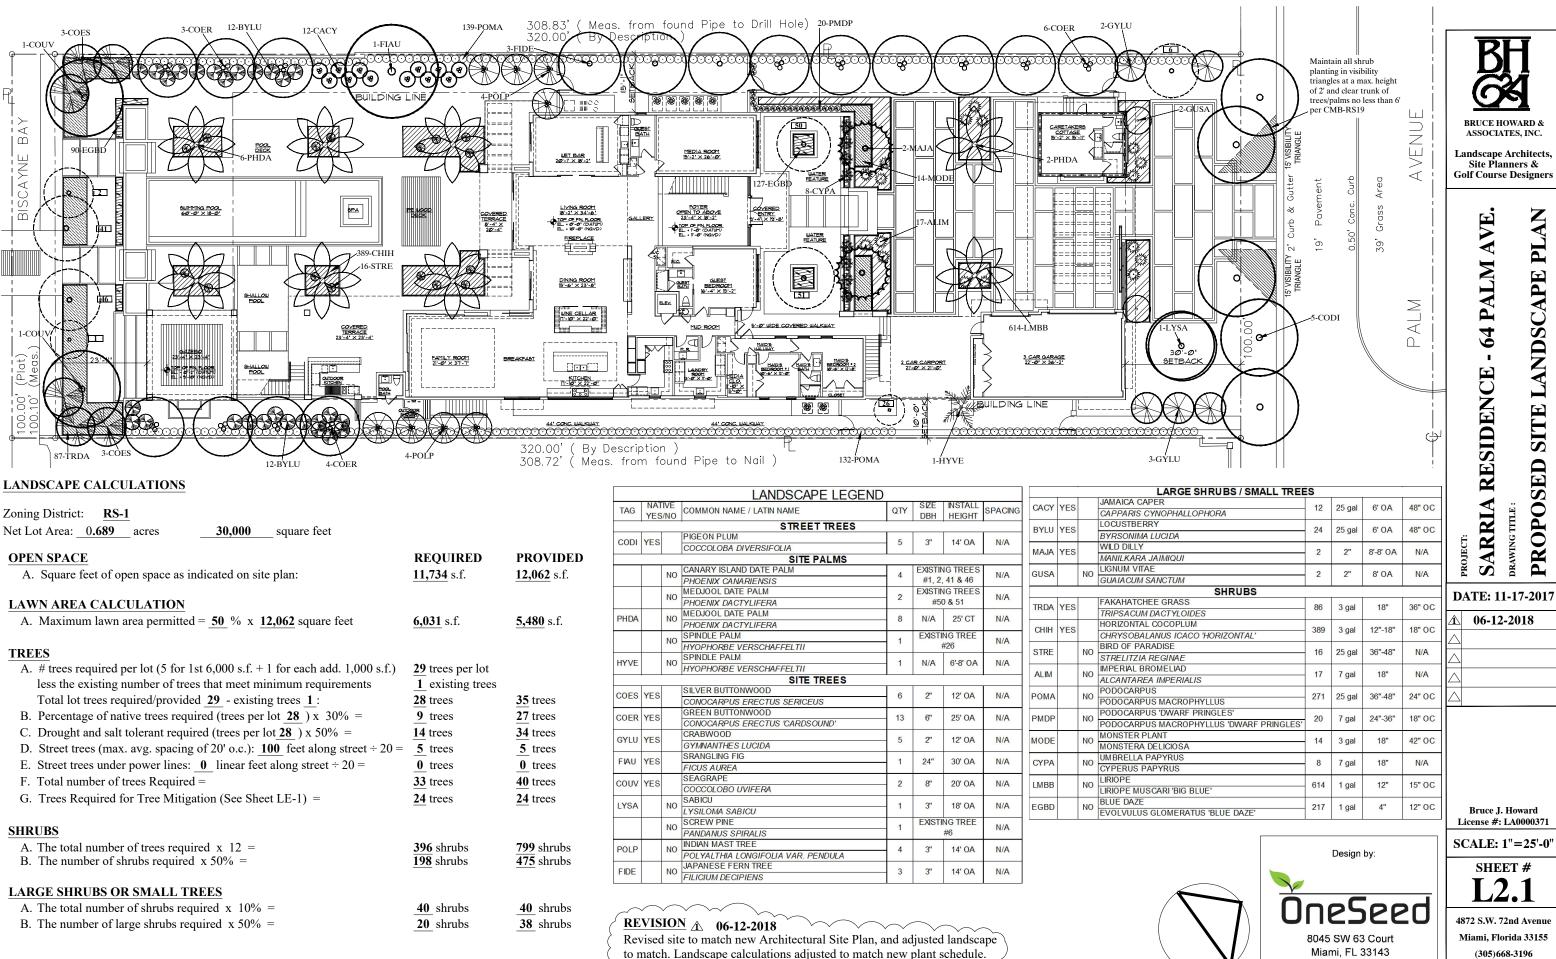


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NORTH

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(305)668-3196 Fax(305)668-2871



ANDSCAPE NOTES

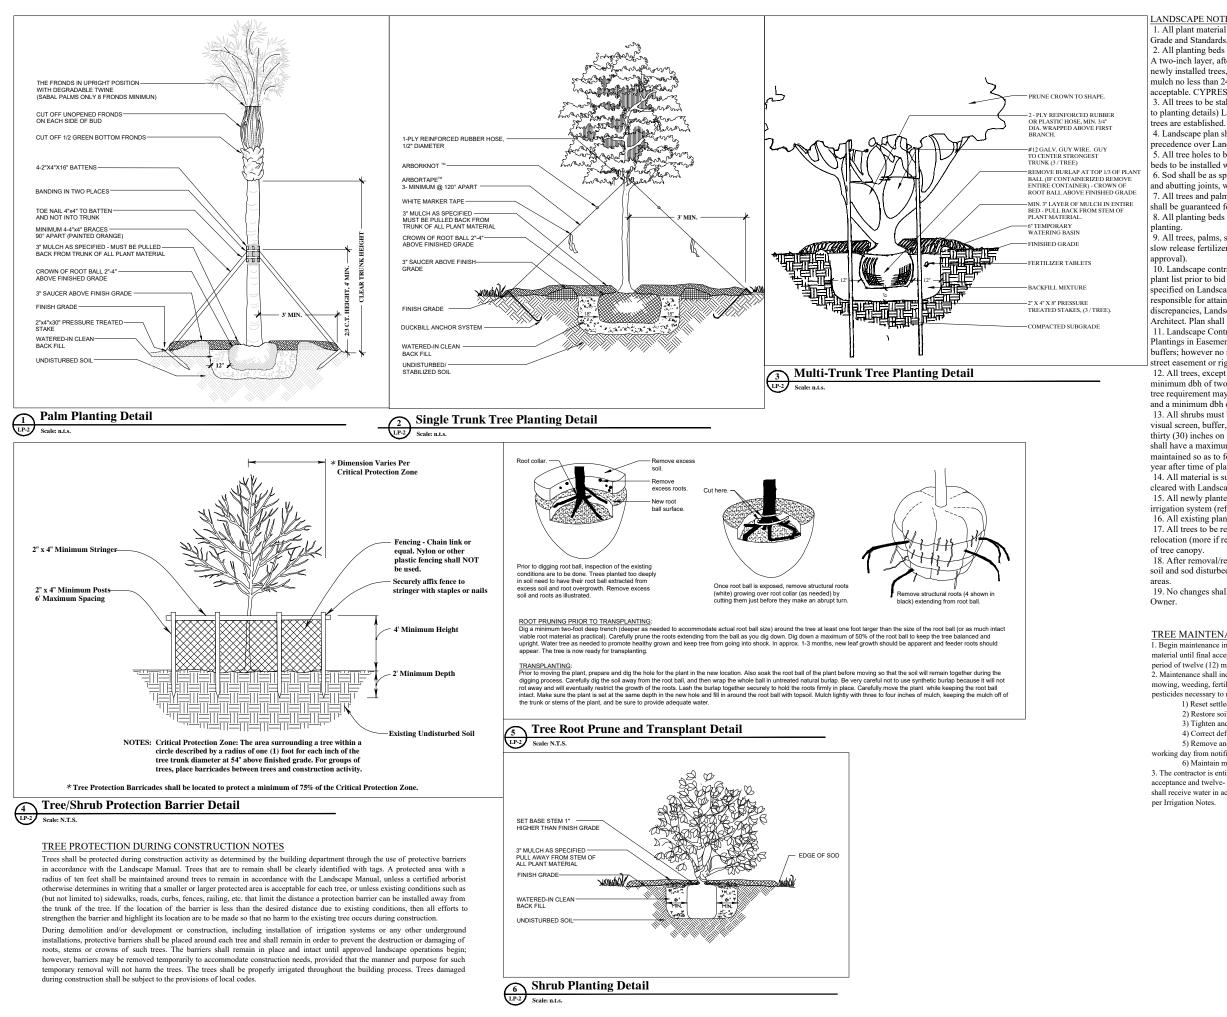1. All plant material to be Florida No.1 or better. Florida Department of Agriculture Grade and Standards, Parts I and II 1973, 1975 Respectively

2. All planting beds to be topped with 2" min. mulch "Grade A", unless otherwise noted. A two-inch layer, after watering in, of mulch must be placed and maintained around all newly installed trees, shrubs, and ground cover plantings. Each tree must have a ring of mulch no less than 24 inches beyond its' trunk in all directions. Red mulch is not acceptable. CYPRESS MULCH WILL NOT BE USED.

3. All trees to be staked in good workmanlike manner. No nail staking permitted. (Refer to planting details) Landscape contractor is responsible for removing trees stakes once

4. Landscape plan shall be installed in compliance with all local codes. Local codes take precedence over Landscape plan.

5. All tree holes to be back filled around and under root ball with planting soil. All shrub beds to be installed with planing soil (see planting details).

6. Sod shall be as specified in the landscape plan. Solid sod shall be laid with alternative and abutting joints, with 2" top soil minimum if required.

7. All trees and palms are to be guaranteed for one year. All shrubs and ground covers shall be guaranteed for six months from date of final acceptance.

8. All planting beds shall be free of weeds, grass, litter, and construction debris prior to

9. All trees, palms, shrubs, and groundcover plants shall be fertilized at installation with slow release fertilizer, according to manufacturer's recommendations (submit sample for

10. Landscape contractor shall review all drawings and prepare his own take off and plant list prior to bid cost, and compare to Landscape Architect's plant list. Sizes specified on Landscape plan are deemed to be minimums. Landscape Contractor is responsible for attaining accurate counts of plant materials specified. In the event of

discrepancies, Landscape Contractor shall bring to the attention of the Landscape Architect. Plan shall take precedence over plant list. No Exceptions! 11. Landscape Contractor shall locate and verify all underground utility prior to digging.

Plantings in Easements: Utility, power, or drainage easements may overlap required buffers; however no required trees or shrubs may be located in any utility, power, or street easement or right-of-way.

12. All trees, except street trees, shall be a minimum of ten (10) feet high and have a minimum dbh of two (2) inches at time of planting except that thirty (30) percent of the tree requirement may be met by native species with a minimum height of eight (8) feet and a minimum dbh of one and one-half (11/2) inches at time of planting.

13. All shrubs must be a minimum of 18" in height at time of planting. When used as a visual screen, buffer, or hedge, shrubs shall be planted at a maximum average spacing of thirty (30) inches on center or if planted at a minimum height of thirty-six (36) inches, shall have a maximum average spacing of forty-eight (48) inches on center and shall be maintained so as to form a continuous, unbroken and solid visual screen within one (1) year after time of planting.

14. All material is subject to availability at time of installation. Substitutions MUST be cleared with Landscape Architect prior to install.

15. All newly planted areas to receive 100% coverage (with 50% overlap) by automatic irrigation system (refer to irrigation plan).

16. All existing plant material to remain shall be protected (see planting details).

17. All trees to be relocated will get root pruned a minimum of 30 days prior to relocation (more if req. by species). Upon relocation, thin out (under LA direction) 25%

18. After removal/relocation of existing trees and palms, backfill tree pit with planting soil and sod disturbed area (if needed) to bring them to the same level of the surrounding


19. No changes shall be made without the prior consent of the Landscape Architect and

TREE MAINTENANCE NOTES

1. Begin maintenance immediately after planting. Maintain all plant material until final acceptance and for a maintenance and warra

- period of twelve (12) months after final acceptance.
- 2. Maintenance shall include but is not limited to pruning, cultivating,
- mowing, weeding, fertilizing, watering, and application of appropriate
- pesticides necessary to maintain plants in healthy condition 1) Reset settled plants to proper grade and position.
 - 2) Restore soil berm and mulch laver.
 - 3) Tighten and repair elastic guys or other supports 4) Correct defective work.
- 5) Remove and replace rejected material within one (1) working day from notification.
 - 6) Maintain mulch surface weed-free
- 3. The contractor is entirely responsible for the irrigation through final
- acceptance and twelve- (12) month warranty period. Plant material
- shall receive water in accordance with the water schedule established



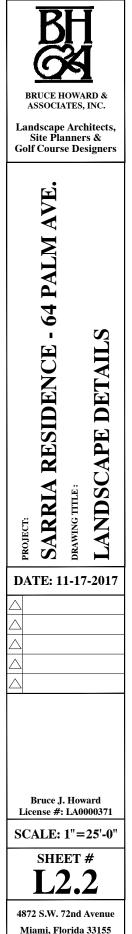

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