

N.T.S.

Issue Date:



AXELBEACH - MIAMI

Project Address: 1500 COLLINS AVE MIAMI BEACH, FL 33139

DesignGroup 7636 NE 4th Court, Suite 101 Miami, FL 33138 T 305-576-2006 F 305-576-2005 www.tsaodesign.com

KEY PLAN (EXISTING DESIGN)



EXISTING CONDITIONS PHOTOGRAPH 01



EXISTING CONDITIONS PHOTOGRAPH 02


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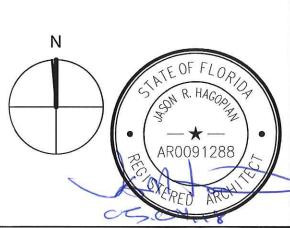


EXISTING CONDITIONS PHOTOGRAPH 01



EXISTING CONDITIONS PHOTOGRAPH 02



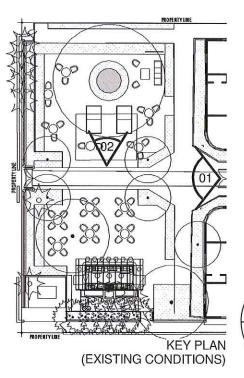

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Sheet Name: SCOPE OF WORK #1
EXISTING PHOTOGRAPHS

Issue Date:



AXELBEACH - MIAMI


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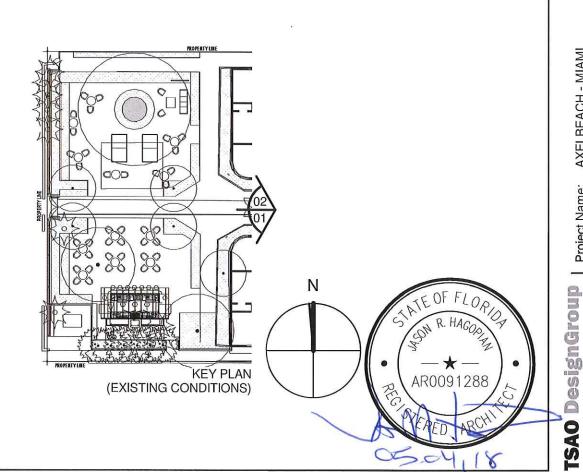
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EXISTING CONDITIONS PHOTOGRAPH 02



EXISTING CONDITIONS PHOTOGRAPH 03





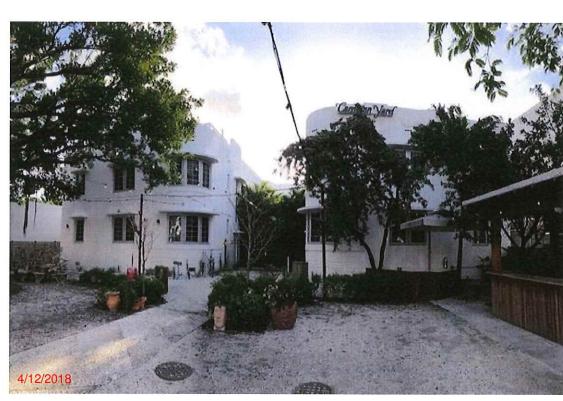



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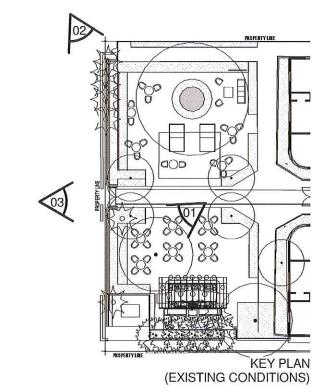
EXISTING CONDITIONS PHOTOGRAPH 01



EXISTING CONDITIONS PHOTOGRAPH 03



EXISTING CONDITIONS PHOTOGRAPH 02





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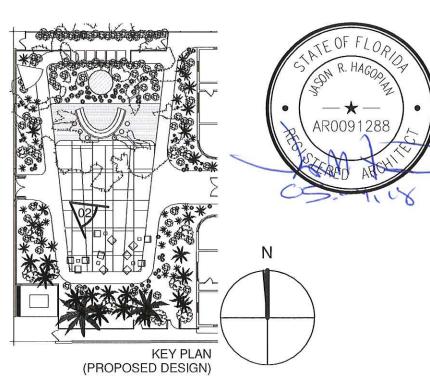
SIGNAGE AT WASHINGTON AVENUE WILL COMPLY WITH ALL SIGN CODES, AND IS NOT PART OF THIS VARIANCE PACKAGE.



RENDERING 01: PROPOSED WASHINGTON AVENUE GARDEN BAR #1



RENDERING 02: PROPOSED WASHINGTON AVENUE GARDEN BAR FURNITURE



Sheet Name: Scale:

ame: SCOPE OF WORK #1 PROPOSED DESIGN RENDERINGS N.T.S.

Issue Date:

AXELBEACH - MIAMI Project Nam

Project Address: 1500 COLLINS AVE MIAMI BEACH, FL 33139


Project Number: 18118.01

DesignGroup


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RENDERING 01: PROPOSED WASHINGTON AVENUE GARDEN BAR #2



DETAIL RENDERING 02: PROPOSED WASHINGTON AVENUE FLOOR FINISHES

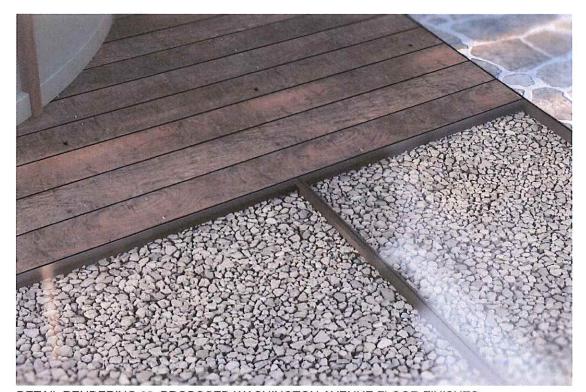

AXELBEACH - MIAMI

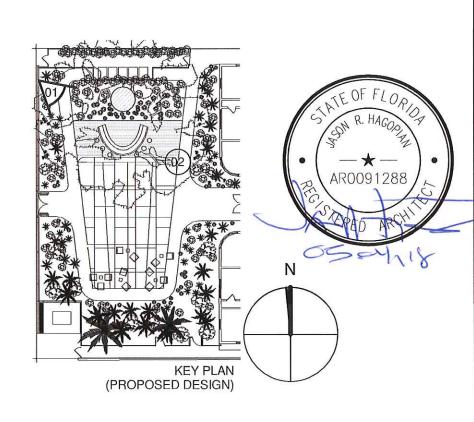Project Address: 1500 COLLINS AVE MIAMI BEACH, FL 33139

Project

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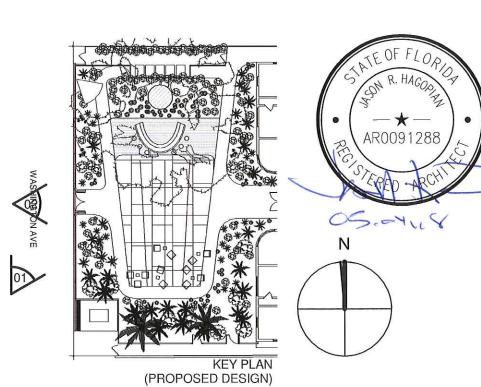
Sheet Name: SCOPE OF WORK #1 PROPOSED DESIGN RENDERINGS Scale: N.T.S.



RENDERING 01: WASHINGTON AVENUE FENCE REFRESH #1



RENDERING 02: WASHINGTON AVENUE FENCE REFRESH #2



Sheet Name: SCOPE OF WORK #1 PROPOSED DESIGN RENDERINGS Scale: N.T.S. Scale:

Issue Date:

AXELBEACH - MIAMI

Project Name:

Project Address: 1500 COLLINS AVE MIAMI BEACH, FL 33139

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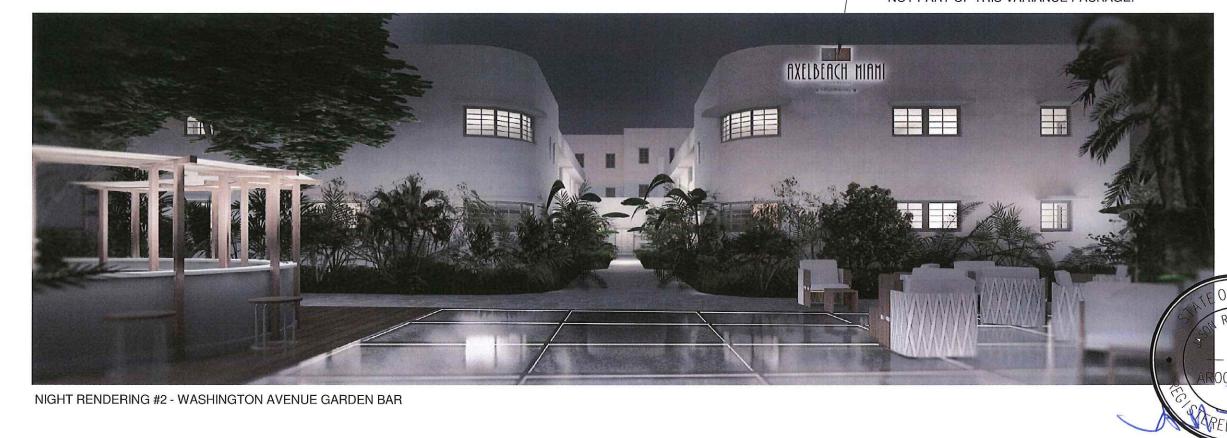
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NIGHT RENDERING #1 - WASHINGTON AVENUE GARDEN BAR

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Sheet Name: SCOPE OF WORK #1 PROPOSED DESIGN NIGHT RENDERINGS Scale: N.T.S.



1500 COLLINS AVE MIAMI BEACH, FL 33139 AXELBEACH - MIAMI Project Name:

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NIGHT RENDERING #3 - WASHINGTON AVENUE GARDEN BAR



Sheet Name: SCOPE OF WORK #1 PROPOSED DESIGN NIGHT RENDERINGS Scale: N.T.S.

Issue Date:

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Project Name:

Project Address: 1500 COLLINS AVE MIAMI BEACH, FL 33139

Project Number: 18118.01

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05/04/18 FINAL SUBMITTAL

AR0091288

Issue Date: Scale:

AXELBEACH - MIAMI

1500 COLLINS AVE MIAMI BEACH, FL 33139

18118.01 Project

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Project Name:

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VIEW 1

NEW PROPOSED SLIDING DOOR (REFER DETAIL 1 ON SHEET SK-17) REMOVE EXISTING DOOR **EXISTING** CAFE/BAR DEMO 6'-0" X 7'-0" OPENING IN EXISTING **EXISTING WALL** .0 - .9 NEW PROPOSED SLIDING DOOR (REFER DETAIL 1 ON SHEET SK-18) NÉW OPENING

VIEW 1

EXISTING BAR TO REMAIN


VIEW 2: PROPOSED RENDERING NEW CAFE/BAR DOORS

PROPOSED FLOOR PLAN: NEW CAFE/BAR DOORS



DEMO OPENING FOR NEW PROPOSED SLIDING DOOR

VIEW 1: EXISTING LOBBY VIEW

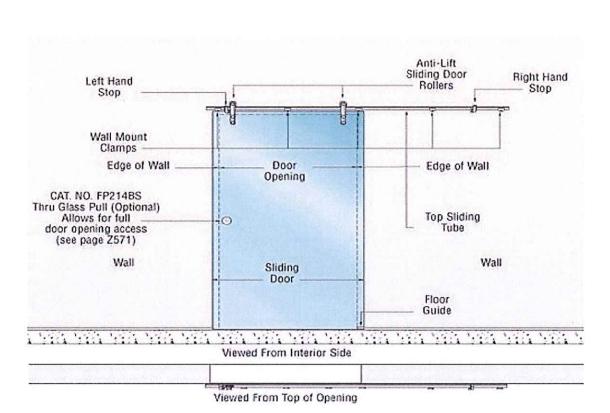

DETAIL 1: SLIDING DOOR EXAMPLE




EXISTING CONDITIONS PHOTOGRAPH 01



EXISTING CONDITIONS PHOTOGRAPH 03



EXISTING CONDITIONS PHOTOGRAPH 02

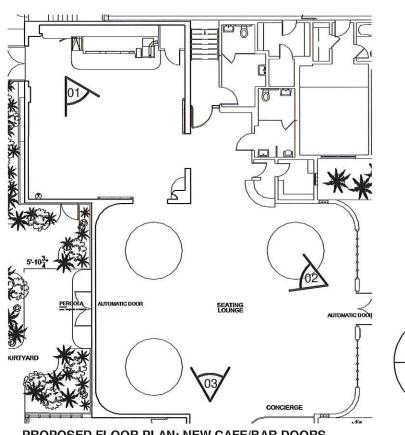

PROPOSED FLOOR PLAN: NEW CAFE/BAR DOORS



N.T.S.

AXELBEACH - MIAMI Project Name:

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DesignGroup

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Project Number: 18118.01


SCOPE OF WORK #3 COLLINS AVENUE ELEVATION SIGNAGE Sheet Name:

N.T.S. Scale:

1500 COLLINS AVE MIAMI BEACH, FL 33139 **AXELBEACH - MIAMI**

Address: Project Name: Project

7636 NE 4th Cour Suite 101 Miami, FL 33138 T 305-576-2006 F 305-576-2005

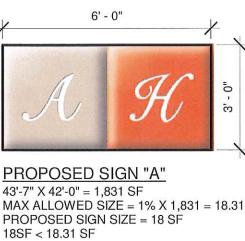

MAX ALLOWED SIZE = 1% X 1,831 = 18.31 SF

PROPOSED SIGN "B"

43'-0" X 42'-0" = 1,806 SF MAX ALLOWED SIZE = 1% X 1,806 = 18.06 SF PROPOSED SIGN SIZE = 18 SF 18SF < 18.06 SF

EXISTING SIGN "C"

20 SF - HISTORIC EXISTING HADDEN HALL SIGN TO REMAIN

TOTAL ALLOWED SIGNAGE = 100 SF

TOTAL PROPOSED SIGNES (2) 18 SF + 20 SF = 56 SF < 100

Sec. 138-21. - Minimum design standards and guidelines. All signs permissible within this article shall comply with the following minimum design standards:

(a) The framework and body of all signs shall consist of aluminum or similar alloy material.

(b) Wall signs shall consist of individual letters, or routed out aluminum panels offset a minimum of four inches from the wall.

(c) Wall sign individual letters shall have a minimum depth of four inches.

(d) Wall sign individual letters shall be pin-mounted or flush-mounted. Raceway or wireway mounting shall only be permitted where the structural conditions of the wall do not allow for the direct mounting of letters. Raceways or wireways, if permitted, shall not exceed the width or height of the sign proposed and shall be subject to the design review process. (e) The placement and location of all signs shall be compatible with the architecture of the building, and shall not cover or obscure architectural features, finishes or elements.

TOP OF PARAPET

TOP OF DECK (ROOF)

TOP OF DECK (01)


TOP OF DECK (02)

TOP OF DECK (01)

TOP OF SLAB (LOBBY



EXISTING VIEW: COLLINS AVENUE ELEVATION

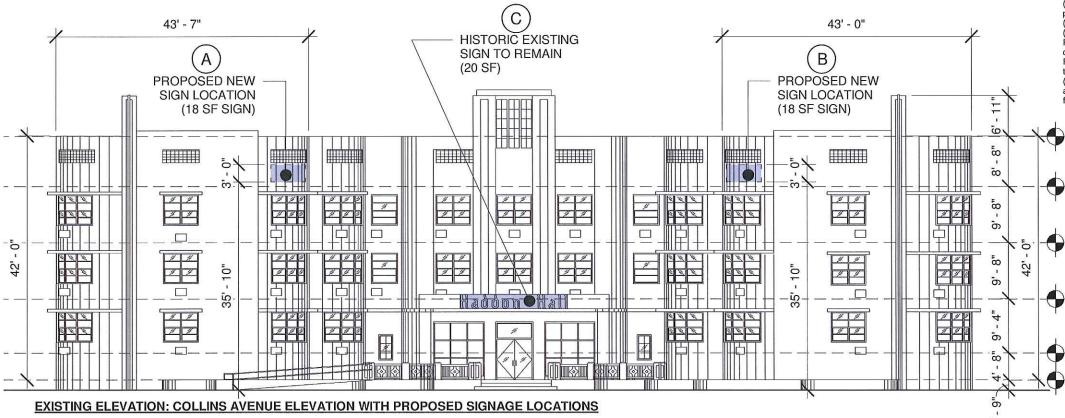

AR0091288

DesignGroup

Date:



RENDERING: PROPOSED ELEVATION



RENDERING: PROPOSED ELEVATION (NIGHT)

AXELBEACH - MIAMI Project Name:

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7636 NE 4th Court,
Suite 101
Miami, FL 33138
T 305-576-2006
F 305-576-2005

Project Address: 1500 COLLINS AVE MIAMI BEACH, FL 33139

Project Number: 18118.01



Sheet Name: SCOPE OF WORK #3 COLLINS AVENUE ELEVATION SIGNAGE Scale: N.T.S.

05.04.16

05/04/18 FINAL SUBMITTAL Issue Date:

SK-28

THE FOLLOWING DRAWINGS ILLUSTRATE THE PROPOSED SCOPE OF WORK FOR 1500 COLLINS AVENUE TO BE PERMITTED BY THE CITY OF MIAMI BEACH:

NEW LANDSCAPE DESIGN FOR COURTYARD IN THE BACK OF THE PROPERTY ALONG WASHINGTON AVENUE.



SHEET INDEX

ANDSCAPE DRAWINGS

LANDSCAPE DRAWINGS

LOT COVER PAGE

LOT COV

DRAWING NOTES

LOCATION MAP



LANDSCAPE ARCHITECT
LAND
2610 NORTH MIAMI AVENUE
MIAMI, FL 33127
614 439 4695
WWW.LAND DESIGN

ARCHITECT
TSAO DESIGN GROUP
7638 NE 4TH COURT, SUITE 101
MAM, FL. 33138
305 576 2005
305 576 2005
WWW TSAODESIGN.COM

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LCVR

SITEWORK GENERAL NOTES

- THE GENERAL CONTRACTOR SHALL BE RESPONSIBLE FOR COORDINATING ALL WORK BY THE SUBCONTRACTORS.
- CONTRACTOR SHALL VERIFY ALL CONDITIONS AT JOB SITE AND NOTIFY LANDSCAPE ARCHITECT AND GENERAL CONTRACTOR OF DIMENSIONAL ERRORS, OMISSIONS OR DISCREPANCIES BEFORE BEGINNING ANY WORK.
- CONTRACTOR TO OBTAIN ALL NECESSARY PERMITS PRIOR TO CONSTRUCTION. ALL CONTRACTORS MUST COMPLY WITH PERMIT REQUIREMENTS, LOCAL, STATE AND FEDERAL JURISDICTIONS AND GOVERNING BODIES/AGENCIES RULES AND REGULATIONS AND LAND USE APPROVAL CONDITIONS AT ALL TIMES.
- 4. WORK PERFORMED WITHOUT APPROVAL OF LOCAL, STATE AND FEDERAL JURISDICTIONS AND GOVERNING BODIES/AGENCIES AND/OR NOT IN COMPLIANCE WITH SPECIFICATIONS AND/OR DRAWINGS IS SUBJECT TO REMOVAL AT CONTRACTOR'S EVIDENCE
- 5. ALL WORK SHALL CONFORM TO THE APPROPRIATE AGENCIES. CONTRACTOR SHALL VERIFY LOCATION OF ALL EXISTING UTILITIES, LINES AND STRUCTURES PRIOR TO EXCAVATION OR TRENCHING. DAMAGE SHALL BE REPAIRED BY THE CONTRACTOR AT NO COST TO THE OWNER. THE LANDSCAPE ARCHITECT ASSUMES NO RESPONSIBILITY FOR UTILITIES OR STRUCTURES NOT SHOWN ON THE DRAWINGS. CONTRACTOR IS TO VERIFY THE EXACT LOCATION OF UTILITIES PRIOR TO CONSTRUCTION AND NOTIFY THE LANDSCAPE ARCHITECT OF ANY DISCREPANCIES. CONTRACTOR SHALL USE EXTREME CAUTION WHEN WORKING OVER OR NEAR EXISTING GAS AND ELECTRICAL LINES.
- 6. THE CONTRACTOR SHALL BE RESPONSIBLE FOR RESETTING ALL LAND MONUMENTS DISRUPTED BY CONSTRUCTION ACTIVITIES OR NEGLIGENCE ON THE PART OF THE CONTRACTOR. RESETS SHALL BE PERFORMED UNDER THE SUPERVISION OF A REGISTERED LAND SURVEYOR AND MONUMENT RECORDS MUST BE FILED AS REQUIRED BY STATUTE FOR ALL MONUMENTS.
- 7. THE CONTRACTOR SHALL TAKE ALL PRECAUTIONARY MEASURES NECESSARY TO PROTECT EXISTING IMPROVEMENTS FROM DAMAGE AND ALL SUCH IMPROVEMENTS AND STRUCTURES DAMAGED BY THE CONTRACTOR'S OPERATIONS SHALL BE REPAIRED OR RECONSTRUCTED SATISFACTORY TO THE LANDSCAPE ARCHITECT AT THE CONTRACTOR'S EXPENSE.
- 8. ALL BARRICADING AND TEMPORARY TRAFFIC CONTROL DEVICES OR METHODS USED DURING CONSTRUCTION SHALL BE IN ACCORDANCE WITH LOCAL, STATE AND FEDERAL JURISDICTIONS AND GOVERNING BODIES/AGENCIES STANDARDS. PROVIDE ADEQUATE TIME FOR REVIEW AND APPROVAL BY THE ABOVE JURISDICTIONS PRIOR TO COMMENCEMENT.
- 9. THE LANDSCAPE ARCHITECT IS NOT RESPONSIBLE FOR THE CONSTRUCTION MEANS, METHODS, TECHNIQUES, SEQUENCES UTILIZED OR FOR SAFETY PRECAUTIONS OR PROBLEMS IN CONNECTION WITH THE WORK. THE LANDSCAPE ARCHITECT WILL NOT BE RESPONSIBLE FOR THE CONTRACTOR'S FAILURE TO CARRY OUT THE WORK IN ACCORDANCE WITH THE CONTRACT DOCUMENTS. CONTRACT DOCUMENTS INCLUDE THE CONSTRUCTION DOCUMENT DRAWING SET/TECHNICAL SPECIFICATIONS MANUAL/LASIS.
- CONTRACTOR TO VERIFY ALL QUANTITIES. IN CASE OF ANY DISCREPANCIES, GRAPHICALLY SHOWN MATERIAL QUANTITIES SHALL TAKE PRECEDENCE.
- A SYSTEM OF DIAGRAMMATIC SYMBOLS, HATCHES AND NOTATIONS IS USED IN THESE DRAWINGS. REVIEW NOTATIONS CAREFULLY, NOTIFY LANDSCAPE ARCHITECT AND REQUEST CLARIFICATION OF ANY UNCLEAR NOTATION OR DISCREPANCY PRIOR TO COMMENCING WORK.

SITEWORK GENERAL NOTES CONTINUED

- PROVIDE SLEEVES AS REQUIRED FOR DRAINAGE, IRRIGATION AND ELECTRICAL LINES. IRRIGATION AND ELECTRICAL SLEEVES AND SUBSURFACE DRAINAGE SYSTEMS SHALL BE CONSTRUCTED PRIOR TO PAVING AND LANDSCAPE WORK. UTILITY SLEEVES ARE REQUIRED IN ALL PLANT BEDS ISOLATED BY PAVEMENT OR ANY OTHER STRUCTURES.
- SPECIAL CONSIDERATION IS GIVEN TO THE DESIGN AND INTENDED RELATIONSHIP BETWEEN ARCHITECTURE, PLANTING AREAS AND PAVING SYSTEMS. PAVEMENT JOINTING, PAVERS, STONE, FINISHES AND GRADES HAVE BEEN STRICTLY COORDINATED IN THE CONTRACT DOCUMENTS. CONSTRUCTION OF THESE SYSTEMS SHALL BE STRICTLY COORDINATED.
- VEHICLES, EQUIPMENT, AND/OR MATERIALS SHALL NOT BE PARKED OR STORED IN AREAS OF EXISTING VEGETATION, INCLUDING WITHIN THE DRIPLINE OF EXISTING TREES TO BEMAIN
- 4. CONSTRUCTION WASTE-INCLUDING BUT NOT LIMITED TO: PLANT MATERIAL, BUILDING MATERIALS, DEMOLISHED MATERIALS, PACKAGING, LEFTOVER PAINT AND CONCRETE SLURRY-SHOULD BE PROPERLY REUSED, RECYCLED, DISPOSED OF LEGALLY OFF-SITE OR IN DESIGNATED WASH-OUT AREAS DETERMINED BY THE GENERAL CONTRACTOR.
- RECYCLING AND TRASH BINS TO BE PROVIDED ON SITE. SEPARATE BINS FOR CARDBOARD, CO-MINGLED, AND OTHER RECYCLABLE/REUSABLE MATERIALS IDENTIFIED BY THE LOCAL JURISDICTION SHALL BE MAINTAINED. ALL BINS TO BE MILE FOR PROOF.
- 6. ON-SITE FUEL STORAGE FOR CONSTRUCTION EQUIPMENT IS DISCOURAGED. CONSTRUCTION EQUIPMENT USED ON SITE TO BE CHECKED REGULARLY TO ASSURE CONTAMINATION CONCERNS FROM OILS AND GREASES ARE ELIMINATED. NO TOXIC MATERIALS SHALL BE STORED ON-SITE.
- GENERAL CONTRACTOR TO KEEP ALL ITEMS IMPLEMENTED BY LANDSCAPE ARCHITECT IN PROPER WORKING ORDER THROUGHOUT THE DURATION OF THE PROJECT.
- 8. THE CONSTRUCTION SITE TO BE INSPECTED ON A MONTHLY BASIS BY LANDSCAPE ARCHITECT AND/OR CIVIL ENGINEER TO ASSURE THAT THE SILT FENCE AND MUD TRACKING PAD ARE PROPERLY IN PLACE AND FUNCTIONING AS DESIGNED.
- GREEN BUILDING PRACTICES SHALL BE EMPLOYED TO THE EXTENT FEASIBLE.
 SUCH PRACTICES INCLUDE: CARPOOLING/VANPOOLING TO JOB SITE, MINIMIZING MATERIALS PACKING BEFORE ARRIVAL TO JOB SITE, REDUCING MATERIAL/RESOURCE INEFFICIENCIES BY COORDINATING WORK.
- 10. THE PROJECT LIMIT OF CONSTRUCTION AND ALL EXISTING VEGETATION TO REMAIN IS TO BE CLEARLY DEFINED BY STURDY, WEATHERPROOF FENCING AT A MINIMUM OF FOUR (4) FEET HIGH.
- 11. WATERPROOFING OF SUBGRADE AND OTHER ARCHITECTURAL SPACES BELOW AND/OR ADJACENT TO IMPROVEMENTS DESIGNED BY THE LANDSCAPE ARCHITECT IS TO BE ADEQUATELY DESIGNED AND DETAILED BY OTHERS TO PERMANENTLY REPEL ALL WATER SOURCES INCLUDING, BUT NOT LIMITED TO: PRECIPITATION, STORM WATER RUNOFF, GROUND WATER, IRRIGATION, ROOF RUNOFF, GROUND WATER, AND PLUMBING LEAKS.
- 12. STRUCTURAL DESIGN TO SUPPORT IMPROVEMENTS DESIGNED BY THE LANDSCAPE ARCHITECT AND LOCATED ABOVE, BELOW, AND/OR ADJACENT TO SUBGRADE AND OTHER ARCHITECTURAL SPACES IS THE RESPONSIBILITY OF THE STRUCTURAL ENGINEER. THE STRUCTURAL DESIGN SHOULD BE ADEQUATELY DESIGNED TO SUPPORT ALL POSSIBLE LOADS INCLUDING, BUT NOT LIMITED TO: BACKFILL, COMPACTION, PLANTINGS, HARDSCAPES, RETAINING AND FREESTANDING SITE WALLS, AND CONSTRUCTION MATERIALS/EQUIPMENT/ACTIVITY.

LANU 2610 NORTH MAMI AVENUE MMANI, FL 38127

SOIL EROSION CONTROL NOTES

- PRIOR TO BEGINNING ANY EARTH CHANGE, THE CONTRACTOR SHALL INSTALL AND MAINTAIN ALL SESC MEASURES AS SHOWN ON THE CONTRACT DOCUMENTS AND AS REQUIRED BY ANY GOVERNING AGENCIES.
- 2. ALL SESC MEASURES TO BE MAINTAINED DAILY.
- 3. THE CONTRACTOR TO CONDUCT ALL EXCAVATION, FILLING, GRADING, AND CLEANUP OPERATIONS IN A MANNER SUCH THAT SEDIMENT, GENERATED BY WIND OR WATER IS NOT DISCHARGED INTO ANY STORM SEWER, DRAINAGE DITCH, RIVER, LAKE, AIR, OR UNDERGROUND UTILITY SYSTEM. STAGE WORK TO MINIMIZE THE AREA OF EXPOSED SOIL. THEREBY REDUCING THE OPPORTUNITY FOR SOIL EROSION.
- 4. WATER FROM TRENCHES AND OTHER EXCAVATION TO BE PUMPED INTO A FILTRATION BAG TO REMOVE SEDIMENTS FROM THE WATER.
- NORTH AMERICAN GREEN SC-150 OR EQUIVALENT EROSION CONTROL FABRIC IS REQUIRED ON ALL DISTURBED SLOPES GREATER THAN 3:1 UNTIL PROJECT AREA IS REVEGETATED PER THE PLANTING PLAN.
- 6. PROVIDE POSITIVE DRAINAGE AWAY FROM ALL STRUCTURES.
- CONTRACTOR TO PROVIDE ONSITE WATERING TO REDUCE FUGITIVE DUST LEAVING THE SITE DURING CONSTRUCTION.
- SOIL EROSION CONTROL MEASURES TO BE PROVIDED FOR ALL EXISTING AND PROPOSED DRAINAGE STRUCTURES WITHIN THE PROJECT LIMITS.
- CONSTRUCTION STAGING AND PHASING SHALL OCCUR, WHERE APPLICABLE, TO MINIMIZE SOIL DISTURBANCE TIME.
- 10. BEST MANAGEMENT PRACTICES (BMPs) SHALL BE ADJUSTED AS NEEDED TO MEET ANY OTHER UNFORESEEN CONDITIONS.
- 11. THE GENERAL CONTRACTOR IS RESPONSIBLE FOR INSTALLING A MUD TRACKING PAD/WASHING PAD AT THE CONSTRUCTION ENTRANCES TO MINIMIZE MUD DETACHMENT FROM TRUCK TIRES. 1-1/2 INCH SCREENED ROCK TO BE PLACED ON MIRAFI 140-N FILTER FABRIC. ADDITIONAL CLEAN GRAVEL TO BE ADDED THROUGHOUT THE DURATION OF CONSTRUCTION AS NEFDED.
- CONTRACTOR SHALL ABIDE BY THE LOCAL, STATE AND FEDERAL JURISDICTIONS AND GOVERNING BODIES/AGENCIES CONSTRUCTION MANAGEMENT PLAN REQUIREMENTS.
- 13. RESEED AS INDICATED IN SEEDING NOTES.



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GENERAL SITE NOTES

DATE ISSUE

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MITIGATION NOTES

 THE PROPOSED PLAN SPECIFIES THE REMOVAL OF 334 SQUARE FEET OF CANOPY AREA FOR SITE TREES. PER, CITY OF MIAMI BEACH CODE OF ORDINANCES, CHAPTER 46, DIVISION 2

DEFINITIONS

TREE: ANY SELF-SUPPORTING WOODY PLANT OR PALM WHICH USUALLY HAS A SINGLE MAIN AXIS OR TRUNK, WITH A MINIMUM TRUNK DIAMETER AT BREAST HEIGHT OF TWO INCHES AND A MINIMUM OVERALL HEIGHT OF 12 FEET. THIS DEFINITION EXCLUDES PLANTS WHICH ARE DEFINED AS SHRUBS, HEDGES, VINES, OR GROUND COVERS. PALMS SHALL HAVE A MINIMUM HEIGHT OF 14 FEET IN ORDER TO BE CLASSIFIED AS A TREE. - CITY OF MIAMI BEACH CODE OF ORDINANCES, CHAPTER 46, DIVISION 2.

TREES & PLANTING TO BE PRESERVED NOTES

- EXISTING TREES TO BE PRESERVED SHALL BEAR SAME RELATIONSHIP TO FINISHED GRADE AS THEY BEAR TO PRE-CONSTRUCTION GRADE.
- EXISTING TREES TO BE PRESERVED SHALL BE PROTECTED WITH STURDY, WEATHERPROOF FENCING AT A MINIMUM FOUR (4) FEET HEIGHT INSTALLED NO CLOSER TO THE TREE TRUNK THAN ITS DRIPLINE. THIS FENCE SHALL BE MAINTAINED IN WORKING ORDER DURING ALL PHASES OF CONSTRUCTION. MAINTAIN TREE PROTECTION ZONES FREE OF WEEDS AND TRASH.
- NO WORK SHALL BE CONDUCTED WITHIN THE DRIPLINE, UNLESS REVIEWED AND APPROVED BY THE LANDSCAPE ARCHITECT. ALL WORK APPROVED WITHIN THE DRIPLINE SHALL BE COMPLETED BY HAND. PROTECT ROOT SYSTEMS FROM PONDING, ERODING, OR EXCESSIVE WETTING.
- THE PROJECT LIMIT OF CONSTRUCTION AND ALL EXISTING VEGETATION TO REMAIN IS TO BE CLEARLY DEFINED BY STURDY, WEATHERPROOF FENCING AT A MINIMUM OF FOUR (4) FEET HIGH.

TREES & PLANTING TO BE REMOVED NOTES

- THE CONTRACTOR IS TO COMPLETELY REMOVE ALL PLANTER MATERIAL DESIGNATED FOR REMOVAL (I.E. ROOT BALL, DEBRIS, SAW DUST, ETC.).
- THE CONTRACTOR IS TO BACKFILL ALL EXCAVATED ROOT BALLS FLUSH TO THE ADJACENT ELEVATION LEVEL.
- 3. CONTRACTOR TO NOTIFY LANDSCAPE ARCHITECT TWO WEEKS IN ADVANCE OF ALL SCHEDULED WORK PERTAINING TO THE RELOCATION OF SITE TREES.


TREE PROTECTION NOTES

- 1. PROTECTION FENCE SHALL BE GALVANIZED CHAIN LINK STANDARD 2"X2" MESH.
- PROVIDE HINGED GATE.
- 3. ALTERNATE: 2X4 WOOD POSTS (6'-0" O.C. MAX) WITH THREE EVENLY SPACED WOODEN RAILS. MIN. HT 4'
- 4. POSTS MAY BE SHIFTED TO AVOID ROOTS.
- 5. NO STORAGE, DEBRIS, VEHICULAR TRAFFIC OR EQUIPMENT CLEANING IS ALLOWED WITHIN THE PROTECTED AREA.
- 6. REFER TO MUNICIPAL REQUIREMENTS FOR ADDITIONAL INFORMATION.

TREE PRUNING

- RETAIN CERTIFIED ARBORIST TO UNDERTAKE PRUNING OF ANY ON SITE OR OFF SITE PLANTING MATERIAL TO REMAIN.
- USE BEST PRACTICES AND FOLLOW MUNICIPAL GUIDELINES FOR ALL PRUNING. DO NOT REMOVE MORE MATERIAL THAN ALLOWED. DO NOT LEAVE MATERIAL MISSHAPEN.

TREE PROTECTION DETAIL

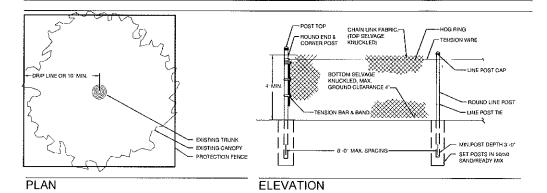

TREES DISPOSITION SCHEDULE

rree Ma.	TREE - LATIN NAME	TREE - COMMON NAME	DIAMETER AT BREAST HEIGHT (in Inches)	HEIGHT OF CANOPY TREES (in feet)	CLEAR TRUNK HEIGHT OF PAUM TRIES (In feet)	CANOPY DIAMETER (in feet)	(In Sq. FTL)	DISPOSITION	сонотом	5 9 5 5	REMOVAL- MUNICIPAL CRITERIA AND NO	16
			1	•						CRITERIA	CANOPY 5Q. FT.	ROW CANOPY SQ. FT.
17	Ficus benghalensis	BANYAN TREE	60	35		50	1963	REMAIN	GOOD			
18	Tomorindus indica	TAMARIN TREE	4	18		10	79	REMOVE	FAIR		79	
	Hcus aurea	FICUS TREE	6	20		12	113	REMOVE	POOR		113	
20	Ptychosterma elegans	ALEXANDER PALM	6		18	9	64	REMOVE	POOR		64	
21	Conocarpus erectus	SILVER BUTTONWOOD	5	18		10	79	REMOVE	ROOR		79	
TREET T	REES	1										
1	Cocos nucifera	COCONUT PALM	10		15	15	177	REMAIN	GOOD			
2	Cocos nucifera	COCONUT PALM	10		15	15	177	REMAIN	GODD			
3	Cocos nucifera	COCONUT PALM	10		15	15	177	REMAIN	GOOD			
4	Cocos nucifera	COCONUT PALM	8		15	15	177	REMAIN	GODD			
5	Cocos nucifera	COCONUT PALM	10		15	15	177	REMAIN	GOOD			
6	Cocos nucifera	COCONUT PALM	10		15	15	177	REMAIN	GOOB			
7	Cocos nucifera	COCONUT PALM	10		15	15	177	REMAIN	GOOD		i	
8	Cocas nucifera	COCONUT PALM	7		15	15	177	REMAIN	GOOD		. 1.	
9	Cocos nuclfera	COCONUT PALM	8		15	15	177	REMAIN	GOOD	l'		
10	Cocos nucifero	COCONUT PALM	8		15	15	177	REMAIN	GOOD			
11	Cocos nucifera	COCONUT PALM	8		15	15	177	REMAIN	GOOD	·	f i	
12	Cocas nucifera	COCONUT PALM	8		15	15	177	REMAIN	GOOD		1	
13	Cocas nucifera	COCONUT PALM	8		15	15	177	REMAIN	GOOD			
14	Cocos nucifera	COCONUT PALM	. 8		15	15	177	REMAIN	GOOD			
15	Cocos nucifero	COCONUT PALM	7		15	15	177	REMAIN	6000			
16	Cocos nucifera	COCONUT PALM	7		15	15	177	REMAIN	6000	I		

2810 NORTH MIAMI AVENUE MIAMI, FL 33127 61 4 439 4895 WWW.LAND DESIGN

AXEL HOTEL

SEAL MARSH C. KRIPLEN LIC.FL LASSSTOOT NOT FOR CONSTRUCTION



TREE DISPOSITION NOTES &

TATE A SECRETARIA

TD100


COEAMONE F2/C



TREE TO BE PRESERVED



TREE TO BE RELOCATED

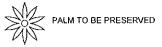



PALM TO BE RELOCATED



TREE TO BE REMOVED





PALM TO BE REMOVED

*** TREE PROTECTION







2610 NORTH MIAMI AVENUE MIAMI, FL 33127 614 439-4895 WWW LAND.DESIGN

PLANTING NOTES

- PLANT MATERIAL IS TO BE HEALTHY SPECIMENS FREE FROM DISEASE OR DAMAGE, AND IS TO BE MAINTAINED IN EXCELLENT CONDITION WHILE ON THE JOBSITE. LANDSCAPE ARCHITECT SHALL INSPECT PLANT MATERIAL UPON ARRIVAL TO JOBSITE AND WILL REJECT PLANT MATERIAL THAT DOES NOT MEET THE STANDARDS DESCRIBED WITHIN THE CONTRACT DOCUMENTS.
- THE LANDSCAPE ARCHITECT WILL PERIODICALLY INSPECT PLANT MATERIAL STOCKPILED AND/OR PLANTED ON SITE DURING THE COURSE OF CONSTRUCTION PLANT MATERIAL NOT MEETING THE STANDARDS CONTAINED WITHIN CONTRACT DOCUMENTS SHALL BE REPLACED AT NO COST TO THE OWNER.
- PROVIDE MATCHING SIZES AND FORMS FOR EACH PLANT OF THE SAME SPECIES UNLESS OTHERWISE INDICATED.
- CONTRACTOR TO VERIFY ALL QUANTITIES. IN CASE OF DISCREPANCIES, GRAPHICALLY SHOWN QUANTITIES SHALL TAKE PRECEDENCE.
- ALL MATERIALS USED SHALL CONFORM TO THE GUIDELINES ESTABLISHED BY THE CURRENT AMERICAN STANDARDS FOR NURSERY STOCK, PUBLISHED BY THE AMERICAN ASSOCIATION OF NURSERYMEN.
- ALL PLANT MATERIAL SHALL BE INSTALLED PLUMB AND PER THE SPECIFICATIONS
 CONTAINED WITHIN THE CONTRACT DOCUMENTS. ANY NEGESSARY STAKING AND/OR
 OTHER SUPPORTS MATERIALS/METHODS SHALL BE SUBMITTED TO THE LANDSCAPE
 ARCHITECT FOR REVIEW AND APPROVAL PRIOR TO INSTALLATION.
- THE CONTRACTOR SHALL PRUNE EXISTING AND/OR NEW TREES ONLY PER LANDSCAPE ARCHITECT DIRECTION.
- THE CONTRACTOR SHALL STAKE THE LOCATIONS OF ALL TREES AND B&B SHRUBS FOR LANDSCAPE ARCHITECT REVIEW AND APPROVAL, PRIOR TO INSTALLATION.
- ALL ROOT-WRAPPING MATERIALS THAT ARE NOT BIO-DEGRADABLE SHALL BE REMOVED FROM THE ROOT BALL. ROOT BALLS SHALL BE FREE OF WEEDS.
- 10. SPECIFIED PLANT MATERIAL SIZES SHALL BE CONSIDERED MINIMUM SIZES.
- 11. FINISH GRADE OF PLANTING BEDS SHALL BE ONE (1) INCH BELOW ADJACENT FLATWORK, UNLESS SPECIFIED OTHERWISE.
- 12. MULCH OR PLANTING BED DRESSING SHALL BE PLACED IN ALL PLANTING AREAS AS SPECIFIED. MULCH OR PLANTING BED DRESSING SHALL NOT BE PLACED WITHIN SIX (6) INCHES OF TREE TRUNKS. MULCHING SHOULD BE REPEATED ANNUALLY DURING THE AUTUMN TO A THREE (3) INCH DEPTH.
- 13. ALL PLANT MATERIAL SHOULD RECEIVE AN ORGANIC FERTILIZER IN LIMITED APPLICATION FOLLOWING INSTALLATION. TYPE AND APPLICATION RATE AND METHOD OF APPLICATION TO BE SPECIFIED BY THE CONTRACTOR AND APPROVED BY THE LANDSCAPE ARCHITECT.
- EXCESS FERTILIZER SHALL BE DISPOSED OF PROPERLY OFF-SITE. IT SHALL NOT BE DISPOSED OF IN STORM DRAINS AND/OR DRYWELLS.
- 15. STOCKPILED PLANT MATERIAL TO BE PLACED IN THE SHADE AND PROPERLY HAND-WATERED UNTIL PLANTED.
- 16. MINI-NUGGET TYPE DECORATIVE BARK MULCH WILL BE USED TO RETURN NUTRIENTS TO THE SOIL, REDUCE MAINTENANCE AND MINIMIZE EVAPORATION FOR AREAS APPROXIMATE TO THE RESIDENCE. LARGER SHREDDED BARK MULCH WILL 9E USED FOR STEEP AREAS SO SLOUGHING IS LESS LIKELY TO OCCUR.
- 17. PRESERVE & PROTECT ALL EXISTING VEGETATION INDICATED TO REMAIN AT ALL TIMES.
- 18. ALL VEGETATION PROPOSED FOR OUTSIDE THE BUILDING ENVELOPE TO BE NATIVE UNLESS OTHERWISE NOTED. PLANTING THAT OCCURS OUTSIDE THE BUILDING ENVELOPE IS FOR RESTORATION PURPOSES ONLY OR IS SPECIFIC TO UTILITIES RESTORATION.
- SIX (6) INCH PLANT MIX SHALL BE PROVIDED FOR ALL LAWN, TURF, AND NATIVE PLANTING ZONES. 18 INCH PLANT MIX SHALL BE PROVIDED FOR ALL PERENNIAL PLANTING BEDS UNLESS OTHERWISE NOTED.
- 20. LANDSCAPE CONTRACTOR SHALL GUARANTEE ALL NEW TREES AND PALMS FOR A PERIOD OF 1-YEAR FROM DATE OF INITIAL ACCEPTANCE.
- 21. A FINAL ONSITE INSPECTION SHALL BE REQUIRED WITH URBAN FORESTRY DIVISION STAFF PRIOR TO ANY OFFICIAL ACCEPTANCE OF ROW PLANT MATERIAL, IN ORDER TO VERIFY PROPER PLANTING DEPTH, SPACING AND QUALITY OF MATERIAL. FAILURE TO CONDUCT THE INSPECTION COULD RESULT IN REJECTION OF THE PLANT MATERIAL.

PLANTING SCHEDULE

EXISTING TREES TO REMAIN					
# BOTANICAL NAME	COMMON NAME	DBH. HT. S	SPREAD ACTION	NOTES	
17 FICUS BENGHALENSIS	BANYAN TREE	60° 35°	50' REMAIN		

TITY I BOTANICAL NAME	COMMON NAME	SPECIFICATIONS	
COCOS NUCIFERA	COCONUT PALM	CHARACTER CURVE TRUNK 25' OA	
SABAL PALMETTO	CABBAGE PALM	CHARACTER CURVE TRUNK 30" OA	
	COCOS NUCIFERA SABAL PALMETTO	COCOS NUCIFERA COCONUT PALM	COCOS NUCIFERA COCONUT PALM CHARACTER CURVE TRUNK 25' OA SABAL PALMETTO CABBAGE PALM CHARACTER CURVE TRUNK 30" OA

THE	ES			
CGR	4	CAESALPINIA GRANADILLO	BRIDALVEIL	200 GALLON, 4" CAL. 12' HEIGHT MIN.
CRO	3	CLUSIA ROSEA	AUTOGRAPH TREE	200 GALLON, 2" CAL. 10' HEIGHT MIN. MULTI.
CUV	1	COCCOLOBA UVIFERA	SEA GRAPE	300 GALLON, 4° CAL. 12' HEIGHT MIN. MULTI.
PRA	6	PIMENTA RACEMOSA	BAY RUM	25 GALLON, 2° CAL, 8' HEIGHT MIN.

AT	312	ASCLEPIAS TURBEROSA	ORANGE BUTTERFLY PLANT	3 GAL. 18" O.C.	
MS	20	MICROSORUM SCOLOPENDRIUM	WART FERN	3 GAL. 24" O.C.	
MD	130	MONSTERA DELICIOSA	MONSTERA	3 GAL 24" O.C.	
NB	129	NEPHROLEPIS BISERRATA	MACHO FERN	3 GAL 24" O.C.	
PB	394	PHILODENDRON BURLE MARX	PHILODENDRON	3 GAL. 18° O.C.	



AXEL HOTEL


SEAL (MARSH C. KRIPLEN LIC.FL LAGGETOOT) NOT FOR CONSTRUCTION




PLANTING SCHEDULE & NOTES
DATE / ISSUE




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LIMIT OF WORK

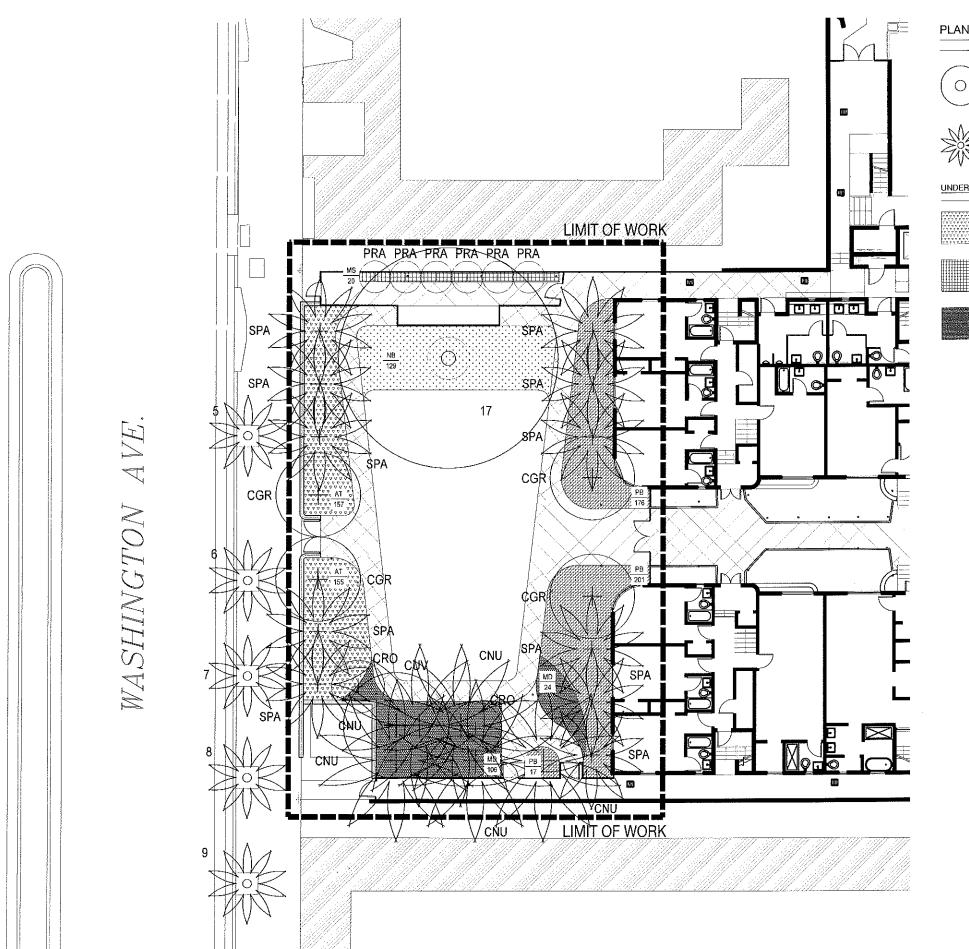MD, MONSTERA DELICIOSA

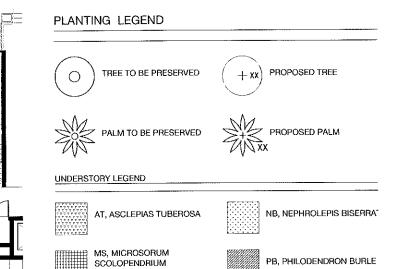



SEAL (MARSHIC, KRIPLEN LIC.FL LASSSF007) NOT FOR CONSTRUCTION

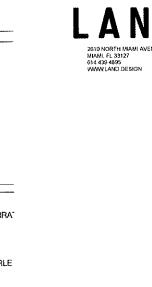

PLANTING PLAN

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TOP OF STAKE MUST BE MINIMUM OF 3" BELOW FINISHED GRADE

PLANT SPACING ROW SPACING 10.4 15.6 18" 24" 20.8" 26.0" 31.2° 41.6" 52.0" PLANT SPACING 6 SCALE: NOT TO SCALE

IN MOST CASES TRIANGULAR SPACING IS PREFERRED, USE SQUARE SPACING ONLY IN SMALL RECTILINEAR AREAS. EQUAL TYPICAL PLANT SPACING SQUARE SPACING PLAN

PLANT LOCATIONS TYPICAL PLANT SPACING -----TRIANGULAR SPACING PLAN

DIG OUT / DECOMPACT EXISTING SORT TO ENSURE PROPER DRAMAGE UNDERNEATH ROOT BALL, FRACTURE CORAL ROCK TO ENCOURAGE DEEP ROOTING, BLEND IN SOME PLANTING SOIL INTO EXISTING SUB GRADE AS FLASTELS

FERTILIZE PER SPECIFICATIONS

EXCAVATE PLANTING PIT. REMOVE ROOTS, ROCKS, & OTHER DEBRIS & CONTAMINANTS. TAKE EXISTING NATIVE SOIL, (ROCKY FILL, SAND OR SIMILAR) AND BLEND 50/50 WITH SPECIFIED PLANTING SOIL 1.5 X BALL DIA.

-CONTAINER GROWN SHRUB

-FINISH GRADE / SOD OR PAVING

BREAK- UP COMPACTED SUBGRADE & ROCK TO A DEPTH OF 1 1/2 TIMES THE SIZE OF ROOT BALL

EXCAVATE PLANTING PIT. REMOVE. ROOTS, ROCKS, & OTHER DEBRIS & CONTAMINANTS. TAKE EXISTING NATIVE SOIL, (ROCKY FILL, SAND OR SIMILARY AND BLEND 50/50 WITH PLANTING SOIL (70/30 SAND/MUCK) AS USED AS A BLENDED MIX TO ENCOURAGE ROOT GROWTH INTO SURROURDING AREA.

- EXISTING UNDISTURBED SUBSOIL

-2" LAYER OF MULCH

SHRUB PLANTING

SCALE: NOT TO SCALE

9 STAKING DETAIL SCALE: NOT TO SCALE

PREPARATION:
STORE ALL MATERIAL IN DRY, CLEAN AREA, COVER TO PROTECT FROM RAIN AND
MINIMIZE DUST. COORDINATE RUN-OFF COMIRCO WITH GENERAL CONTRACTOR.
TEST DUSTINGS SOLD TO ENSURE IT IS FREE OF EXCESSIVE CLAY OR SALT AND ANY
CHEMICALS/PETROCHEMICALS WHICH MAY HARM PLANT HEALTH.

EXISTING MATERIAL:
IF INCORPORATING EXISTING SITE SOIL REMOVE ALL ROOTS, AND ROCK LARGER THAN
2° IN 92E. REMOVE ALL PLASTIC, WETAL AND MAINVADE DETRITUS.

MIX: 50% EXISTING SOIL 10% COCO PEAT 10% COUPOST 20% CLEAN SAND 10% PERLITE

BLEND QUANTITIES NEEDED BY HAND OR MACHINE

INSTALLATION: REFER TO APPROPRIATE DETAILS FOR AVENDMENTS, COMPACTION DEPTHS ETC.

GENERAL: REFER TO LANDSCAPE NOTES FOR ADDITIONAL INFORMATION

PLANTING SOIL- TYPICAL

MULCH A: PINE STRAW, FOR USE IN GENERAL PLANTING AREAS AND ON SLOPES GREATER THAN 102

MULCH B: MINI PINE BARK NUGGETS, FOR USE IN SPECIALTY AREAS

MULCH C: MELALEUCA MULCH, FOR USE IN GENERAL PLANTING AREAS AND ON SLOPES GREATER THAN 10%

BLEND QUANTITIES NEEDED BY HAND OR MACHINE.

installation: Refer to appropriate details for extents and depths.

GENERAL: REFER TO LANDSCAPE NOTES FOR ADEXTIONAL INFORMATION, CONFRM TYPE TO BE USED WITH LANDSCAPE ARCHITECT PRIOR TO INSTALLATION.


MULCH- TYPICAL

MIX: # 5050- MUCK AND FINE SAND

SUPPLIER: ATLAS PEAT AND SOIL 561,734,7300


PLANTING SOIL- LAWN TOP DRESSING



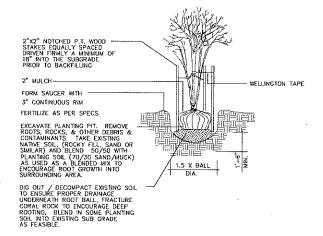


MULTI TRUNK TREE- PLANTING & STAKING

CALIPER STRANDS STAKES 1" - 1 1/2" 1 # 12 2 - 2 X 2 1 1/2" - 2" 1 # 12 3 - 2 X 2 2" - 3" 2 # 12 2 - 2 X 2

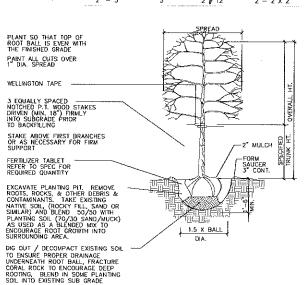

NOTE: USE FOR 3" OR LESS SINGLE STEM TREES & PALMS

(8) CANOPY AND PALM TREE- PLANTING & VERTICAL STAKING SCALE: NOT TO SCALE

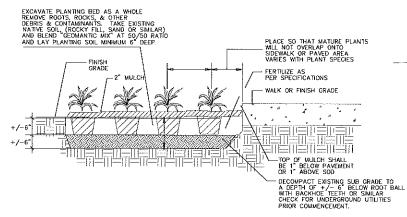


SHRUB- HEDGE AND MASS PLANTING SCALE: NOT TO SCALE

CALIPER CLEATS NAILS 3" - B" 2 x 4 x 8" 1 # 12 3 - 2 X 4 2 - 16d 8" - 10" 2 x 4 x 12" 1 # 12 3 - 2 X 4 10" - 16" 2 x 4 x 12" 2 # 12 4 - 2 X 4 3 - 166 SPREAD PLANT SO THAT TOP OF ROOT BALL IS EVEN WITH THE FINISHED GRADE STAKE TO FIRST BRANCHES AS NECESSARY FOR FIRM SUPPORT WRAP TRUNK W/ 5 LAYERS OF BURLAP, IF SOFT SKIN BARK WOODEN CLEATS WILL BE EQUALLY SPACED OVER PADDING & SECURED W/ STEEL BANDS EQUALLY SPACED 2" X 4"
P.T. WOOD STAKES NAILED TO
CLEATS. DO NOT NAIL TO TRUNK FORM SAUCER WITH 3" CONTINUOUS RIM EXCAVATE PLANTING PIT. REMOVE ROOTS, ROCKS, & OTHER DEBRIS & CONTAMINANTS. TAKE EXISTING NATIVE SOIL, (ROCKY FILL, SAND OR SIMILAR) AND BLEND 50/50 WITH REFER TO STAKING DETAIL PLANTING SOIL (70/30 SAND/MUCK)
AS USED AS A BLENDED MIX TO
ENCOURAGE ROOT GROWTH INTO
SURROUNDING AREA. 1.5 X BALL DIG OUT / DECOMPACT EXISTING SOIL TO ENSURE PROPER DRAINAGE UNDERNEATH ROOT BALL, FRACTURE CORAL ROCK TO ENCOURAGE DEEP ROOTING, BLEND IN SOME PLANTING SOIL INTO EXISTING SUB GRADE AS FEASIBLE NOTE: USE FOR 3" TO 12" SINGLE TRUNK TREES

CANOPY TREE- PLANTING & TRIPLE BRACE STAKING

SCALE: NOT TO SCALE

SHRUB- HEDGE AND MASS PLANTING

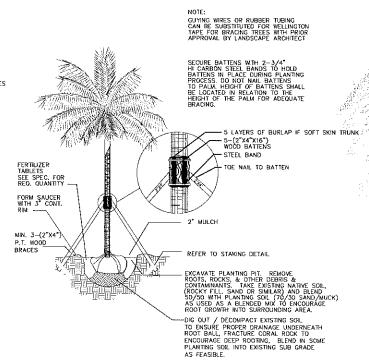

PALM- PLANTING & STAKING

HOTE AXEL

MAMI, FL 33127 614.439.4995

(MARSH C. KRIPLEN LIC.FL-LA6667007) NOT FOR CONSTRUCTION.

HITEO

25-15.18

/ PLANTING DETAILS ISSUE

J. 7

SCALE AS NOTED