
SANTORO RESIDENCE


ADDITION TO AN EXISTING SINGLE FAMILY RESIDENCE


828 4TH STREET, MIAMI BEACH FL 33139




PROJECT DATA FLORIDA BUILDING CODE, 5TH EDITION 2014 5TH EDITION FLORIDA FIRE PREVENTION CODE, 2016 BROWARD FIRE AMENDMENTS FLORIDA ADMINISTRATIVE CODE 69A-40 CITY OF MIAMI BEACH MIAMI DADE COUNTY STATE OF FLORIDA PROJECT TEAM <u>ARCHITECT</u> JOSEPH B. KALLER AND ASSOCIATES, P.A. FLORIDA HISTORIC HOMES LLC CONTACT: MR. JOSEPH B. KALLER CONTACT: FABRIZIO SANTORO 2417 HOLLYWOOD BLVD. ADDRESS: 440 SOUTH FEDERAL HIGHWAY HOLLYWOOD, FL 33020 HOLLYWOOD, FL 33020 (954) 920-5746 (954) 274-4832 (954) 926-2841 fabrizio@altoinvestments.com joseph@kallerarchitects.com <u>SURVEY OR</u> LANDSCAPE ARCHITECT COUSINS SURVEYORS AND ASSOCIATES, INC. TONNING AND ASSOCIATES INC. CONTACT: RICHARD COUSINS CONTACT: WAYNE TONNING ADDRESS: 3921 SW 47TH AVENUE, SUITE 1011 199 JEFFREY STREET DAYIE, FL 33314 BOCA RATON, FL 33481 (954) 680-9885 PHONE: (561) 414-8269 RECourveyr@aol.com FAX: (561) 892-5977 EMAIL: tonningrla@aol.com

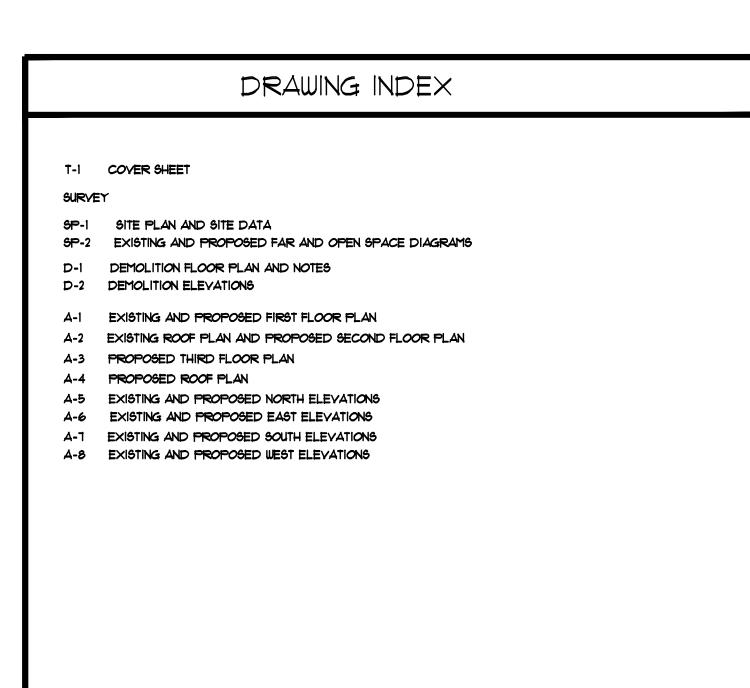

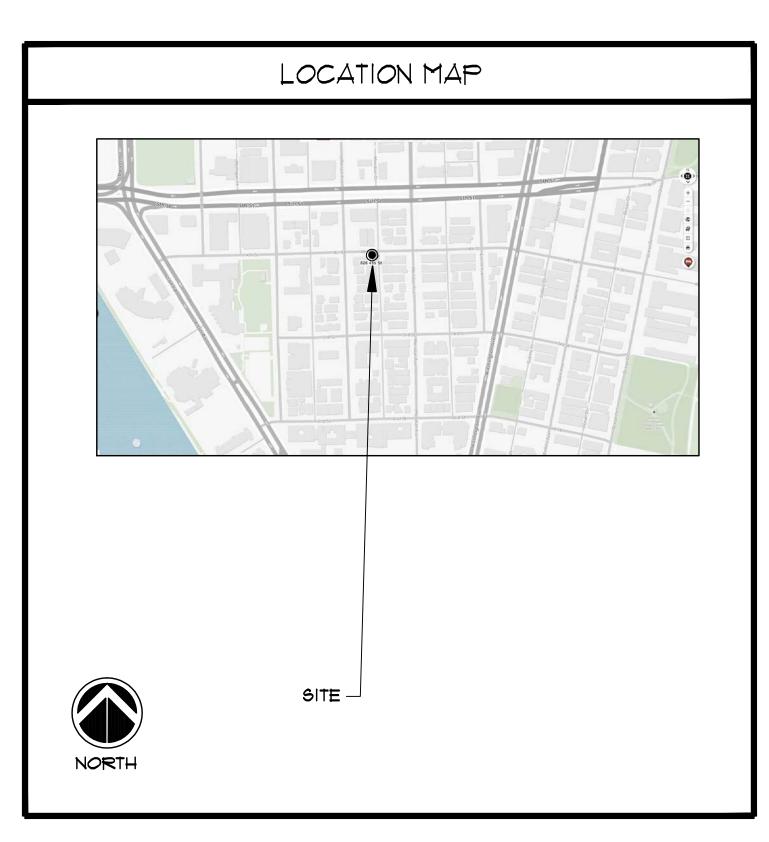

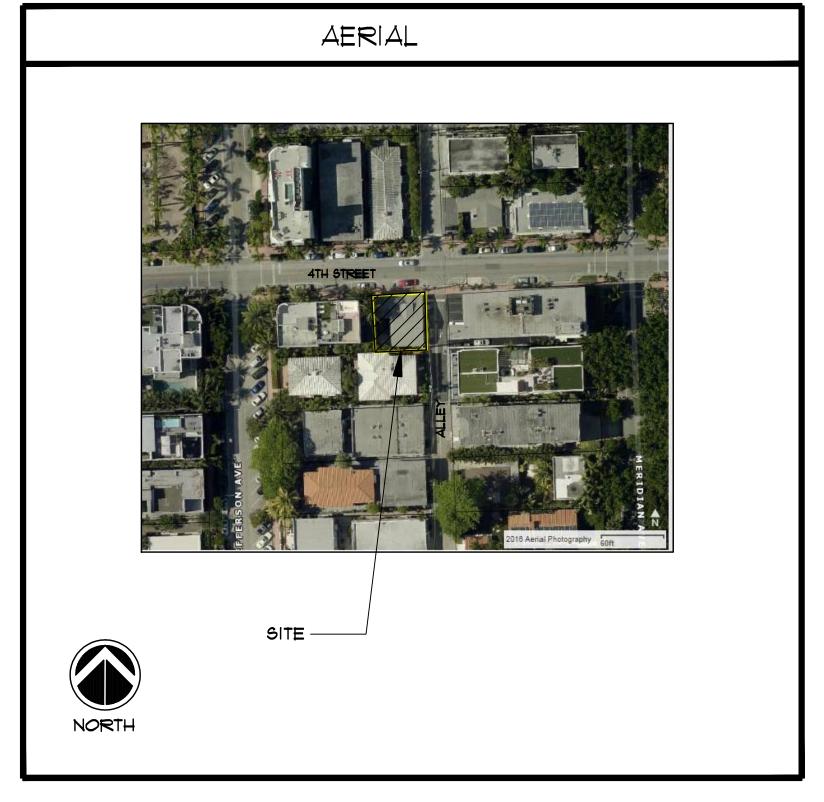

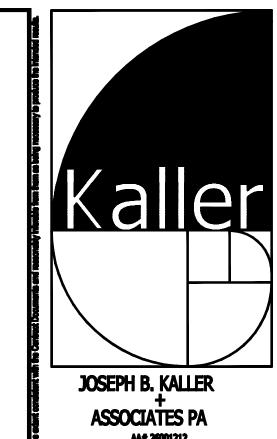

+ ASSOCIATES PA

AA# 26001212


2417 Hollywood Blvd. Hollywood, Floride 33020
(954) 920 5746 phone - (954) 926 2041 fax
kaller@belleouth.net

SEAL

JOSEPH B. KALLER FLORIDA R.A. # 0009239

SANTORO RESIDENCE
ADD. TO EXIST. RESIDENCE
828 4TH STREET
MIAMI BEACH FL 33139

TITLE PAGE HPB

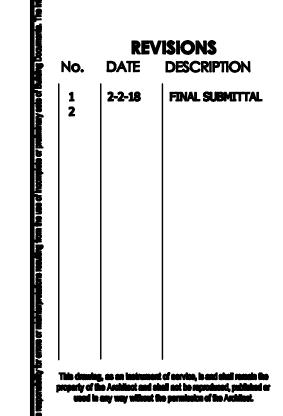


PROJECT No.: 1710
DATE: 9-17
DRAWN BY: TMS
CHECKED BY: JBK

SHEE

T-1

4TH STREET FP&L MANHOLE WATER WATER ASPHALT PAVEMENT RIM = 4.77VALVES VALVE 0 0 \bowtie 25. 25. ASPHALT PAVEMENT **TRENCH** DRAIN CATCH BASIN CURB 2' CURB & RIM=4.50' PALM, INLET **GUTTER** DROPPED CURB DROPPED CURB CONCRETE WALK PLANTER-0.0 CONCRETE WALK 2.6 **HEDGE** 50.00 ્ ઈ FIR(§ GATE HEDGE **PLANTER** HEDGE PAVEMENT FIP(1/2") ŴOOD WITH WOOD FENCE HEDGE HEDGE FENCE 26.6' STEPS COVERED CORAL ROCK 8. ×7. HEDG **ASPHALT** W BUILDING WM B 2.0 LEGEND: CKD CHECKED BY FINISHED FLOOR ELEVATION=8.32' CONC CONCRETE / DRAWN BY Z DWN CATCH BASIN RIM=4.67' AI.I.F 00 / FB/PG FIELD BOOK AND PAGE BLOCK WALI SIR SET 5/8" IRON ROD & CAP #6448 50, OF BLOCK 50.00 CBS ,0.4 BFP N 50 SET NAIL AND CAP #6448 SNC 42.5 FOUND IRON ROD FIR CONCRETE FIP FOUND IRON PIPE \geq STORY WM GUTTER FNC FOUND NAIL AND CAP LOT 16, FDH FOUND DRILL HOLE WEST F 16, 2 HEDGE A/C AIR CONDITIONER SLAB P.B. PLAT BOOK **PAVEMENT** M/D.C.R. MIAMI/DADE COUNTY RECORDS 19.0 -X-CHAIN LINK/ WOOD FENCE WATER METER **ELEVATION** CPP CONCRETE POWER POLE BACK FLOW PREVENTER SPHALT BFP WATER ICV IRRIGATION CONTROL VALVE 26.6 VALVE MLP METAL LIGHT POLE EΒ ELECTRIC BOX 0.0 CORAL r. % **STEPS** SIR .8.0 WOOD FENCE 50.00 LOT 15, BLOCK 76 WATER VALVE

SKETCH OF SURVEY

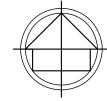

LAND DESCRIPTION:

THE EAST 50 FEET OF LOT 16, BLOCK 76, "OCEAN BEACH, FLA. ADDITION NO. 3", ACCORDING TO THE PLAT THEREOF, AS RECORDED IN PLAT BOOK 2, PAGE 81, OF THE PUBLIC RECORDS OF MIAMI/DADE COUNTY, FLORIDA.

NOTES:

- NOT VALID WITHOUT THE SIGNATURE AND THE ORIGINAL RAISED SEAL OF A FLORIDA LICENSED SURVEYOR AND MAPPER.
- LANDS SHOWN HEREON WERE NOT ABSTRACTED FOR RIGHTS-OF-WAY, EASEMENTS, OWNERSHIP, OR OTHER INSTRUMENTS OF RECORD.
- THIS SURVEY WAS DONE SOLELY FOR BOUNDARY PURPOSES AND DOES NOT DEPICT THE JURISDICTION OF ANY MUNICIPAL, STATE, FEDERAL OR OTHER ENTITIES.
- 4. THE LAND DESCRIPTION SHOWN HEREON WAS PROVIDED BY THE CLIENT.
- UNDERGROUND IMPROVEMENTS NOT SHOWN.
- ELEVATIONS SHOWN HEREON ARE BASED ON THE NATIONAL GEODETIC VERTICAL DATUM OF 1929 (NGVD29).
- 7. BENCHMARK DESCRIPTION: MIAMI/DADE COUNTY BENCHMARK # D-151. ELEVATION = 3.63' (NGVD29)

I HEREBY CERTIFY THAT THE "SKETCH OF SURVEY" OF THE HEREON DESCRIBED PROPERTY IS TRUE AND CORRECT TO THE BEST OF MY KNOWLEDGE AND BELIEF AS SURVEYED IN THE FIELD UNDER MY DIRECTION IN NOVEMBER, 2017. I FURTHER CERTIFY THAT THIS SURVEY MEETS THE STANDARD OF PRACTICE FOR SURVEYING IN THE STATE OF FLORIDA ACCORDING TO CHAPTER 5J-17 OF THE FLORIDA ADMINISTRATIVE CODE. PURSUANT TO SECTION 472.027, FLORIDA STATUTES. THERE ARE NO ABOVE GROUND ENCROACHMENTS OTHER THAN THOSE SHOWN HEREON, SUBJECT TO THE QUALIFICATIONS NOTED HEREON.

FOR THE FIRM, BY:

RICHARD E. COUSINS

PROFESSIONAL SURVEYOR AND MAPPER FLORIDA REGISTRATION NO. 4188

SURVEY DATE : 11/06/17

COUSINS SURVEYORS & ASSOCIATES, INC.

3921 SW 47th AVENUE, SUITE 1011 DAVIE, FLORIDA 33314 CERTIFICATE OF AUTHORIZATION: LB # 6448 PHONE (954)689-7766 FAX (954)689-7799 PROJECT NUMBER: 8504-17

CLIENT:

FABRIZIO SANTORO

REVISIONS	DATE	FB/PG	DWN	CKD
BOUNDARY & IMPROVEMENTS SURVEY	11/06/17	SKETCH	АМ	REC
REVISED BOUNDARY	11/18/17	SKETCH	REC	REC
ADDED TREES/ VEGETATION	01/11/18	SKETCH	JD	REC


FLOOD ZONE INFO	RMATION
COMMUNITY NUMBER	120651
PANEL NUMBER	0319 L
ZONE	AE
BASE FLOOD ELEVATION	l 8
EFFECTIVE DATE	09/11/09

PROPERTY ADDRESS : 828 4TH STREET

SCALE: 1"= 10'


SHEET 1 OF 1

1777							
ITEM#	Zoning Information						
1	Address:	828 4th Street					
		Miami Beach FL 33139					
2	Board and File numbers:	HPB17-0182					
3	Folio Number(s):	02-4203-009-5290	7 . D. L. L	DDCA			
4	Year Constructed:	1938	Zoning District:	RPS2			
5	Base Flood Elevation:	8 NGVD 6.525 NGVD	Grade Value in NGVD: Lot Area:	5.05			
6 7	Adjusted Grade (Flood + Grade/2): Lot Width:	50.00'		2,500 sf 50.00'			
8	Minimum Unit Size:	n/a	Lot Depth: Average unit size:	n/a			
9	Existing Use:	Single Family Residence	Proposed Use:	Single Family Residence			
9	Existing 030.	Single Fairing Residence	110p030d 030.	Sirigic Farminy Mediachice			
		<u>Maximum</u>	Existing	Proposed	<u>Deficiences</u>		
1.0	11.*.1.1.		-				
10 11	Height: Number of Stories:	40'-0" 4 stories	15'-7 1/2"	33'-5 1/2" 3 stories	n/a		
12	FAR	4 5101165	1 story	J Stories	n/a		
13	Gross Square footage:	3750 sf	1142 sf	3043 sf	n/a		
14	Square footsge by Use:	n/a	n/a	n/a	n/a		
15	Number of Residential Uses:	n/a	n/a	n/a	n/a		
16	Number of Units Hotel:	n/a	n/a	n/a	n/a		
17	Number of Seats:	n/a	n/a	n/a	n/a		
18	Occupancy Load:	n/a	n/a	n/a	n/a		
			·	·	·		
	<u>Setbacks</u>	Required	Existing	<u>Proposed</u>	<u>Deficiences</u>		
	Subterranean						
19	Front Setback:	n/a	n/a	n/a	n/a		
20	Side Setback:	n/a	n/a	n/a	n/a		
21	Side Setback:	n/a	n/a	n/a	n/a		
22	Side Setback facing street:	n/a	n/a	n/a	n/a		
23	Rear Setback:	n/a	n/a	n/a	n/a		
	At Grade Parking	,	,	,	,		
24	Front Setback:	n /a	n /a	n /a	n /a		
24 25	Side Setback:	n/a n/a	n/a n/a	n/a n/a	n/a n/a		
26	Side Setback:	n/a	n/a	n/a	n/a		
27	Side Setback facing street:	n/a	n/a	n/a	n/a		
28	Rear Setback:	n/a	n/a	n/a	n/a		
		,	, .	, 5	, -		
	Pedestal						
29	Front Setback:	5'-0"	2'-9 1/2"	15'-9 1/2"	n/a		
30	Side Setback:	5'-0"	18'-9"	5'-0"	n/a		
31	Side Setback:	n/a	n/a	n/a	n/a		
32	Side Setback facing street:	5'-0"	3'-0 1/2"	3'-0 1/2"	1'-11 1/2"		
33	Rear Setback:	5'-0"	5'-0"	5'-0"	n/a		
	Tower						
34	Front Setback:	n/a	n/a	n/a	n/a		
35	Side Setback:	n/a	n/a	n/a	n/a		
36	Side Setback:	n/a	n/a	n/a	n/a		
37	Side Setback facing street:	n/a	n/a	n/a	n/a		
38	Rear Setback:	n/a	n/a	n/a	n/a		
	<u>Parking</u>						
7.0	-						
39	Parking District	Restricted	٥	4	/		
40	Total # of parking spaces	0	0	. / .	n/a		
41	Total # of parking spaces	n/a	n/a	n/a	n/a		
42	per use	n /a	n /a	n /a	n /a		
42	Total # of parking spaces per level	n/a	n/a	n/a	n/a		
43	Parking space dimension	8.5' X 18'	n/a	8.5' X 18'	n/a		
44	Parking space config.	90d	n/a	90d	n/a		
45	ADA spaces	n/a	n/a	n/a	n/a		
46	Tandem spaces	n/a	n/a	n/a	n/a		
47	Drive aislle width	n/a	n/a	n/a	n/a		
48	Valet drop off/ pick up	n/a	n/a	n/a	n/a		
49	Loading Zones	n/a	n/a	n/a	n/a		
50	Racks	90d	n/a	90d	n/a		
	Pootauranto Cafoo Paro	Loungoo Nightoluho					
	<u>Restaurants, Cafes, Bars</u>				,		
51	Type of Use	n/a	n/a	n/a	n/a		
52	Number of seats outside	n/a	n/a	n/a	n/a		
53	Number of seats inside	n/a	n/a	n/a	n/a		
54 55	Total number of seats outside	n/a	n/a	n/a	n/a		
55 56	Total Occupant content	n/a	n/a	n/a	n/a		
56 57	Total Occupant content Occupant content per venue	n/a	n/a	n/a	n/a		
37	occupant content per venue	n/a	n/a	n/a	n/a		
58	Proposed hours of operation		n/a				
59	Is this an NIE?		no				
60	Is Entertainment proposed?		no				
61	Is the building contributing?		yes				
62	Located in a Historic Distric?		yes				
		Required	Existing	<u>Proposed</u>	<u>Deficiences</u>		
63	<u>FAR</u>	3,750 sf (1.50)	1,142 sf (0.46)	3,043 sf (1.22)	n/a		
64	<u>Open Space</u>	1,625 sf (0.65)	1,358 sf (0.54)	929 sf (0.57)	696 sf (0.43)		
<u> </u>	, 	, (3.33)	.,	(3.3.)	100 0. (0.10)		

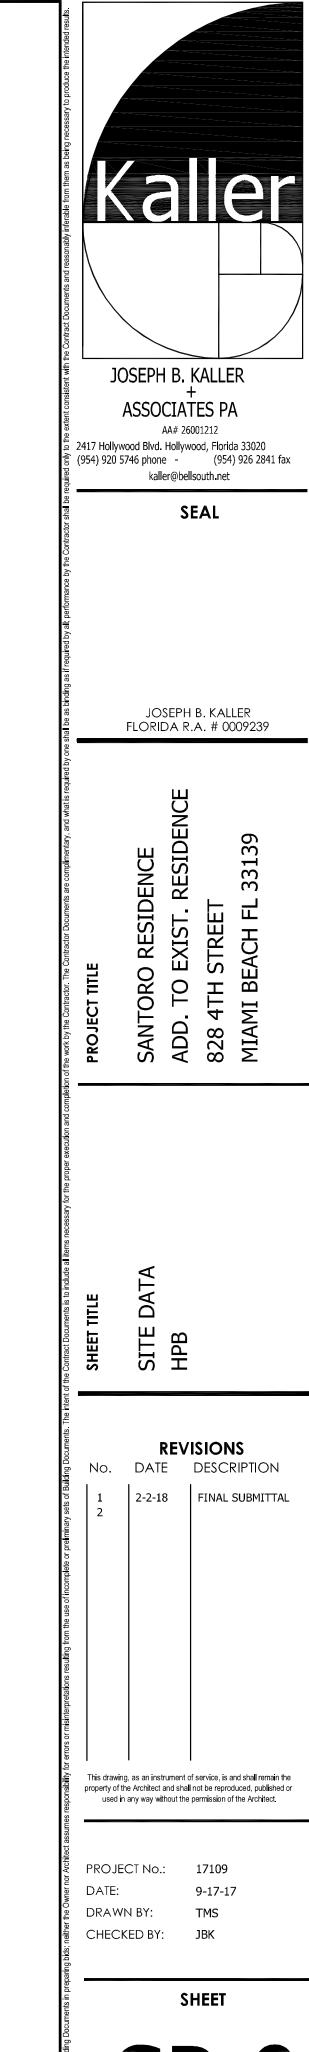


1 SITE DATA


SP-0

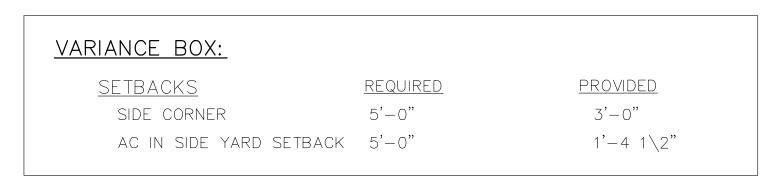

SOUTH POINTE TREESCAPE FUND:

929 (0.57) OPEN SPACE 1625 (0.65) NOTE: FEE TO BE PAID IN FULL AT APPLICATION FOR BUILDING PERMIT.

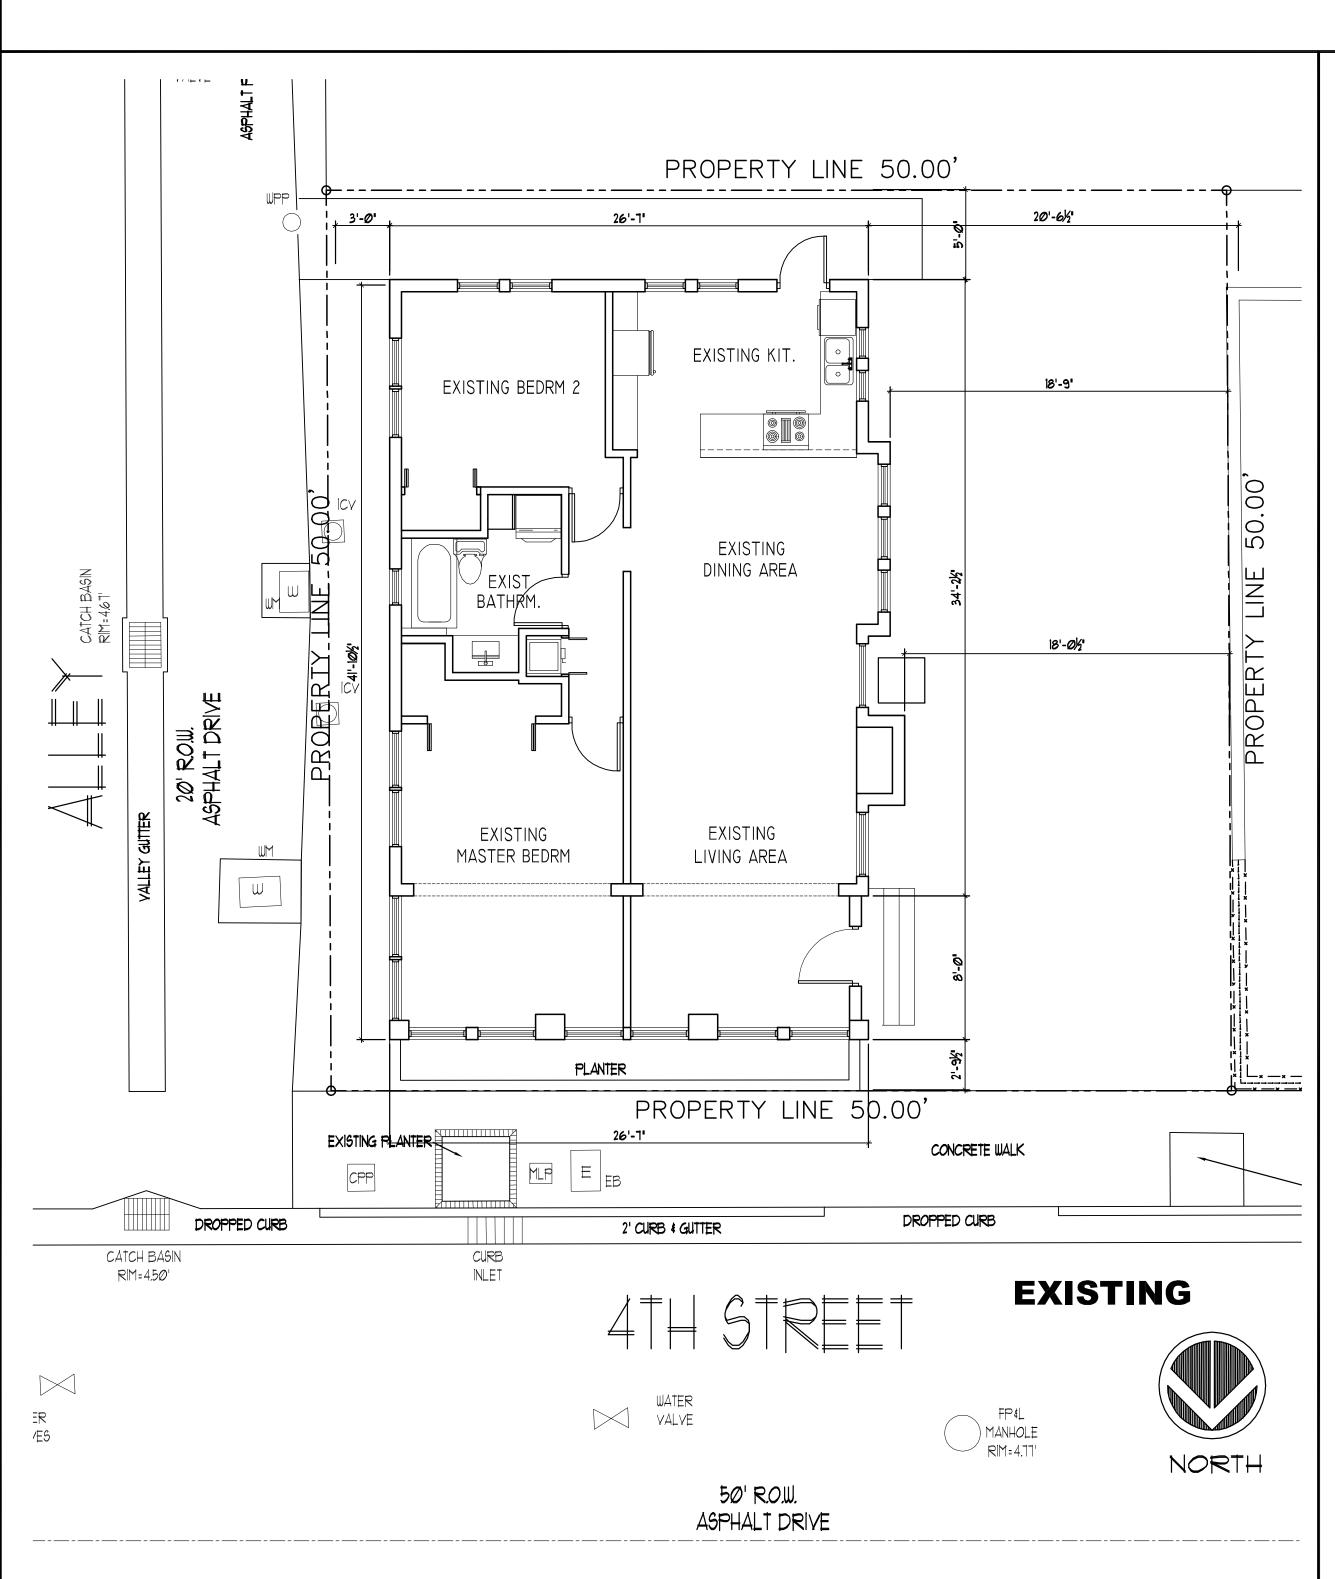

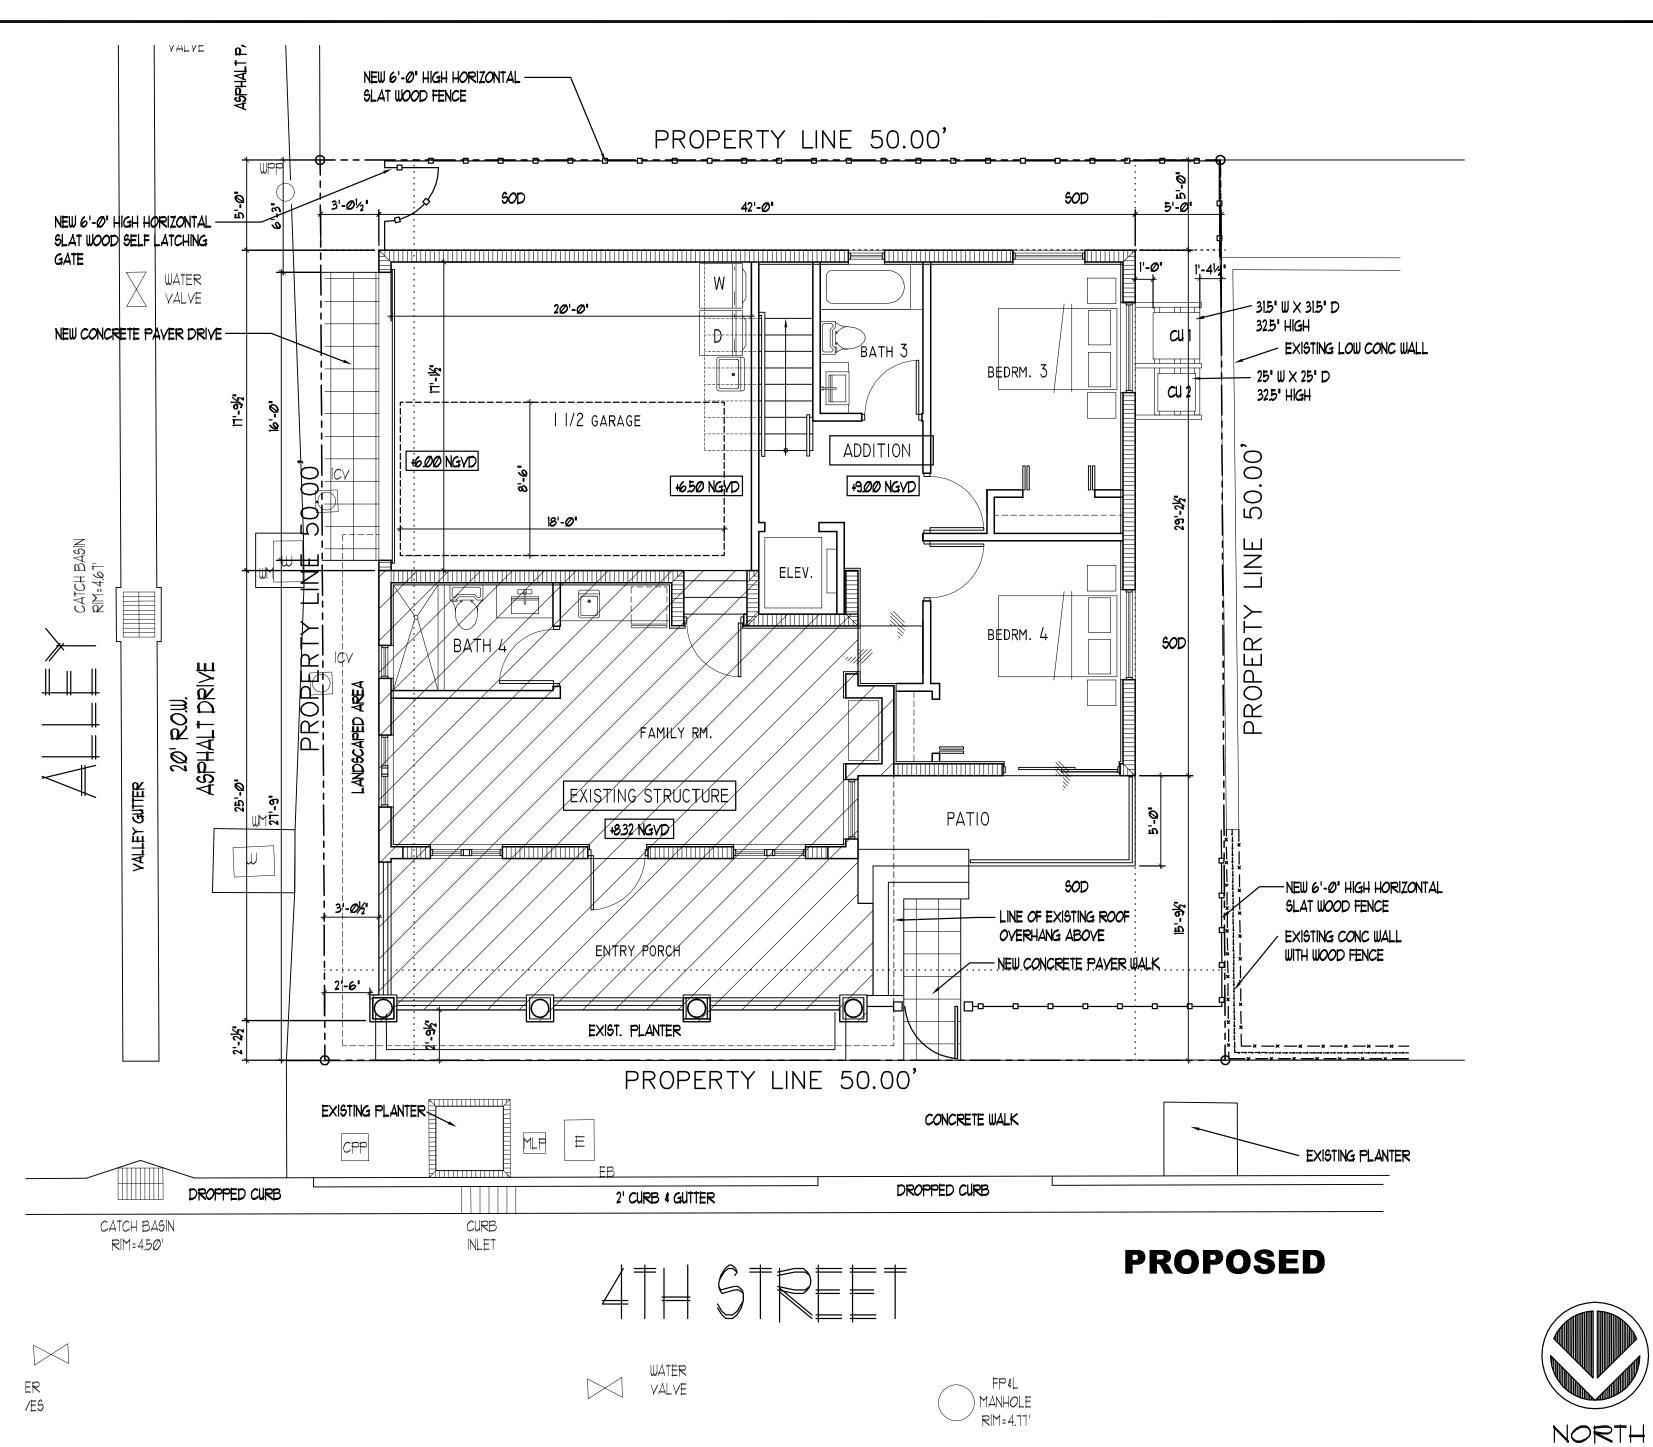

50' R.O.W.

ASPHALT DRIVE

Kaller JOSEPH B. KALLER ASSOCIATES PA

2417 Hollywood Blvd. Hollywood, Florida 33020 (954) 920 5746 phone - (954) 926 2841 fax kaller@bellsouth.net

SEAL

JOSEPH B. KALLER FLORIDA R.A. # 0009239

SANTORO RESIDENCE

SITE PL HPB

REVISIONS No. DATE DESCRIPTION FINAL SUBMITTAL 2-2-18


This drawing, as an instrument of service, is and shall remain the property of the Architect and shall not be reproduced, published or used in any way without the permission of the Architect.

PROJECT No.: 17109 DATE: DRAWN BY: CHECKED BY:

SHEET

1 OF 2

SITE PLAN
SCALE: 3/16"= 1'-0"

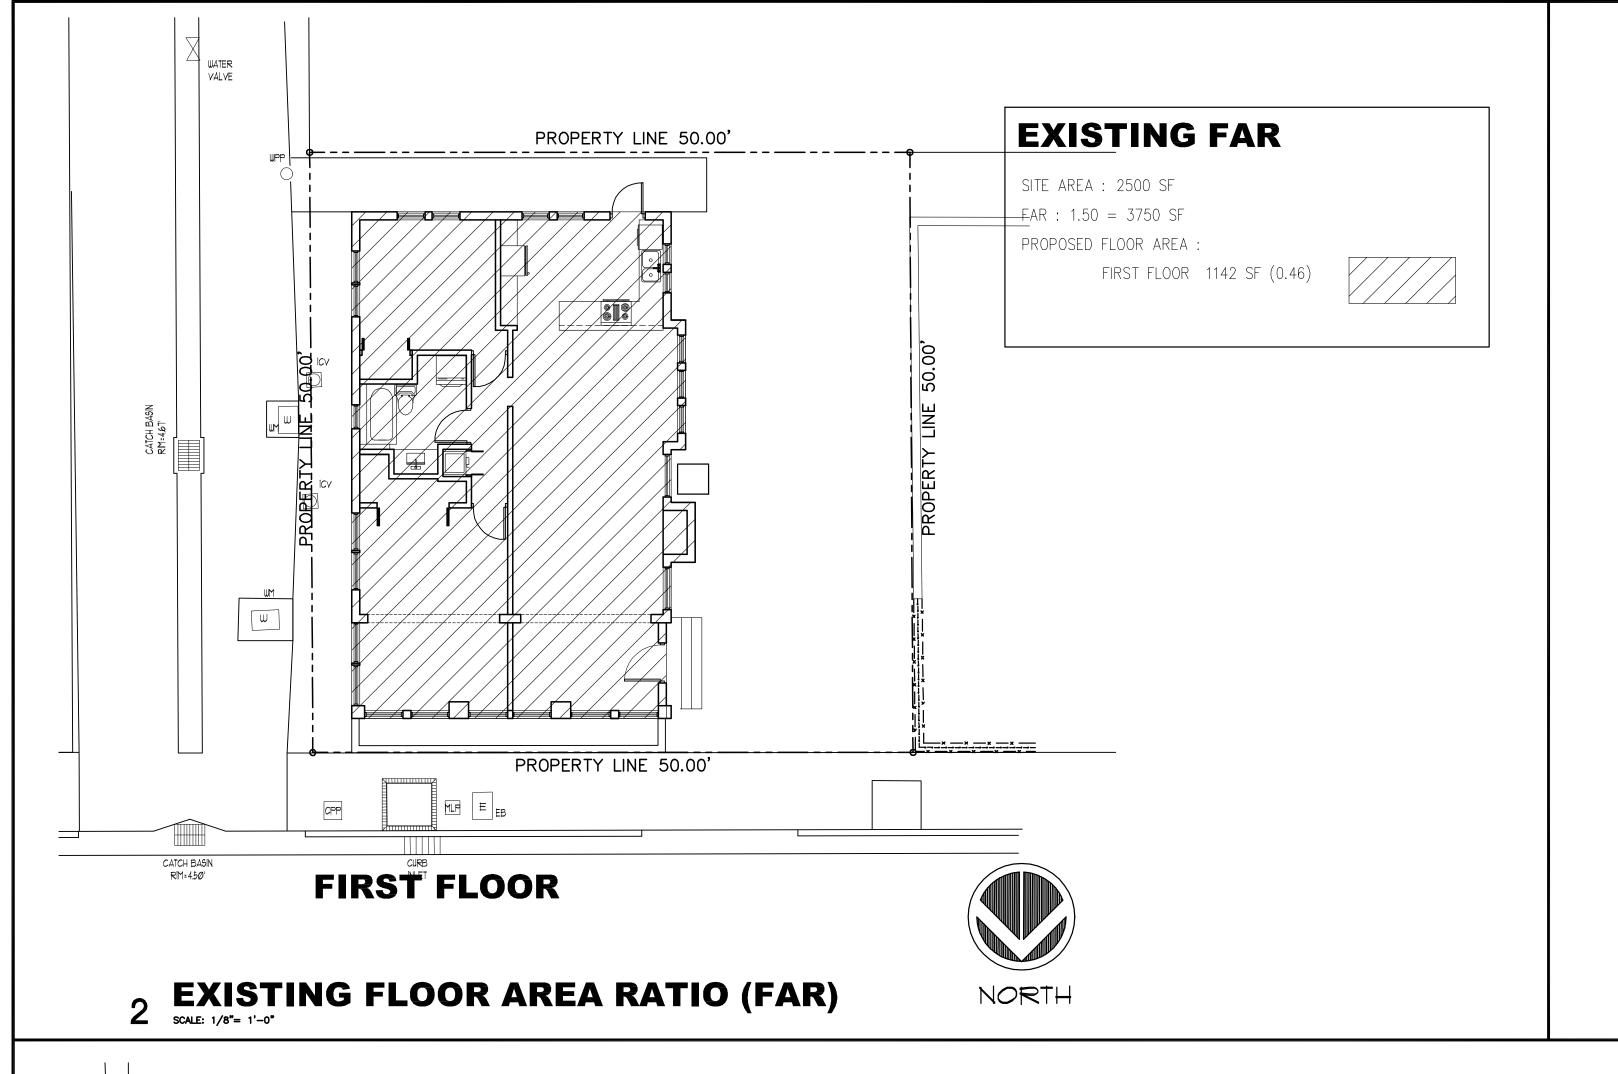

LIVING LANDSC. MATERIAL

ROOF DECK 845.5 SF

REQUIRED PLANTING: 211 sf (25%) PROVIDED PLANTING: 216 sf (25.5%) PROPOSED OPEN SPACE : 216 sf

JOSEPH B. KALLER ASSOCIATES PA

2417 Hollywood Blvd. Hollywood, Florida 33020

SEAL

JOSEPH B. KALLER FLORIDA R.A. # 0009239


REVISIONS No. DATE DESCRIPTION

This drawing, as an instrument of service, is and shall remain the property of the Architect and shall not be reproduced, published or used in any way without the permission of the Architect.

CHECKED BY:

ROOF DECK


PROPOSED LIVE PLANTING AREA ROOF DECK SCALE: 1/8"= 1'-0"

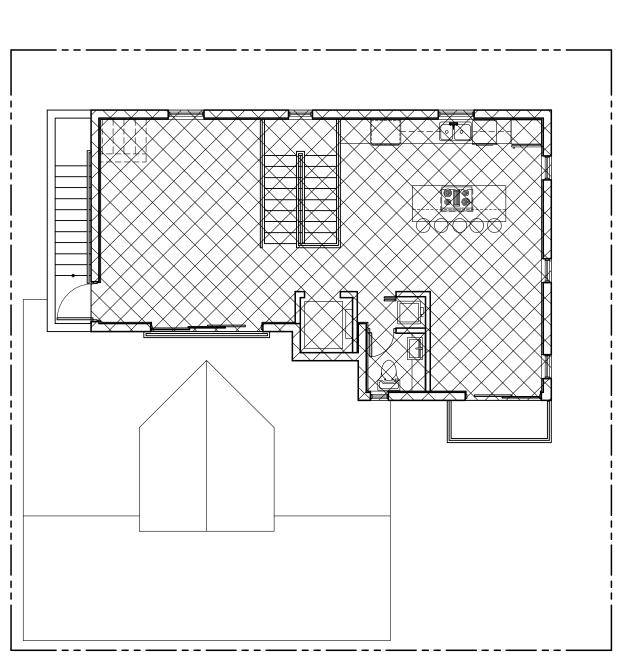

THIRD FLOOR

FAR SITE AREA: 2500 SF FAR: 3750 SF (1.50) PROPOSED FLOOR AREA FIRST FLOOR 1349 SF SEOND FLOOR 881 SF

SECOND FLOOR

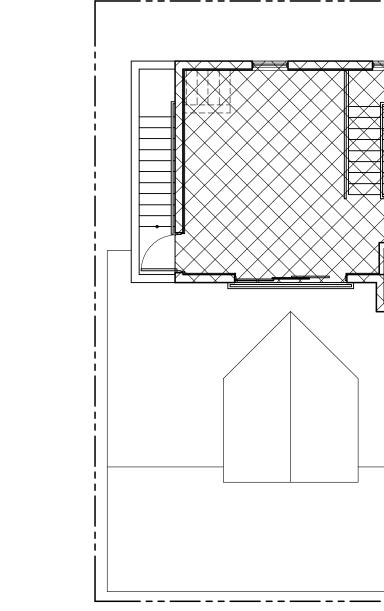

PROPSED FLOOR AREA RATIO (FAR) AND OPEN SPACE SCALE: 1/8"- 1"-0"

FIRST FLOOR

PROPERTY LINE 50.00'

PROPERTY LINE 50.00'


PROPOSED OPEN SPACE : FIRST FLOOR 713 SF

OPEN SPACE

OPEN SPACE REQUIRED: 1625 SF (0.65)

SITE AREA: 2500 SF

ROOF DECK

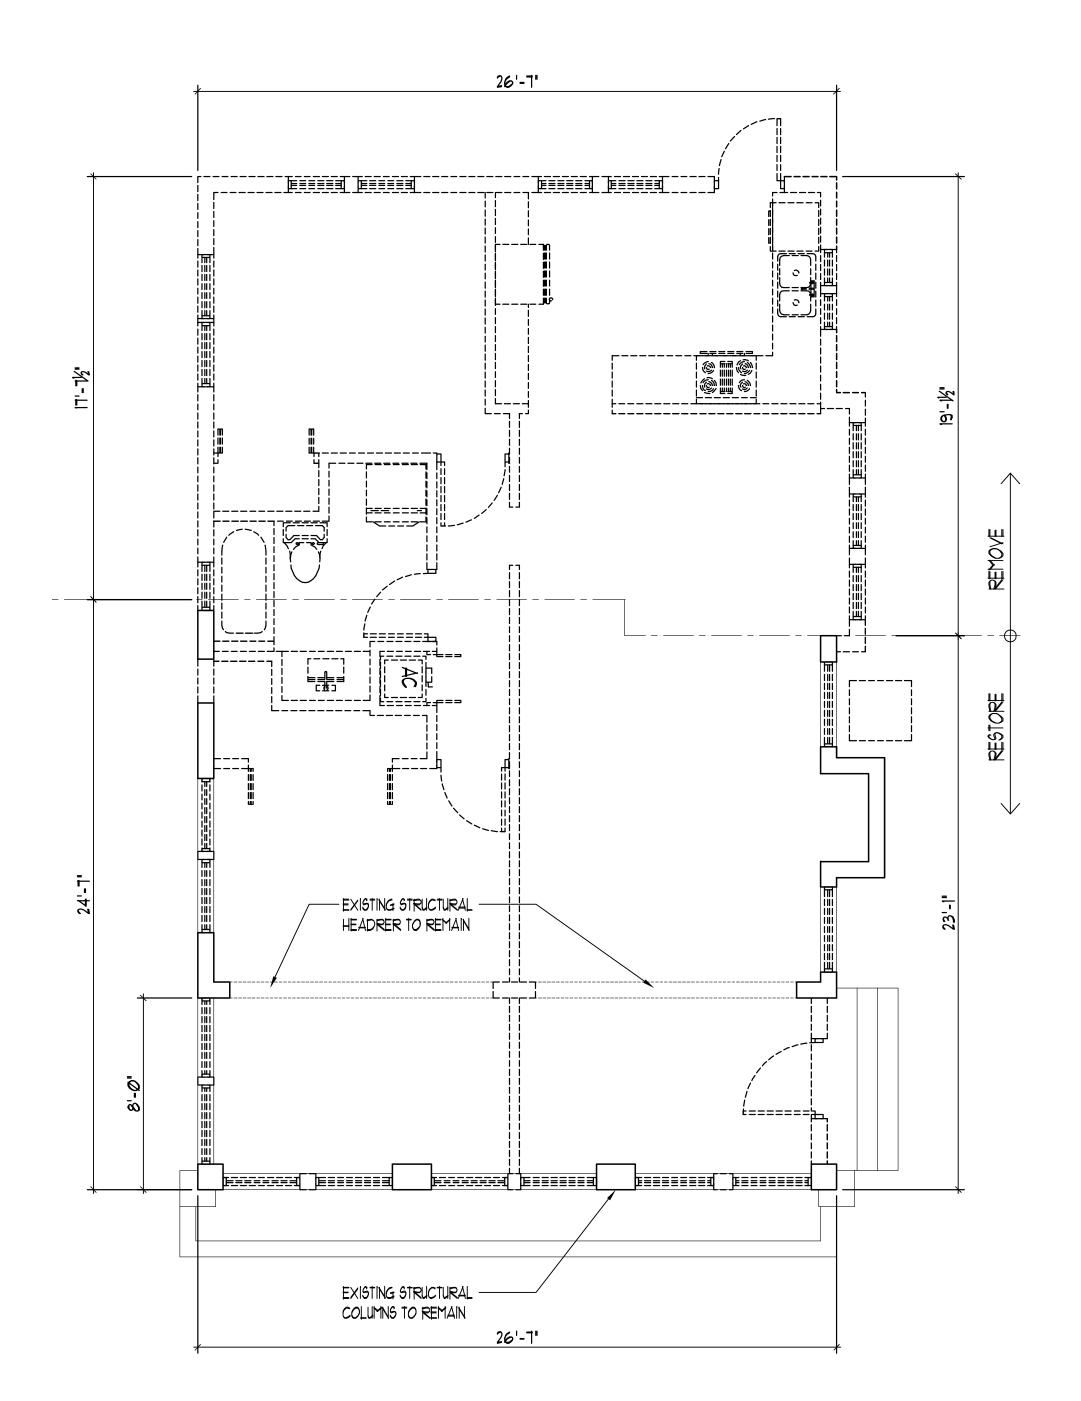

DEMOLITION PLAN SCALE: 1/4"= 1'-0"

DEMOLITION NOTES:

- CONDITIONS & REQUIREMENTS: THE DEMOLITION CONTRACTOR SHALL OBTAIN ALL PERMITS REQUIRED FOR HAULING & LEGALLY DISPOSING OF MATERIALS REMOVED IN DEMOLITION WORK.
- 2. PROCEDURES: THE PROCEDURES PROPOSED FOR THE ACCOMPLISHMENT OF SALVAGE & DEMO WORK SHALL PROVIDE FOR SAFE CONDUCT OF THE WORK, CAREFUL REMOVAL & DISPOSING OF MATERIALS, PROTECTION OF PROPERTY, COORDINATING WORK OF OTHERS IN PROGRESS, & TIMELY DISCONNECTION OF UTILITY SERVICES. THE PROCEDURES SHALL INCLUDE A DETAILD DESCRIPTION OF METHODS & REQUIREMENTS TO BE USED FOR EACH OPERATION.
- 3. PARTITION: REMOVE ALL EXISTING INTERIOR PARTITIONS & RELATED UTILITIES AS INDICATED IN THE DEMOLITION PLAN.
- 4. DUST CONTROL: THE AMOUNT OF DUST RESULTING FROM DEMO SHALL BE CONTROLLED TO PREVENT THE SPREAD OF DUST TO AVOID CREATION OF A NUISANCE IN THE SURROUNDING AREA. USE OF WATER WILL NOT BE PERMITTED WHEN IT WILL RESULT IN, OR CREATE HAZARDOUS OR OBJECTIONABLE CONDITIONS SUCH AS FLOODING.
- 5. PROTECTION OF EXISTING BUILDING:
- A. EXISTING BUILDING SHALL BE PROTECTED FROM DAMAGE, ANY PART DAMAGE BY THE CONTRACTOR SHALL BE REPAIRED TO MATCH EXISTING CONDITIONS AT CONTRACTOR'S EXPENSE
- B. COVER ITEMS AS NECESSARY TO PROTECT FROM DUST.
 C. AT END OF EACH WORK DAY, CLOSE OFF AREAS FROM PUBLIC
 D. DEMO CONTRACTOR SHALL PROVIDE & MAINTAIN NECESSARY
 BARRICADES TO PREVENT ENTRY OF ANY UNAUTHORIZED
 PERSONS FROM ACCIDENTALLY OR INTENTIONALLY ENTERING THE
- 6. ENVIRONMENTAL PROTECTION: ALL WORK & CONTRACT OPERATIONS SHALL COMPLY W ALL REQUIREMENTS OF STATE & COUNTY ENVIRONMENTAL PROTECTION REGULATIONS.
- 7. BURNING:

WORK AREA

- A. USE OF FIRE FOR DEMO OR DISPOSAL OF MATERIAL OR ANY OTHER SITUATION INTENTIONAL OR ACCIDENTAL WILL NO BE PERMITTED
- 8. EXISTING UTILITIES:
- A. CONTACT ALL UTILITIES INCLUDING ELECTRIC, WATER, GAS & TELEPHONE, PRIOR TO BEGINNING WORK & REQUEST THAT ALL SERVICES BE SHUT OFF & CAPPED @ AREAS WHERE DEMOLITION WORK IS TO BE EXECUTED.
- B. REMOVE ALL EXISTING UTILITIES ACCORDING TO SEQUENCE OF OPERATIONS APPROVED AT START OF PROJECT
- C. REMOVE ALL EXIST UTILITIES UNCOVERED BY DEMO & TERMINATE IN A MANNER & AT A TIME SATISFACTORY TO UTILITY COMPANIES INVOLVED. WHERE UTILITY COMPANY DESIRE TO EFFECT THE REMOVAL OF THEIR MATERIALS THEY SHALL BE PERMITTED TO DO SO.
- WHEN UTILITY LINES ARE ENCOUNTERED THAT ARE
 NOT ON THE DWGS OR VISIBLE THEY SHALL BE DISPOSED OF IN
 ACCORDANCE W INSTRUCTIONS OF THE ARCHITECT/ENGINEER.
- D. INSTALL & LEAVE A WELL MARKED STAKE @ CAPPED END OF EVERY UTILITY CAPPED ON SITE.
- 9. DISPOSING OF MATERIAL
- A. TITLE TO MATERIALS: TITLE TO ALL MATERIAL & EQUIPMENT TO BE DEMO & REMOVED EXCEPT ITEMS INDICATED TO BE TURNED OVER TO THE OWNER IS VESTED IN THE CONTRACTOR AT START OF PROJECT. THE OWNER WILL NOT BE RESPONSIBLE FOR THE CONDITIONS, LOSS OR DAMAGE TO SUCH PROPERTY AFTER NOTICE TO PROCEED.
- B. DEBRIS CONTROL: REMOVE & TRANSPORT DEBRIS IN LEAK-FREE CONTAINERS IN A MANNER TO PREVENT SPILLAGE ON ANY PART OF EXISTING BUILDING, PARKING LOT AREAS, OR CITY STREETS C. REGULATIONS: COMPLY W COUNTY, MUNICIPALITY & CITY REGULATIONS REGARDING HAULING & DISPOSAL OF DEBRIS. ALL SUCH MATERIAL SHALL BE DISPOSED OF OFF SITE IN A LEGAL
- 10. PREPARATION:

DISPOSAL AREA.

- A. PROVIDE ADEQUATE TEMPORARY SUPPORT AS NECESSARY TO ASSURE STRUCTURAL VALUE OR INTEGRITY OF AFFECTED PORTION OF PROJECT FROM DAMAGE
- B. PROVIDE DEVICES & METHODS TO PROTECT OTHER PORTIONS OF
- THE PROJECT FROM DAMAGE

 C. PROVIDE PROTECTION FROM ELEMENTS FOR THAT PORTION OF
 THE PROJECT WHICH MAY BE EXPOSED BY CUTTING PATCHING
- II. PERFORMANCE:
- A. EXECUTE CUTTING & DEMO METHODS WHICH WILL PREVENT DAMAGE TO OTHER WORK & WHICH WILL PROVIDE PROPER
- SURFACES TO RECEIVE INSTALLATION OF REPAIRS

 B. EXECUTE FITTING & ADJUSTMENT OF PRODUCTS TO PROVIDE A FINISH INSTALLATION TO COMPLY W SPECIFIED PRODUCT,
- FUNCTION, TOLERANCE & FINISHES

 C. RESTORE WORK WHICH HAS BEEN CUT OR REMOVED. INSTALL NEW PRODUCTS TO PROVIDE COMPLETE WORK IN ACCORD W
- REQUIREMENTS THROUGH SURFACES

 D. FIT WORK AIR-TIGHT TO PIPES, SLEEVES, DUCTS, CONDUIT \$
- OTHER PENETRATIONS THROUGH SURFACES

 E. REFINISH ENTIRE SURFACES AS NECESSARY TO PROVIDE AN EVEN FINISH TO MATCH ADJACENT FINISH.

 a. FOR CONTINUOUS SURFACES, REFINISH TO NEAREST
- INTERSECTION

 b. FOR AN ASSEMBLY, REFINISH ENTIRE UNIT

ALTERATION PROJECT PROCEDURES:

- A. REQUIREMENTS INCLUDED:
- I. COORDINATE WORK OF TRADES & SCHEDULE ELEMENTS OF ALTERATIONS & RENOVATION WORK BY PROCEDURES &
- METHODS TO EXPEDITE COMPLETION OF WORK

 2. CUT, MOVE, OR REMOVE ITEMS AS NECESSARY TO PROVIDE
 ACCESS OR TO ALLOW ALTERATIONS & NEW WORK TO PROCEED.
- INCLUDE SUCH ITEMS AS:

 a. REPAIR OR REMOVAL OF HAZARDOUS OR UNSANITARY

 CONDITIONS
- b. REMOVAL OF ABANDONED ITEMS & ITEMS SERVING NO USEFUL PURPOSE, SUCH AS ABANDONED PIPING, CONDUIT & WIRING
 c. REMOVAL OF UNSUITABLE OR EXTRANEOUS MATERIALS NOT MARKED FOR SALVAGE, SUCH AS ABANDONED EQUIPMENT & DEBRIS INCLUDING ROTTED WOOD, RUSTED MTL &
- DETERIORATED CONC.

 3. ALTERATIONS & CONNECTIONS OF NEW CONSTRUCTION TO EXIST CONSTRUCTION OCCURS AT DUST SENSITIVE AREAS. EXECUTE ALL MEASURES TO COMPLETELY CONTROL & SEPARATE DUST FROM EXIST AREA & EQUIP

DEMOLITION LEGEND

EXISTING CONC BLOCK WALL TO REMAIN AS IS.

GC TO FIELD VERIFY

EXISTING CONC BLOCK WALL TO BE DEMOLISHED.

GC TO FIELD VERIFY EXACT LOCATIONS & MATCH
W PERMIT DRAWINGS.

EXISTING INTERIOR PARTITION TO REMAIN AS IS.
GC TO FIELD VERIFY

EXISTING INTERIOR WALL/PARTITION TO BE
DEMOLISHED. GC TO FIELD VERIFY EXACT
LOCATIONS & MATCH W PERMIT DRAWINGS.

FIELD VERIFY EXACT LOCATIONS & MATCH W
PERMIT DRAWINGS.

EXISTING DOOR TO BE DEMOLISHED. GC TO
FIELD VERIFY EXACT LOCATIONS & MATCH W

PERMIT DRAWINGS.

EXISTING WINDOW TO BE DEMOLISHED. GC TO

₂ DEMOLITION NOTES AND LEGEND

SEAL STORING & MATCH W

JOSEPH B. KALLER FLORIDA R.A. # 0009239

JOSEPH B. KALLER

ASSOCIATES PA

(954) 920 5746 phone - (954) 926 2841 fax kaller@bellsouth.net

2417 Hollywood Blvd. Hollywood, Florida 33020

AA# 26001212

NTORO RESIDENCE
D. TO EXIST. RESIDENCE
8 4TH STREET
AMI BEACH FL 33139

DEMOLITION PLAN, NOTE

REVISIONS

No. DATE DESCRIPTION

1 |

or misinterpretations resulting from the use of incomplete or pref

This drawing, as an instrument of service, is and shall remain the property of the Architect and shall not be reproduced, published or used in any way without the permission of the Architect.

PROJECT No.: 17109


DATE: 9-17-17


DRAWN BY: TMS

CHECKED BY: JBK

SHEET

D-1

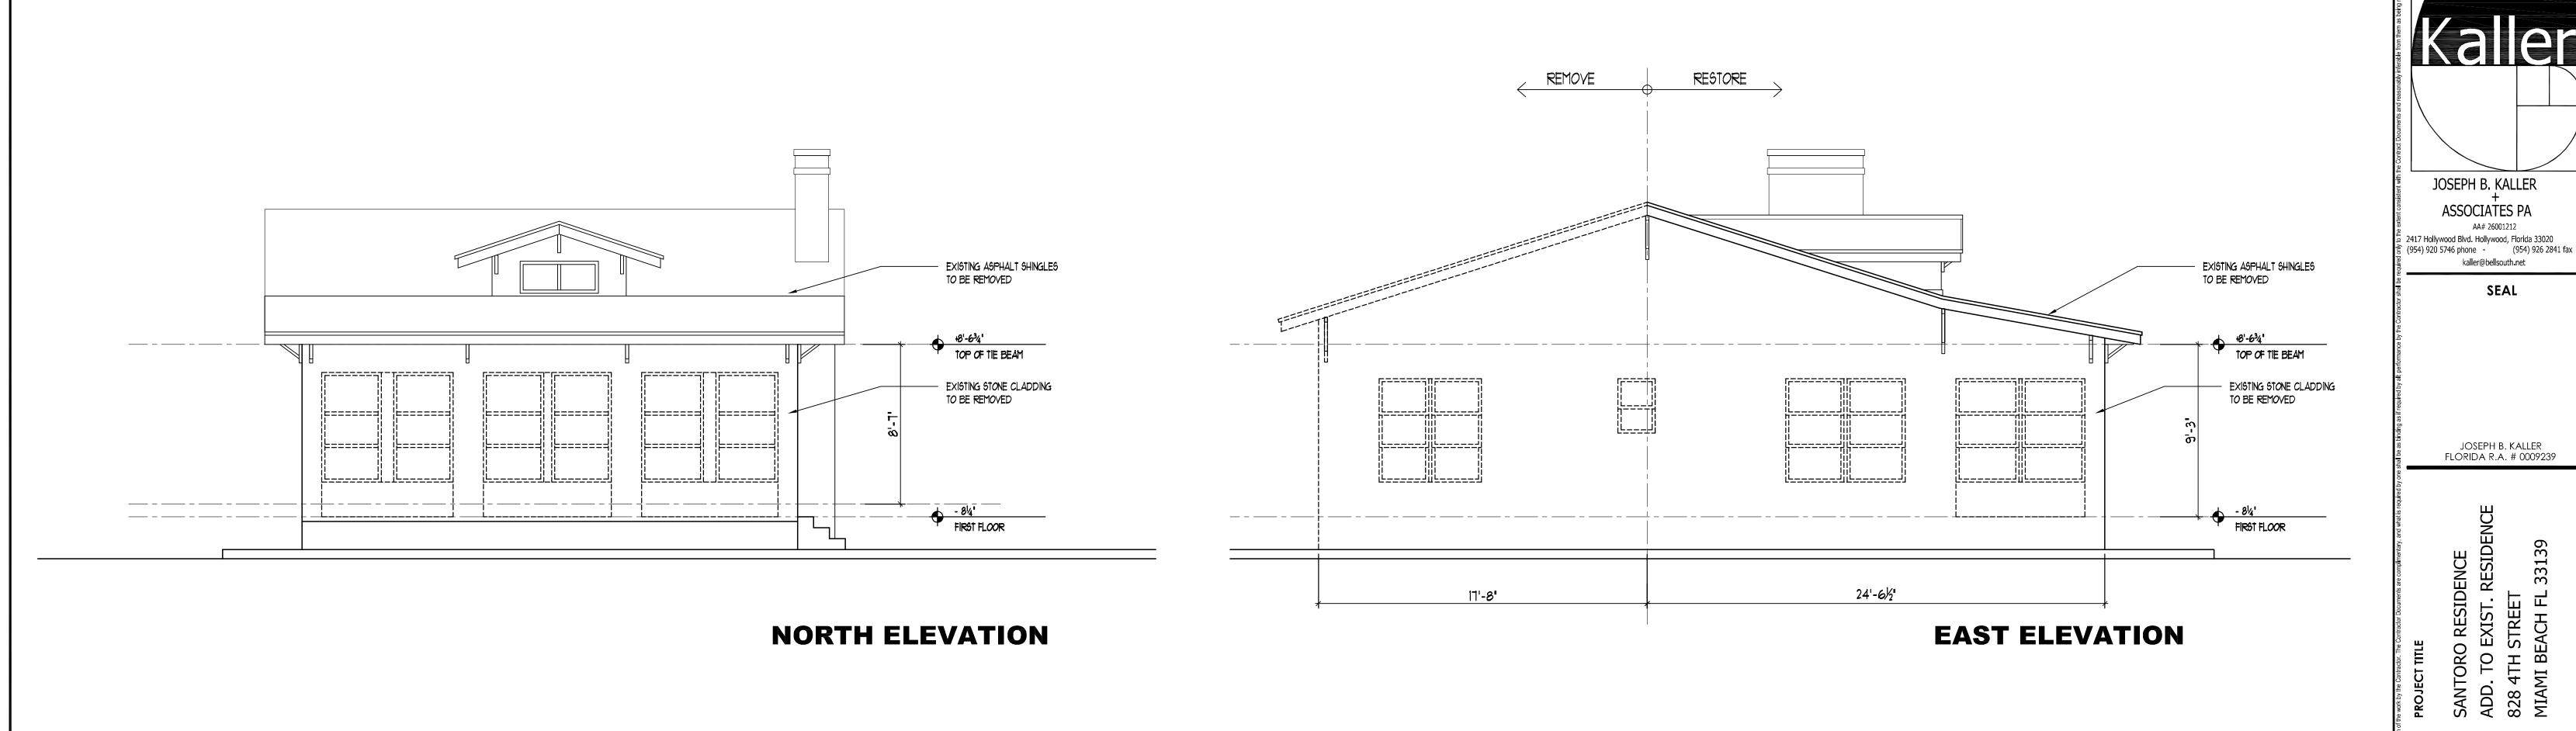


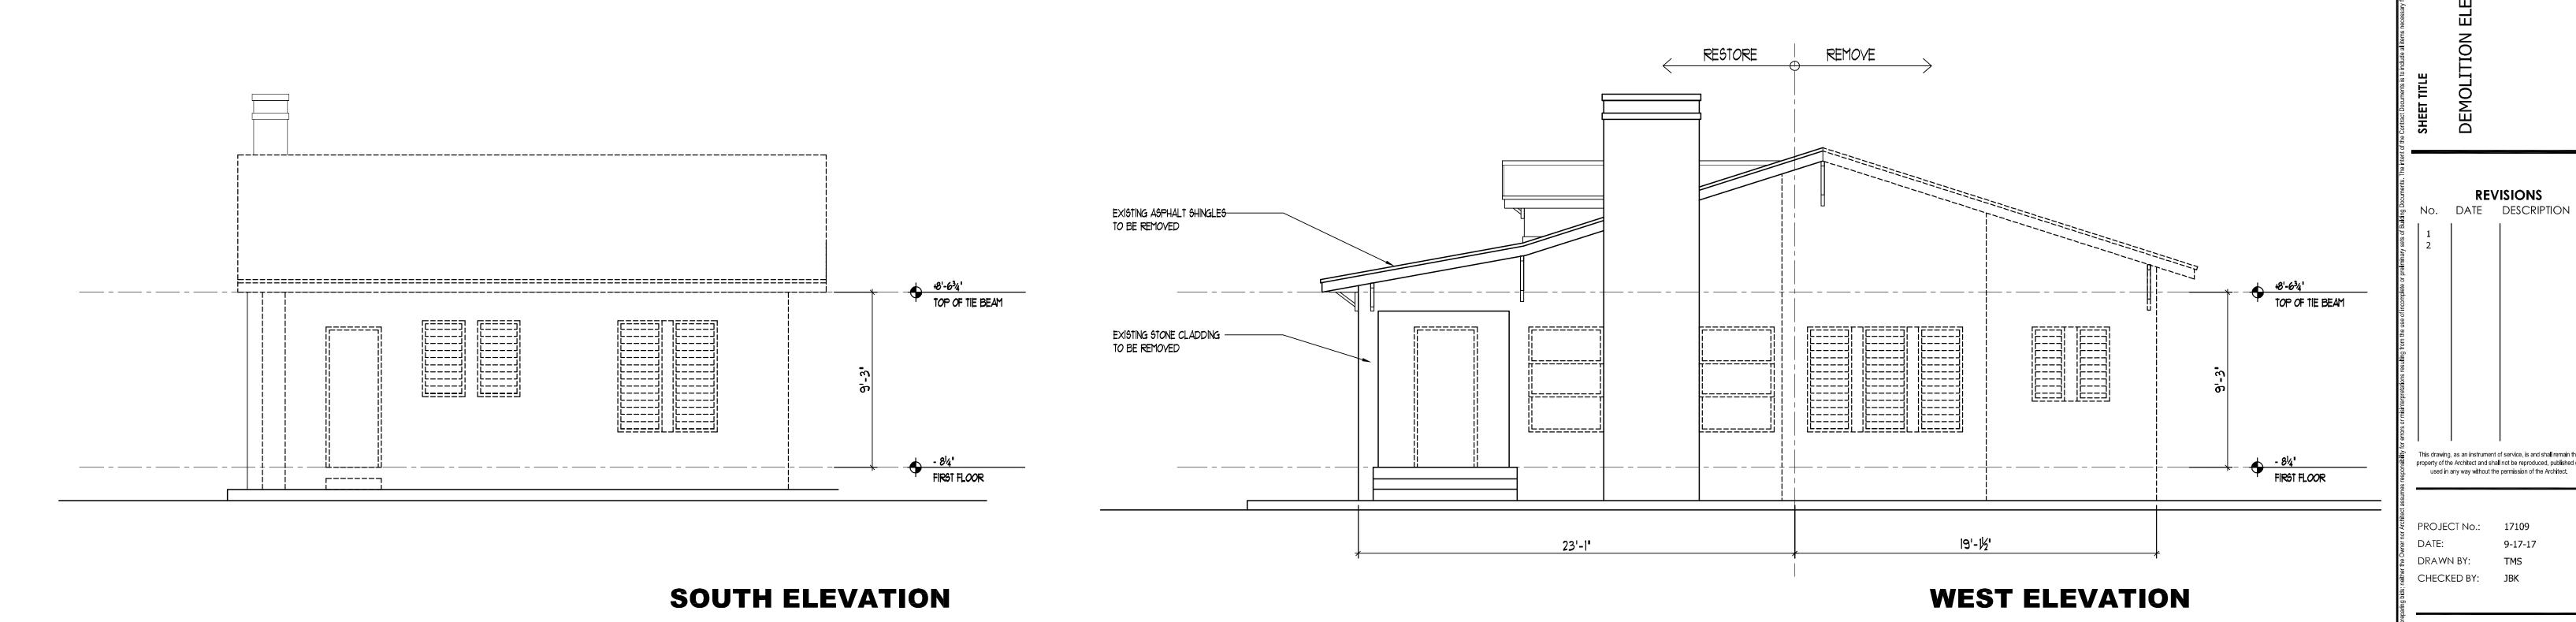


This drawing, as an instrument of service, is and shall remain the property of the Architect and shall not be reproduced, published or used in any way without the permission of the Architect. PROJECT No.: 17109 CHECKED BY: JBK SHEET

2 OF 2

DEMOLITION ELEVATIONS
SCALE: 1/4"= 1'-0"

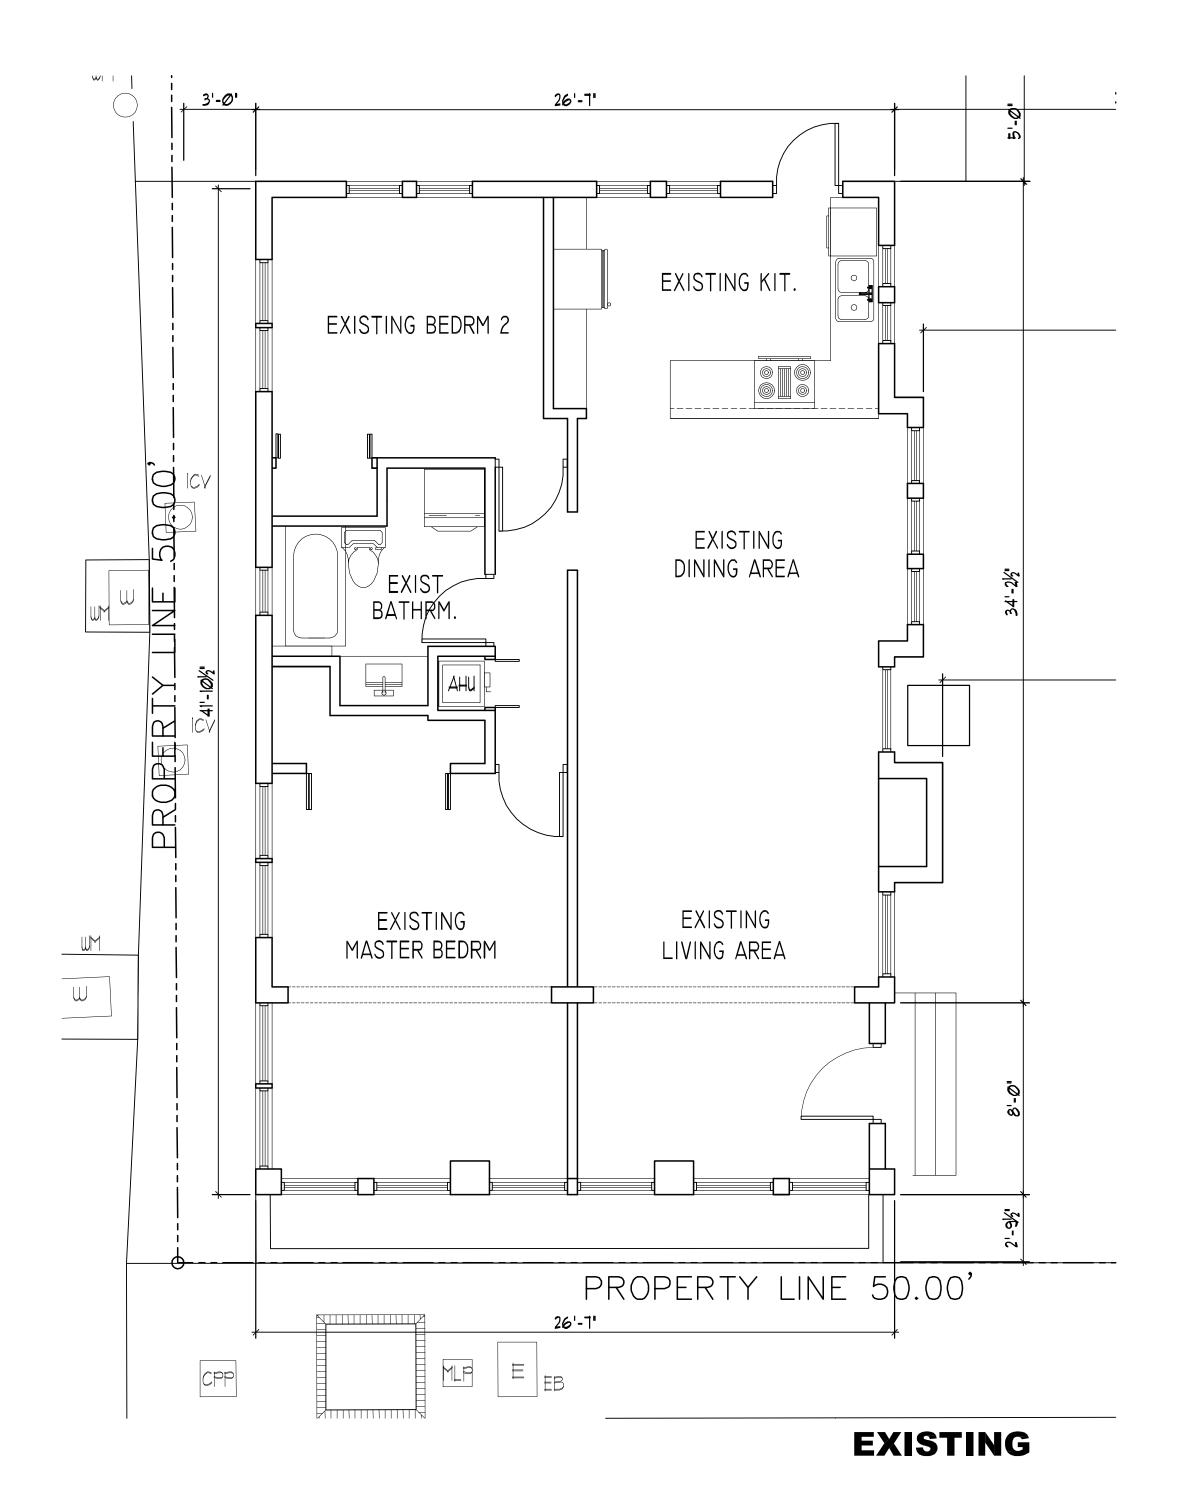

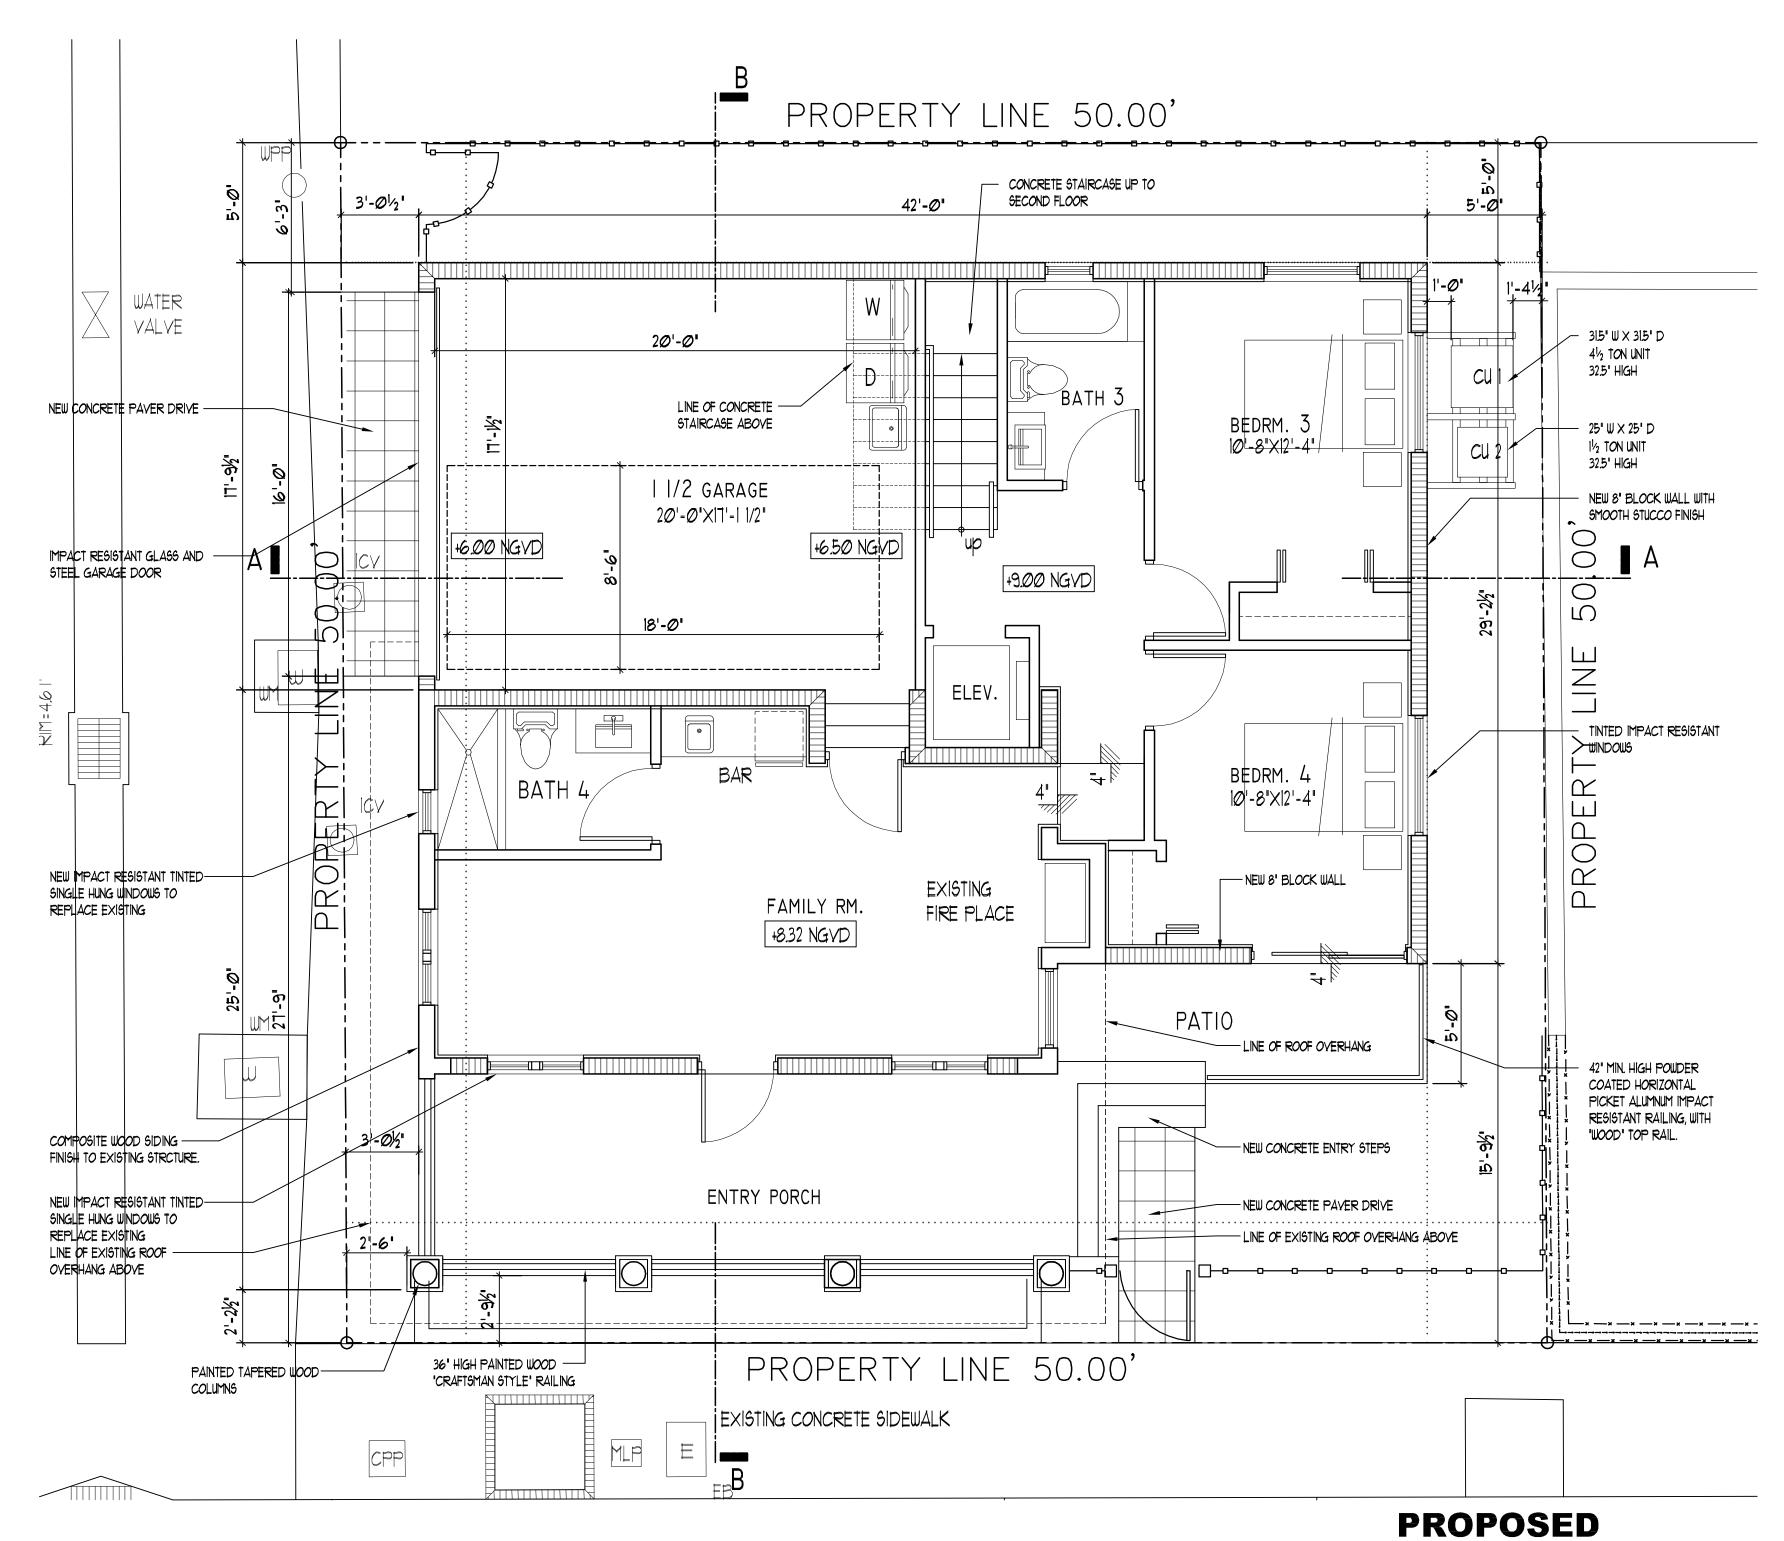



1 FIRST FLOOR PLAN
SCALE: 1/4"= 1'-0"

JOSEPH B. KALLER

+ ACCOCHATES DA

ASSOCIATES PA

AA# 26001212

Hollywood Blvd, Hollywood, Florida 330

2417 Hollywood Blvd. Hollywood, Florida 33020 (954) 920 5746 phone - (954) 926 2841 fax kaller@bellsouth.net

SEAL

JOSEPH B. KALLER

JOSEPH B. KALLER FLORIDA R.A. # 0009239

SANTORO RESIDENCE ADD. TO EXIST. RESIDENCE 828 4TH STREET MIAMI BEACH FL 33139

LOOR PLAN PB

REVISIONS

No. DATE DESCRIPTION

1 2-2-18 FINAL SUBMITTAL

This drawing, as an instrument of service, is and shall remain the property of the Architect and shall not be reproduced, published or used in any way without the permission of the Architect.

PROJECT No.: 17109


DATE: 9-17-17


DRAWN BY: TMS

CHECKED BY:

SHEET

A-1

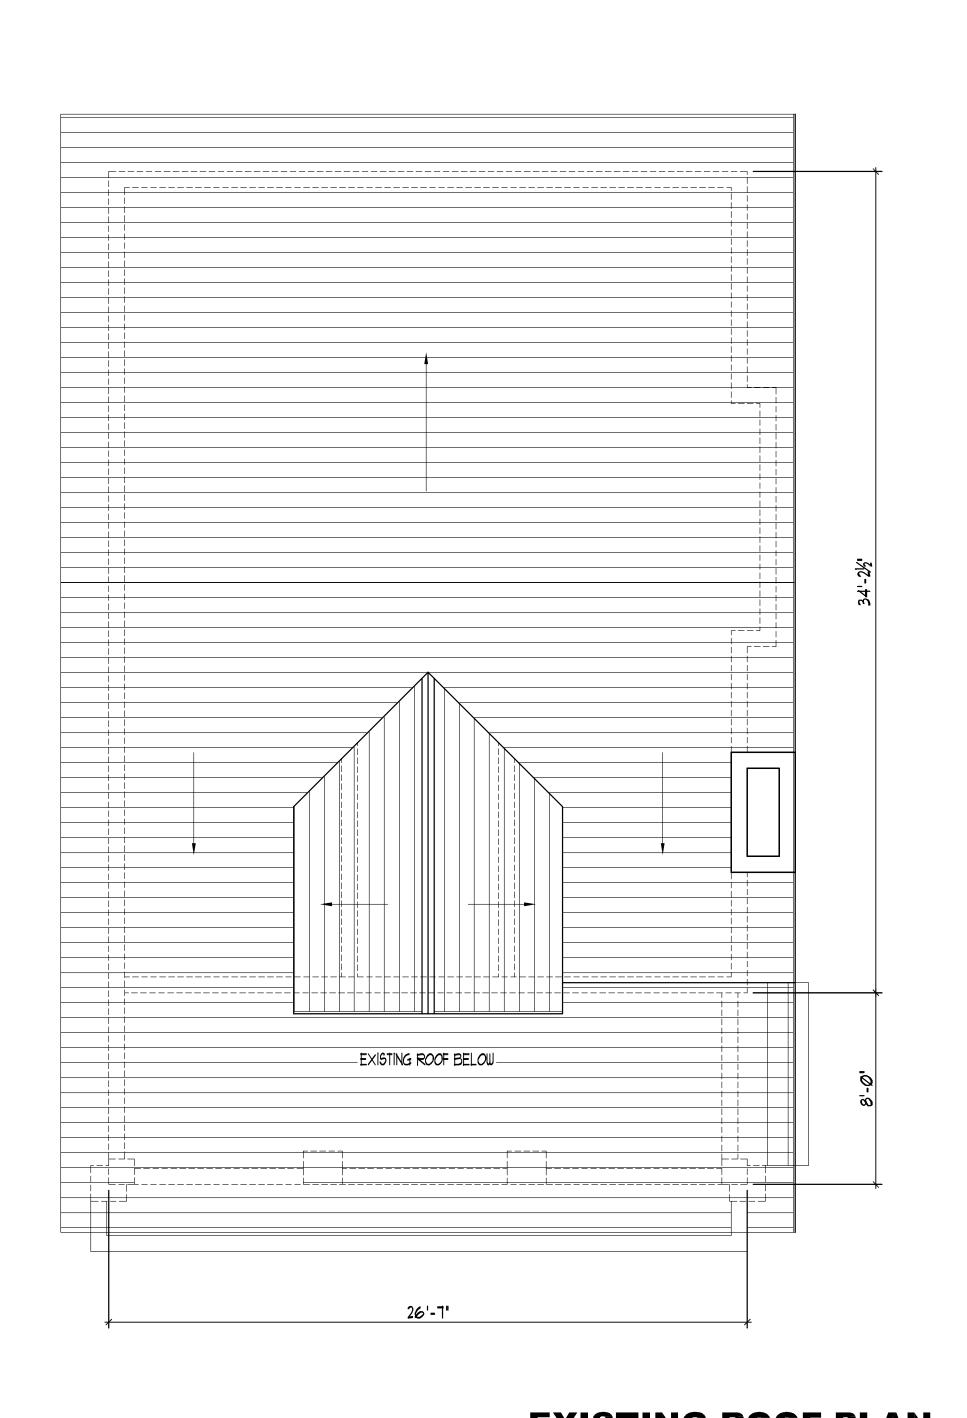

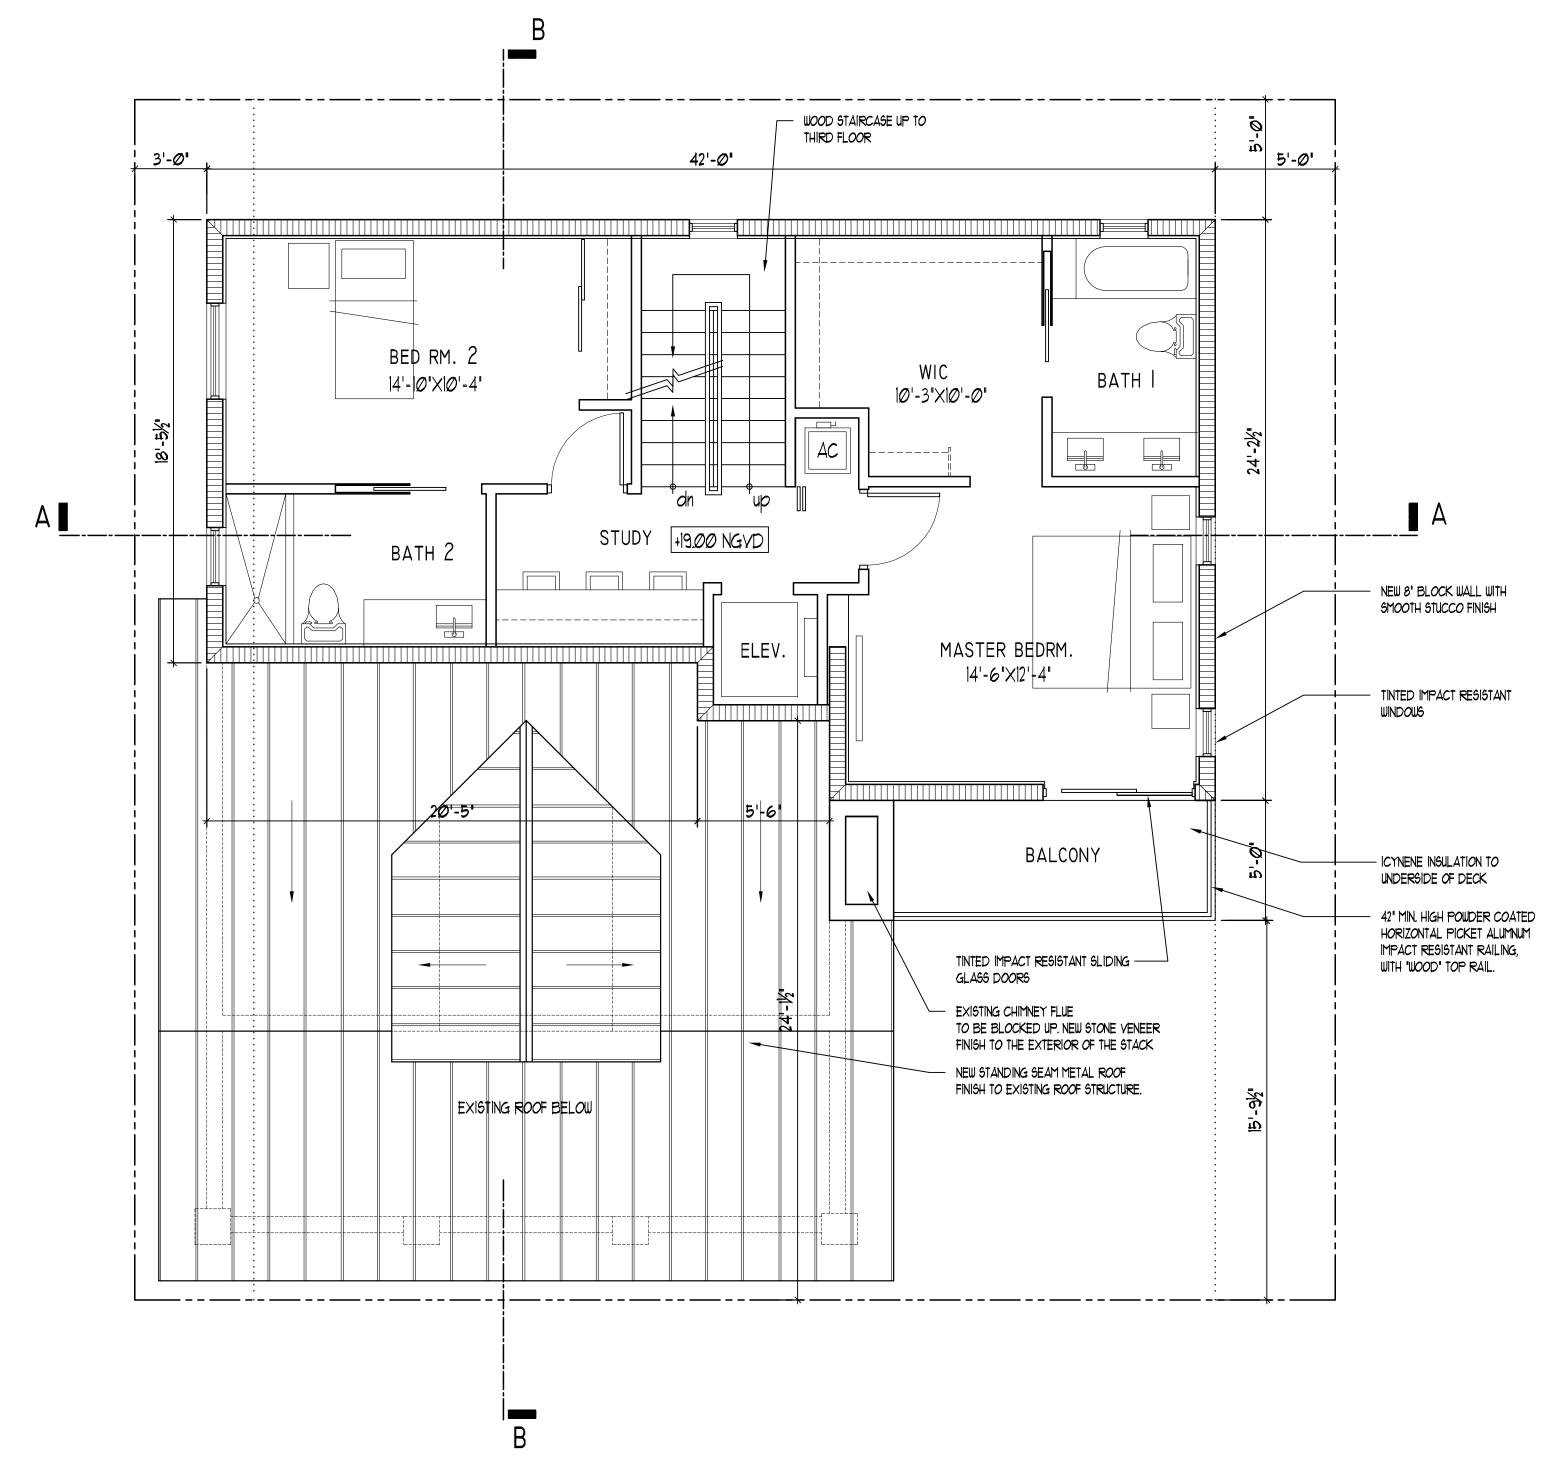

EXISTING ROOF PLAN

PROPOSED



SECOND FLOOR PLAN
SCALE: 1/4"= 1'-0"

JOSEPH B. KALLER

ASSOCIATES PA

2417 Hollywood Blvd. Hollywood, Florida 33020 (954) 920 5746 phone - (954) 926 2841 fax kaller@bellsouth.net

SEAL

JOSEPH B. KALLER FLORIDA R.A. # 0009239

SANTORO RESIDENCE ADD. TO EXIST. RESIDENCE 828 4TH STREET MIAMI BEACH FL 33139


REVISIONS No. DATE DESCRIPTION

2-2-18 FINAL SUBMITTAL

This drawing, as an instrument of service, is and shall remain the property of the Architect and shall not be reproduced, published or used in any way without the permission of the Architect

PROJECT No.: 17109 DATE: DRAWN BY: CHECKED BY: JBK

SHEET

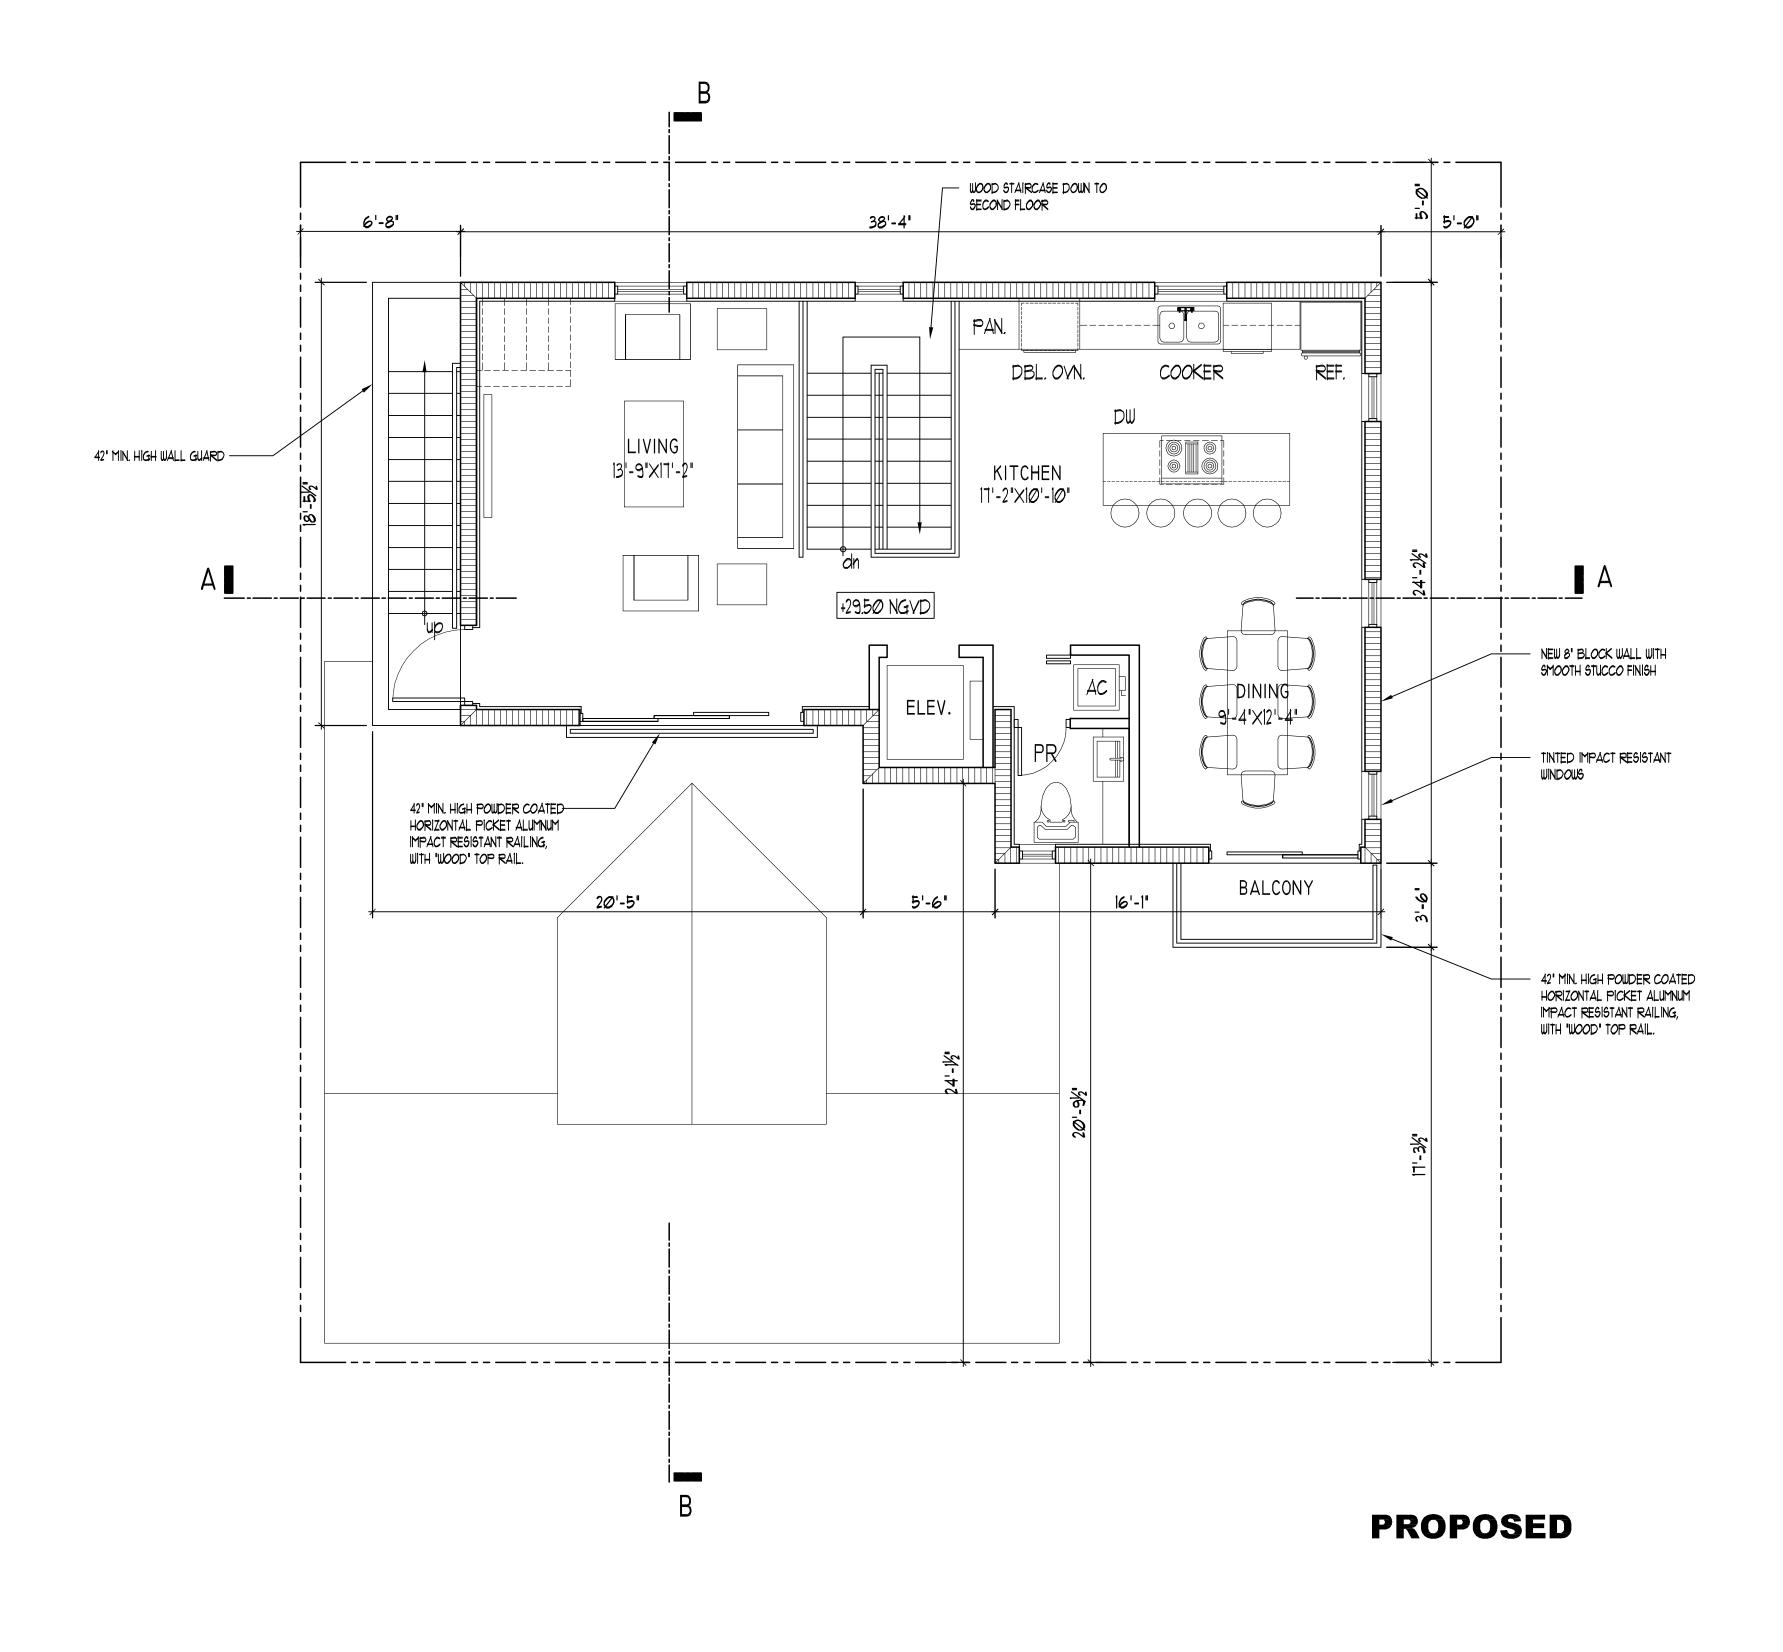



THIRD FLOOR PLAN
SCALE: 1/4"= 1'-0"

JOSEPH B. KALLER

ASSOCIATES PA AA# 26001212

2417 Hollywood Blvd. Hollywood, Florida 33020 (954) 920 5746 phone - (954) 926 2841 fax kaller@bellsouth.net

SEAL

JOSEPH B. KALLER FLORIDA R.A. # 0009239

SANTORO RESIDENCE ADD. TO EXIST. RESIDENCE 828 4TH STREET MIAMI BEACH FL 33139


REVISIONS

No. DATE DESCRIPTION 2-2-18 FINAL SUBMITTAL

This drawing, as an instrument of service, is and shall remain the property of the Architect and shall not be reproduced, published or used in any way without the permission of the Architect.

PROJECT No.: 17109 DRAWN BY: CHECKED BY: JBK

SHEET

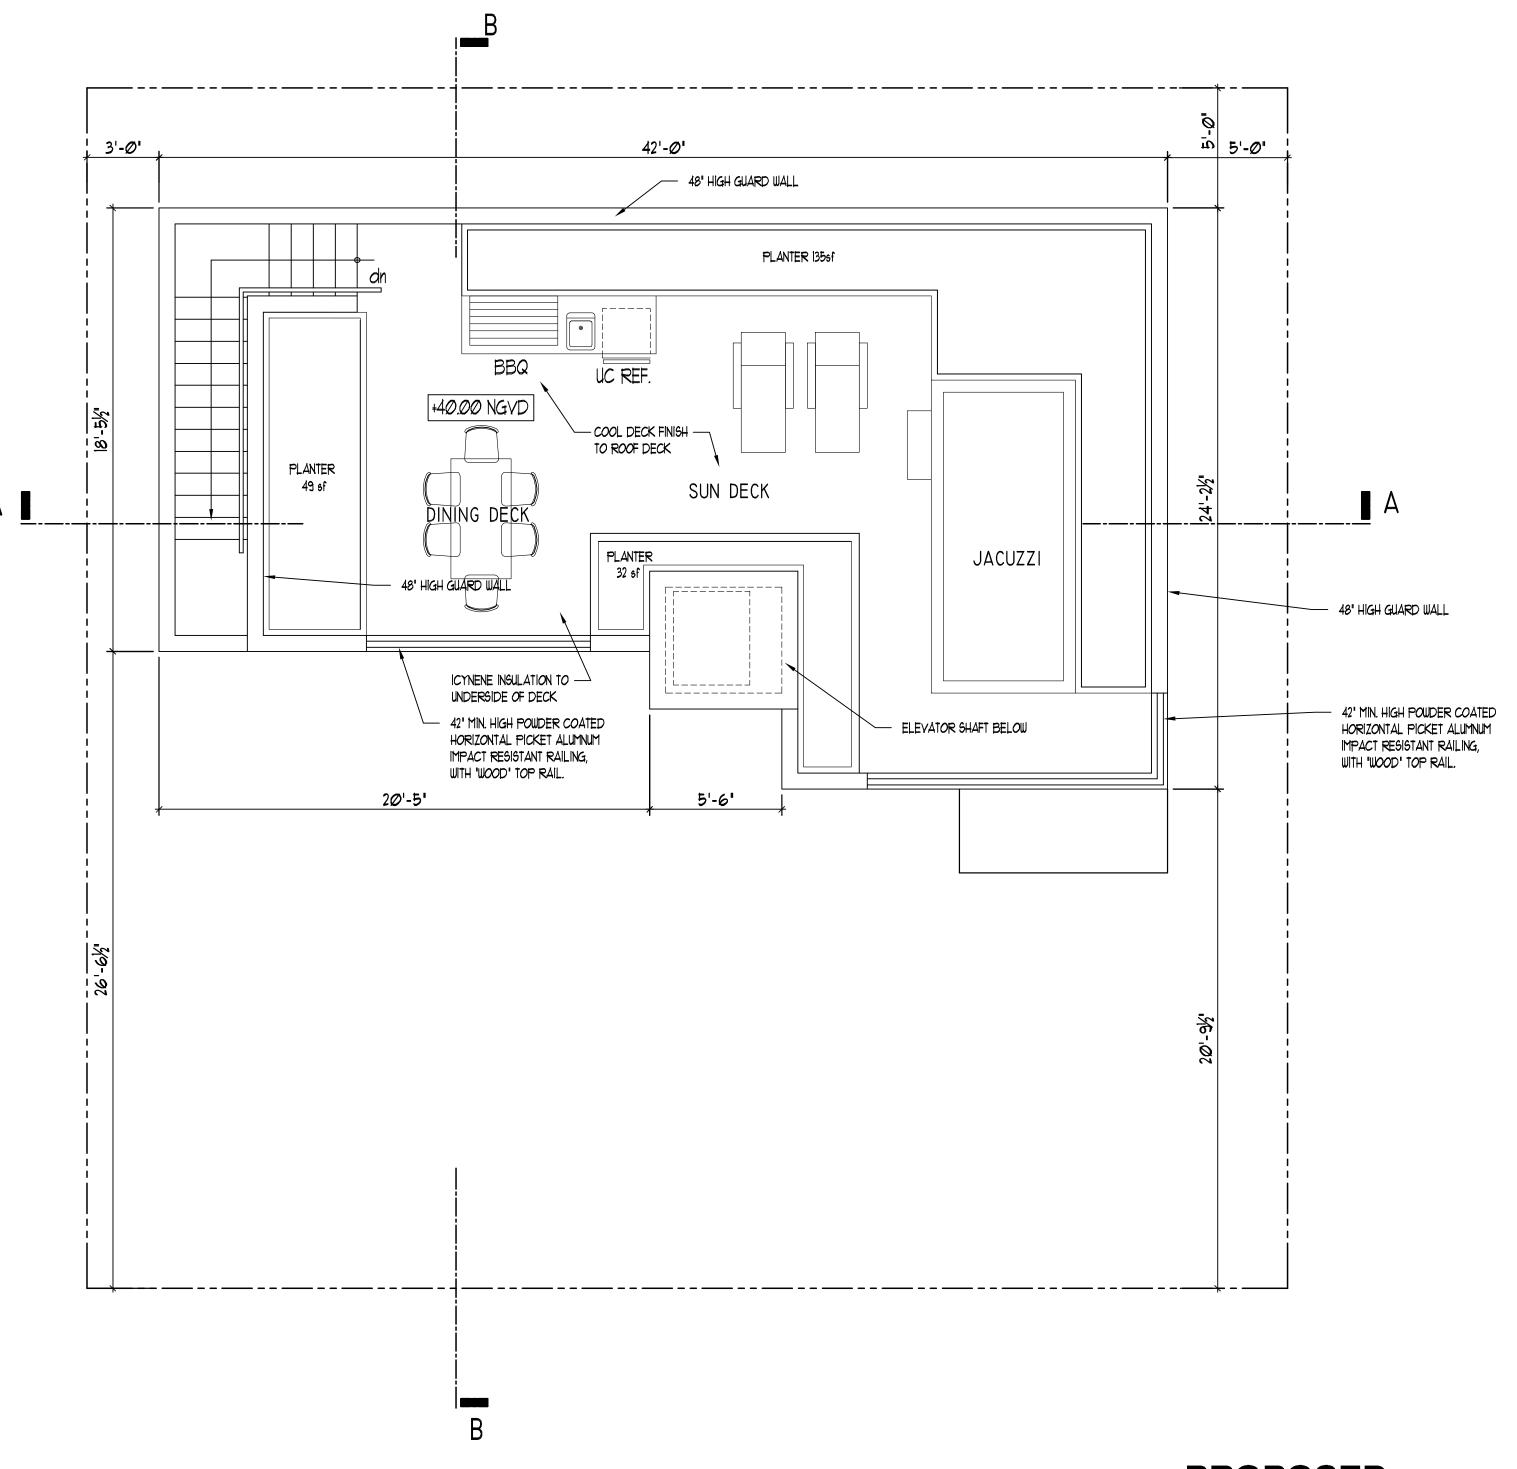

PROPOSED



ROOF PLAN
SCALE: 1/4"= 1'-0"

ASSOCIATES PA

ASSOCIATES PA

AA# 26001212

2417 Hollywood Bland be so Birding as size on the source of the source

SANTORO RESIDENCE
ADD. TO EXIST. RESIDENCE
828 4TH STREET
MIAMI BEACH FL 33139

ROOF PLAN HPB

REVISIONS

No. DATE DESCRIPTION

1 2-2-18 FINAL SUBMITTAL

misinterpretations resulting from the use of incomplete or prefirminary sets of

This drawing, as an instrument of service, is and shall remain the property of the Architect and shall not be reproduced, published or used in any way without the permission of the Architect.

PROJECT No.: 17109


DATE: 9-17-17

DRAWN BY: TMS

CHECKED BY: JBK

SHEE

A-4

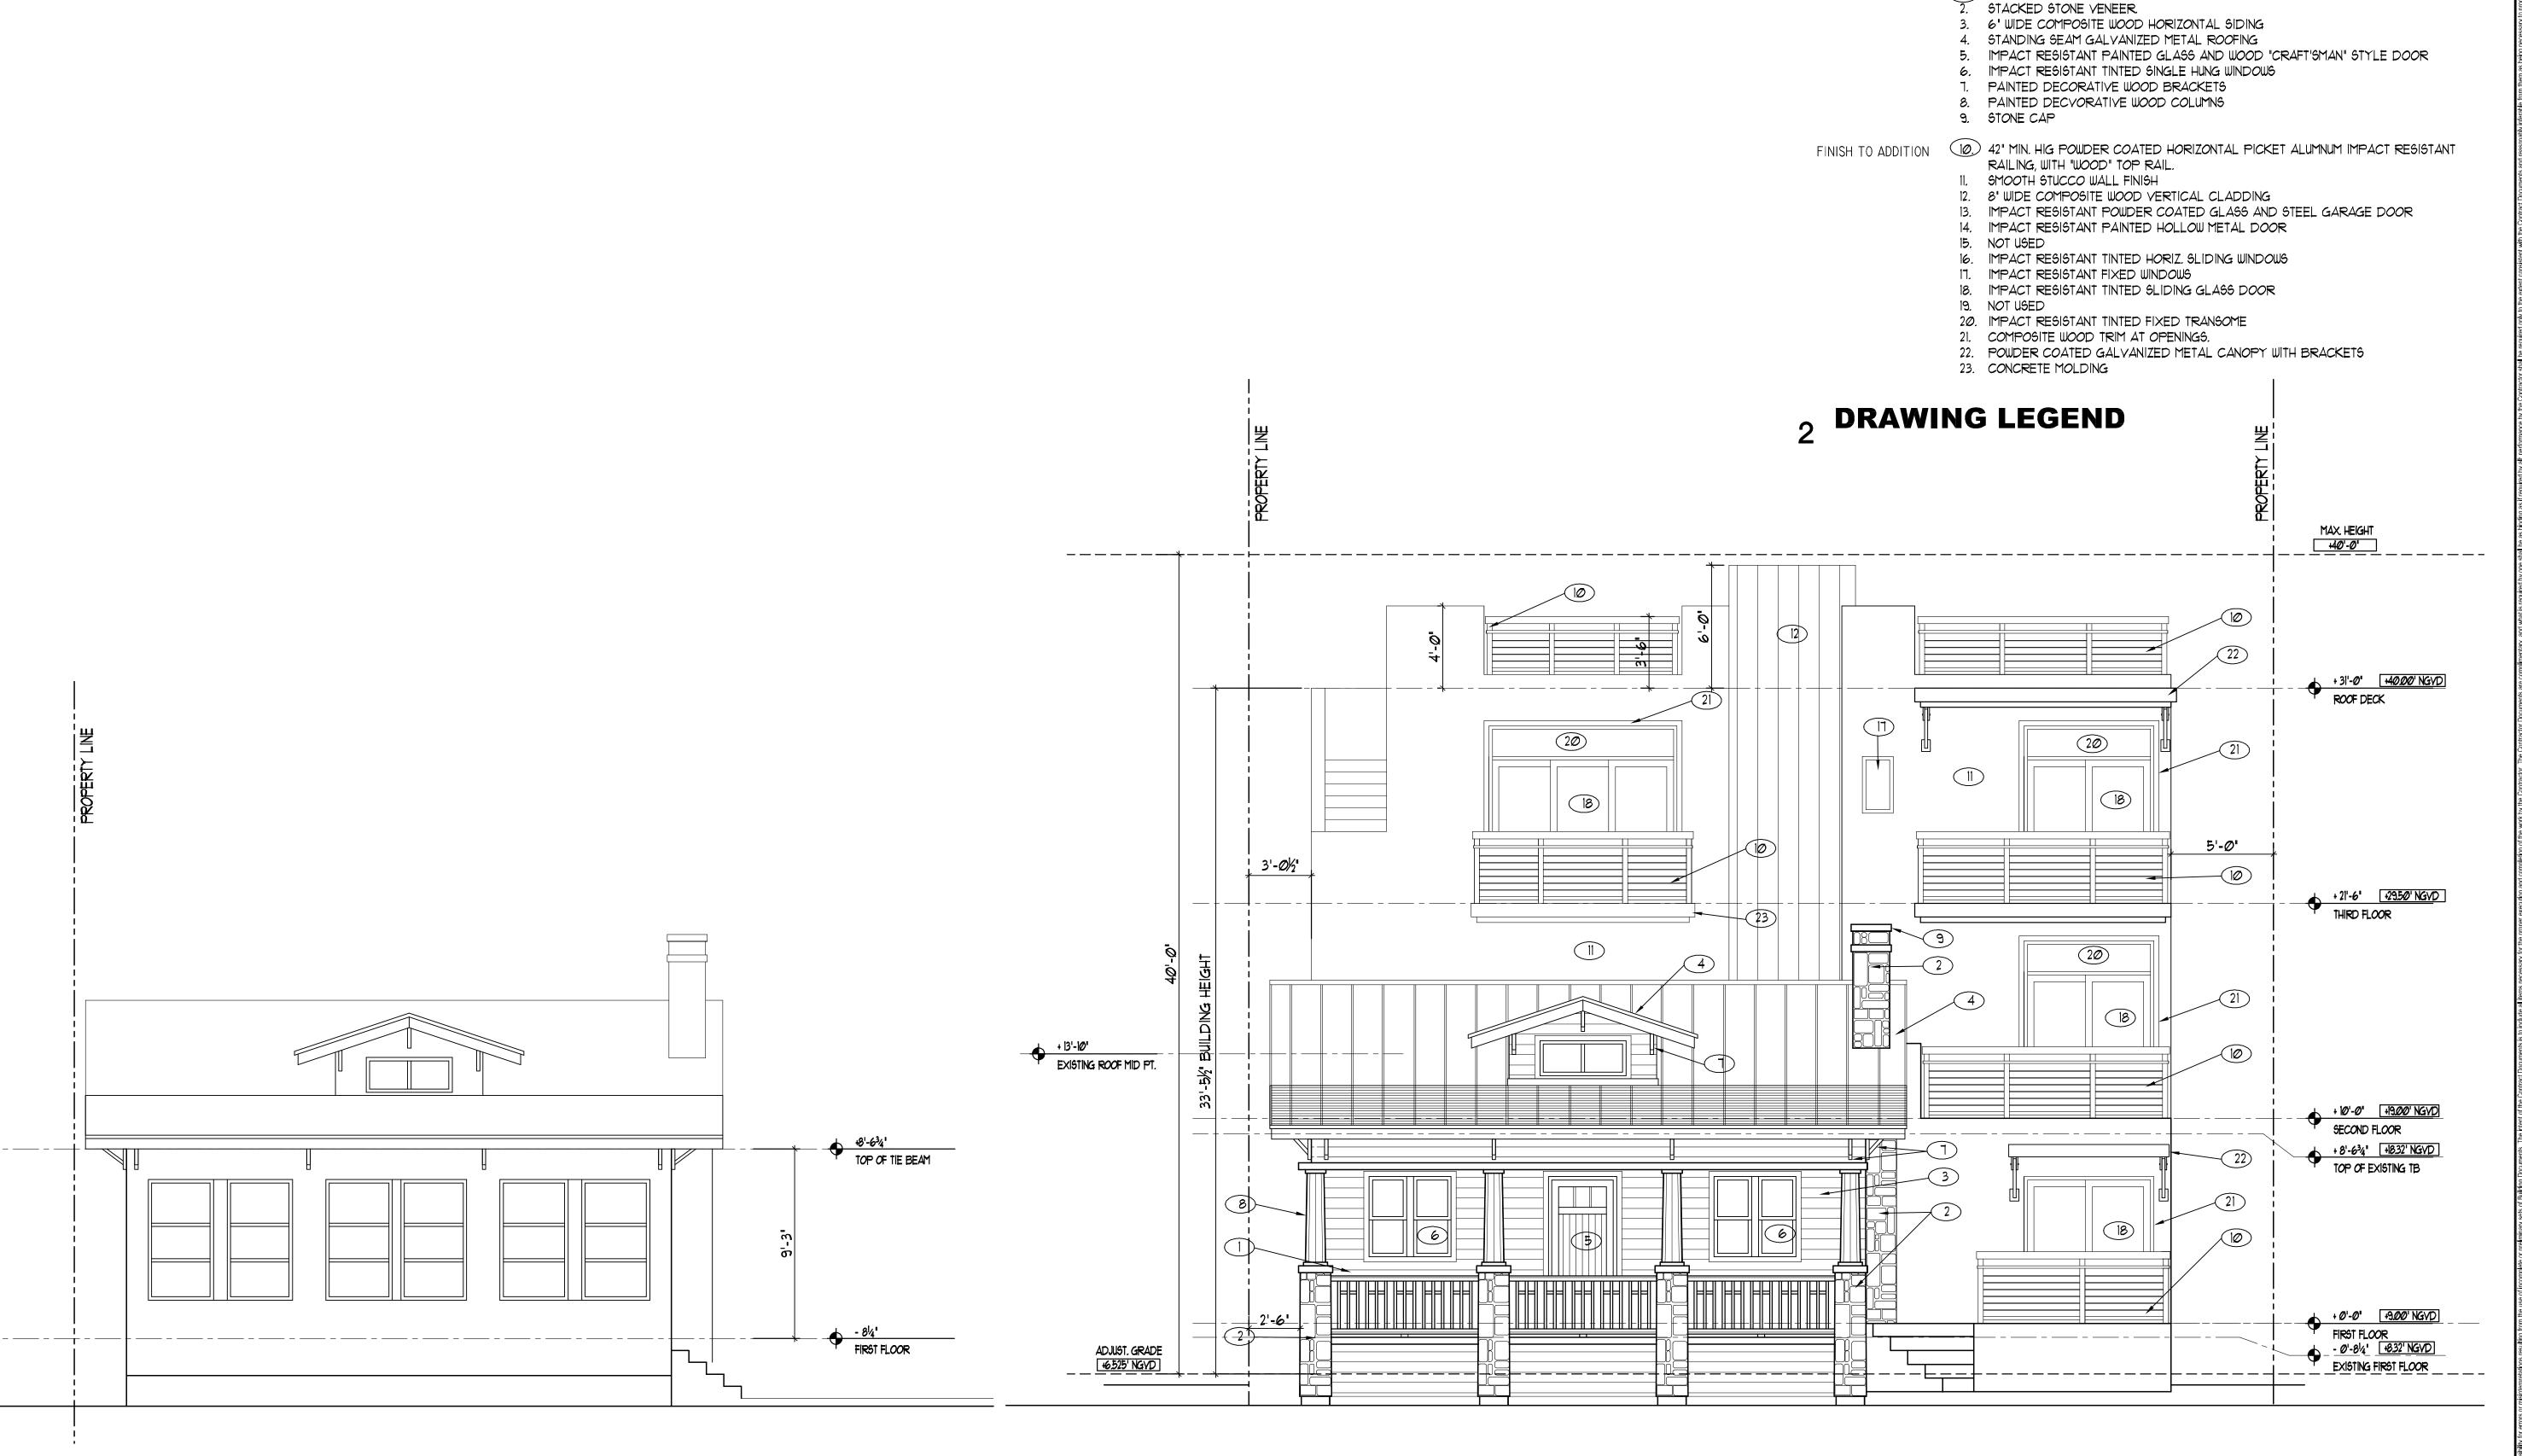


EXISTING

PROPOSED

FINISHES TO EXISTING (1.) 36' MIN. HIGH PAINTED WOOD RAILING.

NORTH ELEVATION
SCALE: 1/4"= 1'-0"

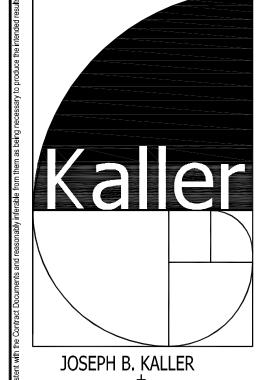

JOSEPH B. KALLER + ASSOCIATES PA

AA# 26001212

2417 Hollywood Blvd. Hollywood, Florida 33020

(954) 920 5746 phone - (954) 926 2841 fax

kaller@bellsouth.net

SEAL

JOSEPH B. KALLER FLORIDA R.A. # 0009239

> SANTORO RESIDENCE ADD. TO EXIST. RESIDENCE 828 4TH STREET MIAMI BEACH FL 33139

ELEVATIONS HPB

REVISIONSNo. DATE DESCRIPTION

2-2-18 FINAL SUBMITTAL

This drawing, as an instrument of service, is and shall remain the property of the Architect and shall not be reproduced, published or used in any way without the permission of the Architect.

PROJECT No.: 17109


DATE: 9-17-17

DRAWN BY: TMS

CHECKED BY: JBK

SHEET

A-5

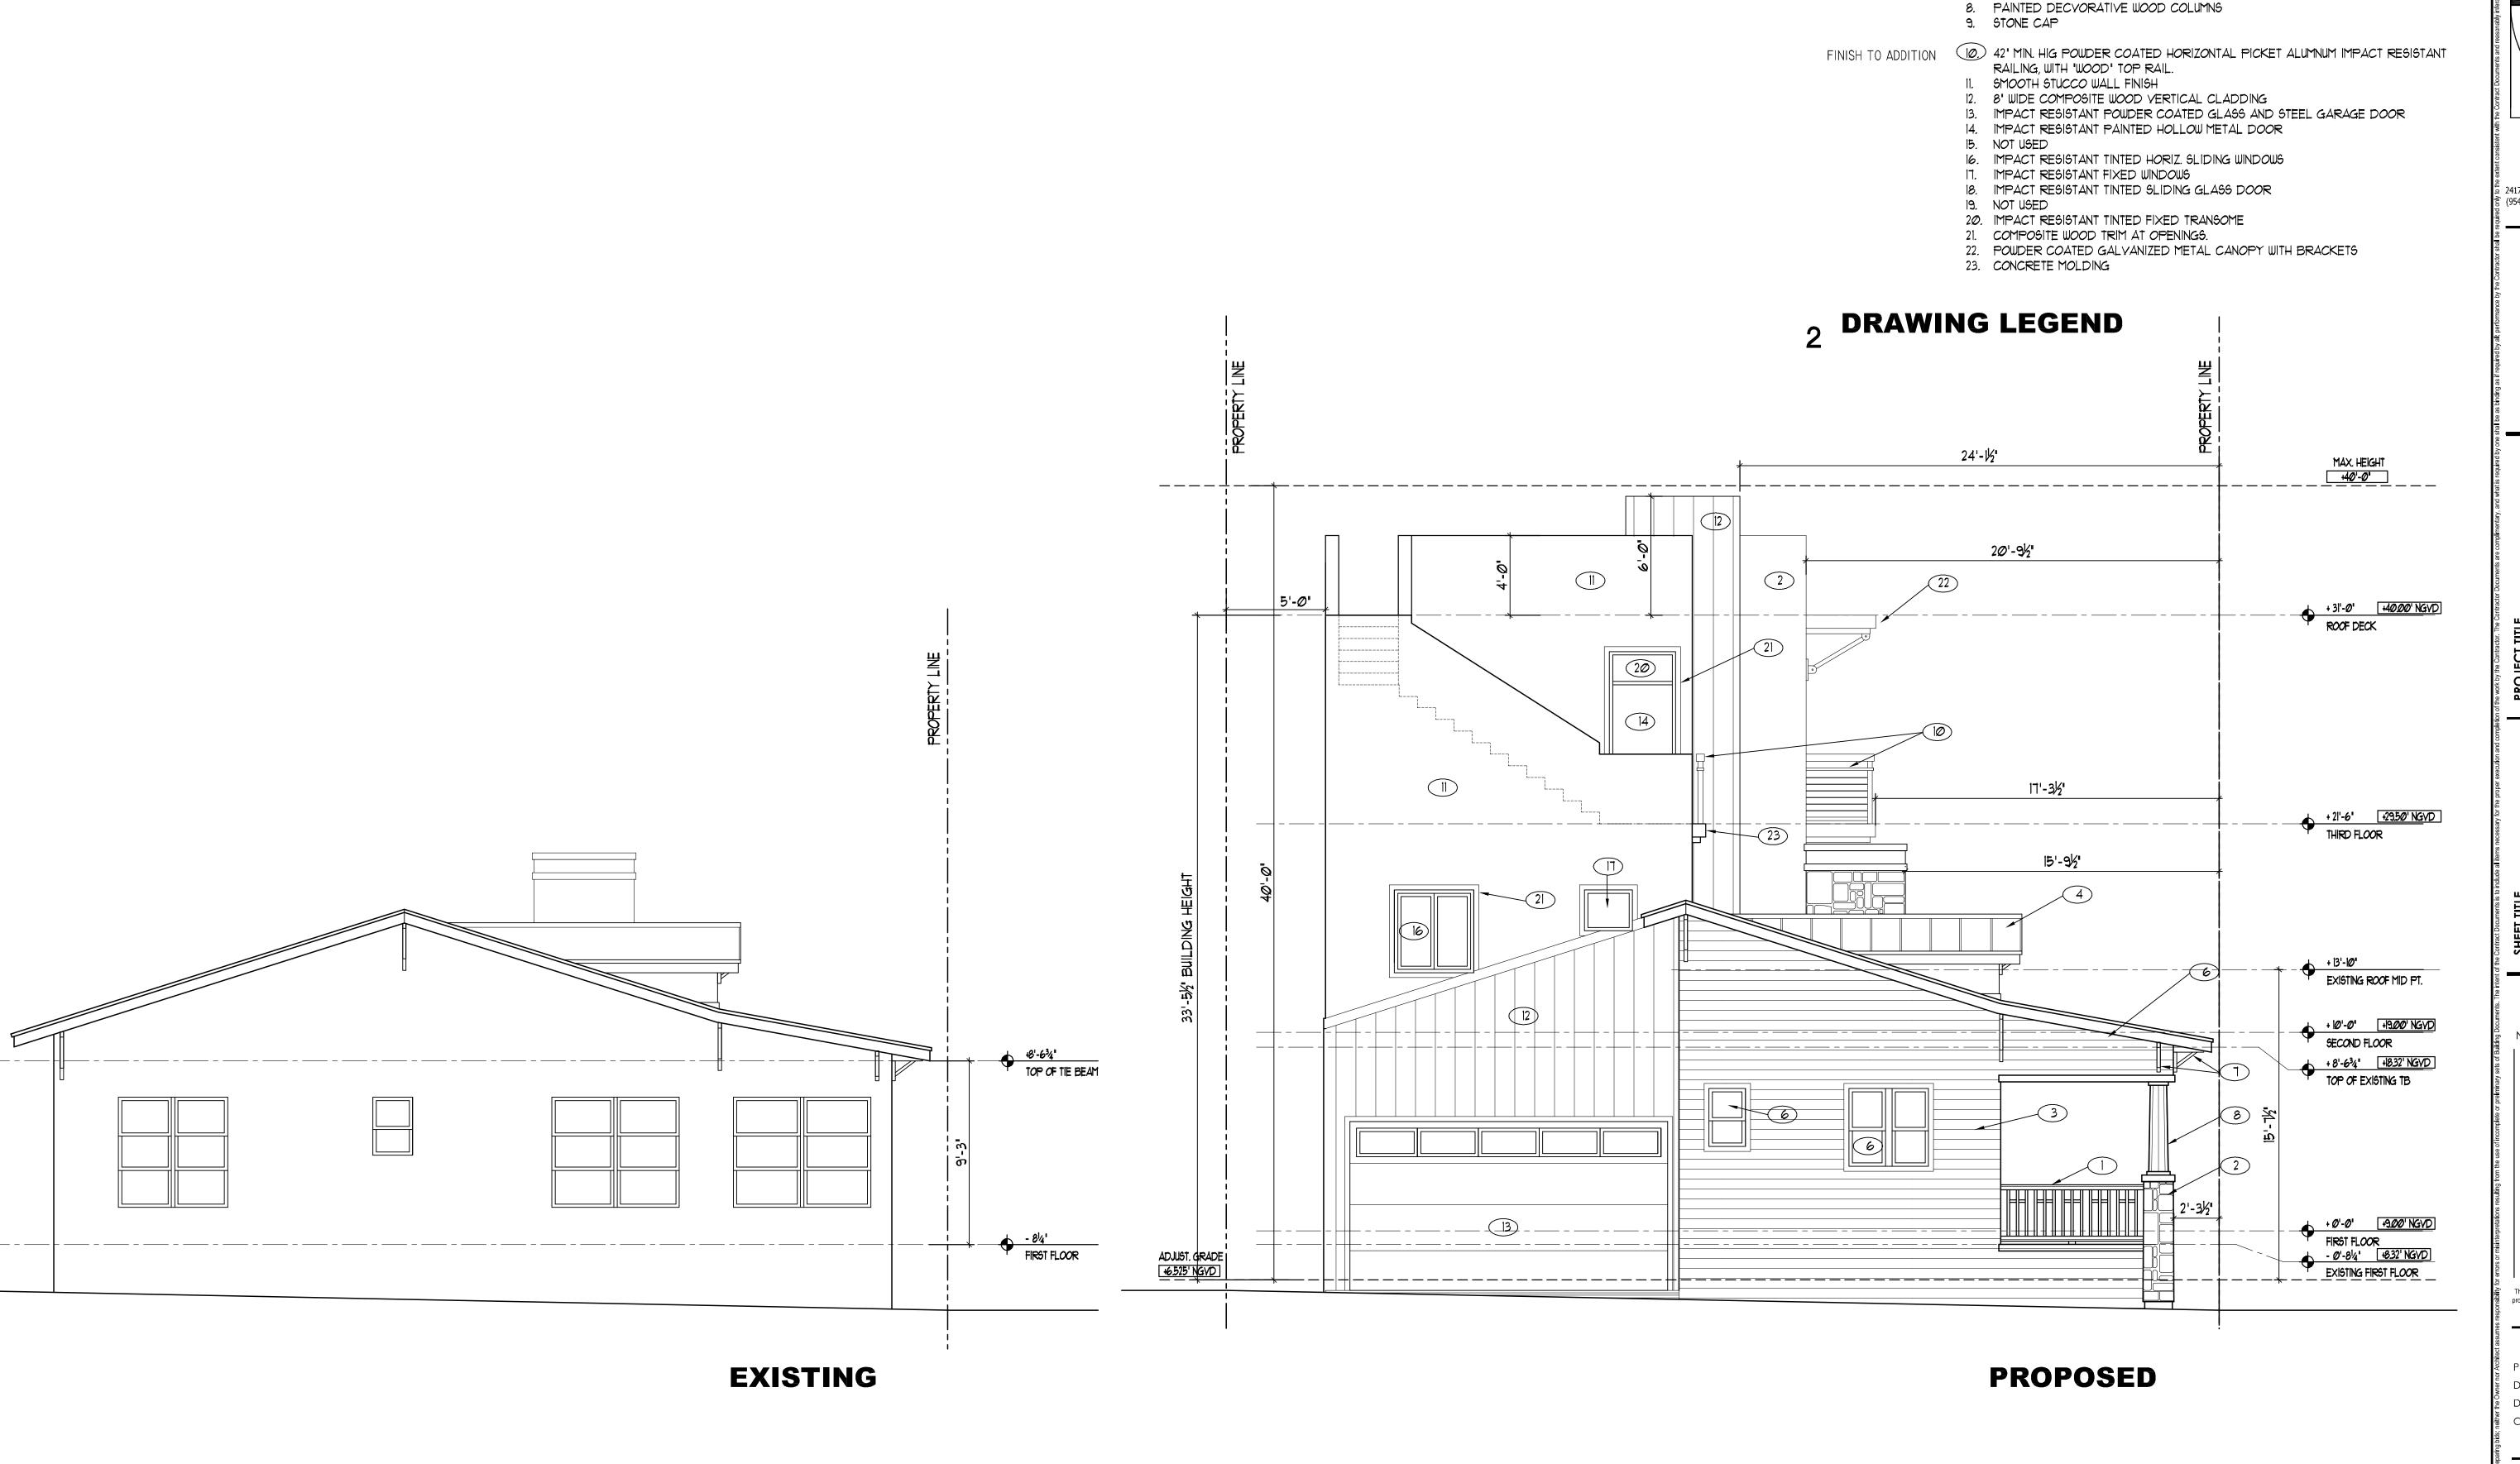

h the Contract Documents and reasonably inferable from them as being necessary to produce the intended I

FINISHES TO EXISTING (I.) 36" MIN. HIGH PAINTED WOOD RAILING.

STACKED STONE VENEER.

6" WIDE COMPOSITE WOOD HORIZONTAL SIDING STANDING SEAM GALVANIZED METAL ROOFING

6. IMPACT RESISTANT TINTED SINGLE HUNG WINDOWS

1. PAINTED DECORATIVE WOOD BRACKETS

5. IMPACT RESISTANT PAINTED GLASS AND WOOD "CRAFT'SMAN" STYLE DOOR

JOSEPH B. KALLER + ASSOCIATES PA

AA# 26001212
2417 Hollywood Blvd. Hollywood, Florida 33020
(954) 920 5746 phone - (954) 926 2841 fax kaller@bellsouth.net

SEAL

JOSEPH B. KALLER FLORIDA R.A. # 0009239

SANTORO RESIDENCE ADD. TO EXIST. RESIDENCE 828 4TH STREET MIAMI BEACH FL 33139

:LEVATIONS IPB

REVISIONS

No. DATE DESCRIPTION

1 2-2-18 FINAL SUBMITTAL

This drawing, as an instrument of service, is and shall remain the property of the Architect and shall not be reproduced, published or used in any way without the permission of the Architect.

PROJECT No.: 17109

DATE: 9-17-17


DRAWN BY: TMS

CHECKED BY: JBK

SHEET

EAST ELEVATION
SCALE: 1/4"= 1'-0"

A-6

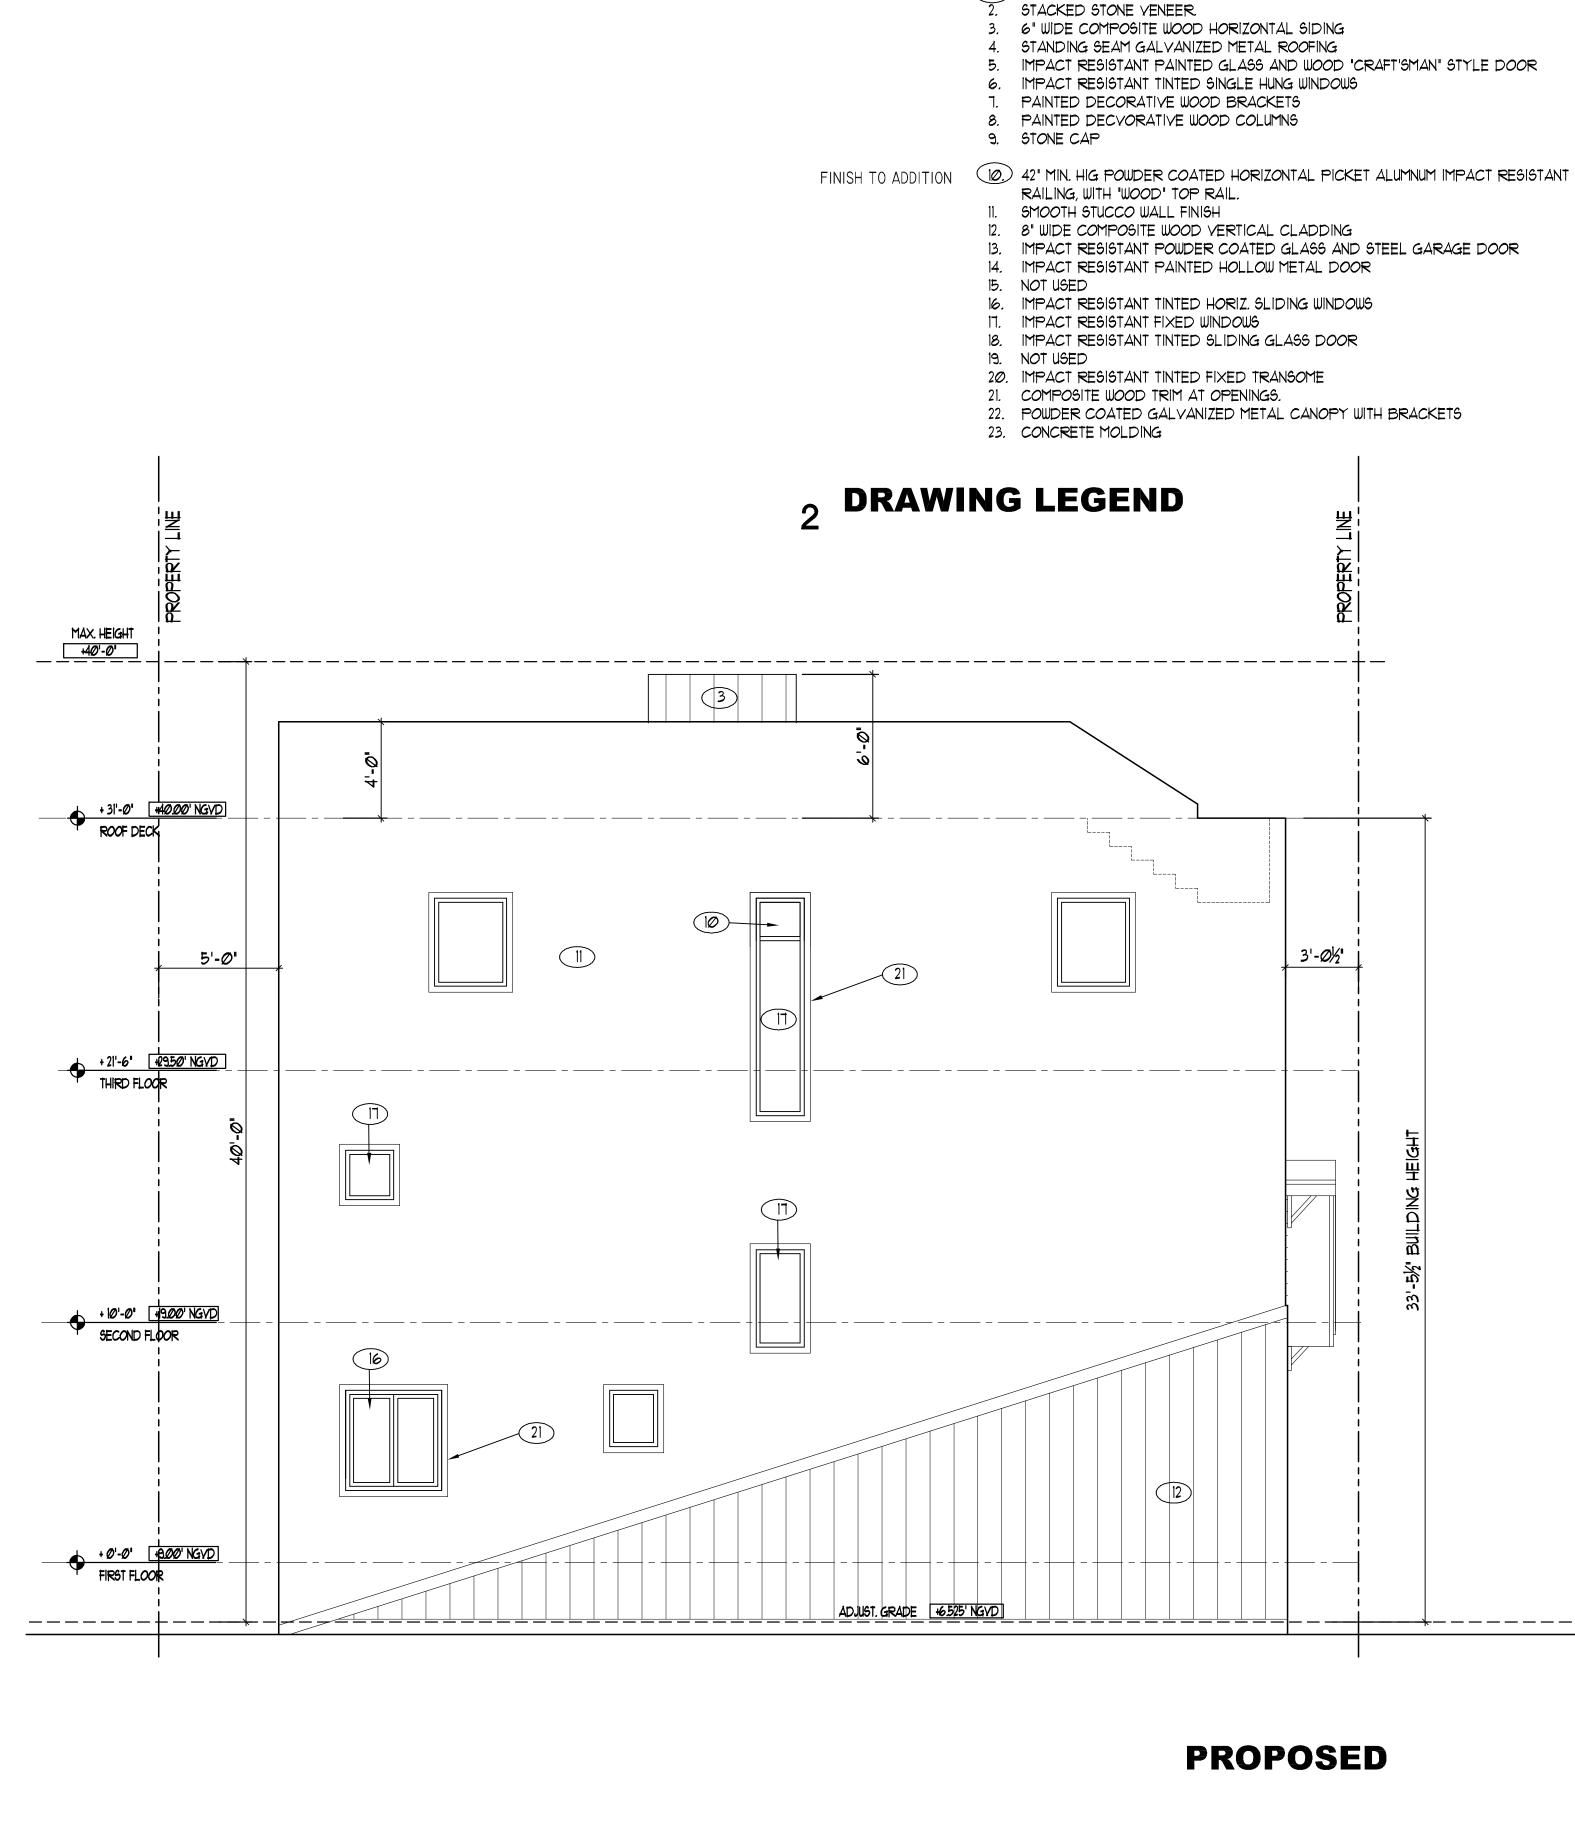

+8'-6³4"

TOP OF TIE BEAM

- 814" FIRST FLOOR

EXISTING

FINISHES TO EXISTING (1.) 36" MIN. HIGH PAINTED WOOD RAILING.

SOUTH ELEVATION
SCALE: 1/4"= 1'-0"

JOSEPH B. KALLER

JOSEPH B. KALLER

JOSEPH B. KALLER + ASSOCIATES PA AA# 26001212

2417 Hollywood Blvd. Hollywood, Florida 33020 (954) 920 5746 phone - (954) 926 2841 fax kaller@bellsouth.net

SEAL

JOSEPH B. KALLER FLORIDA R.A. # 0009239

> SANTORO RESIDENCE ADD. TO EXIST. RESIDENCE 828 4TH STREET MIAMI BEACH FL 33139

LEVATIONS IPB

REVISIONSNo. DATE DESCRIPTION

2-2-18 FINAL SUBMITTAL

This drawing, as an instrument of service, is and shall remain the property of the Architect and shall not be reproduced, published or


used in any way without the permission of the Architect.

PROJECT No.: 17109

DRAWN BY: TMS
CHECKED BY: JBK

SHEET

A-7

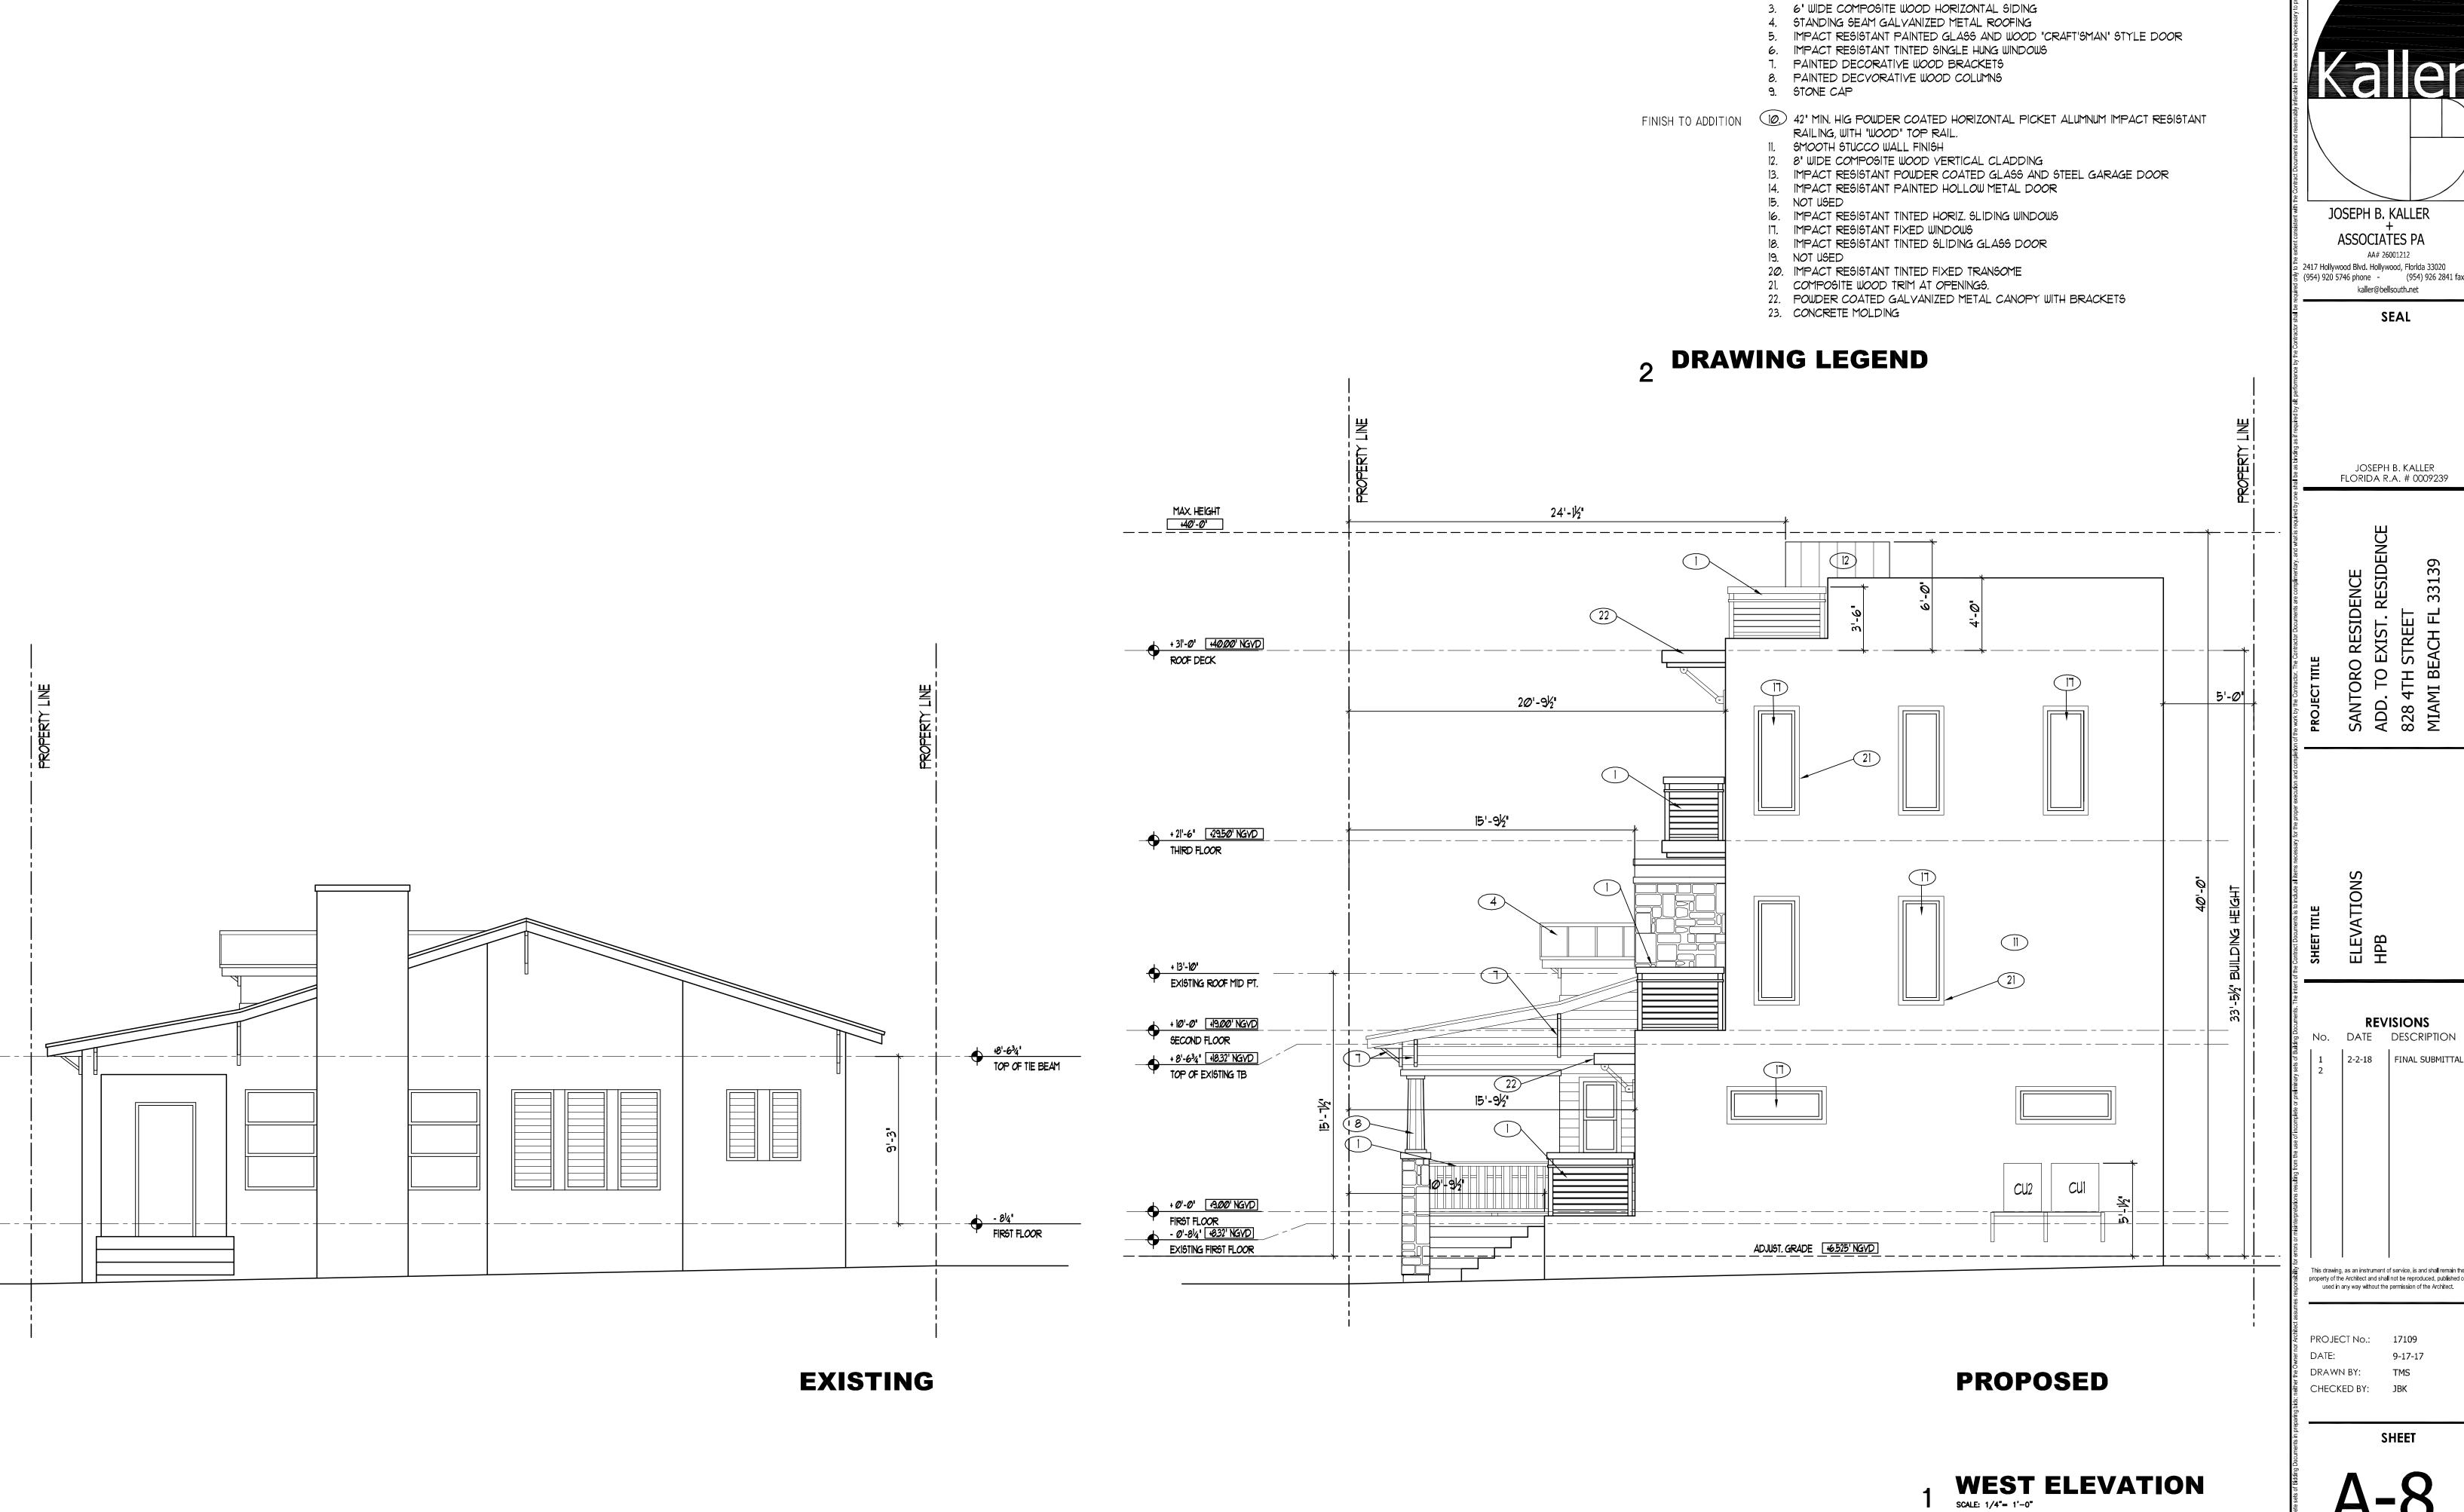

FINISHES TO EXISTING (1.) 36' MIN. HIGH PAINTED WOOD RAILING.

STACKED STONE VENEER.


ASSOCIATES PA


2417 Hollywood Blvd. Hollywood, Florida 33020 (954) 920 5746 phone - (954) 926 2841 fax

REVISIONS

FINAL SUBMITTAL

This drawing, as an instrument of service, is and shall remain the property of the Architect and shall not be reproduced, published or

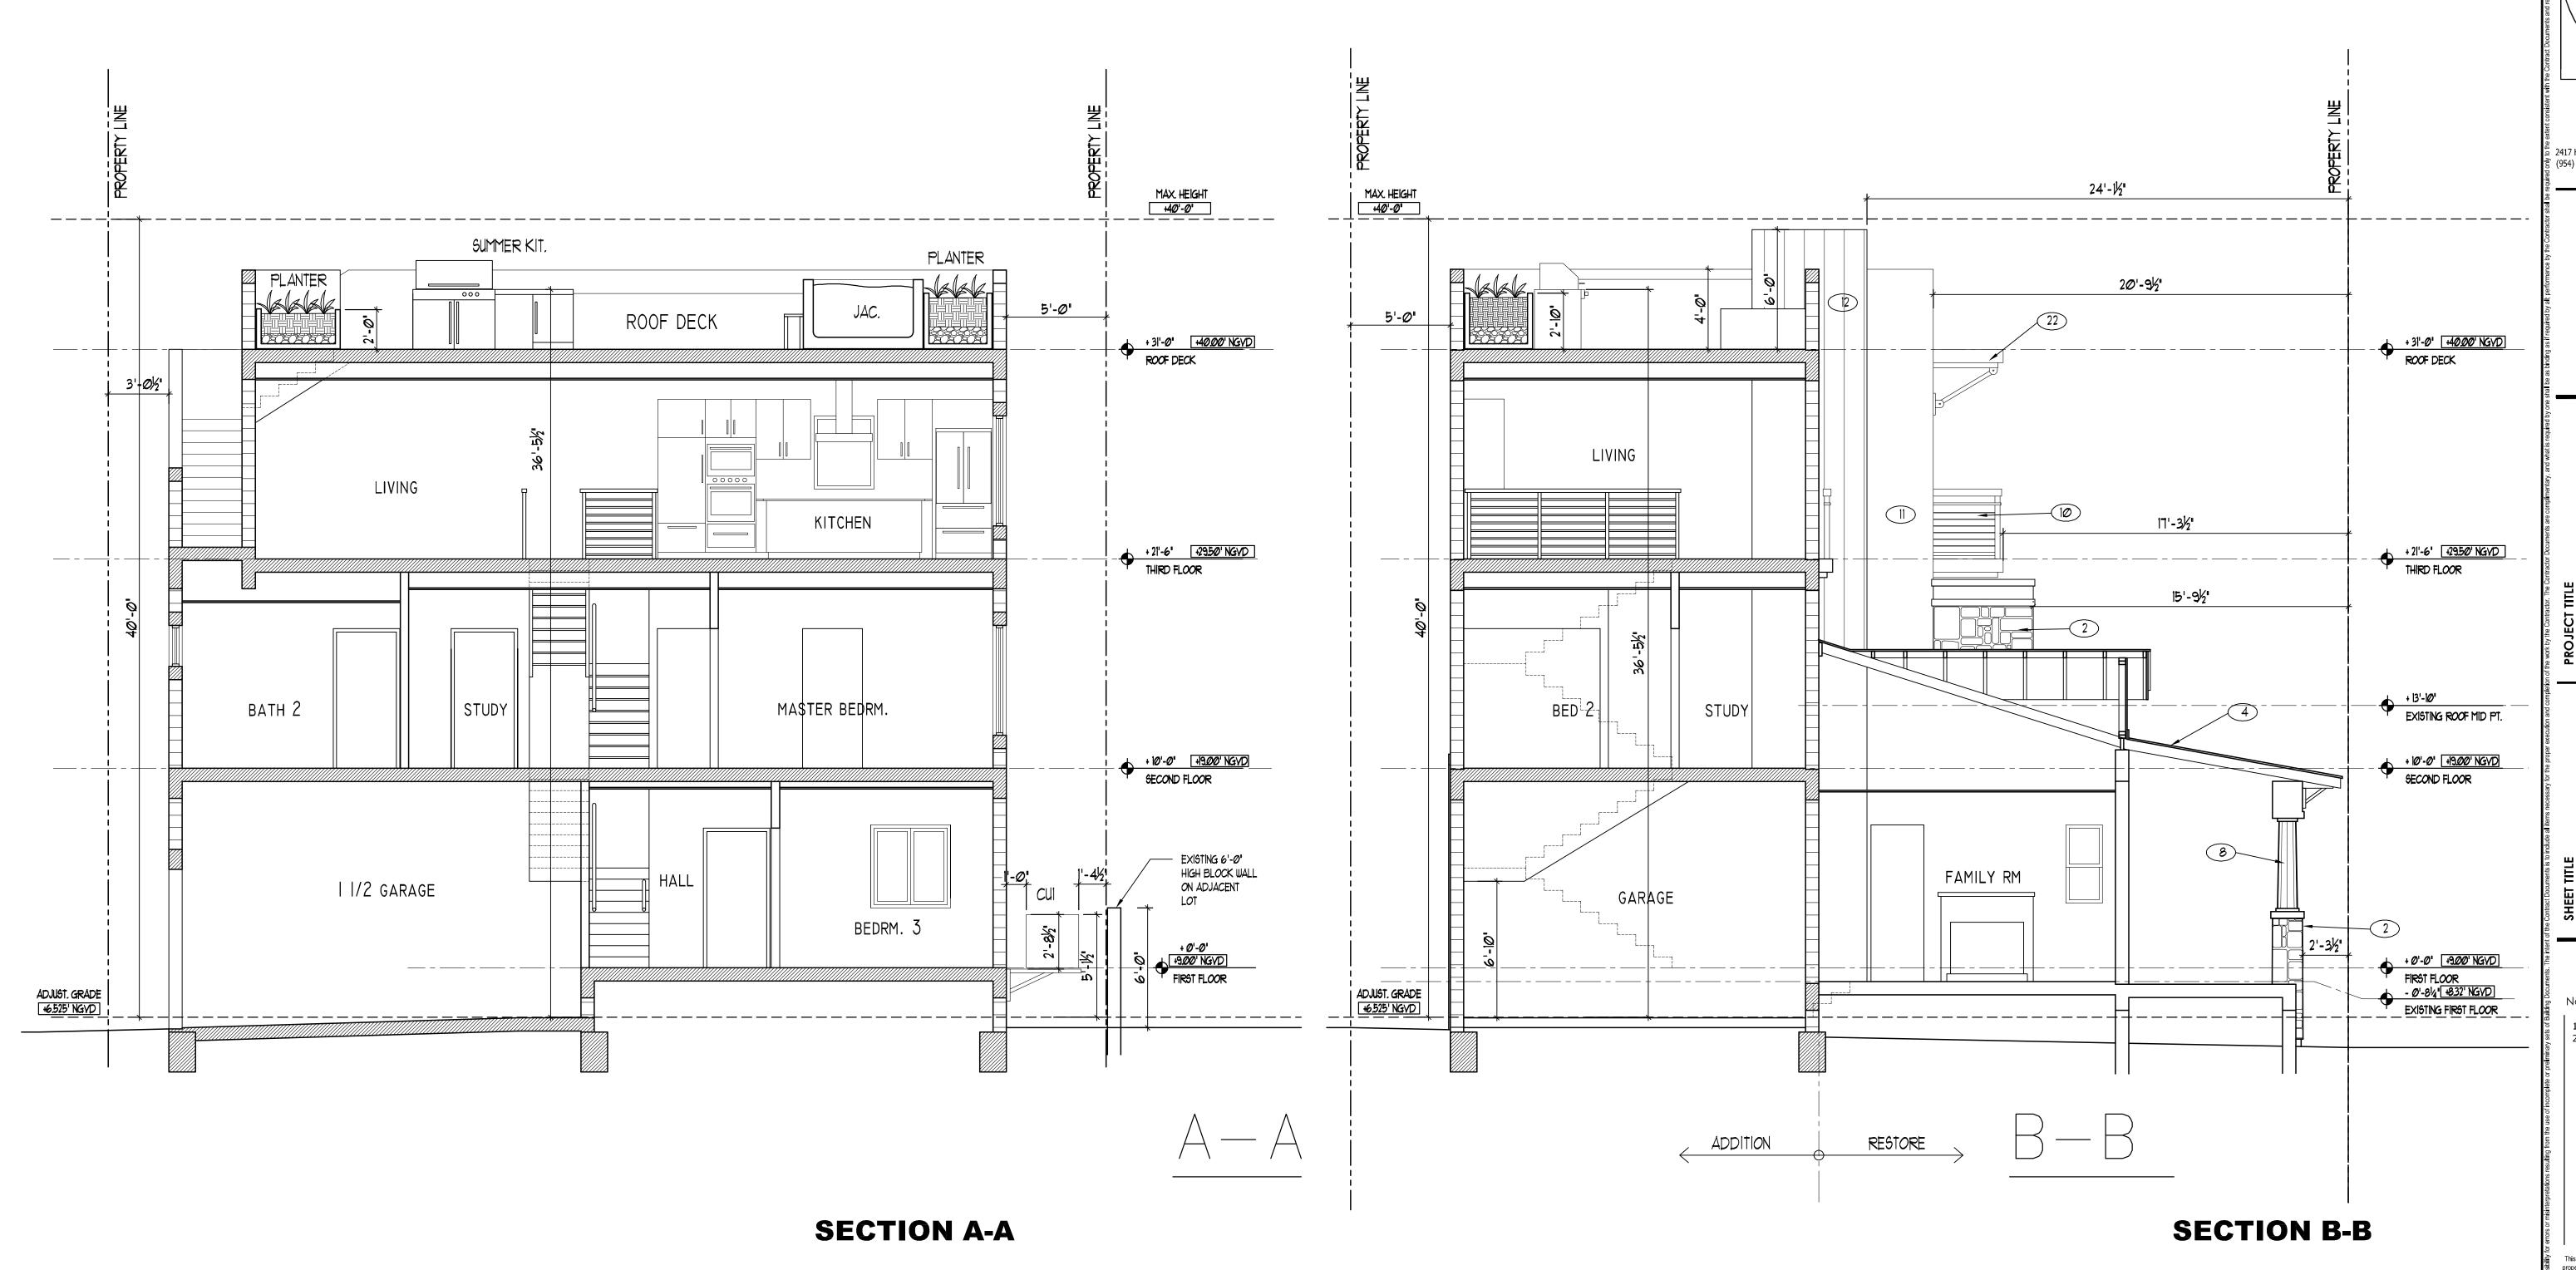

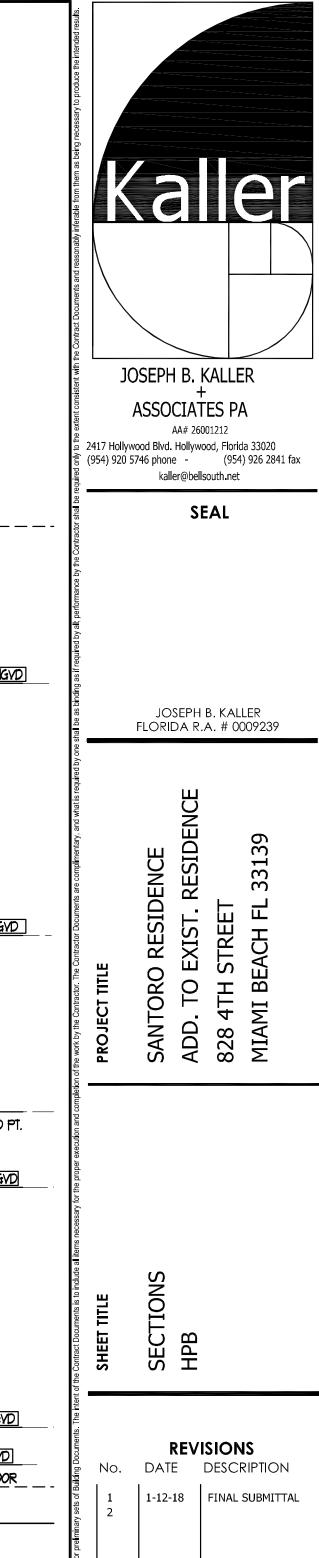

THE CONTROL OF THE CO

This drawing, as an instrument of service, is and shall remain the property of the Architect and shall not be reproduced, published or used in any way without the permission of the Architect.

PROJECT No.: 17109

DATE: 9-17-17

DRAWN BY: TMS

CHECKED BY: JBK

SHEET

A-9

9 OF 9

SECTIONS
SCALE: 1/4"= 1'-0"