

2 NORTH EAST 3D VIEW



3 SOUTH WEST 3D VIEW

1 NORTH WEST 3D VIEW

4 SOUTH EAST 3D VIEW

SKLAR chitecture

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> SEAL ARI L. SKLAR LICENSE #AR1473

> > REVISIONS

WATERCUP INVESTMENTS LLC.

809 2ND STREET, MIAMI BEACH-FLORIDA 33139

Drawn By: M.V Checked By: ARI SKLAR

3D VIEWS


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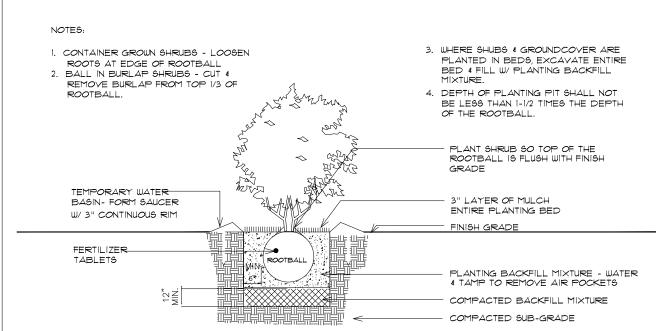
PROJECT #: 16-029

DATE: 04-24-17


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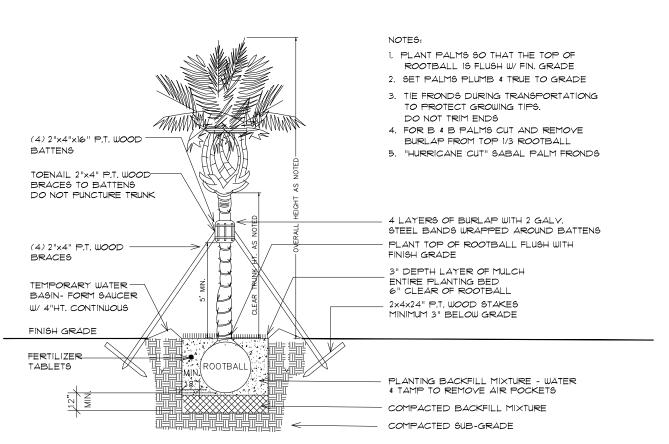
#### NOTE: ALL STAKING & GUYS SHALL BE REMOVED APPROXIMATELY 9 MONTHS AFTER PLANTING OR AS DIRECTED BY LANDSCAPE ARCHITECT



#### SHRUB PLANTING DETAIL

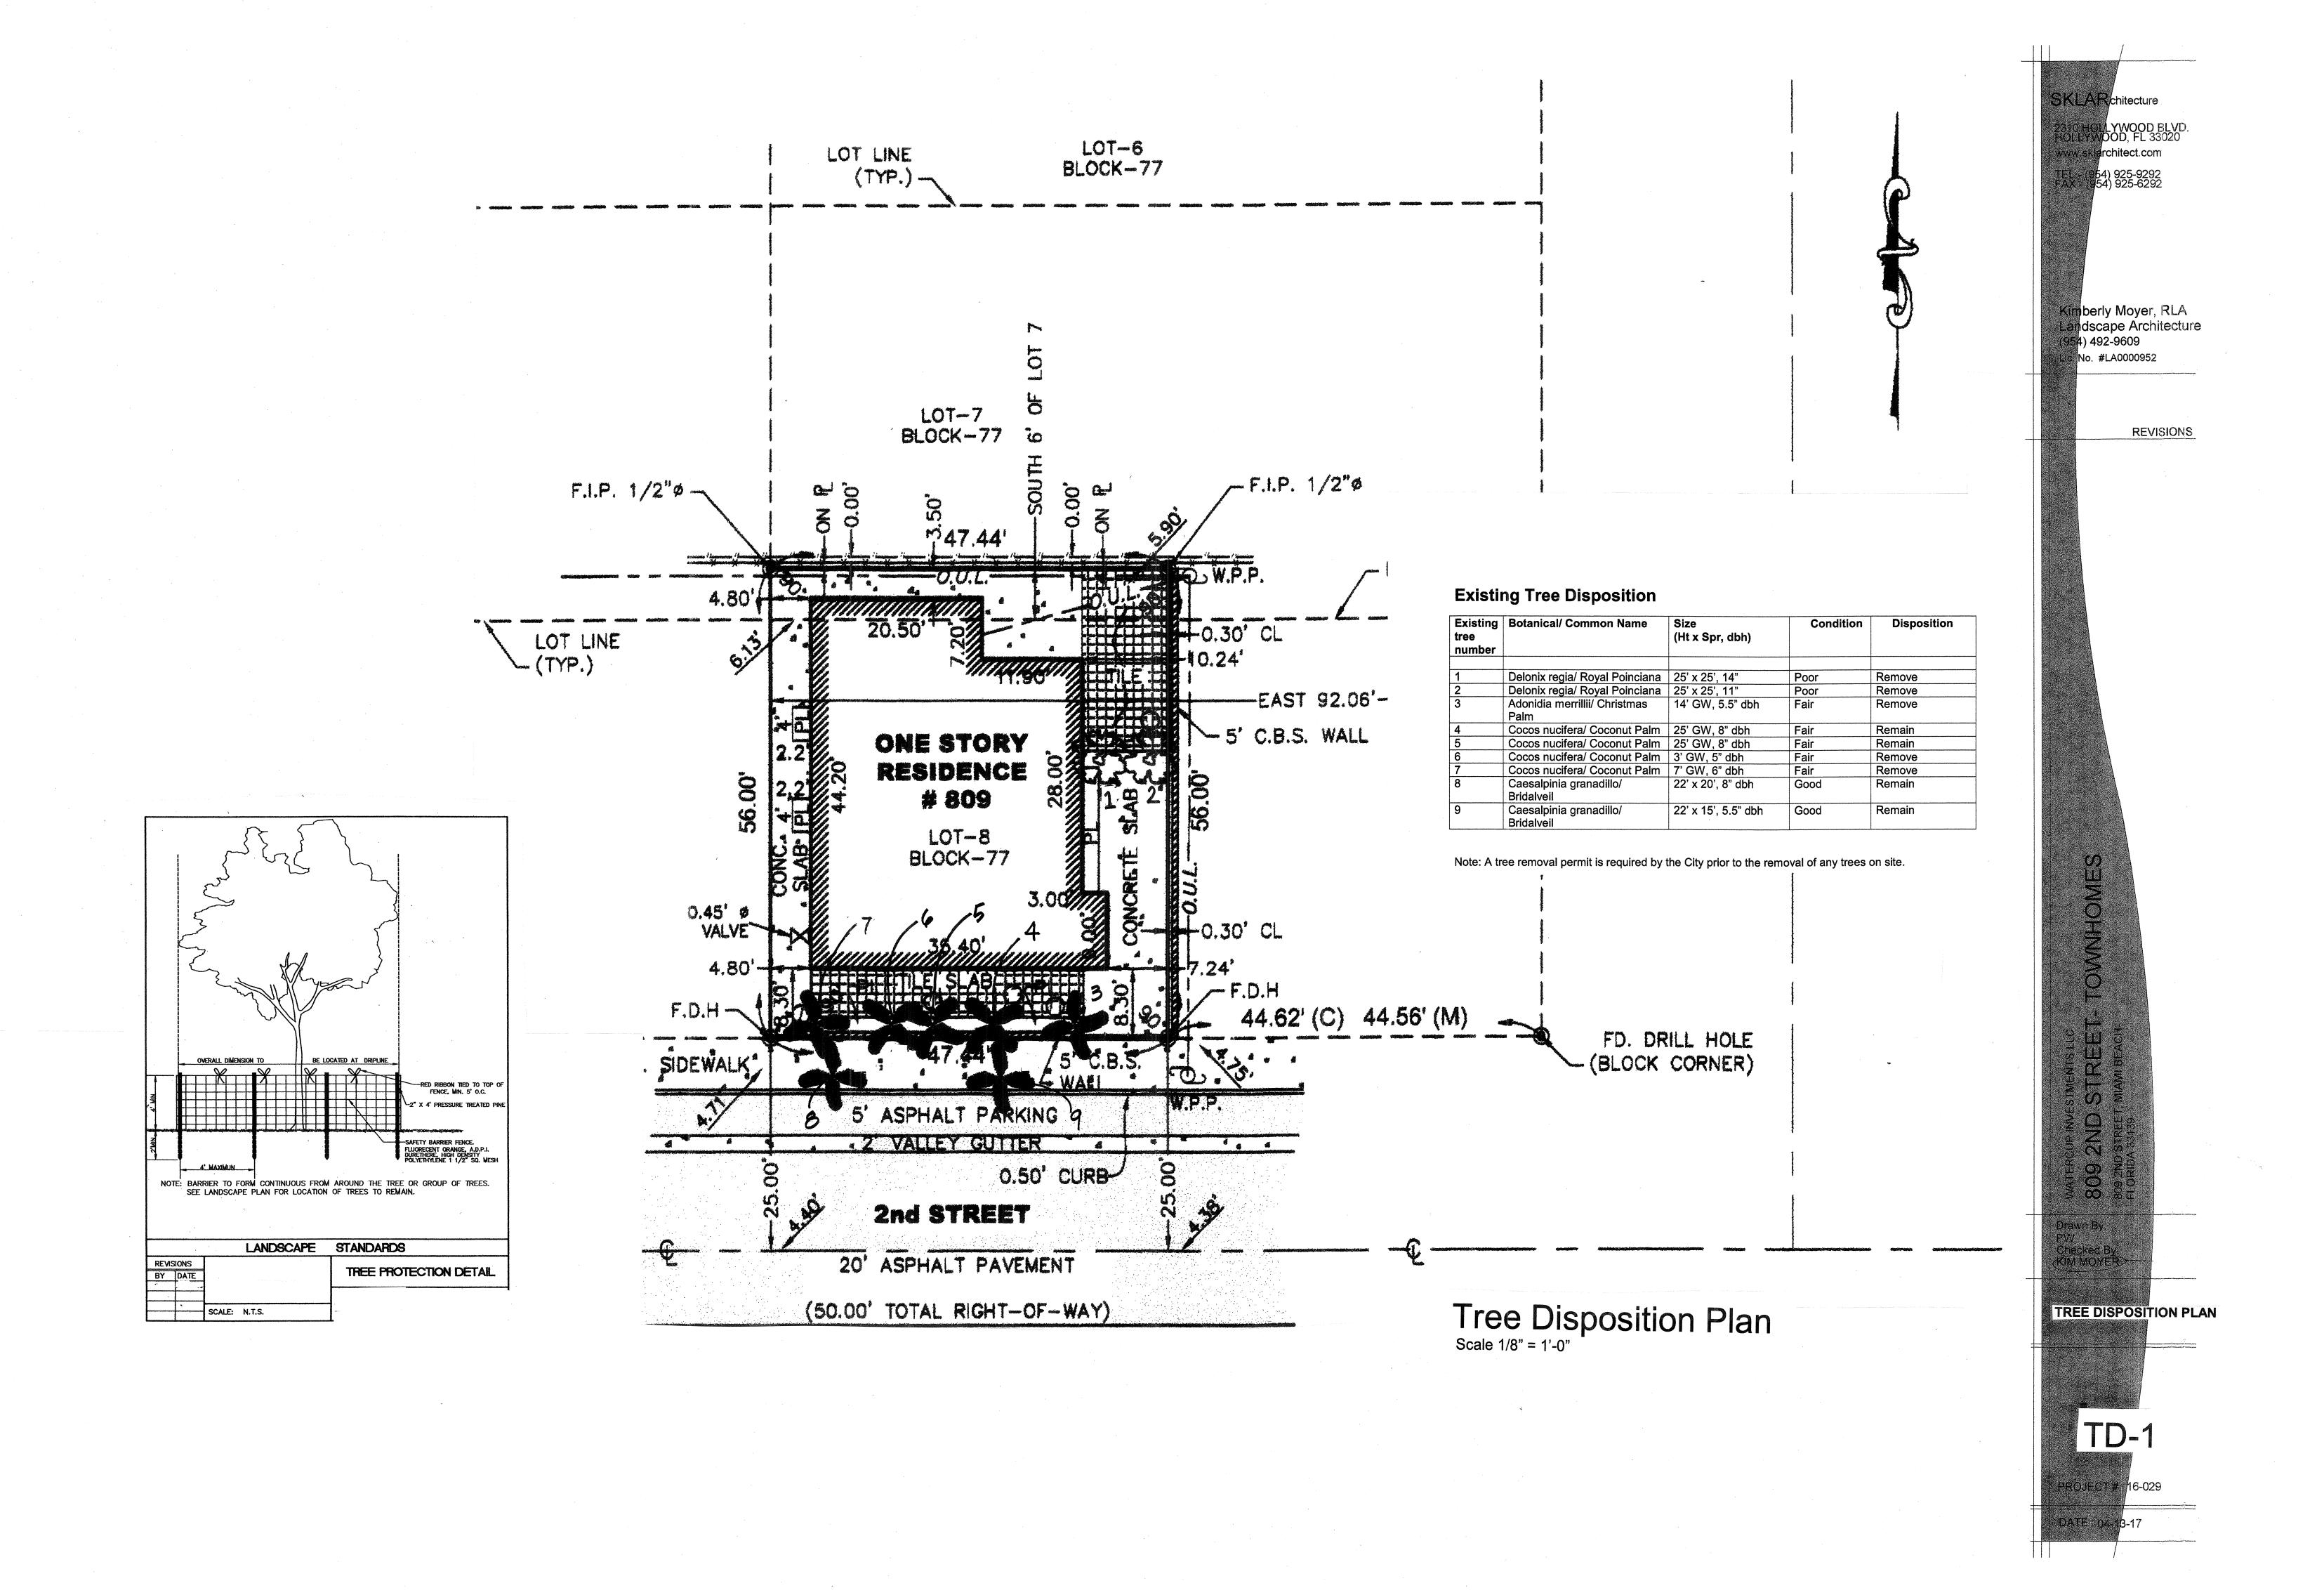

### TREE STAKING DETAIL

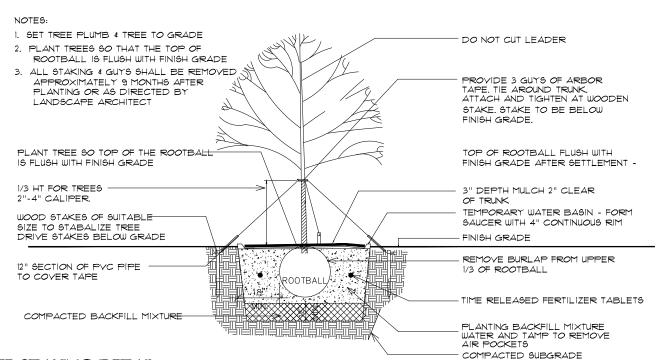

## PALM PLANTING DETAIL

NOTE: NO WELLINGTON TAPE OR OTHER NON-BIODEGRADABLE MATERIALS SHALL COME INTO CONTACT WITH THE TREE.

### Plant List for Proposed Plant Material

Sym	Qty	Botanical/ Common Name	Size	Native
TR	2	Thrinax radiata/ Thatch Palm	12' OA HT	yes
AF	2	Acacia farnesiana/ Sweet Acacia	5' Ht, std	yes
MF	2	Myrcianthes fragrans/ Simpson's Stopper	10' Ht x 4' Spr, 2" Cal	yes
CI	12	Chrysobalanus icaco/ Cocoplum	24" x 24", 24" O.C.	yes
PM	45	Podocarpus macrophyllus/ Podocarpus	24" x 24", 24" O.C.	no
BE	12	Begonia odorata 'Alba'/ White Angel	16"x 16", 24" O.C.	no
NE	18	Neoregelia 'Bossa Nova'/ Bossa Nova	16" x 16"	no
IV	16	Ilex vomitoria 'Stokes Dwarf'/ Ilex	9" x 12", 18" O.C.	yes
NF	13	Nephrolepis exaltata/ Boston Fern	20" x 20", 24" O.C	yes
BA	15	Bambusa textilis gracilis/ Slender Weavers Bamboo	6' Ht, 5 stem min	no
PB	16	Philodendron 'Burle Marx'/ Burle Marx	16" x 16", 24" O.C.	no
CL	16	Clusia guttifera / Small leaf clusia	36" Ht.	No


Shredded Eucalyptus, Melaleuca or recycled mulch

	Landscape Legend			
	Zoning District: RPS-2 Lot Area: 2656.65 sf Acres: .06 AC			
		REQUIRED	/	
	OPEN SPACE	ALLOWED		PROV
A.	Square feet of required Open Space as indicated on site plan:			
	Lot Area = 2656.65 s.f.x 65% = 1726.8 sf	1726.8 sf		2075 sf
В.	Square feet of parking lot open space required as indicated on site plan:			
	Number of parking spaces 0 x 10 s.f. parking space =	0		0
C.	Total square feet of landscaped open space required: A+B=			2075 sf
	LAWN AREA CALCULATION			
A.	Square feet of landscaped open space required			
В.	Maximum lawn area (sod) permitted= 20 % x 1726.8 s.f.			0
	TREES			
A.	Number of trees required per lot or net lot acre, less existing number of			
	trees meeting minimum requirements=			
	22 trees x .06 net lot acres - number of existing trees=	2		3
B.	% Natives required: Number of trees provided x 30% =	1		2
C.	% Low maintenance / drought and salt tolerant required:			2
D.	Number of trees provided x 50%= Street Trees (maximum average spacing of 20' o.c.) 47.4 LF along street	1	$\dashv$	
υ.	divided by 20'=	3		2
E.	Street tree species allowed directly beneath power lines:		+	
	(maximum average spacing of 20' o.c.):			
	47.4 linear feet along street divided by 20'=	2		_
		3		2
	SHRUBS		-	
^				
Α.	Number of shrubs required: Sum of lot and street trees x 12 =	60	_	16
В.	% Native shrubs required: Number of shrubs x 50%=	30		41
			_	
۸	LARGE SHRUBS OR SMALL TREES		$\dashv$	
Α.	Number of large shrubs or small trees required: Number of required shrubs x 10%=	6		17
В.	% Native large shrubs or small trees required: Number of large shrubs or		Ţ	
	small trees provided x 50%=	3		3

# **General Notes:**

- 1. All plant material shall be Florida No. 1 or better as given in the current Florida Grades and Standards for Nursery Plants, 2015, Florida Department of Agriculture and Consumer
- 2. All plant materials shall be subject to inspection and approval by the Landscape Architect at place of growth and upon delivery for conformity to specification.
- 3. All plants shall be true to species and variety and shall conform to measurements specified.
- All substitutions shall be submitted to the City and Landscape Architect for final approval. 4. All plants shall be exceptionally heavy, symmetrical, tight knit and so trained in appearance as to be superior to form, branching and symmetry.
- 5. Contractor shall notify Sunshine 811 (call 811) for locations of existing utility lines 48 hours prior to beginning work. Contractor shall verify location of all utility lines and easements prior to commencing any work. Excavation in the vicinity of underground utilities shall be undertaken with care and by hand, if necessary. The Contractor bears full responsibility for this work and disruption or damage to utilities shall be repaired immediately at no expense to
- 6. Grade B+, shredded sterilized Eucalyptus mulch shall be used in all mass planting beds and for individual tree pits. All trees shall have a mulch ring with a depth of 3" and a diameter of 3'- 4' around their base. All mulch shall be kept 4" from base of all plant material. Mulch
- beds shall be a minimum of 12" wider than plants measured from outside edge of foliage. 7. Sod shall be St Augustine and free of weeds, insects, fungus and disease, laid with
- alternating and abutting joints. 8. All trees and shrubs shall be backfilled with a suitable planting soil consisting of 50 percent sand and 50 percent approved compost. All plant materials shall be planted with a minimum of 6 to 18 inches of planting soil around the root ball. Refer to planting details. Planting soil to be backfilled into plant pits by washing in. Planting beds shall be free from road, pea, egg
- or colored rock, building materials, debris, weeds, noxious pests and disease. 9. All sodded areas to have a minimum of 2" of planting soil as described in note #8.
- 10. All trees shall be warranted by the Contractor and will be healthy and in flourishing condition of active growth one year from date of final acceptance.
- 11. All shrubs, groundcovers, vines and sod shall be fully warranted for 90 days under same condition as above.
- 12. All synthetic burlap, synthetic string or cords or wire baskets shall be removed before any trees are planted. All synthetic tape shall be removed from trunks, branches, etc before inspection. The top 1/3 of any natural burlap shall be removed or tucked into the planting hole before trees are backfilled. Planting soil to be backfilled into pits by washing in.
- 13. All trees, palms and other plants shall be planted with the top of their rootballs no deeper than the final grade surrounding the planting area.
- 14. In areas where paved surfaces abut sod or mulch, the final level of both surfaces should be
- 15. All planting shall be installed with fertilizer at time of planting.
- 16. All planting shall be installed in a sound, workmanlike manner and according to good planting procedures. Installation shall include watering, weeding, fertilizing, mulching, selective pruning and removal of refuse and debris on a regular basis so as to present a neat and well kept appearance at all times.
- 17. All landscape and sod areas shall have an automatic irrigation system installed. Coverage should be 100% with 50% minimum overlap using rust free water to all landscape and sod areas. Spray upon public sidewalks, streets and adjacent properties should be minimized. Sodded areas and shrub/ groundcover beds should be on separate irrigation zones when feasible for a more efficient system. Irrigation system shall be installed with a rainswitch
- 18. All landscape and irrigation shall be installed in compliance with all local codes.
- 19. The plan shall take precedence over the plant list, should there be any discrepancy between

the two.

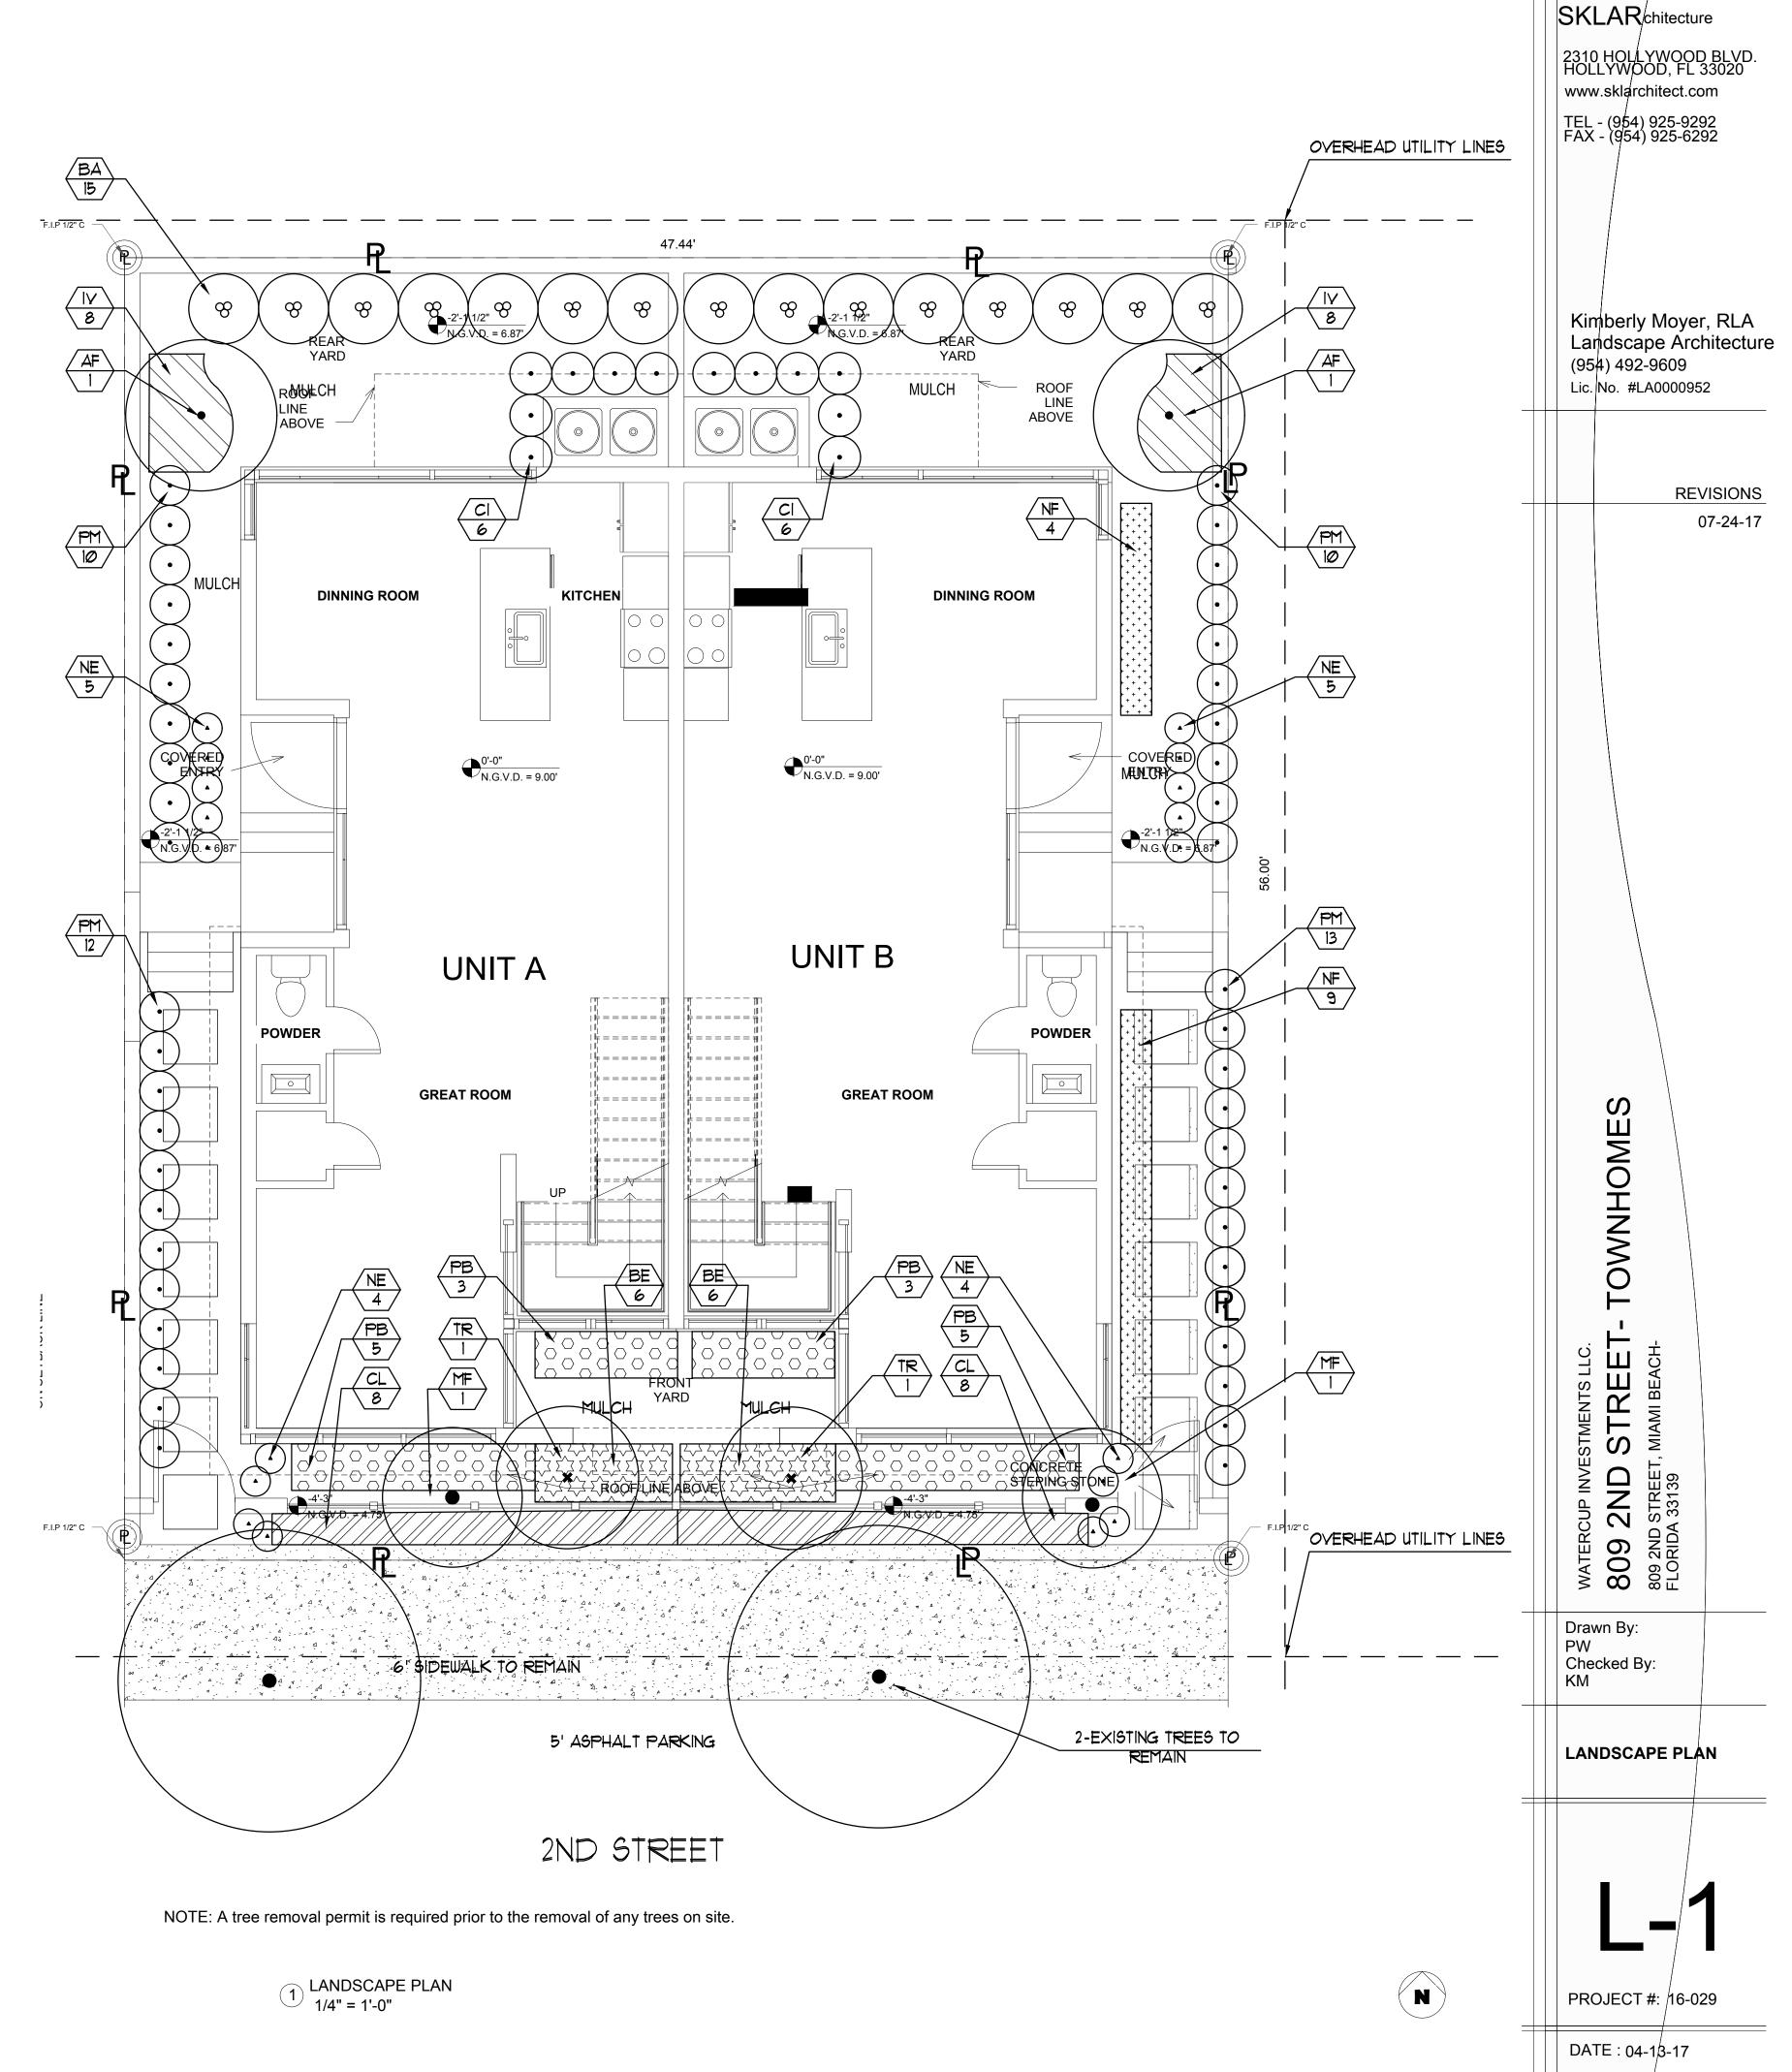

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REVISIONS

IND STREET, MIAMI BEACH-

Drawn By:
PW
Checked By:
KM

LANDSCAPE PLAN

809 2ND FLORIDA

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L-2

PROJECT #: 16-029

DATE : 04-13-17

# **Plant List**

I fall List							
Sym	Qty	Botanical/ Common Name	Size	Native			
AG	38	Arachis glabrata/ Rhizome Peanut	6" x 6"	No			
NE	16	Neoregelia 'Fireball/ Bromeliad	6" x 6"	No			
HC	5	Hohenbergia castellanosii/ Bromeliad	16" x 16"	No			
ZP	15	Zamia pumila/ Coontie	12" x 12"	Yes			
Boulde	ers 6	Artificial lightweight boulders 18"- 2' in length					
Mulch		Shredded Melaleuca or Eucalyptus					

47'-5" 37'-5" 5'-0" ROOF OVERHANG ON SETBACK LINE 3'-9" 37'-5" 1'-3" 3'-9" CABLE RAILING 11'-3" OPEN STAIRS DRONE PAD DRONE PAD  $-\!\!\!\!\!-$ ALUM. GATE  $-\!\!\!\!-$ ALUM. GATE CONC. BLOCK 6'-6" PARAPET - CONC. BLOCK PARAPET TRELLIS ABOVE ABOVE ROOF DECK ROOF DECK ARTIFICIAL BOULDER CONC. EYEBROW CONC. EYEBROW -18'-8" 18'-9"

NOTE: SEE SHEET L-1 FOR PLANTING NOTES & DETAILS NOTE: ROOF TOP GARDEN TO HAVE AUTOMATIC IRRIGATION SYSTEM

2 ROOF LANDSCAPE PLAN 1/4" = 1'-0"

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