

GENERAL PLANTING NOTES AND SPECIFICATIONS:

. EXISTING TREES DESIGNATED TO REMAIN SHALL BE PROTECTED 1. BARRICADE SHALL BE GALVANIZED AND WELDED WIRE FABRIC: 1X1" DURING ALL CONSTRUCTION PHASES. ANY TREES DESIGNATED TO MESH .063, 48" IN HEIGHT RECOMMENDED CONTACT: REMAIN WHICH ARE SCARRED OR DESTROYED WILL BE REPLACED AT THE Wire Cloth Man CONTRACTOR'S EXPENSE, WITH SIMILAR SPECIES, SIZE AND QUALITY.

2. EXISTING TREES DESIGNATED TO BE STORED OFF-SITE, SHALL BE PH: 1.888.947.3256 PROTECTED AND CARED FOR ACCORDING TO INDUSTRY STANDARD. FX: 727.524.4000 ANY TREES OR SHRUBS SCARRED OR DESTROYED WILL BE REPLACED AT THE CONTRACTOR'S EXPENSE, WITH SIMILAR SPECIES, SIZE AND QUALITY.

B.LANDSCAPE CONTRACTOR SHALL BECOME FAMILIAR WITH ALL 3. ACCESS: PROVIDE HINGED, LATCHING GATE. UNDERGROUND UTILITIES OR STRUCTURES PRIOR TO DIGGING. 4. METAL GATE: SHALL PERMIT FREE PASSAGE OF WATER, AIR AND SHALL LANDSCAPE CONTRACTOR SHALL REPAIR ALL DAMAGE TO UTILITIES, ACCEPT CONSTRUCTION TRAFFIC WITHOUT EXCESSIVE DEFLECTION. AND/OR CONSTRUCTION CAUSED BY CONSTRUCTION OR DIGGING, AT NO COST TO THE OWNER.

MONTHS AFTER DATE OF SUBSTANTIAL COMPLETION.

5.LANDSCAPE CONTRACTOR SHALL VERIFY ALL ESTIMATED QUANTITIES LANTING PLAN TO TAKE PRECEDENCE OVER PLANT LIST.

. EXISTING PLANT MATERIAL NOT SHOWN ON THE PLAN AND IN CONFLICT WITH NEW PLANTING SHALL BE EVALUATED AT THE TIME OF

NEW PLANTING INSTALLATION BY THE LANDSCAPE ARCHITECT. , ALL BUILDING CONSTRUCTION MATERIAL AND FOREIGN MATERIAL SHALL BE REMOVED FROM PLANTING AREAS AND REPLACED WITH 80/20 ARCHITECT PRIOR TO PROCUREMENT, PREPARATION OR INSTALLATION. MIX FILL SOIL, OR AS PER SPECIFICATIONS. ALL ISLANDS IN PARKING LOTS AND AROUND BUILDINGS, SHALL BE EXCAVATED TO A DEPTH OF 3' MIN. AND REPLACED WITH 80/20 PLANT MIX, OR AS PER SPECIFICATIONS.

3. ALL PLANT MATERIAL SYMBOLS SHOWN ON LANDSCAPE PLAN SHALL FIELD BY CONTRACTOR TO AVOID ALL UTILITIES AND ALL OTHER OF THE LANDSCAPE ARCHITECT IMMEDIATELY, PRIOR TO PREPARATION. OBSTRUCTIONS AFTER CONSULTING THE LANDSCAPE ARCHITECT.

). ALL SIZES SHOWN FOR PLANT MATERIAL ON THE PLAN AND PLANT LIST ARE TO BE CONSIDERED MINIMUM. ALL PLANT MATERIAL MUST MEET OR EXCEED THESE MINIMUM REQUIREMENTS FOR BOTH HEIGHT AND SPREAD. ANY OTHER REQUIREMENTS FOR SPECIFIC SHAPE OR EFFECT AS NOTED ON THE PLAN SHALL ALSO BE REQUIRED FOR ACCEPTANCE. ALL TREES TO HAVE SINGLE TRUNK, UNLESS OTHERWISE NOTED ON THE PLANS OR PLANT LIST.

0. SITE PREPARATION SHALL INCLUDE THE ERADICATION AND REMOVAL OF ANY WEEDS AND/OR GRASS, AS WELL AS CLEAN-UP OF ANY DEAD MATERIAL AND FINISH GRADING AS PER THE SPECS.

I. THE LANDSCAPE CONTRACTOR SHALL AT ALL TIMES KEEP THE JOB SITE CLEAN AND FREE FROM ACCUMULATION OF WASTE MATERIAL, CERTIFIED ARBORIST. DEBRIS, AND RUBBISH.

ANY NEW HARDSCAPE CONSTRUCTION OR IRRIGATION. ANY DAMAGE REVIEWED AND APPROVED BY LANDSCAPE ARCHITECT PRIOR TO PRUNING. SHALL BE REPLACED OR REPAIRED TO THE ORIGINAL STATE BY THE 7. DEAD WOOD, CROSSING BRANCHES, AND GENERAL CANOPY PRUNING SHALL LANDSCAPE CONTRACTOR AT NO ADDITIONAL COST TO THE OWNER.

FOR NURSERY PLANTS PART I AND II".

4. MULCH ALL PLANTING AREAS WITH SHREDDED ORGANIC MULCH TO A TO PRUNING. MINIMUM DEPTH OF 2". WITH THE EXCEPTION OF BEACH PLANTING. 5. ALL PLANTING AREAS WITHIN LIMIT OF WORK SHALL BE 100% FULLY IRRIGATED. THE IRRIGATION CONTRACTOR AWARDED THE BID SHALL

6. ON-SITE LAYOUT OF PLANT MATERIAL MUST BE COORDINATED WITH THE LANDSCAPE ARCHITECT PRIOR TO INSTALLATION. L.A. TO BE GIVEN A MIN. OF (1) WEEK NOTICE TO REVIEW PRIOR TO IMPLEMENTATION.

COMPLY WITH THE PROPOSED IRRIGATION DESIGN.

7. LANDSCAPE CONTRACTOR TO INCLUDE REMOVAL, CORRECTIVE 13/4"-2" HALL BE PERFORMED OR DIRECTED BY AN ISA OR ASCA CERTIFIED ARBORIST IN ACCORDANCE WITH MIAMI DADE COUNTY CODE, ANSI A-300 PART1) PRUNING STANDARDS AND OR AN ISSUED ERM TREE OR NVIRONMENTAL PERMIT.

8. TREE PROTECTION BARRIERS MUST BE INSTALLED AT THE DRIP LINES START OF CONSTRUCTION ACTVITIES ONSITE AND SHALL REMAIN IN PLACE UNTIL CONSTRUCTION HAS COMPLETED

19. MULCH SHALL NOT BE APPLIED WITHIN 6" OF ANY TREE OR PALM FOR ROW TREES/PALMS PLEASE UTILIZE AMERIGROW (PREMIUM USED WITHIN THE HORTICULTURAL INDUSTRY, IN TWO COMPLETE LAYERS. PINEBARK BROWN) SHREDDED MULCH OR A CITY APPROVED 10. ALL TREES TO BE FLOODED FOR FIVE (5) DAYS PRIOR TO TRANSPLANT. ALTERNATIVE.

20. SHOULD ANY CORRECTIVE STRUCTURAL PRUNING BE NECESSARY LIFTS/LAYERS, EACH THEN COMPACTED BEFORE A SUBSEQUENT 18" LIFT/LAYER FOR TREES PROPOSED TO REMAIN ON SITE, DUE TO CLEARANCE, IS PLACED. REPEAT UNTIL BACKFILL IS FLUSH WITH SURROUNDING GRADE. SAFETY OR FOR CONSTRUCTION RELATED REASONS THE PRUNING SHALL BE PERFORMED OR DIRECTED BY AN ISA OR ASCA CERTIFIED ARBORIST IN ACCORDANCE WITH THE LATEST VERSION IF THE ANSI A-300 URBAN FORESTER SHALL BE PROVIDED WITH A WRITTEN COPY OF THE RESIDUAL ROOTS, STUMPS AND PORTIONS AND PARTS THEREOF. NECESSARY, PRIOR TO THE PRUNING ACTIVITIES TAKING PLACE.

FRENCHING THROUGH EXISTING TREE OR PALM DRIPLINES OF TREES 14. LANDSCAPE CONTRACTOR IS RESPONSIBLE FOR ALL MATERIAL INCLUDING SLATED TO REMAIN IN PLACE OR BE RELOCATED. IF CONSTRUCTION BUT NOT LIMITED TO BACKFILL MATERIAL, PROTECTION FENCING, FLAGGING, REQUIRES THE CUTTING OF ANY ROOTS WITH A DIAMETER OF 2" OR ROOT BALL BURLAP OR SHRINK WRAP. GREATER, ROOTS SHALL BE CLEANLY CUT WITH A SHARP TOOL, AS DIRECTED BY AN ISA CERTIFIED ARBORIST, AND IN ACCORDANCE WITH THE ANSI A-300 STANDARDS. CUT ROOTS SHOULD BE IMMEDIATELY SHOULD BE CONSULTED PRIOR TO ANY ROOT PRUNING TAKING PLACE .

HANDLING AND TRANSPORTATION

. TREES/PALMS SHALL BE PROPERLY HANDLED DURING EXCAVATION, 2. LANDSCAPE CONTRACTOR TO FLAG ALL PROPOSED PLANT LOCATIONS FOR MOVING, STORAGE, RELOCATION, AND REPLANTING. DO NOT SCAR OR LANDSCAPE ARCHITECT'S APPROVAL PRIOR TO INSTALLATION. OTHERWISE DAMAGE TRUNKS AND BRANCHES, AND AVOID BREAKING LIMBS, BRANCHES, AND FRONDS. DAMAGE TO TREE/PALM MAY BE CAUSE FOR ITS REJECTION, AND MAY REQUIRE MITIGATION REPLACEMENT.

FINAL ACCEPTANCE OF ALL WORK BY THE LANDSCAPE ARCHITECT FLUSH WITH IMMEDIATELY ADJACENT FINAL OR PROPOSED GRADE. AND/OR CLIENT.

AND MAINTAINING TREE/PALM PROTECTION. INSTALL BARRICADE OF GALVANIZED WELDED WIRE FABRIC OR PLASTIC MESH TO ENCOMPASS HE DRIPLINE OF THE TREE/PALM. BARRICADE SHALL BE PLUMB, TAUT, AND STURDY, BARRICADE TO BE LEFT UP AND MAINTAINED UNTIL DIRECTED TO REMOVE BY LANDSCAPE ARCHITECT.

TREE PROTECTION MATERIALS

7158 123rd Circle N. Largo, FL 33773

2. POSTS & RAIL: METAL POST, SUFFICIENT TO HOLD FABRIC PLUMB AND TAUT

4. ALL PLANT MATERIALS SHALL BE GUARANTEED FOR A PERIOD OF 12 👚 1. LANDSCAPE CONTRACTOR SHALL PROVIDE A MINIMUM OF ONE (1) YEAR GUARANTEE FOR ALL RELOCATED TREES/PALMS AFTER FINAL ACCEPTANCE BY LANDSCAPE ARCHITECT AND/OR CLIENT.

OF MATERIAL SHOWN ON THE DRAWINGS PRIOR TO SUBMITTING HIS BID. 2. LANDSCAPE CONTRACTOR SHALL REMOVE COMPLETELY AND DISPOSE OF OFF-SITE, ANY RELOCATED TREE/PALM THAT FAILS TO THRIVE AS DETERMINED BY THE LANDSCAPE ARCHITECT.

> 3. FOR ANY RELOCATED TREE/PALM REMOVED DUE TO ITS FAILURE TO THRIVE LANDSCAPE CONTRACTOR SHALL BE RESPONSIBLE FOR REPLACING AND INSTALLING WITH A SPECIMEN OF EQUAL OR GREATER SPECIFICATION OF ORIGINAL. REPLACEMENT MATERIAL SHALL BE APPROVED BY LANDSCAPE

TREE / PALM RELOCATION NOTES

DRAWINGS AND THOSE TAGGED IN THE FIELD CORRESPOND AS TO NUMBER BE CONSIDERED DIAGRAMMATIC AND SHOULD BE ADJUSTED IN THE AND DESCRIPTION. ANY DISCREPANCIES SHALL BE BROUGHT TO THE ATTENTION

> LANDSCAPE CONTRACTOR SHALL BE RESPONSIBLE FOR TREE/PALM PROTECTION OF ALL VERIFIED MATERIAL. INSTALL BARRICADE OF GALVANIZED WELDED WIRE FABRIC OR PLASTIC MESH TO ENCOMPASS THE DRIPLINE OF THE TREE/PALM. BARRICADE TO BE REMOVED WHEN DIRECTED BY LANDSCAPE

> 3. TREE ROOT BALL SHALL BE ROOT PRUNED 50% (EQUALLY AROUND TREE) 60 DAYS PRIOR TO TRANSPLANT. THE REMAINING 50% TO BE PRUNED 30 DAYS PRIOR TO TRANSPLANTING.

4. PALMS TO BE RELOCATED MAY BE IMMEDIATELY RELOCATED AFTER DIGGING. 5. ROOTS TO BE PRUNED WITH CLEAN, SHARP TOOLS. ROOTS ONE (1) INCH AND LARGER IN DIAMETER SHALL BE NEATLY AND CLEANLY CUT WITH A HAND SAW OF OTHER APPROVED CUTTING IMPLEMENT AS DIRECTED BY AN ISA OR ASCA

6. LANDSCAPE CONTRACTOR TO APPLY MYCORRHIZA APPLICATION TO ROOTS 12. THE LANDSCAPE CONTRACTOR SHALL EXERCISE CAUTION TO PROTECT DURING ROOT PRUNING AND DIGGING OPERATIONS. ALL PRUNING TO BE

BE PERFORMED OR DIRECTED BY AN ISA OR ASCA CERTIFIED ARBORIST IN 3. ALL PLANT MATERIAL TO BE FLORIDA #1 OR BETTER, AS DEFINED BY ACCORDANCE WITH THE LATEST VERSION OF THE ANSI A-300 PRUNING THE FLORIDA DEPARTMENT OF AGRICULTURE'S "CODES AND STANDARDS STANDARDS AND GOOD HORTICULTURAL PRACTICES IMMEDIATELY AFTER COMPLETION OF ROOT PRUNING OF EACH SPECIMEN TO BE RELOCATED. ALL PRUNING TO BE REVIEWED AND APPROVED BY LANDSCAPE ARCHITECT PRIOR

> 8. ROOT BALL SIZE TABLE: (NOTE: ROOT BALL SIZES SHALL EXCEED MINIMUM STANDARDS SET FORTH IN "GRADES AND STANDARDS FOR NURSERY PLANTS, PART II, PALMS AND TREES,

FLORIDA DEPARTMENT OF AGRICULTURE") MINIMUM ROOT BALL DIAMETER

5" - 5 1/2"

THE ROOT BALL OF LARGER CALIPER SIZES SHALL BE INCREASED OF ALL TREES AND PALMS TO REMAIN OR BE RELOCATED PRIOR TO THE PROPORTIONALLY AT THREE (3) INCHES OF ROOT BALL DIAMETER FOR EVERY INCREASE OF ONE (1) INCH IN CALIPER OR FRACTION THEREOF.

9, MAINTAIN COMPACT ROOT BALLS, ROOT BALLS SHALL BE COMPLETELY TRUNKS THAT ARE INSTALLED OR INCORPORATED INTO THE PROJECT.

ENCLOSED WITHIN A BURLAP COVERING OR STRETCH WRAP AS COMMONLY

11. ALL PITS TO BE FILLED THE SAME DAY AND WITH CLEAN FILL IN 18 INCH

2. CORRECT ALL PROBLEMS RELATED TO SETTLEMENT, EROSION, OR OTHER DISTRESS OF EXCAVATED/BACKFILLED PIT FROM WHICH TREE/PALM HAS BEEN PRUNING STANDARDS AND GOOD HORTICULTURAL PRACTICES. THE CITY

REMOVED, INCLUDING THE COMPLETE AND THROUGH REMOVAL OF ALL

PROPOSED PRUNING PLAN INCLUDING THE REASONS WHY PRUNING IS 13. RESTORE THE SURFACE WITH MATERIAL TO MATCH ADJACENT AREAS. MATERIAL TO BE APPROVED BY LANDSCAPE ARCHITECT. CONTRACTOR TO I. CARE SHALL BE TAKEN TO AVOID UTILITY OR CONSTRUCTION PROVIDE A MINIMUM ONE YEAR WARRANTY ON SETTLING AND PLANT MATERIAL.

COVERED WITH SOIL TO PREVENT DRYING. ROOTS SHOULD NOT BE 1. VERIFY ALL UNDERGROUND CONSTRUCTIONS OR OBSTRUCTIONS (UTILITIES, FORN OR BROKEN BY HEAVY EQUIPMENT. SHREDDED, RAGGED OR SEPTIC SYSTEMS, ETC.) ARE IDENTIFIED, LOCATED AND CLEARLY MARKED AS BROKEN ROOTS ENDS SHOULD BE NOTED IN WRITING AND AN ARBORIST APPROPRIATE PRIOR TO EXCAVATION OF PLANTING PITS FOR RELOCATED TREES AND PALMS. ANY UNKNOWN OBJECTS SHALL BE BROUGHT TO THE ATTENTION OF THE LANDSCAPE ARCHITECT IMMEDIATELY, PRIOR TO INSTALLING AND BACKFILLING

3. PLANTING PITS SHALL BE A MINIMUM OF TWO (2) TIMES LARGER IN DIAMETER


AND ONE AND A HALF (1-1/2) TIMES LARGER IN DEPTH THAN THE ROOT BALL ROUGHEN SIDES AND BOTTOM OF PIT. . CONTRACTOR SHALL BE RESPONSIBLE FOR THE MANUAL WATERING 4. AFTER EACH PLANTING PIT IS EXCAVATED, PLACE SUFFICIENT PLANTING MIX IN OF ALL RELOCATED TREES/PALMS DURING MAINTENANCE PERIOD, UNTIL BOTTOM OF EXCAVATION, AND SEAT PLANT, INSURING TOP OF ROOT BALL IS

5. LANDSCAPE CONTRACTOR TO INSURE ALL PLANT MATERIAL IS INSTALLED AT 3. LANDSCAPE CONTRACTOR SHALL BE RESPONSIBLE FOR INSTALLING THE CORRECT ELEVATION, REFER TO GRADING PLAN. 6. LANDSCAPE CONTRACTOR TO INSURE ALL ROOT FLARES ARE EXPOSED.

> 7. CENTER EACH RELOCATED TREE/PALM IN ITS PLANTING PIT AND BACKFILL WITH SPECIFIED PLANTING MIX. 8. PLACE PLANTING MIX IN 12 INCH LIFTS/LAYERS AROUND ROOT BALL AND

EACH PLANTING PIT TO FORM WATERING BASIN. MULCH TO A DEPTH OF 3".

COMPACT UNTIL ALL VOIDS ARE FILLED WITH COMPACTED PLANTING MIX. 9. BUILD SOIL SAUCER OF MOUNDED EXCAVATED SOIL AROUND PERIMETER OF

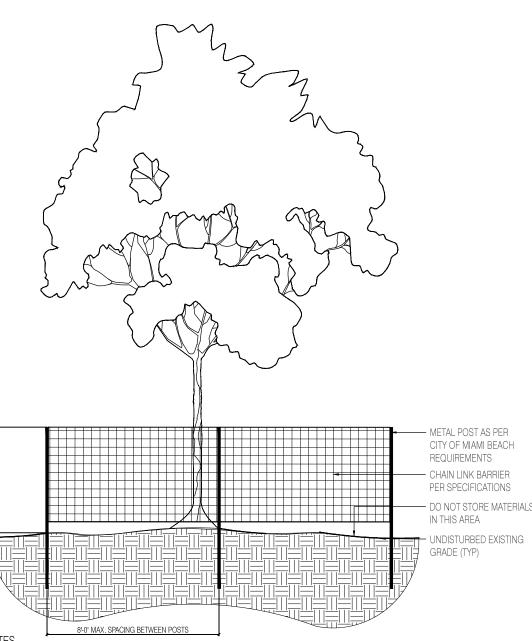

1.) THE TREE PROTECTION BARRICADE SHALL BE INSTALLED PER CITY OF MIAMI BEACH CODE CHAPTER 46, AND WILL BE AT LEAST FOUR (4) FEET HIGH. THE BARRIER SHALL BE CONSTRUCTED OF CONTINUOUS CHAIN LINK FENCE WITH METAL POSTS AT (8) FOOT SPACING, OR OF 2X4 POSTS WITH THREE EQUALLY SPACED 2X4 RAILS. POSTS MAY BE SHIFTED TO AVOID ROOTS.

2,) THE BARRIER SHALL BE PLACED AT THE DRIP LINE OF EACH TREE OR PRESERVATION AREA, AND IN NO CASE LESS THAN 10' FROM THE TRUNK OF ANY PROTECTED TREE, FOR ANY DISCREPANCIES RELATED TO PLACEMENT OF THE BARRIER, THE CITY'S URBAN FORESTER SHOULD BE CONTACTED FOR APPROVAL.

C.O.M.B. TREE PROTECTION DETAIL

4.) TREE BARRICADE APPROVAL: OBTAIN CITY APPROVAL OF TREE BARRICADES BEFORE BEGINNING CLEARING OPERATIONS OR ANY SITE DEVELOPMENT.

COVER 10 GAUGE WIRE. 3.) HAND WORK ONLY WITHIN TREE BARRICADES

- POLYPROPYLENE OR CINCH TIES. TYP.

- STAKE - 2" DIA. PRESSURE TREATED

LODGE POLE, HEIGHT AS SPECIFIED.

(NOTE: TOP OF STAKES SHALL BE

- 2" DEPTH MULCH ON ROOT BALL.

4" WATER RING - (WITHIN ROOT BALL

PLANTING RAKE OUT PRIOR TO

MULCHING AND PLANTING.

ROOT FLARE 1" - 2" ABOVE

FINISHED GRADE.

APPLICATION:

CALIPER

2" MULCH

SMALL TREE PLANTING AND STAKING DETAIL

DIA.), FILL 3 TIMES IMMEDIATELY AFTER

- ROOTBALL: LOOSEN AND REMOVE BURLAP

AND WIREFROM TOP OF ROOT BALL

TO $\frac{1}{2}$ OF THE DEPTH. REMOVE ALL

BURLAP IF NOT 100% BIODEGRADABLE

BACKFILL: TOP SOIL TYPICAL OF AREA.

FERTILIZER AND COMPOST AS REQUIRED.

(BACKFILL SHALL BE AMENDED THROUGHOUT ENTIRE SITE W/

1.) FOR SMALL TREES UP TO AND INCLUDING 2.5"

SPACE PLANTS FROM EDGE SO

THAT MATURE PLANTS WILL NO

OVERLAP ONTO SIDEWALK AREA

-VARIES WITH PLANT SPECIES

EXCAVATE TO ROOT BALL DEPTH

SPECIFIED PLANTING MIX

EXISTING SOIL OR APPROVED

SPECIFIED GROUNDCOVER

REMOVE AND RECYCLE POT

PLUS 4 INCHES

BACKFILL

FASTEN IN FIGURE 8.

BELOW CANOPY, TYP.).

1.) SET TREE PLUMB IN PLANTING PIT. 2.) PROTECT TREE TRUNK WITH 1 NOMACO ® STYROFOAM PADDING GUARDS, #6U048048. AS SPECIFIED, OR APPROVED EQUAL. 3.) AMAZON HOUSE AND RUBBER ®. 1 ½ AIR HOSE #K1146 OR APPROVED EQUAL, TO

4.) 1 10 GAUGE GALVANIZED WIRE. WIRE PRODUCT ®, OR APPROVED EQUAL. 5.) 1 2" X 4" X 4' NON TREATED LANDSCAPE TIMBER AS SPECIFIED. FASTEN WITH 4 3 2" DECK SCREWS TO 2" X 4" X 8' P.T. LANDSCAPE TIMBERS 6.) 1 $\frac{1}{8}$ MALLEABLE CLAMP FASTENER FOR WIRE. 13.) UNDISTURBED SUBGRADE. SUPPLIER: FLORIDA WIRE ® OR APPROVED EQUAL. 2 MEDIUM TREE PLANTING & STAKING DETAIL
SCALE: N.T.S

8.) 2" MULCH DEPTH LAYER ON ROOT BALL. 9.) 4" WATER RING, (WITHIN ROOTBALL DIA.), FILL 3 TIMES IMMEDIATLEY AFTER PLANTING, RAKE OUT PRIOR RO MULCHING AND PLATING. 10.) ROOT FLARE 1"-2" ABOVE FINISHED GRADE. 11.) B&B OR CONTAINERIZED ROOTBALL, REMOVE

ALL BURLAP IF NOT 100% BIODEGRADABLE. REMOVE CONTAINER FROM ROOTBALL PRIOR TO PLANTING. 12.) BACKFILL, TOP SOIL TYP, OR AREA, BACKFILI SHALL BE AMENDED THROUGHOUT ENTIRE SITE WITH FERTILIZER AND COMPOST AS REQUIRED.

5'-0" ABOVE GRADE

3'-0" BELOW GRAD

BASE OF LEAF BUD

7.) 2 2" X 4" X 8' PT. LANDSCAPE TIMBER AS SPECIFIED. 14.) COMPACT SOIL IMMEDIATELY BENEATH THE ROOT BALL TO PREVENT SETTLING.

> 1.) CONTRACTOR TO ASSURE PERCOLATION IN TREE PITS.

2.) NO MULCH WITHIN 4" OF TRUNK.

(3) 2"X4" WOOD BRACES

6" COMPACTED SOIL SAUCER

TO HOLD WATER

2"X4"x30" TREE STAKE

NATIVE SOIL BACKFILL OR AMENDED PLANTING SOIL

TRAIN VINE ON TO FENCE / TRELLIS

AS REQUIRED BY SOIL

FINAL GRADE

ANALYSIS

LINING

LARGE TREE PLANTING AND STAKING DETAIL

SPECIFICATION

SPACED 120-DEGREES O.C. & PAINTED BLACK (SEE NOTES BELOW)

- 2" DEPTH MULCH LAYER- REFER TO

PALM PLANTING AND STAKING DETAIL

BASE OF LEAF BUD

PLANTING

RECIEVING

1.) PALMS OVER 30' GW HEIGHT, USE MINIMUM (4) 4X4 BRACING AND STAKES.

7.) AMENDED SOIL MIX, TO BE ADDED AT THE TIME OF PLANTING IF NEEDED,

SHALL CONSIST OF A RATIO MIX OF 80% CLEAN SILICA SAND AND 20% SCREENED,

4.) BUD SHALL BE PERPENDICULAR TO THE GROUND PLANE.

5.) TRUNK SHALL BE STRAIGHT AND WITHOUT CURVES.

2.) PRIMARY STAKES SHOULD PLACED PARALLEL TO WALKWAYS WHENEVER POSSIBLE


3.) RECEIVING PLANTING HOLE SHALL BE APPROXIMATELY 1/3 LARGER THAN ROOTBALL

ROOT BALL


PLANTING HOLE


6.) NO SCARRED OR BLACKENED TRUNKS.

PULVERIZED TOPSOIL AS NEEDED.

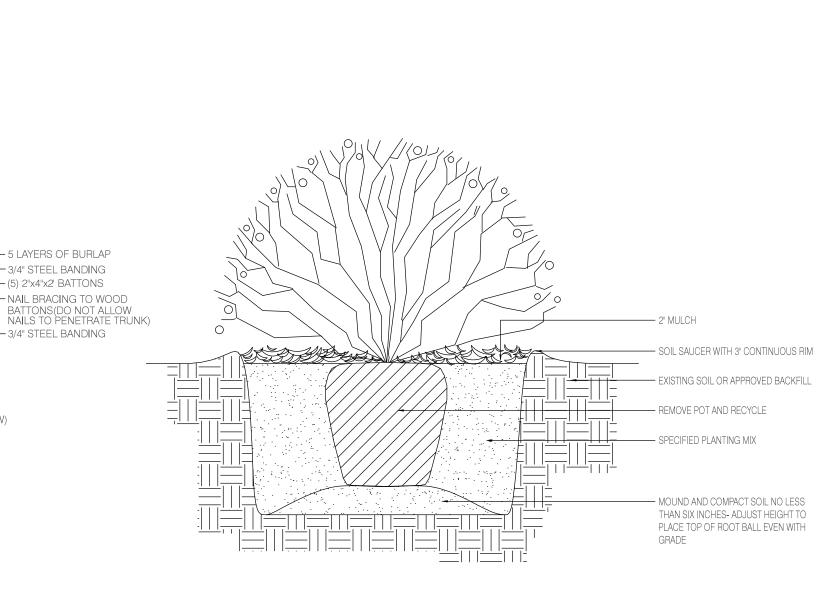

6 SHRUB PLANTING DETAIL

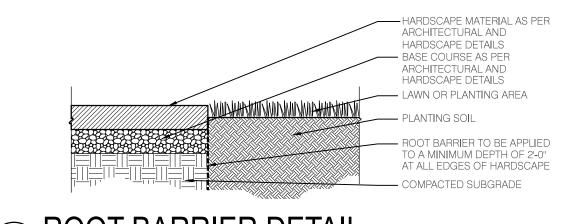

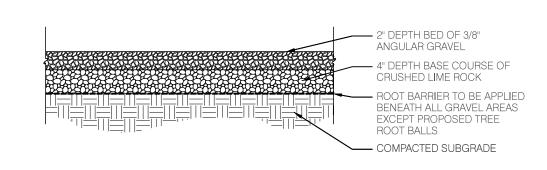

GRAVEL BED DETAIL

CORAL GABLES, Florida 33134 www.dnbdesigngroup.com NAIL BRACING TO WOOL

3/4" STEEL BANDING

(5) 2"x4"x2" BATTONS

- 3/4" STEEL BANDING

(3) 2"X4" WOOD BRACES

- 6" COMPACTED SOIL SAUCER

NATIVE SOIL BACKFILL OR

AMENDED PLANTING SOIL

AS REQUIRED BY SOIL

SPECIFICATION

TO HOLD WATER

- III- III- FINAL GRADE

2"X4"x30" TREE STAKE

ANALYSIS

& PAINTED BLACK (SEE NOTES BELOW)

2" DEPTH MULCH LAYER- REFER TO

6881 INDIAN CREEK HOTEL RENOVATIONS

6881 INDIAN CREEK

MIAMI, FLORIDA

370 MIRACLE MILE

Tel. 305.444.5545

Fax. 305.444.5509

OWNER

MIAMI, FL

DNB PROJECT NUMBER 17-128

OWNER'S PROJECT NUMBER

ISSUED FOR: DRB FINAL SUBMITT

TYPE OF DOCS:

CONSTRUCTION

No.	DATE	REVISION	BY

G.G, F.M A.A, P.A DATE: SCALE: 08.03.17 AS SHOWN CONSULTANTS:

Landscape Architect

naturalficial, inc

6915 Red Road Suite 224 Coral Gables FL 33143 Firm# LC26000548 P 786 717 6564 naturalficial.com

PETER N. ANSELMO R.L.A. FL# 6667221

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GENERAL PLANTING **DETAILS & SPECIFICATIONS**

SHEET NUMBER L-3.20

GROUNDCOVER PLANTING DETAIL

1.) PRUNING: REMOVE ANY BROKEN BRANCHES.

3) USE THREE LODGE POLES FOR ADDED STABILITY.

2) NO MULCH WITHIN 4" OF TRUNK, TYP.

TOP OF MULCH SHALL BE 1" -


BELOW PAVEMENT

1.) SEE PLANTING PLAN FOR SPACING.

PROVIDE 2, 2" X 4" X 4' TEMPORARY STAKES WITH 3. 1" X 2" HORIZONTAL MEMBERS @ EACH PLANT (PAINT GREEN) COPING (COORDINATE 2" MULCH -WITH ARCHITECT REINFORCED CONCRETE -WALL (COORDINATE W/ STRUCTURAL ENGINEER) BUILDING FACADE PLANTING MIX AS -(COORDINATE W/ SPECIFIED ARCHITECT) PLANTER DRAINAGE -LINING 6" GRAVEL -- WATERPROOF PLANTER

VINE PLANTING DETAIL

DRAINAGE SYSTEM

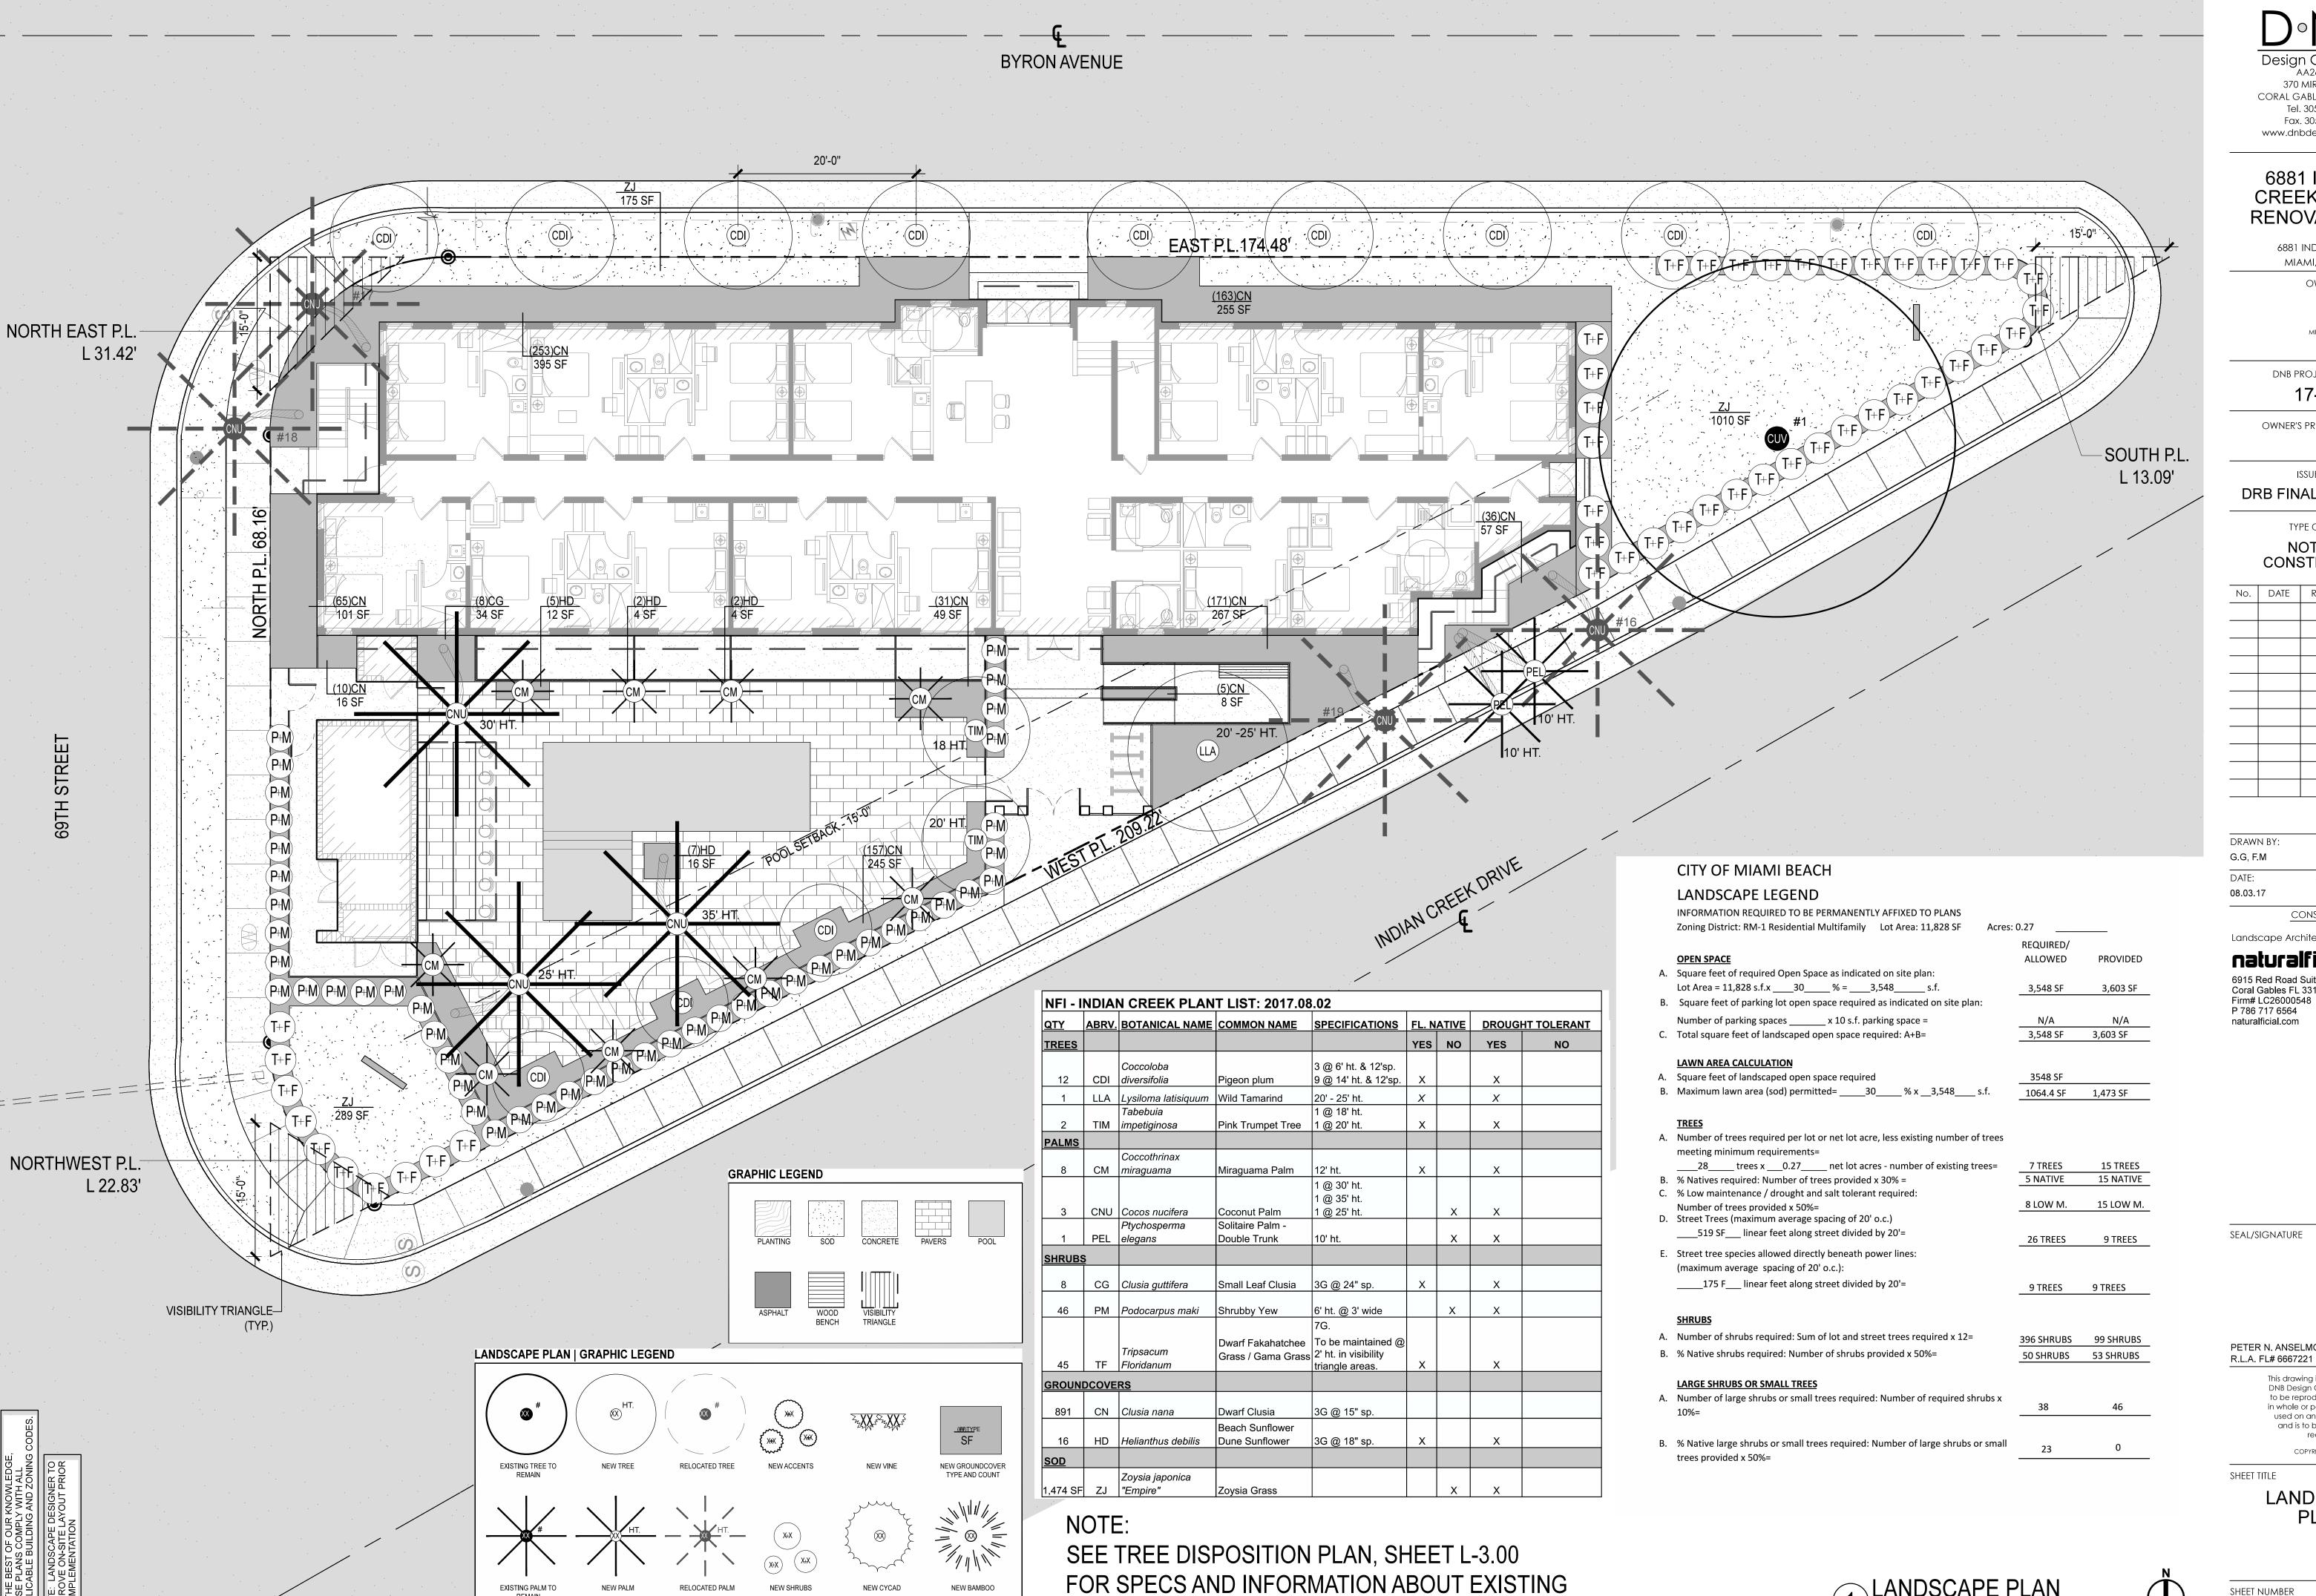

TREES AND PALMS.

370 MIRACLE MILE CORAL GABLES, Florida 33134 Tel. 305.444.5545 Fax. 305.444.5509 www.dnbdesigngroup.com

6881 INDIAN CREEK HOTEL RENOVATIONS

6881 INDIAN CREEK MIAMI, FLORIDA

MIAMI, FL

DNB PROJECT NUMBER 17-128

OWNER'S PROJECT NUMBER

ISSUED FOR:

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DRAWN BY: APPROVED BY: G.G, F.M A.A, P.A DATE: 08.03.17 AS SHOWN

Landscape Architect

naturalficial, inc.

CONSULTANTS:

6915 Red Road Suite 224 Coral Gables FL 33143 Firm# LC26000548 P 786 717 6564 naturalficial.com

SEAL/SIGNATURE

PETER N. ANSELMO

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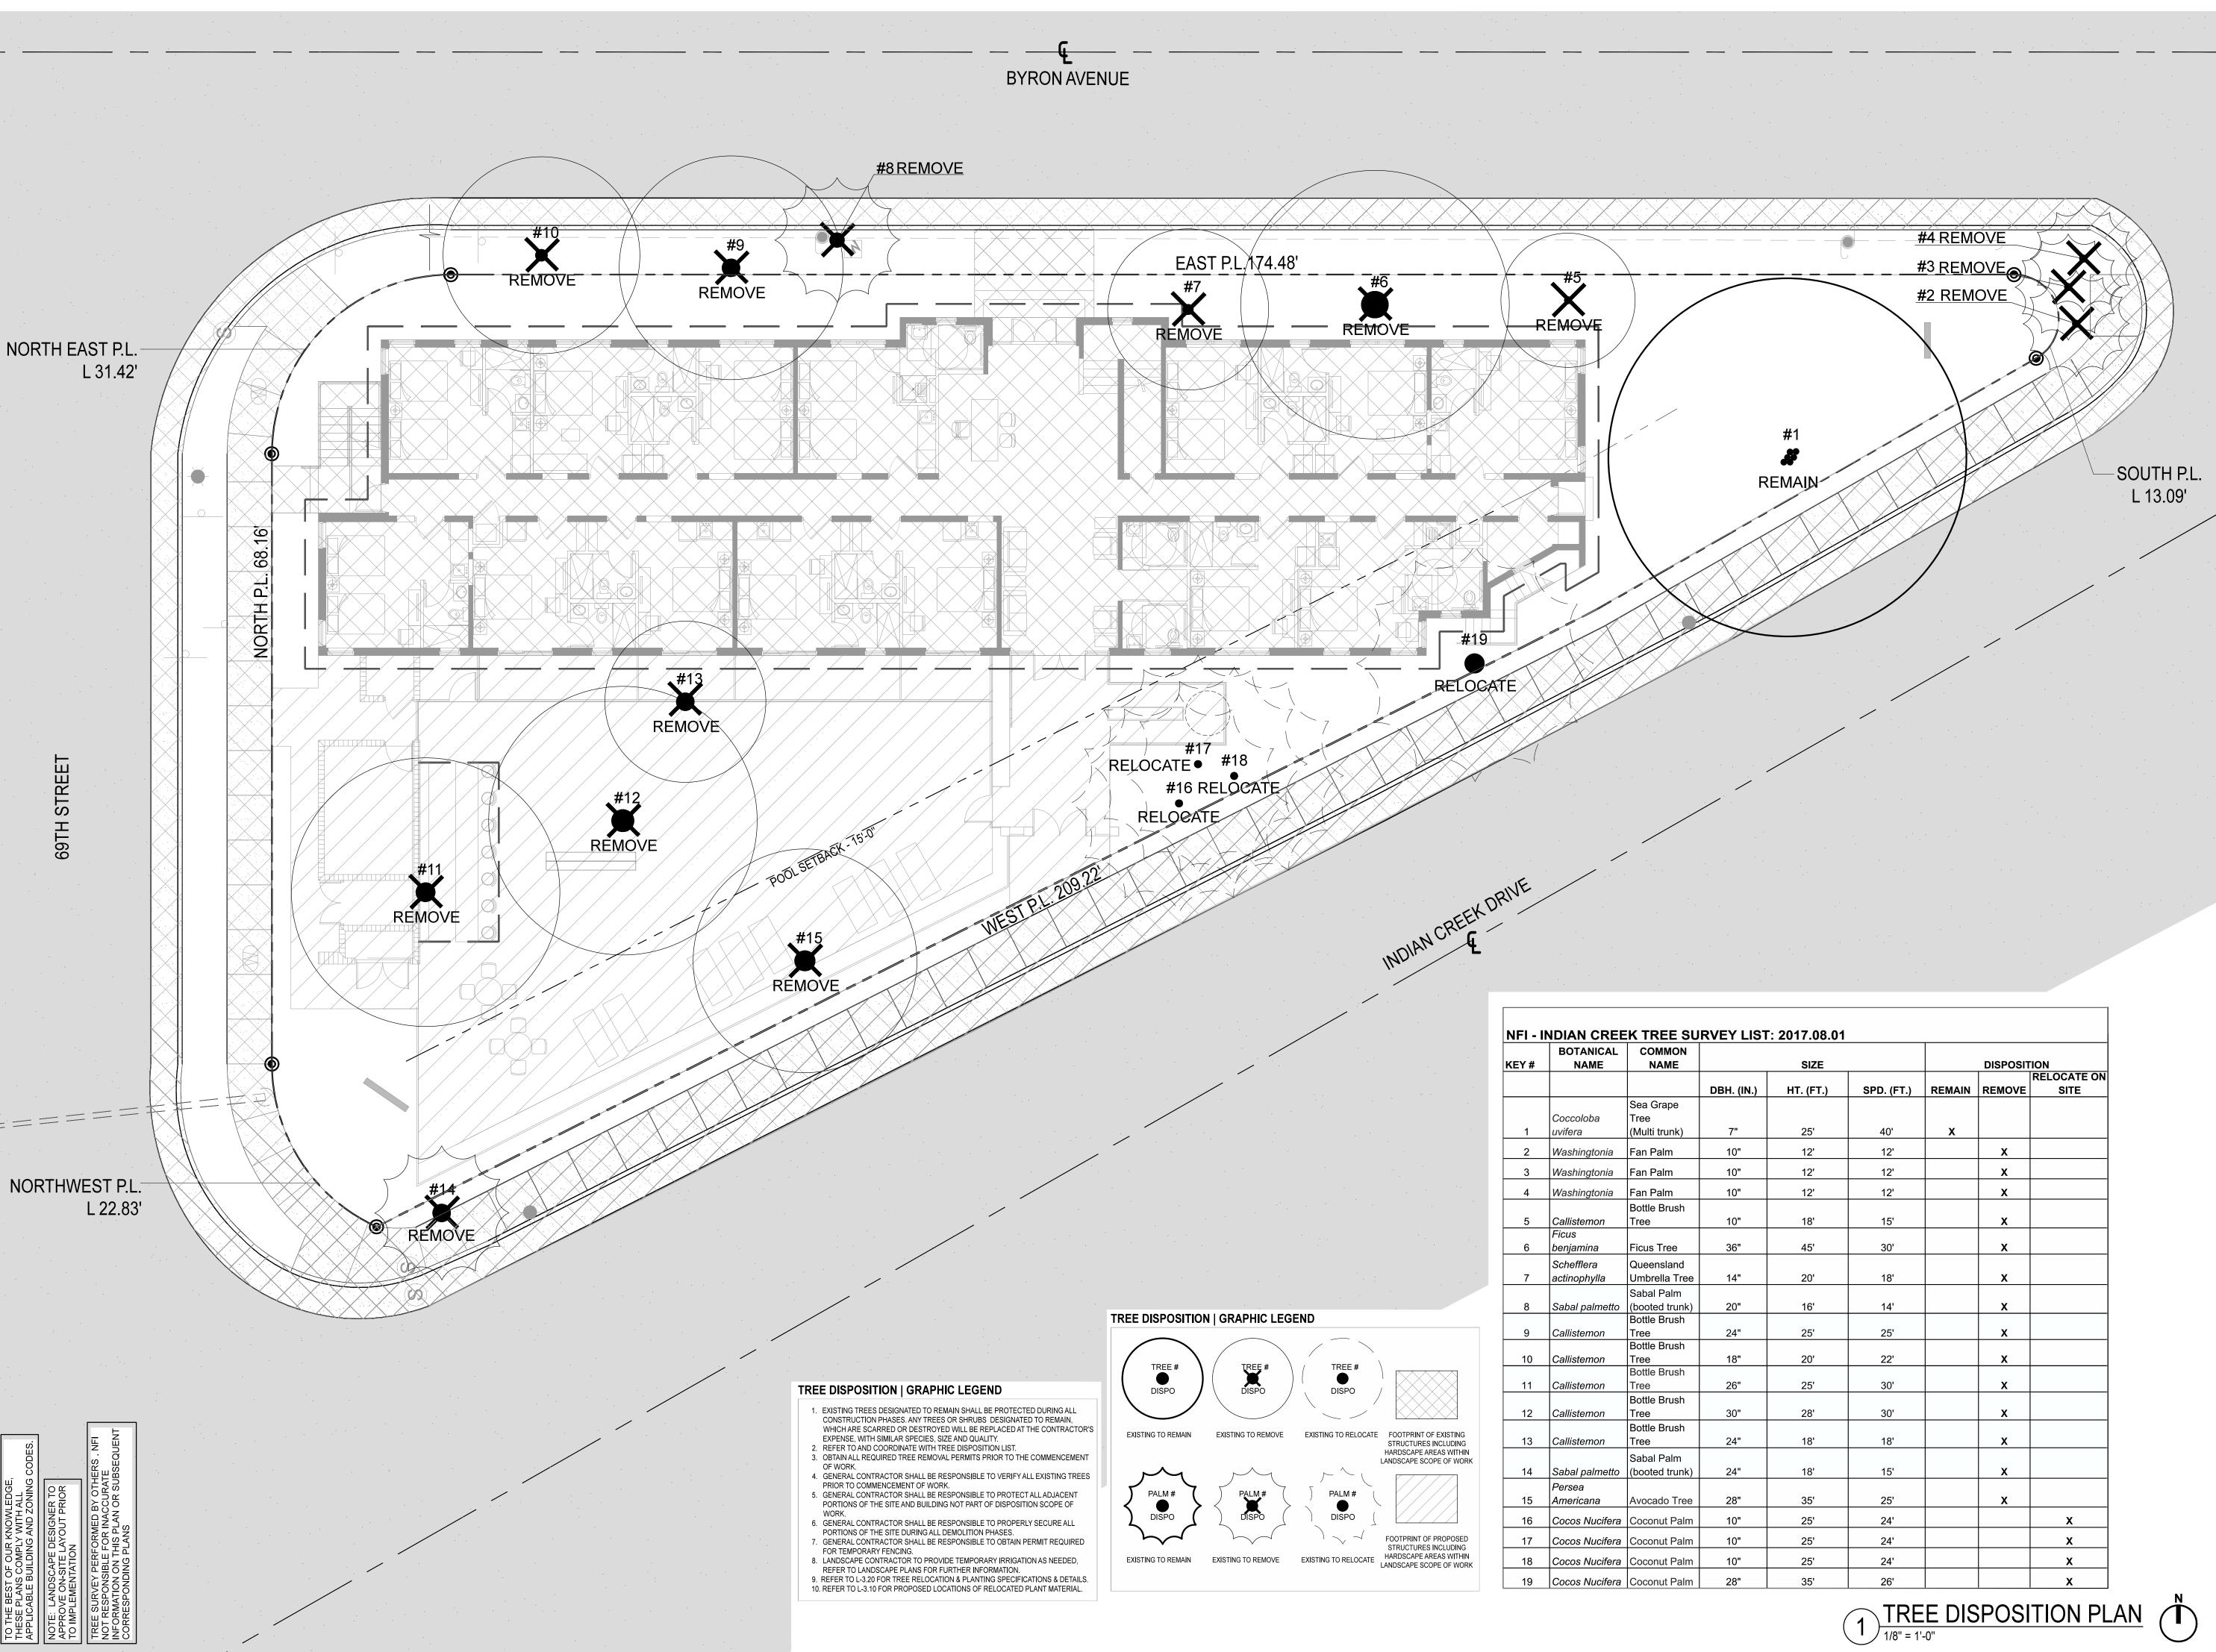
SHEET TITLE

LANDSCAPE PLAN





SHEET NUMBER L-3.10



DoNoB

Design Group, LLC

Design Group, LLC
AA26001282
370 MIRACLE MILE
CORAL GABLES, Florida 33134
Tel. 305.444.5545
Fax. 305.444.5509
www.dnbdesigngroup.com

6881 INDIAN CREEK HOTEL RENOVATIONS

6881 INDIAN CREEK MIAMI, FLORIDA

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APPROVED BY:
A.A, P.A

SCALE:
AS SHOWN

Landscape Architect

naturalficial, inc.

CONSULTANTS:

6915 Red Road Suite 224 Coral Gables FL 33143 Firm# LC26000548 P 786 717 6564 naturalficial.com

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SHEET TITLE

TREE DISPOSITION PLAN

SHEET NUMBER L-3.00

