# FINAL PLANNING BOARD

- L001 COVER SHEET
- L002 TREE DISPOSITION PLAN
- L003 EXISTING TREE SCHEDULE
- L004 LANDSCAPE LEGEND AND MITIGATION
- L100 SITE HARDSCAPE PLAN
- L200 SITE PLANTING PLAN
- L201 2ND LEVEL PLANTING PLAN
- L202 PLANTING DETAILS
- L300 SITE LIGHTING PLAN

NOTE: ARBORIST REPORT SUBMITTED AS A SEPARATE FILE



7500 NE 4th Court Suite 102 Miami, FL 33138 T: (305) 573-2728

PROJECT NUMBER

2314

PROJECT NAME

WHOLE FOODS AND

WELLS FARGO

1901 ALTON ROAD MIAMI BEACH, FL 33141

OWNER

CRESCENT HEIGHTS

FACADE ARCHITECT

OPPENHEIM ARCHITECTURE AND DESIGN

DRAWING



JUSTINE VELEZ FLORIDA LIC# LA6667391

ALL DRAWINGS AND WRITTEN MATERIAL APPEARING HEBIN CONSTITUTETHE ORIGINAL AND UNRUELSHED WORK OF SEUDID M:-G ARAVETICUTIER AND MAY NOT BE DUPLICATED USED OR DISCLOSED WITHOUT THE DWRESS WITTEN CONSENT OF STUDIO H:-G ARACHTECTURE & RANNING, MC (c) 2020

SCALE:

DRAWN:

JV/DS

AJ


1/32" = 1'- 0"

CHECK: DATE:

01/19/24

SHEET NUMBER

L001

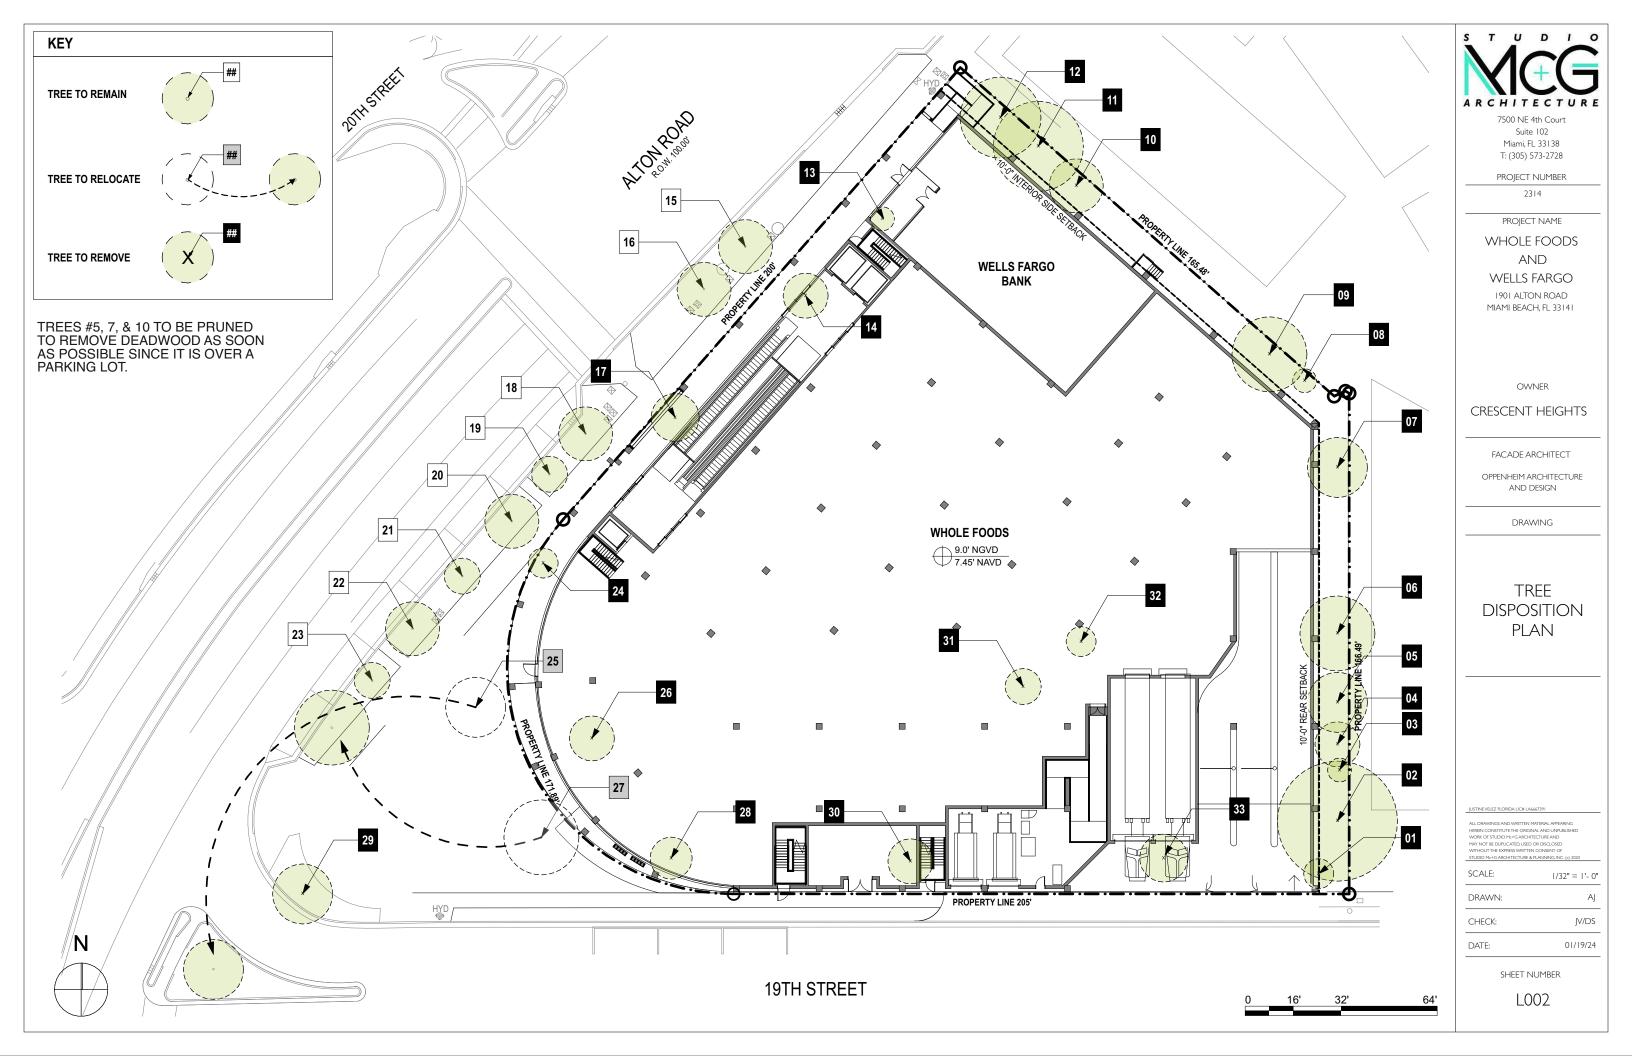


			E	xisting Tre	e Schedu	е		1	
Symbol	ID	Botanical Name	Common Name	DBH	Height	Spread	Native	Status	Remarks
	01	Washingtonia robusta	Mexican Fan Palm	14"	50'	10'	N	REMOVE	
	02	Acacia auriculiformis	Earleaf acacia	30"	45'	40'	N	REMOVE	Prohibited Tree*
×	03	Washingtonia robusta	Mexican Fan Palm	8"	8'	8'	N	REMOVE	
	04	Acacia auriculiformis	Earleaf acacia	10.5"	30	15	N	REMOVE	Prohibited Tree*
	05	Acacia auriculiformis	Earleaf acacia	17"	33	20	N	REMOVE	LARGE DEADWOOD; PRUNE TO REMOVE DEADWOOD ASAP Prohibited Tree*
$\left( \cdot \right)$	06	Acacia auriculiformis	Earleaf acacia	12"	30'	25'	N	REMOVE	Prohibited Tree*
	07	Acacia auriculiformis	Earleaf acacia	18.5"	40'	20'	N	REMOVE	LARGE DEADWOOD; PRUNE TO REMOVE DEADWOOD ASAP Prohibited Tree*
×	08	Tabebuia heterophylla	Pink Trumpet Tree	6"	20'	8'	N	REMOVE	
	09	Acacia auriculiformis	Earleaf acacia	19.5"	40'	25'	N	REMOVE	Prohibited Tree*
	10	Acacia auriculiformis	Earleaf acacia	24"	40'	18'	N	REMOVE	LARGE DEADWOOD; PRUNE TO REMOVE DEADWOOD ASAP Prohibited Tree*
	11	Acacia auriculiformis	Earleaf acacia	24"	40'	30'	N	REMOVE	Prohibited Tree*
	12	Acacia auriculiformis	Earleaf acacia	12"	40'	27'	N	REMOVE	Prohibited Tree*
×	13	Washingtonia robusta	Mexican Fan Palm	16"	40'	8'	N	REMOVE	
	14	Roystonea regia	Royal Palm	14"	50'	15'	Y	REMOVE	
	15	Conocarpus erectus 'sericeus'	Silver Buttonwood	8"	15'	18'	Y	REMAIN	
	16	Conocarpus erectus 'sericeus'	Silver Buttonwood	8"	15'	18'	Y	REMAIN	
	17	Roystonea regia	Royal Palm	16"	45'	16'	Y	REMOVE	
	18	Quercus virginiana	Live Oak	6"	20'	18'	Y	REMAIN	
	19	Phoenix sylvestris	Silvester Date Palm	12"	25'	12'	N	REMAIN	
	20	Quercus virginiana	Live Oak	9"	20'	18'	Y	REMAIN	
$\bigcirc$	21	Phoenix sylvestris	Silvester Date Palm	12"	25'	12'	N	REMAIN	

			E	Existing Tre	e Schedu	e			
Symbol	ID	Botanical Name	Common Name	DBH	Height	Spread	Native	Status	Remarks
	22	Quercus virginiana	Live Oak	6"	18'	18'	Y	REMAIN	
	23	Phoenix sylvestris	Silvester Date Palm	14"	25'	12'	N	REMAIN	
	24	Roystonea regia	Royal Palm	14"				REMOVE	
	25	Phoenix dactylifera	Date Palm	18"	28'	20'	N	RELOCATE	
	26	Sabal palmetto	Sabal Palm	13"	25'	15'	Y	REMOVE	
	27	Quercus virginiana	Live Oak	12"	30'	25'	Y	RELOCATE	
	28	Roystonea regia	Royal Palm	12.5"	40'	14'	Y	REMOVE	
	29	Veitchia arecina	Montgomery Palm 'double'	7"	25	20		REMOVE	
	30	Roystonea regia	Royal Palm	14"	50'	15'	Y	REMOVE	
	31	Waashingtonia robusta	Mexican Fan Palm	14"	40'	12'	N	REMOVE	
	32	Syagrus romanzoffiana	Queen Palm	8"	25'	10'	N	REMOVE	
	33	Roystonea regia	Royal Palm	17"	50'	16'	Y	REMOVE	

TREE/ PALM PROTECTION FENCES SHALL BE CONSTRUCTED PRIOR TO ANY CONSTRUCTION ACTIVITY INCLUDING GRUBBING FOR ALL TREES/PALMS THAT ARE 'TO REMAIN, BE PROTECTED OR BE RELOCATED'

NO ACTIVITY OR DISTURBANCE SHOULD OCCUR WHITHIN THE FENCED AREAS, INCLUDING VEHICLE USE, STORAGE OF MATERIALS, DUMPING OF LIQUIDS OR MATERIALS, GRADE CHANGES, GRUBBING, AND MECHANICAL TRENCHING FOR IRRIGATION, ELECTRICAL, LIGHTING, ETC.

IN NO CASE SHALL THE FENCE BE INSTALLED LESS THAN TEN FEET FROM THE TRUNK

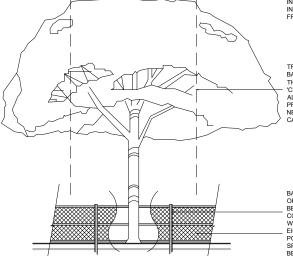

TREE + PALM PROTECTION BARRIERS TO EXTEND BEYOND THE 'DRIPLINE' OR TO THE - 'CRITICAL ROOT ZONE AREA' OF ALL TRES/PALMS TO BE PROTECTED. EXTEND WHERE NECESSARY TO PROTECT TREE ' CANOPY ROOTS

BARRIERS SHALL BE A MINIMUM OF FOUR FEET HIGH, AND SHALL BE CONSTRUCTED OF CONTINUOUS CHAIN LINK FENCE WITH METAL POSTS AT EIGHT-FOOT SPACING R0 2\*X4\* POSTS WITH THREE EQUALLY SPACED 2\*X4\* RAILS POSTS MAY BE SHIFTED TO AVOID ROOTS.

PROTECTION DETAIL NOTE: CONTRACTOR TO INSTALL 'TREE/PALM PROTECTION FENCE BARRIERS' AROUND ALL EXISTING TREES OR PALMS AT THE START OF THE PROJECT. BARRIERS TO REMAIN IN PLACE THROUGHOUT THE DURATION OF THE PROJECT AND SHOULD NOT BE REMOVED OR DROPPED FOR ANY REASON WITHOUT AUTHORIZATION FROM THE CITY OF MIAMI BEACH URBAN FORESTER + PLANNING + ZONING DEPARTMENT

#### C.M.B. TREE / PALM PROTEC. DETAIL

NOTE:

TREES #5, 7, & 10 TO BE PRUNED TO REMOVE DEADWOOD AS SOON AS POSSIBLE SINCE THEY ARE OVER A PARKING LOT.

s т U D I O
ARCHITECTURE
7500 NE 4th Court
Suite 102
Miami, FL 33138
T: (305) 573-2728
PROJECT NUMBER
2314
PROJECT NAME

WHOLE FOODS AND WELLS FARGO

1901 ALTON ROAD MIAMI BEACH, FL 33141

OWNER

CRESCENT HEIGHTS

FACADE ARCHITECT

OPPENHEIM ARCHITECTURE AND DESIGN

DRAWING



JUSTINE VELEZ FLORIDA LIC# LA6667391

ALL DRAWINGS AND WRITTEN MATERIAL APPEARING HEREIN CONSTITUTE THE ORIGINAL AND UNPUBLISHED WORK OF STUDIO MH-G ARCHITECTURE AND MAY NOT BE DUPLICATED, USED OR DISCLOSED WITHOUT THE EXPRESS WRITEIN CONSENT OF STUDIO Mc+G ARCHITECTURE & PLANNING, INC.

SCALE:

DRAWN:

JV/DS 01/19/24

AJ

1/32" = 1'- 0"

CHECK: DATE:

SHEET NUMBER

L003

# **CITY OF MIAMI BEACH**

# LANDSCAPE LEGEND

	INFORMATION REQUIRED TO BE PERMANENTLY AFFIXED TO PLANS   Zoning District CD-1   Lot Area 55,377   Acree	es1.27	
		REQUIRED/	
	OPEN SPACE	ALLOWED	PROVIDED
Α.	Square feet of required Open Space as indicated on site plan:		
	Lot Area = <u>55,377</u> s.f.x <u>5.98</u> % = <u>3,312</u> s.f.	3,312	3,312
В.	Square feet of parking lot open space required as indicated on site plan:		
	Number of parking spaces x 10 s.f. parking space =	N/A	N/A
C.	Total square feet of landscaped open space required: A+B=	3,312	2,913
	LAWN AREA CALCULATION		
Α.	Square feet of landscaped open space required		
В.	Maximum lawn area (sod) permitted= <u>3,312</u> % x <u>20%</u> s.f.	662	0
	TREES		
A.	Number of trees required per lot or net lot acre, less existing number of		
	trees meeting minimum requirements=		16 Ground
	22 trees x 1.27 net lot acres - number of existing trees=	28	7 On structure
В.	% Natives required: Number of trees provided x 30% =	8	23
C.	% Low maintenance / drought and salt tolerant required:		
	Number of trees provided x 50%=	14	23
D.	Street Trees (maximum average spacing of 20' o.c.)		6 Existing
	576.96 linear feet along street divided by 20'=	29	25 Proposed = 3
Ε.	Street tree species allowed directly beneath power lines:		
	(maximum average spacing of 20' o.c.):		
	linear feet along street divided by 20'=	N/A	N/A
	SHRUBS		
A	Number of shrubs required: Sum of lot and street trees required x 12=	684	694
D	% Native shrubs required: Number of shrubs provided x 50%=	347	
Б.	7 Native sindus required. Number of sindus provided x 50%-		394
	LARGE SHRUBS OR SMALL TREES		
Α.	Number of large shrubs or small trees required: Number of required shrubs		100
-	x 10%=	68	103
В.	% Native large shrubs or small trees required: Number of large shrubs or	• -	
	small trees provided x 50%=	39	103

## TOTAL TREES AND PALMS TO BE RE

## TREES

- 183" DBH 1 Tabebuia heterophylla
- 9 Acacia auriculiformis (prohibited tree)

## **REQUIRED MITIGATION**

60 SMALL TREES (2" DBH x 6' SPREAD x 12' HEI 30 LARGE TREES (4" DBH x 8' SPREAD x 16' HE \$60,000 CONTRIBUTION TO TREE TRUST FUND

## PALMS

- 4 Washingtonia robusta
- 6 Roystonea regia 1 Veitchia arecina
- 1 Syagrus romanzoffiana 1 Sabal Palm

## **REQUIRED MITIGATION**

13 SMALL TREES (2" DBH x 12' HEIGHT) OR, 6.5 LARGE TREES (4" DBH x 16' HEIGHT) OR, \$13,000 CONTRIBUTION TO TREE TRUST FUND

## PROPOSED TREES. SEE PLANTING

SMALL TREES: 7 7 Annona glabra

- LARGE TREES: 41
- 6 Coccoloba diversifolia \*
- 5 Illex cassine \*
- 5 Pimenta racemosa \*
- 8 Conocarpus erectus \*
- 5 Conocarpus erectus sericeus \*
- 12 Taxodium distichum \*

\* = Native trees

#### **REQUIRED MITIGATION** 73 SMALL TREES


TOTAL PROPOSED 7 SMALL TRESS + 41 LARGE TREES (89 SMALL TREES EQUIVALENT)


EXCEEDING BY 16 SMALL TREES OR 8 LARGE

#### NOTE:

Street Trees will comply with Florida Fancy requirements. All other planting materials shall meet or exceed Florida Grade # 1 as specified in Grades and Standards for Nursery Plants and Part II, Palms and Trees, current edition

	S T U D I O
MS TO BE REMOVED	
	ARCHITECTURE
	7500 NE 4th Court
	Suite 102 Miami, FL 33138
d tree)	T: (305) 573-2728 PROJECT NUMBER
PREAD x 12' HEIGHT) OR,	2314
SPREAD x 16' HEIGHT) OR,	PROJECT NAME
EE TRUST FUND	WHOLE FOODS
	AND
Sec. 46-61. (c) The removal of a palm shall be	WELLS FARGO
replaced with one canopy tree at 12 feet overall height with a two-inch DBH.	1901 ALTON ROAD MIAMI BEACH, FL 33141
HEIGHT) OR,	
S'HEIGHT) OR,	OWNER
EE TRUST FUND	CRESCENT HEIGHTS
E PLANTING PLANS	FACADE ARCHITECT
	AND DESIGN
	DRAWING
	LANDSCAPE
	LEGEND
	AND
	MITIGATION
REES	JUSTINE VELEZ FLORIDA LIC# LA6667391
)	ALL DRAWINGS AND WRITTEN MATERIAL APPEARING HEREIN CONSTITUTE THE ORIGINAL AND UNPUBLISHED WORK OF STUDIO ME+6 ARCHITECTURE AND MAY NOT BE DUPUCATED USED OR DISCLOSED
S OR 8 LARGE TREES EQUIVALENT	WITHOUT THE EXPRESS WRITTEN CONSENT OF STUDIO Mc+G ARCHITECTURE & PLANNING, INC. (c) 2020
	SCALE: 1/32" = 1'- 0"
	DRAWN: AJ
	CHECK: JV/DS
	DATE: 01/19/24
	SHEET NUMBER
	L004

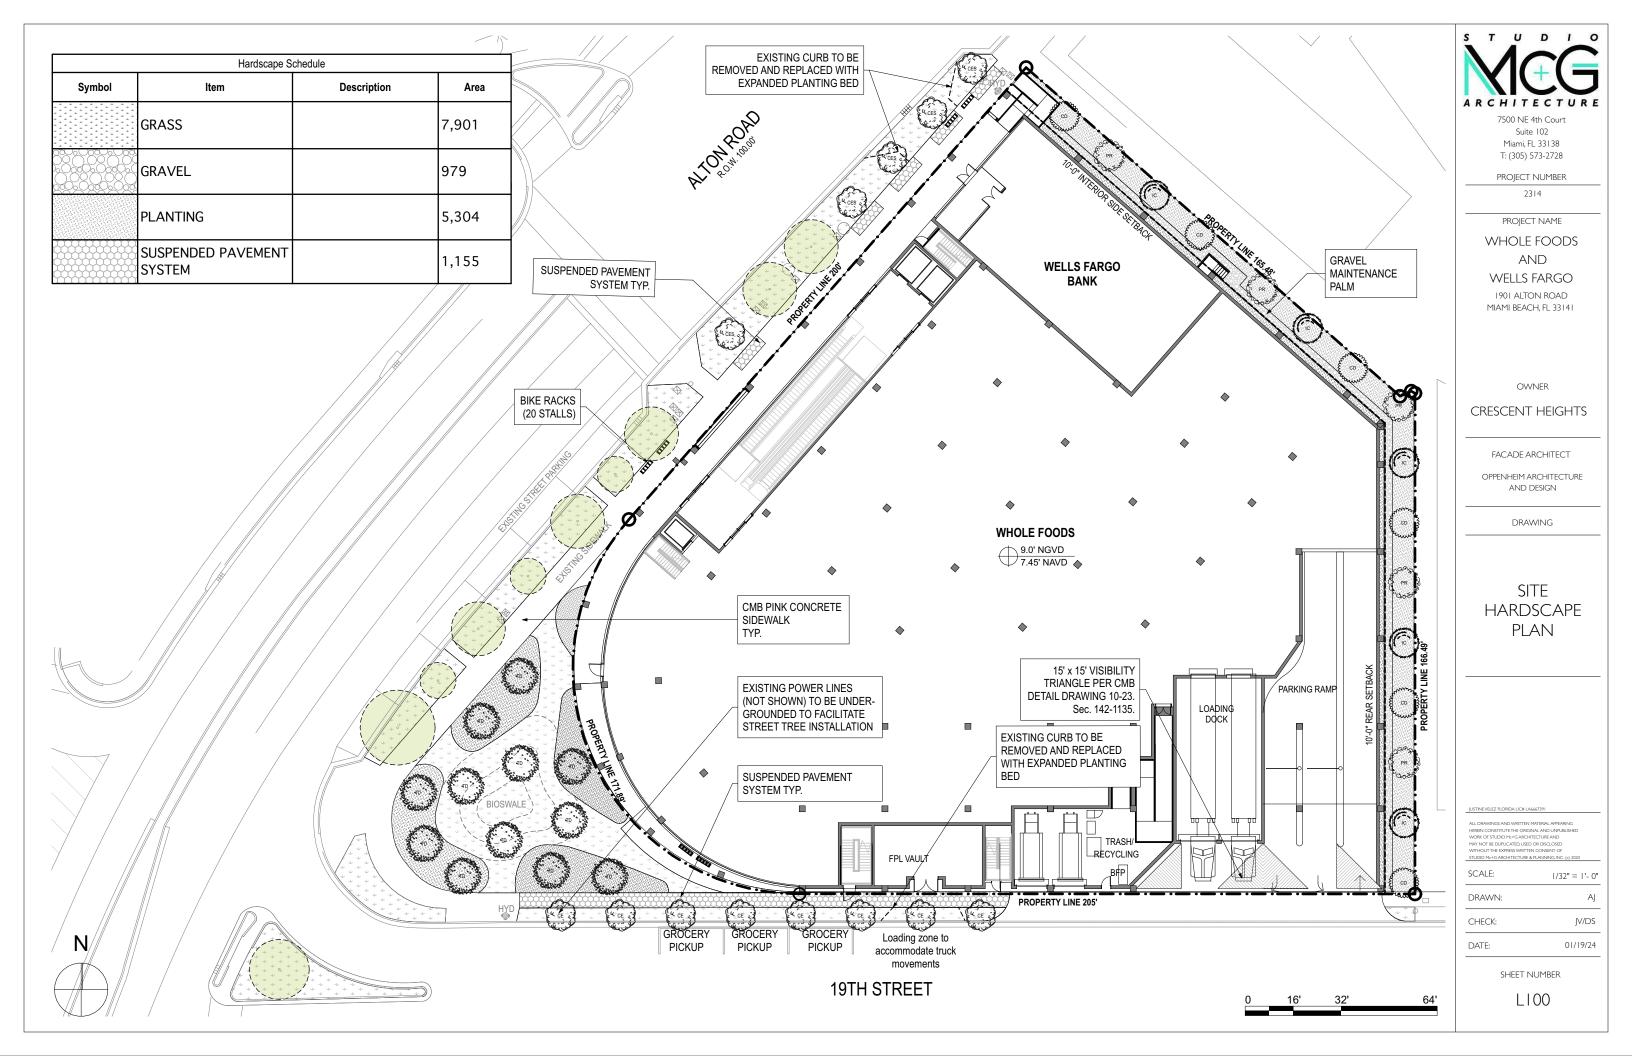

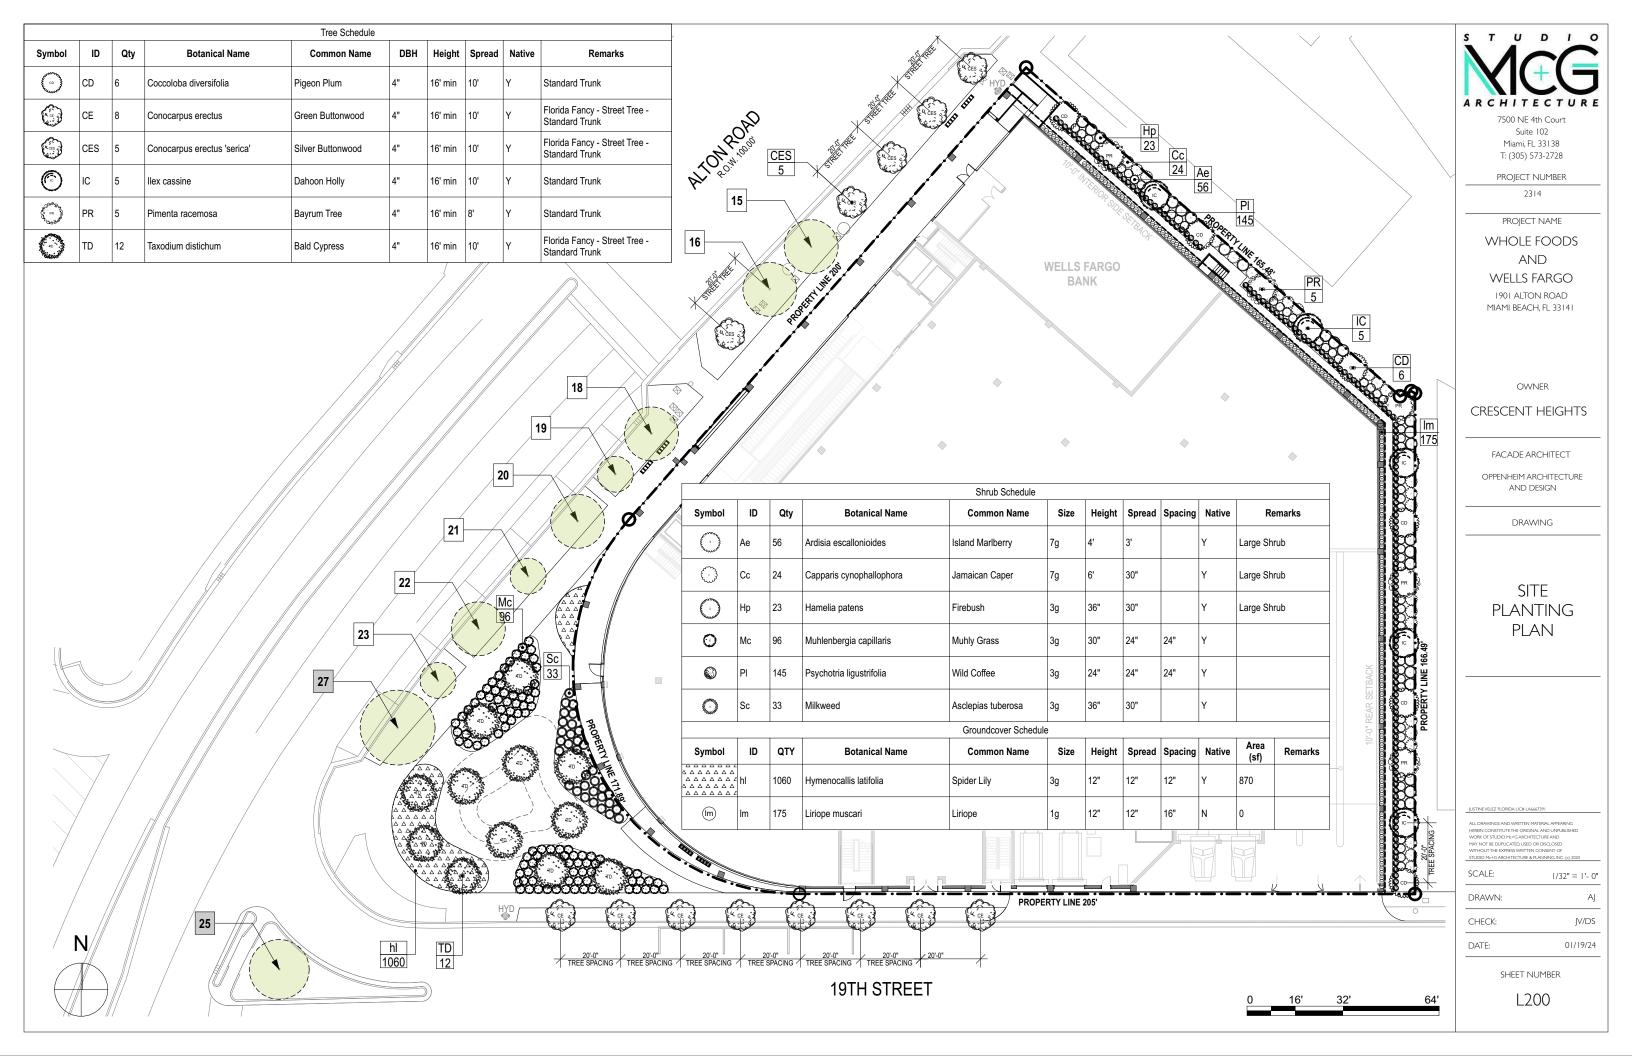

			2nd	Level Tree Schedule		1	1	1	
Symbol	ID	Qty	Botanical Name	Common Name	DBH	Height	Spread	Native	Remarks
$\bigcirc$	AG	7	Annona glabra	Pond Apple Tree	2.5"	12'	6'	Y	Lot Tree
(ML)	ML	7	Polyalthia longifolia 'Upright'	Mast Tree		10'	4'	N	
	RM	24	Ravenala madagascariensis	Traveller Tree		15'	12'	N	
			-	Level Shrub Schedule					
Symbol	ID	Qty	Botanical Name	Common Name	Size	Height	Spread	Native	Remarks
WWW WWW	Am	12	Alocasia macrorrhiza	Black Stem Elephant Ear	7g			N	
Ap	Ар	51	Alpinia purpurata 'Pink'	Pink Ginger	15g	5'		N	
0	Cf	37	Cordyline fruticosa 'Pink Diamond'	Pink Diamond Cordyline	7g	30"	30"	N	
(FI)	FI	24	Ficus lyrata	Fiddle Leaf Fig	7g			N	
	Hc	48	Heliconia caribaea x bihai 'Jacquinii'	Heliconia caribaea x bihai 'Jacquinii'		8'		N	
Ś	Lc	42	Leea coccinea 'Rubra'	West Indian Holly	7g	36"	30"	N	Shrub
0	Md	88	Monstera deliciosa	Swiss Cheese Vine	7g	4'	3'	N	
0	Pg	122	Philodendron gloriosum	Philodendron gloriosum	3g	2'	2'	N	
Re	PI	113	Psychotria ligustrifolia	Wild Coffee	3g	24"	24"	Y	
Θ	Re	10	Rhapis excelsa	Lady Palm		6'		N	Shade Grown
									PUONO PARA
									PROPERTY OF
									RTYLIN
									PROPERTY LINE 171.5
	Ν								

