

MIAMI BEACH

PUBLIC WORKS DEPARTMENT

CONVENTION CENTER DRIVE & 19TH STREET

INTERACTIVE DIGITAL KIOSK DEPLOYMENT PROJECT

FEBRUARY 2024

IKE SMART CITY

MIB-003

CITY OF MIAMI BEACH

MAYOR: STEVEN MEINER

COMMISSIONERS: KRISTEN ROSEN GONZALEZ
LAURA DOMINGUEZ
ALEX J. FERNANDEZ
TANYA K. BHATT
DAVID SUAREZ
JOSEPH MAGAZINE


CITY MANAGER: ALINA T. HUDAK

CITY ATTORNEY: RAFAEL A. PAZ

PUBLIC WORKS DIRECTOR: JOE GOMEZ, P.E., F.FES

CITY ENGINEER: CRISTINA ORTEGA

Always call 811 two full business days before you dig to have underground utilities located and marked.

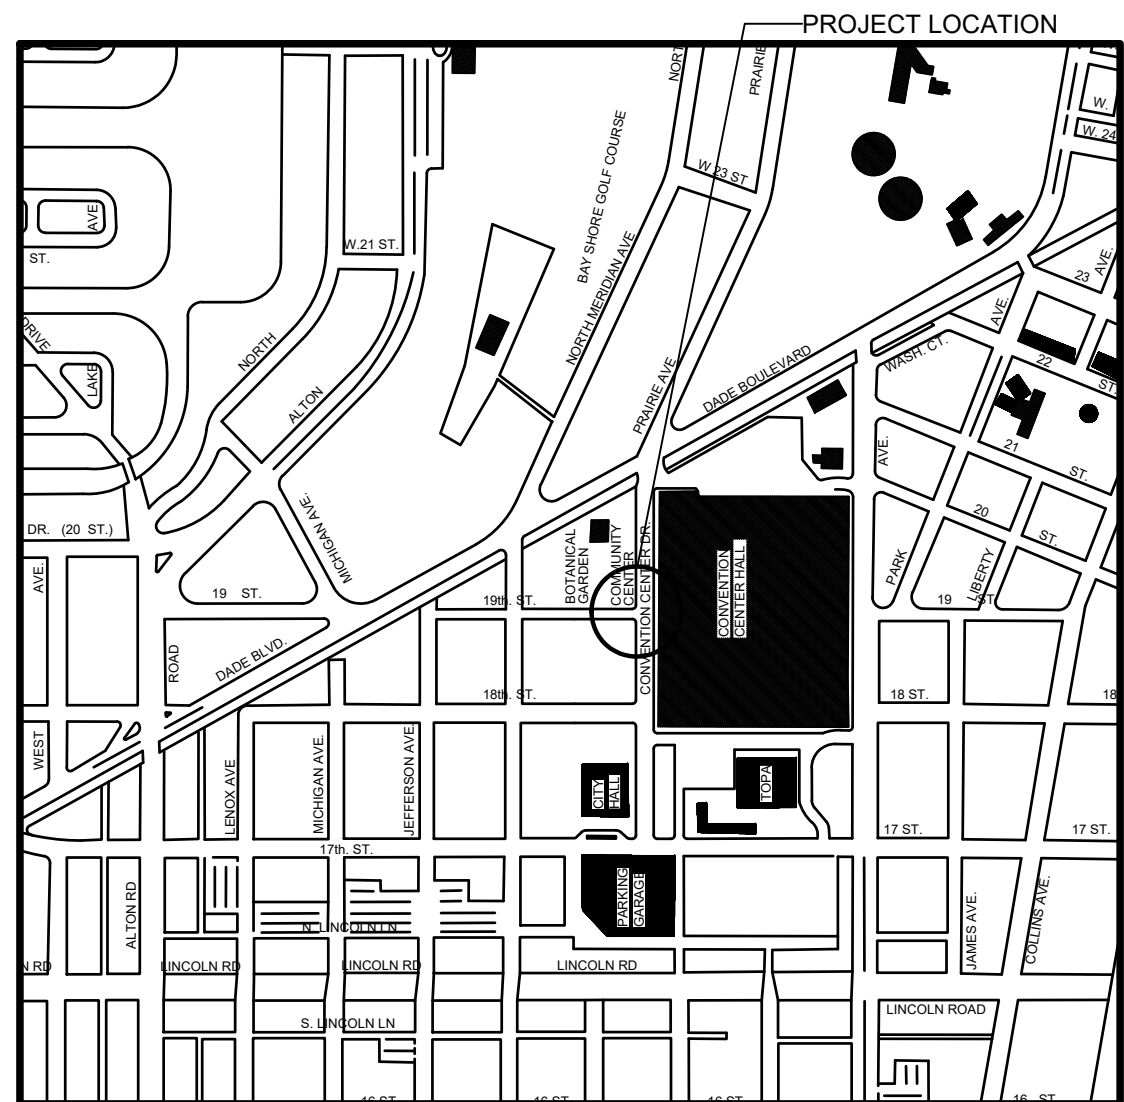

LOCATION MAP

INDEX OF PLANS

| NUMBER | DISCIPLINE | SHEET NO. | DESCRIPTION | NOTES |
|--------|------------|-----------|---|-------|
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| 2 | GENERAL | G0-03 | INDEX OF SHEETS | |
| 3 | GENERAL | G0-04 | ADA NOTES, SCOPE OF WORK & KIOSK SPECIFICATIONS | |
| 4 | CIVIL | C1-01 | CIVIL SITE PLAN | |
| 5 | CIVIL | C1-02 | KIOSK MIB-003 ENGINEERING PLAN | |
| 6 | ELECTRICAL | E1-01 | KIOSK MIB-003 ELECTRICAL PLAN | |
| 7 | SURVEY | | KIOSK MIB-003 SITE SURVEY | |

SCOPE OF WORK: THE PROJECT CONSISTS OF THE INSTALLATION OF ONE (1) DIGITAL INTERACTIVE KIOSK AND APPLICABLE INFRASTRUCTURE; STRUCTURAL FOUNDATION AND ELECTRICAL SERVICE AT THE LOCATION INDICATED ON THESE DESIGN PLANS.

ENGINEER OF RECORD: VANESSA A. MELA, P.E. NO. 77676


Work Order _____ Sheet 1 of 7 Drawing **G0-01**

INDEX OF PLANS

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| 7 | SURVEY | | KIOSK MIB-003 SITE SURVEY | |

HISTORIC DISTRICTS AND SITES OF THE CITY OF MIAMI BEACH • FLORIDA •

INCORPORATED 1915
DATE OF LAST REVISION MAY 17, 2019

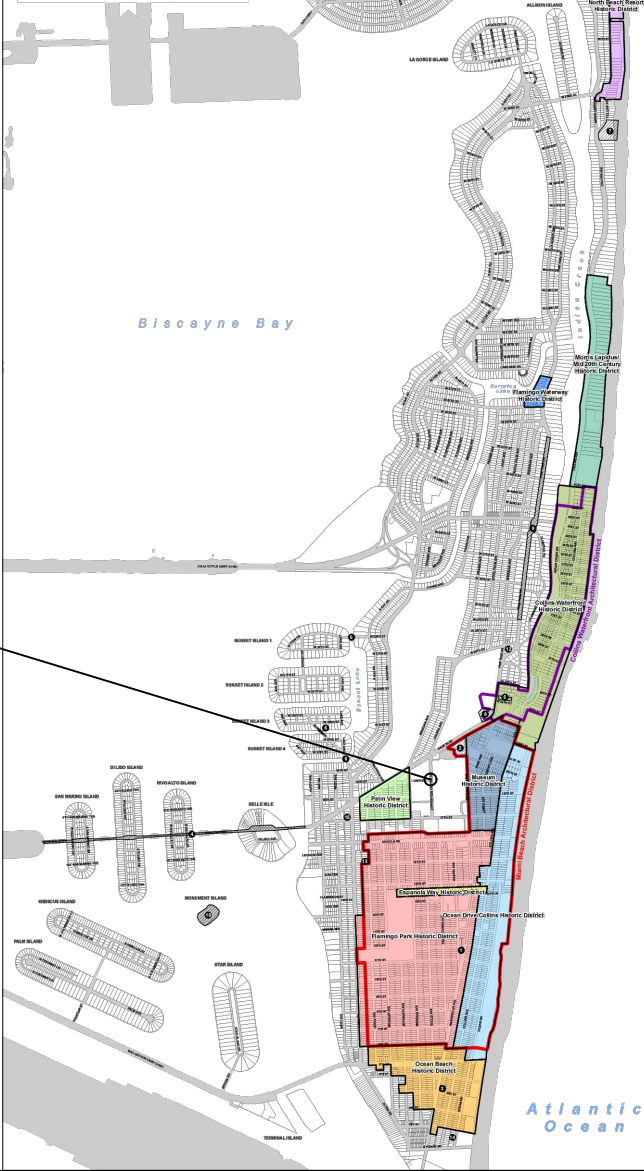


PROJECT LOCATION


| LEGEND AND ABBREVIATIONS | |
|--------------------------|-------------------------------|
| | = PALM TREE |
| | = TREE |
| | = ORNAMENTAL TREE |
| O.R.B. | = OFFICIAL RECORDS BOOK |
| PG. | = PAGE |
| ELEV. | = ELEVATION |
| TYP. | = TYPICAL |
| CATV | = CABLE TELEVISION |
| OHE | = OVERHEAD ELECTRIC LINE |
| X 0.00 | = SPOT ELEVATION |
| CONC. | = CONCRETE |
| C.B.S. | = CONCRETE BLOCK STUCCO |
| C.L.F. | = CHAIN LINK FENCE |
| W.F. | = WOOD FENCE |
| M.F. | = METAL FENCE |
| RCP | = REINFORCED CONCRETE PIPE |
| FF | = FINISH FLOOR |
| (R) | = RECORD |
| (C) | = CALCULATED |
| (M) | = MEASURE |
| LB | = LICENSE BUSINESS |
| L | = LENGTH |
| A | = CENTRAL ANGLE |
| R | = RADIUS |
| T | = TANGENT |
| PT | = POINT OF TANGENCY |
| PC | = POINT OF CURVATURE |
| STA. | = STATION |
| PI | = POINT OF INTERSECTION |
| ID | = IDENTIFICATION |
| MLP | = METAL LIGHT POLE |
| CLP | = CONCRETE LIGHT POLE |
| R/W | = RIGHT-OF-WAY |
| P.B. | = PLAT BOOK |
| S | = SECTION LINE |
| C | = CENTERLINE |
| B | = BASELINE |
| M | = MONUMENT LINE |
| T | = TRAFFIC SIGNAL BOX |
| S | = TRAFFIC SIGNAL CABINET |
| B | = BOLLARD |
| P | = PEDESTRIAN SIGNAL |
| M | = TRAFFIC SIGNAL MAST ARM |
| S | = SIGN |
| T | = CABLE TELEVISION BOX |
| L | = LIGHT POLE |
| E | = ELECTRIC BOX |
| U | = UTILITY POLE |
| E | = ELECTRIC TRANSFORMER |
| G | = GUY ANCHOR |
| E | = ELECTRIC MANHOLE |
| E | = ELECTRIC METER |
| G | = GAS VALVE |
| G | = GAS UTILITY BOX |
| G | = GAS MANHOLE |
| G | = GAS TANK |
| G | = GAS METER |
| C | = COMMUNICATION BOX |
| C | = COMMUNICATION MANHOLE |
| G | = GARBAGE RECEPTACLE |
| H | = HANDICAP PARKING SPACE |
| W | = WATER METER |
| I | = IRRIGATION VALVE |
| W | = WATER VALVE |
| F | = FIRE HYDRANT |
| W | = WATER BOX |
| W | = WATER CONNECTION |
| W | = WATER MANHOLE |
| W | = WATER TANK |
| W | = WATER WELL |
| W | = WATER MARKING FLAG |
| W | = WATER MARKING SIGN |
| S | = STORM MANHOLE |
| S | = STORM METER |
| C | = CATCH BASIN |
| T | = TELEPHONE MANHOLE |
| T | = TELEPHONE BOX |
| N | = NEWSPAPER DISPENSER |
| M | = MAILBOX |
| S | = SANITARY MANHOLE |
| S | = SANITARY BOX |
| S | = SANITARY TANK |
| S | = SANITARY LIFT STATION |
| G | = GREASE TRAP MANHOLE |
| C | = CLEANOUT |
| P | = PARKING METER |
| F | = FIBER OPTIC BOX |
| F | = FIBER OPTIC MARKER SIGN |
| M | = MONITORING WELL |
| F | = FUEL TANK |
| U | = UNKNOWN UTILITY BOX |
| U | = UNKNOWN UTILITY METER |
| U | = UNKNOWN UTILITY MANHOLE |
| U | = UNKNOWN UTILITY VALVE |
| U | = UNKNOWN UTILITY MARKER FLAG |
| S | = SANITARY VALVE |
| R | = RAILROAD SIGN |
| F | = FLAGPOLE |
| P | = PROPERTY LINE |
| E | = ELECTRICAL OUTLET |

NOTES:

KEY PLAN (NOT TO SCALE):

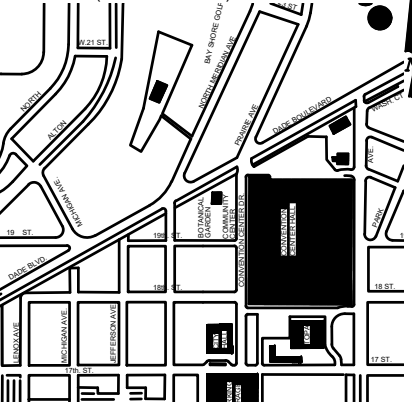

P.E. SEAL:

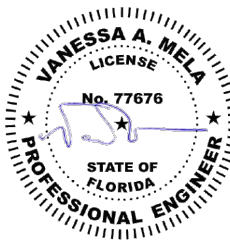

PROJECT DIRECTORY:

PROJECT NAME:
INTERACTIVE DIGITAL INFORMATION
KIOSKS DEPLOYMENT PROJECT

JURISDICTION:
CITY OF MIAMI
DEPARTMENT OF RESILIENCE AND
PUBLIC WORKS
MIAMI RIVERSIDE CENTER
444 S.W. 2nd AVENUE, 8th FLOOR
MIAMI, FLORIDA 33130
TEL: 305-416-1200

OWNER:
IKE SMART CITY
250 N HARTOFORD AVE
COLUMBUS, OH 43222
(614) 589-0087

ENGINEER OF RECORD:
MAINSTREET ENGINEERING
7035 SW 47 STREET, SUITE A
MIAMI, FL 33155
(305) 456-3505
PROJ. MGR: VANESSA MELA, P.E.
VMELA@MAINSTREETENG.COM

KIOSK MANUFACTURER:
DISPLAY DEVICE INC.
21075 WESTGATE RD.
GOLDEN, CO 80403
CONTACT: ERIC PERKINS
PHONE: (303) 929-4071

TELEPHONE: AT&T

CABLE: COMCAST, XFINITY,
ATT-UVERSE

GAS: FLORIDA GAS

UTILITIES:

ELECTRICAL POWER: FLORIDA
POWER & LIGHT COMPANY (FPL)

WATER & SEWER: MIAMI-DADE
WATER & SEWAGE DEPARTMENT

SIDEWALK & STREET SYMBOLS

| | | | |
|--|------------|--|------------------|
| | ASPHALT | | BRICK |
| | PAVER | | CONCRETE |
| | UNIMPROVED | | TILE |
| | GRAVEL | | STAMPED CONCRETE |

MIAMI BEACH

PUBLIC WORKS DEPARTMENT
1700 CONVENTION CENTER DRIVE, MIAMI BEACH, FL 33139

CITY MANAGER: ALINA T. HUDAK

DIRECTOR: JOE GOMEZ, P.E.

CITY ENGINEER: CRISTINA ORTEGA
CASTINEIRAS, P.E.

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| NO. | DATE | REVISION | APP'D. BY |



ENGINEER OF RECORD:

VANESSA A. MELA,
P.E. NO. 77676

ENGINEER OF RECORD: VM

DESIGN ENGINEER: VM

DRAWN BY: KM

CHECKER: WP

SCALE: _____

NEIGHBORHOOD:

MIB-003: CONVENTION CENTER DR & 19TH ST

TITLE:

INDEX OF SHEETS

File Name: MIB-003-GENERAL AND FOUNDATION.dwg

Survey Reference:

Field Book: N/A Page: N/A Work Order: N/A

Date: 02/09/2024 Sheet: 2 of 7 Drawing: G0-03

ADA NOTES

- ALL CONSTRUCTION ACTIVITIES SHALL BE COMPLETED IN FULL COMPLIANCE WITH THE AMERICANS WITH DISABILITIES ACT (ADA). CLEAR SPACES IN FRONT OF KIOSK SHALL HAVE THE FOLLOWING CHARACTERISTICS:
- SURFACES SHALL BE FIRM, STABLE, AND SLIP RESISTANT AND OTHERWISE COMPLY WITH PROWAG SECTION R302.7 AND SHALL HAVE A RUNNING SLOPE CONSISTENT WITH GRADE OF THE ADJACENT PEDESTRIANT ACCESS ROUTE AND CROSS SLOPE OF 1.50% +/-0.50%)
- SIZE: CLEAR SPACES SHALL BE 48" MINIMUM BY 48" MINIMUM.
- POSITION: UNLESS OTHERWISE SPECIFIED, CLEAR SPACES SHALL BE POSITIONED FOR EITHER FORWARD OR PARALLEL APPROACH TO THE KIOSK.
- APPROACH: ONE FULL UNOBSTRUCTED SIDE OF A CLEAR SPACE SHALL ADJOIN A PEDESTRIAN ACCESS ROUTE OR ADJOIN ANOTHER CLEAR SPACE.
- MANEUVERING SPACE: WHERE A CLEAR SPACE IS CONFINED ON ALL OR PART OF THREE SIDES, ADDITIONAL MANEUVERING SPACE SHALL BE PROVIDED AS FOLLOWS:
 - FORWARD APPROACH: THE CLEAR SPACE AND ADDITIONAL MANEUVERING SPACE SHALL BE 36" WIDE MINIMUM WHERE THE DEPTH OF THE CONFINING ELEMENT EXCEEDS 24".
 - PARALLEL APPROACH: THE CLEAR SPACE AND ADDITIONAL MANEUVERING SPACE SHALL BE 60" WIDE MINIMUM WHERE THE DEPTH OF THE CONFINING ELEMENT EXCEEDS 15".
- THE MINIMUM WHEELCHAIR PASSAGE WIDTH OR CLEAR SPACE WIDTH FOR A SINGLE WHEELCHAIR PASSAGE SHALL BE 48" PER PROWAG SECTION R302.3.
- INITIAL OPERATION FOR THE KIOSK WILL HAVE 4G LTE CONNECTION SECTION R404. TO THE INTERNET.
- THE KIOSKS HAVE BEEN DESIGN TO COMPLY WITH ALL ADA GUIDELINES INCLUDING VIEWING, OPERATION, AND ACCESSIBILITY.
- THE MOBILE IKE EXPERIENCE WILL FOLLOW WEB CONTENT ACCESSIBILITY GUIDELINES (WCAG) TO WORK IN TANDEM WITH THE NATIVE ACCESSIBILITY FEATURES ON THE USER'S MOBILE DEVICE, INCLUDING TALKBACK AND VOICEOVER TOOLS.

SCOPE OF WORK

THE PROJECT CONSIST OF THE INSTALLATION OF ONE (1) DIGITAL INTERACTIVE KIOSKS AT THE LOCATION(S) INDICATED ON THIS PLANS SET. INSTALLER SHALL PROVIDE AND INCLUDE ALL WORKMANSHIP AND MATERIALS NECESSARY TO COMPLETE THE INSTALLATION INCLUDING BUT NOT LIMITED TO:

- INSTALLATION OF THE KIOSKS TO THE FOUNDATION AS INDICATED ON PLANS TO NEW RECTANGULAR CONCRETE FOUNDATION.
- ELECTRICAL SERVICE POINTS ARE EXISTING. CONNECT THE EXISTING ELECTRIC SERVICE TO THE NEW KIOSK AS INDICATED ON PLANS.
- TESTING OF THE ELECTRICAL SERVICE INFRASTRUCTURE SHALL BE PERFORMED IN CONJUNCTION WITH A REPRESENTATIVE OF THE ENGINEER OF RECORD.
- THE CONTRACTOR SHALL INSTALL THE KIOSK IN SUCH A WAY THAT THE KIOSK IS WITHIN THE PUBLIC R.O.W. AND IN COMPLIANCE WITH ALL APPLICABLE A.D.A. REQUIREMENTS
- THE LOCATION OF KIOSKS HAS BEEN COORDINATE TO ENSURE THERE IS NO OBSTRUCTION OF THE SIGHT OF VEHICULAR SIGNS.
- STAND-ALONE PEDESTRIAN KIOSKS SHOULD NOT BE INSTALLED WITHIN PEDESTRIAN CIRCULATION PATHS IN A MANNER THAT PERSONS AT THE KIOSK LOCK THE EFFECTIVE WIDTH OF THE PEDESTRIAN TRAVEL WAY.

MONUMENT SIGN SPECIFICATIONS AND FUNCTIONS


THE UNIT CONSISTS OF A UL/NRTL LISTED WEATHER AND VANDAL RESISTANT FREE STANDING ENCLOSURE DESIGNED TO COMPLY WITH THE FLORIDA BUILDING CODE AND OTHER APPLICABLE CODES INCLUDING THE NATIONAL ELECTRICAL CODE. THE UNIT HAS BEEN DESIGNED TO WITHSTAND WINDS OF 165 MPH. THE UNIT'S MAIN COMPONENTS ARE:

- TWO (2) INTERACTIVE 65" VIDEO TOUCH SCREENS.
- TWO (2) CAMERAS
- ONE (1) CPU
- ONE (1) WI-FI TRANSMITTER


MANUFACTURER: DYNASCAN MODEL NUMBER: CIO651DR5
NATIVE RESOLUTION: 1920 X 1080
ELECTRICAL POWER REQUIREMENT:

- ONE-2-POLE, 20 AMP, 240 VOLTS CIRCUIT.
- TOTAL LOAD: 1400/2200 WATTS (OPERATIONAL/PEAK)
- VOLTAGE: 100-240 VOLTS AC, 50-60 HZ


WEIGHT: 832 LBS
CERTIFICATION CE / FCC / RoHS

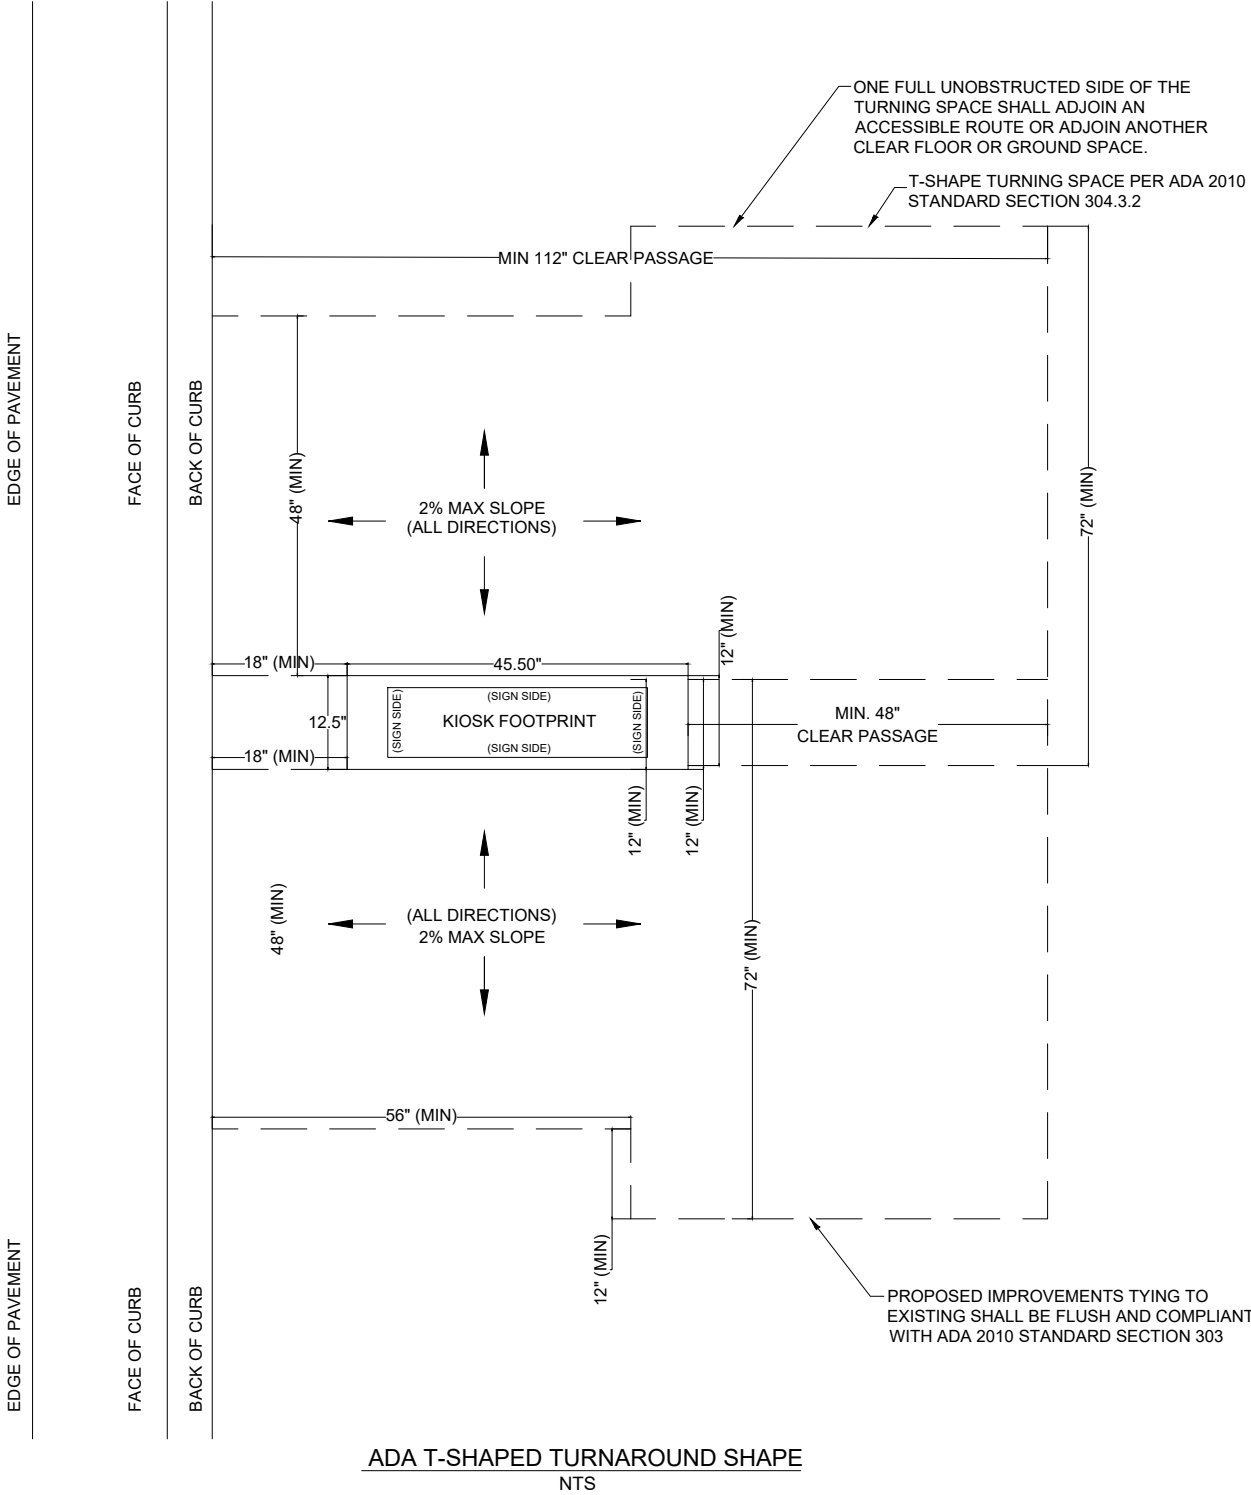

NOTES:

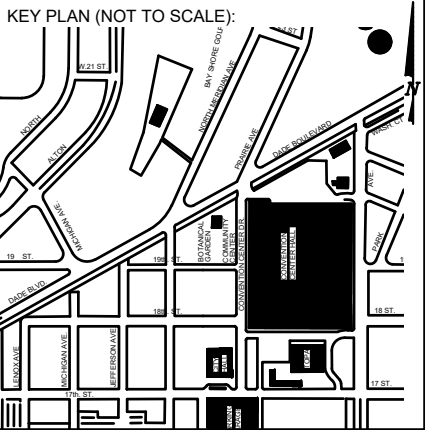

P.E. SEAL:

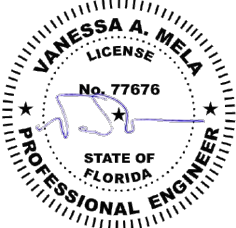

CITY MANAGER: ALINA T. HUDAK
DIRECTOR: JOE GOMEZ, P.E.
CITY ENGINEER: CRISTINA ORTEGA CASTINEIRAS, P.E.

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ENGINEER OF RECORD:
VANESSA A. MELA,
P.E. NO. 77676

ENGINEER OF RECORD: VM
DESIGN ENGINEER: VM
DRAWN BY: KM
CHECKER: WP
SCALE:

NEIGHBORHOOD:
MIB-003: CONVENTION CENTER DR & 19TH ST
TITLE:
ADA NOTES, SCOPE OF WORK
& KIOSK SPECIFICATIONS

File Name: MIB-003-GENERAL AND FOUNDATION.dwg
Survey Reference:
Field Book: N/A Page: N/A Work Order: N/A
Date: 02/09/2024 Sheet: 3 of 7 Drawing: G0-04



Call 811 or visit sunshine811.com two full business days before digging to have buried facilities located and marked.

Check positive response codes before you dig!

MIAMI BEACH
PUBLIC WORKS DEPARTMENT
1700 CONVENTION CENTER DRIVE, MIAMI BEACH, FL 33139

CITY MANAGER: ALINA T. HUDAK
DIRECTOR: JOE GOMEZ, P.E.
CITY ENGINEER: CRISTINA ORTEGA CASTINEIRAS, P.E.

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ENGINEER OF RECORD:
VANESSA A. MELA,
P.E. NO. 77676

ENGINEER OF RECORD: VM
DESIGN ENGINEER: VM
DRAWN BY: KM
CHECKER: WP
SCALE:

NEIGHBORHOOD:
MIB-003: CONVENTION CENTER DR & 19TH ST
TITLE:
CIVIL SITE PLAN

File Name: MIB-003-CIVIL PLANS.dwg
Survey Reference:
Field Book: N/A Page: N/A Work Order: N/A
Date: 02/09/2024 Sheet: 4 of 7 Drawing: C1-01

LEGEND




AREA WHERE NO STRUCTURE OR PLANTING WHICH OBSTRUCTS TRAFFIC VISIBILITY BETWEEN THE HEIGHT OF TWO FEET AND TEN FEET ABOVE THE STREET CORNER GRADE IS ALLOWED. REFER TO CITY OF MIAMI BEACH CODE OF ORDINANCES SECTION 142-1135



NO PLANTING OR STRUCTURE PERMITTED WITHIN THESE LIMITS WHICH OBSTRUCTS TRAFFIC VISIBILITY.


E.P. EDGE OF PAVEMENT

R/W RIGHT OF WAY

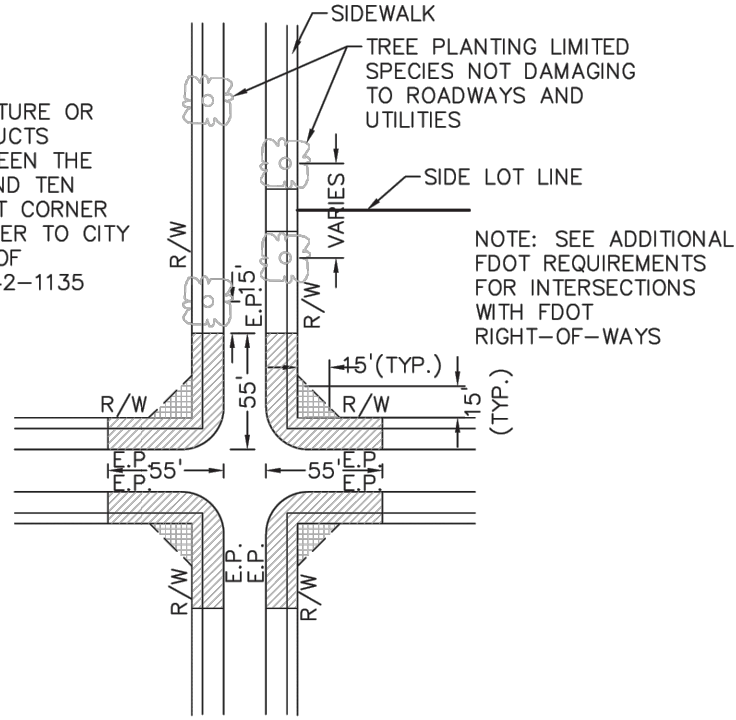

PLAN VIEW

N.T.S.

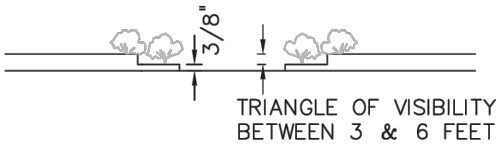

ELEVATION VIEW

N.T.S.

NOTES:

1. AT INTERSECTIONS WITH ALL-WAY STOP CONTROL, THE FIRST STOPPED VEHICLE ON ONE APPROACH SHOULD BE VISIBLE TO THE DRIVERS OF THE FIRST STOPPED VEHICLES ON EACH OF THE OTHER APPROACHES. THERE ARE NO OTHER SIGHT DISTANCE CRITERIA APPLICABLE TO INTERSECTIONS WITH ALL-WAY STOP CONTROL AND, INDEED, ALL-WAY CONTROL MAY BE THE BEST OPTION AT A LIMITED NUMBER OF INTERSECTIONS WHERE SIGHT DISTANCE FOR OTHER CONTROL TYPES CANNOT BE ATTAINED.
2. FOR TWO-WAY STOP INTERSECTIONS, SIGHT DISTANCE CRITERIA FOR STOP CONTROLLED INTERSECTIONS ARE LONGER THAN STOPPING SIGHT DISTANCE TO ENSURE THAT THE INTERSECTION OPERATES SMOOTHLY. MINOR- ROAD VEHICLE OPERATORS CAN WAIT UNTIL THEY CAN PROCEED SAFELY WITHOUT A MAJOR-ROAD VEHICLE TO STOP.

MIAMI BEACH
PUBLIC WORKS DEPARTMENT
1700 CONVENTION CENTER DRIVE, MIAMI BEACH, FL 33139

APPROVED

REVISED

07/2020

08/2020


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SIGHT RESTRICTIONS AT INTERSECTIONS
WITH NO DEDICATED RADII


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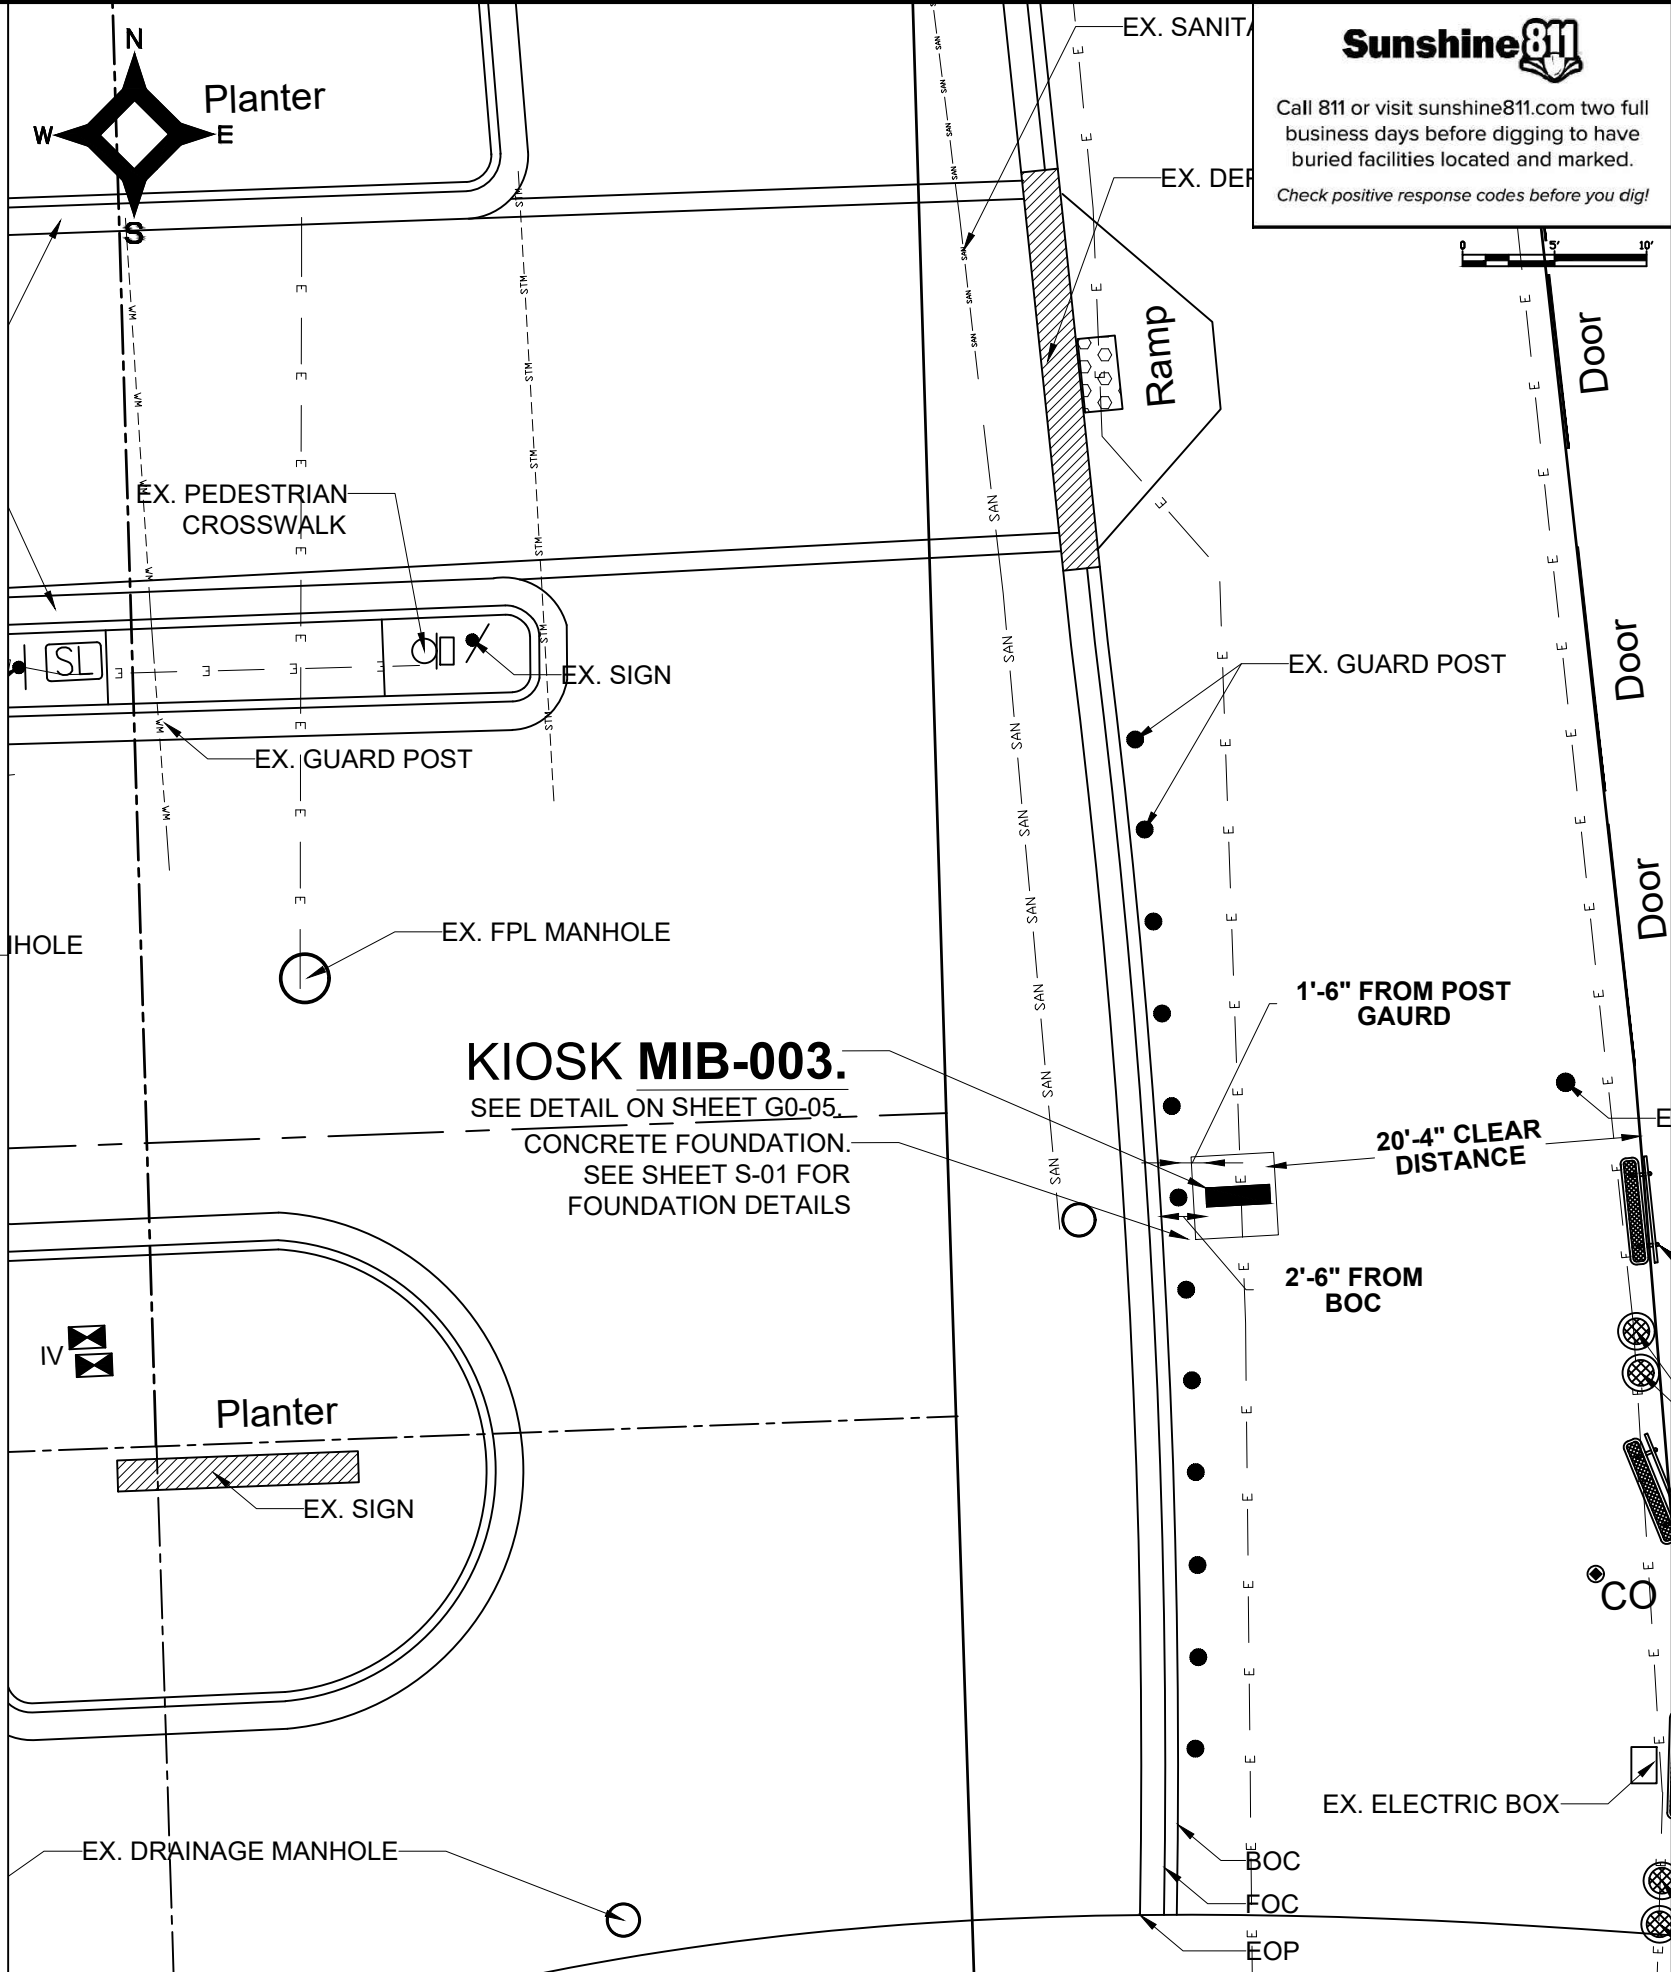
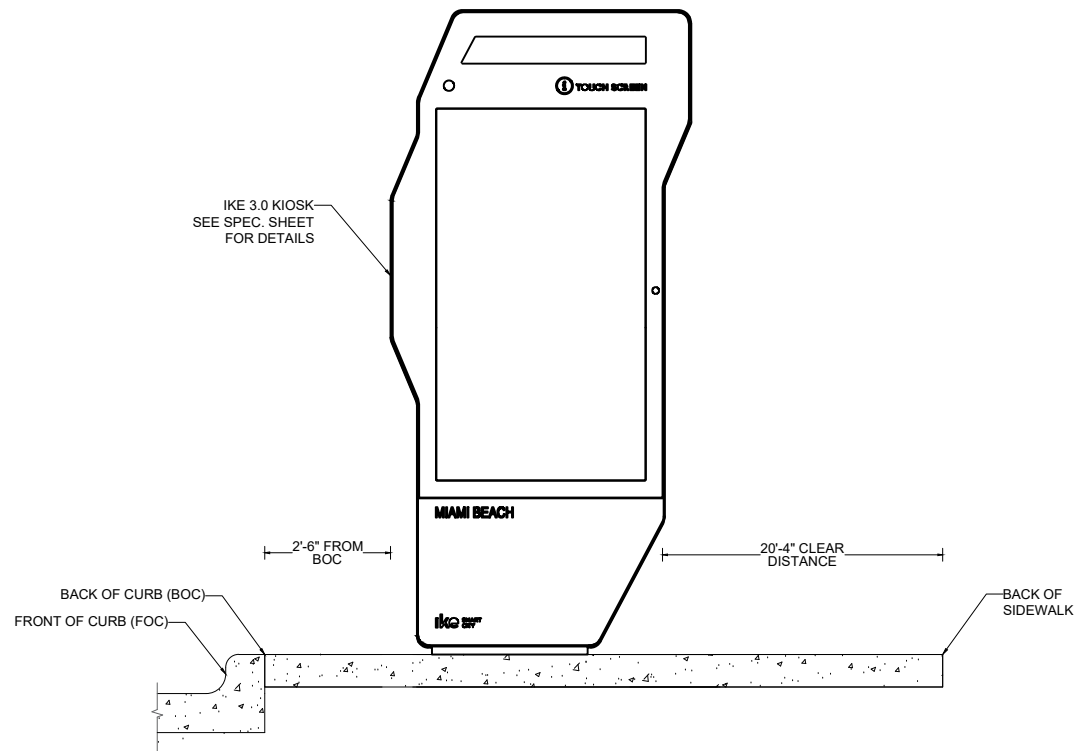
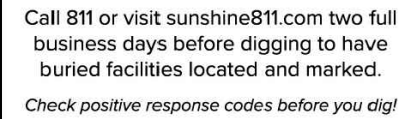
10-26

KEY PLAN (NOT TO SCALE):




P.E. SEAL:

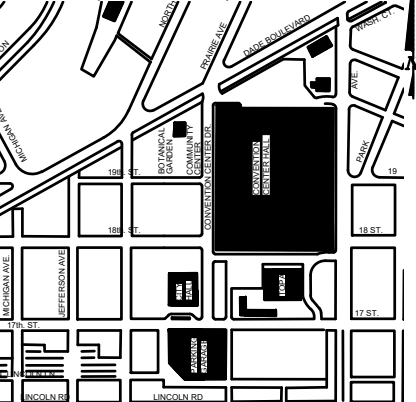


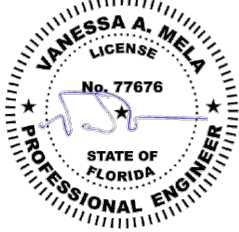

A circular professional engineer seal for Vanessa A. Mela. The outer ring contains the text "VANESSA A. MELA" at the top and "PROFESSIONAL ENGINEER" at the bottom, separated by two stars. Inside the ring, the word "LICENSE" is at the top, "No. 77676" is in the center, and "STATE OF FLORIDA" is at the bottom. A blue ink signature is written across the center of the seal.

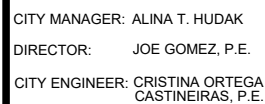

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| 1 | | | |
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ENGINEER OF RECORD: VM
DESIGN ENGINEER: VM
DRAWN BY: KM
CHECKER: WP
SCALE: 1"=5'
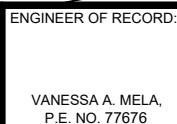
| | |
|---------------|---|
| NEIGHBORHOOD: | MIB-003: CONVENTION CENTER DR & 19TH ST |
| TITLE: | KIOSK MIB-003 ENGINEERING PLAN |

File Name: MIB-003-CIVIL PLANS.dwg


Survey Reference:

Field Book: N/A Page: N/A Work Order: N/A

Date: 02/09/2024 Sheet: 5 of 7 Drawing: **C1-02**

ELECTRICAL PLAN

SCALE: 1"-20'

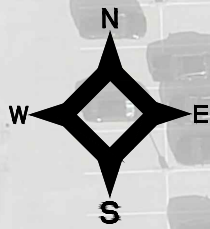

NOTES:

NEW FPL
PULLBOX JB-1

FPL 120/240V
PADMOUNTED
TRANSFORMER

NEW FPL METER

NEW PULLBOX JB-3

8'-4"
CLEAR
DISTANCE

NEW PULLBOX
JB-4


KIOSK MIB-003

NEW PULLBOX
JB-5


20'-4"
CLEAR
DISTANCE

2'-6" FROM
BOC

1'-6" FROM POST
GAURD

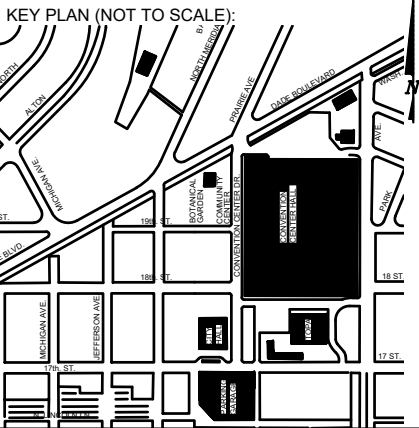

P.E. SEAL:

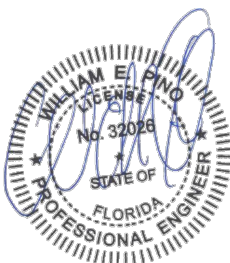

Sunshine811

Call 811 or visit sunshine811.com two full business days before digging to have buried facilities located and marked.
Check positive response codes before you dig!

MIAMI BEACH

CITY MANAGER: ALINA T. HUDAK
DIRECTOR: JOE GOMEZ, P.E.
CITY ENGINEER: CRISTINA ORTEGA CASTINEIRAS, P.E.

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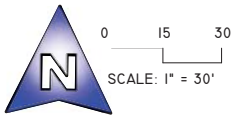
ENGINEER OF RECORD:
WILLIAM E. PINO,
P.E. NO. 32026

ENGINEER OF RECORD: WP
DESIGN ENGINEER: WP
DRAWN BY: KM
CHECKER: WP
SCALE: 1"=20'

NEIGHBORHOOD:
MIB-003: CONVENTION CENTER DR & 19TH ST
TITLE:
KIOSK MIB-003 ELECTRICAL PLAN


File Name: MIB-003-ELECTRICAL & TTC PLANS.dwg
Survey Reference:
Field Book: N/A Page: N/A Work Order: N/A
Date: 02/09/2024 Sheet: 6 of 7 Drawing: E1-01

SPECIFIC PURPOSE SURVEY



LEGEND & ABBREVIATIONS

| | |
|---------|------------------------------------|
| | = CONCRETE (CONC.) |
| | = CONCRETE BLOCK WALL |
| | = WOOD DECK |
| | = COVERED AREA |
| | = ASPHALT |
| | = TILE |
| | = PAVERS |
| | = STONE |
| | = CHAIN LINK FENCE (CLF) |
| | = WOOD FENCE (WF) |
| | = IRON METAL BARS FENCE (IF) |
| | = OVERHEAD WIRES |
| | = WATER VALVE (WV) |
| | = POWER POLE (PP) |
| | = GUY ANCHOR |
| | = WATER METER (WM) |
| | = CONC. LIGHT POLE (LP) |
| | = ELECTRIC BOX (EB) |
| | = STREET SIGN |
| | = SANITARY MANHOLE |
| | = DRAINAGE MANHOLE |
| | = MANHOLE |
| | = TELEPHONE MANHOLE |
| | = FIRE HYDRANT |
| | = CABLE BOX (CATV) |
| | = IRRIGATION VALVE (IV) |
| | = CATCH BASIN OR INLET |
| | = EXISTING ELEVATION |
| | = CONCRETE COLUMNS |
| | = TREE (NO IDENTIFIED) |
| | = PALM (NO IDENTIFIED) |
| PT | = POINT OF TANGENCY |
| PC | = POINT OF CURVATURE |
| PCC | = POINT OF COMPOUND CURVE |
| PRC | = POINT OF REVERSE CURVE |
| BM | = BENCH MARK |
| BR | = BEARING REFERENCE |
| DWP | = DETECTABLE WARNING PAD |
| DEPR. | = DEPRESSED |
| EL | = PROPERTY LINE |
| CL | = CENTER LINE |
| BL | = BASE LINE |
| PSM | = PROFESSIONAL SURVEYOR AND MAPPER |
| C&G | = CURB & GUTTER |
| GA | = GUY ANCHOR |
| ENCR | = ENCROACHMENT |
| VG | = VALLEY GUTTER |
| (XX-XX) | = DENOTES PLAT BOOK XX - PAGE XX |
| ORB | = OFFICIAL RECORD BOOK |
| CBS | = CONCRETE BLOCK STRUCTURE |
| R/W | = RIGHT OF WAY |
| ELECT | = ELECTRIC |
| SEC | = SECTION |
| T | = TOWNSHIP |
| R | = RANGE |
| (M) | = FIELD MEASURED |
| (C) | = CALCULATED |
| (R) | = RECORD |
| (P) | = PER PLAT |

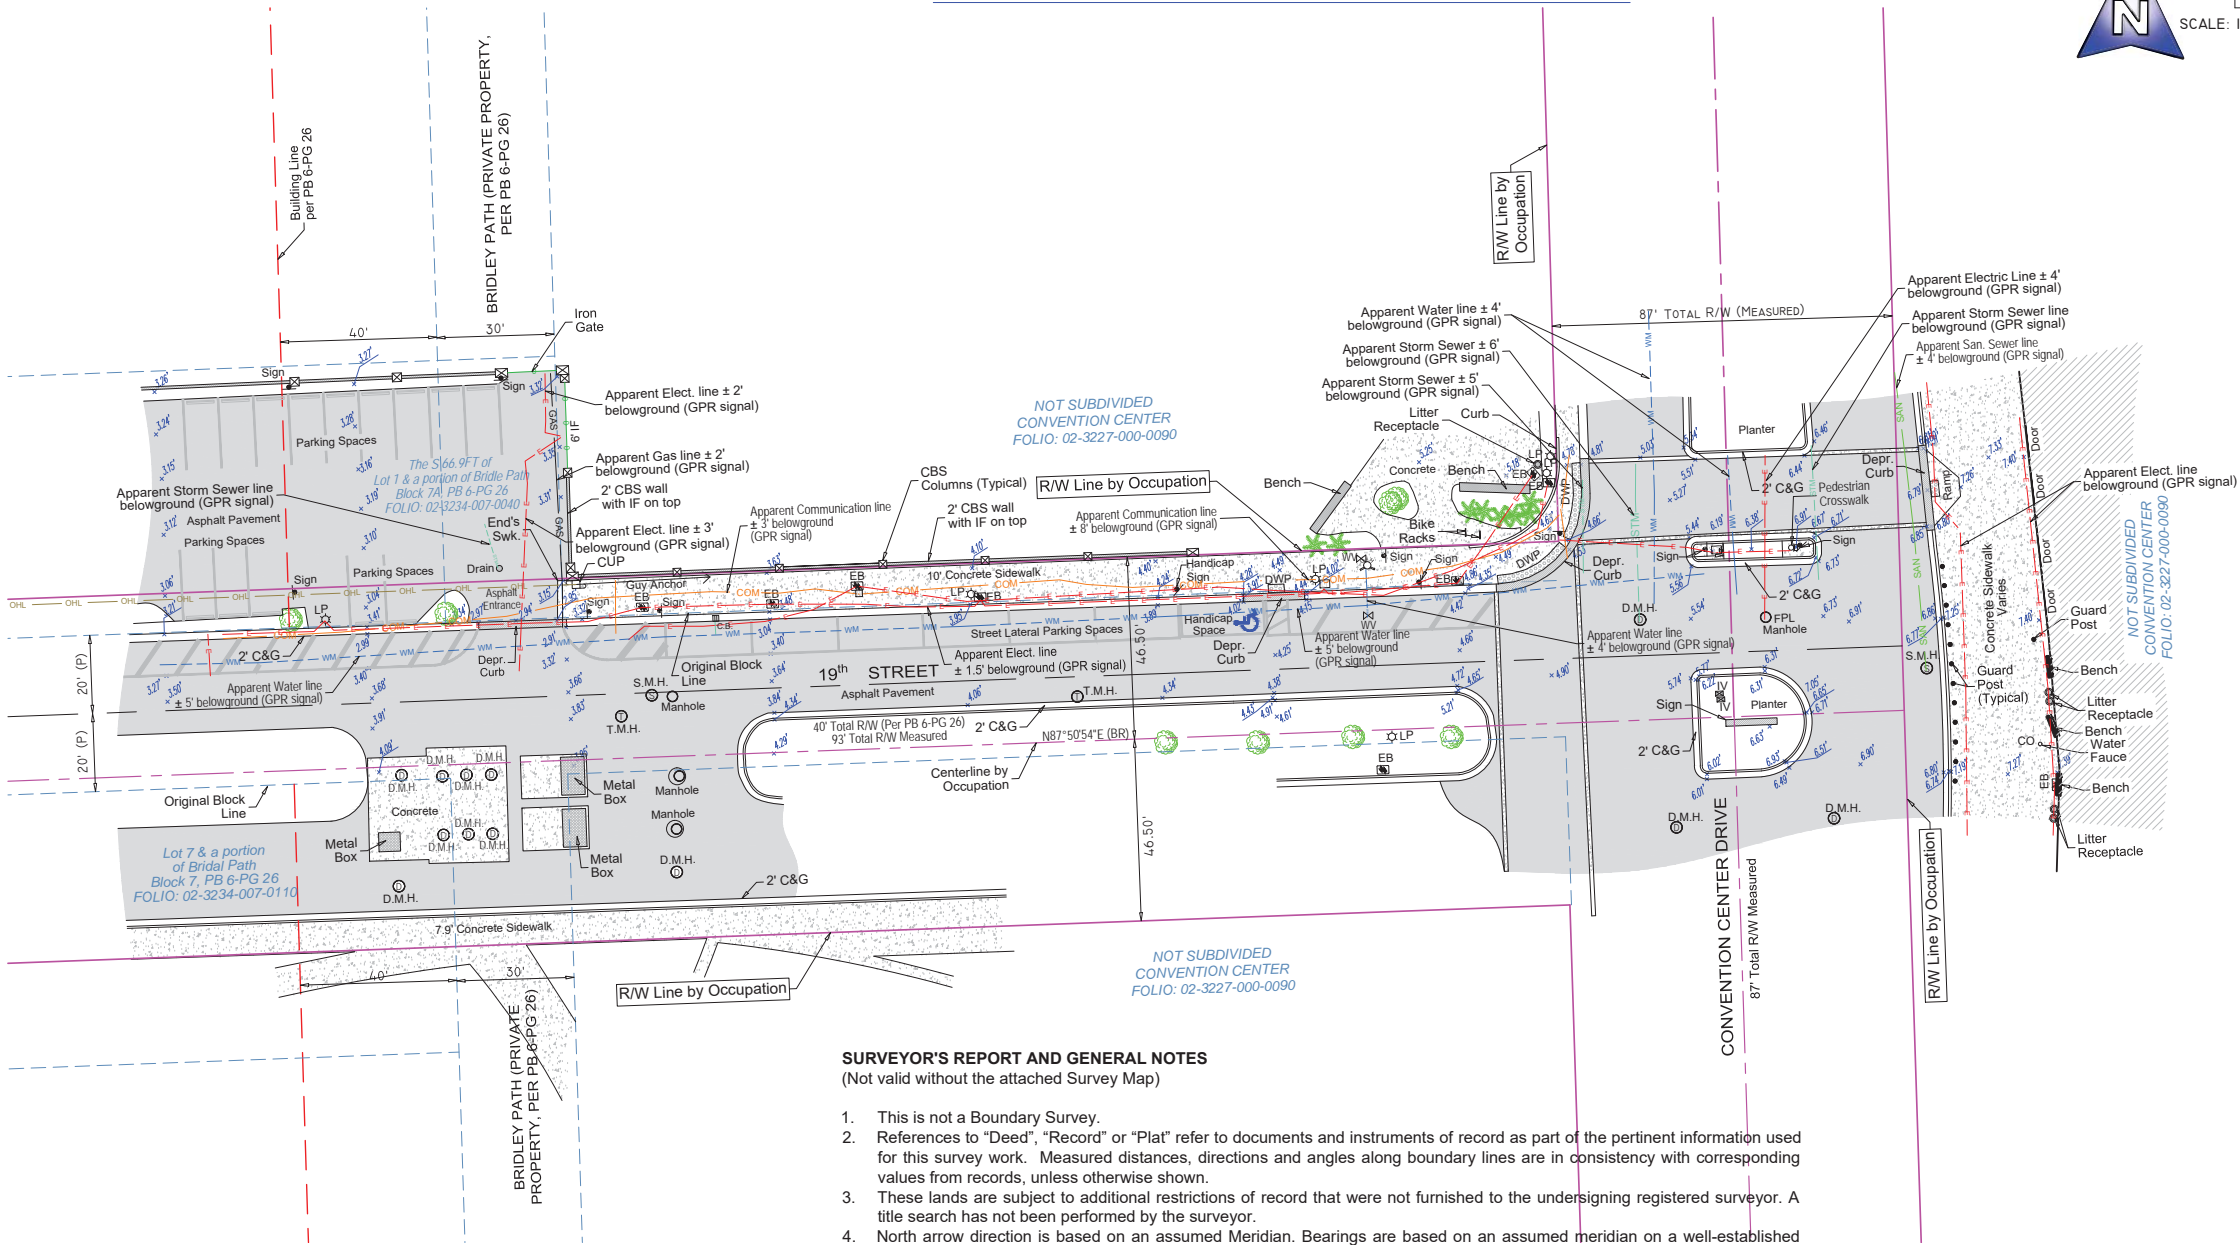

SURVEYOR'S REPORT AND GENERAL NOTES
(Not valid without the attached Survey Map)

- This is not a Boundary Survey.
- References to "Deed", "Record" or "Plat" refer to documents and instruments of record as part of the pertinent information used for this survey work. Measured distances, directions and angles along boundary lines are in consistency with corresponding values from records, unless otherwise shown.
- These lands are subject to additional restrictions of record that were not furnished to the undersigning registered surveyor. A title search has not been performed by the surveyor.
- North arrow direction is based on an assumed Meridian. Bearings are based on an assumed meridian on a well-established line, said line is being noted as BR on the Survey Map.
- Only above ground improvements are shown herein. Foundations, underground features and utilities have not been located.
- Survey markers found in the field have no identification unless otherwise shown. Any survey marker set by our company is labeled LB 7262 or PSM 6169.
- This Survey Map is intended to be displayed at the scale shown hereon. Data is expressed in U.S. Survey Foot.
- This Survey Map is being prepared for the use of the party/parties that it is certified to and does not extend to any unnamed individual, entity or assignee.
- FLOODPLAIN INFORMATION:** As scaled from Federal Insurance Rate Map (FIRM) of Community No. 120651 (City of Miami Beach), Panel 0319, Suffix L, revised on Sept 11th, 2009, this real property falls in Zone "X" and "AE" with Base Flood Elevation 8 feet (NGVD 1929)
- HORIZONTAL ACCURACY:** Accuracy obtained thru measurements and calculations meets and exceeds the minimum horizontal feature accuracy for a Suburban area being equal to 1 foot in 7,500 feet.
- VERTICAL CONTROL AND ACCURACY:** The elevations as shown are referred to the National American Vertical Datum of 1988 (NAVD 1988). The closure in feet, as computed, meets the standard of plus or minus 0.05 feet times the squared root of the loop distance in miles. Elevation are based on a level loop from and to the following official Bench Marks:
Bench Mark # 1: City Miami Beach Bench Mark CMB MA 12, Elevation = 7.56 feet (NAVD'88)
Description: PK Nail & washer in traffic separator @ south side of Dade Boulevard & Meridian Avenue.
Bench Mark # 2: City Miami Beach Bench Mark CMB 17 CH, Elevation = 2.46 feet (NAVD'88)
Description: Nail & washer @ Southeast quadrant of intersection Meridian Avenue & 17th Street.

SUE NOTES:

- Data collected for this Survey had been determined using GNSS (RTK/GPS) conventional TS and differential leveling. Dimensions obtained are subject to equipment limitations.
- Subsurface Utility investigation was performed as part of this survey using GPR (Ground Penetrating Radar) and RD (Radiodetection Technology) for designation and location of underground facilities. This Survey depicts apparent location of underground piping found during this investigation. This method accuracy is plus or minus 1.5 feet approximately. There might be additional underground facilities not discovered at the time of this survey.

| | |
|--|---|
| | = RED PAINT LINE APPARENT ELECTRIC CONDUIT |
| | = BLUE PAINT LINE APPARENT WATER LINE |
| | = GREEN PAINT LINE APPARENT SANITARY SEWER LINE |
| | = YELLOW PAINT LINE APPARENT GAS LINE |
| | = ORANGE PAINT LINE APPARENT COMMUNICATION LINE |
| | = GREEN PAINT LINE APPARENT STORM SEWER LINE |


I HEREBY CERTIFY TO:
Main Street Engineering
That this Survey conforms to the Standards of Practice as set forth by the Florida Board of Professional Surveyors and Mappers in applicable provisions of Chapter 5J-17, Florida Administrative Code pursuant to Section 472.027 Florida Statutes. This Survey is accurate and correct to the best of my knowledge and belief.

Odalys C Bello
c=US, o=Bello and Bello Land
Surveying Corp.,
dnQualifier=A01410C00000188
4E3B67E8000DD40A, cn=Odalys
C Bello
2023.08.02 09:08:54 -04'00'

Odalys C. Bello-Iznaga
Professional Surveyor and Mapper LS6169 - State of Florida
Field Work Date: 08/01/2023

Additions and deletions to this Survey Map are prohibited. This Survey Map and Report are not valid without the signature and original raised seal or without the authenticated electronic signature and seal of the undersigning Florida licensed Surveyor and Mapper.

Property Address:
1901 Convention Center Drive, Miami Beach, Florida 33125
Project No. 23181 D.B.: EO Page 1 of 1

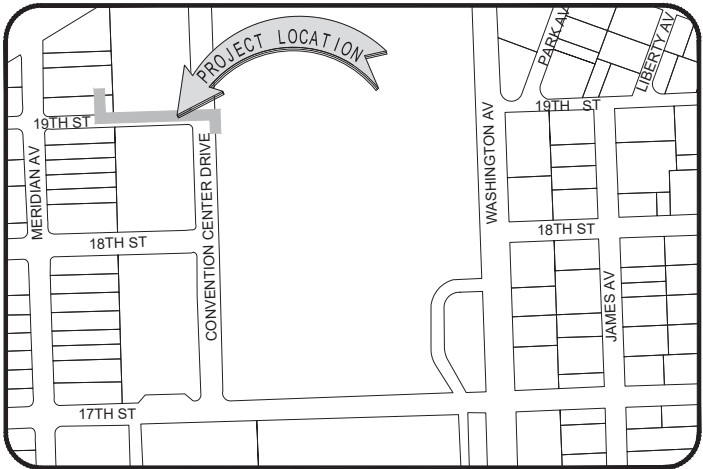

LOCATION MAP

Not to Scale

BELLO & BELLO LAND SURVEYING
12230 SW 131 AVENUE • SUITE 201 • MIAMI FL 33186
Phone: 305.251.9606 • Fax: 305.251.6057 • LB#7262
e-mail: info@belloand.com • www.belloandsurveying.com




1. VIEW OF SITE FROM NORTH



2. VIEW OF SITE FROM NORTHWEST

● TEAL CIRCLES: PHOTOGRAPHER'S APPROXIMATE POSITION
 ● RED CIRCLE: APPROXIMATE KIOSK POSITION

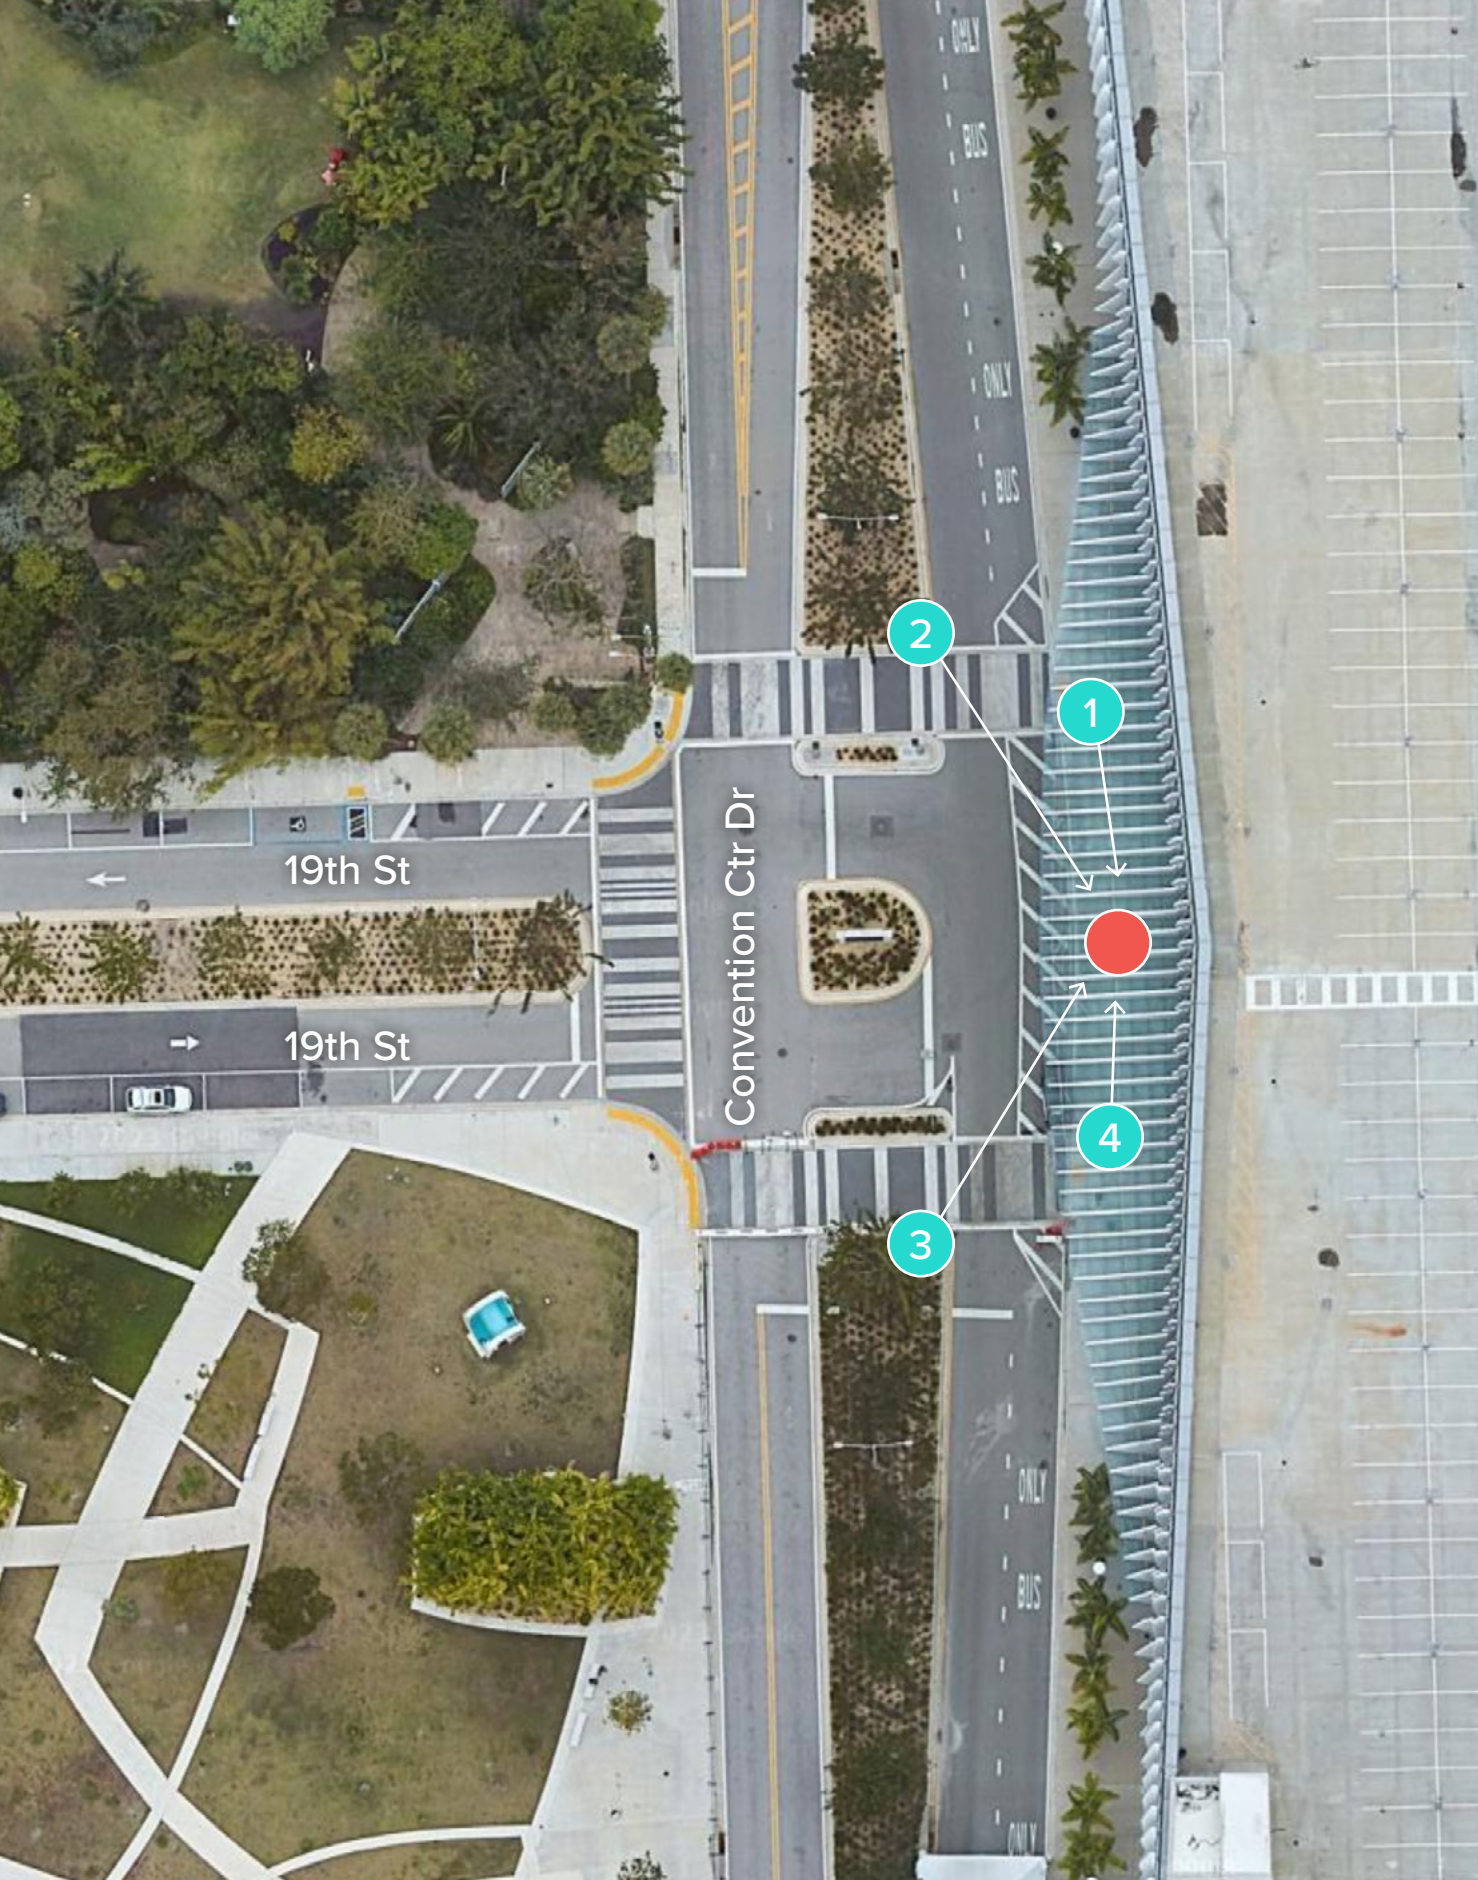

● TEAL CIRCLES: PHOTOGRAPHER'S APPROXIMATE POSITION
 ● RED CIRCLE: APPROXIMATE KIOSK POSITION



MIAMI BEACH

PUBLIC WORKS DEPARTMENT LINCOLN ROAD & ALTON ROAD (SR-907) INTERACTIVE DIGITAL KIOSK DEPLOYMENT PROJECT FEBRUARY 2024 IKE SMART CITY MIB-017

CITY OF MIAMI BEACH

MAYOR: STEVEN MEINER

COMMISSIONERS: KRISTEN ROSEN GONZALEZ
LAURA DOMINGUEZ
ALEX J. FERNANDEZ
TANYA K. BHATT
DAVID SUAREZ
JOSEPH MAGAZINE


CITY MANAGER: ALINA T. HUDAK

CITY ATTORNEY: RAFAEL A. PAZ

PUBLIC WORKS DIRECTOR: JOE GOMEZ, P.E., F.FES

CITY ENGINEER: CRISTINA ORTEGA

Always call 811 two full business days before you dig to
have underground utilities located and marked.

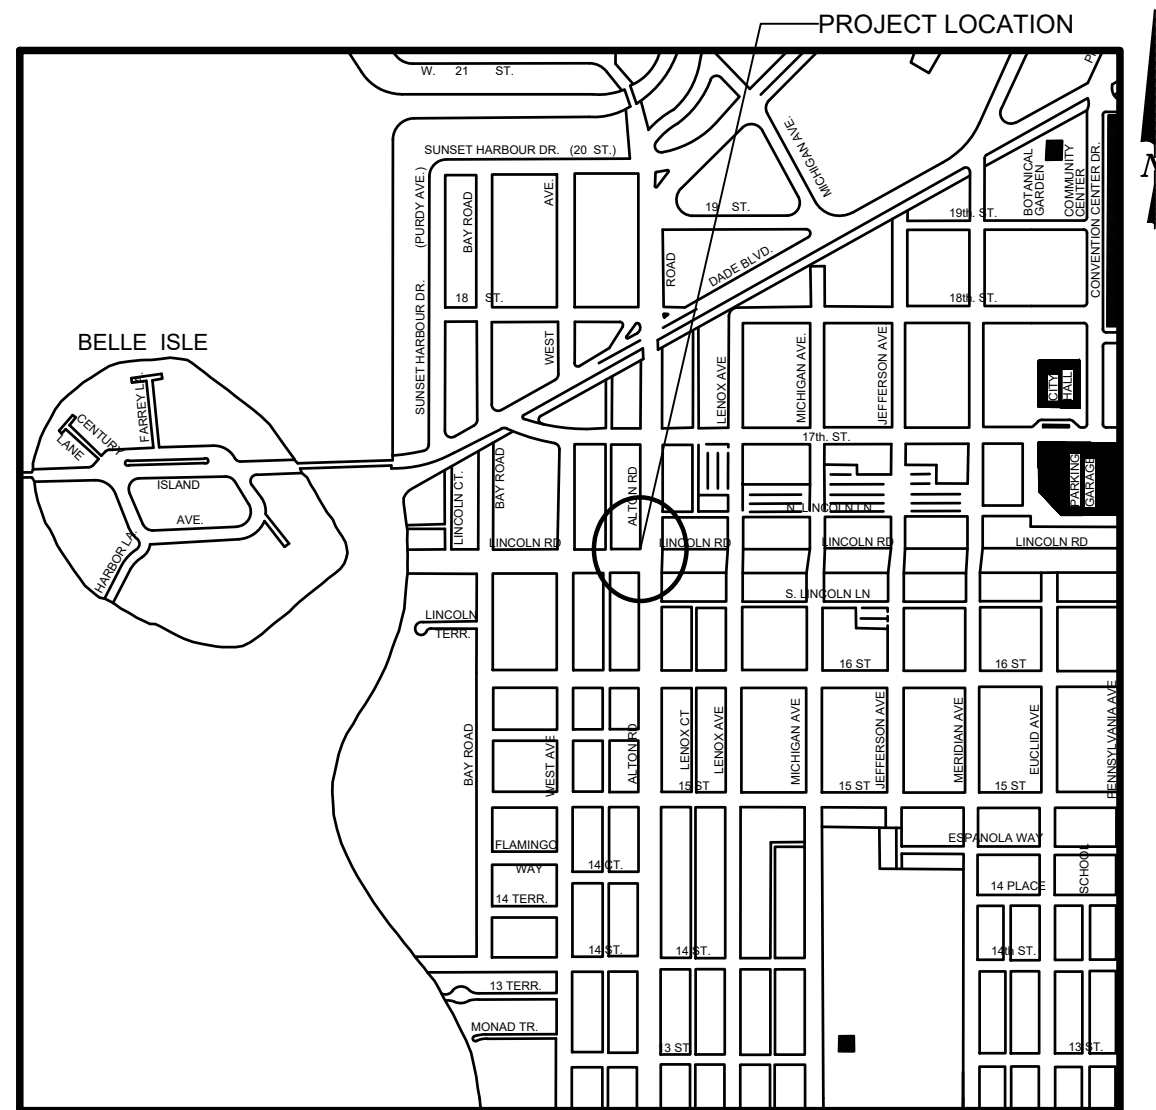

LOCATION MAP



INDEX OF PLANS

| NUMBER | DISCIPLINE | SHEET NO. | DESCRIPTION | NOTES |
|--------|------------|-----------|-------------|-------|
| 1 | GENERAL | G0-01 | COVER SHEET | |

SCOPE OF WORK: THE PROJECT CONSISTS OF THE INSTALLATION OF ONE (1) DIGITAL INTERACTIVE KIOSK AND APPLICABLE INFRASTRUCTURE; STRUCTURAL FOUNDATION AND ELECTRICAL SERVICE AT THE LOCATION INDICATED ON THESE DESIGN PLANS.

ENGINEER OF RECORD: VANESSA A. MELA, P.E. NO. 77676

Work Order _____ Sheet 1 of 1 Drawing **G0-01**

6. Lincoln Rd & Alton Rd - Plans

Due to the ongoing construction at this intersection as a result of the CitizenM Hotel development, the sidewalk is currently obstructed by construction fencing. Therefore, this location could not be surveyed due to the inaccessibility of the site. However, once the location is accessible, the plan sets shall reflect what the intersection will look like post-construction.