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1940 BAY DRIVE

FINAL SUBMITTAL 11/05/2023

DRB File No. 23-0934

REQUESTED DEVIATIONS:

WAIVER FOR LOT COVERAGE VARIANCE FOR INGRESS/EGRESS DRIVE

A DEVELOPMENT OF:

1940 APARTMENTS , LLC. 16690 COLLINS AVE SUNNY ISLES, FL. 33160

ARCHITECTURE:

REVUELTA ARCHITECTURE INTERNATIONAL, PA. 2950 SW 26TH AVE., SUITE 110 MIAMI, FL. 33133 T: 305.590.5000

LANDSCAPE ARCHITECT

GARDNER + SEMLER 17670 NW 78TH AVENUE MIAMI , FL 33015 T: 305.392.1019



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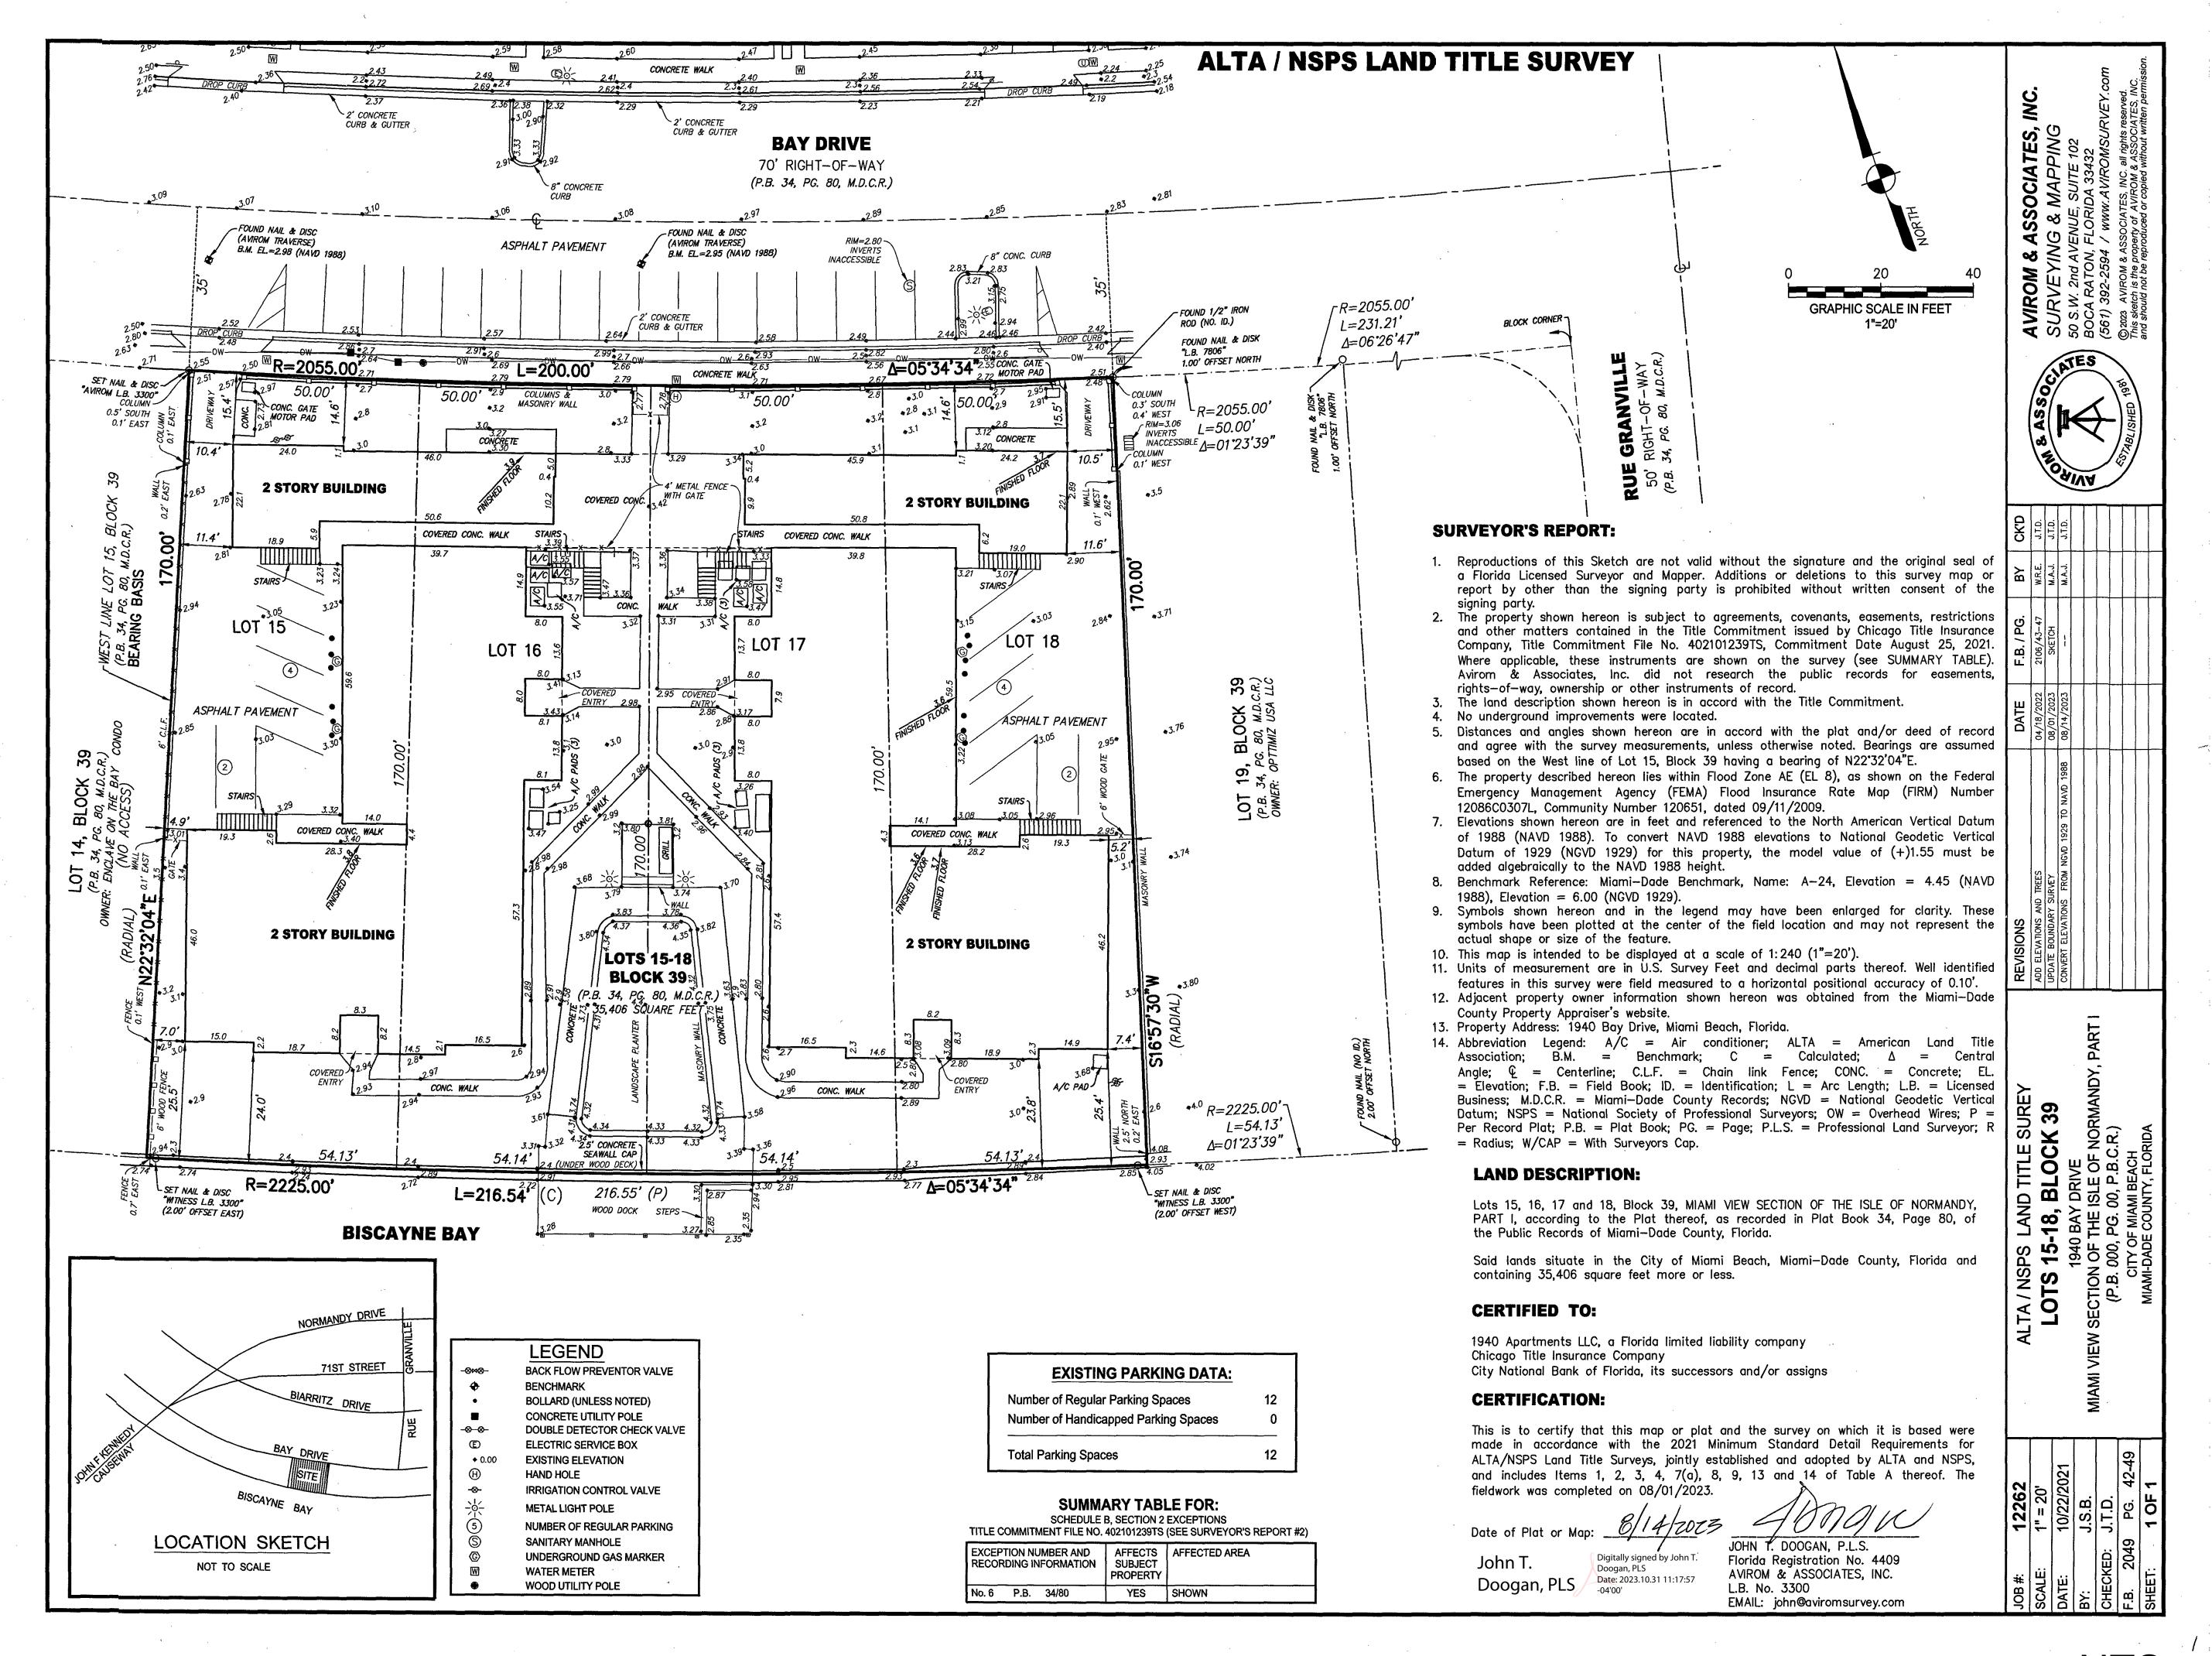
RESPONSES TO COMMENTS


RESPONSES TO COMMENTS **A-000**

Plan Correction Report Matrix Date: 10.30.2023

Plan Address: 1940 Bay Dr., Miami Beach, FL 33141-6900 1st App. Date: 05.17.2023 (DRB23-0934)

	Reference St 7400
	TA 400
or a total of 15 street parking spaces. Existing 18 street required to provide access to the property.	A-100
	A-000
	A-000
TURE ADDED.	A-003.2
on of all structures on site.	A-003.3
	A-015
	A-003.1
	A-006
esidential uses, lobbies or stoops = 50% = 81'-11" Frontage mensions added Sheet A-100 First Floor Plan, Staircase	
ded to provide the required radius for a perty. Fire truck needs to be a minimum of 50' from main ariance Required for Entry and Exit FEMA requirements cannot be Dry-Flood Proofed. Only I. All proposed uses including Parking have been proposed	A-100
includes solid walls to avoid lighting spillage, architectural A-401	A-100 A401 LA - 401
)2	A-502
more suitable for single s less intense. In multifamily projects pavers on slab is stense vehicular traffic.	
d to Section in sheet A-502	A-502
is 4.7 NAVD (6.47 NGVD) . sed on adjusted grade per Public Works Department is D. GVD + 30"= 10'-2" NGVD which per Section 142- ta Sheet A-001	A-001
counted	A-009 to A-01
part of the hatched area	A-009 to A-01
more suitable for single s less intense. In multifamily projects pavers on slab is ore intense vehicular traffic.	A-009
	A-401 to A-40501, A-502
nave been added to all plans and to the site setback	A-004 & A-00
vel below: 50% of 10,018sf)	A-105
a. Congreation spaces for reading, hammok and relaxation	A-100
5% of 20'-0= 5'-0" therefore the proposed 2'-9" complies. on 6'-7". (See dimension in A-100 First Floor Plan)	A-100
to 8'-8 1/2"	A-100
complies with the minimum side setback for accessory	A-100
	A-401



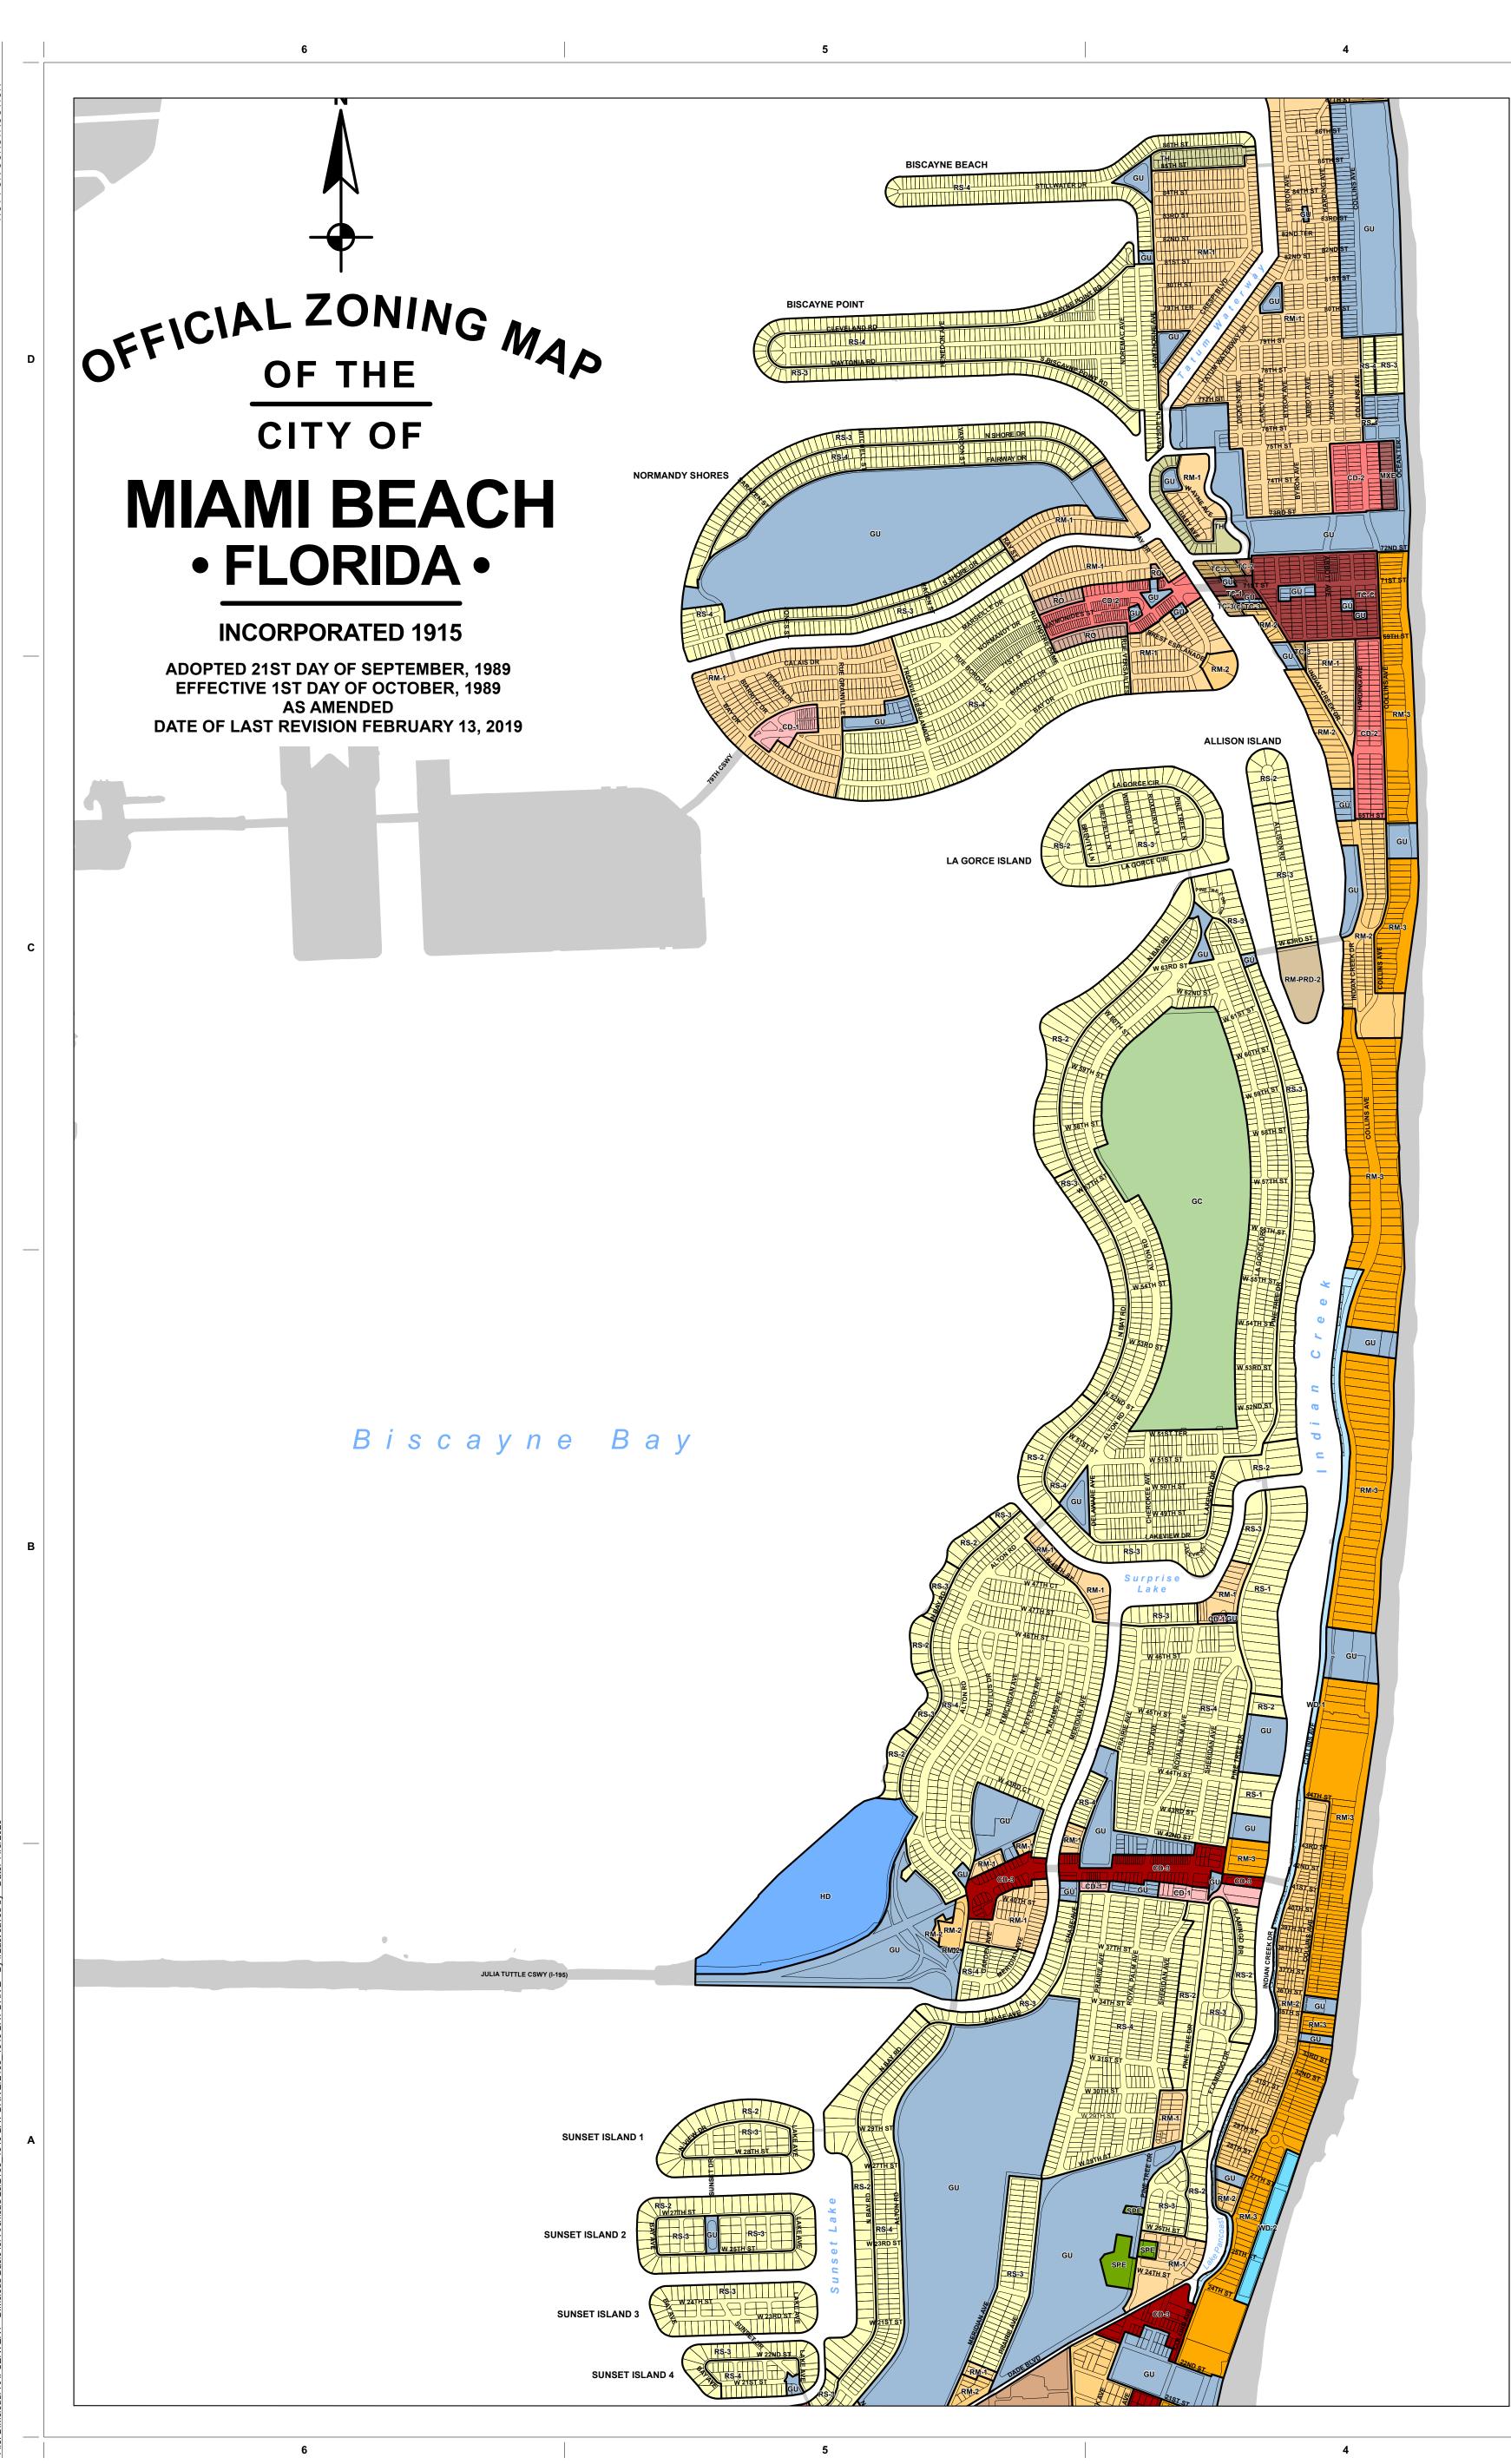

1	g Information				
	Address:	1940 Bay Drive			
	Board and File Numbers:	00 0040 000 4000			
	Folio Number(s): Year Constructed:	02-3210-002-1200 1955			
	Zoning District	RM-1			
	 	Residential	Proposed use:	Residential	
	Based Flood Elevation:	8'-0" N.G.V.D.	Grade value in NGVD:	N.G.V.D.	
	-	Proposed (B.F.E. + 5 feet):		······································	······································
	Maximum Lot Coverage ≤ 45%	15,932.7 SF	Proposed:	17,303 SF	Waiver Required 1,371
	Minimum Lot Area Required	5600 SF 50'-0"	Lot Width	35,406 SF (0.81 Acre)	
	Minimum Lot Width Required; Minimum Yard Elev. Requirements		Minimum Yard Elevation proposed:	200 feet to 216.54 feet 6'-7" N.G.V.D.	
	•	,		6'-7" N.G.V.D.	
	·	≤ 30" above existing sidewalk elevation	Proposed:		
	the 1st 4 ft of the property facing a street				
		≤ 11% (5:1 horizontal; vertical)	Proposed:		
	facing a street				
di	ng Data	Required		Proposed	Deficiencies
	Max. FAR Maximum Building Height	44257.5 55'-0"		44,252.15 SF 55'-0"	
	Ground floor minimum height	12' from BFE+ minimum freeboard	this requirement may be waived by up 2 feet		
_	Minimum Unit Size	New Construction - 550 SF	The state of the s	2808.5 SF	
_	Average Unit Size	New Construction - 800 SF		2924.33 SF	
_	Number of Stories	N/A		5	
	Gross square footage	A I / A		76,371.25 SF	
	Square Footage by use	N/A		N/A 12	
ha:	Number of units Residential	N/A	equired	12 Proposed	Deficionaica
Jd	At Grade Parking:	Re	-quii cu	Proposed	Deficiencies
	Front Setback (BAY DRIVE)	20 feet		20 feet	
	Side Setback	8% lot width for lot ≥ 65 feet in width	16'-2" to 17'-2" feet	16'-2" to 17'-2" feet	
	Rear Setback (BISCAYNE BAY)	10% of lot depth	17.0 feet	17 feet	
	Pedestal:				
	Front Setback (OCEAN DRIVE)	20 feet		20 feet	
	Side Setback	8% lot width for lot ≥ 65 feet in width 10% of lot depth	2 16'-8" to 17'-8" feet 17 feet	16'-8" to 17'-8" feet 3	
	Rear Setback (BISCAYNE BAY) Tower (above 50 feet):	10 % of lot deptil	17 1881	17 1661	
	,	20 ft+ 1 ft for every 1 ft increase in height		25 feet (20+5 feet height increase)	
		above 50 feet			
	Side Setback:	Pedestal setback + 10% of the height	16'-8" to 17'-8" feet	16'-8" to 17'-8" feet	
	De an Outle de	of the tower	25'.2"	25.57	
	Rear Setback:	15% of lot depth	25'-6"	25.5 feet	
kir		D ₀	equired	Proposed	Deficiencies
rAII	Parking district		rict No. 1	Fioposeu	Delicielicies
	Total # of parking spaces		spaces	24 spaces	
	# of parking spaces per use (Provide a		•	1	
	separate chart for a breakdown	see cl	hart below		
	Parking Space Dimensions	one-half feet and a length of not less that with two feet of pervious overhang, in plat concrete curb, for a total length of 18 feet area overhang in standard parking spat planning and zoning director in those instance, however, shall the length of than 18 feet, unless otherwise provided for	shall have a width of not less than eight and in 18 feet, or when located outdoors, 16 feet ace of wheel stops and defined by continuous it. The provision of having a two-foot pervious aces may be waived at the discretion of the tances where said overhang is not pratical. In any standard off-street parkind space be less or under sections 130-101, 130-251, 130-281, 130-61(2) herein.	8'-6" x 18'-0"	
	Parking Space configuration (45°,60°,			90°	
	90°, Parallel)		1	1	
	ADA Spaces Tandem Spaces		1	1	
	Drives (sec. 130-64)	way traffic. Notwithstanding the foregoing units, drives shall have aminimum width o level parking areas with less than ten par underneath a building or structure, the to	2 feet for two-way traffic and 11 feet for one g, for residential buildings with fewer than 25 f 18 feet for two-way traffic.c. For those grade king spaces, inclusive of those parking areas wo-way curb-cut anddriveway entrance shall m width of 12 feet.	•	Aisles reduced by with 90 degree parking = 1 foot
}	Valet drop off and pick up			NO	
	Loading zones and Trash collection	N/A			
	areas	IW/A			
	Bicycle Parking / Racks			5	
_			PARKING SPACES CALCULA	TION	
/ .	NUMBER OF PARKING SPACES	UNIT SIZE [SF]	NUMBER OF UNITS	REQUIRED PARKING SPACES	PROPOSED PARKING SPACES
	2 PSACES / UNIT	> 1,600	12	24	24
		TOTAL		24	
			PARKING REDUCION		
			TOTAL REQUIRED PARKING	24	24
			BYCICLE PARKING REQUIRE		DD 0 0 0 0 0 0 0 0 0 0 0 0 0 0 0 0 0 0
_				REQUIRED	PROPOSED
•	CHODT TEDM OD A OF O			Λ	^
V .	SHORT TERM SPACES			0	0
	SHORT TERM SPACES LONG TERM SPACES	TOTAL		0 0 n	0 5 5

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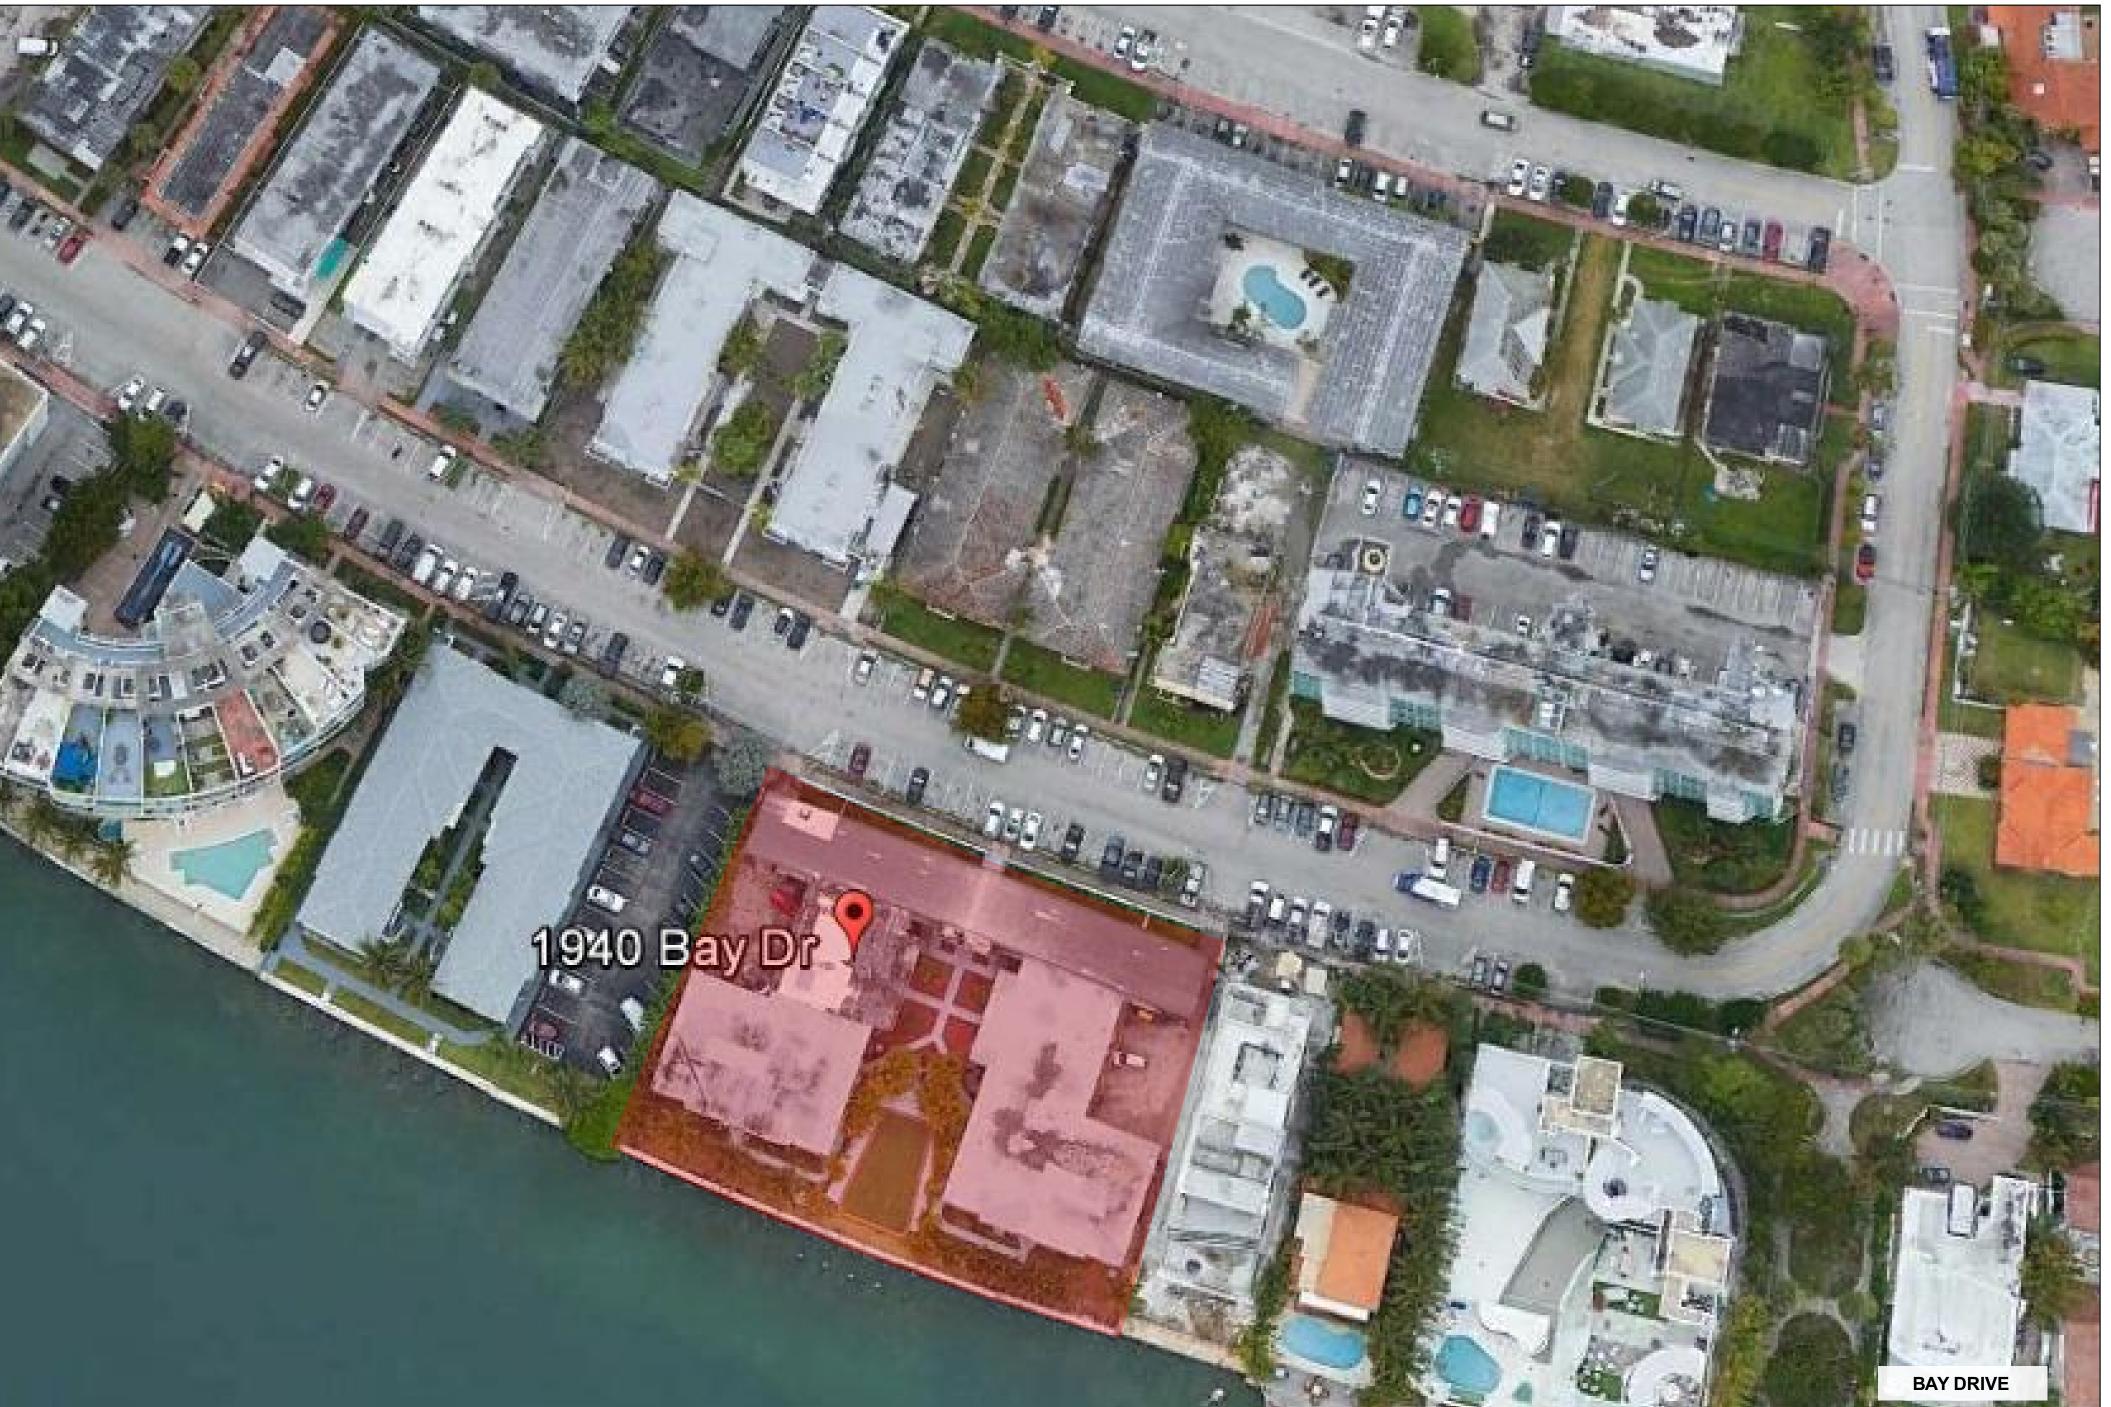
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MIAMI BEACH





1 LOCATION MAP
SCALE: 1:0.5263

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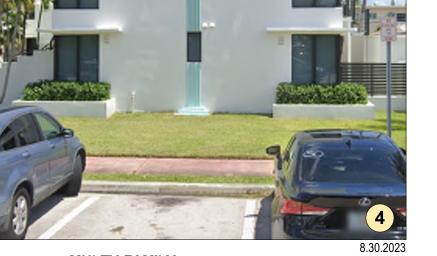
Luis O. Revuelta AR-0007972 FINAL SUBMITTAL DRB File No. 23-0934 11/05/2023
Scale
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Project No.
2133
Sheet Name

Sheet No.

A-002












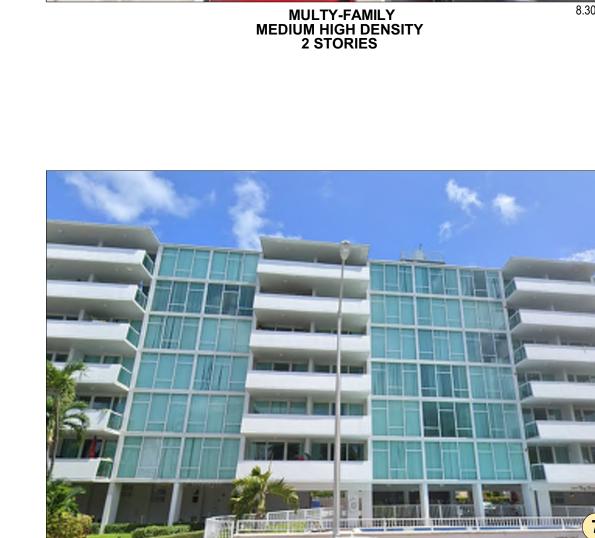





MULTY-FAMILY MEDIUM HIGH DENSITY 2 STORIES








MULTY-FAMILY MEDIUM HIGH DENSITY 12 STORIES

MULTY-FAMILY MEDIUM HIGH DENSITY 2 STORIES



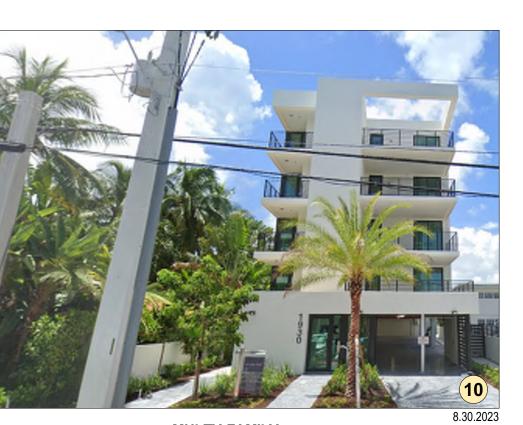



LOCATION MAP

CONTEXT ANALYSIS

A-003

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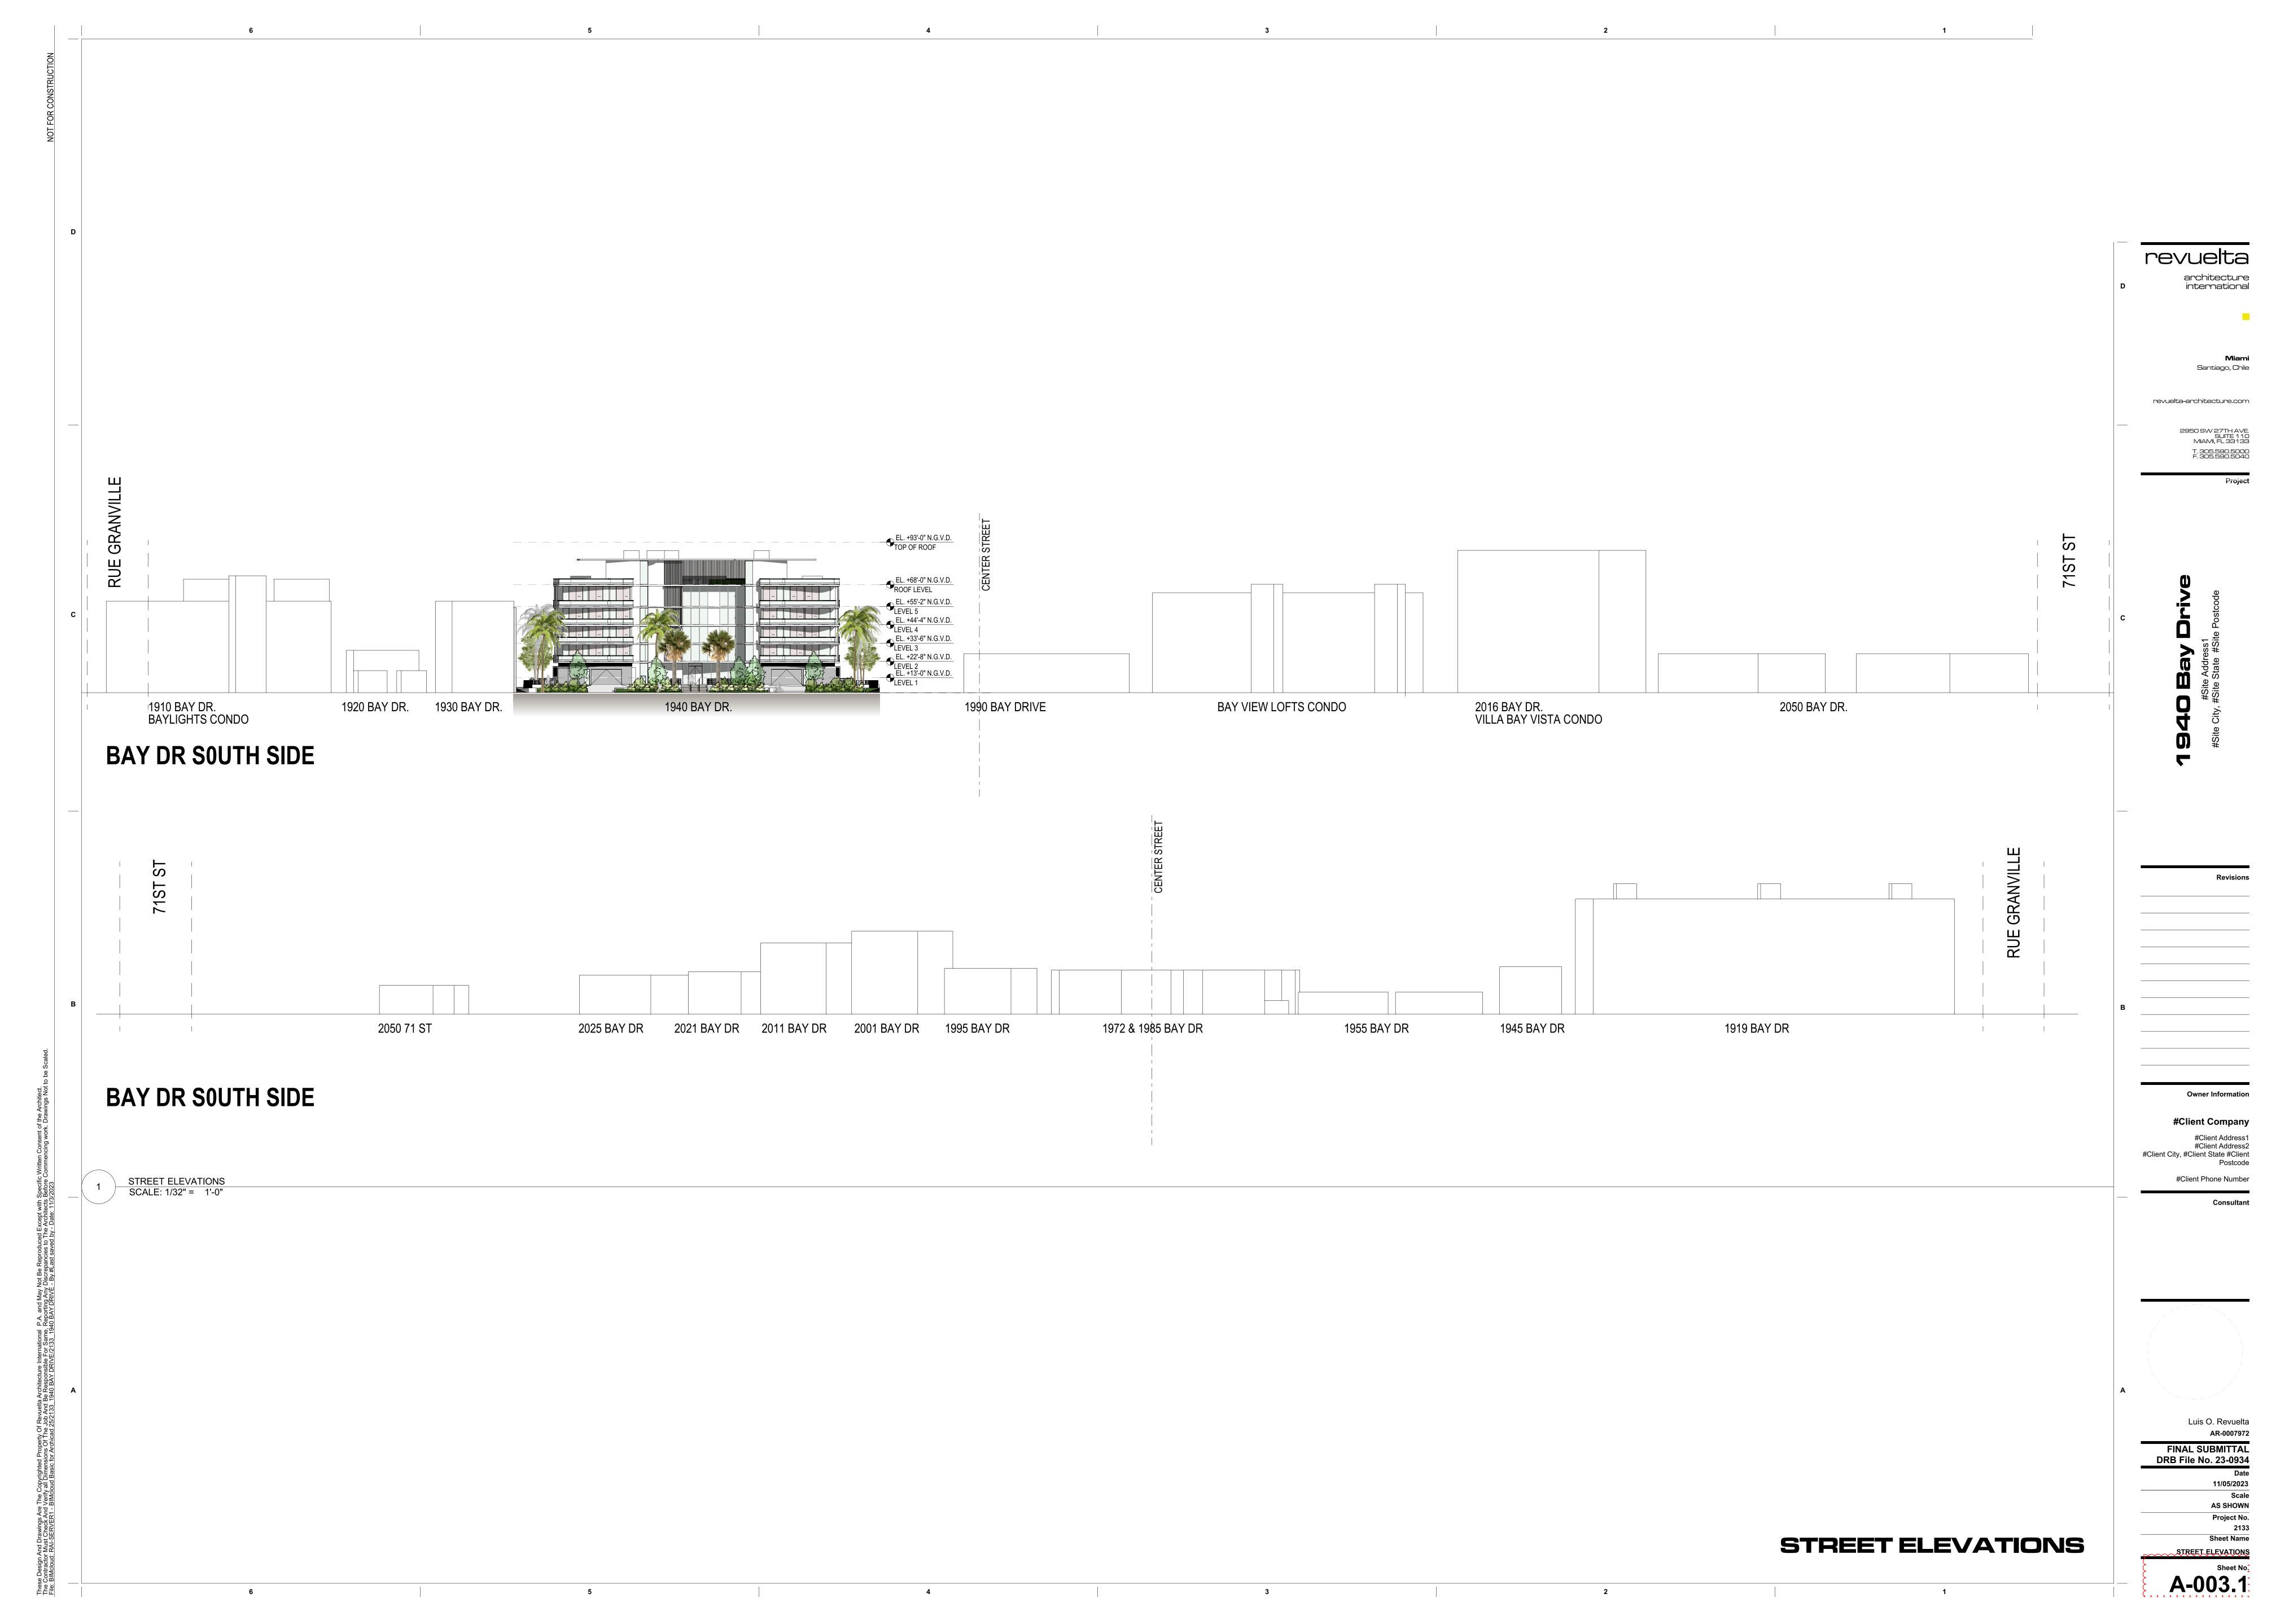
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Sheet Name CONTEXT ANALYSIS







04. SIDE COURT _ 11.3.2023



06. CENTRAL COURT _ 11.3.2023



09. REAR ELEVATIOON _ 11.3.2023









02. FRONT ELEVATIOON _ 11.3.2023





08. CENTRAL COURT _ 11.3.2023



EXISTING BUILDING

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A-003.2



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FINAL SUBMITTAL DRB File No. 23-0934 **AS SHOWN**

PROPERTY LINE 216.55' 17' -0" REAR SETBACK LINE UP TO 50'-0"

10% LOT DEPTH

ARC LENGHT AT SETBACK LINE = 214'-11"


6-0" ALLOWABLE BALCONY PROJECTION ABOVE 50 FEET

MEASURED AT SETBACK LINE 17'-2" 8% of 214'-11" MEASURED AT SETBACK LINE 17'-8" AT 55 FEET Curring huminimum particular p revuelta-architecture.com SUMMARY: LOT AREA: **35,406 SQ FT**FAR: **1.25**FAR ALLOWED AREA: **44,257.5** SQ FT
LOT COVERAGE: 45%: **15,932.7** SQ FT
BUILDING HEIGHT: 50 FEET
WITH A GROUND LEVEL CONSISTING OF
NON-HABITABLE PARKING AND OR AMENITY USES: **55 FEET**MAXIMUM DENSITY: **48 UNITS** 16'-8" AT 55 FEET **PROPERTY LINE 200.00'** GRADE ELEVATION = 4.09' N.G.V.D. LOT AREA = 35,406 FAR = 1.25 FAR AREA = 44,257.5 SF LOT COVERAGE = 45% =15,932.7 SF SITE SETBACK PLAN ANALYSIS

SCALE: 1/8" = 1'-0" 0 4' 8' 16' Sheet Name SITE SETBACK PLAN ANALYSIS

2950 SW 27TH AVE. SUITE 110 MIAMI, FL 33133

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REAR SETBACK LINE UP TO 50' 10% LOT DEPTH TOP OF STRUCTURE 93'-0" N.G.V.D.
MECHANICAL ENCROACHMENTS ABOVE ROOF – TOP OF ELEV. DECK --- ROOF-LEVEL F.F.E. --73'-0" N.G.V.D. ALLOWABLE POOL WATER LEVEL 71'-0" N.G.V.D. ALLOWABLE DECK ABOVE ROOF LEVEL **68'-0" N.G.V.D.** MAX. BUILDING HEIGHT WITH PARKING AND LOBBY AT GRADE **63'-0" N.G.V.D.** MAX. BUILDING HEIGHT 14" DROPPED CEILING THROUGHT UNIT FOR INSULATION AND ROOF DRAINS LEVEL 4 RED SHADED AREA ZONING ALLOWABLE ENVELOPE LEVEL 3 BLUE SHADED AREA SHORELINE ALLOWABLE ENVELOPE TO BE NEGOTIATED WHEN PARKING/AMENITIES PROPOSED AT GRADE,
— 12'-0" MINIMUM TO B.O.SLAB OF FIRST HABITABLE LEVEL FROM BFE+1
DRB MAY REDUCE REQUIREMENT TO 10'-0" 13'-0" N.G.V.D. DFE (BFE + 5 FEET) - MEASUREMENT REF. LEVEL MIN./MAX. SIDE YARDS ELEVATION 6'-7" N.G.V.D. +/- 4'-1" N.G.V.D. EXISTING GRADE ELEVATION

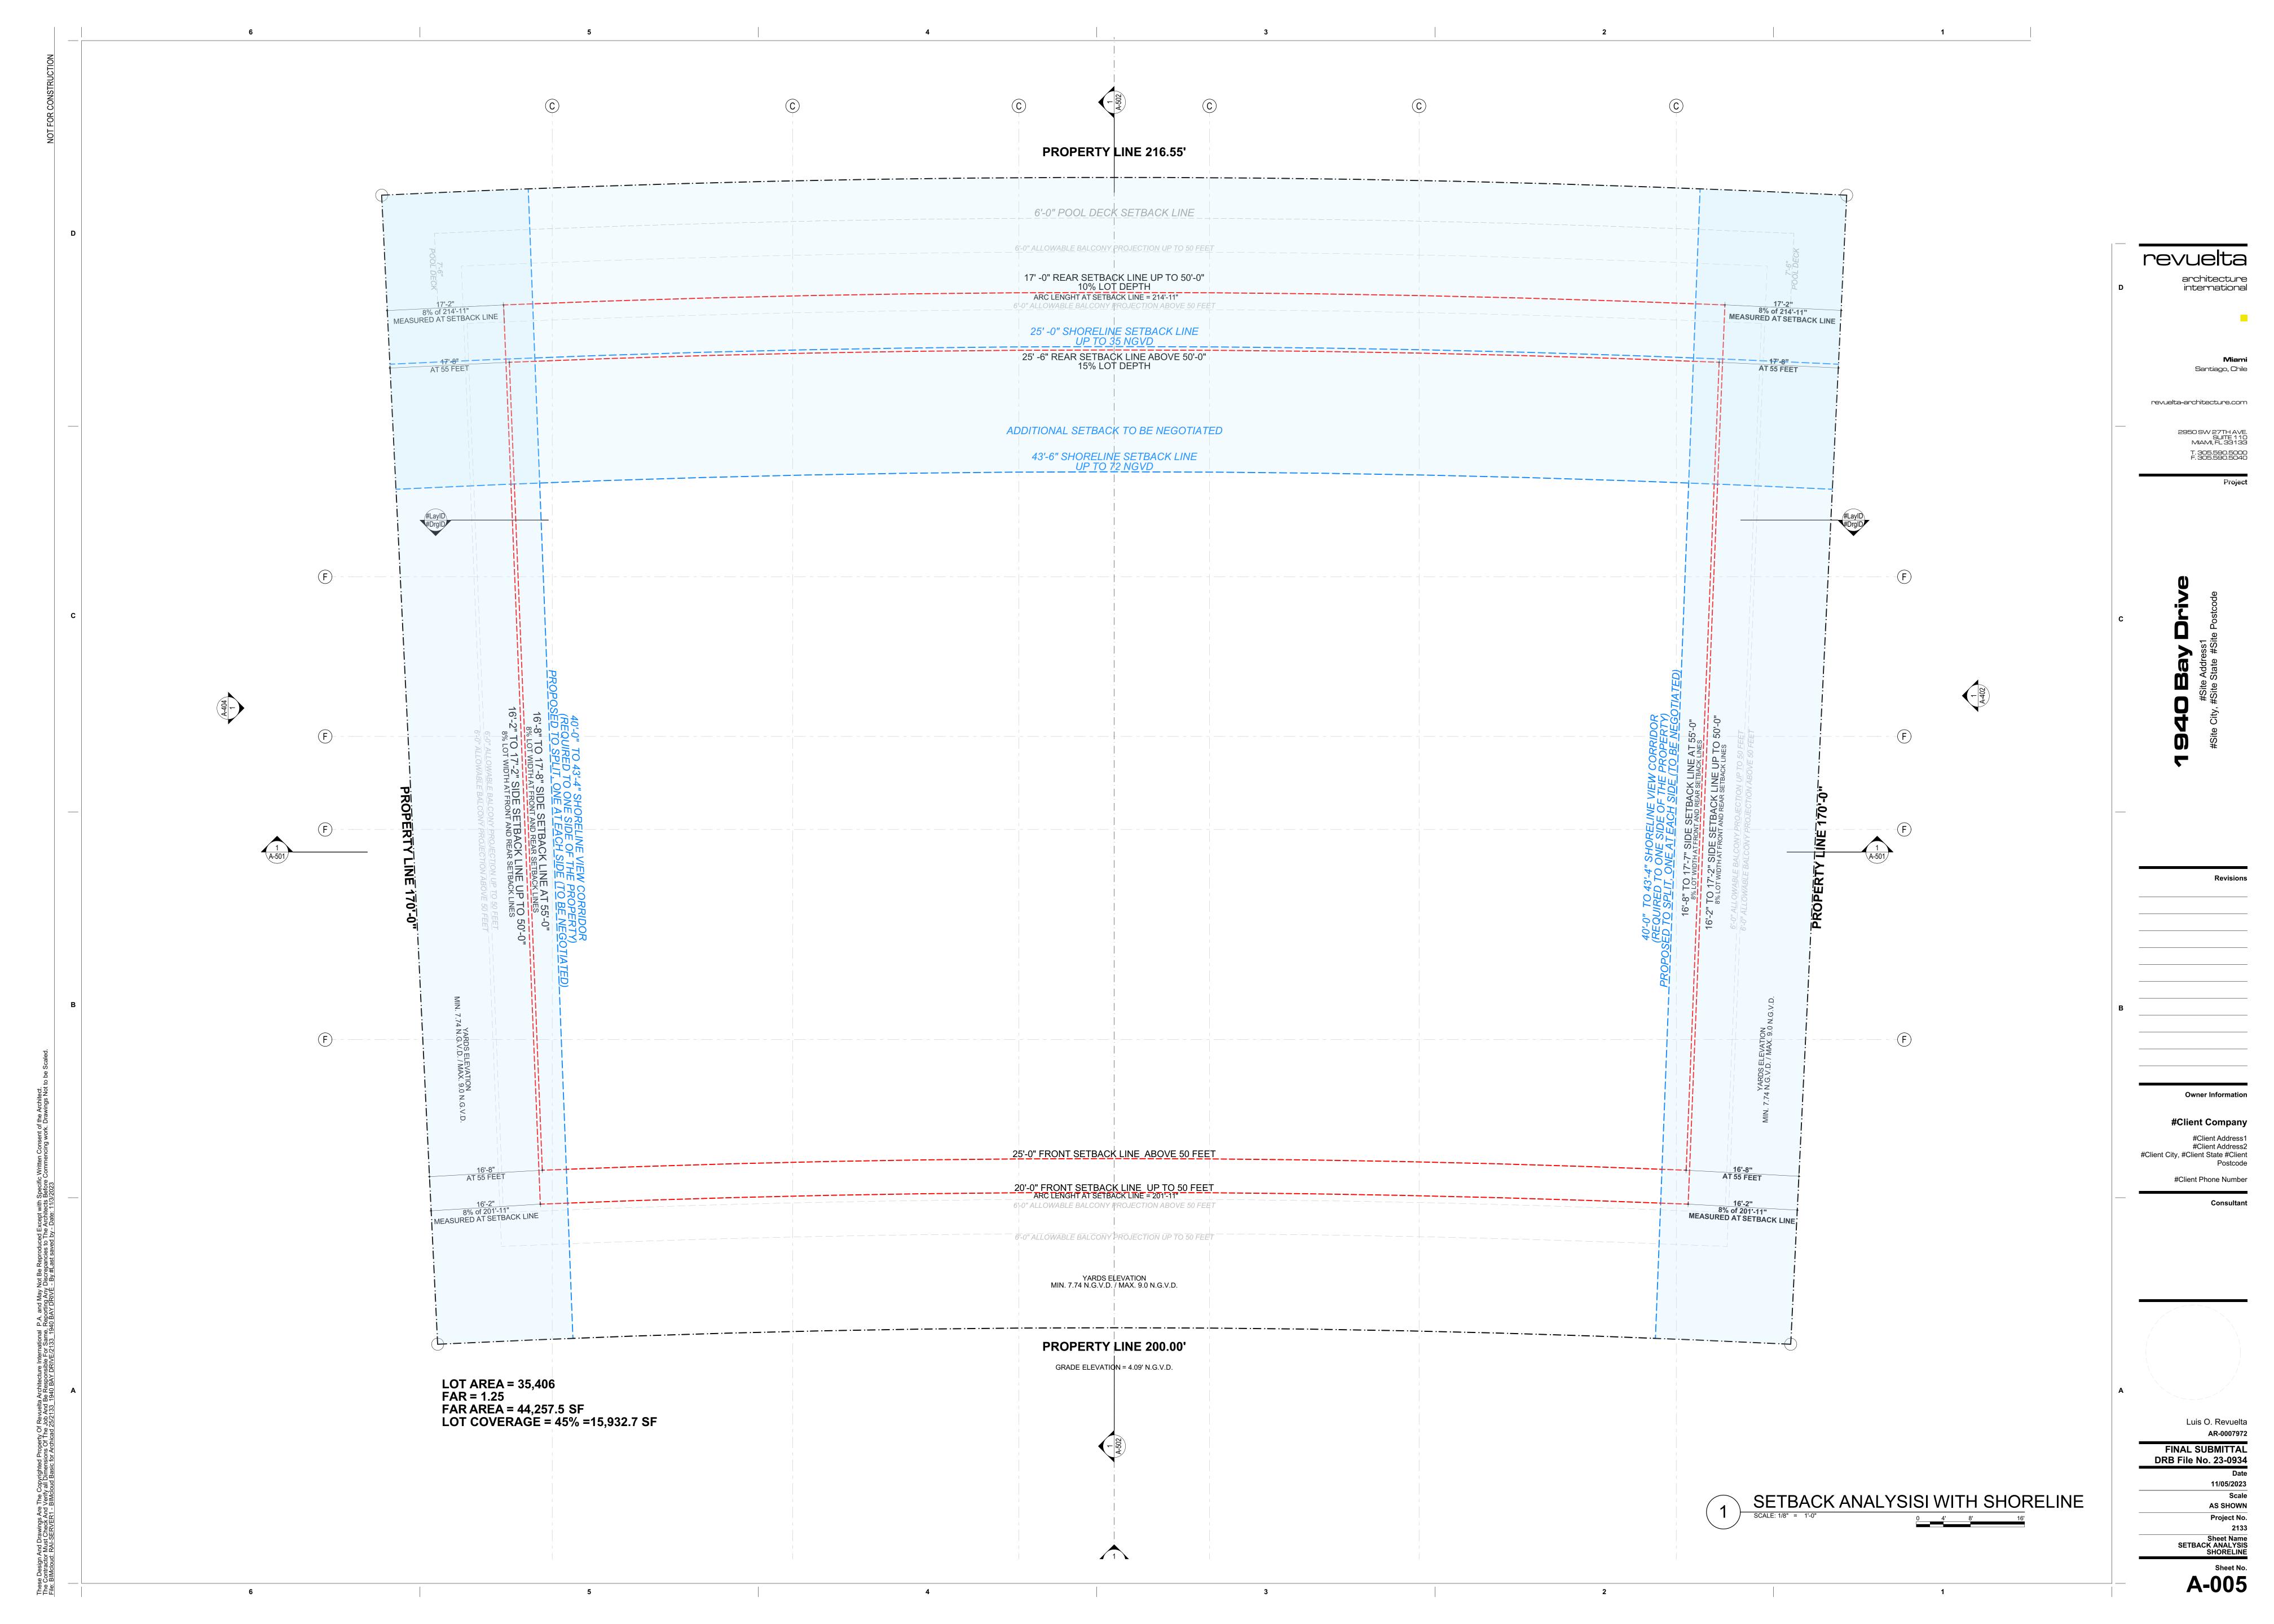SETBACK LINES_SECTION ANALYSIS

SCALE: 1/8" = 1'-0"

0 4' 8' 16'

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Project

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te City, #Site State #Site Postcode

#Client Company

#Client Address1
#Client Address2
#Client City, #Client State #Client
Postcode

Consultant

Luis O. Revuelta
AR-0007972

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DRB File No. 23-0934


Date
11/05/2023

Date
11/05/2023
Scale
AS SHOWN
Project No.
2133
Sheet Name

Sheet No. **A-007**

Axonometry

SCALE: 1/8" = 1'-0"

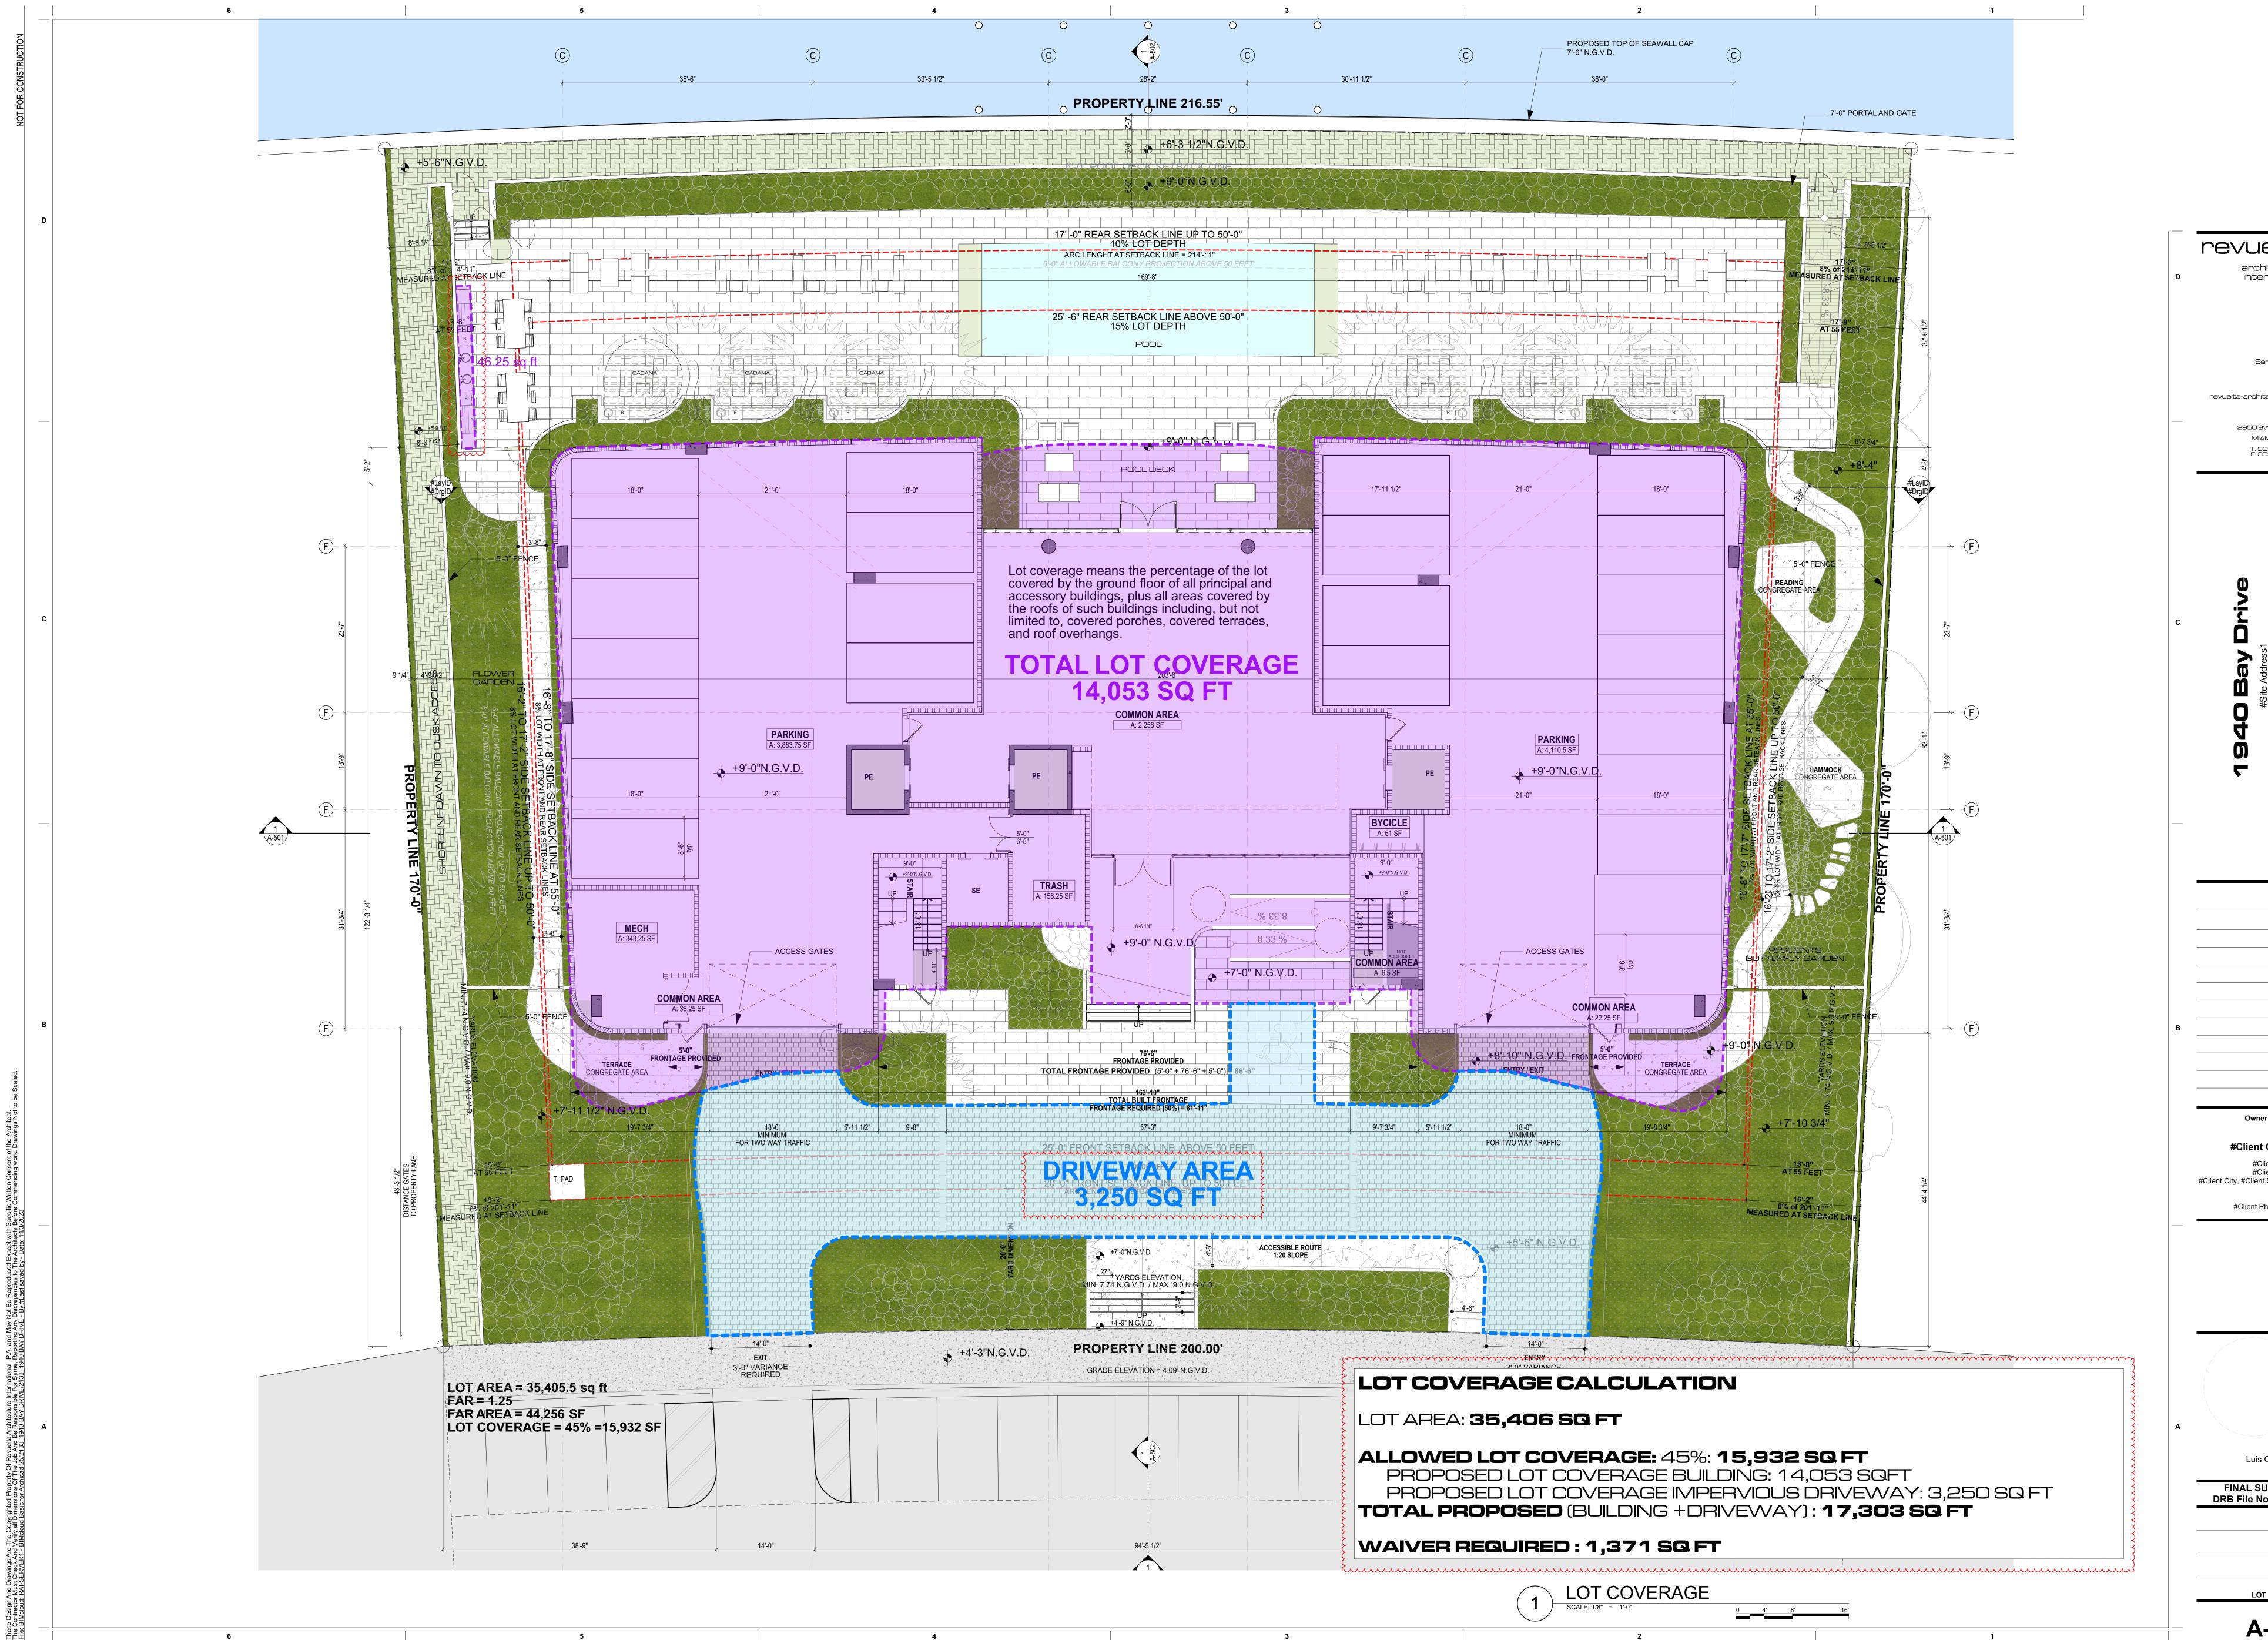

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