EX. PLANTER N. EX. PARKING DRIVEWAY RAMP EX. COVER PARKING DRIVEWAY SD17 SD11 SD16 SD19 SD18 SD19-SD13 SD12 \_\_\_\_<u>SD15</u>  $\wedge$ ✓ FEG  $\wedge \wedge$  $\wedge$ 1 1 1 1 1 1 1 SD12 SD9 SD17 SD12 EX PLANTER SD12 SD10 SD20 SD7 SD7 SD18 SD7  $\Box$ SI SI SD3 SD7 H) 11. <u>504</u> 11. SD1 SD5-----1 DEMO SITE PLAN 1/8" = 1'-0"

6

8 10

11

12

13

19

SD20

### **GENERAL NOTES - DEMOLITION**

SEE SPECIFICATION BOOK FOR MORE INFORMATION. THE CONTRACTOR IS DIRECTED TO LOCAL CODES AND REQUILATIONS AND IS TO FAMILIARIZE HERMINSELF WITH ALL WORK RELATED TO EXPONENTIATION INCLUSE CAULTION INFORMATION AND IS TO FAMILIARIZE HERMINSELF WITH ALL WORK RELATED TO EXPONENTIATION INCLUSE CAULTION INFORMATION AND IS TO FAMILIARIZE HERMINSELF WITH ALL DISTORMANIA AND FAMILIARIZE THERESULVES WITH THE SECONTRACTOR AND THEIR REMOXING THE SITE FROM TO BID. AND FAMILIARIZE THERESULVES WITH THE SECONTRACTOR AND VIOLISTIONS, COMMENTS, OR CLARFICATIONS SHALL BE ASKED IN WRITING TO THE ARCHITECT PRIOR TO SUBMISSION OF BID. DEMOLITION DRAWINSS AND SPECIFICATIONS ARE INTENDED TO PROVIDE A QUIDE FOR DEMOLITION WORK WITH SPACE THE CONTRACTOR SHALL PROCEED WITH CAUTION AND INVESTIGATE ALL EXISTING CONDITIONS THOROUGHLY. ANY DISCREPANCIES BUTVENT ASSUMED AND ACTULAL CONDITIONS SHALL BE BROUGHT TO THE ATTENTION OF THE ARCHITECT BEFORE PROCEEDING WITH THE WORK.

ARCHITECT BEFORE PROCEEDING WITH THE WORK. IF THE DEMOLITION WORK REVEALS CONDITIONS THAT CREATE A CONFLICT WITH PROPOSED NEW WORK, THE CONTRACTOR SHALL NOTIFY THE ARCHITECT IN WRITING FOR RESOLUTION BEFORE PROCEEDING WITH WORK. IF THE DEMOLITION WORK REVEALS CONDITIONS THAT CREATE A CONFLICT WITH PROPOSED NEW WORK, THE CONTRACTOR SHALL NOTEY THE ARCHITECT IN WITHING FOR RESOLUTION BEFORE PROCEEDING WITH WORK. PRIOR TO DEMOLITION, WALK THE PROJECT SITE AND RECORD EXISTING CONDITIONS. PREPARE A LOG WITH NOTK. PRIOR TO DEMOLITION, WALK THE PROJECT SITE AND RECORD EXISTING CONDITIONS. PREPARE A LOG WITH NOTK. THE COMPLETION OF THE PROJECT AFEELS OF ATTENTION CAN INCLUDE BUT ARE NOT LIMITED TO ELEVATION CARSA NO THE COMPLETION OF THE PROJECT AFEELS OF ATTENTION CAN INCLUDE BUT ARE NOT LIMITED TO ELEVATION CARSA NO THE ASSUMPTION ON THE PROJECT AFEELS OF ATTENTION CAN INCLUDE BUT ARE NOT LIMITED TO ELEVATION CARSA NO THE ASSUMPTION THAT THE EXISTING TO REMAIN CONSTRUCTION MANAGES TO DO SO, WILL RESULT IN THE ASSUMPTION THAT THE EXISTING TO REMAIN CONSTRUCTION MANAGES TO DO SO, WILL RESULT IN THE ASSUMPTION THAT THE EXISTING TO REMAIN CONSTRUCTION MANAGES TO DO UNING THE CONSERS OF CONSTRUCTION AND WILL BE REQUIRED TO BE RESTORED AT THE END OF THE PROJECT. ALL DEMOLISHED THEN THAT ARE NOT SHOWN TO BE RUEDED AFE TO BE OF PREPRICE TO THE BUILDING OWNER PRIOR TO REMOVAL FROM THE STIEL F BUILDING OWNER DOES NOT WANT ANY OF THE CONSTRUCTION SHALL BE REPARED BY CONTRACTOR AT NO ADDITIONAL COST TO TENNIT. LAND CONSTRUCTION STRUCTUR SHALL BE REPARED BY CONTRACTOR AT ADDITIONAL COST TO TENNIT. LAND CORE DO STRUCT CONSTRUCTION SHALL BE REPARED BY CONTRACTOR AT NO ADDITIONAL COST TO TENNIT. LAND CORE ON DUT THE FLOORING TO LEVEN BOUND TO SATISFY ALLABLE PROVED AND RESOLVED TO STRUCT TO TO SHALL BE REPARED BY CONTRACTOR AT NO ADDITIONAL COST TO TENNIT. LAND CONSTRUCTION SHALL BE REPARED BY CONTRACTOR AT NO ADDITIONAL COST TO TENNIT. LAND CONSTRUCTION SHALL BE REPARED BY CONTRACTOR AT NO ADDITIONAL COST TO TENNIT. LAND CONSTRUCTION SHALL BE REPARED BY CONTRACTOR AT NO ADDITIONAL COST TO TENNIT. LAND CORE CONDUCT THAT IS NOT REUSED IN THE NEW SCOPE OF WORK SHALL BE REMOVED.

CONTRACTOR SHALL REMOVE ALL MATERIALS ABOVE CEILING NOT SPECIFICALLY INDICATED TO REMAIN. ALL UNUSED WIRING, CABLES, CONDUIT, ETC. SHALL BE REMOVED AND STRIPPED BACK TO ORIGINAL SOURCE. THIS INCLUDES DATA CABLING THAT WILL NOT BE REUSED.

CABLING THE LOOPENDUM, ETUS ORALL BER HERMANDED AND SIRIPIPED BACK TO ORIGINAL SOURCE. THIS INCLUDES DATA CABLING THAT WILL NOT BE REUSED. ALL BANNDONED TELEDATA RUNS AND TERMINATIONS SHALL BE REMOVED (REMOVE BOX AND COVER PLATE, PATCH WALT DO LIKE-REW CONDITION. ALL BANDONED ELECTRICAL QUITETS SHALL HAVE THE BOX REMOVED TO THE PANEL. REMOVE BOX AND COVER PLATE, PATCH WALT DO LIKE-REW CONDITION. REMOVE ALL FLOOR FINISHES AND SECALITY FINISHES AND WILL BASE INLESS OTHERWISES NOTED DIS SHALL INCLUDE ALL INCERSION FOR AND SECALITY FINISHES AND WILL BASE INLESS OTHERWISES NOTED DIS SHALL INCLUDE ALL INCERSION FOR SUBFRACES FOR NEW FINISH AS SPECIFIED BASE BID SHALL INCLUDE ALL INCERSION FOR DISCIPLINE SING THE OTHERWISE ALL DOORS, FRAME'S AND HARDWARE FOR REVEN FINISH AS SPECIFIED ALORS FINISHES. PREPARE WALL FLOORS, FRAME'S AND HARDWARE FOR REVEN FINISH AS SPECIFIED SALVAGE ALL DOORS, FRAME'S AND HARDWARE FOR REVEN FINISH AS SPECIFIED SALVAGE ALL BLIODES, STANLESS AND HARDWARE FOR REVEN FINISH AS SPECIFIED SALVAGE ALL SES SINGED OTHERWISES. ALL CELINGS ARE TO REMAIN UNLESS NOTED OTHERWISE ON THE DEMOLITION OR REFLECTED CELING PLANS. ANY EXISTING BLINDS SHALL BE DOWN AND WRAPPED DURING DEMOLITION AND CONSTRUCTION, UNLESS SPECIFICALLY NOTED TO BE REMOVED.

NOTE: UF DE REMOVED. GENERAL CONTRACTOR SHALL RETAIN ALL WASTE HAULING TICKETS AND RETAIN NO LESS THAN 50% OF NONHAZARDOUS CONSTRUCTION WASTE WHICH SHALL BE DIVERTED FROM DISPOSALE VR ECVCLING OR SALVAGE OF CONSTRUCTION MATERIALS AND WASTE AS STATED IN THE 2013 DC GREEN CONSTRUCTION SECTION 503

### **KEY NOTES - SITE DEMOLITION**

REMOVE EXISTING CONCRETE RAMP AND RAILINGS, REFER TO SECTIONS REMOVE EXISTING PLANTER AND CONCRETE CAP, PREPARE SURFACE TO RECEIVE NEW FLOOR FINISH. REMOVE EXISTING PLANTER, PREPARE SURFACE TO RECEIVE NEW FLOOR FINISH. REMOVE EXISTING CONCRETE EXISTIRG AND RAILING MALL REMOVEMENT FOR SUBJECT ON S. SELECTIVE DEMOLITION OF EXISTING RETAINING WALL, REMOVEMENT STRUCTURAL DAVIMANDS.

STRUCTURAL DRAWINGS. REMOVE EXISTING CONCRETE PLANTER WALL, REFER TO SECTIONS. EXISTING HARDSCAPELANDSCAPE AREA TO BE REMOVE/MCDIFIED, PREPARE SURFACES AS NEEDED, REFER TO NEW SCOPE. REMOVE TERRANOVA AND 301 SIGNAGE. PATCH AND REPAR SURFACE.

REMOVE TERRANDVA AND 801 SIGNAGE, PATCH AND REPAIR SURFACE.
EXISTING PARNICIA AND MERISTO TO BE REMOVED
EXISTING PARNICIA AND MERISTO TO TO BE REMOVED
REMOVE PORTION OF SUBA, AS NEEDED. DREFER TO NEW SCOPE
REMOVE EXISTING CONCRETE CURRE AND CURRE SURFACE TO RECEIVE NEW FINISHES.
EXISTING EXISTING CONCRETE CURRE AND CURRE AND URANY FREMARE SURFACE TO RECEIVE NEW FINISHES.
EXISTING EXISTING CONCRETE CURRE AND CURRE AND AND REPARE SURFACE TO RECEIVE NEW FINISHES.
EXISTING VICUL IKE NEW REMACLE CURRE AND CURRE YE WORKING. IF ARADINDED, DEMOVED FINISH DRE SURFACE TO RECEIVE NEW FINISHES.
EXISTING WARCH AND FIRE EXITINGUISHER TO BE REPLACED PROVIDE NEW FLUSH CABINETS.
EXISTING WARCH AND FIRE EXISTINGUISHENT OB REPLACED PROVIDE NEW FLUSH CABINETS.
EXISTING WARCH AND FIRE EXISTING VICUL IN EW VICUL IN COMPANY AND VICUL IN WORKING. IF ARADINDED, DEMOVE PACH, REPAR AND
PREPARE SURFACE TO RECEIVE NEW FINISH.
EXISTING VICUL IN EWN CONCEALED HEADS, COORDINATE WITH NEW FINISHES. REFER TO
ENDINE TART FRANCING TOR READS WITH NEW CONCEALED HEADS, COORDINATE WITH NEW FINISHES. REFER TO
EXISTING PLANESSING STORERS TO BE RESTEDIPED
EXISTING VICUOR FINISH TO BE REMOVED, PATCH, REPARE AURFACES TO RECEIVE NEW FINISH.
REMOVE EXISTING STORERS TO BE REMOVED AND CHERVIEW FUNCHALED
EXISTING STORERS TO BE REMOVED, PATCH, REPARE AURFACES TO RECEIVE NEW FINISH.
REMOVE EXISTING STORERS TO REMOVED, PATCH, REPARCE WITH NEW.
INTERIOR DEMO SCOPE ON INTERIOR DEMO SHEETS.



169 E FLAGLER ST. SUITE 727 MIAMI, FL,

CLIEN

# 801 ARTHUR GODFREY ROAD

801 ARTHUR GODFREY ROAD, MIAMI BEACH, FL 33140

## ONSULTANT

MEP CONSULTANT: MGE ENGINEERING 300 SOUTH PARK RD. SUITE 140 HOLLYWOOD, FL 33021 P: 305.755.3833

# STRUCTURAL YHCE

YHCE 99 NW 27TH AVE MIAMI, FL 33125 P:305.969.9423

LANDSCAPE GSLA DESIGN 17670 NW 78TH AVE. SUITE 214 MIAMI, FL 33015 P:305.392.1016

SEAL / SIGNATUR



REVISION NUMBER DATE


FILE INFORMATION

9768.00 OV Checker DRB Project Drawn Checked Project Phase:

SHEET NAME


DEMO SITE PLAN




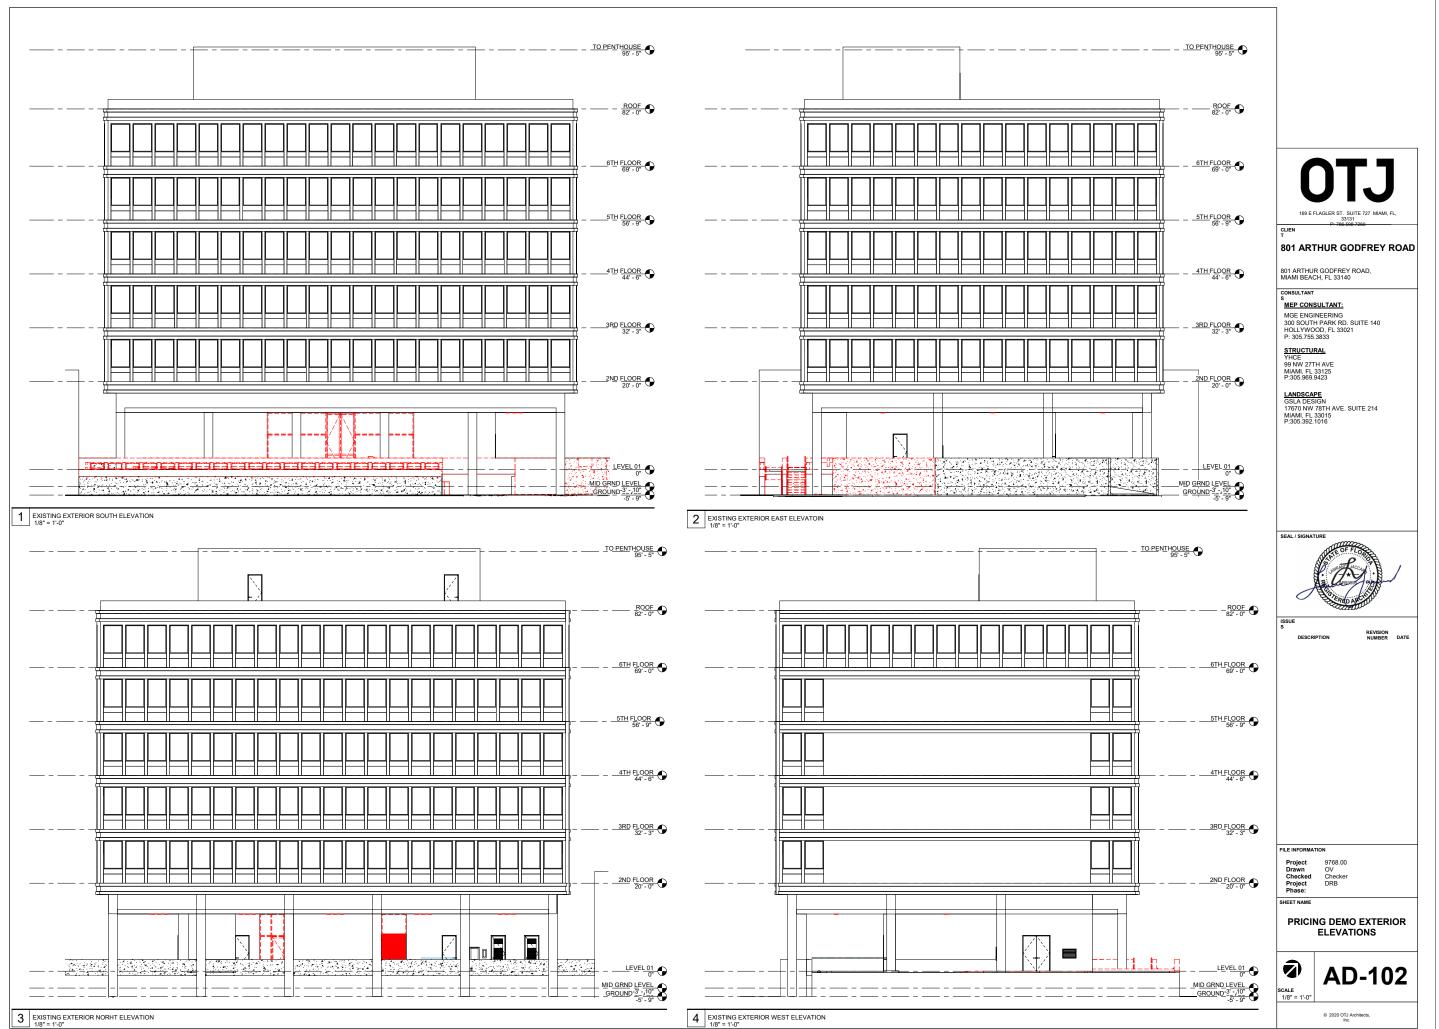



BIM 380.//511-00788.01-801 AGR-R2019788.00\_801 AGR\_GROUND FLOOR -




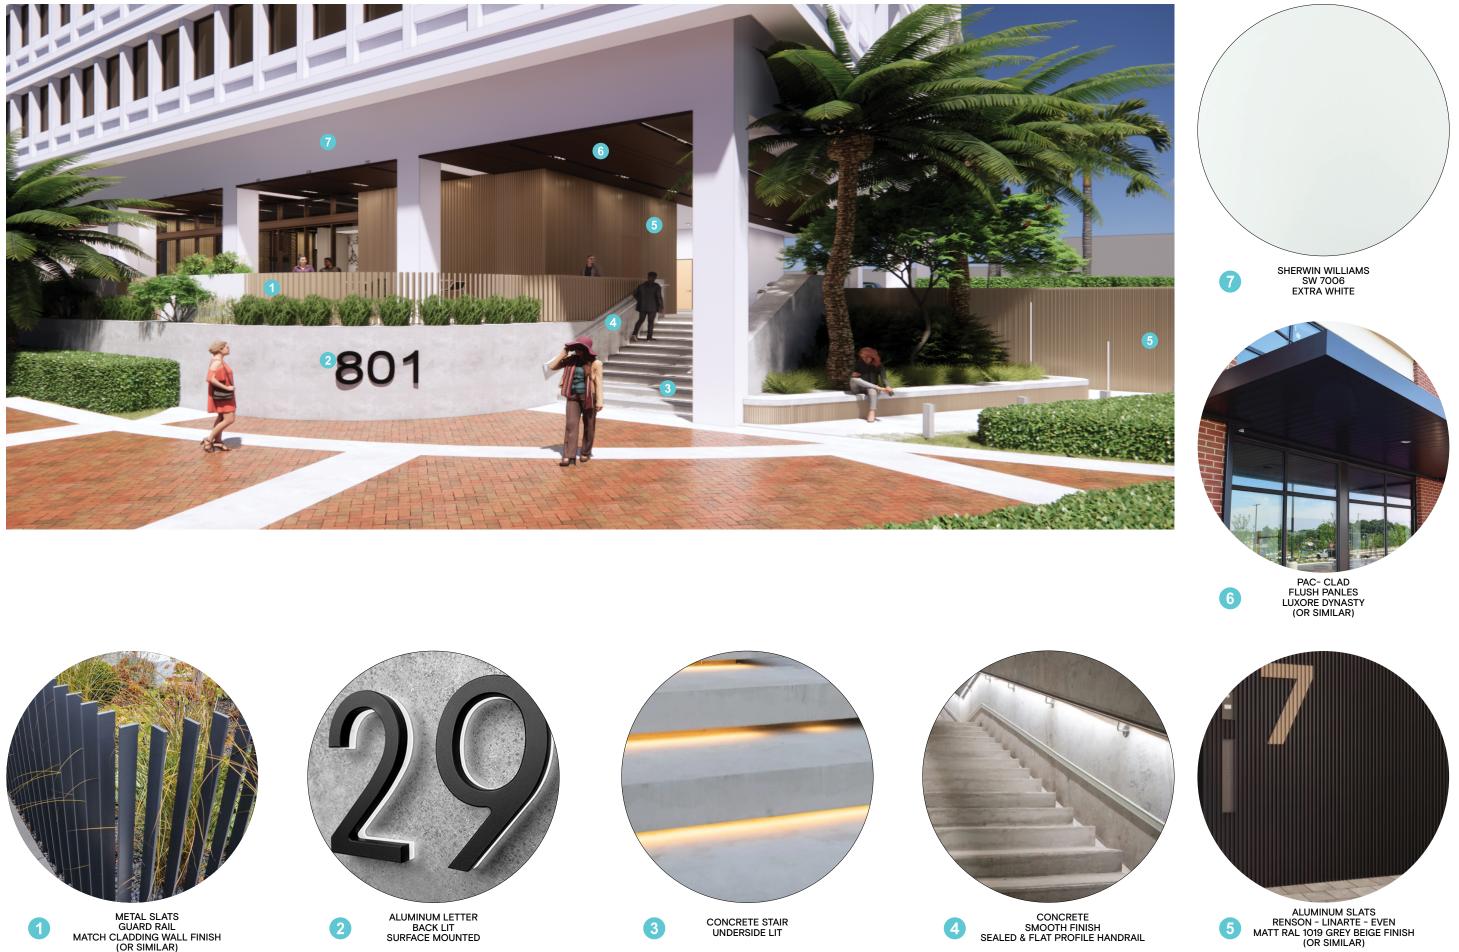

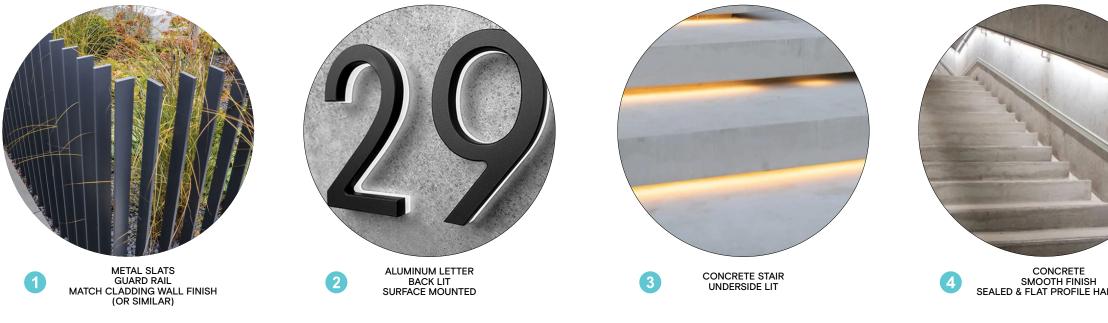

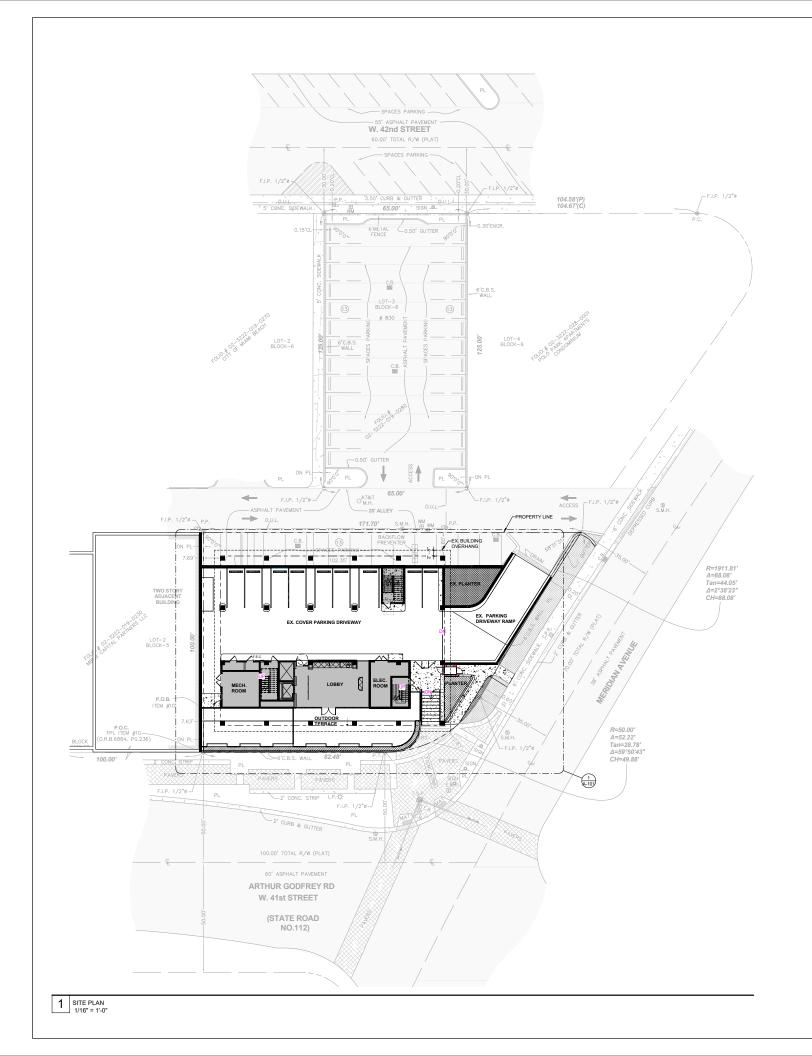

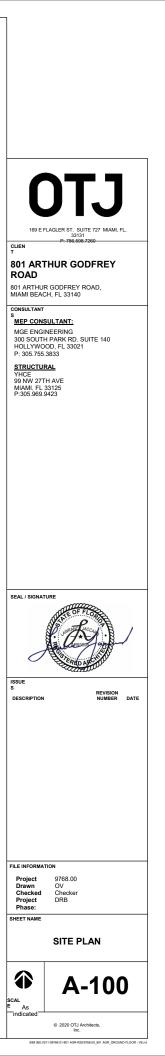

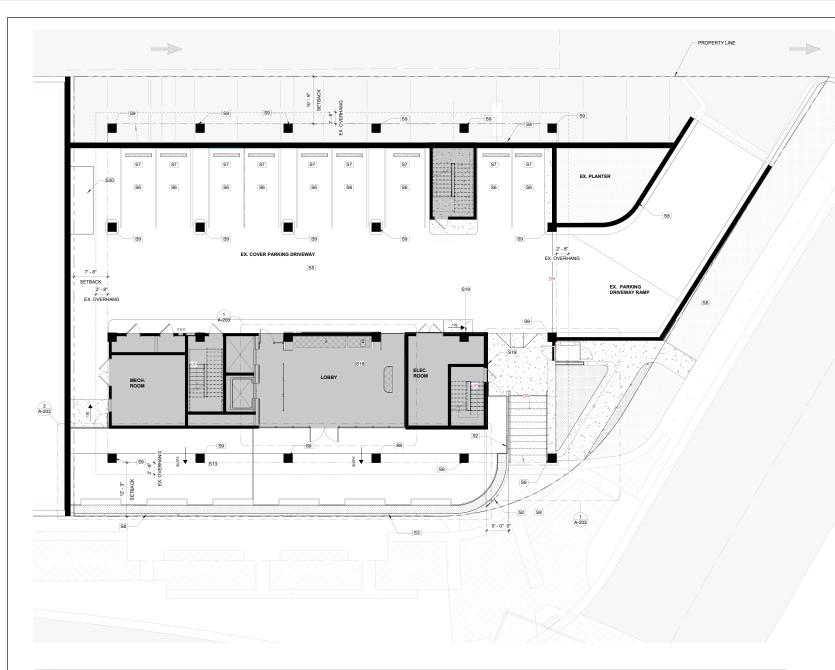

GENERAL NOTES - CONSTRUCTION GENERAL CONTRACTOR TO VERIPY EXTENT EXISTING CONSTRUCTION IN FIELD GENERAL CONTRACTOR SHALL INEEDALTS TOTON TO VERIPY EXTENT EXISTING CONSTRUCTION IN FIELD GENERAL CONTRACTOR SHALL INEEDALTS TOTON TO VERIPY EXISTING CONSTRUCTION CAUSED BY THE GENERAL CONTRACTOR SHALL INEEDALTS TOTON TO UNE THE SECOND THE GENERAL CONTRACTOR SHALL DEVICE INADEQUATE PROTECTION, OR INAEGUAITS ESCURTING CONSTRUCTION ARE TO BE CORRECTED AT THE GENERAL CONTRACTOR'S EXPENSE.
 PROR TO THE COMMENSEMENT OF CONSTRUCTION CAUSED BY THE GENERAL CONTRACTOR SHALL DRIVING TOTO THE COMMENSEMENT OF CONSTRUCTION CAUSED BY THE GENERAL CONTRACTOR SHALL ON UNIT CONTRACTOR'S EXPENSE.
 PROR TO THE COMMENSEMENT OF CONSTRUCTION ARE TO BE CORRECTED AT THE GENERAL CONTRACTOR'S EXPENSE.
 GENERAL CONTRACTOR TO THE CONSTRUCTION ARE DEVICED AND ALL RESIDENT TO THE COMMENSEMENT OF CONSTRUCTION, THE GENERAL CONTRACTOR SHALL ARE SHOULD BE TOTON TO THE COMMENSEMENT OF CONSTRUCTION ARE DEVICED AND ALL RESIDENT TO THE COMMENSEMENT OF CONSTRUCTION, THE GENERAL CONTRACTOR SHALL AND AND SUPPLEMENTAL INCERNICAL EQUIPMENT TO COORDINATE INCOMENDATIONS. MOVALE PRINTENT TRACK LAYOUTS: VAV BOXES AND LIGHTING LAYOUTS FOR RECEPTION AREAS, CONTRACTOR TONS. MOVALE PRINTENT TRACK LAYOUTS: VAV BOXES AND LIGHTING LAYOUTS FOR RECEPTION AREAS, CONTRACTOR TO NOTIFY ARCHITECT INTEGENT MALESTING TO ARRANGE AND MODEY ALL ENSTITUS AND ALLOR PUBLIC SPACES. AND OTTEY ARCHITECT IMMEDIATE LOCATIONE CONCE FOR CELLING INSTITUTIONS. GENERAL CONTRACTOR TO ARRANGE AND DESTING AND LIGHTING LAYOUTS FOR RECEPTION TO COMMENCEMENT OF WORK.
 ALL HOLES IN SUBS AREAS TO BE FILLED WITH CODE COMMENTALIZITION AS SHOUND. GENERAL CONTRACTOR TO NOTIFY ARCHITECT IMMEDIATE LOCATIONE FOR GENERAL TRUTCH THERE REFERE TO MECHANICAL PLURING, AND LECTRICAL PLURING, SPECE FOR SUB APPRETINGTION FILE CONTRACTOR TO ARRANGE AND MODIFY ARCHITECT INSIGNES FOR SUB APPRETING TO ARRANGE AND MODIFY ARCHITECT INSIGNES FOR SUB APPRETING TO ARRANGE AND MODIFY ARCHITECT ARCH

KEY T NEW RETAINING WALL NEW PLANTER AREA, PROVIDE IRRIGATION & LIGHTING COVER PARKING DRIVEWAY AND CURBS TO BE PAINTED EXISTING ARRING STRIPES TO BE RE-STRIP EXISTING ANEW FEINISH DO BER SCHWEN TBU EXISTING ALEW RETAINING TO BE CEVEN IN THE EXISTING A CHURCH STRIPES TO BE COVEN IN THE EXISTING A CULUMIN STO RECEIVE NEW FLOOR FINISH EXISTING A CULUMIN STO RECEIVE NEW FLOOR FINISH, G.C. INTERIOR IMPROVEMENTS SCOPE ON INTERIOR CONSTRU NEW SATTED CLADING ON EXISTING EXTERIOR WALLS PATCHED CONCRETED AREA S2 S13 S18 S19 S20

20

1 PRICING SITE PLAN 1/8" = 1'-0"

FINISHES. ALL NEW DIMINSIONS ARE FROM FINISH SURFACE TO FINISH SURFACE, UNLESS NOTED OTHERWISE. ALL UNENIMENDE BASE BUILDING CORE WALLS, PERIMETER WALLS, OR COLUMNS ARE TO BE FURRED OUT WITH GYPSUM BOARD

BOARD ALLDOORS, MILLWORK, DEVICES, ETC. SCHEDULED TO REMAIN ARE TO BE CLEANED, TESTED, SERVICED IF REQUIRED, AND RESTORED TO FULL OPERATING. CONDITION, FINISHES TO BE REPAIRED AND RESTORED TO LIKE NEW CONDITION. POROUS OR FIRINGUS MATERIALS, SAN OTHER MATERIALS SUBJECT TO MOISTURE DAMAGE SHALL BE PROTECTED FROM MOISTURE DURING THE CONSTRUCTION PHASE. MATERIAL DAMAGED SY MOISTURE OR THAT ARE VISIBLY COLONZED BY FUNGI ETHER PROR TO DELIVERY OR DURING THE CONSTRUCTION PHASE SHALL BE CLEANED AND DRIED OR, WHERE DAMAGE CANNOT BE CORRECTED BY SUCH MEANS, SHALL BE FRIMOVED AND REPLACED.

# **KEY NOTES - SITE PLAN**

NOTE	
LIGHTING	
BE PAINTED, COLOR FINISH TBD	
E	
OR FINISH TBD	
IVE NEW FINISH	
1	
R FINISH, G.C TO MAINTAIN EXISTING SLOPE.	
IOR CONSTRUCTION SHEETS.	



33131 P: 786.598.7260

CLIEN

## 801 ARTHUR GODFREY ROAD

801 ARTHUR GODFREY ROAD, MIAMI BEACH, FL 33140

# CONSULTANT

 MEP CONSULTANT:

 MGE ENGINEERING

 300 SOUTH PARK RD. SUITE 140

 HOLLYWOOD, FL 33021

 P: 305.755.3833

STRUCTURAL YHCE 99 NW 27TH AVE MIAMI, FL 33125 P:305.969.9423

LANDSCAPE GSLA DESIGN 17670 NW 78TH AVE. SUITE 214 MIAMI, FL 33015 P:305.392.1016

SEAL / SIGNATURE



REVISION NUMBER DATE

FILE INFORMATION 9768.00 OV Checker DRB


Project Drawn Checked Project Phase:


SHEET NAME


ENLARGE SITE PLAN





BIM 360://S11-09768.01-801 AGR-R20/9768

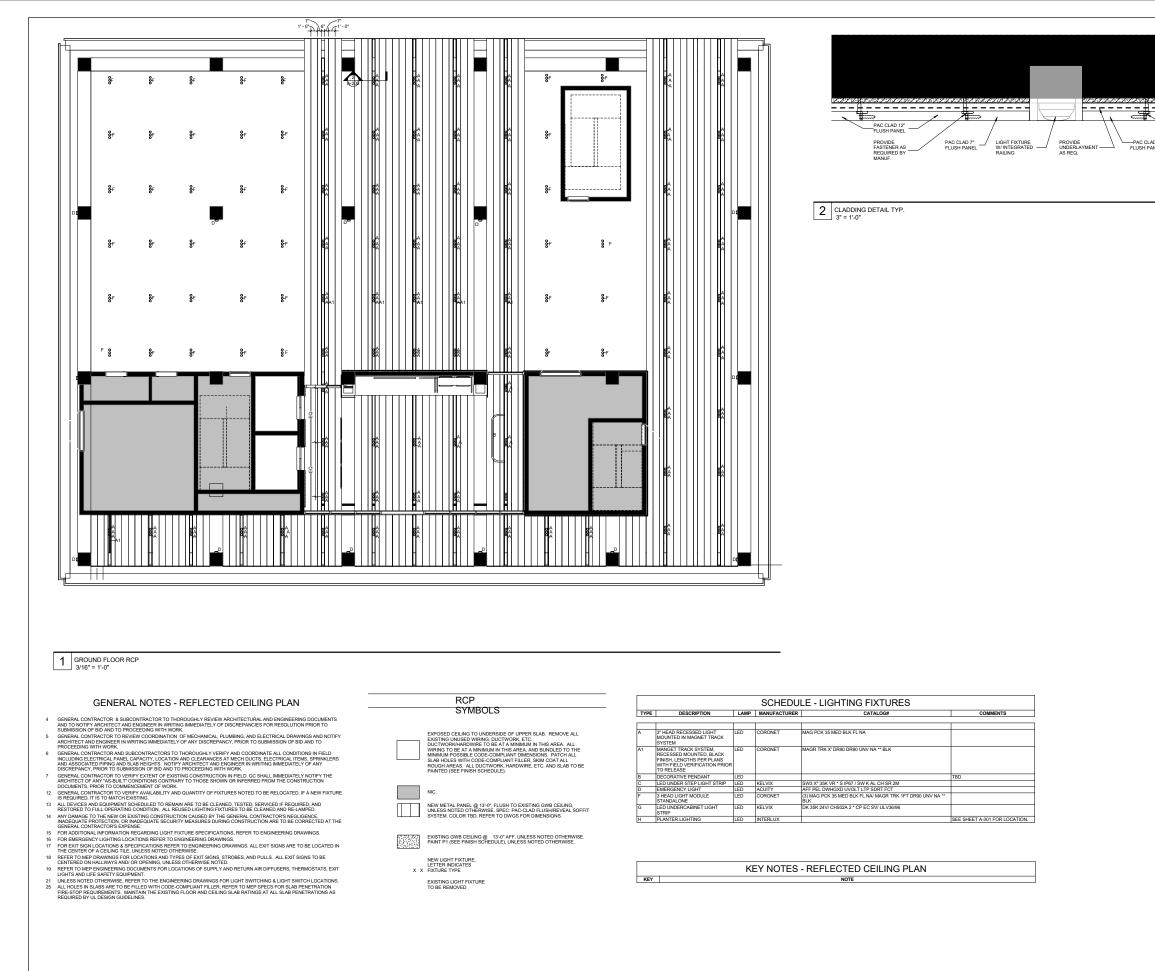

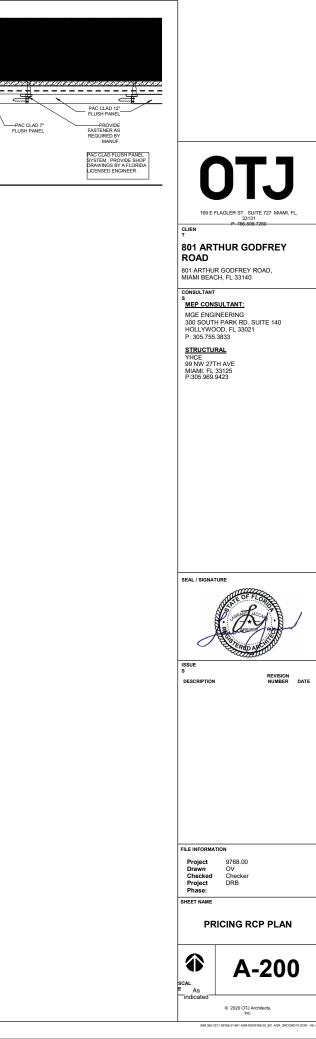

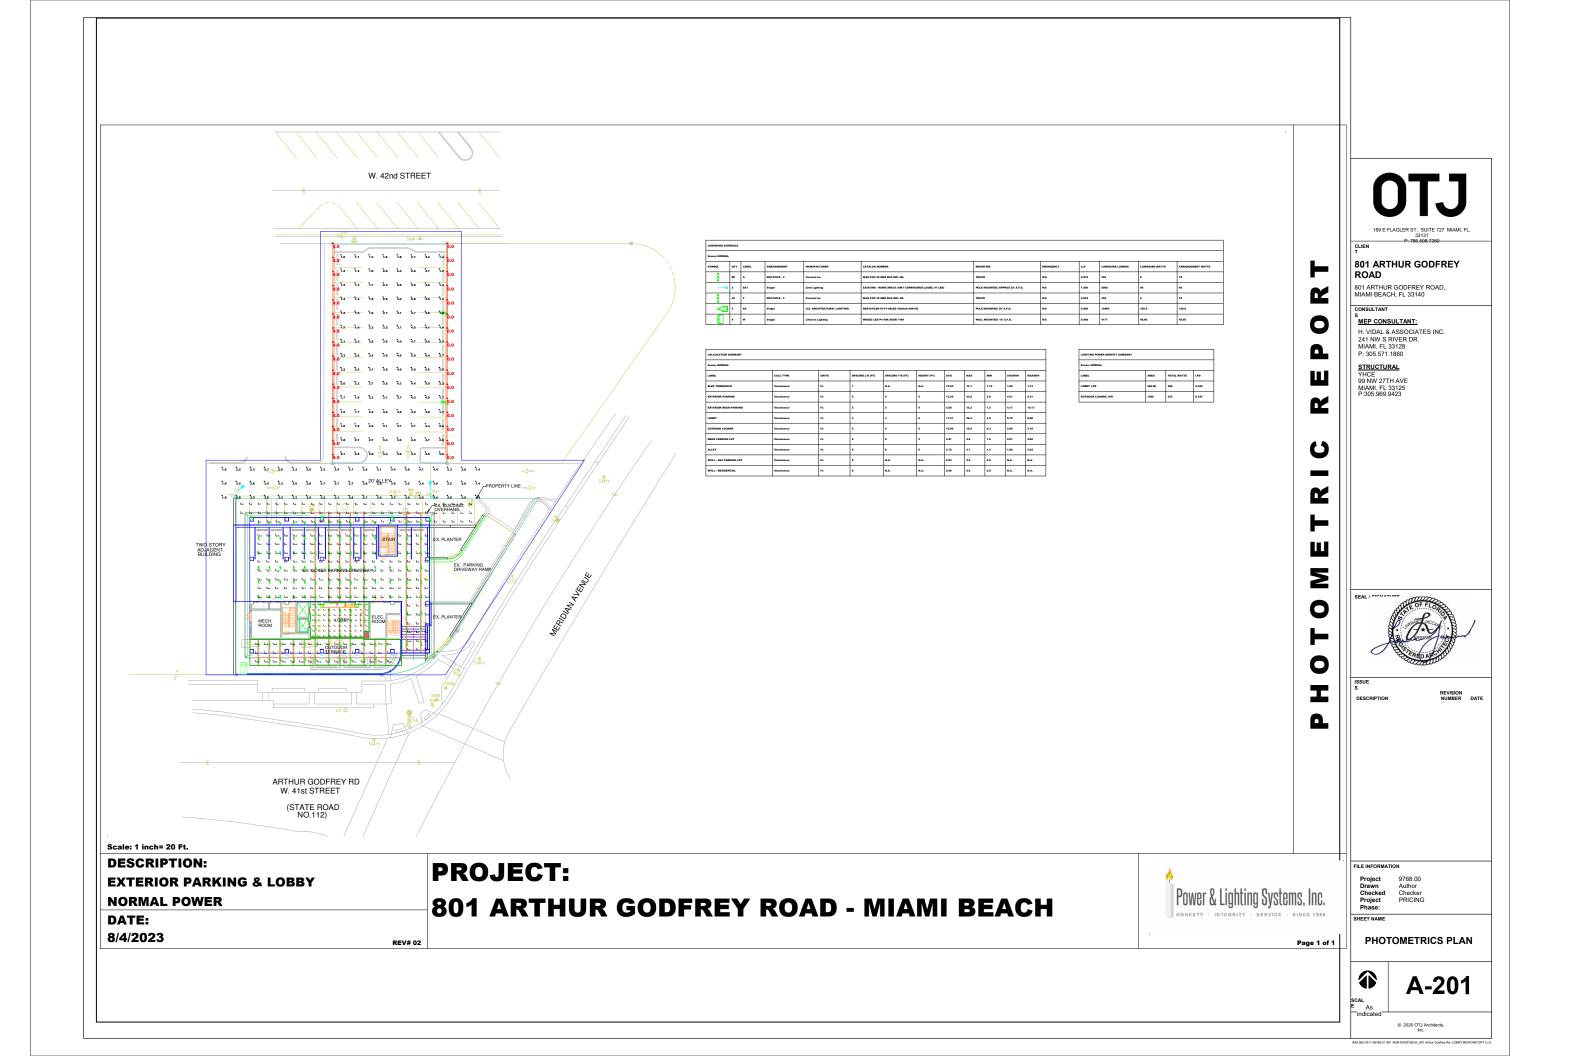

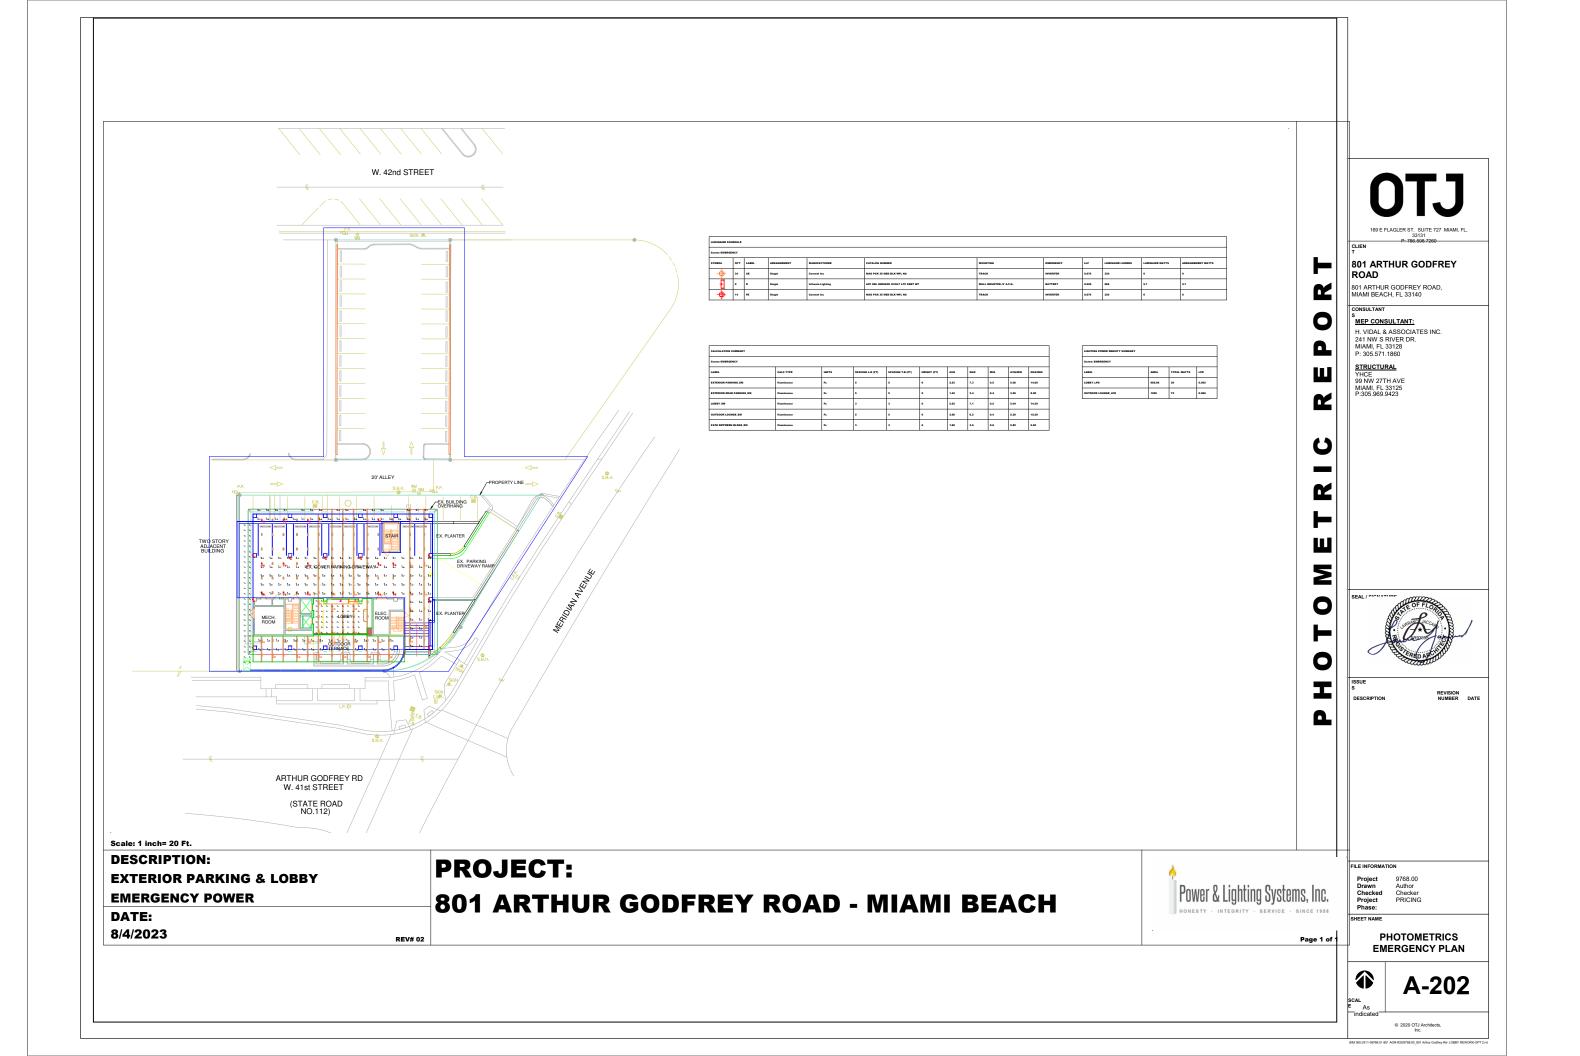

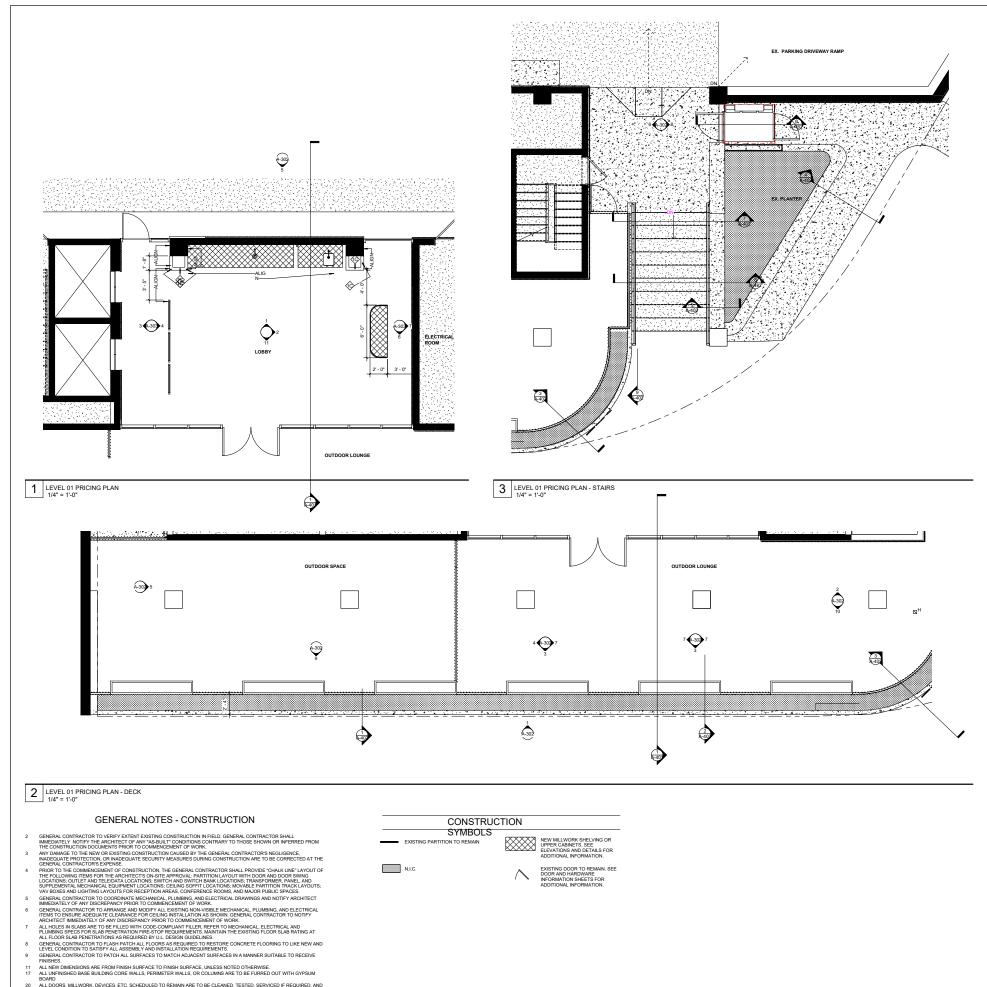

BOARD 20 ALL DOORS, MILLWORK, DEVICES, ETC. SCHEDULED TO REMAIN ARE TO BE CLEANED, TESTED, SERVICED IF REQUIRED, AND RESTORED TO FULL OPERATING COMDITION. FINISHES TO BE REPARED AND RESTORED TO LIKE NEW CONDITION. 21 POROUS OR FIBORUS MATCHILS AND OTHER MATERIALS SUBJECT TO MOISTURE DAMAGE SHALL BE PROTECTED FROM MOISTURE DURING THE CONSTRUCTION PHASE. MATERIAL DAMAGED BY MOISTURE OR THAT ARE VISIBLY COLONIZED BY FUNGIETHER PRIOR TO DELIVERY OR DURING THE CONSTRUCTION PHASE SHALL BE CLEANED AND DRIED OR. WHERE DAMAGE CANNOT BE CORRECTED BY SUCH MEANS, SHALL BE REMOVED AND REPLACED.



BIM 380.//S11-09768.01-801 AGR-R2019768.00\_801 AGR\_GROUND FLOOR - VE