

# - THE ALTON -MIAMI BEACH, FL

# FINAL DRB SUBMITTAL (DRB22-0897) SHEET INDEX


	THE ALTON, MIAMI BEACH	<b>X</b> = Shee	T SUBMITT	ED	• = SHEET I	REVISE	)	
SHEET#		SUB	DRB FIRST SUBMITTAL 12-20-2022		DRB SECOND SUBMITTAL 01-10-2023		DRB FINAL SUBMITTAL 08-07-2023	
L-0	COVER SHEET + SHEET INDEX	Х		X		Х		
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L-5.11	GENERAL LANDSCAPE NOTES	X		X		Х		

CLAD Landscape Architecture and Design
THE ALTON MIAMI BEACH, FL
SITE ADDRESS: 1656 - 1680 ALTON ROAD & 1677 WEST AVENUE MIAMI BEACH, FL 33139
LANDSCAPE ARCHITECT:
8020 NE 4TH AVE, STUDIO 113 MIAMI, FL 33138 (786) 536-6076 INFO@CLADLANDSCAPE.COM
SEAL:
CAROLINA MONTEIRO DA SILVA REGISTERED LANDSCAPE ARCHITECT LA6667311
DRAWING TITLE:
COVER SHEET + SHEET INDEX
© 2022 CLAD, LLC REVISIONS:
ISSUE DATE
DRB FIRST SUBMITTAL12/20/22DRB SECOND SUBMITTAL01/10/23DRB FINAL SUBMITTAL08/07/23
DRB SECOND SUBMITTAL 01/10/23

#	SCIENTIFIC NAME	COMMON NAME	DBH (IN)	HEIGHT (FT)	SPREAD (FT)	CONDITION	DISPOSITION	NOTES	DBH (IN) REMOVED	PALMS REMOVED
1	Adonidia merrillii	CHRISTMAS PALM	6	12	6	GOOD	REMOVE			1
2	Roystonea regia	ROYAL PALM	16	30	18	GOOD	REMOVE			1
3	Bursera simarub a	GUMBO LIMBO	12	18	15	GOOD	REMOVE		12	
4	Bursera simarub a	GUMBO LIMBO	10	18	15	GOOD	REMOVE		10	
5	Bursera simarub a	GUMBO LIMBO	10	18	15	GOOD	REMOVE		10	
6	Bursera simarub a	GUMBO LIMBO	12	18	15	GOOD	REMOVE		12	
7	Bursera simarub a	GUMBO LIMBO	11	18	15	GOOD	REMOVE		11	
8	Washingtonia robusta	MEXICAN FAN PALM	14	40	12	GOOD	REMOVE			1
9	Quercus virginiana	LIVE OAK	8	25	16	GOOD	RELOCATE			
10	Quercus virginiana	LIVE OAK	8	25	16	GOOD	RELOCATE			
11	Quercus virginiana	LIVE OAK	7	25	16	GOOD	RELOCATE			
12	Quercus virginiana	LIVE OAK	8	25	16	GOOD	RELOCATE			
13	Quercus virginiana	LIVE OAK	9	25	16	GOOD	RELOCATE			
14	Quercus virginiana	LIVE OAK	8	25	16	GOOD	RELOCATE			
15	Quercus virginiana	LIVE OAK	8	25	16	GOOD	RELOCATE			
16	Quercus virginiana	LIVE OAK	9	25	16	GOOD	RELOCATE			
17	Quercus virginiana	LIVE OAK	10	25	16	GOOD	RELOCATE			
18	Quercus virginiana	LIVE OAK	9	25	16	GOOD	RELOCATE			
19	Veitchia arecina	MONTGOMERY PALM	8	30	10	GOOD	REMOVE			1
20	Veitchia arecina	MONTGOMERY PALM	8	30	10	GOOD	REMOVE			1
21	-	DEAD PALM	-	-	-	-	REMOVE			1
22	Veitchia arecina	MONTGOMERY PALM	8	30	10	GOOD	REMOVE			1
								TOTAL REMOVED:	55	7


TREE DISPOSITION SUMMARY						
	TOTAL	REMAIN	REMOVE	RELOCATE		
TREES	15	0	5	10		
PALMS	7	0	7	0		

DISPOSITION SYMBOL LEGEND:

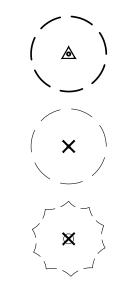


TREE TO BE REMOVED

TREE TO BE RELOCATED

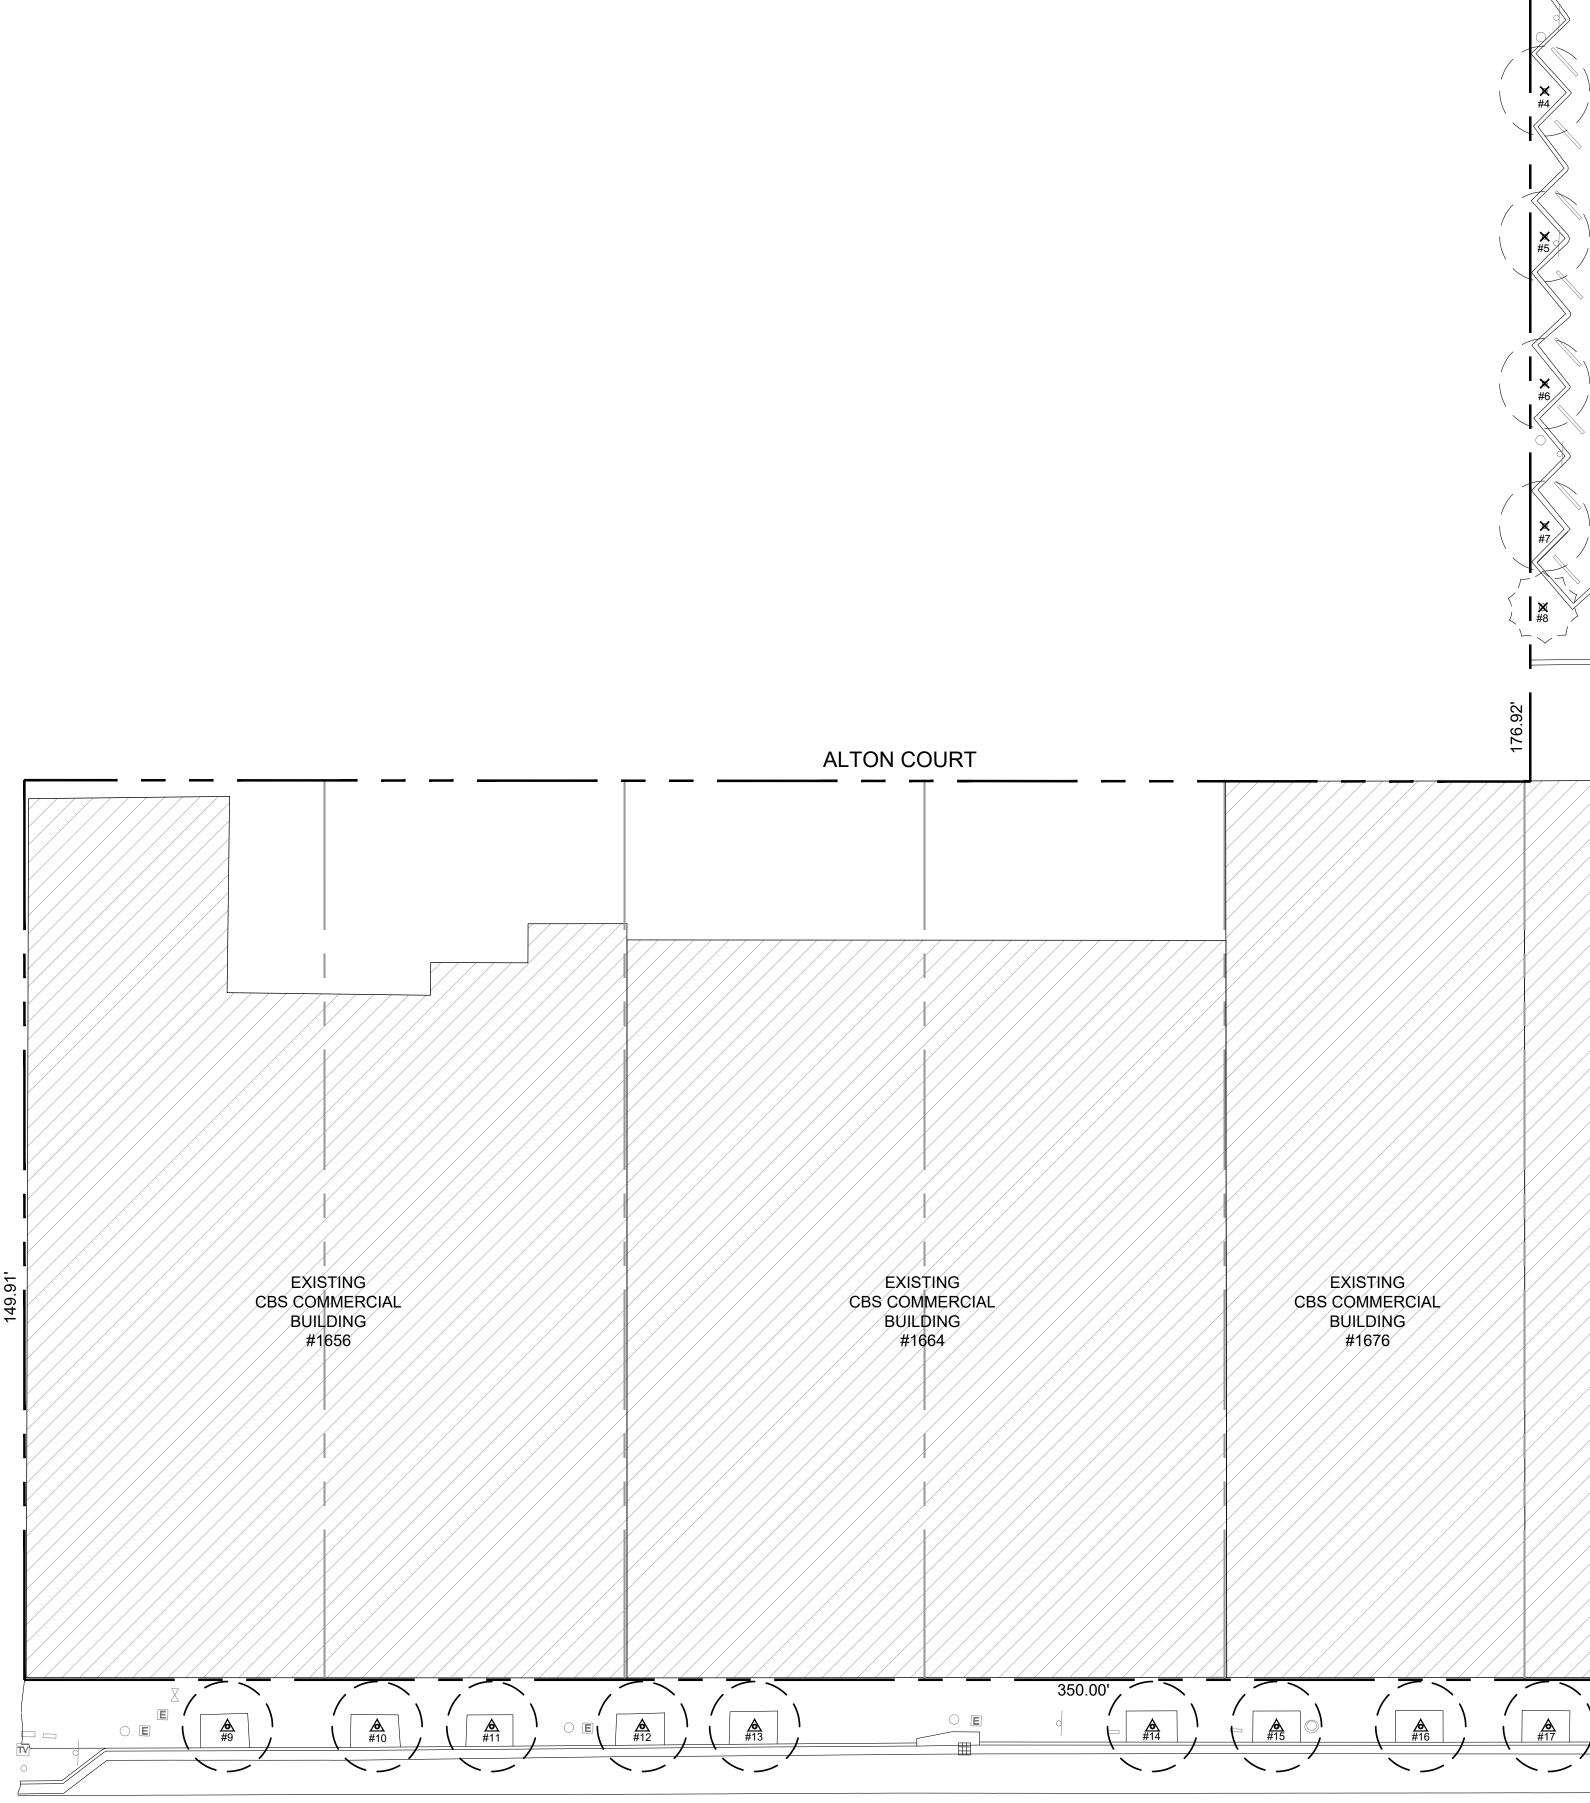

ALTON ROAD

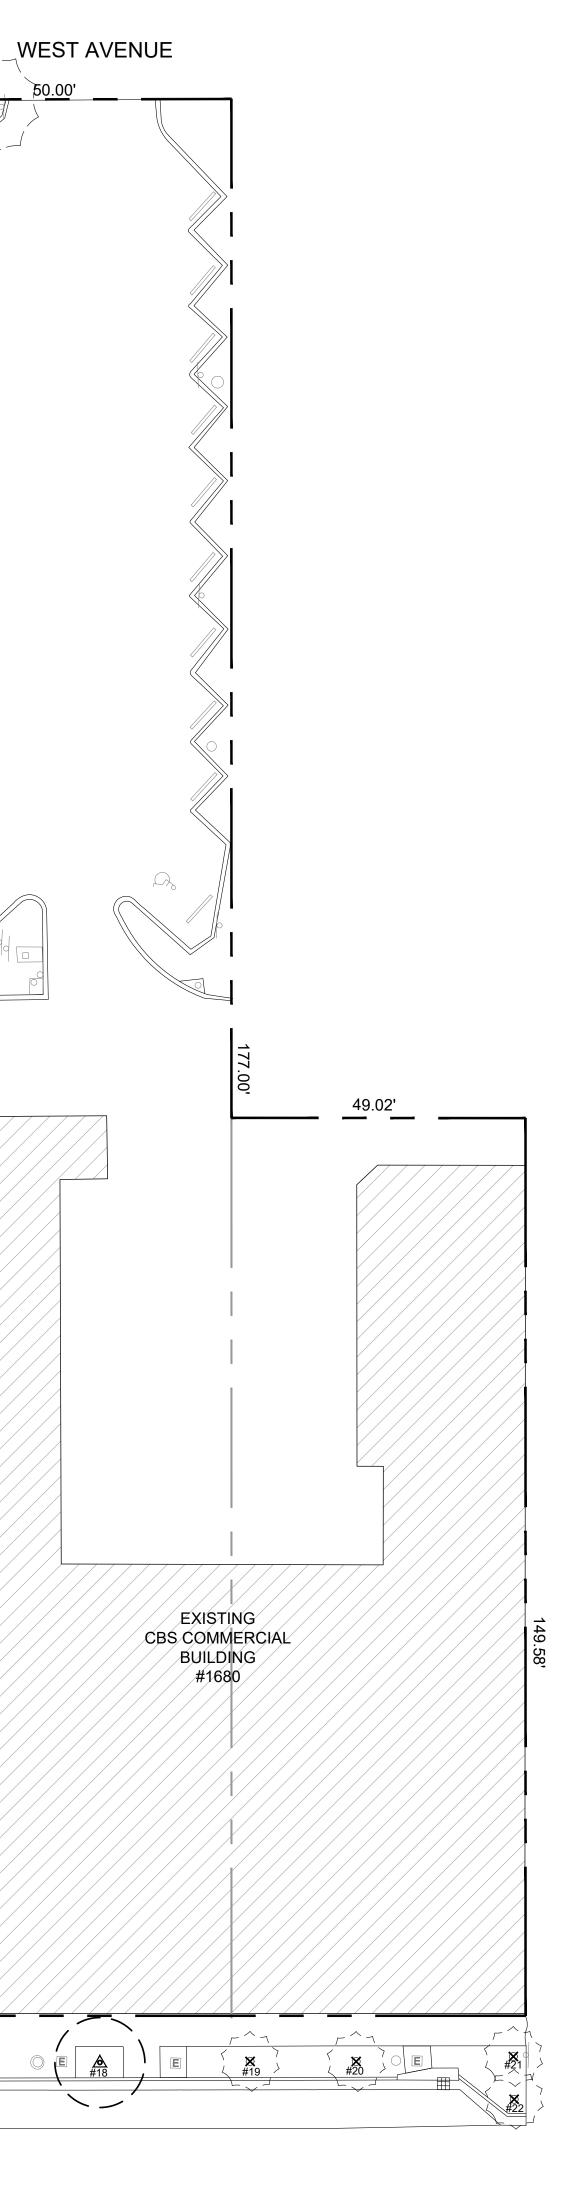


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Landscape Architecture and Design THE ALTON MIAMI BEACH, FL \_\_\_\_\_ SITE ADDRESS: 1656 - 1680 ALTON ROAD & 1677 WEST AVENUE MIAMI BEACH, FL 33139 -----LANDSCAPE ARCHITECT: CLAD 8020 NE 4TH AVE, STUDIO 113 MIAMI, FL 33138 (786) 536-6076 INFO@CLADLANDSCAPE.COM SEAL: CAROLINA MONTEIRO DA SILVA REGISTERED LANDSCAPE ARCHITECT LA6667311 DRAWING TITLE: TREE DISPOSITION PLAN + SCHEDULE © 2022 CLAD, LLC **REVISIONS**: ISSUE DATE 12/20/22 DRB FIRST SUBMITTAL DRB SECOND SUBMITTAL 01/10/23 DRB FINAL SUBMITTAL 08/07/23 SCALE: 1/16" = 1'-0" PROJ. Nº:

2232 SHEET N°:

L-1

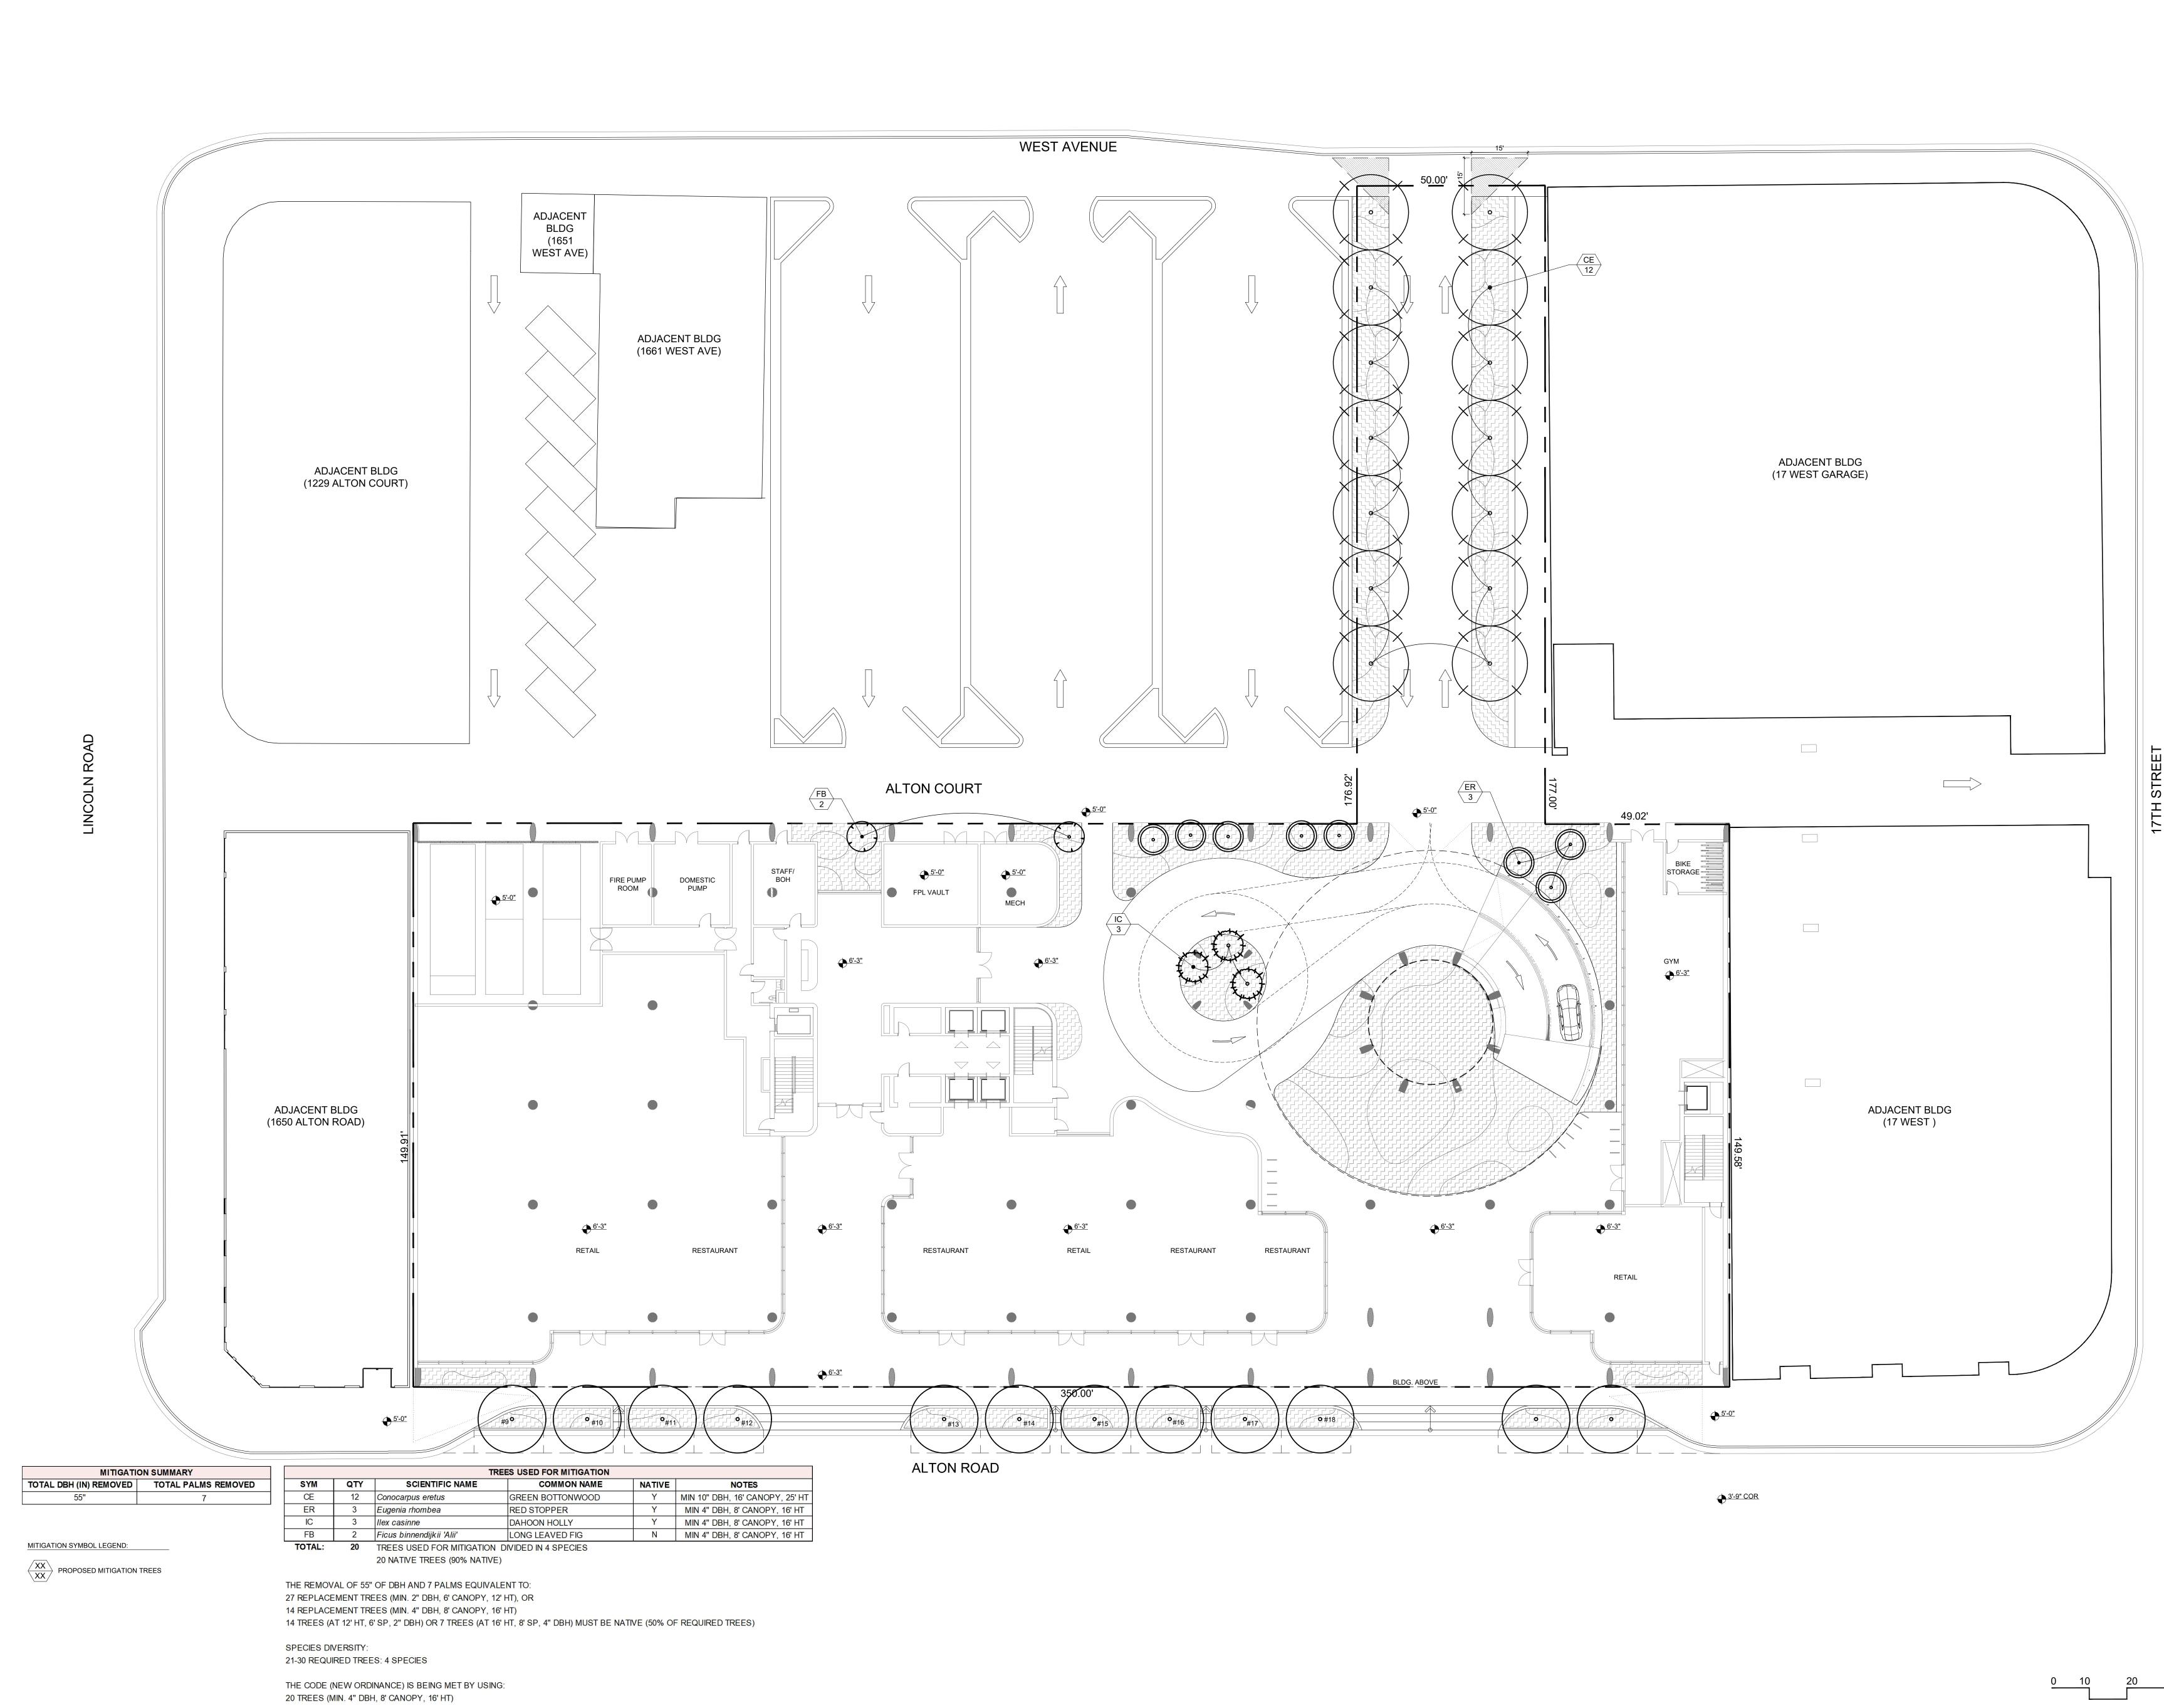

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THE ALTON MIAMI BEACH, FL
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DRAWING TITLE: TREE MITIGATION PLAN + SCHEDULE GROUNDFLOOR © 2022 CLAD, LLC
REVISIONS:
ISSUEDATEDRB FIRST SUBMITTAL12/20/22DRB SECOND SUBMITTAL01/10/23DRB FINAL SUBMITTAL08/07/23
SCALE: PROJ. Nº:


1/16" = 1'-0"

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SHEET N°:

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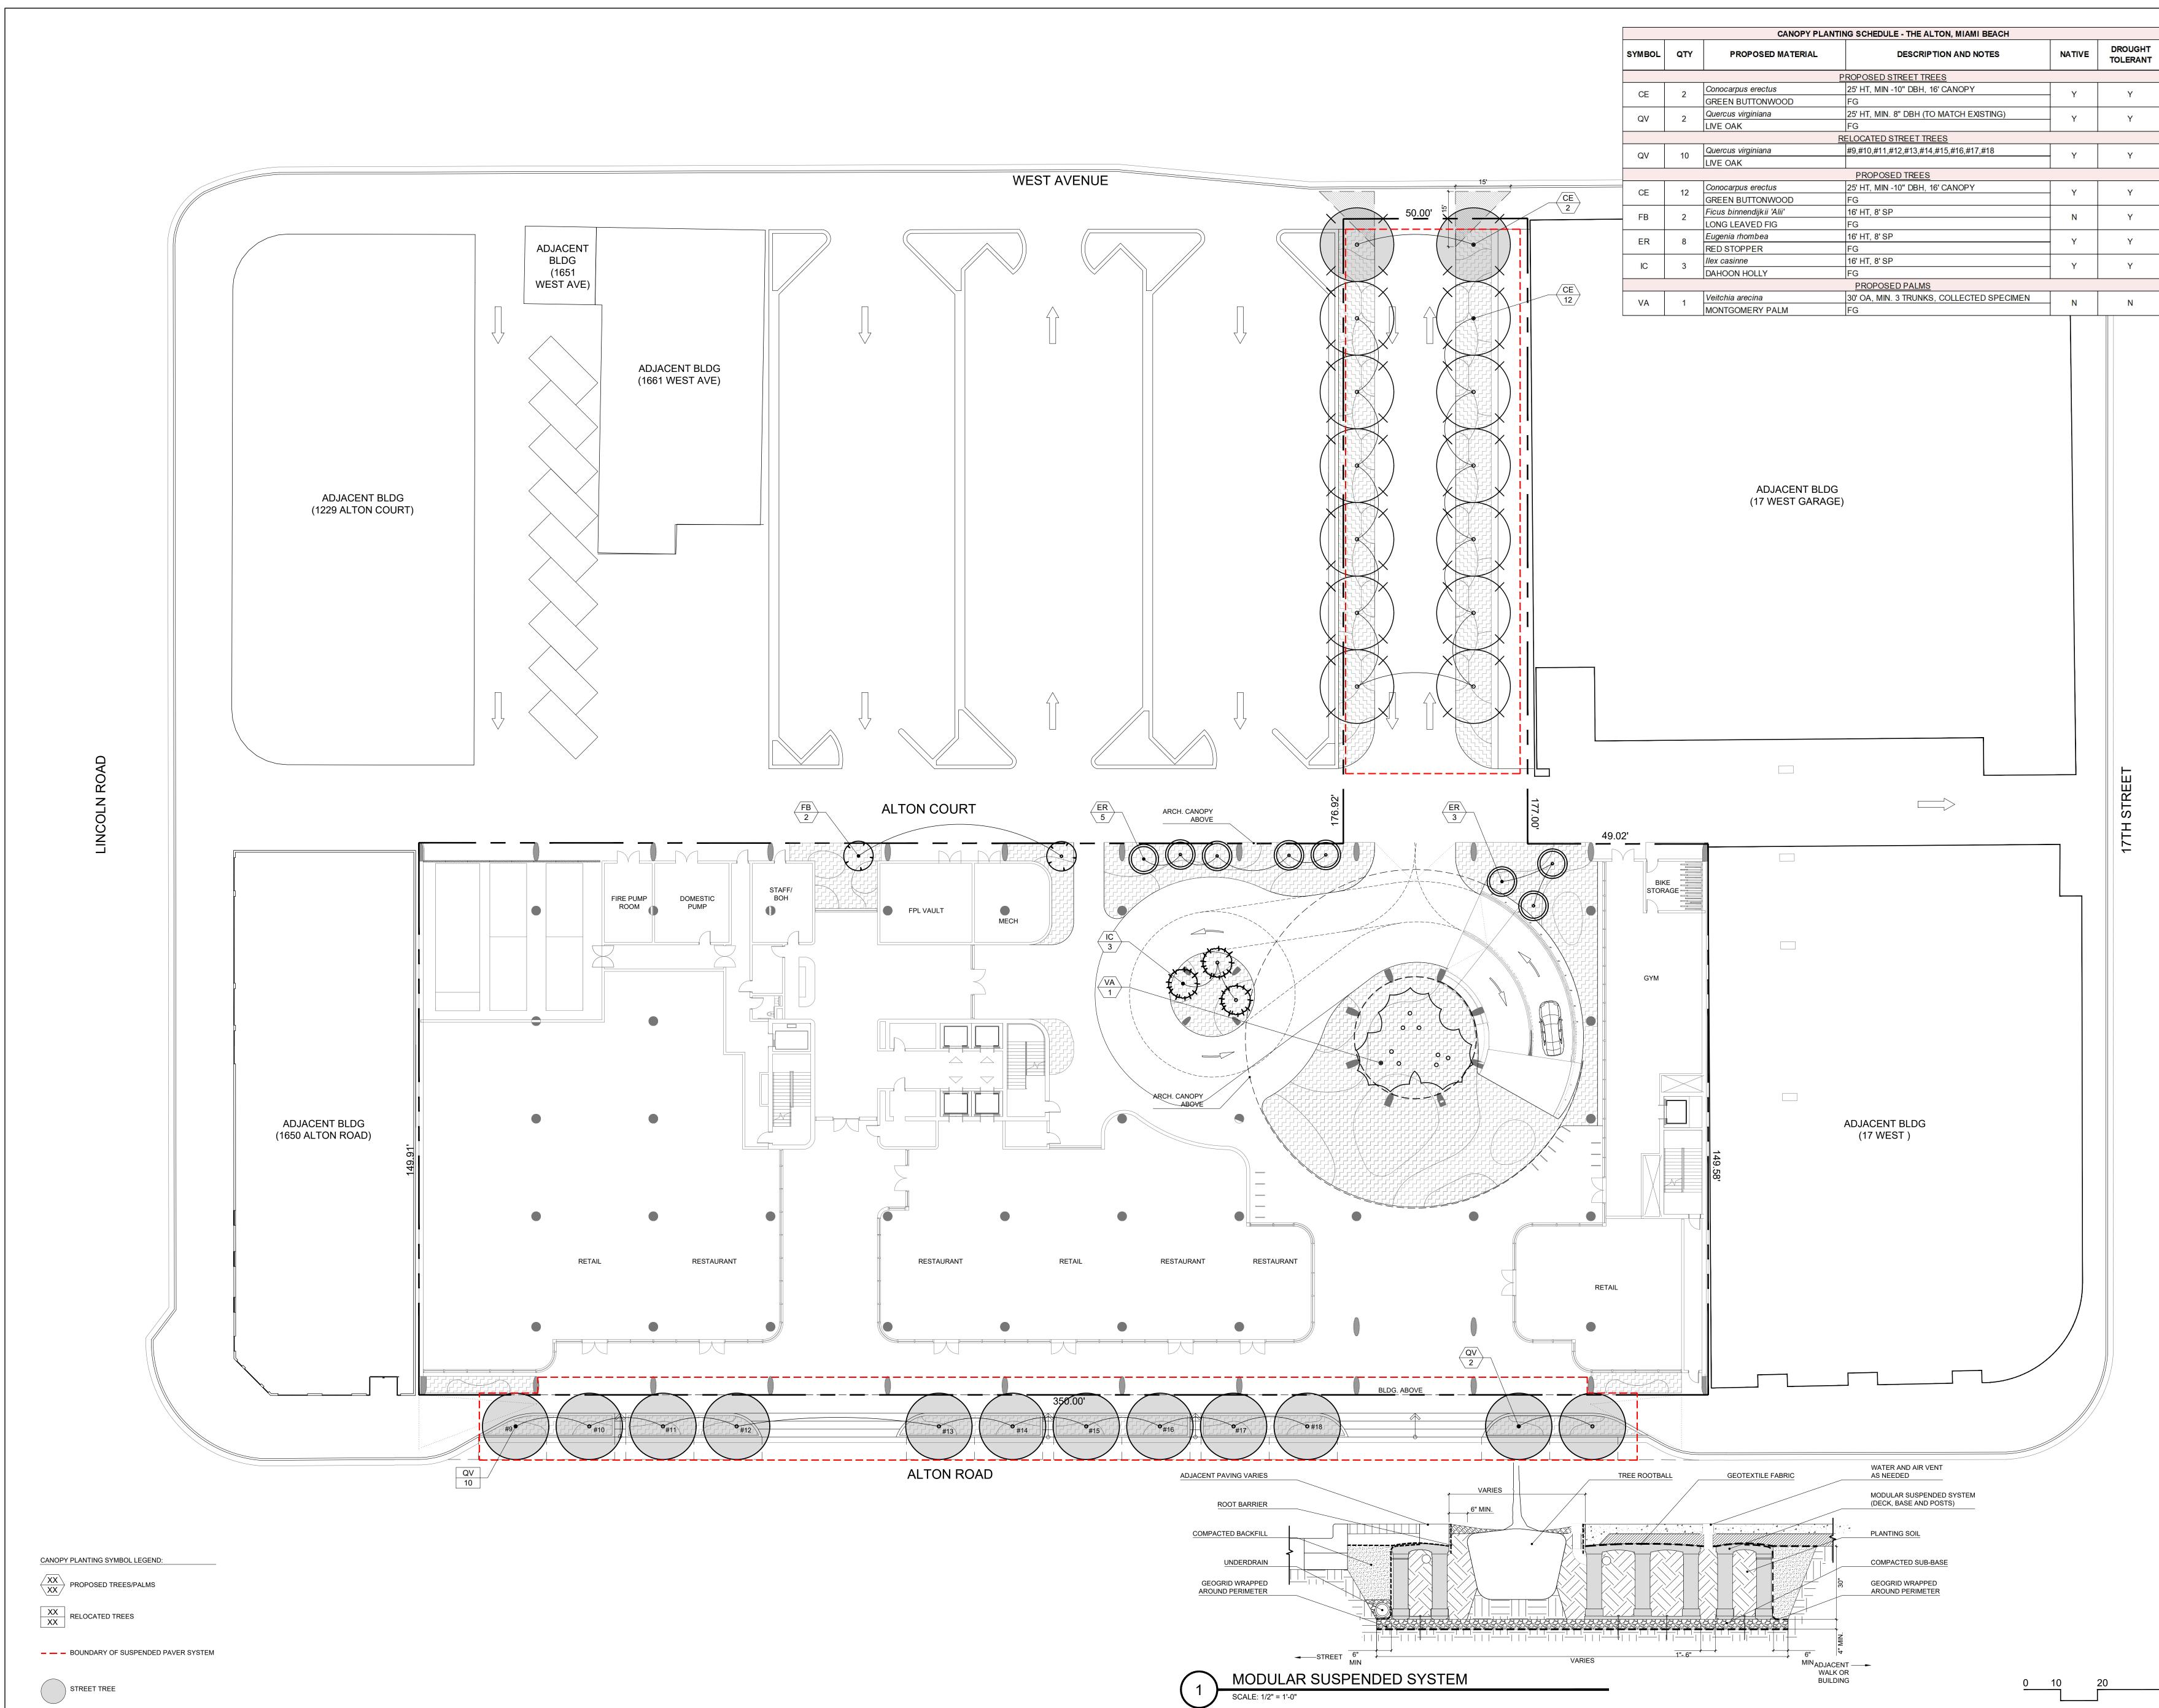



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MIAMI BEACH, FL 
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REGISTERED LANDSCAPE ARCHITECT LA6667311 DRAWING TITLE: ILLUSTRATIVE SITE PLAN GROUNDFLOOR
REGISTERED LANDSCAPE ARCHITECT LA6667311 DRAWING TITLE: ILLUSTRATIVE SITE PLAN GROUNDFLOOR © 2022 CLAD, LLC REVISIONS: ISSUE DATE DRB FIRST SUBMITTAL 12/20/22
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REGISTERED LANDSCAPE ARCHITECT LA6667311 DRAWING TITLE: ILLUSTRATIVE SITE PLAN GROUNDFLOOR © 2022 CLAD, LLC REVISIONS: ISSUE DATE DRB FIRST SUBMITTAL 12/20/22 DRB SECOND SUBMITTAL 01/10/23

2232 SHEET N°:

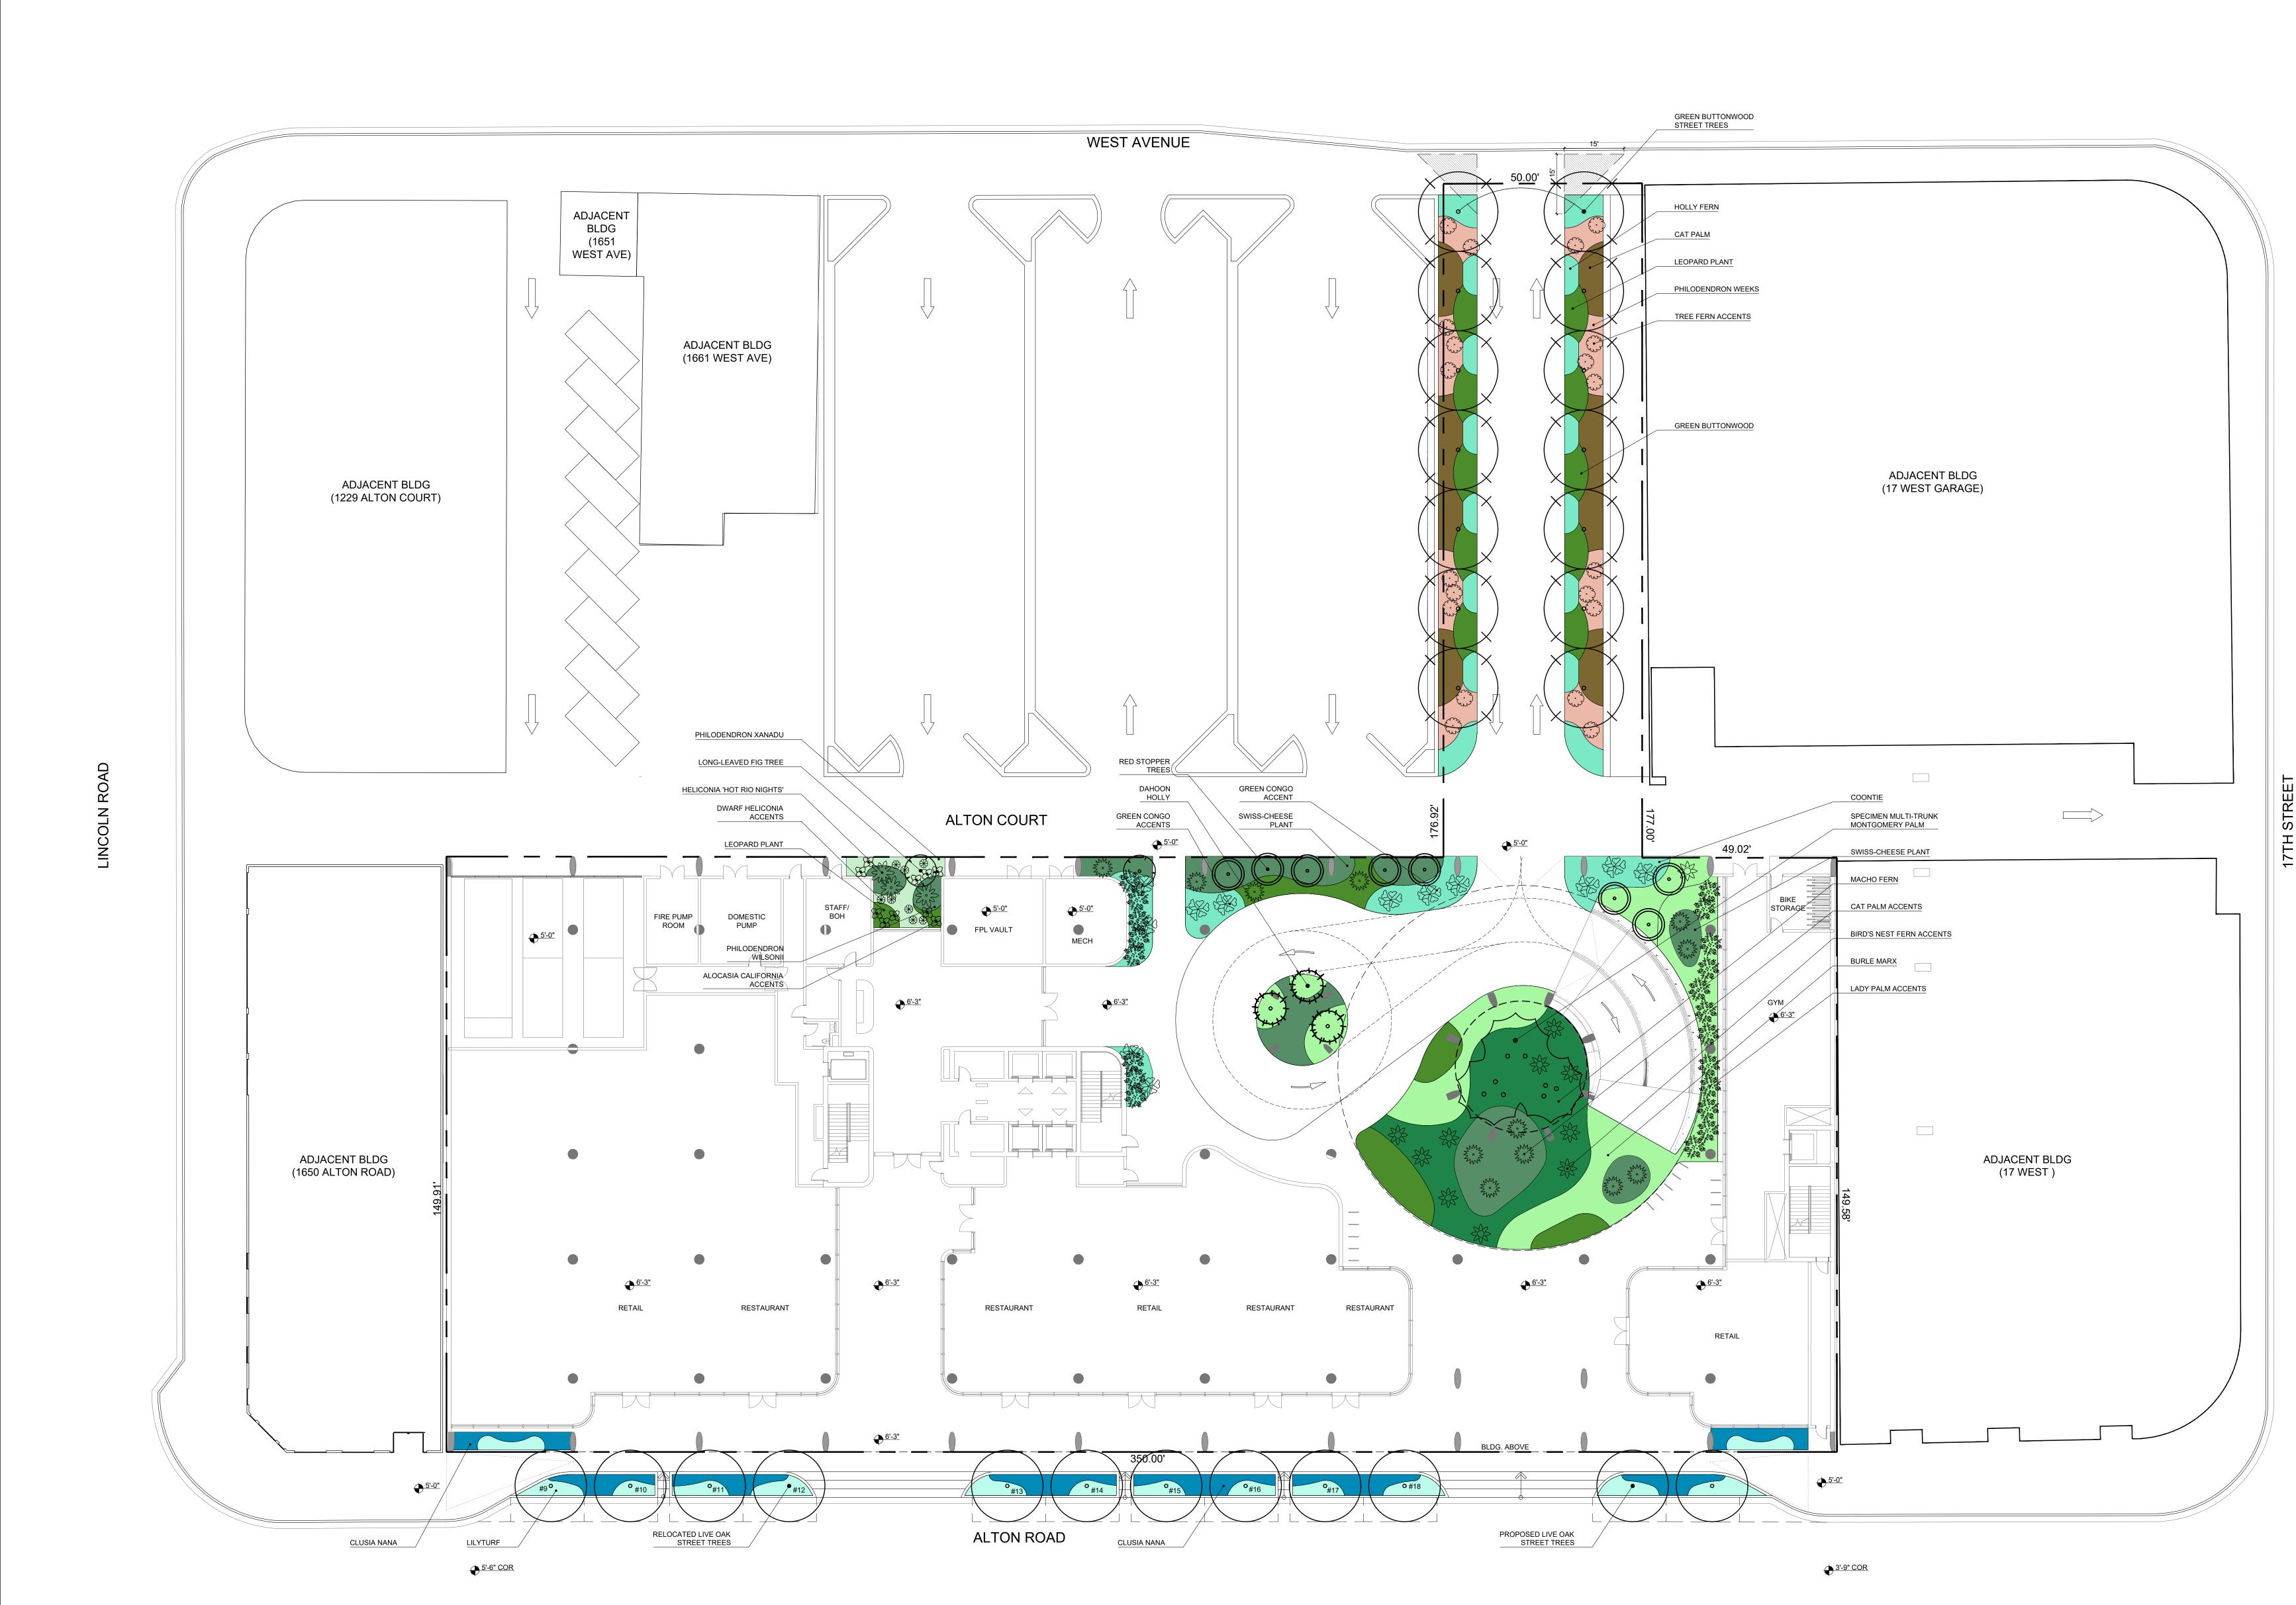
L-2

1/16" = 1'-0"




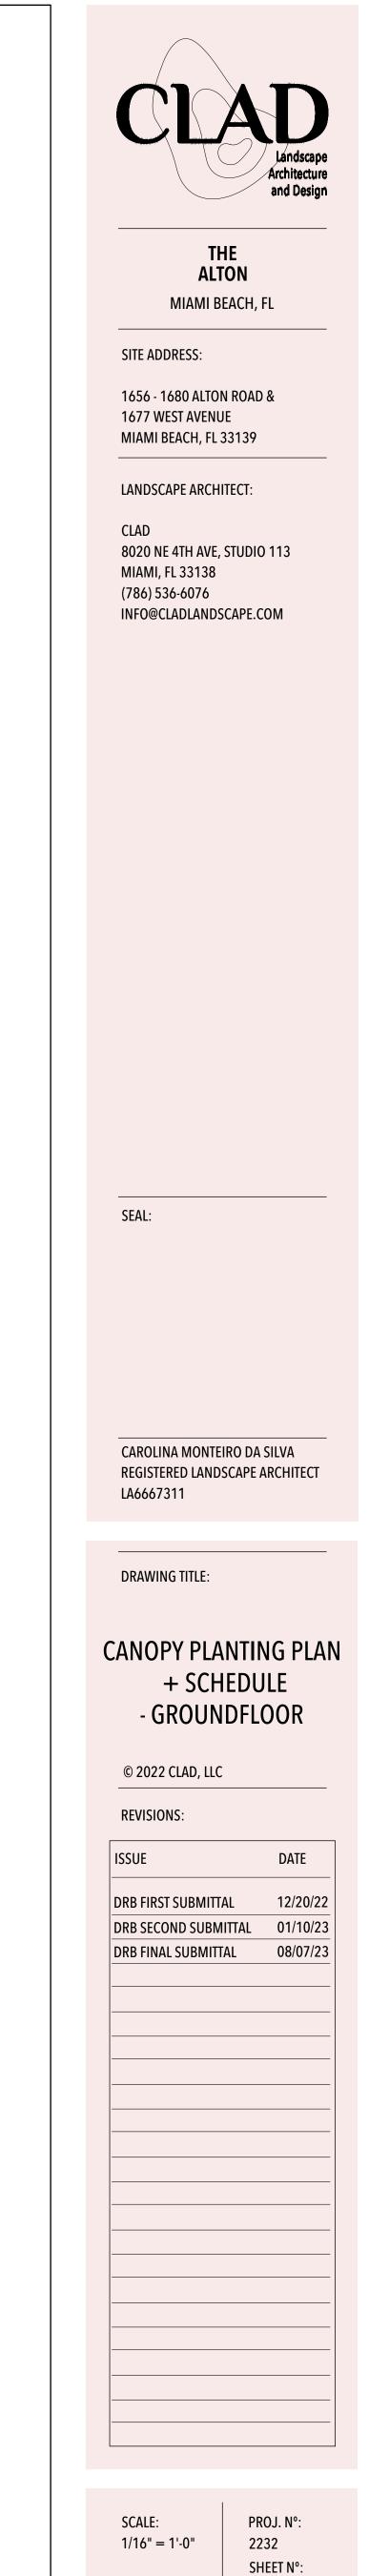

L-5

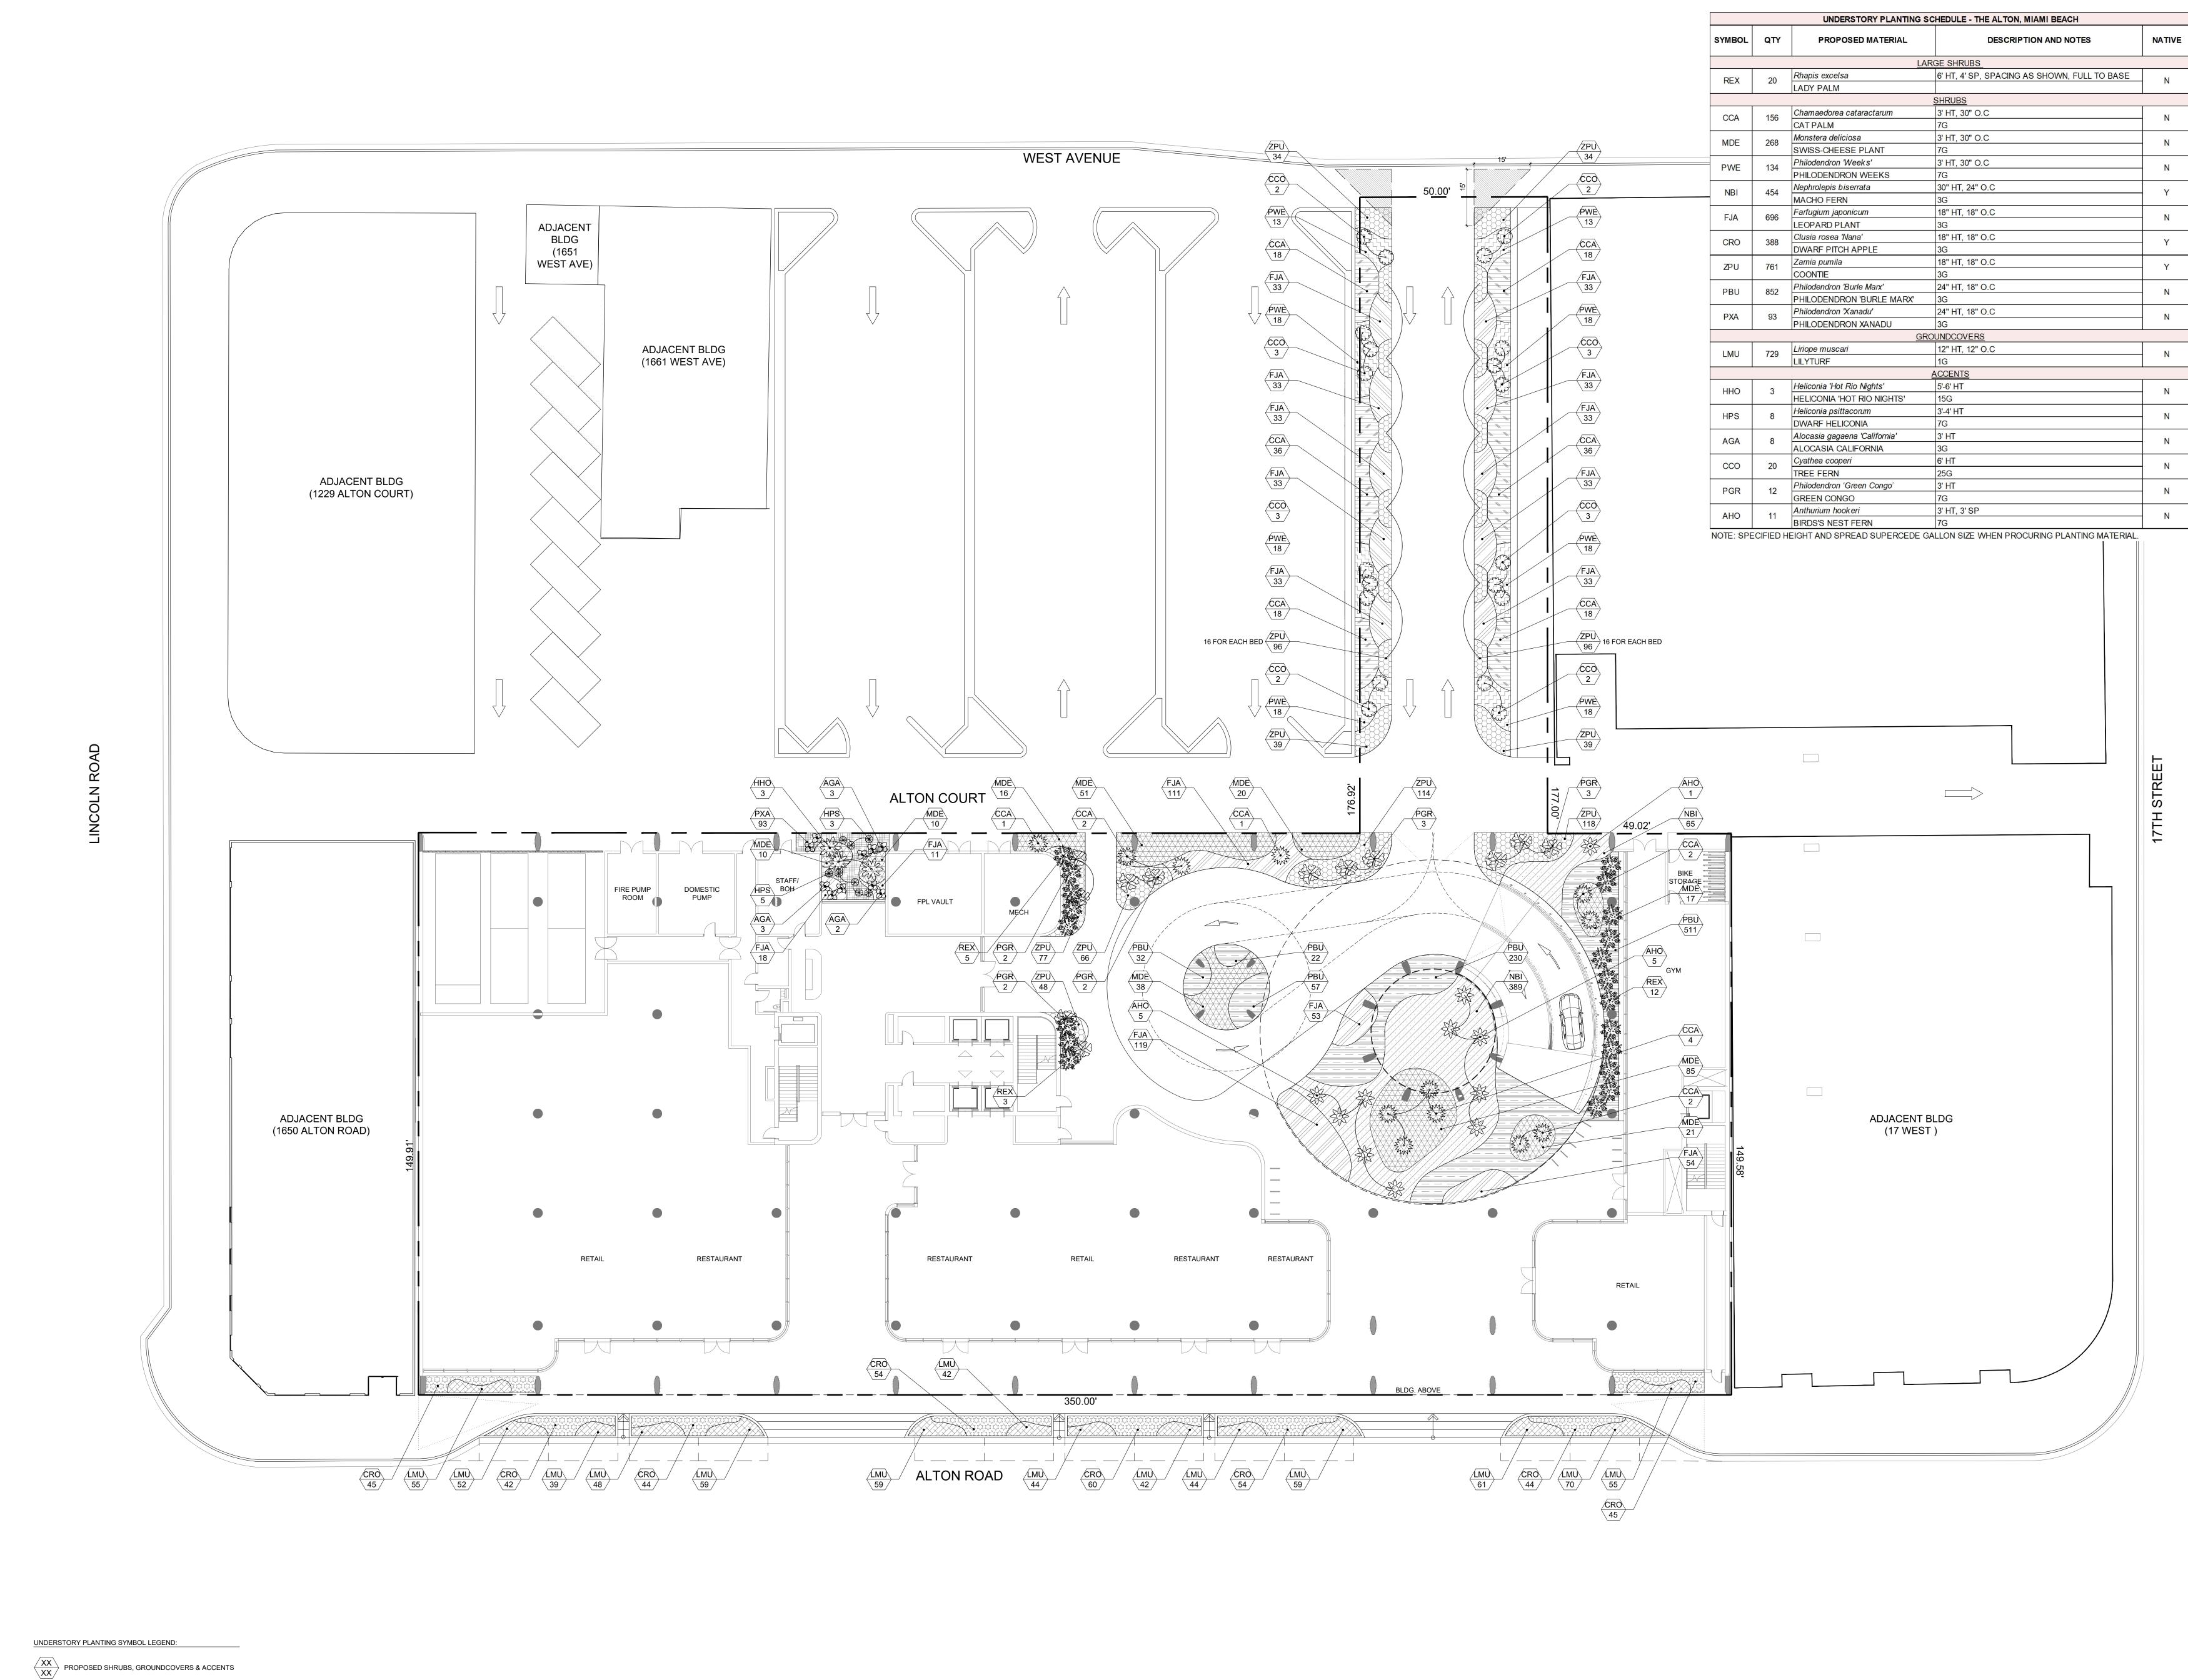


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CANOPY PLANTING SYMBOL LEGEND:

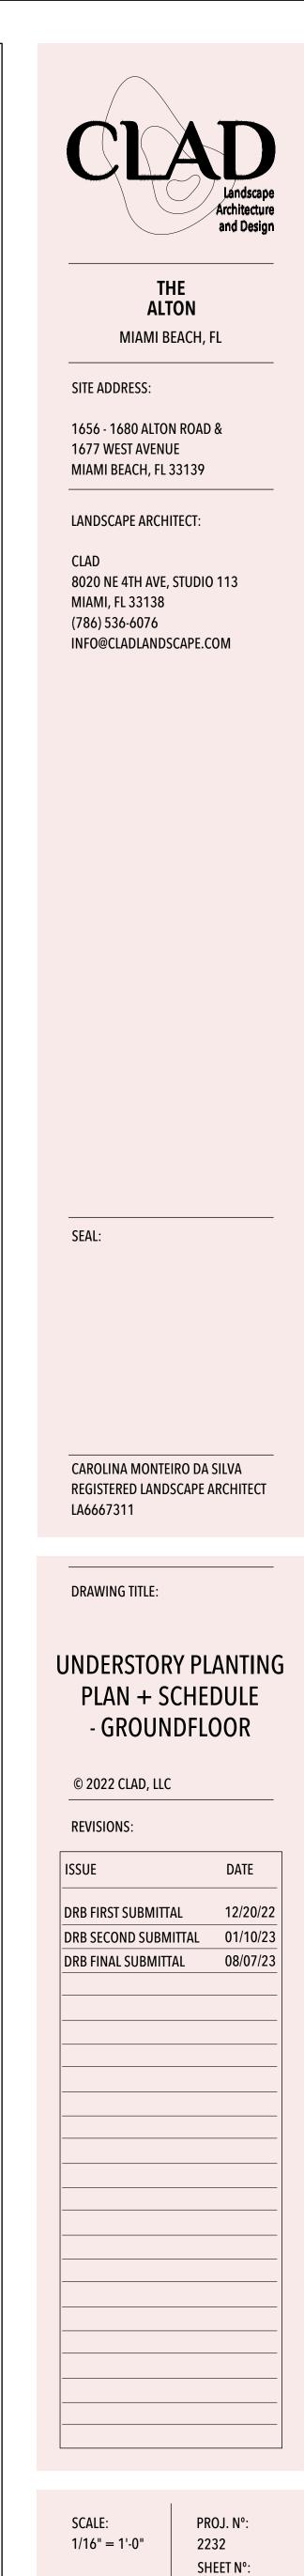XX XX PROPOSED TREES

PROPOSED TREE TO COMPENSATE FOR THE REQUIRED STREET TREE COUNT.

		CANOPY PLANT	NG SCHEDULE - THE ALTON, MIAMI BEACH	_	
SYMBOL	QTY	PROPOSED MATERIAL	DESCRIPTION AND NOTES	NATIVE	DROUGHT TOLERANT
			PROPOSED TREES		
PR	1	Pimenta racemosa	16' HT, 8' SP	N	V
FIX	ļ.	BAYRUM	FG		1
CU	5	Coccoloba uvifera	16' HT, 8' SP	v	v
0 5		SEAGRAPE	FG	1	T
CR	6	Clusia rosea	16' HT, 8' SP	v	V
UN	6	AUTOGRAPH TREE	FG		Ŷ

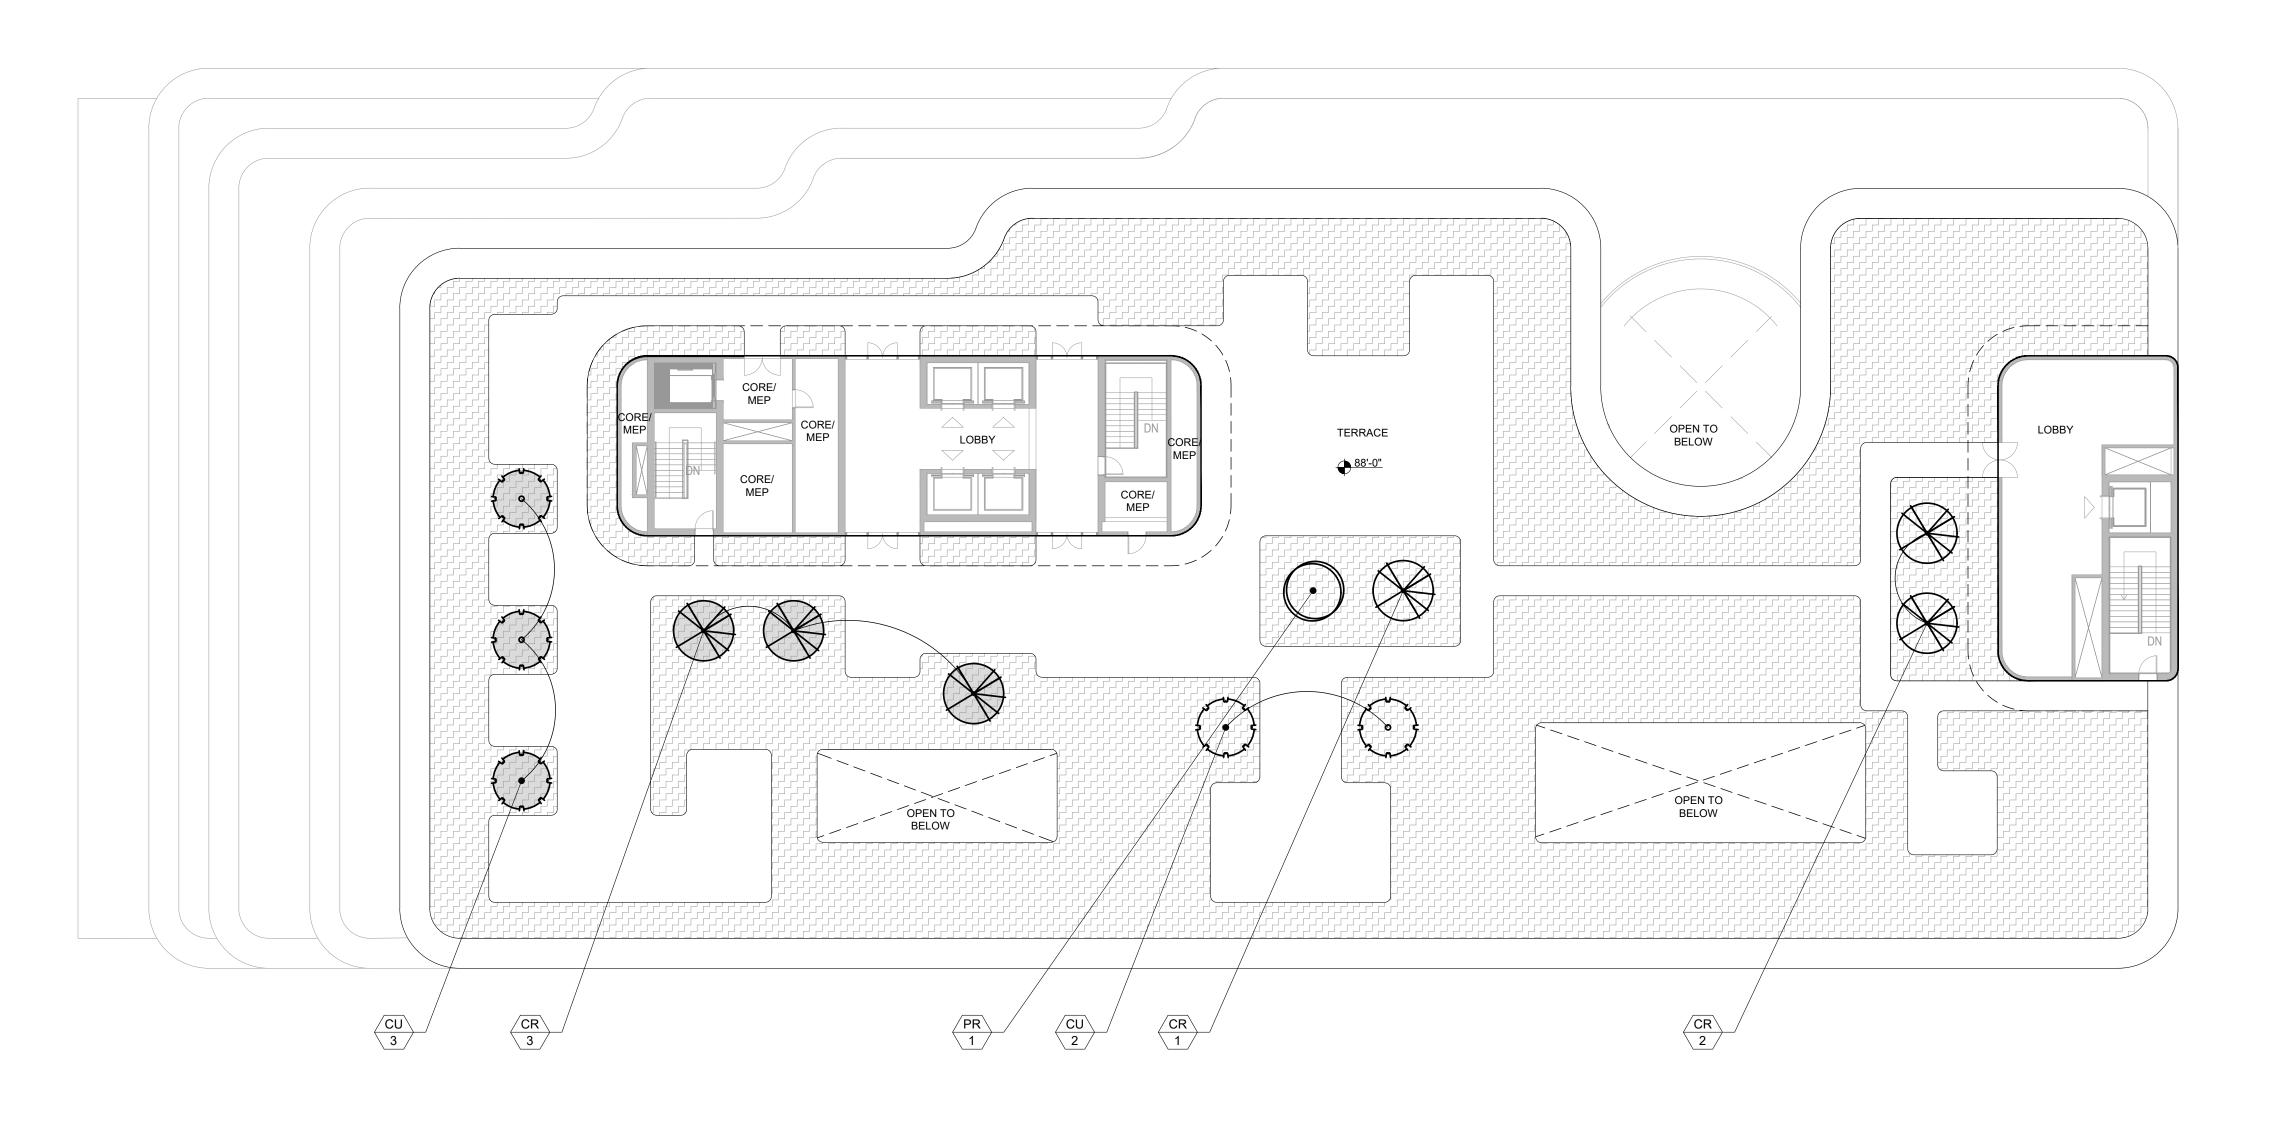0 10 20 40

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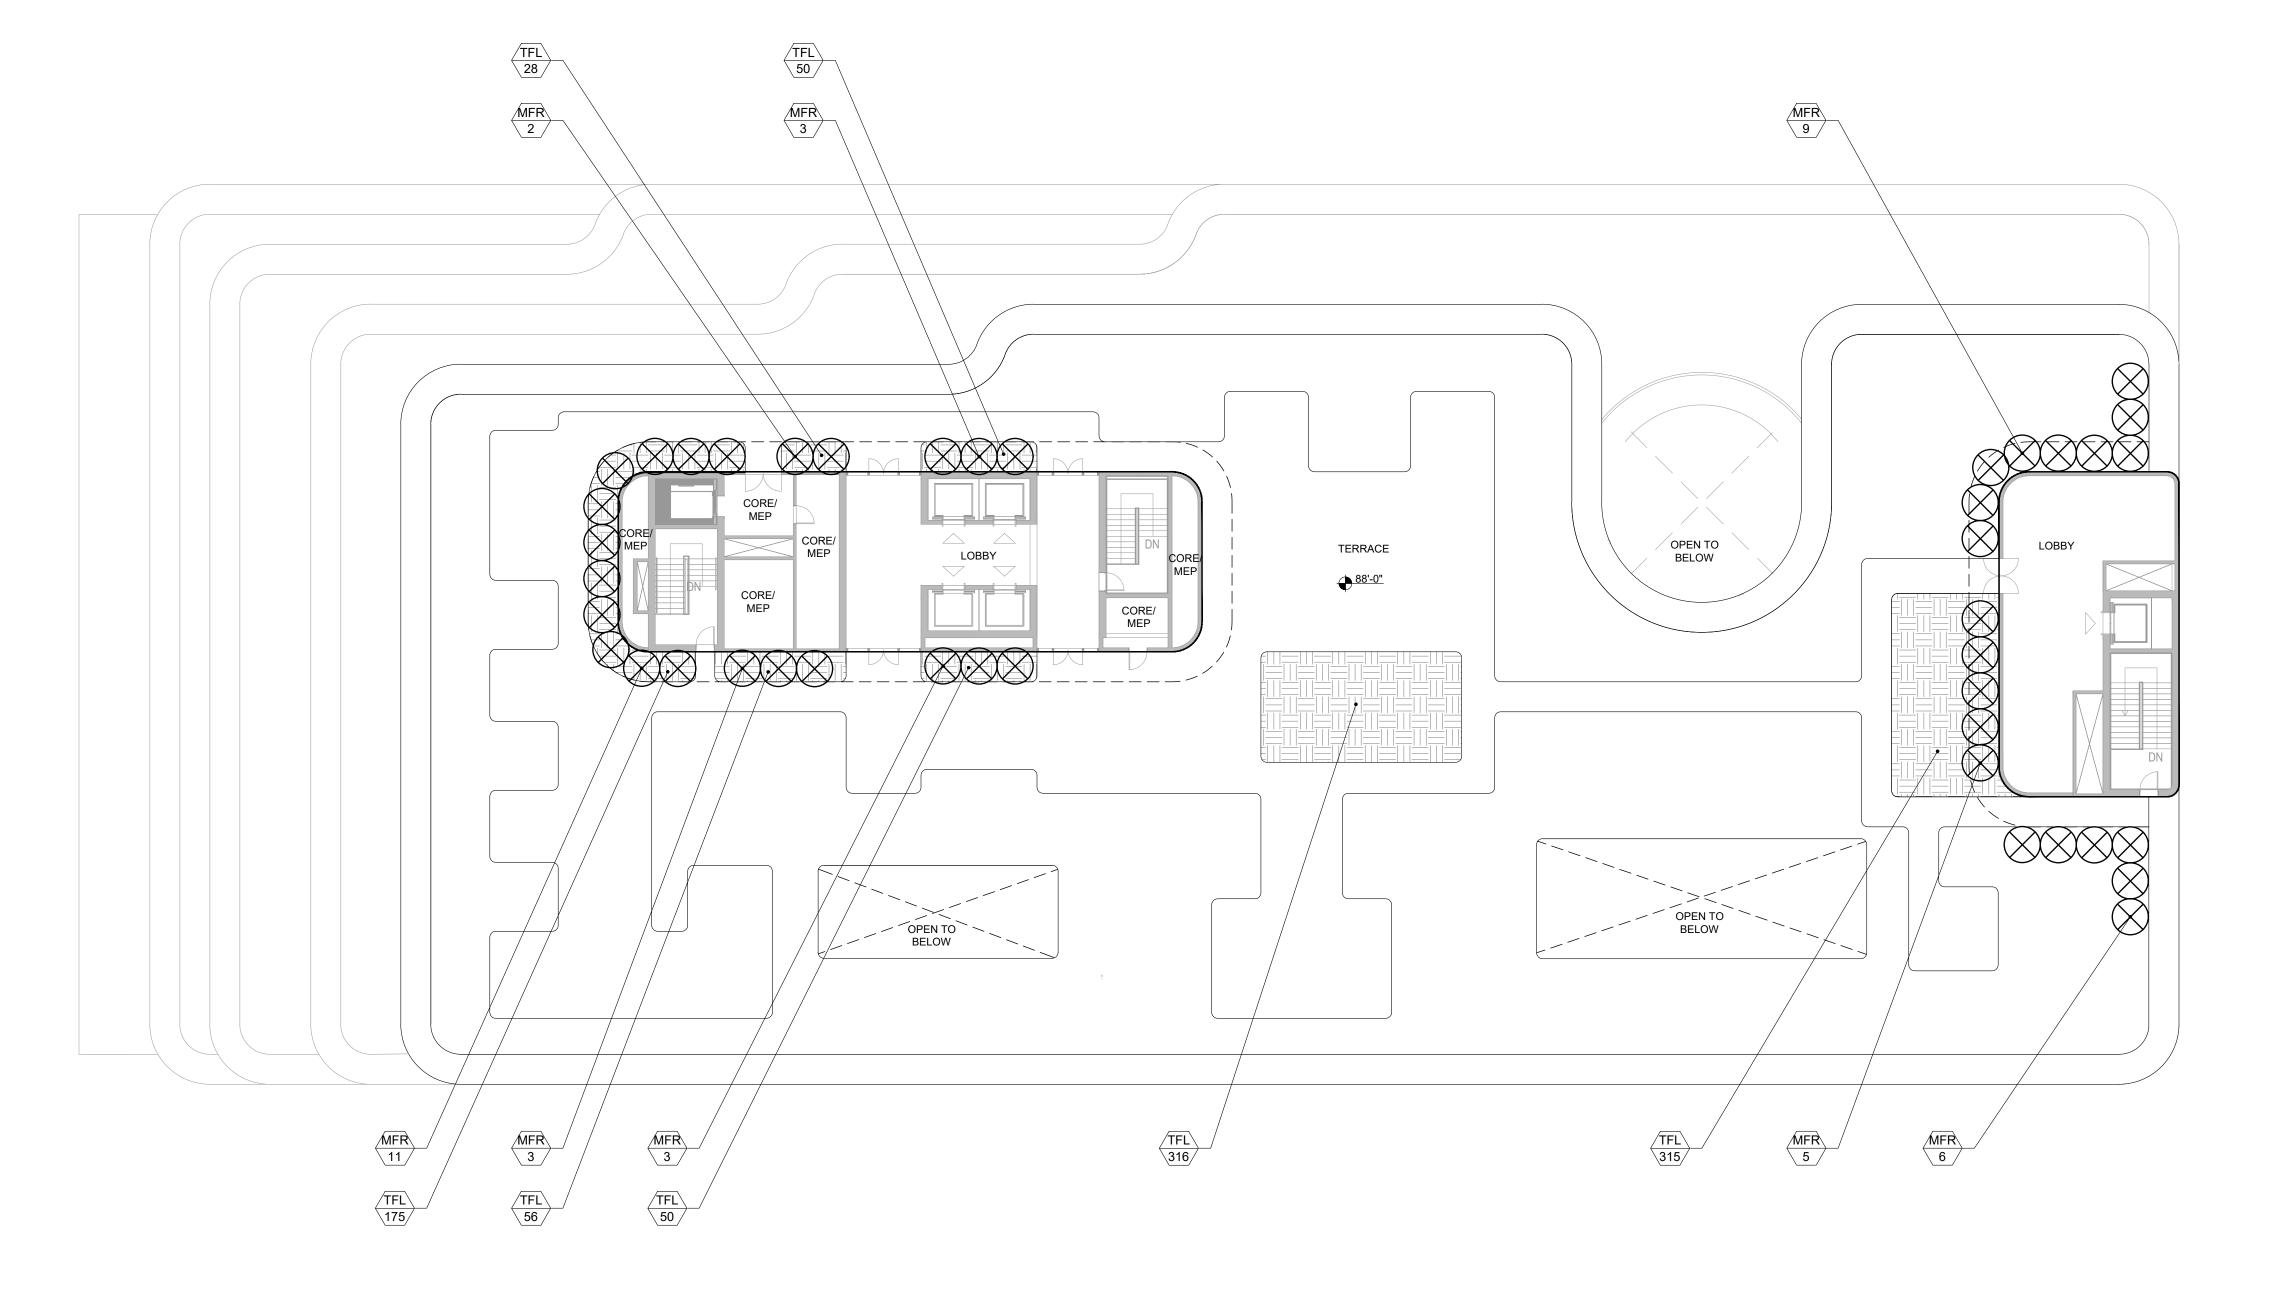
1/16" = 1'-0"

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2232


SHEET N°:

L-5.7



UNDERSTORY PLANTING SYMBOL LEGEND: XX XX PROPOSED SHRUBS

	UNDERSTORY PLANTING SCHEDULE - THE ALTON, MIAMI BEACH						
SYMBOL	QTY	PROPOSED MATERIAL	DESCRIPTION AND NOTES	NATIVE			
	LARGE SHRUBS						
MFR	42	Myrcianthes fragans	6' HT, 4' SP, SPACING AS SHOWN, FULL TO BASE	Y			
	42	SIMPSON'S STOPPER					
			<u>SHRUBS</u>				
TFL	990	Tripsacum floridana	18" HT, 18" O.C	v			
IL	990	DWARF FAKAHATCHEE GRASS	3G	T			
NOTE: SPECIFIED HEIGHT AND SPREAD SUPERCEDE GALLON SIZE WHEN PROCURING PLANTING MATERIAL							

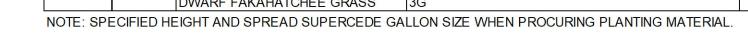



	ULAD
	Landscape Architecture and Design
	THE ALTON
	MIAMI BEACH, FL
	SITE ADDRESS:
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	LANDSCAPE ARCHITECT:
	CLAD
	8020 NE 4TH AVE, STUDIO 113 MIAMI, FL 33138
	(786) 536-6076 INFO@CLADLANDSCAPE.COM
	SEAL:
	CAROLINA MONTEIRO DA SILVA
	REGISTERED LANDSCAPE ARCHITECT LA6667311
	DRAWING TITLE:
	UNDERSTORY
	PLANTING PLAN
	LEVEL 7 ROOF
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	REVISIONS:
	ISSUE DATE
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	DRB FINAL SUBMITTAL 08/07/23
	SCALE: PROJ. N°: 1/16" = 1'-0" 2232 SHEET N°:
	L-5.8

## CITY OF MIAMI BEACH

### LANDSCAPE LEGEND


	INFORMATION REQUIRED TO BE PERMANENTLY AFFIXED TO PLANS Zoning District <u>CD-2 COMMERCIAL</u> , MEDIUM INTENSITY DISTRICT Lot A	rea <u>60,911</u> SF	Acres <u>1.398</u>
		REQUIRED/	
	OPEN SPACE	ALLOWED	PROVIDED
A.	Square feet of required Open Space as indicated on site plan:		
	Lot Area = _60,911_ s.f.x 20 % = _12,182 _ s.f.	12,182	9,365
B.	Square feet of parking lot open space required as indicated on site pl		
	Number of parking spaces <u>N/A</u> x 10 s.f. parking space =	N/A	N/A
C.	Total square feet of landscaped open space required: A+B=	N/A	N/A
۸	LAWN AREA CALCULATION	12 102	0.205
A.		12,182	9,365
В.	, ,,	2,436	0
٨	<u>TREES</u> Number of trees required per lot or net lot acre=		
А.	_22_trees X 1.398 net lot acres - number of existing trees _0_=	31	31*
		*(6 SHALL BE	
		UPPER	
B.	% Natives required: Number of trees provided x 30% =	9	25
C.	- % Low maintenance / drought and salt tolerant required:		
	Number of trees provided x 50%=	13	25
D.	Street Trees (maximum average spacing of 20' o.c.)		
	_400.00'_linear feet along street divided by 20'=	20	20*
E.	Street tree species allowed directly beneath power lines:	*(6 SHALL BE	PLANTED AT
	(maximum average spacing of 20' o.c.):	UPPER	LEVELS)
	<u>N/A</u> linear feet along street divided by 20'=	N/A	N/A
F.	Number of total trees required (lot + street) =	51	
	SHRUBS		
Α.	Number of shrubs required: Sum of lot and street trees required x 12:	612	3,802
B.	% Native shrubs required: Number of shrubs provided x 50%=	1,901	2,593
	-	*(990 SHALL B	E PLANTED AT
	LARGE SHRUBS OR SMALL TREES	UPPER	LEVELS)
Α.	Number of large shrubs or small trees required: Number of required		
-	shrubs x 10%=	62	62
Β.	% Native large shrubs or small trees required: Number of large	24	42
	shrubs or small trees provided x 50%=	31	42
	<u>SPECIES DIVERSITY</u> 31 OR MORE REQUIRED SITE TREES:	7	7
			<u> </u>

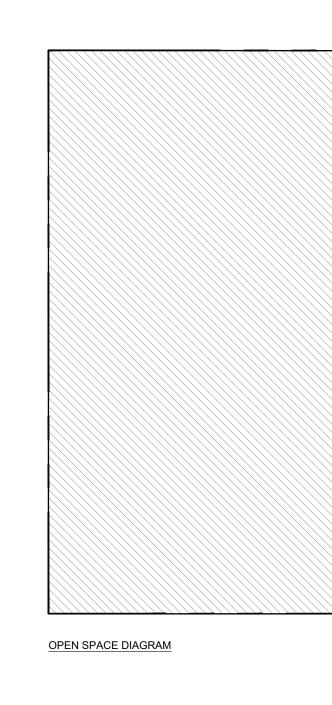

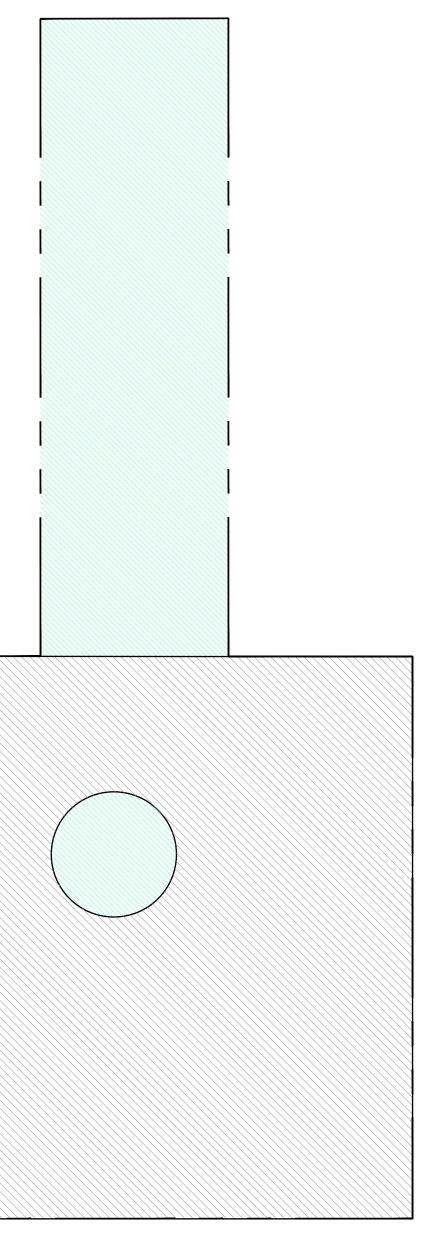


OPEN SPACE AREA: LOT AREA: 60,911 SF OPEN SPACE REQUIRED: 12,182 SF (LOT AREA X 20%) OPEN SPACE PROVIDED: 9,365 SF

Landscape Architecture and Design
THE
ALTON MIAMI BEACH, FL
SITE ADDRESS:
1656 - 1680 ALTON ROAD & 1677 WEST AVENUE MIAMI BEACH, FL 33139
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LA6667311 DRAWING TITLE: LANDSCAPE LEGEND +
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LA6667311 DRAWING TITLE: LANDSCAPE LEGEND + OPEN SPACE DIAGRAM
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BATTEN AND BRACE ENLARGEMENT

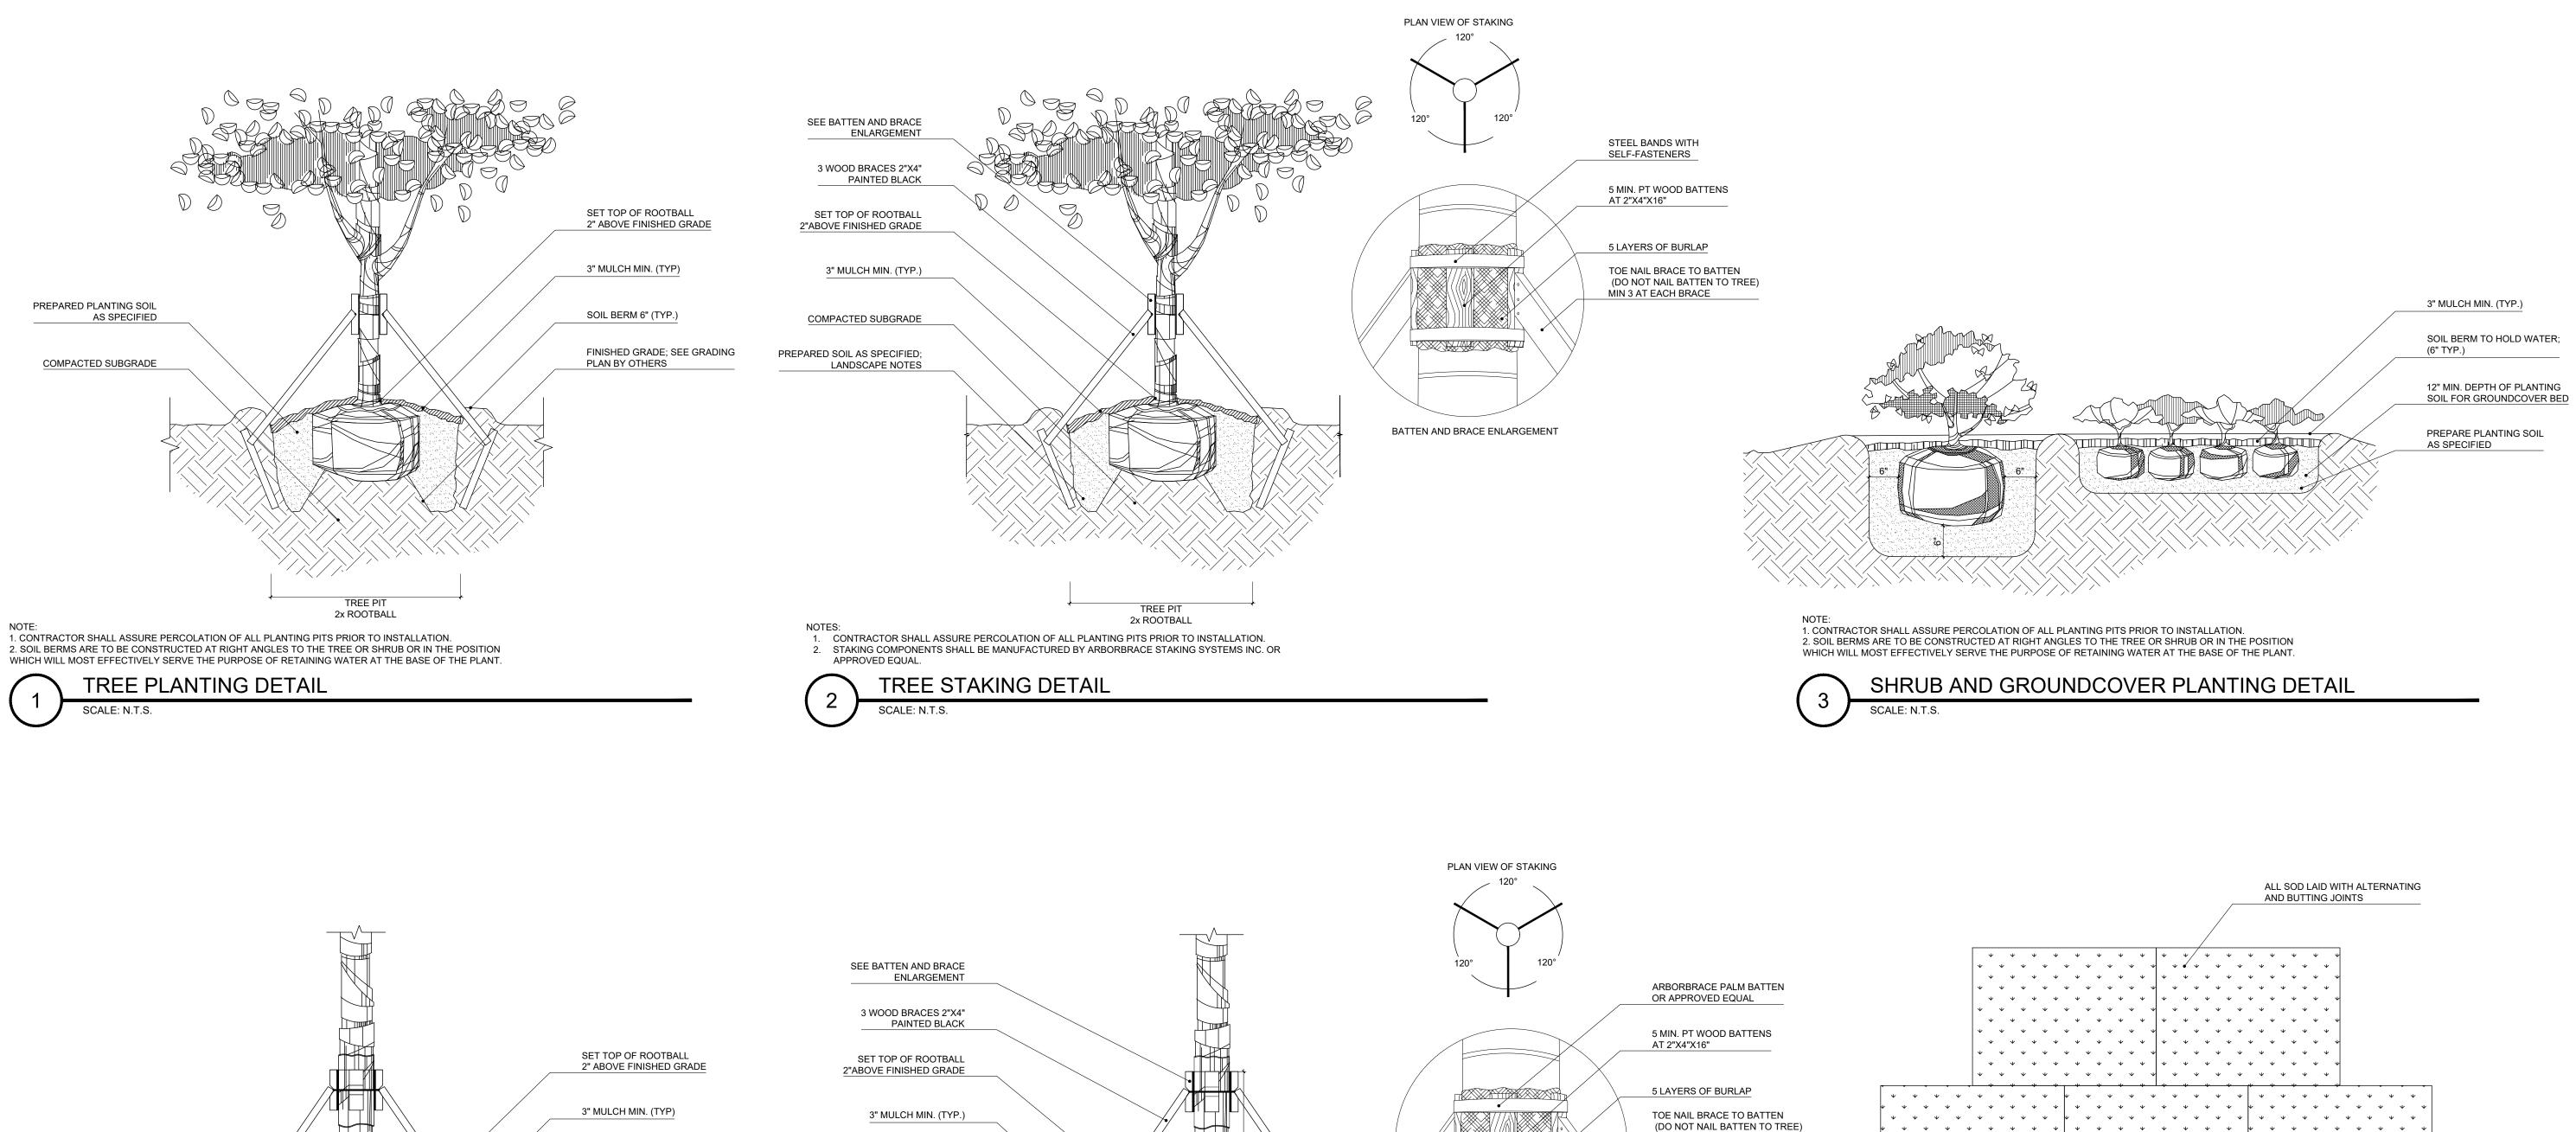

NOTES: CONTRACTOR SHALL ASSURE PERCOLATION OF ALL PLANTING PITS PRIOR TO INSTALLATION.
 STAKING COMPONENTS SHALL BE MANUFACTURED BY ARBORBRACE STAKING SYSTEMS INC. OR

PALM PIT

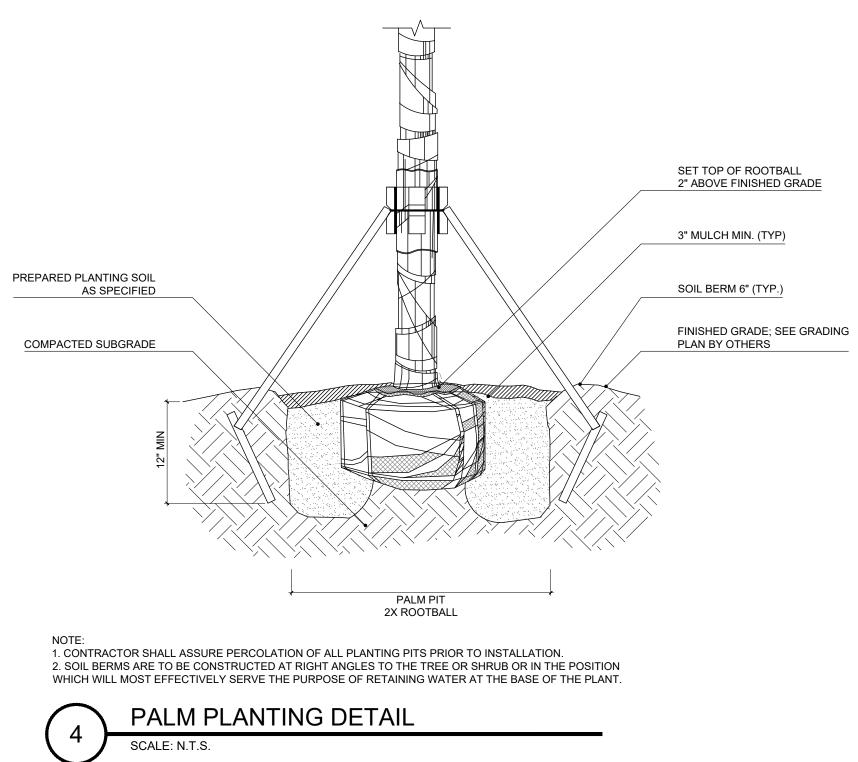2X ROOTBALL

APPROVED EQUAL. PALM STAKING DETAIL

COMPACTED SUBGRADE

PREPARED SOIL AS SPECIFIED;

LANDSCAPE NOTES



SCALE: N.T.S.

MIN 3 AT EACH BRACE 

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> NOTE: PROVIDE 2"-3"OF TOP SOIL FOR FINAL GRADING PRIOR TO LAY DOWN SOD



#### SOD PLANTING DETAIL SCALE: N.T.S.

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THE LITONMIAMI BEACH, FLSITE ADDRESS:1656 · 1680 ALTON ROAD & 1677 WEST AVENUE MIAMI BEACH, FL 33139LANDSCAPE ARCHITECT:CLAD 8020 NE 4TH AVE, STUDIO 113 MIAMI, FL 33138 (786) 536-6076 INFO@CLADLANDSCAPE.COM
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DRAWING TITLE:
SCALE: PROJ. N°: NOT TO SCALE PROJ. N°: 2232 SHEET N°: L-5.10

#### LANDSCAPE NOTES

- SCOPE OF WORK THE WORK CONSISTS OF FURNISHING ALL LABOR, MATERIALS, EQUIPMENT, TOOLS, TRANSPORTATION, AND AN NECESSARY FOR AND INCIDENTAL TO THE COMPLETION OF THIS PROJECT AS SHOWN ON THE DRAWINGS, AS IN AND AS HEREIN SPECIFIED. ii. WORK SHALL INCLUDE MAINTENANCE AND WATERING OF ALL PLANTING AREAS OF THIS DRAWING SET UNTIL CI
- ACCEPTABILITY BY THE OWNER AND/OR THE LANDSCAPE ARCHITECT. iii. PROTECTION OF EXISTING STRUCTURES, ALL EXISTING BUILDINGS, WALKS, WALLS, PAVING, PIPING, AND OTHER AND PLANTING ALREADY COMPLETED OR ESTABLISHED SHALL BE PROTECTED FROM DAMAGE BY THE CONTRA SPECIFIED. ALL DAMAGE RESULTING FROM NEGLIGENCE SHALL BE REPAIRED OR REPLACED TO THE SATISFAC COSTS BY CONTRACTOR.
- iv. ALL WORK SHALL BE PERFORMED TO SPECIFICATIONS WRITTEN IN ACCORDANCE WITH THE MOST CURRENT V ANSI Z-133, GOVERNMENT, AND LOCAL STANDARDS. 2. TREE PROTECTION:
- i. IT IS THE CONTRACTOR'S RESPONSIBILITY TO NOTE AND PROTECT THE EXISTING TREES TO REMAIN ON SITE. ii. PRIOR TO COMMENCEMENT OF ANY WORK, CONTRACTOR SHALL PERFORM ROUTINE MAINTENANCE, PER ANSI TREES TO REMAIN INCLUDING REMOVAL OF DEAD AND DECAYED WOOD, REMOVAL OF ATTACHED BRANCHES A UNSOUND LIMBS, AND SUBORDINATE BRANCHES WHERE INCLUDED BARK IS PRESENT AND REMOVAL OF BRANC
- AND AIR PENETRATION WITHIN THE CANOPY. iii. DO NOT REMOVE MORE THAN 25% OF THE CANOPY WITHIN A TWELVE-MONTH PERIOD.
- iv. ROOT PRUNING SHALL BE COMPLETED PRIOR TO COMMENCEMENT OF THE CONSTRUCTION ACTIVITIES. THE R SUBJECT TO TEARING, RIPPING OR ANY OTHER METHOD EXCEPT CLEAN CUTS AS DESCRIBED IN ANSI A-300. v. PROTECTIVE BARRIERS SHALL BE PLACED AT THE DRIP LINE OF EACH TREE, CLUSTER OF TREES, OR PRESERV.
- LESS THAN TEN (10) FEET FROM THE TRUNK OF ANY PROTECTED TREE, TREE CLUSTER OR PRESERVATION ARE vi. ALL PROTECTIVE BARRIERS SHALL BE INSTALLED PRIOR TO THE START OF ANY CONSTRUCTION OR SITE DEVEI
- REMOVAL, DEMOLITION OR LAND-CLEARING ACTIVITIES, AND SHALL REMAIN IN PLACE THROUGHOUT ALL PHASE VII. ANY TREE WHOSE ROOT SYSTEM IS IMPACTED SHALL BE WATERED ACCORDING TO THE TREE RELOCATION SPI VIII. WHERE CONSTRUCTION ACTIVITY IMPACTS THE EXISTING TREE ROOT SYSTEM, THE CONTRACTOR, UNDER THE ARBORIST, SHALL ONLY ROOT PRUNE IN THE IMPACTED AREAS PER SPECIFICATIONS WRITTEN IN ACCORDANCE STANDARDS.
- ix. NATURAL GRADE SHALL BE MAINTAINED ON AREAS SURROUNDED BY PROTECTIVE BARRIERS IN THE EVENT THAT THE SITE IS CHANGED.
- x. UNDERGROUND UTILITY LINES, INCLUDING, BUT NOT LIMITED TO, IRRIGATION, PLUMBING, ELECTRICAL, OR TELE SHALL BE PLACED OUTSIDE THE AREAS ENCLOSED BY PROTECTIVE BARRIERS xi. NO VEHICLES, EQUIPMENT, OR STOCKPILING/STORAGE OF MATERIALS SHALL BE PERMITTED WITHIN AREAS SUI BARRIERS
- xii. FENCES, WALKWAYS, AND WALLS SHALL BE CONSTRUCTED TO AVOID DISTURBANCE TO ANY PROTECTED TREE 3. TREE RELOCATION:
- 3.a. RELOCATIONS, GENERAL: TRANSPLANTING SHALL CONSIST OF ON-SITE TRANSPLANTING OF EXISTING PL PROPOSED CONSTRUCTION AREAS TO PERMANENT POSITIONS AS NOTED ON DRAWINGS. i. ALL PLANTING, TRANSPLANTING AND RELOCATING OF TREES OR PALMS SHALL, AT MINIMUM, BE DONE IN COMP SET FORTH IN THE MOST RECENTLY PUBLISHED EDITION OF ANSI A-300 STANDARDS.
- ii. VERIFY THE PRESENCE OF VIGOROUS FEEDER ROOTS PRIOR TO RELOCATION OPERATIONS. iii. SOAK TREE ROOT BALLS TO THE FULL DEPTH DAILY FOR SEVEN CONSECUTIVE DAYS PRIOR TO RELOCATING
- iv. LOCATE POSITION AND ELEVATION WHERE TREES ARE INTENDED TO BE PLANTED FOR VERIFICATION BY THE L v. NOTIFY THE OWNER'S REPRESENTATIVE AND LANDSCAPE ARCHITECT 24 HRS IN ADVANCE OF EACH RELOCATION OBSERVATION OF PROCEDURES.
- vi. MATERIALS TO BE TRANSPLANTED SHALL BE ROOT PRUNED A MINIMUM OF SIX MONTHS PRIOR TO RE-LOCATION VII. CONTRACTOR SHALL MAINTAIN TRANSPLANTED MATERIALS DURING CONSTRUCTION PERIOD BY WATERING, WI FERTILIZING, PRUNING, AND OTHER HORTICULTURAL PRACTICES. viii. OWNER AND/OR LANDSCAPE ARCHITECT SHALL REGULARLY INSPECT THE RELOCATED MATERIALS TO ENSURE
- PRACTICES ARE BEING ADHERED TO. OWNER SHALL SUBMIT A WRITTEN REPORT TO LANDSCAPE DEFICIENCIES FOUND DURING THE MAINTENANCE PERIOD. ANY LOSS OF PLANT MATERIALS DUE TO THE NEGLI CONTRACTOR SHALL RESULT IN THE REPLACEMENT OF THE MATERIAL AT NO ADDITIONAL COST TO THE OWNER SHALL BE REPLACED WITH THE SAME SPECIES OF EQUAL SIZE. **3B. QUALITY ASSURANCE:**
- i. THE SUPERVISORS FOR TRANSPLANTING EXISTING TREES, PALMS AND/ OR SHRUBS SHALL HAVE A MINIMUM OF THE FIELD OF RELOCATION OF SIMILAR TYPE PLANT MATERIALS AND SHALL BE A MEMBER OF THE AMERICAN A NURSERYMAN. ii. CONTRACTOR MUST VERIFY THE LOCATIONS OF ALL EXISTING UTILITIES, STRUCTURES AND PLANT MATERIAL
- iii. CONTRACTOR SHALL OBTAIN ALL PERMITS REQUIRED PRIOR TO COMMENCEMENT OF WORK iv. CONTRACTOR SHALL VERIFY THAT TREES IN THE FIELD MATCH TREES DESIGNATED IN THE DRAWINGS
- v. VERIFY PERCOLATION RATES AND SOILS ACCEPTABILITY AT LOCATIONS TO WHICH THE TREES ARE TO BE TRAN vi. ALL TREES SHALL BE PRE-TIED IN OR TIED BACK TO PREVENT BREAKAGE AND SCRAPING OF LIMBS IN ORDER T MOVEMENT **3C. PREPARATION:**
- i. FERTILIZATION AND WATERING: a. INJECT FERTILIZER MIXTURE WITHIN 24 HRS AFTER CROWN PRUNING, AND AT A MINIMUM OF 14 DAYS PRIOR TO b. INJECT THE DEEP ROOT FERTILIZER MIXTURE AT A RATE RECOMMENDED BY THE MANUFACTURER INTO THE PL RELOCATED
- ii. CROWN PRUNING a. DO NOT REDUCE CROWN DIMENSIONS; TRIM TREES TO BE RELOCATED BY THINNING THE CROWN ONLY b. REMOVE SEED PODS FROM SABAL PALMS, AND ALL BUT THE YOUNGEST FRONDS. TRIM BOOTS TO A CLEAN RE c. THERE SHOULD BE NO CANOPY PRUNING OR A MINIMUM OF CANOPY PRUNING BEFORE OR AFTER ROOT PRUNI OR DAMAGED BRANCHES SHALL BE PRUNED AT THIS TIME
- iii. ROOT PRUNING: a. PERFORM ROUGH PRUNING AT NO LESS THAN HALF THE DISTANCE BETWEEN THE DRIP LINE AND THE TRUNK. b. PROVIDE A MIN OF 10" OF ROOT BALL DIAMETER FOR EVERY 1" OF TRUNK CALIPER MEASURED AT 12" ABOVE G c. TREES WITH A CALIPER MORE THAN 12" SHALL BE ROOT PRUNED BY HAND.
- d. PRIOR TO TRANSPLANTING, PRUNE ROOT SYSTEMS IN THIRDS, 8 WEEKS APART. 3D. SUBMITTALS: i. SUBMIT A LIST OF EQUIPMENT, PROCEDURES AND LABOR FORCE USED FOR TRANSPLANTING THE WORK.
- ii. ARBORIST MUST PROVIDE TO THE OWNER WEEKLY REPORTS INCLUDING: a. SITE ACTIVITIES SUMMARY AND CONDITIONS RELATING TO ALL TREES ON SITE
- b. EVALUATION OF EACH TREE'S CONDITION c. RECOMMENDATIONS FOR SURVIVABILITY OF RELOCATED TREES iii. SUBMIT MANUFACTURER'S LITERATURE ON WETTING AGENTS, FERTILIZERS, CONDITIONERS AND INJECTION EC 3E. WATER AND IRRIGATION:
- i. CONTRACTOR SHALL PROVIDE WATER FROM A LEGAL SOURCE ii. CONTRACTOR IS RESPONSIBLE FOR HAND WATERING ALL RELOCATED PLANT MATERIAL iii. DAILY WATERING AND MONITORING SHALL BE PERFORMED DURING THE TERM OF THE CONSTRUCTION CONTRA ACCEPTANCE. RATE OF WATER APPLICATION: A MINIMUM OF 20 GALLONS/ INCH CALIPER PER APPLICATION. iv. WATER SHALL BE FREE OF SUBSTANCES HARMFUL TO PLANT GROWTH, OBJECTIONABLE ODOR OR STAINING A
- v. THE WATER SHALL BE CLEAN, FREE OF SOIL, DEBRIS, POISONS, PESTICIDES, CONTAMINANTS, AND ANY OTHER OR INHIBITS VIGOROUS PLANT GROWTH vi. FOR TREES THAT WILL BE RELOCATED, IRRIGATION MUST BE PRESENT AND APPLIED EFFECTIVELY FOR TWO TO ROOT PRUNING, THROUGH THE PERIOD OF ROOT PRUNING, AND AFTER ROOT PRUNING AND TRANSPLANTATIO
- COMPLETELY REESTABLISHED AT THE NEW PLANTING SPACE. VII. A TENSIOMETER SHALL BE USED TO MEASURE AND MONITOR AVAILABLE MOISTURE IN THE GROUND. WEEKLY NOTED IN ARBORIST'S REPORT. 3F. TRANSPLANTING OPERATIONS:
- i. THE LANDSCAPE CONTRACTOR SHALL TAKE ALL PRECAUTIONS TO MINIMIZE SHOCK OF ROOT PRUNING AND TR ACCORDANCE WITH NURSERY TRADE PROCEDURES INCLUDING THE FOLLOWING: a. ROOT PRUNE ONE THIRD OF BALL AT A TIME. b. THIN OUT THE INTERIOR CROWN OF DICOTS, IN A SIMILAR SEQUENCE, TO COMPENSATE FOR ROOT LOSS, LEAV
- INTACT. c. LEAVE MONOCOT LEAVES ALONE, ALLOWING PLANT TO BALANCE ITSELF. PROTECT GROWING POINT AS REQUI d. AFTER ROOT PRUNING, BACKFILL WITH GOOD ORGANIC ROOTING MEDIUM. FERTILIZE WITH ORGANIC FERTILIZE GROWTH AND USE 'ROOT STIMULATOR AND STARTER' BY GREEN LIGHT OR APPROVED EQUAL.
- e. MULCH TO REDUCE WEEDS, DISCOURAGE FOOT TRAFFIC AND ITS COMPACTING EFFECT, CONSERVE MOISTURE TEMPERATURE FLUCTUATION. f. BRACE TRUNK AND LEAVE IN PLACE UNTIL TREES ARE WIND FORM (+/-1 YEAR).
- g. AT THE TIME OF PLANTING, FILL AIR POCKETS TO KEEP ROOTS, ESPECIALLY FEEDER ROOTS MOIST, ALIVE AND FOR WATERING NEW TRANSPLANT. DIRECT FINE SPRAY AT FOLIAGE TO HELP HARDEN OFF NEW LEAVES. 3G. EQUIPMENT: i. ALL TRANSPLANTING MACHINES WILL HAVE CLEAN, TIGHT FITTING AND SHARP BLADES.
- ii. TREES TO BE RELOCATED IN EXCESS OF 12" CALIPER SHALL BE RELOCATED VIA BOX OR OTHER APPROVED ME 3H. DIGGING AND MOVING:
- i. DIG PITS TO A MINIMUM OF 42" DEEP WITH VERTICAL SIDES AND BOTTOMS. ii. HANDLE TREES TO AVOID DAMAGE TO BARK AND LIMBS. ATTACH SUPPORT STRAPS, CABLES, OR CHAIN AT MUL
- DISTRIBUTION. iii. DO NOT FORCE TREE FROM GROUND PRIOR TO UNDERCUTTING ROOT BALLS. DETERMINE FINAL BALL DEPTH U CONDITIONS AT TIME OF TRENCHING. NOTIFY LANDSCAPE ARCHITECT IF BALL DEPTH VARIES FOR SPECIFIED I
- iv. PLACE TREES IN HEAVY GRADE BASKETS LINED WITH TWO LAYERS OF BURLAP FOR RELOCATION PROCEDURES v. PLANT TOP OF ROOT BALL 3" ABOVE FINISH GRADE.
- vi. ALL TRANSPLANTED TREES SHALL BE WATERED IN, SANDED, MULCHED, AND UNTIED ON THE SAME DAY. vii. STAKE OR BRACE RELOCATED TREES/ PALMS AS SHOWN ON THE DRAWINGS. VIII. SUPPORT TREE WITH MACHINERY UNTIL BRACING IS COMPLETE.
- 3I. POST RELOCATION: . THE CONTRACTOR SHALL MAINTAIN ALL TRANSPLANTED MATERIAL IN A HEALTHY CONDITION UNTIL FINAL ACC
- . THE CONTRACTOR SHALL PREPARE ALL OPERATIONS NECESSARY TO ENSURE THAT PLANTS ARE HEALTHY, V 3J. GUARANTEE:
- . DEATH OF ANY RELOCATED PLANT MATERIAL SHALL BE REPLACED WITH THE SAME SIZE AND SPECIES AND APP ARCHITECT. DETERMINATION OF SURVIVABILITY SHALL BE MADE AT THE END OF THE WARRANTEE PERIOD ii. RELOCATED PLANT MATERIAL INSTALLED BY THE CONTRACTOR SHALL BE WARRANTED IN WRITING FOR A PERI
- THE DATE OF FINAL ACCEPTANCE. 4. MATERIALS
- 4A. SUBMITTALS: i. GENERAL SAMPLES OF MATERIALS AS LISTED BELOW SHALL BE SUBMITTED FOR APPROVAL. ON THE SITE OR AS OTHERWISE DETERMINED WIND.

		BY THE OWNER OR LANDSCAPE ARCHITECT, AT LEAST FOURTEEN (14) WORKING DAYS PRIOR TO ITS INTENDED DELIVERY TO THE SITE. UPON APPROVAL OF SUBMITTALS, DELIVERY OF MATERIALS MAY BEGIN.	ix.	TREE BRACING: FOR MATERIALS GREATER THAN 12' IN HE DEGREES TO THE GROUND PLANE, EQUIDISTANT AROUND
NY OTHER APPURTENANCES	b.	MULCH - ONE (1) CUBIC FOOT ROOT STIMULATOR - ONE (1) CONTAINER		#4 REBAR OR 1/2" GALVANIZED PIPE PASSING THROUGH EA OF THE BRACE. SECURE EACH ANGLED BRACE TO ONE 12
NCLUDED IN THE PLANT LIST, ERTIFICATION OF	d.	FERTILIZER - ONE (1) CONTAINER TOPSOIL - ONE (1) CUBIC YARD PLANTS - ONE (1) REPRESENTATIVE PHOTOGRAPH OF EACH SHRUB AND GROUNDCOVER FOR APPROVAL PRIOR TO TAGGING.		WITH TWO METAL OR PLASTIC STRAPS, ONE 3" FROM THE FOUR 16D NAILS. SEE PLANTING DETAILS SHEET FOR ADD BENJAMIN MOORE 2118-10 UNIVERSAL BLACK, FLAT/MATTI
R ITEMS OF CONSTRUCTION	f.	TREES - ONE PHOTOGRAPH W/ CLEARLY LEGIBLE MEASURING ROD OF ACTUAL CONTRACTOR PRE-TAGGED TREES. UPON APPROVAL OF TREE SUBMITTAL, LANDSCAPE CONTRACTOR SHALL PROVIDE AT LEAST ONE WEEK NOTICE TO SCHEDULE TREE TAGGING.		THERE WILL BE NO PLANT MATERIAL PLANTED INTO ROOT SHRUBS AND GROUND COVERS SHALL BE EVENLY SPACE
ACTOR UNLESS OTHERWISE TION OF THE OWNER WITH	Ū	PLANTING MIX - ONE (1) CUBIC YARD 4B. MULCH: MULCH TYPE: PINE BARK MINI NUGGETS		CULTIVATE ALL PLANTING AREAS TO A MINIMUM DEPTH O MIX AS SPECIFIED. THOROUGHLY WATER ALL PLANTS AFT 6F. WATER AND IRRIGATION:
ERSION OF THE ANSI A-300,	ii. iii. iv.	MULCH MATERIAL SHALL BE MOISTENED AT THE TIME OF APPLICATION. ALL TREES, SHRUBS, AND GROUND COVER BEDS SHALL RECEIVE A MINIMUM OF 2" OF MULCH IMMEDIATELY AFTER PLANTING. MULCH SHALL BE MAINTAINED BELOW THE ELEVATION OF ADJACENT FINISHED SURFACES AND SWEPT CLEAR OF PATHS.	i. II.	CONTRACTOR SHALL PROVIDE WATER FROM A LEGAL SO DAILY WATERING AND MONITORING SHALL BE PERFORME ACCEPTANCE.
A-300, ON THE EXISTING		4C. FERTILIZER: COMMERCIAL FERTILIZER: COMMERCIAL FERTILIZER SHALL BE A COMPLETE FORMULA; IT SHALL BE UNIFORM IN COMPOSITION, DRY AND FREE FLOWING. THIS FERTILIZER SHALL BE DELIVERED TO THE SITE IN THE ORIGINAL UNOPENED CONTAINERS, EACH BEARING THE		WATER SHALL BE FREE OF SUBSTANCES HARMFUL TO PL THE WATER SHALL BE CLEAN, FREE OF SOIL, DEBRIS, POI OR INHIBITS VIGOROUS PLANT GROWTH
ND STRUCTURALLY CHES TO INCREASE LIGHT		MANUFACTURER'S GUARANTEED STATEMENT OF ANALYSIS. FERTILIZER SHALL BE ORGANIC IN MATERIAL CONTAINING NITROGEN, PHOSPHORIC ACID AND POTASH IN EQUAL PERCENTAGES OF PLANT FOOD BY WEIGHT, IN THE FOLLOWING FORM:	vi.	ALL LANDSCAPED AREAS WITHIN LIMITS OF WORK SHALL WELL AND/OR DOMESTIC WATER SUPPLY. IF DOMESTIC W IRRIGATION SYSTEM SHALL PROVIDE 100% COVERAGE WI
COOT SYSTEM SHALL NOT BE	iv.	CONTAINERIZED MATERIAL (I.E. SHRUBS, VINES, GROUND COVERS) SHALL RECEIVE A GRANULAR SUCH AS 'TRI-NITE' OR APPROVED EQUAL. SPECIMENS SHALL RECEIVE TIME-RELEASED FERTILIZER, SUCH AS OSMOCOTE, OR APPROVED EQUAL. THIS INSTRUCTION SHALL SUPERSEDE OTHER NOTES REGARDING FERTILIZERS ON THE DRAWINGS OR DETAILS.		IRRIGATION SYSTEM SHALL BE EQUIPPED WITH A RAIN SE INSTALLATION OF IRRIGATION SYSTEMS SHALL CONFORM
ATION AREA, AND IN NO CASE		4D. PLANTS:		WARRANTY OF WORK VARRANTY:
LOPMENT, INCLUDING TREE ES OF CONSTRUCTION.	ii.	MATERIAL ON THE PLAN ARE TO BE CONSIDERED AS MINIMUMS. ALL PLANTS SHALL BE FLORIDA GRADE NO.1 OR BETTER, GRADED IN ACCORDANCE WITH GRADES AND STANDARDS FOR NURSERY PLANTS,		CONTRACTOR IS RESPONSIBLE FOR MAINTENANCE ON AL AFTER ACCEPTANCE BY OWNER.
ECIFICATIONS. E GUIDANCE OF AN ASCA E WITH ANSI A-300		PUBLISHED BY THE STATE OF FLORIDA, DEPARTMENT OF AGRICULTURE. TREES AND SHRUBS SHALL HAVE PRONOUNCED SYMMETRY OF FOLIAR CROWN. PLANTS JUDGED TO BE NOT IN ACCORDANCE WITH THESE STANDARDS WILL BE REJECTED AND SHALL BE IMMEDIATELY REMOVED FROM THE SITE OF THE WORK AND REPLACED AT THE CONTRACTOR'S EXPENSE.	11.	AFTER NINETY (90) DAYS, CONTRACTOR MUST VISIT THE S OWNER WITH A WRITTEN LETTER NOTIFYING THE OWNER OWNER'S WARRANTY. CONTRACTOR SHALL WARRANTY A
AT THE NATURAL GRADE OF	iii.	ALL QUANTITIES INDICATED ON THE PLANT LIST ARE INTENDED AS A GUIDE FOR THE BIDDERS AND DOES NOT RELIEVE THE BIDDER OF THEIR RESPONSIBILITY TO DO A COMPREHENSIVE PLANT TAKE OFF. SHOULD A DISCREPANCY OCCUR BETWEEN THE BIDDER'S TAKE OFF		ACCEPTANCE BY THE OWNER. IAINTENANCE:
ECOMMUNICATION LINES,		AND THE PLANT LIST QUANTITY, THE LANDSCAPE ARCHITECT IS TO BE NOTIFIED FOR CLARIFICATION PRIOR TO FINAL BID ACCEPTANCE. 4E. PLANTING MIX: PLANTING MIX SHALL BE 70/30 MIX. 70% CRUSHED OOLITIC LIMESTONE OR SAND, AND 30% ORGANIC MATERIAL (COMPOSED OF 15%	i.	OWNER IS RESPONSIBLE TO ENSURE THAT LANDSCAPING COMPLIANCE WITH THE LANDSCAPE REQUIREMENTS; MAI FROM REFUSE AND DEBRIS; AND SUFFICIENTLY FERTILIZE
RROUNDED BY PROTECTIVE		DECOMPOSED WOOD CHIPS AND 15% EVERGLADES PEAT). THE LANDSCAPE ARCHITECT RESERVES THE RIGHT TO REJECT PLANTING MIX UTILIZED THAT FAILS TO MEET THE SPECIFICATION AT ANY	ii.	IF ANY TREE OR PLANT DIES WHICH IS BEING USED TO SA BE REPLACED WITH THE SAME LANDSCAPE MATERIAL OR
Ξ.		TIME DURING EXECUTION OF WORK. 4F. SOD: SELECTION:		TREES SHALL BE PRUNED IN THE FOLLOWING MATTER: ALL CUTS SHALL BE CLEAN, FLUSH, AND AT JUNCTIONS, L THE TRUNK OR PARENT LIMB
ANT MATERIALS FROM	a.	GRASS SPECIES: TBD AMERICAN SOD PRODUCERS ASSOCIATION GRADE: NURSERY GROWN OR APPROVED. FIELD GROWN SOD IS NOT ACCEPTABLE.	b.	REMOVAL OF DEAD WOOD, CROSSING BRANCHES, WEAK SIMULTANEOUSLY WITHOUT ANY REDUCTION IN CROWN.
PLIANCE WITH STANDARDS	d.	FURNISHED IN PADS: 18" X 24" X 1" THICK EXCLUDING TOP GROWTH AND THATCH. NOT STRETCHED, BROKEN OR TORN.		CUTTING OF LATERAL BRANCHES THAT RESULTS IN THE F TREE SHALL ONLY BE ALLOWED IF REQUIRED FOR HAZAR
ANDSCAPE ARCHITECT	f.	UNIFORMLY MOWED HEIGHT WHEN HARVESTED. INSPECTED AND FOUND FREE OF DISEASES, NEMATODES, PESTS, AND PEST LARVAE. UNIFORM IN COLOR, LEAF TEXTURE, AND DENSITY.		LIFTING OF BRANCHES OR TREE THINNING SHALL BE DESI (2/3) OF THE TREE. NO MORE THAN ONE-THIRD (1/3) OF A TREE'S LIVING CANO
ON TO ALLOW FOR	h.	DO NOT DELIVER MORE SOD THAN CAN BE INSTALLED WITHIN 24 HOURS. BEGIN INSTALLATION OF SOD AFTER COMPLETION OF PRECEDING WORK (I.E. EARTH WORK, UNDERGROUND SPRINKLER SYSTEM, SOIL	f. iv.	TREES SHALL BE PRUNED ACCORDING TO THE CURRENT TREES SHALL RECEIVE REGULAR MAINTENANCE FOR A M
N. EEDING, MOWING, SPRAYING,		PREPARATION, INSTALLATION OF TREES, SHRUBS AND GROUND COVERS, ETC.) INSTALLATION: TRANSPLANT SOD WITHIN 48 HOURS AFTER HARVESTING		A CONTRACTED MAINTENANCE SERVICE SHALL BE RESPO CHECK IRRIGATION HEADS AND LINES FOR BREAKS AND F SEASONAL WATER USAGE. CHECK AND MAKE SURE THAT
E THAT ALL HORTICULTURAL R NOTIFYING HIM OF ANY	b.	CONTRACTOR SHALL SOD ALL AREAS THAT ARE NOT PAVED OR PLANTED AS DESIGNATED ON THE DRAWINGS HEREIN BEGIN SODDING AT BOTTOM OF SLOPES		CHECK ALL DRAINS FOR PROPER DRAINAGE. ADDRESS CL OBSERVE ALL PLANTS TO ENSURE THAT NO ABNORMAL Y
GENCE OF THE LANDSCAPE R. SAID PLANT MATERIALS	e.	LAY FIRST ROW OF SOD IN STRAIGHT LINE WITH LONG DIMENSION OF PADS PARALLEL TO SLOPE CONTOURS LAY ALL ROWS WITH ALTERNATING AND ABUTTING JOINTS.	e.	DEFICIENCIES. REPLACE OR REPAIR BRACING AS NECESSARY. MAINTAIN
F 5 YEARS EXPERIENCE IN	g.	DO NOT STRETCH OR OVERLAP ROWS ROLL SOD, EXCEPT PEGGED AREAS, WITH ROLLER WEIGHING NO MORE THAN 100LBS PER FOOT OF ROLLER WIDTH. DURING ROLLING, ALL DEPRESSIONS CAUSED BY SETTLEMENT OF ROLLING SHALL BE FILLED WITH ADDITIONAL SOIL, AND THE SURFACE		TREE HAS DEVELOPED A SUBSTANTIAL ROOT MASS AND F TREES SHALL BE MAINTAINED IN A FIRM POSITION IN THE PROVIDE MULCH OVER ROOTS TO DRIP LINE OF TREE IF A
SSOCIATION OF	iii.	SHALL BE RE-GRADED AND ROLLED UNTIL PRESENTING A SMOOTH AND EVEN FINISH THAT IS UP TO THE REQUIRED GRADE. SOIL PREPARATION:	U	NECESSARY PER NOTE HEREIN. MAINTAIN ALL BEDS FREE OF DEBRIS AND DELETERIOUS N
		PREPARE LOOSE BED FOUR (4) INCHES DEEP. APPLY FERTILIZER AT RATE OF TWENTY (20) POUNDS PER ONE THOUSAND (1000) SQUARE FEET. APPLICATION SHALL BE UNIFORM, UTILIZING APPROVED MECHANICAL SPREADERS. MIX FERTILIZER THOROUGHLY WITH THE SOIL TO A DEPTH OF THREE (3) INCHES. HAND RAKE UNTIL ALL BUMPS AND DEPRESSIONS ARE	Ι.	LANDSCAPE INSPECTIONS SHALL OCCUR AFTER STRONG NATURE.
NSPLANTED. TO FACILITATE MACHINERY	iv.	REMOVED. SOIL WATERING:	8. j.	CERTIFICATES: GRASS SPECIES, AND LOCATION OF NURSERY FROM WHIC
	b.	WATER SOD AND SOIL TO DEPTH OF 6" WITHIN FOUR HOURS AFTER ROLLING. KEEP SOD MOIST DURING FIRST WEEK AFTER PLANTING. AFTER FIRST WEEK, SUPPLEMENT RAINFALL TO PRODUCE A TOTAL OF 2" PER DAY.	iii.	COMPLIANCE WITH STATE AND FEDERAL QUARANTINE RE MANUFACTURER'S CERTIFICATE OF FERTILIZER AND HERI CERTIFICATES FROM SUPPLIERS STATING THAT THE DELI
O RELOCATION LANT MATERIAL TO BE		IT IS THE CONTRACTOR'S RESPONSIBILITY TO WATER ALL PLANT MATERIAL.		WITH REQUIREMENTS SPECIFIED. CERTIFICATES OF INSPECTIONS: SHIPMENTS OR ORDERS
ξ	5. i.	TREES: TREES AND PALMS SHALL BE FRESHLY DUG, BALLED AND BURLAPPED. ALL PLANT MATERIAL SHALL BE FREE OF BROKEN OR DAMAGED	0	SITE BY AUTHORIZED FEDERAL AND STATE AUTHORITIES;
GULAR PATTERN. ING. ONLY DEAD, DISEASED	ij.	ROOT BALLS, OR ROOT BOUND CONDITIONS. PLANT MATERIALS SHALL BE SOUND, HEALTHY, VIGOROUS, FREE FROM PLANT DISEASE, INSECT PESTS OR THEIR EGGS, AND SHALL HAVE HEALTHY, NORMAL ROOT SYSTEMS. TREES ARE NOTED ON PLANS AND HEREIN AS APPROVED BY THE LANDSCAPE ARCHITECT.	94	GENERAL SUBMITTALS: A. SHOP DRAWINGS, PRODUCT DATA, MOCK-UPS, OR SAMP FENCE/GATES - SAMPLE, 2' LENGTH WITH ALL MEMBERS A
	iii.	LANDSCAPE ARCHITECT SHALL TAG ALL TREES. TAGS SHALL NOT BE REMOVED. ABSENCE OF TAG AT DELIVERY TO PROJECT SITE WILL BE GROUNDS FOR REJECTION OF THE TREE	ii. iii.	ELECTRICAL FIXTURES - PRODUCT DATA, AND FOUNDATIC FURNITURE - PRODUCT DATA
RADE.		SUBSTITUTIONS IN PLANT SPECIES OR SIZES SHALL BE MADE ONLY AFTER WRITTEN AUTHORIZATION BY THE LANDSCAPE ARCHITECT. THE HEIGHT AND OR WIDTH OF TREES SHALL BE MEASURED FROM THE TOP OF THE ROOT BALL TO THE TOP OF CANOPY. THIS MEASUREMENT SHALL NOT INCLUDE THE IMMEDIATE TERMINAL GROWTH.	٧.	LANDSCAPE MATERIALS - SAMPLES PER DOCUMENTS HEF GEOTEXTILE MATERIALS - SAMPLE AND PRODUCT DATA LANDSCAPE IRRIGATION DATA - SHOP DRAWINGS AND PR
		PLANTS LARGER IN SIZE THAN THOSE SPECIFIED IN THE PLANT LIST MAY BE USED IF APPROVED BY THE OWNER AND/OR LANDSCAPE ARCHITECT.	vii.	ROOT BARRIERS - PRODUCT DATA .CONCRETE MIX AND COLORS - DESIGN MIX SAMPLE AND F
		. IF THE USE OF LARGER PLANTS IS APPROVED, THE BALL OF EARTH OR SPREAD OF ROOTS SHALL BE INCREASED IN PROPORTION TO THE SIZE OF THE PLANT. I. PLANTS SHALL BE SUBJECT TO INSPECTION AND APPROVAL AT THE PLACE OF GROWTH, OR UPON DELIVERY TO THE SITE, AS DETERMINED	iv	SLAB AND DO NOT DESTROY OR REMOVE FROM THE JOB AND LANDSCAPE ARCHITECT. STORM DRAINAGE MATERIALS - PRODUCT DATA
	VII	BY THE OWNER AND/OR LANDSCAPE ARCHITECT, FOR QUALITY, SIZE, AND VARIETY; SUCH APPROVAL SHALL NOT IMPAIR THE RIGHT OF INSPECTION AND REJECTION AT THE SITE DURING PROGRESS OF THE WORK OR AFTER COMPLETION FOR SIZE AND CONDITION OF BALLS	х.	CAULKS AND SEALANTS - PRODUCT DATA STAIN AND PAINT - SAMPLE
QUIPMENT INFORMATION.		OR ROOTS, LATENT DEFECTS OR INJURIES. REJECTED PLANTS SHALL BE REMOVED IMMEDIATELY FROM THE SITE. NOTICE REQUESTING INSPECTION SHALL BE SUBMITTED IN WRITING AT LEAST ONE (1) WEEK PRIOR TO ANTICIPATED DATE.	xiii	STEEL EDGING - PRODUCT DATA .FERTILIZER - PRODUCT DATA
ACT AND UNTIL FINAL	IX.	CALIPER MEASUREMENT (DBH, 54" ABOVE CROWN OF ROOT BALL), HEIGHT AND SPREAD MEASUREMENTS, ROOT BALL DIMENSIONS, AND CONTAINER SIZE WHEN APPLICABLE, SHALL CONFORM TO THE APPLICABLE STANDARDS ESTABLISHED WITHIN REFERENCE DOCUMENTS CITED HEREIN, AND THE REQUIREMENTS FOR THIS PROJECT.	XV.	.ROOT STIMULATORS - PRODUCT DATA FILL MATERIAL FOR ROUGH AND FINE GRADING - PRODUC .TREE BRACING DETAILS - SHOP DRAWINGS
GENTS.	iy.	NURSERY SUPPORT POLES SHALL BE REMOVED AT THE NURSERY PRIOR TO DELIVERY. TREES DELIVERED WITH NURSERY SUPPORT POLES WILL NOT BE ACCEPTED AND THEREFORE REJECTED WITH THE EXCEPTION OF <i>Clusia rosea</i> AND <i>Conocarpus erectus</i> var. <i>sericeus</i> TREE	xvi xvi	i.IPE DECK FASTENERS AND HARDWARE, IPE PRODUCTS - \$ ii. SAND STABILIZER - PRODUCT DATA
MATERIAL THAT IS HARMFUL	3	SPECIES. EXECUTION		SOIL MIXTURE DOCUMENTATION AND CERTIFICATION IDER AND RECOMMENDATIONS OF SOIL AMENDMENTS FOR PRONURSERY CERTIFICATION FOR ALL PLANT MATERIALS.
ON UNTIL THE TREE HAS BEEN	i.	6A. INSPECTION: IN THE EVENT OF DISCREPANCY, IMMEDIATELY NOTIFY LANDSCAPE ARCHITECT IN WRITING.	9E	3. ALL MOCK UPS, SAMPLES, AND SHOP DRAWINGS SHALL E
OBSERVATION SHALL BE	ii.	DO NOT PROCEED WITH INSTALLATION OF MATERIALS OR PLANTS IN AREAS OF DISCREPANCY UNTIL ALL SUCH DISCREPANCIES HAVE BEEN FULLY RESOLVED TO THE SATISFACTION OF THE OWNER AND/OR LANDSCAPE ARCHITECT. 6B. PREPARATION:	10. i.	FENCING: 10A. SUBMITTALS: SHOP DRAWINGS: SUBMIT FOR APPROVAL, COMPLETE SH
RANSPLANTING IN	i.	VERIFY LOCATIONS OF ALL UTILITIES, CONDUITS, SUPPLY LINES AND CABLES, INCLUDING BUT NOT LIMITED TO: ELECTRICAL, GAS (LINES AND TANKS), WATER, SANITARY SEWER, STORM WATER LINES, CABLE AND TELEPHONE. PROPERLY MAINTAIN AND PROTECT EXISTING	ii.	METHODS AND DEVICES SHOWING SIZES, EDGE DETAILS, MANUFACTURER'S LITERATURE: SUBMIT FOR APPROVAL F
/ING THE ENTIRE CANOPY		UTILITIES. STAKE OR MARK WITH PAINT THE PROPOSED LOCATION OF ALL TREES AND PALMS TO BE PLANTED. EXCAVATE PLANT BEDS.	iii.	HARDWARE, AND INSTALLATION DETAILS. SAMPLES: SUBMIT SAMPLE OF FENCING COMPONENT PAF ARCHITECT'S APPROVAL.
red. Er to promote root	iv.	EXCAVATE PLANT BEDS. ENSURE ALL PLANTING AREAS ARE FREELY DRAINING. PROVIDE PLANT MATERIALS, FERTILIZER, SOD, PLANTING MIX, AND INCIDENTAL MATERIALS AS SPECIFIED.	i.	10B. PRODUCTS: GATES, POSTS AND RAILS: AS PER DETAILS ON DRAWING
E AND MINIMIZE		SET PLANTS, BACKFILL, AND GUY OR BRACE PLANTS AS REQUIRED. . COMPLETE INCIDENTAL WORK RELATED TO PLANTING OPERATIONS, AND AS SPECIFIED.		STAINLESS STEEL HARDWARE, CONNECTORS, AND FASTE DECK SCREWS, STAINLESS STEEL 316, SQUARE DRIVE, HE
HEALTHY. USE SOIL NEEDLE	i.	6C. APPLICATION: FINISH SUB-GRADE: UPON ACCEPTANCE OF ROUGH GRADING ELEVATIONS, ESTABLISH FINE SUB-GRADE WITH SMOOTH AND EVEN FINISH. REMOVE ROCKS EXCEEDING ONE (1) INCH DIAMETER, STICKS, DEBRIS, DELETERIOUS MATERIAL, GRASS AND SOIL CLODS, AND VEGETATION		GATES: 316 STAINLESS STEEL BAR BEARING HINGES SIZE HARDWARE, INCLUDE STAINLESS STEEL CANE BOLT AS RI SAGGING.
	i.	6D. EXCAVATION: EXCAVATIONS IDENTIFIED AS HAVING POTENTIAL UTILITY OR SERVICE LINE CONFLICTS SHALL BE EXCAVATED WITH HAND TOOLS TO	11.	WOOD:
THOD.	ii.	DETERMINE THE LOCATION OF, AND AVOID DAMAGE TO, SUCH UTILITIES. EXCAVATE TREE AND PALM PLANTING PITS A MINIMUM OF 24" GREATER IN DIAMETER THAN THE ROOT BALL, AND MINIMUM OF 12" DEEPER THAN VERTICAL DEPTH OF THE ROOT BALL. TEST SOIL FOR QUALITY OF PERCOLATION. IF DRAINAGE IS INADEQUATE, CREATE		ALL WOOD SHALL BE CERTIFIED WOOD: FABRICATE WITH AN FSC-ACCREDITED CERTIFICATION BODY TO COMPLY W SEALANT FOR IPE WOOD SHALL BE MESSMERS WOOD SEA
TIPLE POINTS FOR WEIGHT		UNDERGROUND SEEPAGE/DRAINAGE. NOTIFY LANDSCAPE ARCHITECT FOR APPROVAL. BUDGET SHOULD ALLOCATE AN ALLOWANCE TO		STONE:
JPON ASSESSING		BARRICADE OR MARK EXCAVATIONS TO PREVENT HAZARDS TO MECHANICAL EQUIPMENT, VEHICLES, AND PEDESTRIANS. 6E. PLANTING:	i.	ALL MATERIALS SHALL BE FREE FROM DAMAGE, FROM EX OF ANY KIND SUCH AS BUT NOT LIMITED TO CRACKING, W
DEPTH. S.		SET TREES IN VERTICAL POSITION WITH THE TOP OF THE ROOT BALL FLUSH WITH THE ADJACENT, FINISH GRADE. AFTER SETTLEMENT, THE PLANT CROWN WILL STAND ONE (1) TO TWO (2) INCHES ABOVE GRADE. SET PLANT IN UPRIGHT POSITION IN CENTER OF PLANTING PIT AND PLACE SPECIFIED PLANTING MIX UNDER AND AROUND THE ROOT BALL.	ii.	MILDEW, ROT, OR ANY EXTERNAL SOURCE AT THE TIME O ALL STONE MATERIALS SHALL BE SEALED WITH MIRACLE INSTALLATION. STONE SHALL BE BRUSHED CLEAN PRIOR
		FOR BURLAPPED ROOT BALLS, CUT TOP 1/3 OF BURLAP AWAY FROM ROOT BALL, AND TURN DOWN INTO THE SIDE OF THE PLANTING PIT, BEFORE PLACING PLANTING MIX AROUND THE ROOT BALL.		100% DRY. ALL WORKMANSHIP SHALL BE PROTECTED IMMEDIATELY
EPTANCE		PROPER "JETTING IN" SHALL BE ASSURED TO ELIMINATE AIR POCKETS AROUND THE ROOTS. 'JET STICK' OR EQUAL IS RECOMMENDED. PRUNE TREES, REMOVING NO MORE THAN 1/3 OF TWIGS AND BRANCHES, WHILE MAINTAINING THE UNIFORM CHARACTER AND SHAPE OF THE TREE. REMOVE ALL DEAD, DISEASED, RUBBING, AND DYING BRANCHES. ALL PLANT MATERIAL SHALL MEET SPECIFICATIONS AFTER	IV.	IN POOL DECK CONDITIONS: MATERIAL SHALL COMPLY WI RESISTANT. MANUFACTURER/SUPPLIER TO CONFIRM THA CONFIRM WHETHER OR NOT MATERIAL CAN BE SUBMERG
GOROUS AND UNDAMAGED.	v.	PRUNING. EARTH SHALL BE BANKED AT EDGE OF EACH PLANTING PIT TO FORM A WATERING SAUCER APPROXIMATELY 6" IN DEPTH. FLUSH PLANTING		CONTRACTOR SHALL SUBMIT SHOP DRAWINGS OF LAYOU
PROVED BY THE LANDSCAPE	vi	SOIL INTO PLACE WITH SLOW HOSE STREAM UNTIL AIR POCKETS ARE ELIMINATED AROUND ROOT BALL, AND PIT IS FILLED WITH PLANTING MIX TO TOP OF ROOT BALL. PLACE MULCH IN LOOSE MEASURE 2" MIN. LAYER WITHIN EACH WATERING SAUCER.	13. i. ii	CRUSHED AGGREGATE FOR PERMEABLE INTERLOCKING AGGREGATES SHALL BE DUMPED, SPREAD AND COMPAC AVOID CONTAMINATION BY SOILS AND SEDIMENT.
UD UT UNE (1) TEAR FROM	vii	. IF PLANTING IS PERFORMED AFTER SOD PLACEMENT, PROPER PROTECTION SHALL BE PROVIDED AND DAMAGE RESULTING FROM PLANTING OPERATIONS SHALL BE REPAIRED PROMPTLY.	iv.	MATERIALS STORED OR INSTALLED ON SITE SHALL BE PL CONTRACTOR TO PROVIDE SILT FENCING AROUND INSTA
	vii	I. TREE GUYING: FOR MATERIALS TO 12' IN HEIGHT, A MINIMUM OF FOUR WOVEN ANCHOR STRAP LINES EACH AT NINETY DEGREES FROM AND CONNECTED TO TREE TRUNK AND ANCHORED BELOW GRADE WITH PRESSURE TREATED STAKES. SECURE TREE AGAINST MOVEMENT IN	v.	CONCRETE PAVERS SHALL BE INSTALLED IMMEDIATELY A

REE BRACING: FOR MATERIALS GREATER THAN 12' IN HEIGHT, A MINIMUM OF THREE 2X4 APPEARANCE GRADE BRACES, SET AT 60 EGREES TO THE GROUND PLANE, EQUIDISTANT AROUND THE TRUNK OF THE TREE, AND SECURED INTO THE GROUND PLANE WITH ONE, 12" 4 REBAR OR 1/2" GALVANIZED PIPE PASSING THROUGH EACH SUCH 2X4 BRACE, DRIVEN INTO THE GROUND, AND SET FLUSH WITH THE TOP OF THE BRACE. SECURE EACH ANGLED BRACE TO ONE 12" LONG 2X4 VERTICAL BLOCK OVER FOUR LAYERS OF BURLAP. SECURE BLOCKS WITH TWO METAL OR PLASTIC STRAPS, ONE 3" FROM THE TOP AND ONE 3" FROM THE BOTTOM OF EACH BLOCK. NAIL BRACE TO BLOCK WITH OUR 16D NAILS. SEE PLANTING DETAILS SHEET FOR ADDITIONAL INFORMATION AND BRACING DETAILS. BRACES TO BE PAINTED WITH ENJAMIN MOORE 2118-10 UNIVERSAL BLACK, FLAT/MATTE EXTERIOR. HERE WILL BE NO PLANT MATERIAL PLANTED INTO ROOT BALLS OF TREES AND PALMS.

HRUBS AND GROUND COVERS SHALL BE EVENLY SPACED IN ACCORDANCE WITH THE DRAWING AND AS INDICATED ON THE PLANT LIST. CULTIVATE ALL PLANTING AREAS TO A MINIMUM DEPTH OF 6", REMOVE AND DISPOSE OF ALL DEBRIS. TILL INTO TOP 4" THE PLANTING SOIL /IX AS SPECIFIED. THOROUGHLY WATER ALL PLANTS AFTER INSTALLATION. WATER AND IRRIGATION:

ONTRACTOR SHALL PROVIDE WATER FROM A LEGAL SOURCE. DAILY WATERING AND MONITORING SHALL BE PERFORMED DURING THE TERM OF THE CONSTRUCTION CONTRACT AND UNTIL FINAL

VATER SHALL BE FREE OF SUBSTANCES HARMFUL TO PLANT GROWTH, OBJECTIONABLE ODOR OR STAINING AGENTS. THE WATER SHALL BE CLEAN, FREE OF SOIL, DEBRIS, POISONS, PESTICIDES, CONTAMINANTS, AND ANY OTHER MATERIAL THAT IS HARMFUL OR INHIBITS VIGOROUS PLANT GROWTH ALL LANDSCAPED AREAS WITHIN LIMITS OF WORK SHALL BE IRRIGATED WITH AN AUTOMATIC IRRIGATION SYSTEM WHICH SHALL UTILIZE VELL AND/OR DOMESTIC WATER SUPPLY. IF DOMESTIC WATER IS USED, A BACKFLOW PREVENTER SHALL BE INSTALLED. RRIGATION SYSTEM SHALL PROVIDE 100% COVERAGE WITH MINIMUM 50% OVERLAP.

RIGATION SYSTEM SHALL BE EQUIPPED WITH A RAIN SENSOR. INSTALLATION OF IRRIGATION SYSTEMS SHALL CONFORM TO SPECIFICATIONS PROVIDED WITH IRRIGATION PLANS.

ONTRACTOR IS RESPONSIBLE FOR MAINTENANCE ON ALL LANDSCAPE MATERIALS, INCLUDING SOD, FOR NO LESS THAN NINETY (90) DAYS FTER ACCEPTANCE BY OWNER. FTER NINETY (90) DAYS, CONTRACTOR MUST VISIT THE SITE ONCE EVERY MONTH FOR TWELVE (12) MONTHS, AND SHALL PROVIDE THE WNER WITH A WRITTEN LETTER NOTIFYING THE OWNER OF ANY WRONG DOING, NEGLIGENCE, OR ISSUES THAT MIGHT AFFECT THE WNER'S WARRANTY. CONTRACTOR SHALL WARRANTY ALL LANDSCAPE MATERIAL FOR NO LESS THAN (12) MONTHS AFTER FINAL

WNER IS RESPONSIBLE TO ENSURE THAT LANDSCAPING REQUIRED TO BE PLANTED PURSUANT TO CITY OF MIAMI BEACH IS INSTALLED IN OMPLIANCE WITH THE LANDSCAPE REQUIREMENTS; MAINTAINED AS TO PRESENT A HEALTHY, VIGOROUS, AND NEAT APPEARANCE FREE ROM REFUSE AND DEBRIS; AND SUFFICIENTLY FERTILIZED AND WATERED TO MAINTAIN THE PLANT MATERIAL IN A HEALTHY CONDITION. ANY TREE OR PLANT DIES WHICH IS BEING USED TO SATISFY CURRENT LANDSCAPE CODE REQUIREMENTS, SUCH TREE OR PLANT SHALL E REPLACED WITH THE SAME LANDSCAPE MATERIAL OR AN APPROVED SUBSTITUTE MEETING CODE REQUIREMENTS. REES SHALL BE PRUNED IN THE FOLLOWING MATTER:

LL CUTS SHALL BE CLEAN, FLUSH, AND AT JUNCTIONS, LATERALS OR CROTCHES. ALL CUTS SHALL BE MADE AS CLOSE AS POSSIBLE TO HE TRUNK OR PARENT LIMB EMOVAL OF DEAD WOOD, CROSSING BRANCHES, WEAK OR INSIGNIFICANT BRANCHES, AND SUCKER SHALL BE ACCOMPLISHED

UTTING OF LATERAL BRANCHES THAT RESULTS IN THE REMOVAL OF MORE THAN ONE-THIRD (1/3) OF ALL BRANCHES ON ONE (1) SIDE OF A FREE SHALL ONLY BE ALLOWED IF REQUIRED FOR HAZARD REDUCTION OR CLEARANCE PRUNING. IFTING OF BRANCHES OR TREE THINNING SHALL BE DESIGNED TO DISTRIBUTE OVER HALF OF THE TREE MASS IN THE LOWER TWO-THIRDS 2/3) OF THE TREE.

O MORE THAN ONE-THIRD (1/3) OF A TREE'S LIVING CANOPY SHALL BE REMOVED WITHIN A ONE (1) YEAR PERIOD. REES SHALL BE PRUNED ACCORDING TO THE CURRENT ANSI A300 STANDARDS AND THE LANDSCAPE MANUAL. REES SHALL RECEIVE REGULAR MAINTENANCE FOR A MINIMUM OF ONE (1) YEAR FOLLOWING INSTALLATION.

CONTRACTED MAINTENANCE SERVICE SHALL BE RESPONSIBLE FOR FERTILIZATION AND PEST CONTROL HECK IRRIGATION HEADS AND LINES FOR BREAKS AND REGULAR FUNCTION, CHECK TIMER AND IRRIGATION SCHEDULE, ADJUST FOR EASONAL WATER USAGE. CHECK AND MAKE SURE THAT RAIN SENSOR IS WORKING AT ALL TIMES. HECK ALL DRAINS FOR PROPER DRAINAGE. ADDRESS CLOGS AND RESOLVE MAINTENANCE ISSUES.

BSERVE ALL PLANTS TO ENSURE THAT NO ABNORMAL YELLOWING OR DISFIGUREMENT OCCURS WHICH INDICATE NUTRIENT

EPLACE OR REPAIR BRACING AS NECESSARY. MAINTAIN UNTIL LANDSCAPE CONTRACTOR DEEMS APPROPRIATE FOR REMOVAL SO THAT REE HAS DEVELOPED A SUBSTANTIAL ROOT MASS AND HAS NATURAL STABILITY. DO NOT REMOVE DURING HURRICANE SEASON. FREES SHALL BE MAINTAINED IN A FIRM POSITION IN THE GROUND AND ALL STAKES AND GUYS SHALL BE CHECKED REGULARLY. PROVIDE MULCH OVER ROOTS TO DRIP LINE OF TREE IF APPLICABLE OR WITHIN TREE PLANTING RING/PLANTER BED. ADD FRESH MULCH AS ECESSARY PER NOTE HEREIN.

IAINTAIN ALL BEDS FREE OF DEBRIS AND DELETERIOUS MATERIAL. ANDSCAPE INSPECTIONS SHALL OCCUR AFTER STRONG WINDS, TROPICAL STORMS, HURRICANES, AND OTHER DISTURBANCES OF

RASS SPECIES, AND LOCATION OF NURSERY FROM WHICH SOD IS CUT. OMPLIANCE WITH STATE AND FEDERAL QUARANTINE RESTRICTIONS.

ANUFACTURER'S CERTIFICATE OF FERTILIZER AND HERBICIDE COMPOSITION. ERTIFICATES FROM SUPPLIERS STATING THAT THE DELIVERED PLANTING MIX, DELIVERED PLANT MATERIALS, AND FERTILIZER COMPLY

WITH REQUIREMENTS SPECIFIED. ERTIFICATES OF INSPECTIONS: SHIPMENTS OR ORDERS OF PLANT MATERIAL SHALL BE PROPERLY INSPECTED AT NURSERY OR GROWING SITE BY AUTHORIZED FEDERAL AND STATE AUTHORITIES; INCLUDE CERTIFICATES WITH SHIPMENT.

SHOP DRAWINGS, PRODUCT DATA, MOCK-UPS, OR SAMPLES FOR THE FOLLOWING: ENCE/GATES - SAMPLE, 2' LENGTH WITH ALL MEMBERS AND CONNECTIONS

LECTRICAL FIXTURES - PRODUCT DATA, AND FOUNDATION DETAILS (SHALL BE INCLUDED IN CONTRACTOR'S BID) URNITURE - PRODUCT DATA

ANDSCAPE MATERIALS - SAMPLES PER DOCUMENTS HEREIN GEOTEXTILE MATERIALS - SAMPLE AND PRODUCT DATA

ANDSCAPE IRRIGATION DATA - SHOP DRAWINGS AND PRODUCT DATA ROOT BARRIERS - PRODUCT DATA

CONCRETE MIX AND COLORS - DESIGN MIX SAMPLE AND PRODUCT SAMPLE. CREATE ON SITE A MOCK UP 6'X6' OF THE FINISHED CONCRETE LAB AND DO NOT DESTROY OR REMOVE FROM THE JOB SITE UNTIL COMPLETION OF ALL SLABS ON GRADE AND ACCEPTANCE BY OWNER ND LANDSCAPE ARCHITECT.

OOT STIMULATORS - PRODUCT DATA FILL MATERIAL FOR ROUGH AND FINE GRADING - PRODUCT DATA AND SAMPLE **FREE BRACING DETAILS - SHOP DRAWINGS** 

IPE DECK FASTENERS AND HARDWARE, IPE PRODUCTS - SAMPLE SAND STABILIZER - PRODUCT DATA

SOIL MIXTURE DOCUMENTATION AND CERTIFICATION IDENTIFYING THE JOB AND CONTRACTOR, INCLUDING TESTING OF PH, KEY NUTRIENTS, AND RECOMMENDATIONS OF SOIL AMENDMENTS FOR PROPOSED LANDSCAPE PLANTING URSERY CERTIFICATION FOR ALL PLANT MATERIALS.

ALL MOCK UPS, SAMPLES, AND SHOP DRAWINGS SHALL BE A PART OF THE ORIGINAL CONTRACT COST.

SHOP DRAWINGS: SUBMIT FOR APPROVAL, COMPLETE SHOP DRAWINGS SHOWING FENCING LAYOUT INCLUDING ALL ATTACHMENT METHODS AND DEVICES SHOWING SIZES, EDGE DETAILS, AND ATTACHMENT DETAILS. MANUFACTURER'S LITERATURE: SUBMIT FOR APPROVAL PROPERLY IDENTIFIED LITERATURE GIVING MATERIAL SPECIFICATIONS, GATE ARDWARE, AND INSTALLATION DETAILS. AMPLES: SUBMIT SAMPLE OF FENCING COMPONENT PARTS AND MANUFACTURER'S FENCING SPECIFICATION FOR LANDSCAPE RCHITECT'S APPROVAL.

GATES, POSTS AND RAILS: AS PER DETAILS ON DRAWING SHEETS. WORKING HARDWARE: AS PER DETAILS ON DRAWINGS. USE ALL 316 TAINLESS STEEL HARDWARE, CONNECTORS, AND FASTENERS. MINIMUM (2) SCREWS AT EACH IPE/WOOD CONNECTION IF APPLICABLE. #8 DECK SCREWS, STAINLESS STEEL 316, SQUARE DRIVE, HEAD #2 BY SIMPSON STRONG TIE OR APPROVED EQUAL. GATES: 316 STAINLESS STEEL BAR BEARING HINGES SIZE 4 ½" X 4 ½" MIN., MINIMUM (3) PER GATE. SELF CLOSING STAINLESS STEEL ARDWARE, INCLUDE STAINLESS STEEL CANE BOLT AS REQUIRED. BRACE GATES AS REQUIRED TO PREVENT DISTORTION AND/OR

ALL WOOD SHALL BE CERTIFIED WOOD: FABRICATE WITH COMPONENTS PRODUCED FROM WOOD OBTAINED FROM FORESTS CERTIFIED BY AN FSC-ACCREDITED CERTIFICATION BODY TO COMPLY WITH FSC STD-01-001, "FSC PRINCIPLES AND CRITERIA FOR FOREST STEWARDSHIP." SEALANT FOR IPE WOOD SHALL BE MESSMERS WOOD SEALER- NATURAL.

ALL MATERIALS SHALL BE FREE FROM DAMAGE, FROM EXTREMES OF TEMPERATURE AND HUMIDITY, PHYSICAL OR MECHANICAL BLEMISHES OF ANY KIND SUCH AS BUT NOT LIMITED TO CRACKING. WARPING. OR SPLITTING. AND FREE FROM STAINING DUE TO RUST. CORROSION. /ILDEW, ROT, OR ANY EXTERNAL SOURCE AT THE TIME OF INSTALLATION AND PRIOR TO FINAL ACCEPTANCE. ALL STONE MATERIALS SHALL BE SEALED WITH MIRACLE 511 IMPREGNATING SEALER PRIOR TO OR IMMEDIATELY FOLLOWING ISTALLATION. STONE SHALL BE BRUSHED CLEAN PRIOR TO APPLICATION OF SEALER; FREE OF DUST, DEBRIS, OR STAINS AND SHALL BE

LL WORKMANSHIP SHALL BE PROTECTED IMMEDIATELY UPON INSTALLATION. POOL DECK CONDITIONS: MATERIAL SHALL COMPLY WITH CODE REQUIREMENTS, BE PROPERLY INSTALLED, STABLE, FIRM AND SLIP ESISTANT. MANUFACTURER/SUPPLIER TO CONFIRM THAT MATERIAL IS SUITABLE FOR USE IN EXTERIOR POOL ENVIRONMENT AND SHALL ONFIRM WHETHER OR NOT MATERIAL CAN BE SUBMERGED IN WATER.

RUSHED AGGREGATE FOR PERMEABLE INTERLOCKING PAVING SYSTEMS. AGGREGATES SHALL BE DUMPED, SPREAD AND COMPACTED WHEN THEY ARRIVE AT THE SITE.

AVOID CONTAMINATION BY SOILS AND SEDIMENT. IATERIALS STORED OR INSTALLED ON SITE SHALL BE PLACED ON FILTER FABRIC AND COVERED BY FILTER FABRIC. CONTRACTOR TO PROVIDE SILT FENCING AROUND INSTALLATION SITE.

CONCRETE PAVERS SHALL BE INSTALLED IMMEDIATELY AFTER AGGREGATE BASE IS PLACED AND SPREAD.

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