LE JARDIN BOUCHERIE - 81 WASHINGTON 230 1ST STREET

FINAL SUBMITTAL:

MARCH 27, 2023

FILE NO.:


PB23-0577


SCOPE OF WORK:

RENOVATION AND REHABILITATION OF AN EXISTING HISTORIC BUILDING. NEW PROPOSED LANDSCAPE DESIGN.

LE JARDIN BOUCHERIE / OMAKASE 230 1ST STREET MIAMI BEACH 33139

CONSULTANT

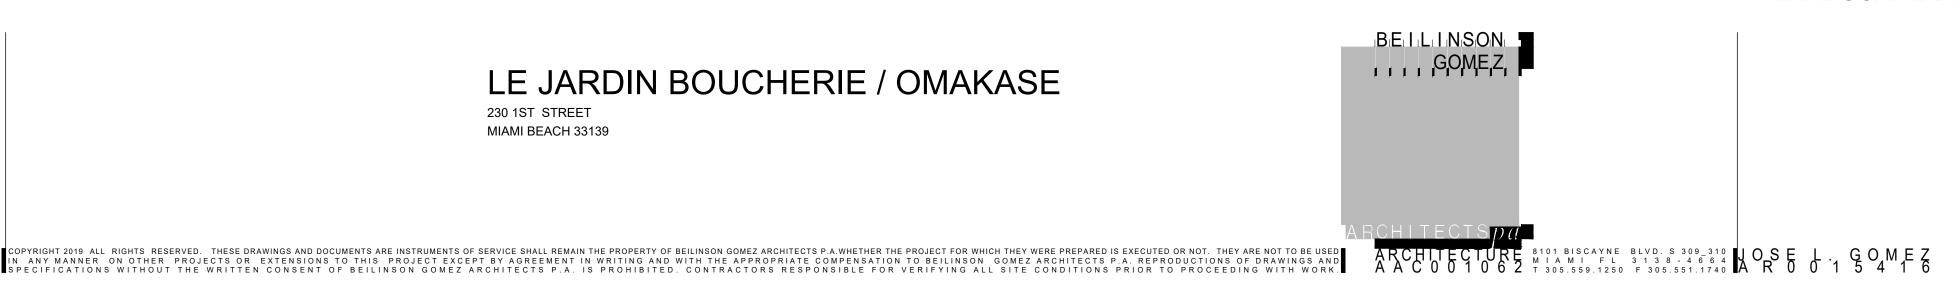

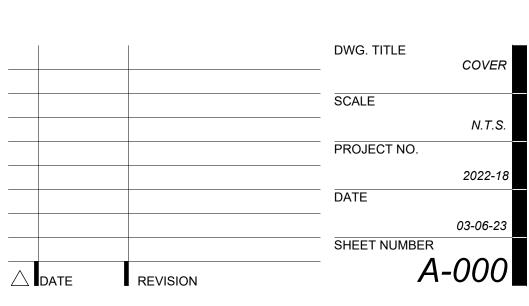

ABBREVIATIONS

GENERAL NOTES 1. ALL DIMENSIONS AND CONDITIONS ARE TO BE FIELD VERIFIED PRIOR TO CONSTRUCTION.

CONTRACTOR SHALL NOTIFY ARCHITECT OF ANY DISCREPANCIES PRIOR TO BID.

2. ALL WORK TO BE DONE IN COMPLIANCE WITH THE REQUIREMENTS OF AND ACCEPTABLE TO

THE CITY OF MIAMI BEACH BUILDING DEPARTMENT 3. ALL MATERIALS SHALL CONFORM WITH ALL PREVAILING CODES. MANUFACTURERS SHALL

PROVIDE DADE COUNTY APPROVAL CODES FOR ALL REQUIRED ASSEMBLIES. 4. CONTRACTOR SHALL GUARANTEE IN WRITING ALL MATERIAL AND WORKMANSHIP FOR A PERIOD OF ONE (1) YEAR FROM THE DATE OF FINAL ACCEPTANCE BY THE OWNER, UNLESS

OTHERWISE NOTED. CONTRACTOR SHALL AT HIS OWN COST REPAIR OR REPLACE ALL DAMAGED DURING REPAIR FOR THE PERIOD OF THE GUARANTEE. 5. COORDINATE ALL STRUCTURAL WORK WITH ARCHITECTURAL, MECHANICAL AND ELECTRICAL

DWG'S. FOR VERIFICATION OF LOCATIONS AND DIMENSIONS OF ALL PROJECT REQUIREMENTS.

6. SUBMIT MIN 5 SETS SHOP DWGS. FOR ARCHITECTS REVIEW OF ALL ITEM REQUIRING FABRICATION. DO NOT FABRICATE UNTIL REVIEWED.

7. ALL MATERIALS AND FIXTURES MUST BE BRAND NEW.

PROJECT TEAM

81 WASHINGTON LLC

N/A

8. INFORMATION SHOWN ON THE DWGS. AS TO THE LOCATION OF THE EXISTING UTILITIES HAS BEEN PREPARED FROM THE MOST RELIABLE DATA AVAILABLE TO THE A/E. HOWEVER, THIS INFORMATION IS NOT GUARANTEED. IT SHALL BE THE CONTRACTOR'S RESPONSIBILITY TO DETERMINE THE LOCATION, CHARACTER AND DEPTH OF EXISTING UTILITIES. THE CONTRACTOR SHALL ASSIST THE UTILITY COMPANIES, BY EVERY MEANS POSSIBLE, TO DETERMINE SAID LOCATIONS AND THE LOCATIONS OF RECENT ADDITIONS OR MODIFICATIONS TO THE SYSTEMS NOT SHOWN. EXTREME CAUTION SHALL BE EXERCISED BY THE CONTRACTOR TO ELIMINATE ANY POSSIBILITY OF ANY DAMAGE TO UTILITIES DURING CONSTRUCTION. THE LOCATION OF ALL UTILITIES SHALL BE VERIFIED AND THE PROJECT REPRESENTATIVE NOTIFIED OF ANY CONFLICT OR DISCREPANCIES WHICH MAY OCCUR. THE CONTRACTOR SHALL BE RESPONSIBLE FOR APPLICABLE CODES OR DISCREPANCIES WHICH MAY OCCUR. THE CONTRACTOR SHALL BE RESPONSIBLE FOR DETERMINING WHICH CONDITIONS WILL NEED SHORING DURING EXCAVATION AND SHALL PROVIDE SUCH SHORING AND SUPPORT AS REQUIRED.

9. CONTRACTOR TO NOTIFY ALL UTILITY COMPANIES AT LEAST 48 HOURS PRIOR TO

A-001 10. ALL ELEVATIONS REFER TO THE NATIONAL GEODETIC VERTICAL DATUM (N.G.V.D.) OF 1929.

11. EXISTING PAVEMENT, SIDEWALKS, SOD, CURB OR OTHER EXISTING WORK NOT SPECIFIED FOR REMOVAL WHICH IS TEMPORARILY REMOVED, DAMAGED, EXPOSED, OR IN ANY WAY DISTURBED DURING CONSTRUCTION PERFORMED UNDER THIS CONTRACT SHALL BE REPAIRED { A-005 TO ORIGINAL PRE-CONSTRUCTION CONDITION AT NO ADDITIONAL COST TO OWNER.

12. ALL PAVING, SIDEWALK AND CURB & GUTTER WORK IN THE PUBLIC RIGHT OF WAY SHALL CONFORM WITH THE REQUIREMENTS OF THE CITY OF MIAMI BEACH, FLORIDA AND/OR THE FLORIDA DEPARTMENT OF TRANSPORTATION.

3. ALL UTILITY CONSTRUCTION AND CONNECTIONS WITHIN THE PUBLIC RIGHT OF WAY ARE TO

14. ALL EXISTING UTILITIES ARE TO REMAIN UNLESS OTHERWISE NOTED.

BE PERFORMED BY THE CITY OF MIAMI BEACH WATER AND SEWER DEPARTMENT.

15. THIRD PARTY BENEFICIARIES: NOTHING CONTAINED IN THESE DRAWINGS SHALL CREATE A CONTRACTUAL RELATIONSHIP WITH OR A CAUSE OF ACTION IN FAVOR OF A THIRD PARTY AGAINST EITHER THE CLIENT OR THE DESIGN PROFESSIONAL. THE DESIGN PROFESSIONAL'S SERVICES UNDER WHICH THESE DRAWINGS WERE PREPARED, ARE BEING PERFORMED SOLELY FOR THE CLIENT'S BENEFIT, AND NO OTHER ENTITY SHALL HAVE ANY CLAIM AGAINST THE DESIGN PROFESSIONAL BECAUSE OF THESE DRAWINGS OR THE PERFORMANCE OR NONPERFORMANCE OF SERVICES HEREUNDER.

16. DO NOT SCALE DRAWINGS. WRITTEN DIMENSIONS TAKE PRECEDENCE OVER DRAWING

17. CONTRACTOR AND EACH SUBCONTRACTOR SHALL BE RESPONSIBLE FOR HAVING COMPLETE KNOWLEDGE OF ALL CONSTRUCTION DOCUMENTS AND THE RELEVANCE TO THE WORK FAILURE TO BE ACQUAINTED WITH THIS KNOWLEDGE DOES NOT RELIEVE RESPONSIBILITY FOR PERFORMING ALL WORK PROPERLY, ADDITIONAL COMPENSATION SHALL NOT BE ALLOWED DUE TO THE FAILURE TO BECOME FAMILIAR WITH THE ENTIRE CONSTRUCTION DOCUMENT PACKAGE.

18. FIRE SPRINKLER SYSTEM AND FIRE ALARM SYSTEM (IF REQUIRED) ARE DESIGN BUILD BY THE CONTRACTOR. CONTRACTOR SHALL SUBMIT FIRE SPRINKLER & FIRE ALARM DRAWINGS TO THE JURISDICTION (AND LANDLORD AS REQUIRED) AND OBTAIN APPROVAL PRIOR TO BEGINNING ANY WORK ON THE FIRE SPRINKLER OR ALARM SYSTEM. THE FIRE SPRINKLER AND ALARM WORK SHALL BE PERFORMED UNDER A SEPARATE PERMIT WHERE APPLICABLE.

19. COORDINATE ALL ROOF PENETRATIONS WITH MEP DWGS. ROOFING UNDER SEPARATE

20. CONTRACTOR SHALL INSPECT ALL EXISTING FIRE PROOFING OF STRUCTURAL ELEMENTS, DEMISING WALLS, AND FLOOR CEILING ASSEMBLIES WHICH ARE REQUIRED TO BE FIRE PROTECTED BY GOVERNING CODES, CONTRACTOR SHALL PATCH AND REPAIR ALL DAMAGED FIREPROOFING. CONTRACTOR SHALL MAINTAIN THE EXISTING FIRE RATINGS OF ALL ELEMENTS AND SHALL PATCH AND REPAIR ANY DAMAGED OR REMOVED ELEMENTS AS REQUIRED TO MAINTAIN ALL FIRE RATINGS.

21. OWNER HAS FILED FOR AND OBTAINED APPROVAL OF THE BUILDING PERMIT. CONTRACTOR SHALL BE RESPONSIBLE FOR COMPLETING ANY OUTSTANDING BUILDING PERMIT ITEMS AND PICKING UP THE PERMIT.

CONTRACTOR SHALL BE RESPONSIBLE FOR APPLYING FOR AND OBTAINING ALL TRADE PERMITS AND OTHER PERMITS AS MAY REQUIRED BY THE JURISDICTIONS HAVING AUTHORITY

OVER THE PROJECT CONTRACTOR SHALL BE RESPONSIBLE FOR SUBMITTING ANY REVISIONS TO THE APPROVED PERMIT DOCUMENTS AND PROCESSING THE APPROVAL OF THE REVISED DOCUMENTS WITH THE JURISDICTIONS HAVING AUTHORITY.

IN THE EVENT THE CONTRACTOR DISCOVERS, AT ANY TIME DURING DEMOLITION, CONSTRUCTION, AND/OR REMODELING OPERATIONS, EXISTING CONDITIONS THAT COULD INCLUDE THE PRESENCE OF MOLD AND/OR MILDEW THE CONTRACTOR SHALL IMMEDIATELY NOTIFY THE OWNER'S REPRESENTATIVE, CONSTRUCTION MANAGER, AND THE ARCHITECT OF RECORD, IN WRITING OF THE CONCERNS AND/OR SUSPICIONS.

25. ALL BUILDINGS SHALL HAVE A PRE-CONSTRUCTION TREATMENT PROTECTION AGAINST SUBTERRANEAN TERMITES AS PER FBC 1816.1.7. THE RULES AND LAWS AS ESTABLISHED BY THE FLORIDA DEPARTMENT OF AGRICULTURE AND CONSUMER SERVICES SHALL BE DEEMED AS APPROVED WITH RESPECT TO PRE-CONSTRUCTION SOIL TREATMENT FOR PROTECTION AGAINST SUBTERRANEAN TERMITES. A CERTIFICATE OF COMPLIANCE SHALL BE ISSUED TO THE BUILDING DEPARTMENT BY THE LICENSED PEST CONTROL COMPANY THAT CONTAINS THE FOLLOWING STATEMENT:

"THE BUILDING HAS RECEIVED A COMPLETE TREATMENT FOR THE PREVENTION OF SUBTERRANEAN TERMITES. TREATMENT IS IN ACCORDANCE WITH RULES AND LAWS ESTABLISHED BY THE FLORIDA DEPARTMENT OF AGRICULTURE AND CONSUMER SERVICES."

A WEATHER RESISTANT JOB SITE POSTING BOARD SHALL BE PROVIDED TO RECEIVE DUPLICATE TREATMENT CERTIFICATES AS EACH REQUIRED PROTECTIVE TREATMENT IS COMPLETED, PROVIDING A COPY FOR THE PERSON THE PERMIT IS ISSUED TO AND ANOTHER COPY FOR THE BUILDING PERMIT FILES. THE TREATMENT CERTIFICATE SHALL BE PROVIDE PRODUCT USED, IDENTIFY OF THE APPLICATOR, TIME AND DATE OF THE TREATMENT, SITE LOCATION, AREA TREATED, CHEMICAL USED, PERCENT CONCENTRATION AND NUMBER OF GALLONS USED TO ESTABLISH A VERIFIABLE RECORD OF PROTECTIVE TREATMENT. IF THE SOIL CHEMICAL BARRIER METHOD FOR TERMITE PREVENTION IS USED, FINAL EXTERIOR TREATMENT SHALL BE COMPLETED PRIOR TO FINAL BUILDING APPROVAL.

MINIMUM INSULATION SHALL BE: WINDOW U VALUE 1.04, SHGC 0.52; R-20 FOR ROOF, R-4.8 FOR EXTERIOR WALLS, R-10 FOR FLOOR, AS PER ENERGY CALCULATIONS & FBC-ENERGY

TOPOGRAPHIC AND BOUNDARY INFORMATION SHOWN ON PLANS ARE TAKEN FROM A SURVEY PREPARED BY DELTA MAPPING & SURVEYING, Inc. DATED 5-09-2022

ALL CEILING HEIGHT THROUGH OUT THE VENUE TO COMPLY WITH FFPC 7TH ED. SECT 30. ALL NEW STAIR, HANDRAILS & GUARDRAILS TO COMPLY WITH FFPC 7TH ED. SECT.7.2.2 TABLE 7.2.2.2.1.1 (a). ALL EXISTING STAIR STAIR, HANDRAILS & GUARDRAILS TO COMPLY WITH

FINAL SUBMITTAL:


MARCH 27, 2023

LE JARDIN BOUCHERIE / OMAKASE

SCALE: N.T.S.

MATERIAL LEGEND

MIAMI BEACH 33139

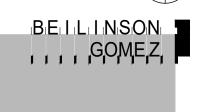

DWG. TITLE **PROJECT INFORMATION & INDEX** PROJECT NO 03-06-23 SHEET NUMBER 03-27-23 RESPONSE TO COMMENTS REVISION

DRAWING INDEX

PROJECT INFORMATION & INDEX

PROJECT SITE & EXISTING STRUCTURE

COMMERCIAL & FREIGHT LOADING ZONE SPACES \(\frac{1}{2}\)

SURVEY)
CONTEXT PHOTOGRAPHS

INTERIOR SPACE

EXIST-102

SP-101

A-103

ENLARGED ZONING DATA

EXISTING SECOND FLOOR

PROPOSED GROUND FLOOR PLAN

PROPOSED SECOND FLOOR PLAN

PROPOSED SITE PLAN

PROPOSED ROOF PLAN

ARCHITECTURAL

230 1ST STREET

CONSULTANT

PYRIGHT 2019 ALL RIGHTS RESERVED. THESE DRAWINGS AND DOCUMENTS ARE INSTRUMENTS OF SERVICE SHALL REMAIN THE PROPERTY OF BEILINSON GOMEZ ARCHITECTS P.A.WHETHER THE PROJECT FOR WHICH THEY WERE PREPARED IS EXECUTED OR NOT. THEY ARE NOT TO BE USED PARTIGIT 2019 ALL RIGHTS RESERVED. THESE DRAWINGS AND DOCUMENTS ARE INSTRUMENTS OF SERVICE STALL REMAIN THE PROPERTY OF BEILINSON GOMEZ ARCHITECTS P.A. WHEINSTAND AND AND AND AND AND AND AND FOR THE PROJECTS OR EXTENSIONS TO THIS PROJECT EXCEPT BY AGREEMENT IN WRITING AND WITH THE APPROPRIATE COMPENSATIONS WITHOUT THE WRITTEN CONSENT OF BEILINSON GOMEZ ARCHITECTS P.A. IS PROHIBITED. CONTRACTORS RESPONSIBLE FOR VERIFYING ALL SITE CONDITIONS PRIOR TO PROCEEDING WITH WORK.

FFPC 7TH ED. SECT.7.2.2 TABLE 7.2.2.2.1.1 (b)

LOCATION MAP





LEGAL DESCRIPTION


Lots 20 and 21, BLOCK 10, of OCEAN BEACH FLORIDA, according to the Plat thereof as recorded in Plat Book 2, at Page 38, of the Public Records of Miami-Dade County, Florida.

OWNER:

81 WASHINGTON LLC

SURVEYOR'S NOTES:


- 1. There may be additional restrictions that are not shown on this survey that may be found in the public records of this county.
- 2. Examination of abstract of title will have to be made to determine recorded instruments, if any, affecting property.
- 3. This certification is only for the lands as described, it is not a certification of title, zoning, easements, or freedom of encumbrances. Abstract not reviewed.
- 4. Location and identification of utilities, if any, are shown in accordance with recorded plat.
- 5. Ownership is subject to opinion of title.
- 6. Type of Survey: BOUNDARY SURVEY
- 7. The herein captioned property was surveyed and described based on the shown legal description: provided by client.
- 8. Survey map and report or the copies thereof are not valid and for reference only, unless signed and sealed with the original raised seal of a Florida licensed surveyor and mapper.
- This plan of survey has been prepared for the exclusive use of the entities named hereon. The certificate does not extend to any unnamed parties.
- 10.Underground utilities are not depicted hereon, contact the appropriate authority prior to any design work or construction on the property herein described. Surveyor shall be notified as to any deviation from utilities shown hereon.
- 11. The surveyor of record does not determine ownership of fences. measurements shown hereon depict physical location of fence.
- 12. Accuracy: The expected use of land as classified in the Minimum Technical Standards (5J-17 FAC), is "commercial". The minimum relative distance accuracy for the type of boundary survey is 1 foot in 10,000 feet. The accuracy obtained by measurement and calculation of a closed geometric figure was found to exceed this requirement.
- 13.In some instances, graphic representations have been exaggerated to more clearly illustrate relationships between physical improvements and/or lot lines. In all cases, dimensions shown shall control the location of the improvements over scaled positions.
- 14. No attempt has been made to locate any foundation beneath the surface of the ground.
- 15. Contact the appropriate authority prior to any design work on the herein described parcel for building and zoning information.
- 16. Additions or deletions to survey maps or reports by other than the signing party or parties is prohibited without written consent of the signing party or parties.
- 17.Bearings shown are assumed and are based on the Easterly right-of-way line of *Washington Avenue*, being *N 10°33'23" E*.

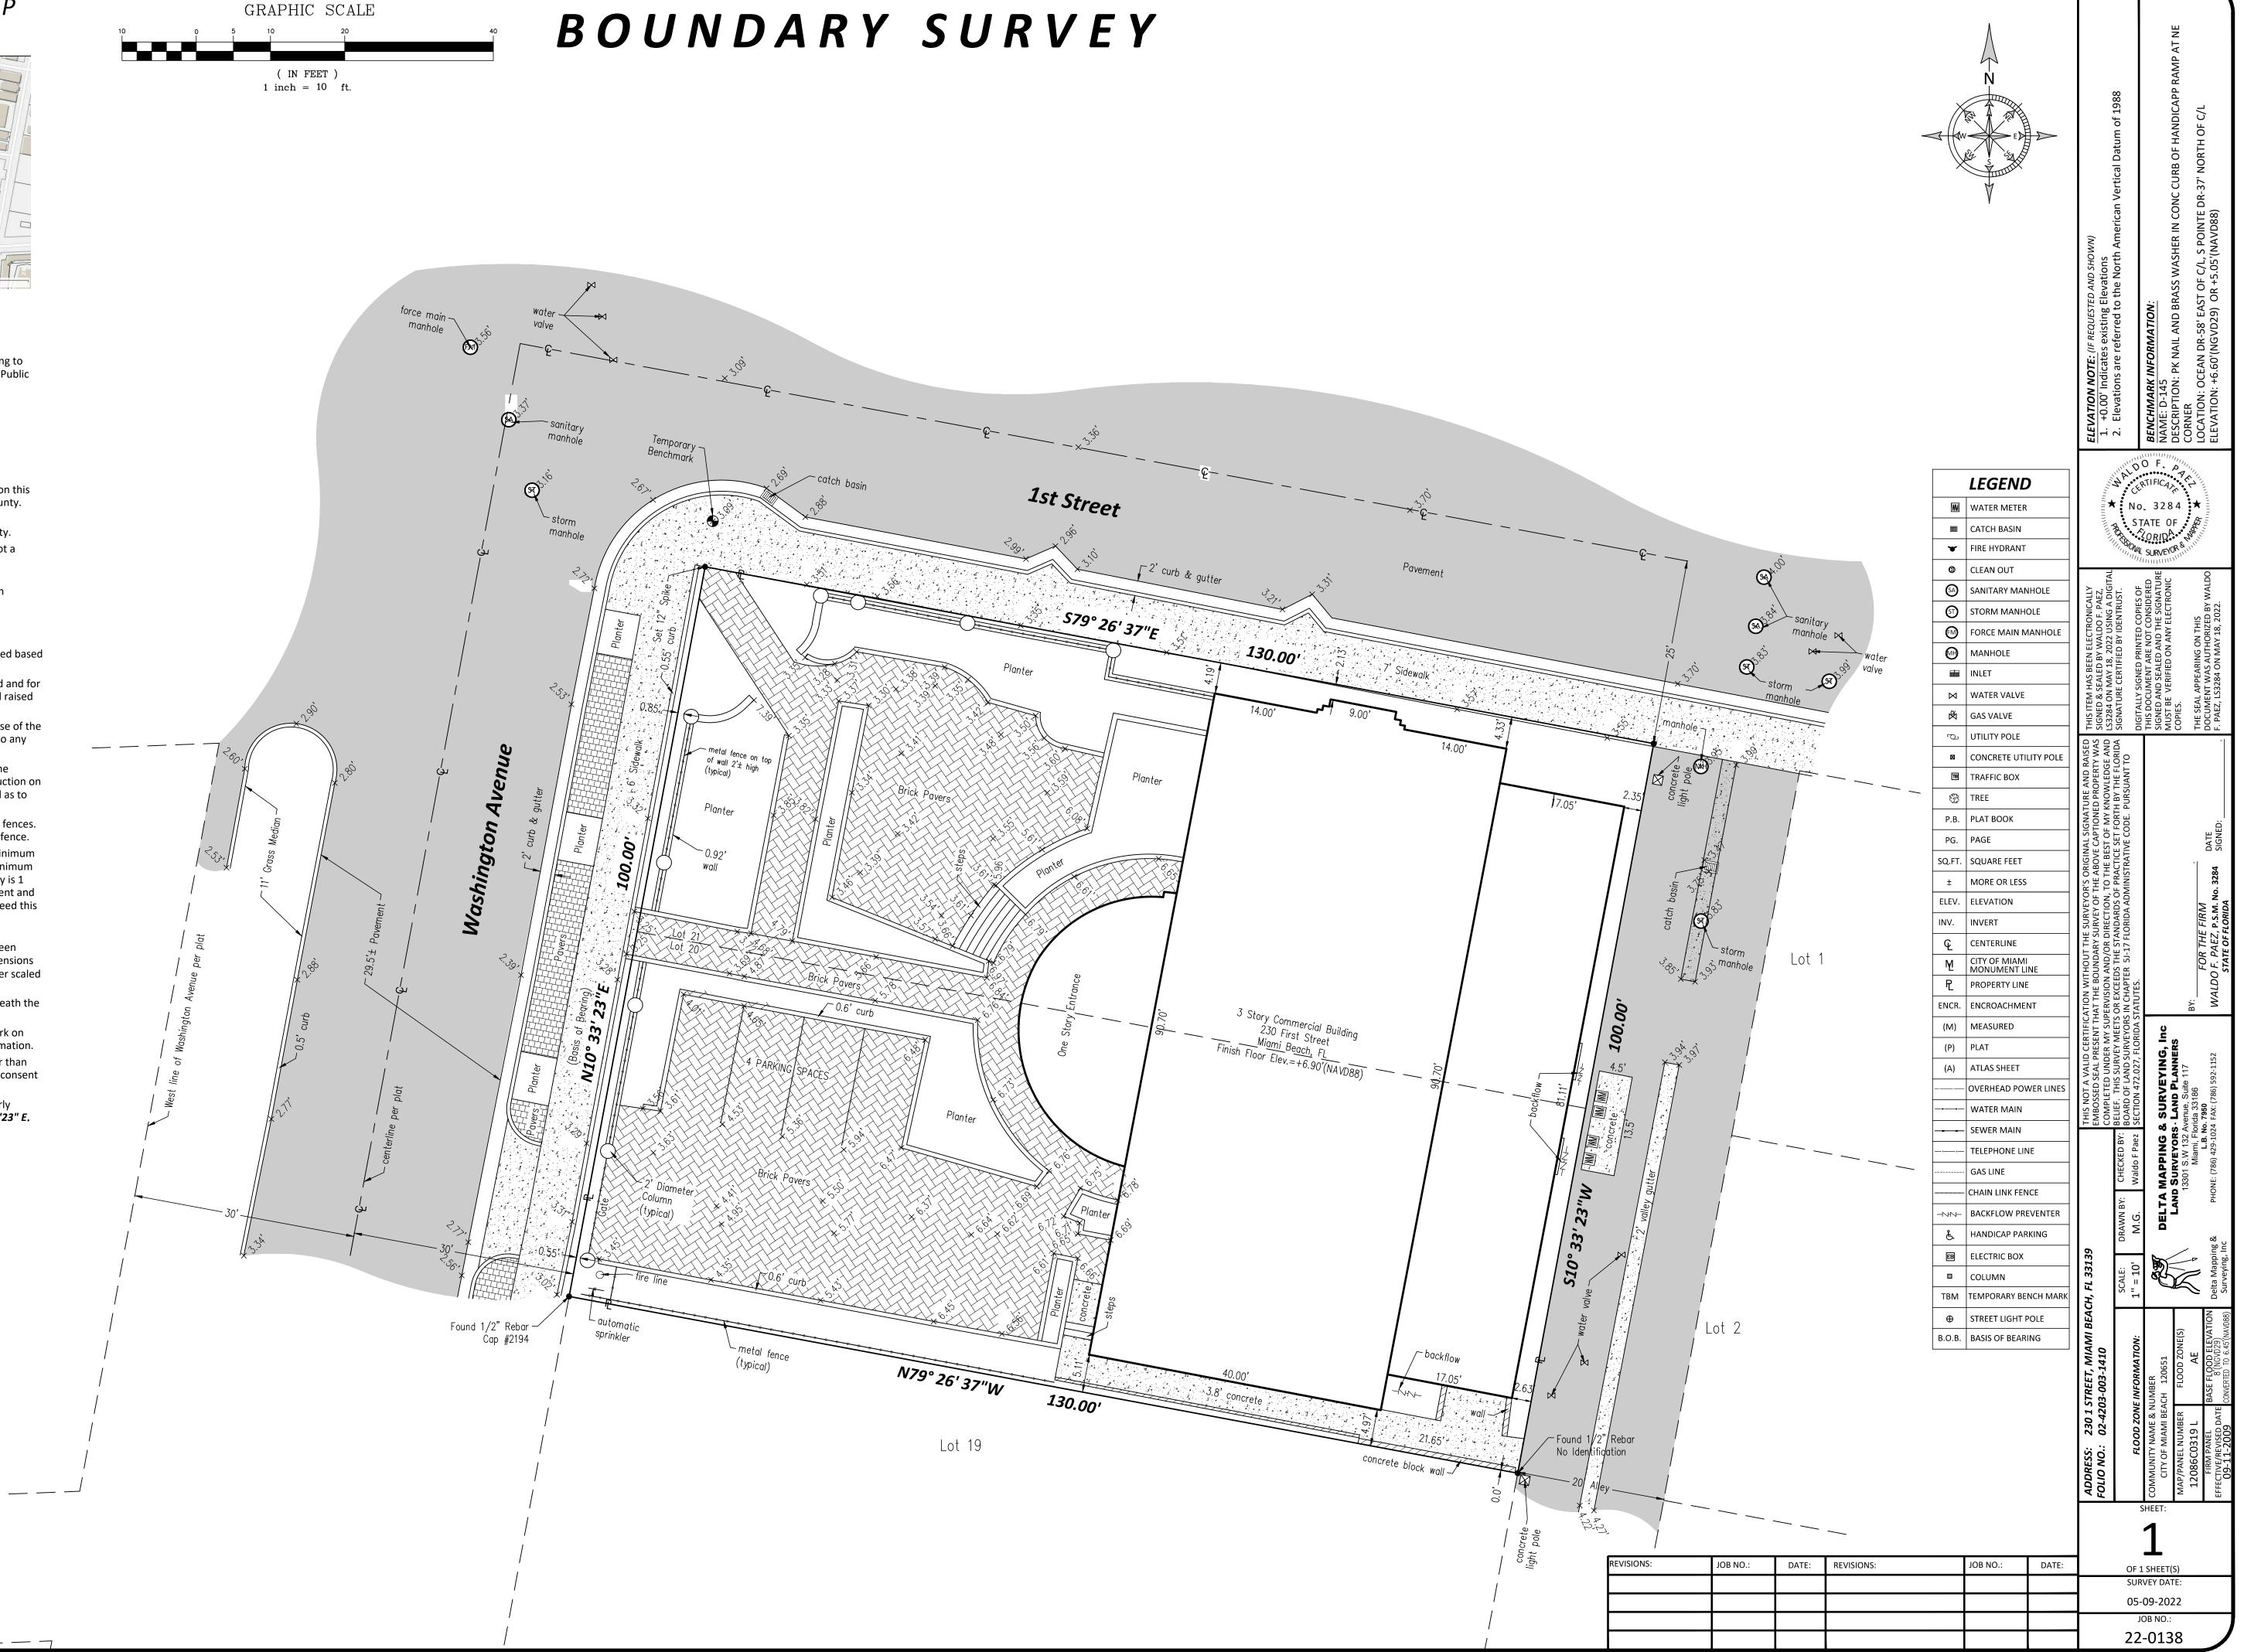








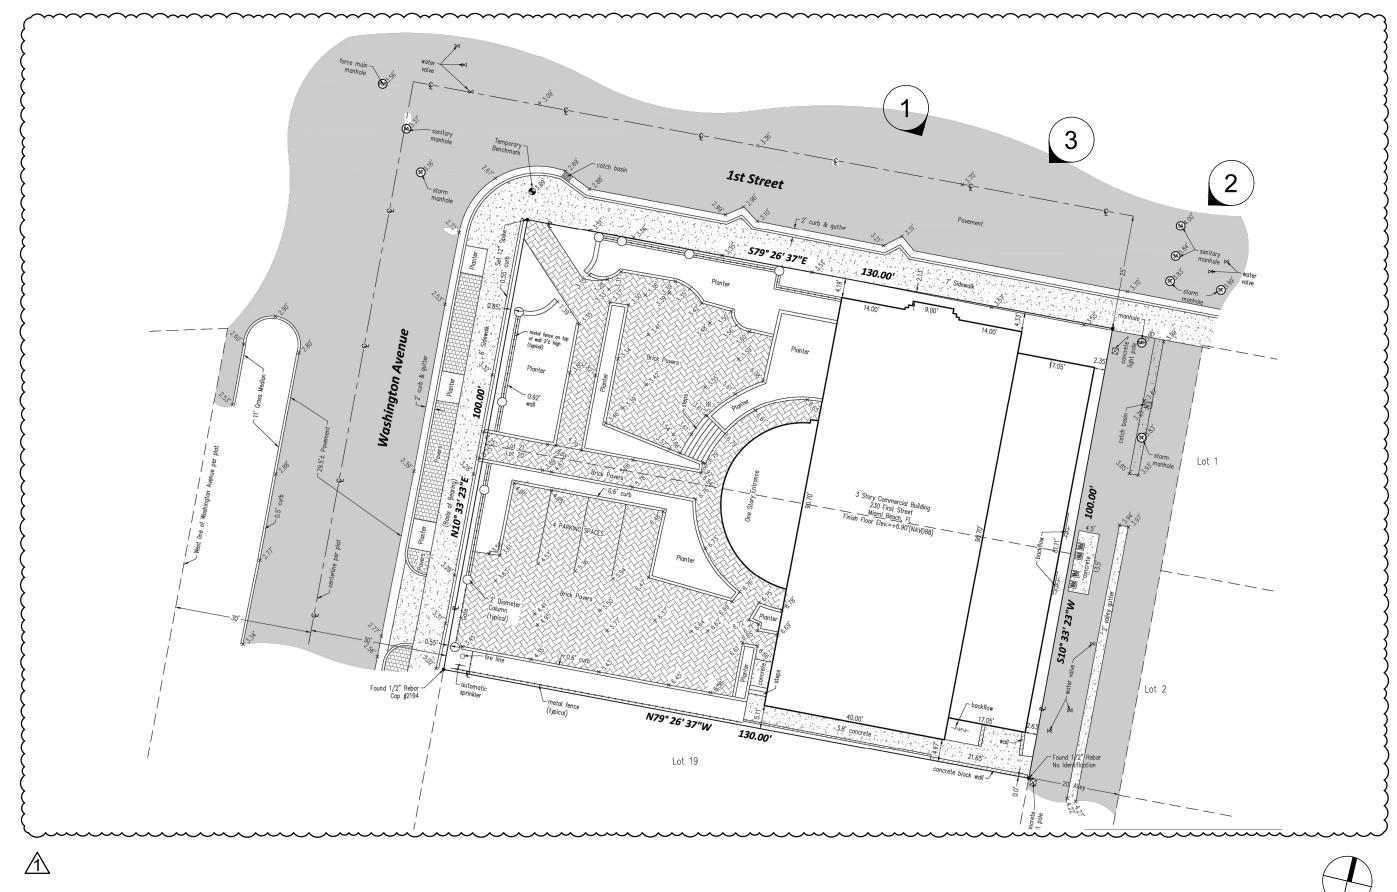


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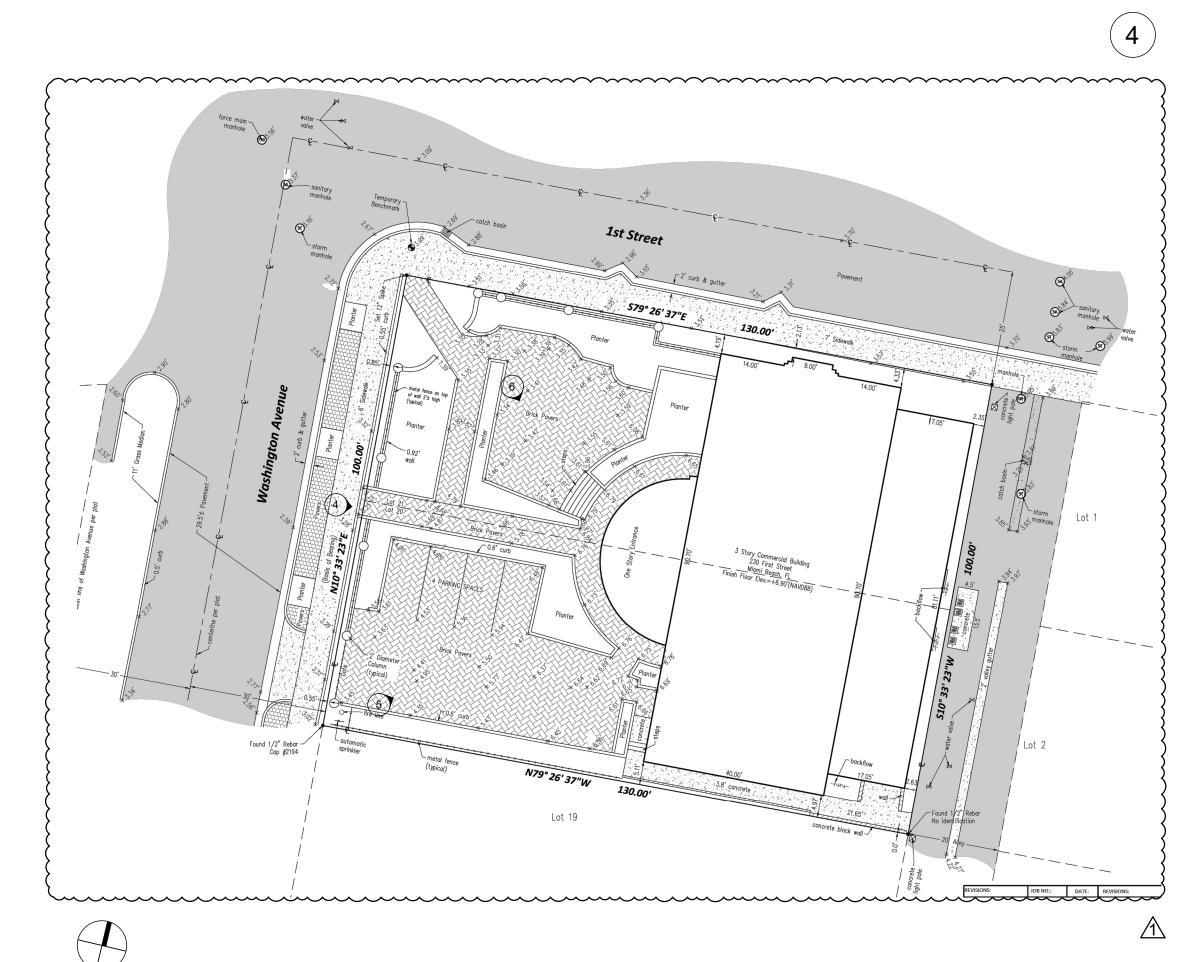
230 1ST STREET MIAMI BEACH 33139





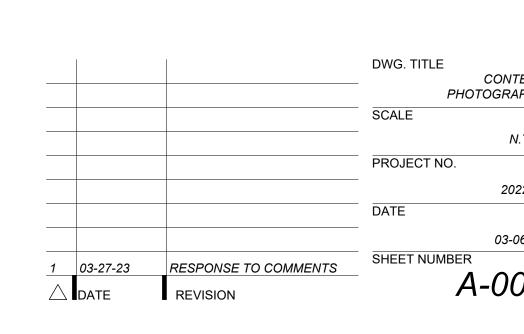

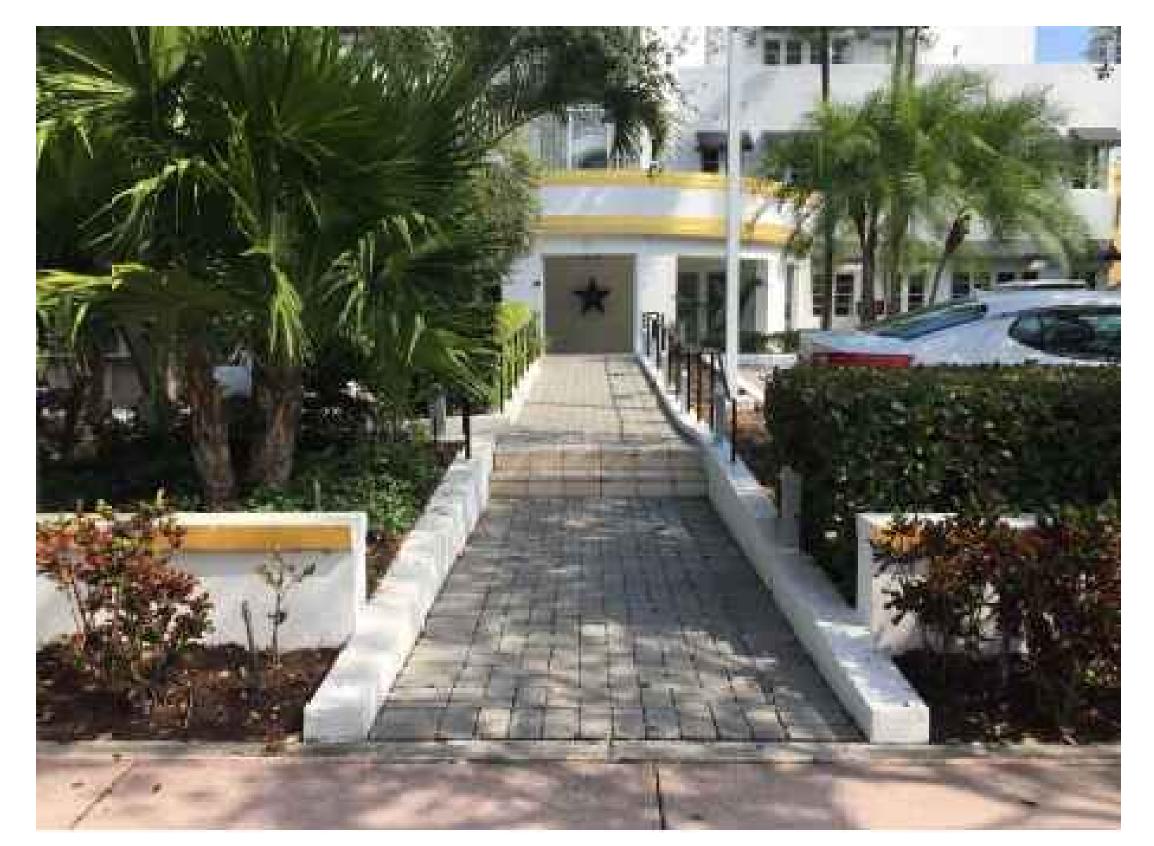






LE JARDIN BOUCHERIE / OMAKASE

230 1ST STREET MIAMI BEACH 33139

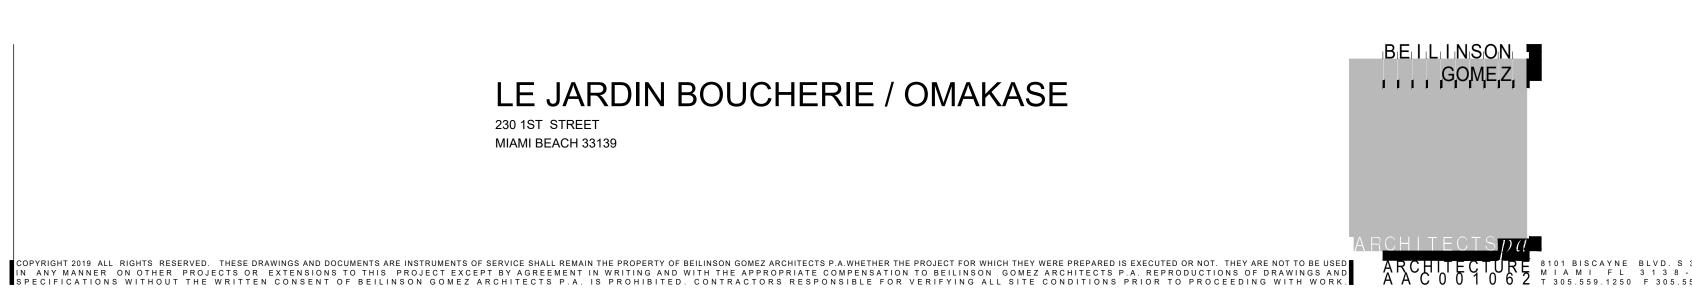

			DWG. TITLE PROJECT SITE & EXISTING STRUCTURE
			SCALE
			N.T.S.
			PROJECT NO.
			2022-18
			DATE
			03-06-23
1	03-27-23	RESPONSE TO COMMENTS	SHEET NUMBER
\triangle	DATE	REVISION	A-003









LE JARDIN BOUCHERIE / OMAKASE

230 1ST STREET MIAMI BEACH 33139



		DWG. TITLE INTERIOR SPACE
		SCALE
		N.T.S.
		PROJECT NO.
		2022-18
		DATE
		03-06-23
		SHEET NUMBER A-004
△ IDATE	REVISION	A-004

MULTIFAMILY - COMMERCIAL - ZONING DATA SHEET ITEM # | Zoning Information 230 1st STREET Address: Board and file numbers: 02-4203-003-1410 Folio number(s): C-PS1 1938 Zoning District: Year constructed: 8.00' 4.81' Grade value in NGVD: Base Flood Elevation: 6.41' 13,000.00 Adjusted grade (Flood+Grade/2): Lot Area (SF): 100.00 Lot Depth (FT): 130.00 Lot width (FT): Restaurant Existing use: Restaurant Proposed use: **Deficiencies** Maximum Existing **Proposed** 43'-5" 40'-0" 43'-5" Height: Number of Stories: 3.00 3.00 1.00 1.13 1.13 FAR: 13,000.00 14,652.00 14,652.00 Gross square footage: Setbacks Deficiencies Required Existing **Proposed** Pedestal: 52'-6" 0'-0" 52'-6" Front Setback: 5'-0" Side Setback: 0'-0'' 5'-0" Side Setback facing street: 0'-0" 2'-1" 2'-1" 2'-4" 2'-4" 5'-0" Rear Setback: **Parking** Required **Existing Deficiencies** Proposed N/A Historic Distric Total # of parking spaces:

	Restaurants, Cafes, Bars, Lounges, Nightclubs	Required	Existing	Proposed	Deficiencies		
18	Type of use:		Restaurant	Restaurant			
19	Total # of seats:		246	450			
20	Total # of seats per venue (Provide a separate chart for a breakdown calculation)			See Seating Capacity Table			
21	Total occupant load:			623			
22	Occupant load per venue (Provide a separate chart for a breakdown calculation)			See Total Occupancy Load Table			
 23	Is this a contributing building?			Yes			
24	Located within a Local Historic District?		Ocean Beach Historic Distric				

CONSULTANT

LE JARDIN BOUCHERIE / OMAKASE 230 1ST STREET

MIAMI BEACH 33139

SEATING CAPACITY PROPOSED


	INTERIOR	BAR	EXTERIOR	TOTAL
GROUND FLOOR PLAN	100	25	158	283
2ND FLOOR PLAN	161	6	0	167
3RD FLOOR PLAN	N/A	N/A	N/A	N/A
TOTAL SEATING:	261	31	158	450


TOTAL OCCUPANCY LOAD


TOTAL 413 210


N/A 623

GROUND FLOOR PLAN 2ND FLOOR PLAN 3RD FLOOR PLAN TOTAL LOAD OCCUPANCY:

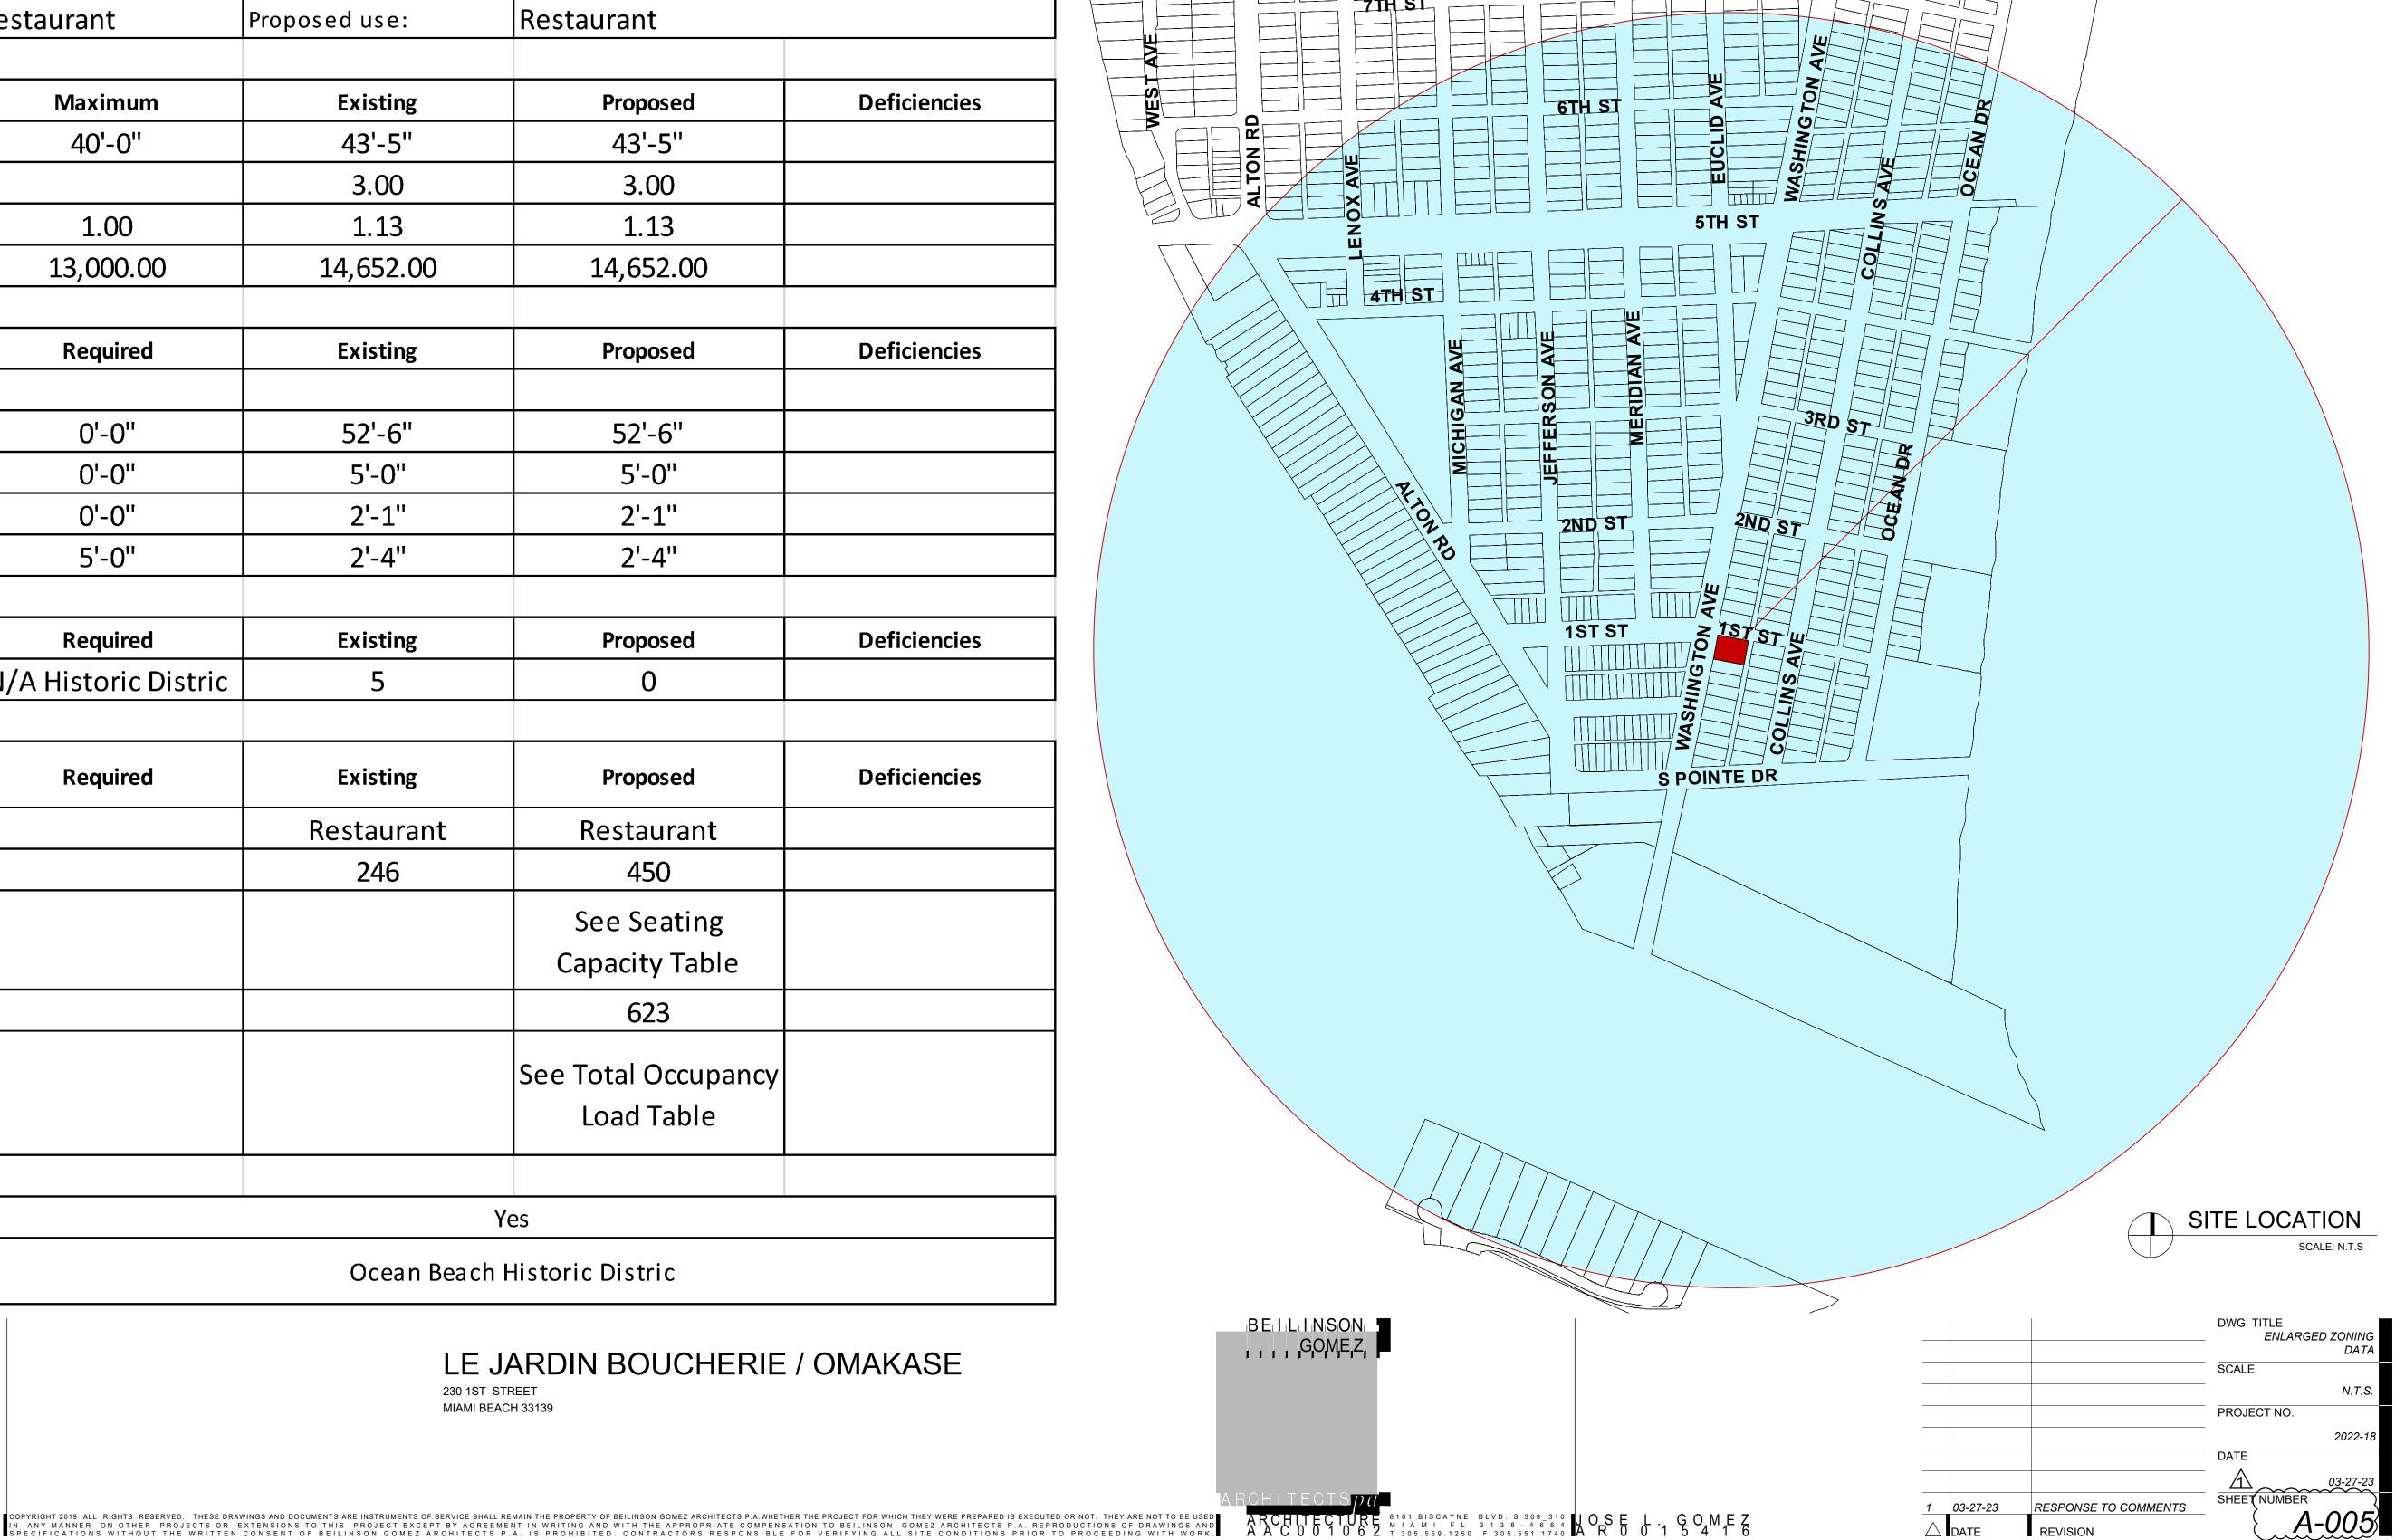


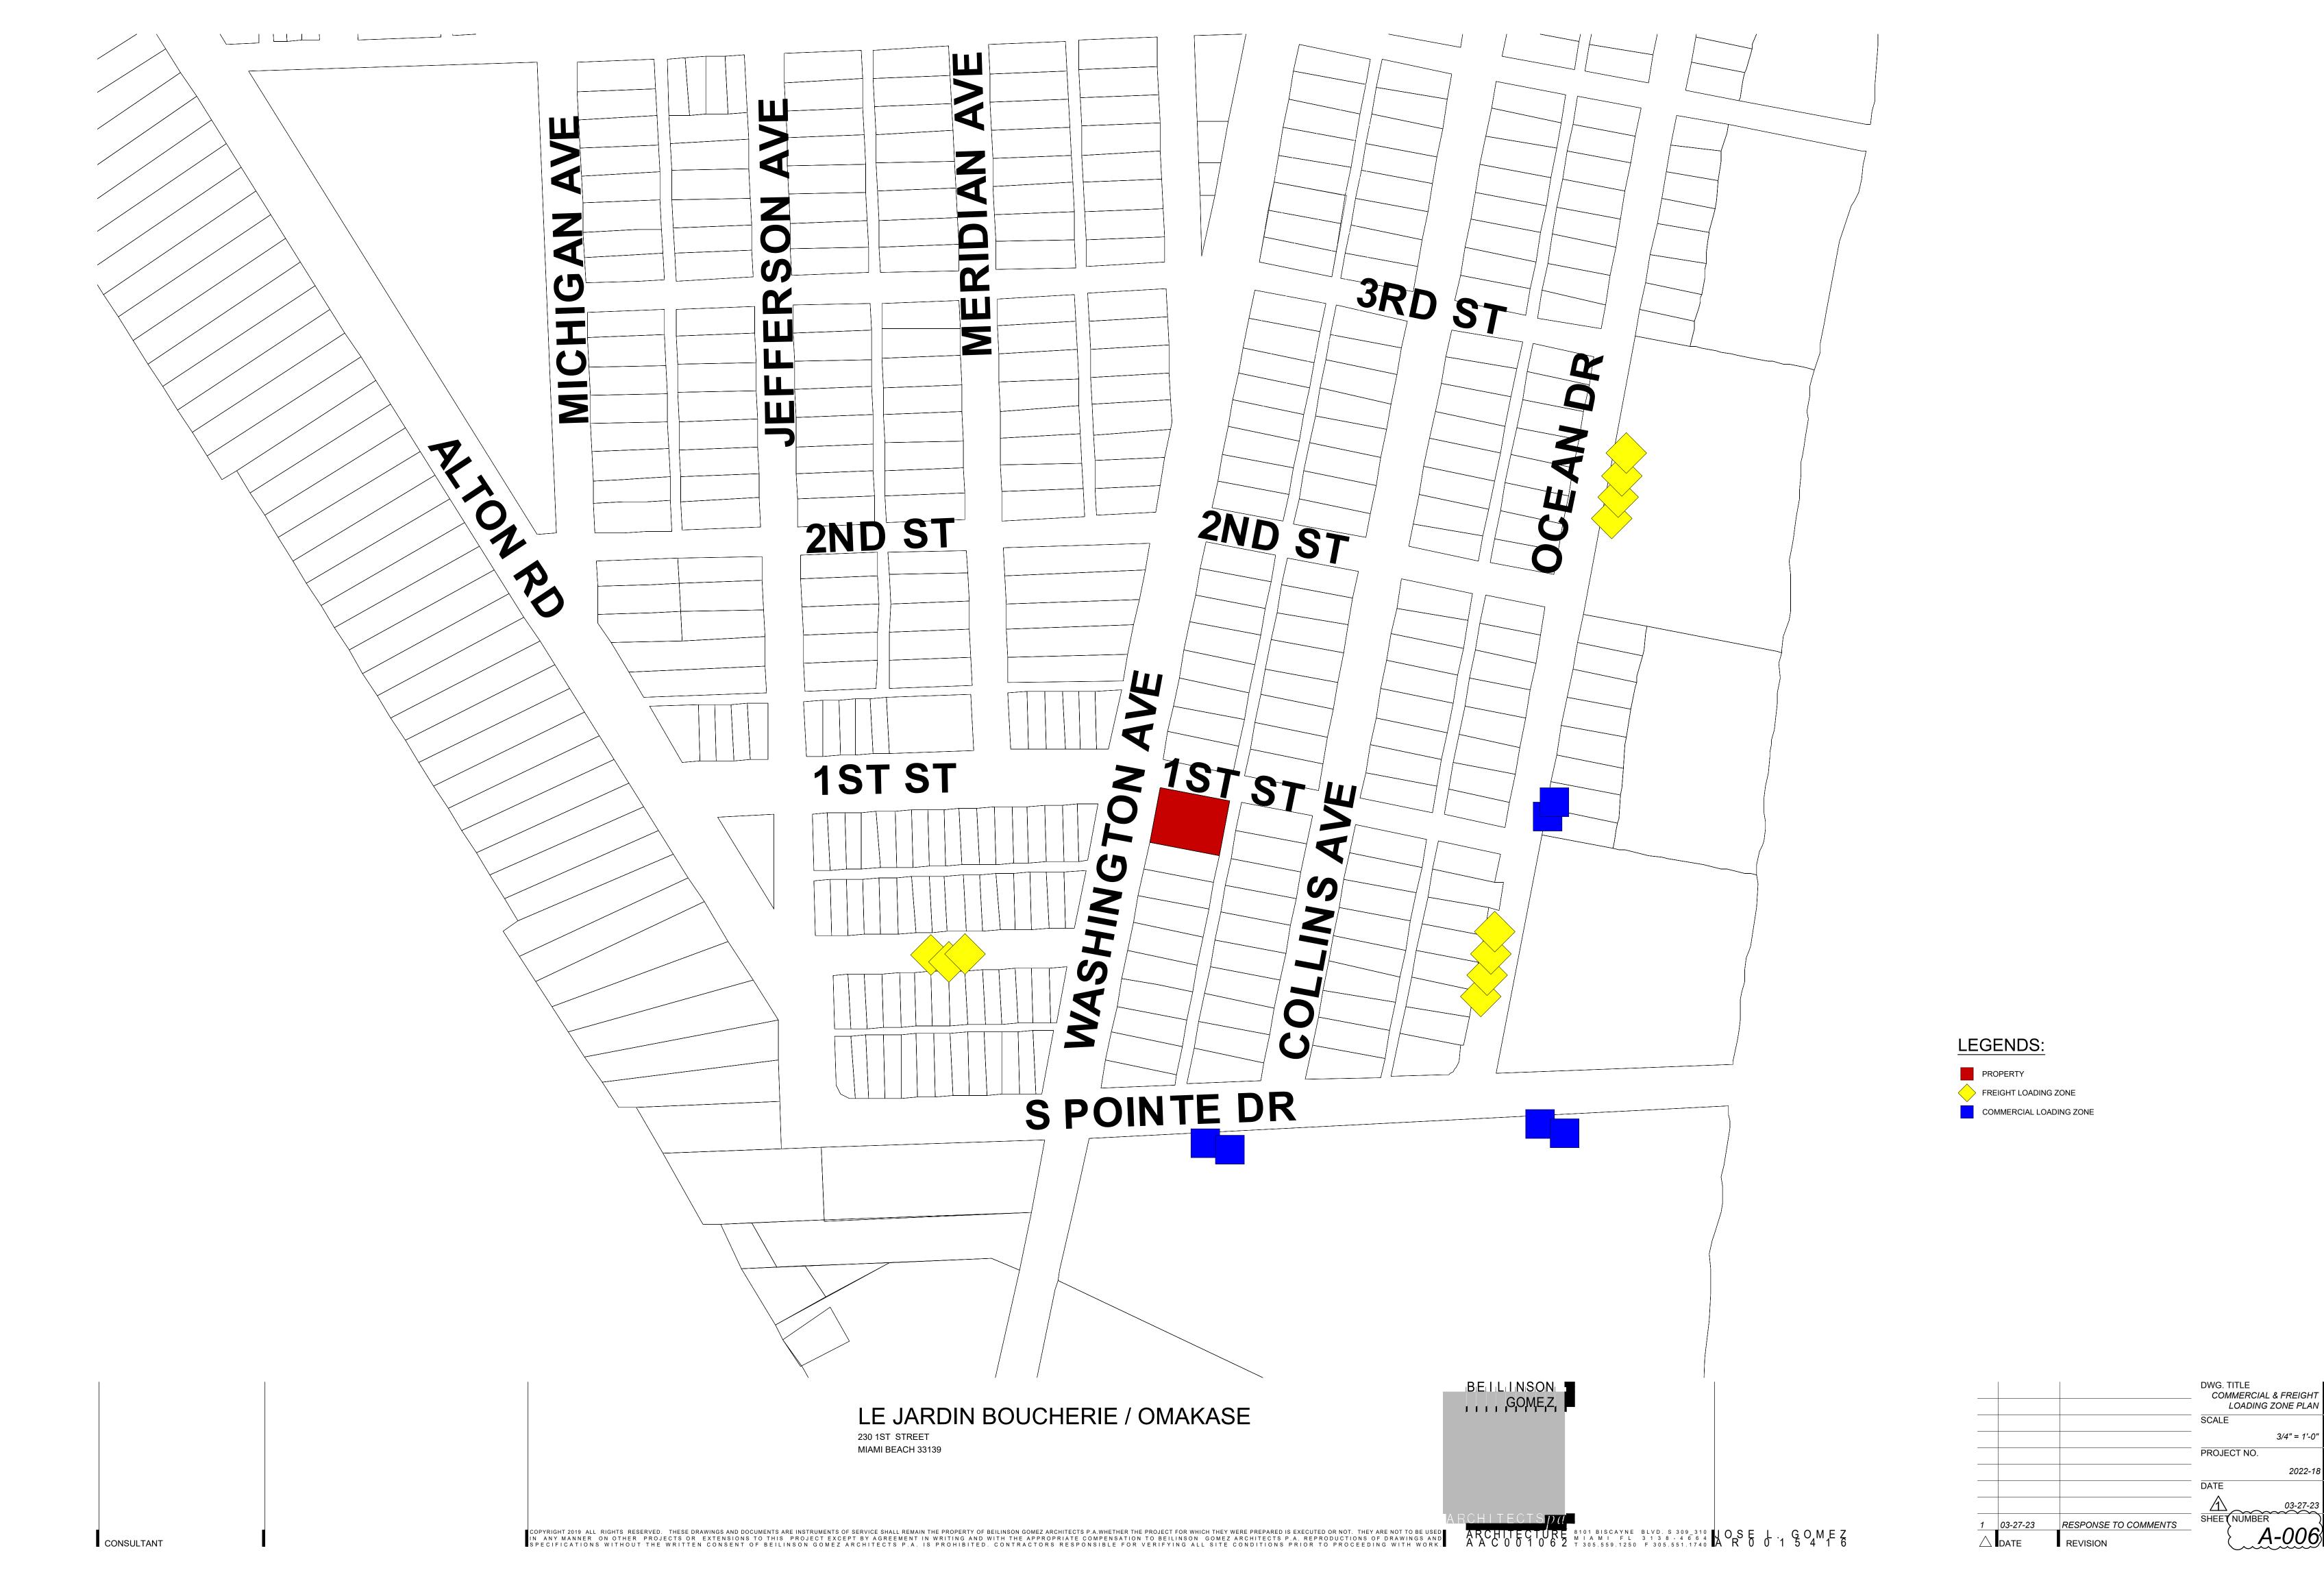


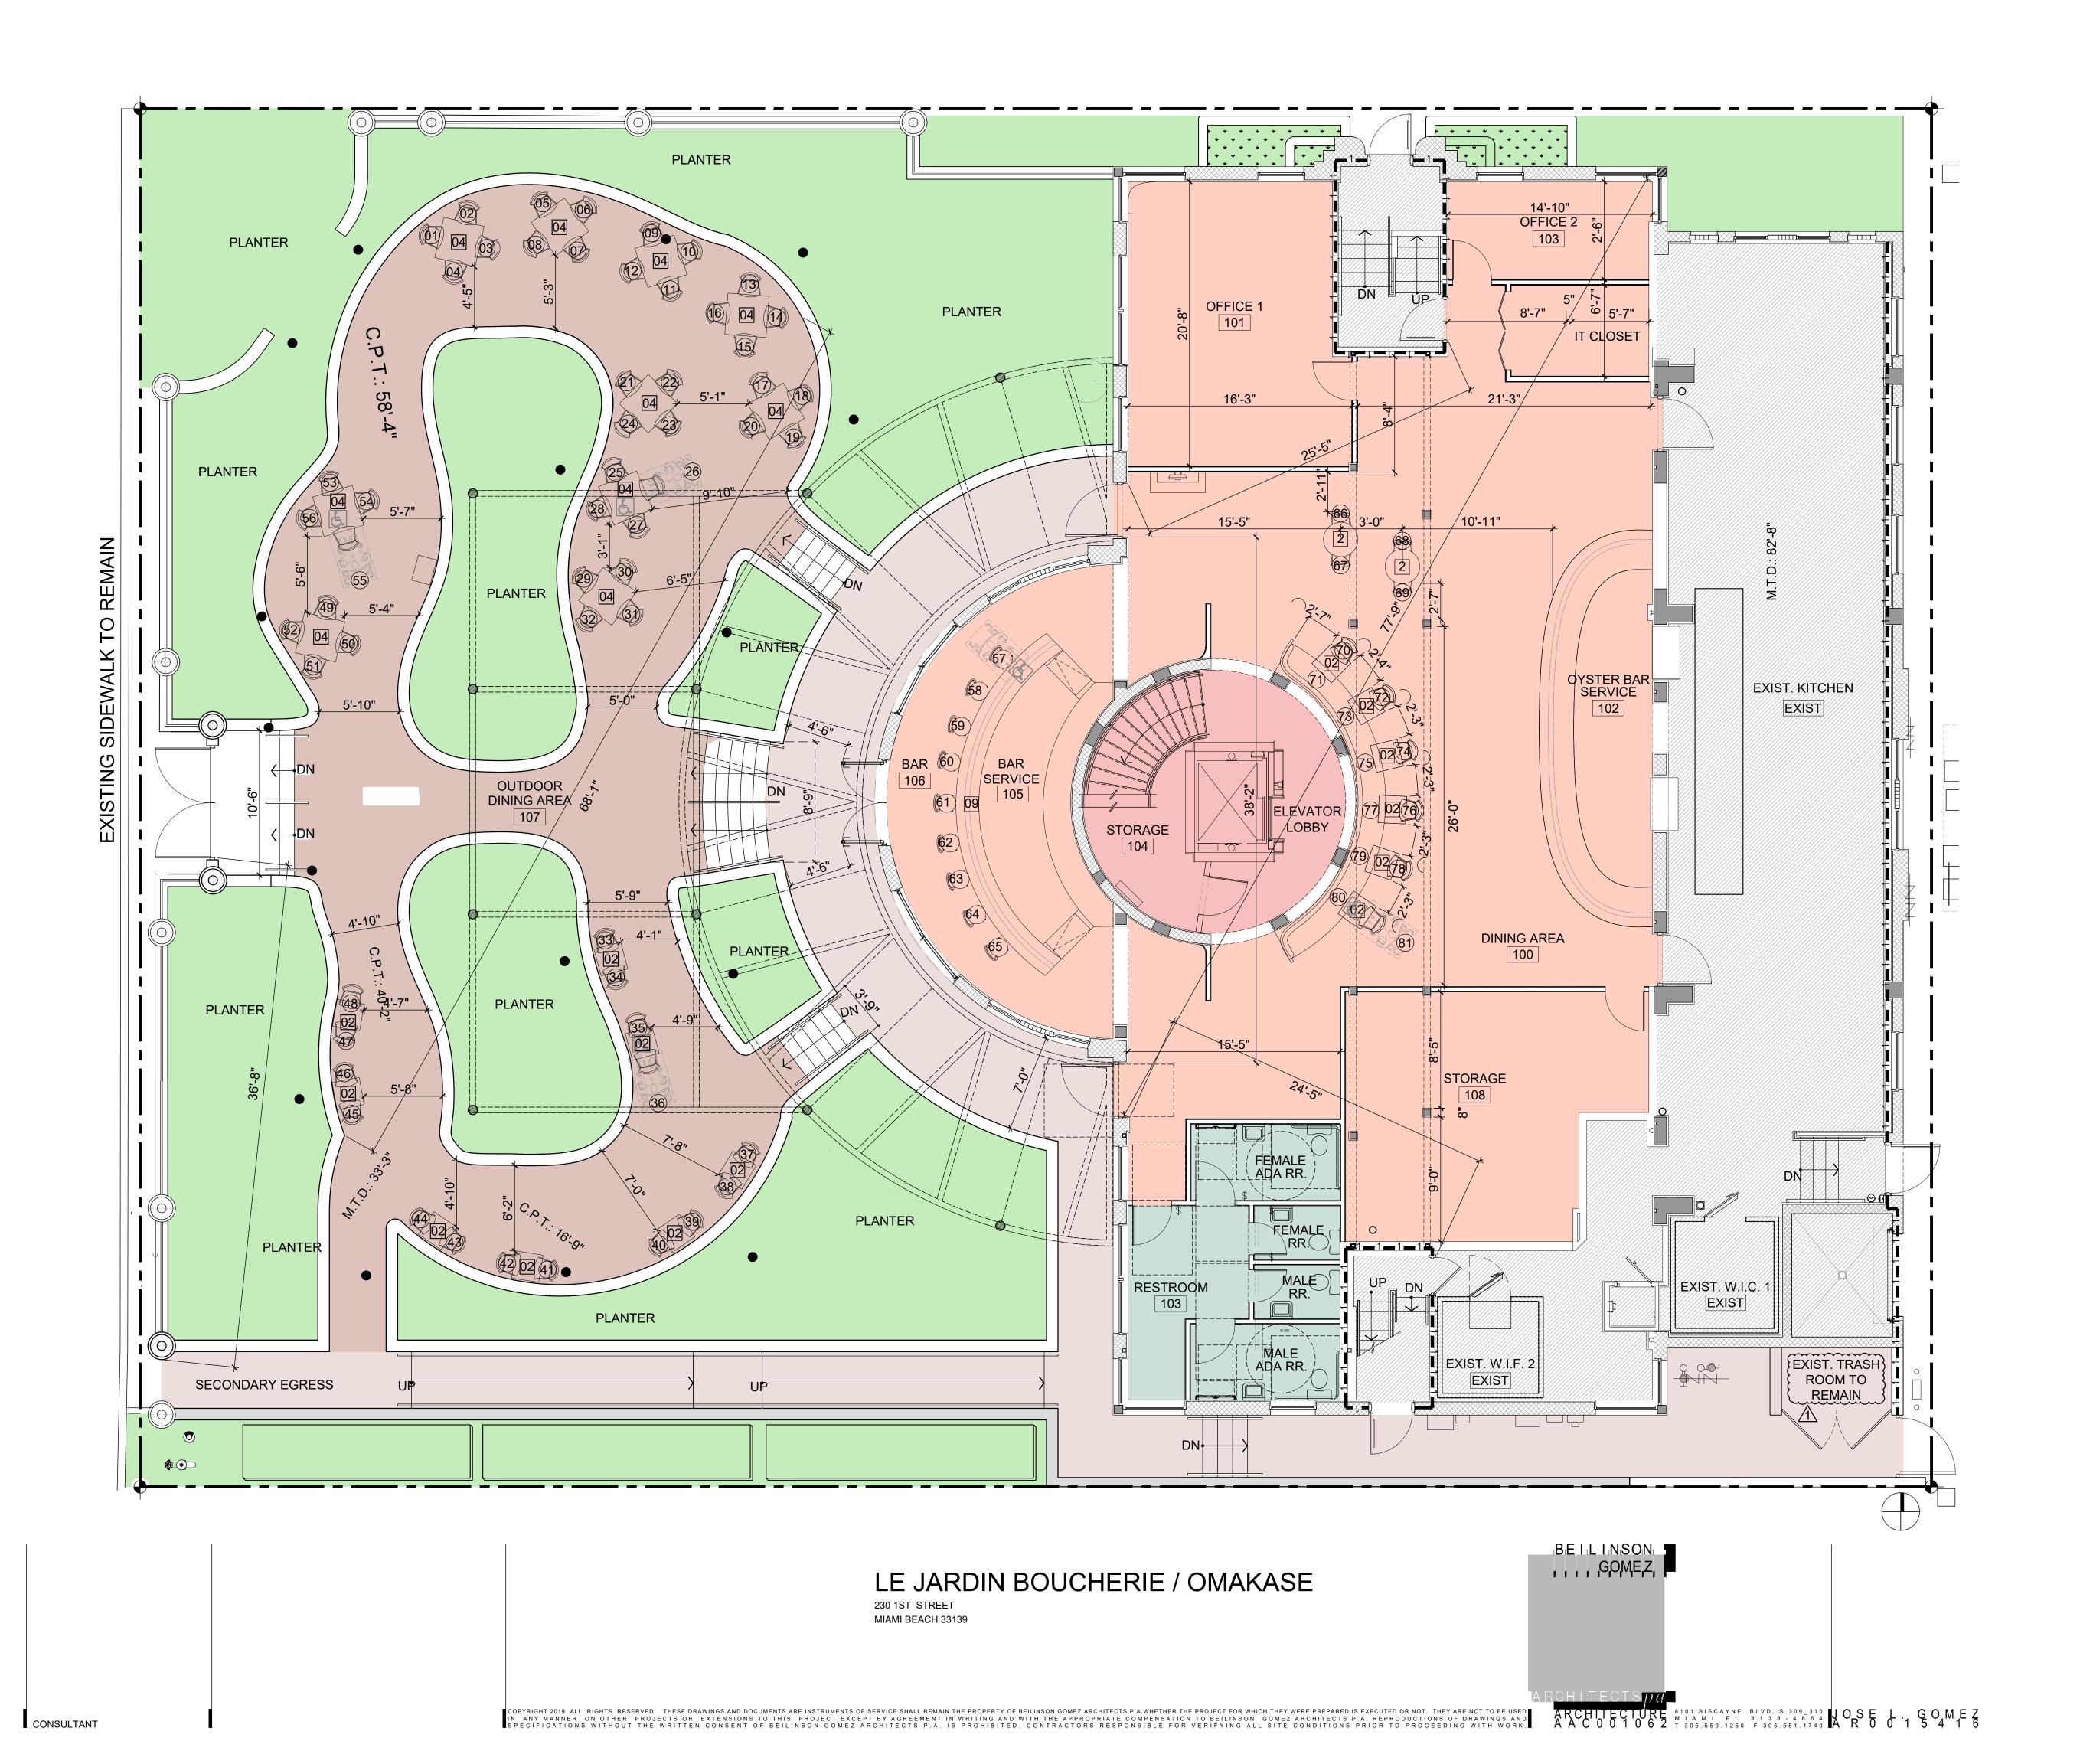


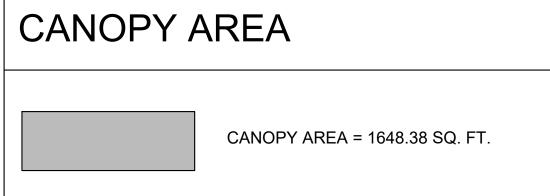


SEATING CALCULATION							
LABEL	NUMBER OF SEATS						
100	DINING AREA	16					
101	BAR	0					
106	BAR	9					
107 OUTDOOR DINING AREA		56					
TOTAL # O	F SEATS	81					

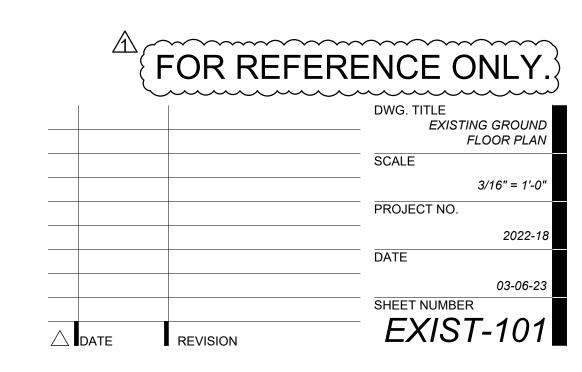

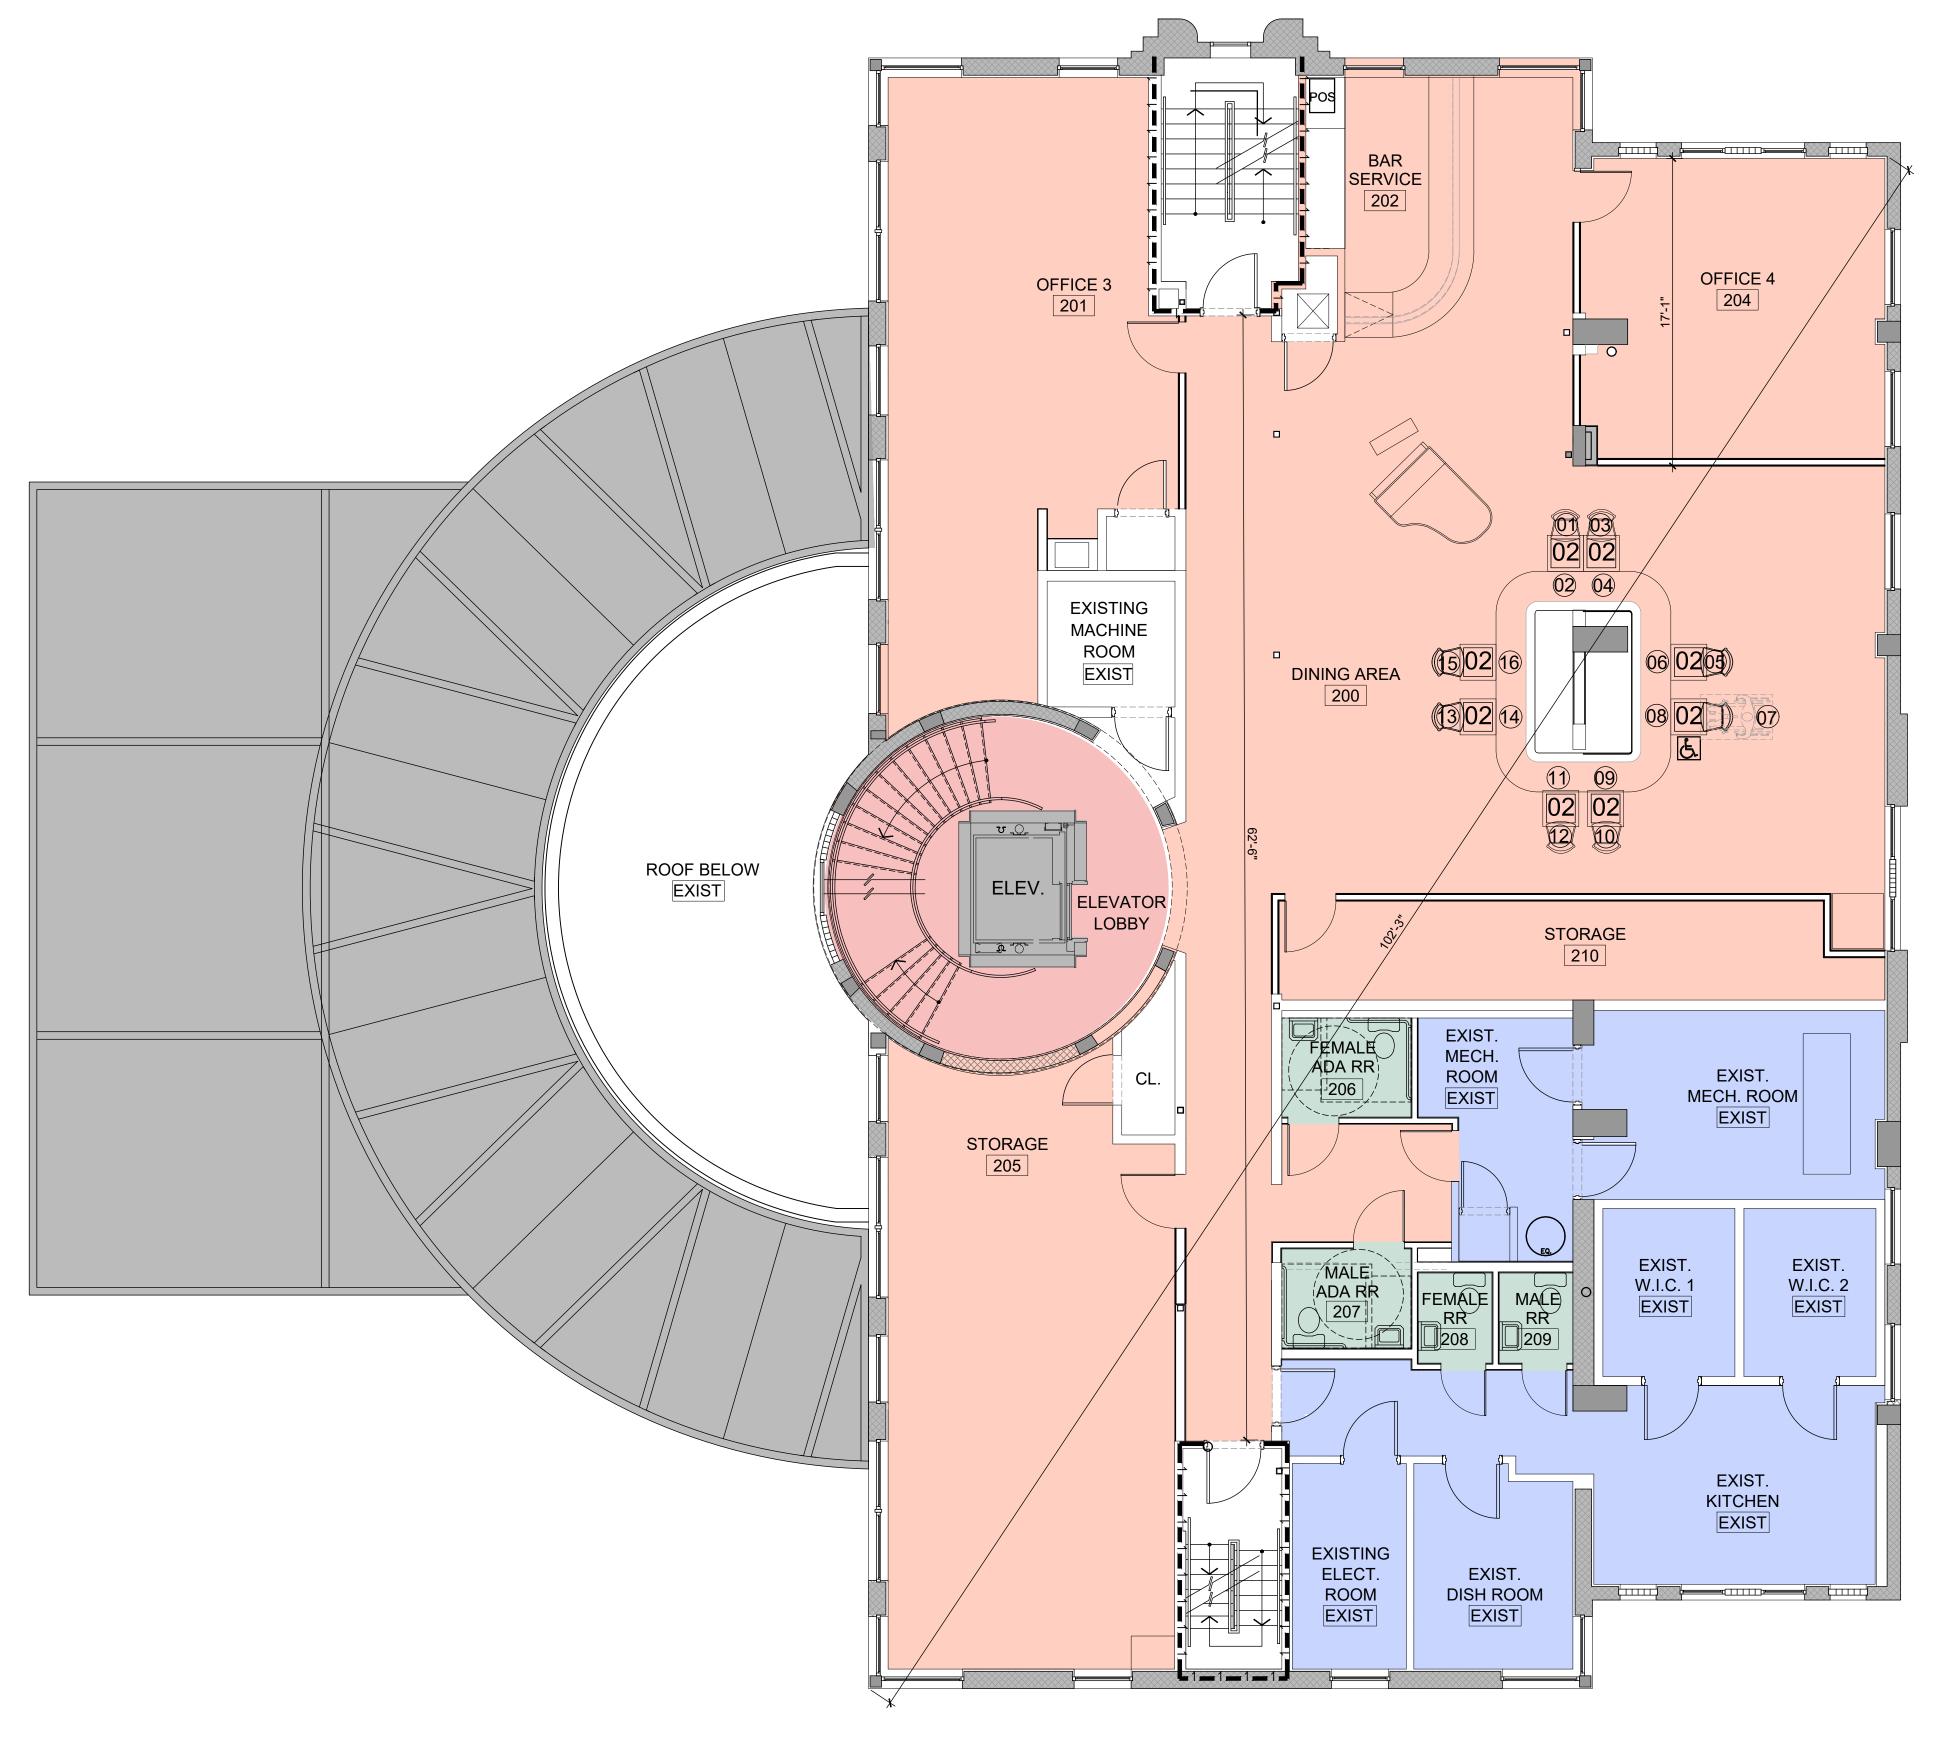

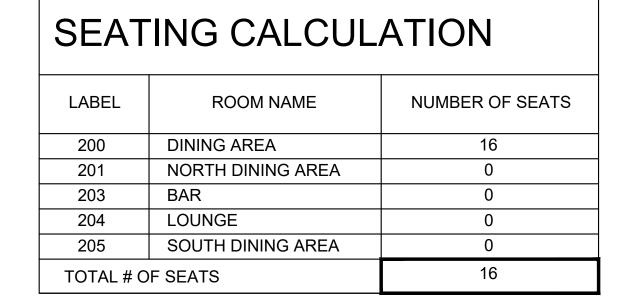

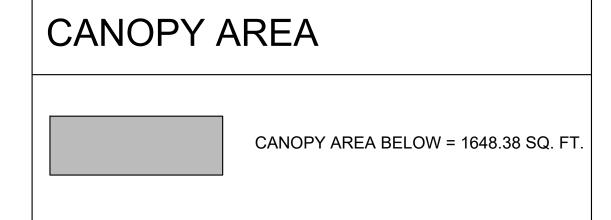

NOTE: ASSEMBLY (A2) BASED ON NFPA 101 2020 F.F.P.C. TBL. 7.3.1.2 AND 2020F.B.C. TABLE 1004.1.2 HIGHEST OCCUPANCY FACTOR WAS USED TO DETERMINED HIGHEST OCCUPANCY LOAD										
	LABEL	ROOM NAME	FUNCTION OF SPACE	AREA /	ı	FBC 2020		F.F.P.C	F.F.P.C N.F.P.A 101	
		_ ROOM NAME	as per table 1004.1.1 F.B.C.	LENGTH	FLOOR AREA IN S.F. PER OCCUP.	# OF OCCUP.	TOTAL # OF OCCUP.	FLOOR AREA IN S.F. PER OCCUP.	# OF OCCUP.	TOTAL # OF OCCUP.
	100	DINING AREA	ASSEMBLY (UNCONCENTRATED)	910 SQ. FT.	15 NET	60.6	61	15 NET	60.6	61
	101	OFFICE 1	BUSINESS	366 SQ. FT.	150 GROSS	2.44	3	150 GROSS	2.44	3
\ \ \	102	OYSTER BAR SERVICE	KITCHEN	191 SQ. FT.	200 GROSS	0.96	1	100 GROSS	1.91	2
OOR	103	OFFICE 2	BUSINESS	132 SQ. FT.	150 GROSS	0.88	1	150 GROSS	0.88	1
<u> </u>	104	STORAGE	STORAGE	123 SQ. FT.	300 GROSS	0.41	1	500 GROSS	0.24	1
ST	105	BAR SERVICE	KITCHEN	163 SQ. FT.	200 GROSS	0.82	1	100 GROSS	1.63	2
1	106	BAR	ASSEMBLY (CONCENTRATED)	29.16 FT.	<u>L X 4</u> 7	16.66	17	<u>L X 4</u> 7	16.66	17
	107	OUTDOOR DINING	ASSEMBLY (UNCONCENTRATED)	1,585 SQ. FT.	15 NET	105.66	106	15 NET	105.66	106
	108	STORAGE	STORAGE	366 SQ. FT.	300 GROSS	1.22	2	500 GROSS	0.73	1
	EXIST	EXISTING KITCHEN	KITCHEN	1,453 SQ. FT.	200 GROSS	7.27	8	100 GROSS	14.53	15
		EXISTING W.I.C. 1	STORAGE	91 SQ. FT.	300 GROSS	0.30	1	500 GROSS	0.18	1
T-6		EXISTING W.I.F. 2	STORAGE	66 SQ. FT.	300 GROSS	0.22	1	500 GROSS	0.13	1
\Box) AL # (<u>OCCUPANTS 1ST FLOOR</u>					203			211

	200	DINING AREA	ASSEMBLY (UNCONCENTRATED)	766 SQ. FT.	15 NET	51.06	52	15 NET	51.06	52
	201	OFFICE 3	BUSINESS	531 SQ. FT.	150 GROSS	3.54	4	150 GROSS	3.54	4
	202	BAR SERVICE	KITCHEN	114 SQ. FT.	200 GROSS	0.57	1	100 GROSS	1.14	2
	204	OFFICE 4	BUSINESS	321 SQ. FT.	150 GROSS	2.14	3	150 GROSS	2.14	3
OR	205	STORAGE	STORAGE	601 SQ. FT.	300 GROSS	2.00	2	500 GROSS	1.20	2
FLO	210	STORAGE	STORAGE	212 SQ. FT.	300 GROSS	0.70	1	500 GROSS	0.42	1
nd F	EXIST	EXIST. MECH. ROOM	STORAGE	332 SQ. FT.	300 GROSS	1.11	2	500 GROSS	0.66	1
2	EXIST	EXIST. W.I.C. 1	STORAGE	83 SQ. FT.	300 GROSS	0.27	1	500 GROSS	0.16	1
	EXIST	EXIST. W.I.C. 2	STORAGE	88 SQ. FT.	300 GROSS	0.29	1	500 GROSS	0.17	1
	EXIST	KITCHEN	KITCHEN	318 SQ. FT.	200 GROSS	1.59	2	100 GROSS	3.18	4
	EXIST	EXIST. ELECT. ROOM	STORAGE	87 SQ. FT.	300 GROSS	0.29	1	500 GROSS	0.17	1
	EXIST	DISH ROOM	KITCHEN	121 SQ. FT.	200 GROSS	0.61	1	100 GROSS	1.21	2
TC	TOTAL # OCCUPANTS 2ND FLOOR						71			74
TC	TOTAL # OCCUPANTS 1ST & 2ND FLOOR						274			285


TOTAL S.F. AT 1ST FLOOR = 7,363 S.F. TOTAL S.F. AT 2ND FLOOR = 3,919 S.F. TOTAL S.F. AT 1ST & 2ND FLOOR = 11,282 S.F.











	A(1	FOR REFERI	ENCE ONLY.
			DWG. TITLE EXISTING SECOND
			FLOOR PLAN
			SCALE
			3/16" = 1'-0"
			PROJECT NO.
			DATE
			03-06-23
1	03-27-2023	RESPONSE TO COMMENTS	SHEET NUMBER
\wedge	DATE	REVISION	<i>EXIST-102</i>

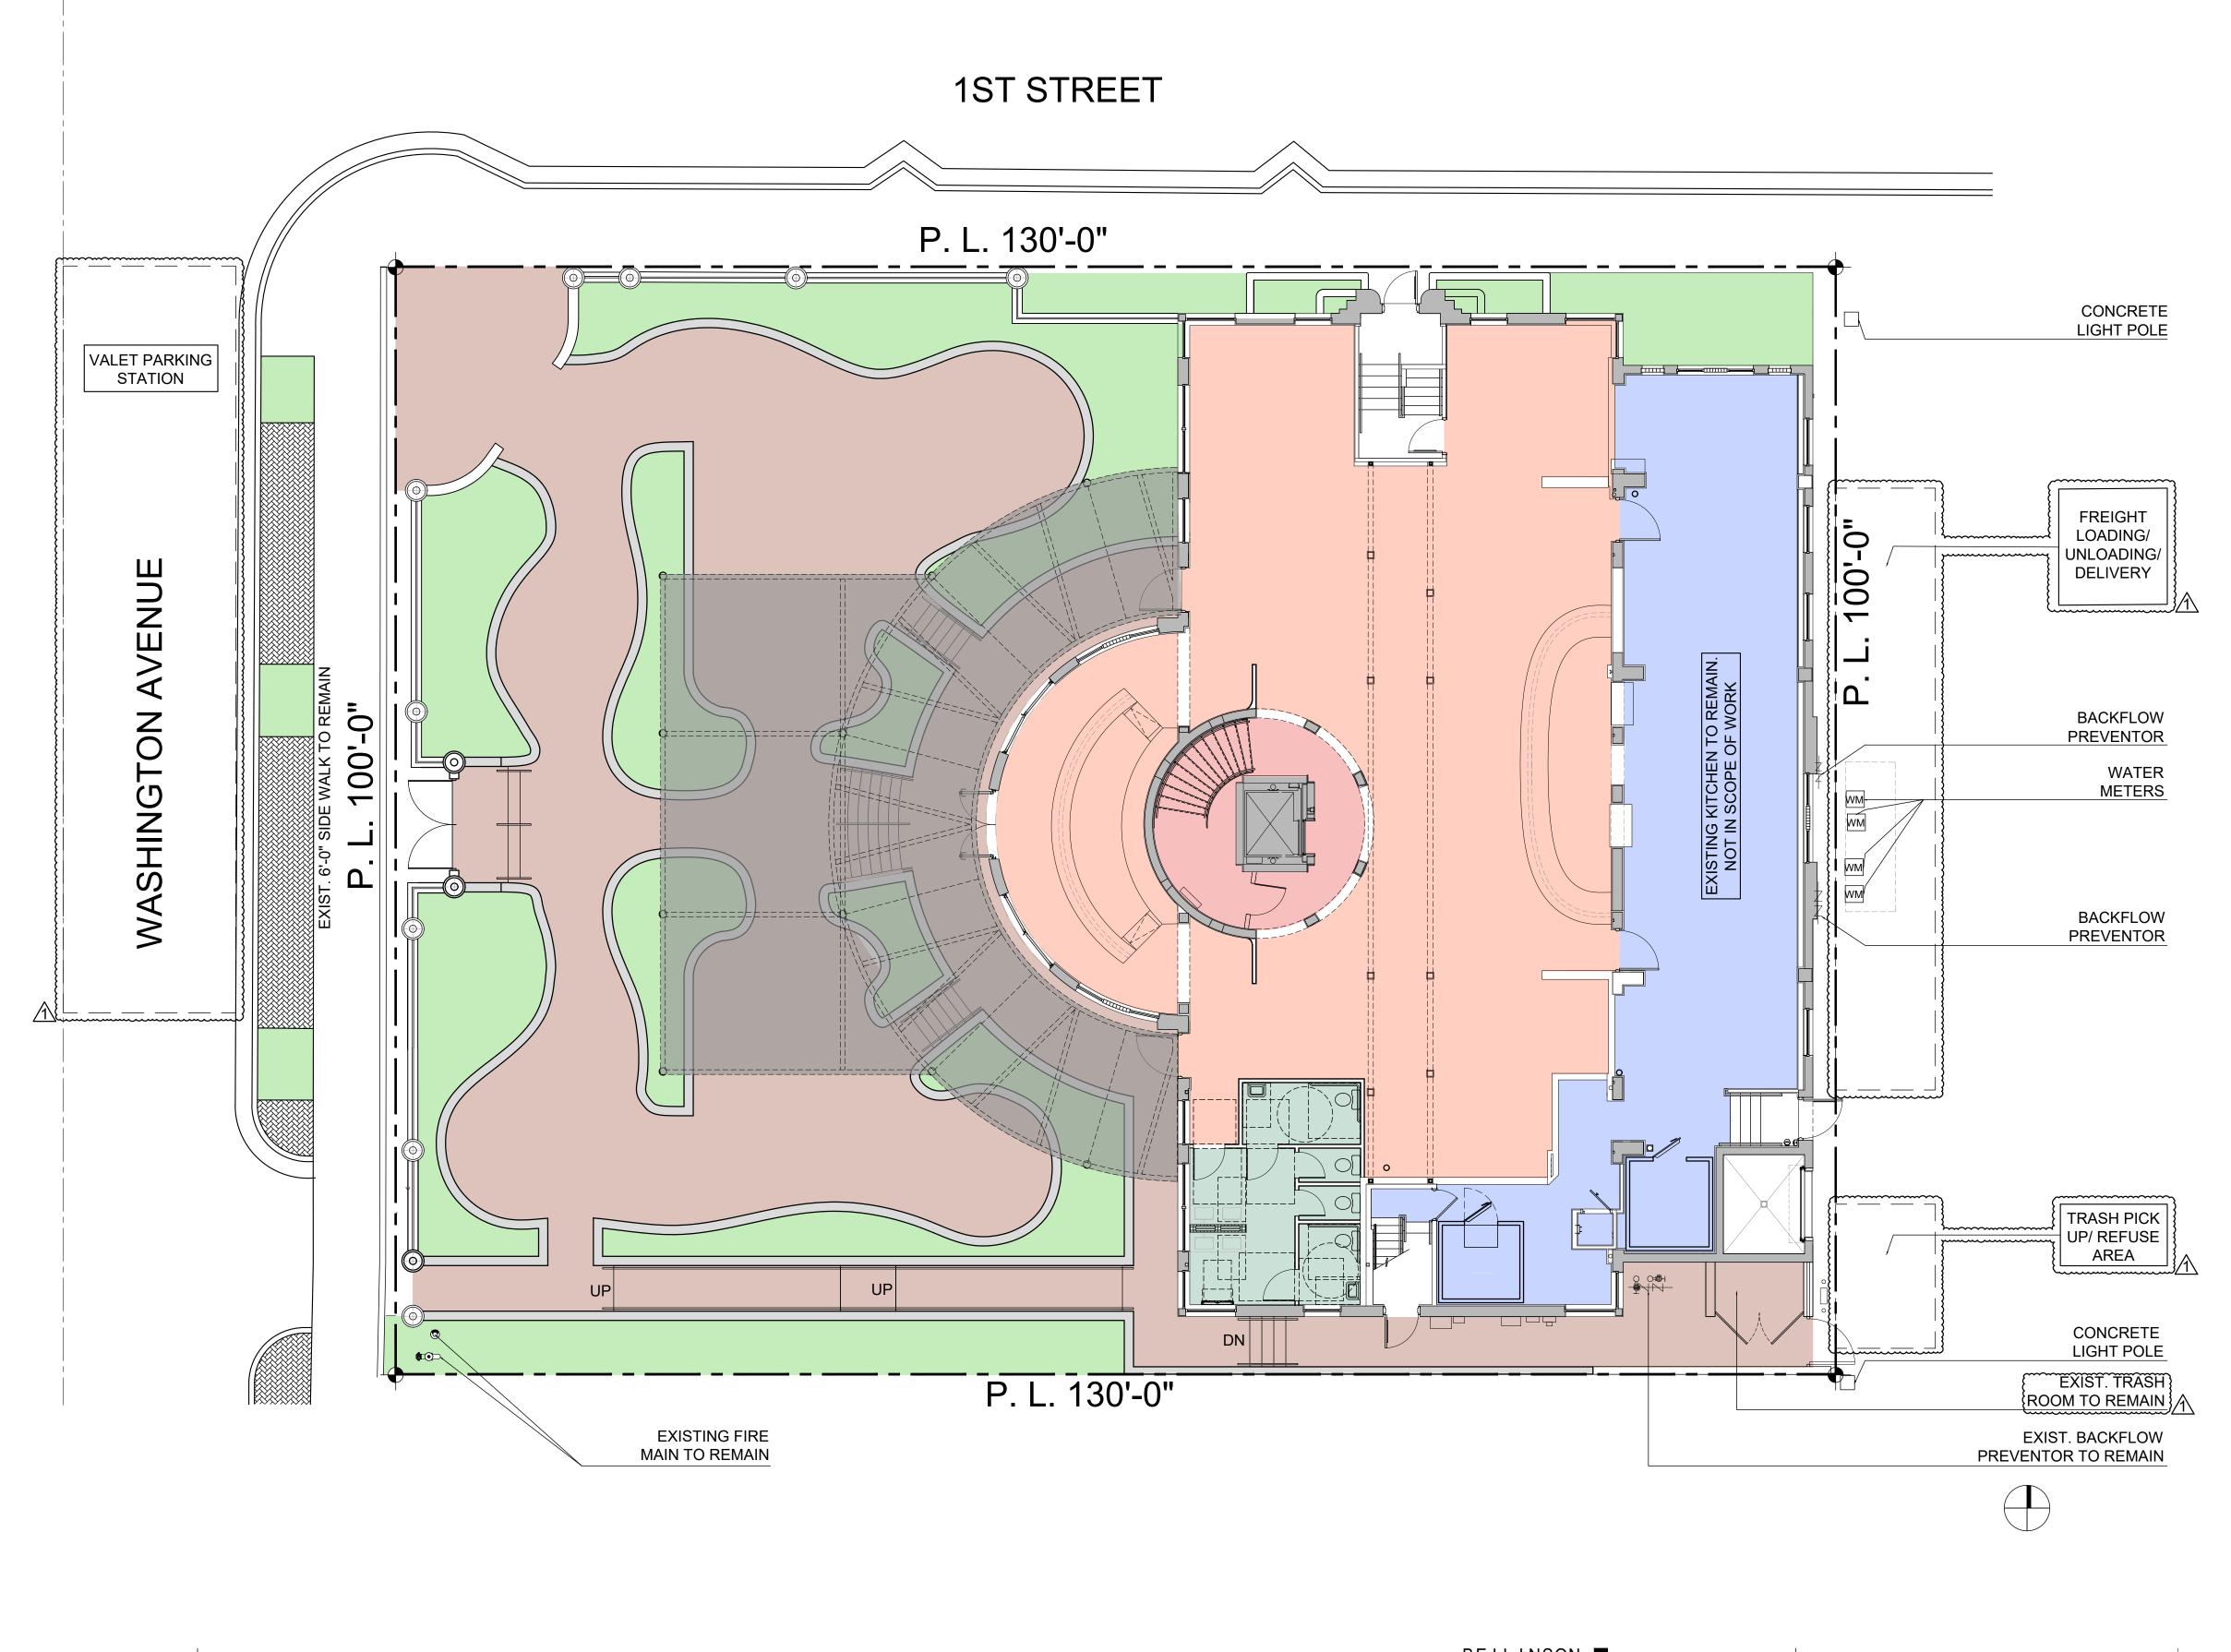

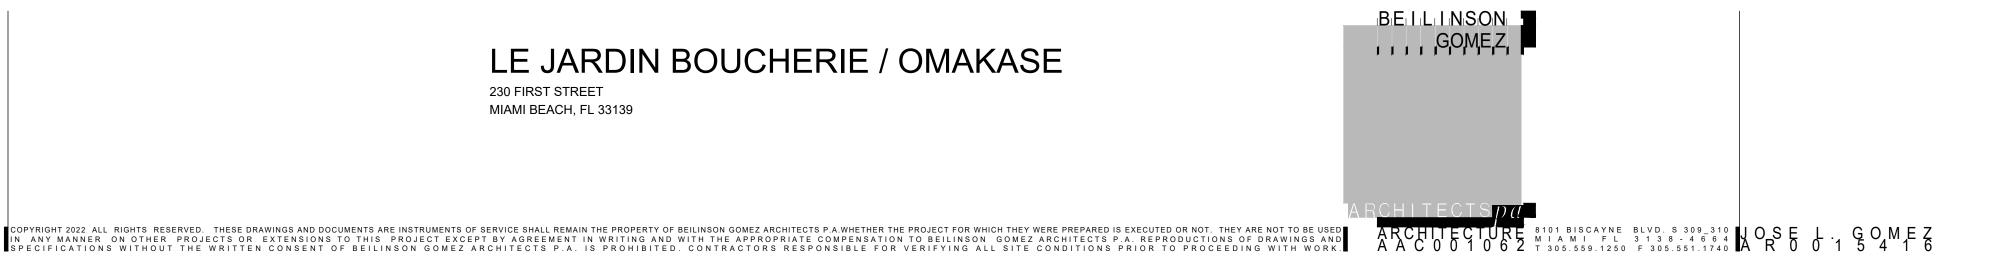

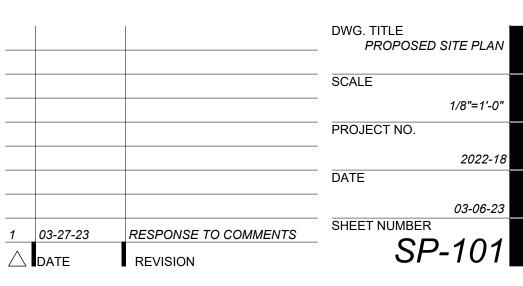


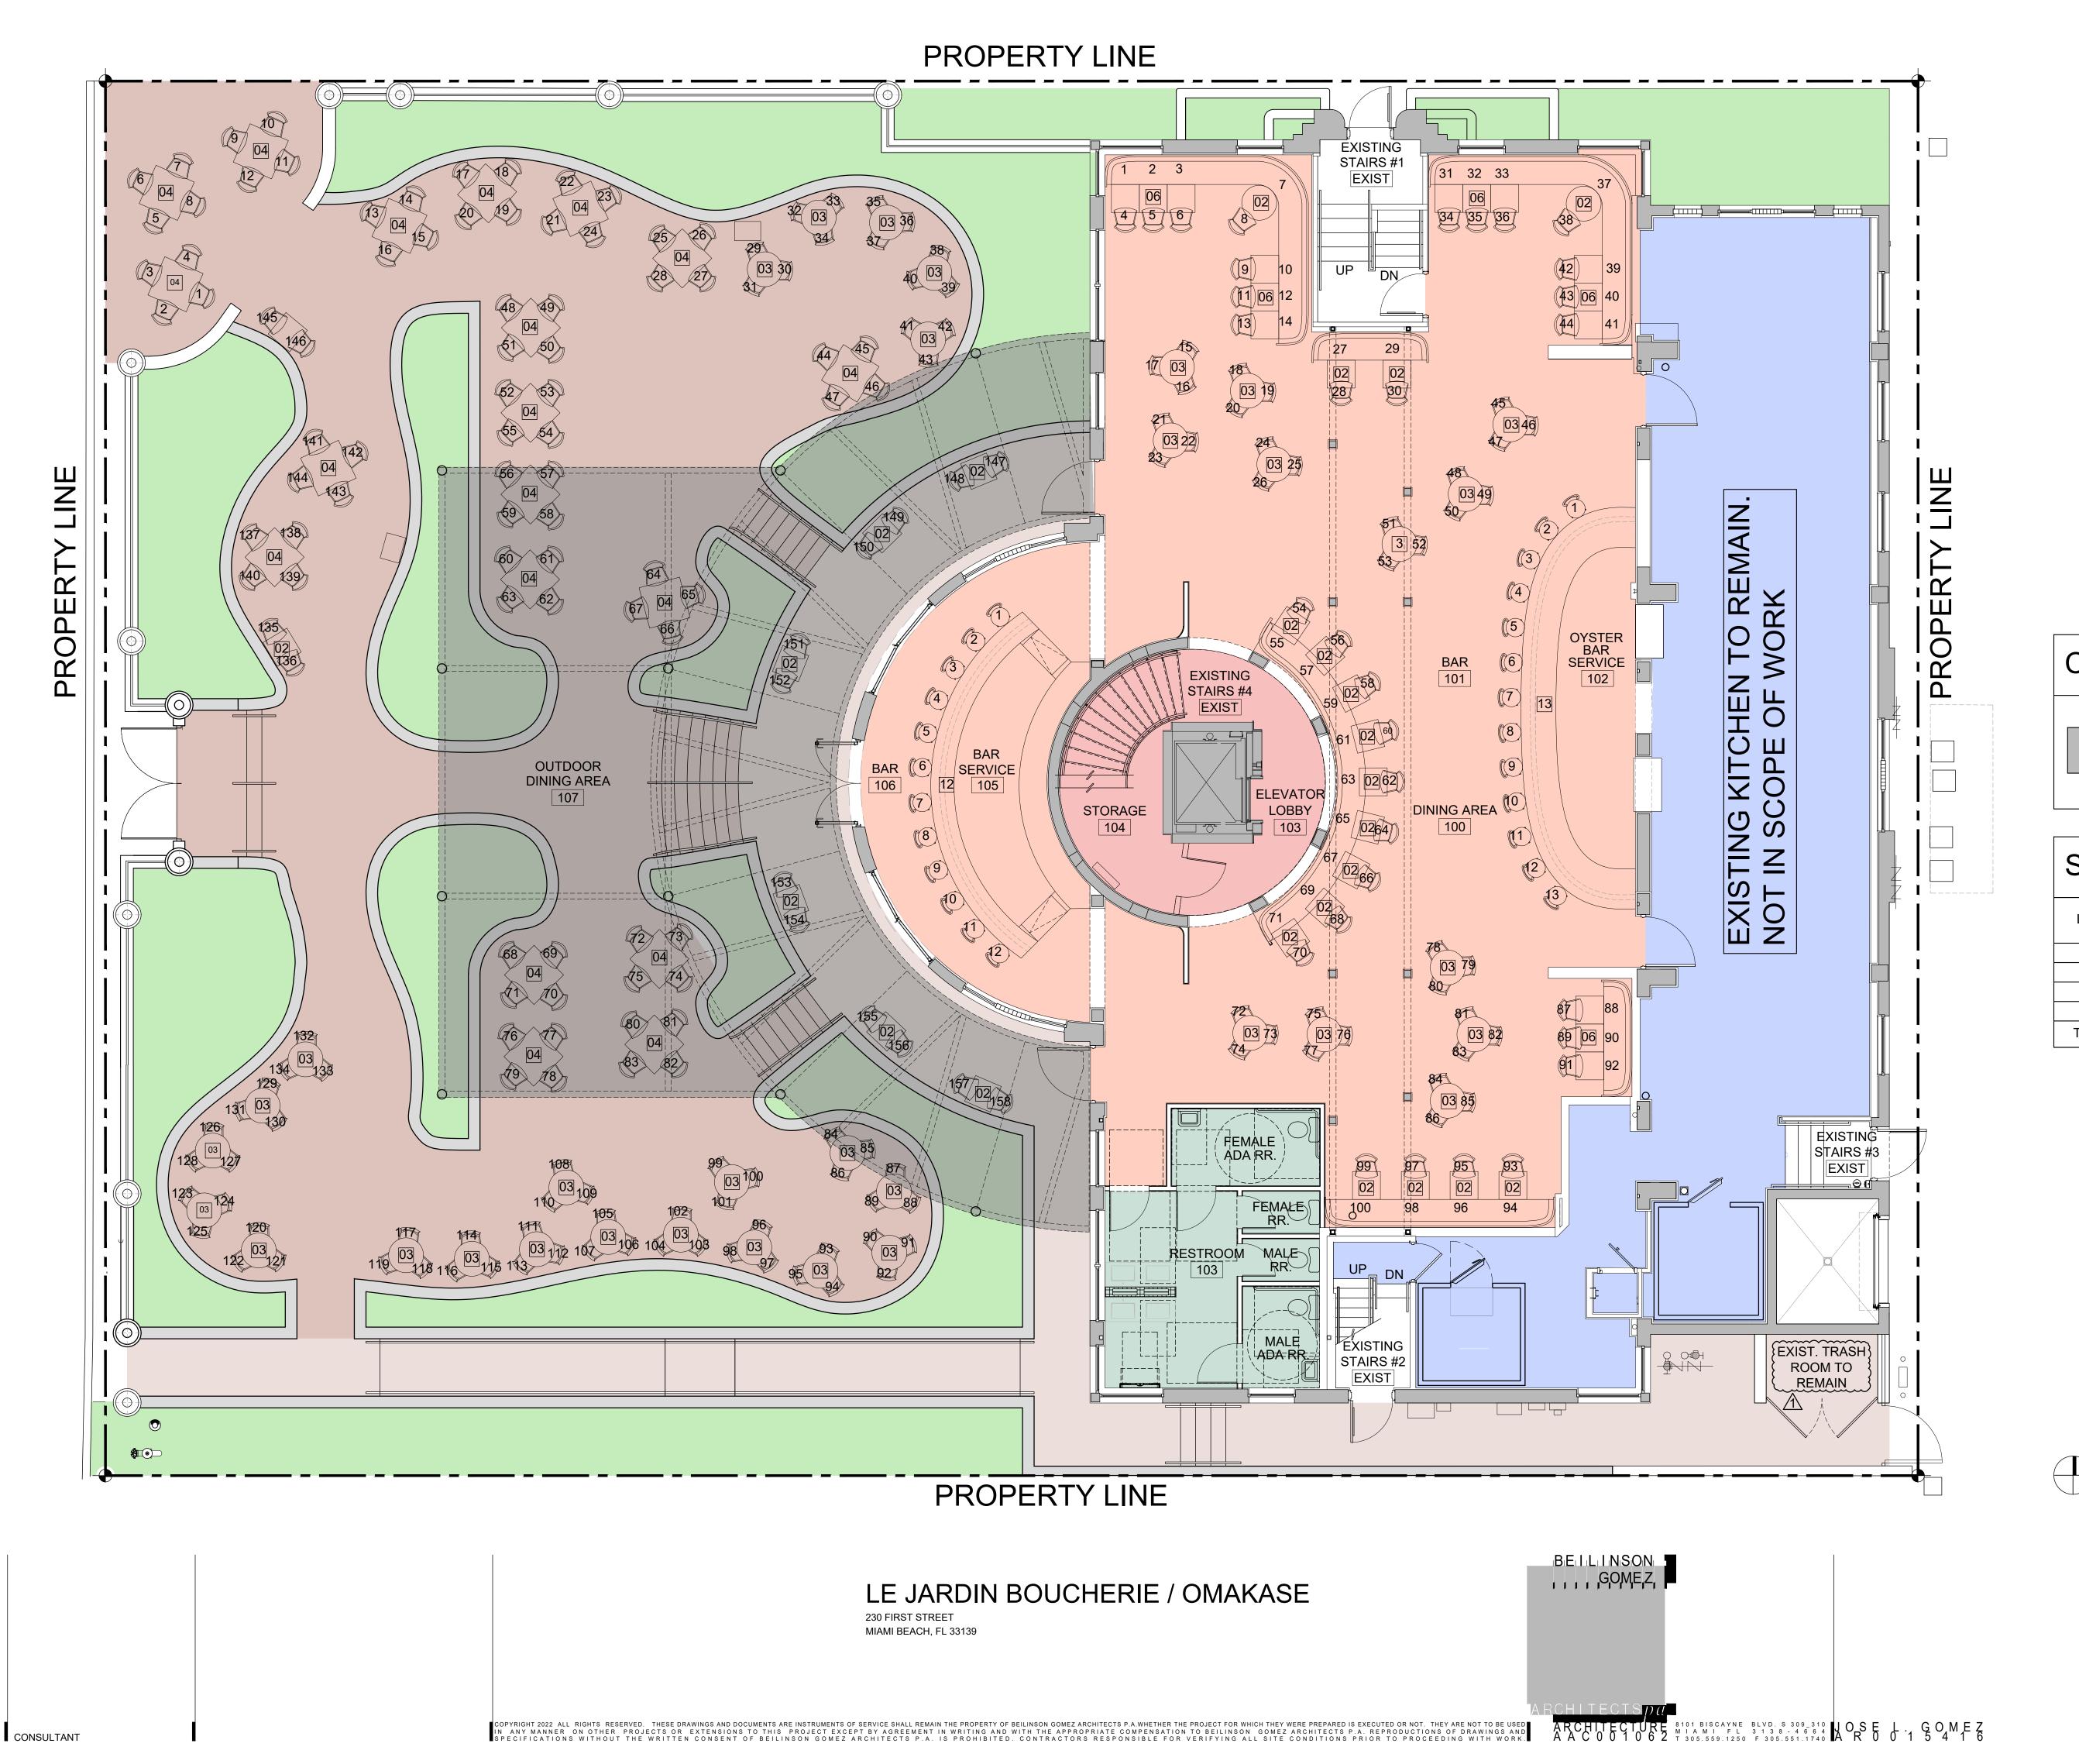


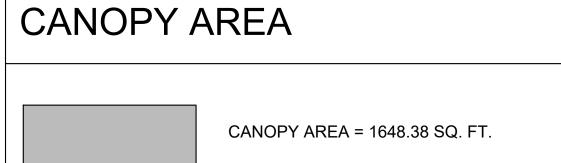

SEATING CALCULATION							
LABEL	ROOM NAME	NUMBER OF SEATS					
100	DINING AREA	100					
101	BAR	13					
106	BAR	12					
107	OUTDOOR DINING AREA	158					
TOTAL # C	F SEATS	283					



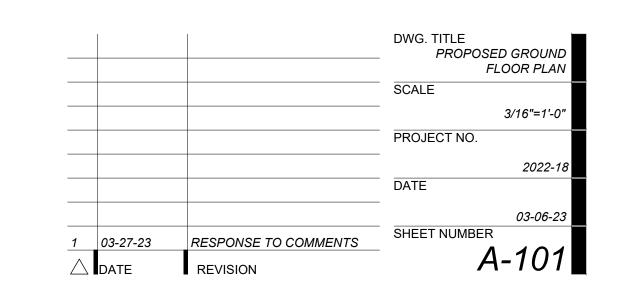

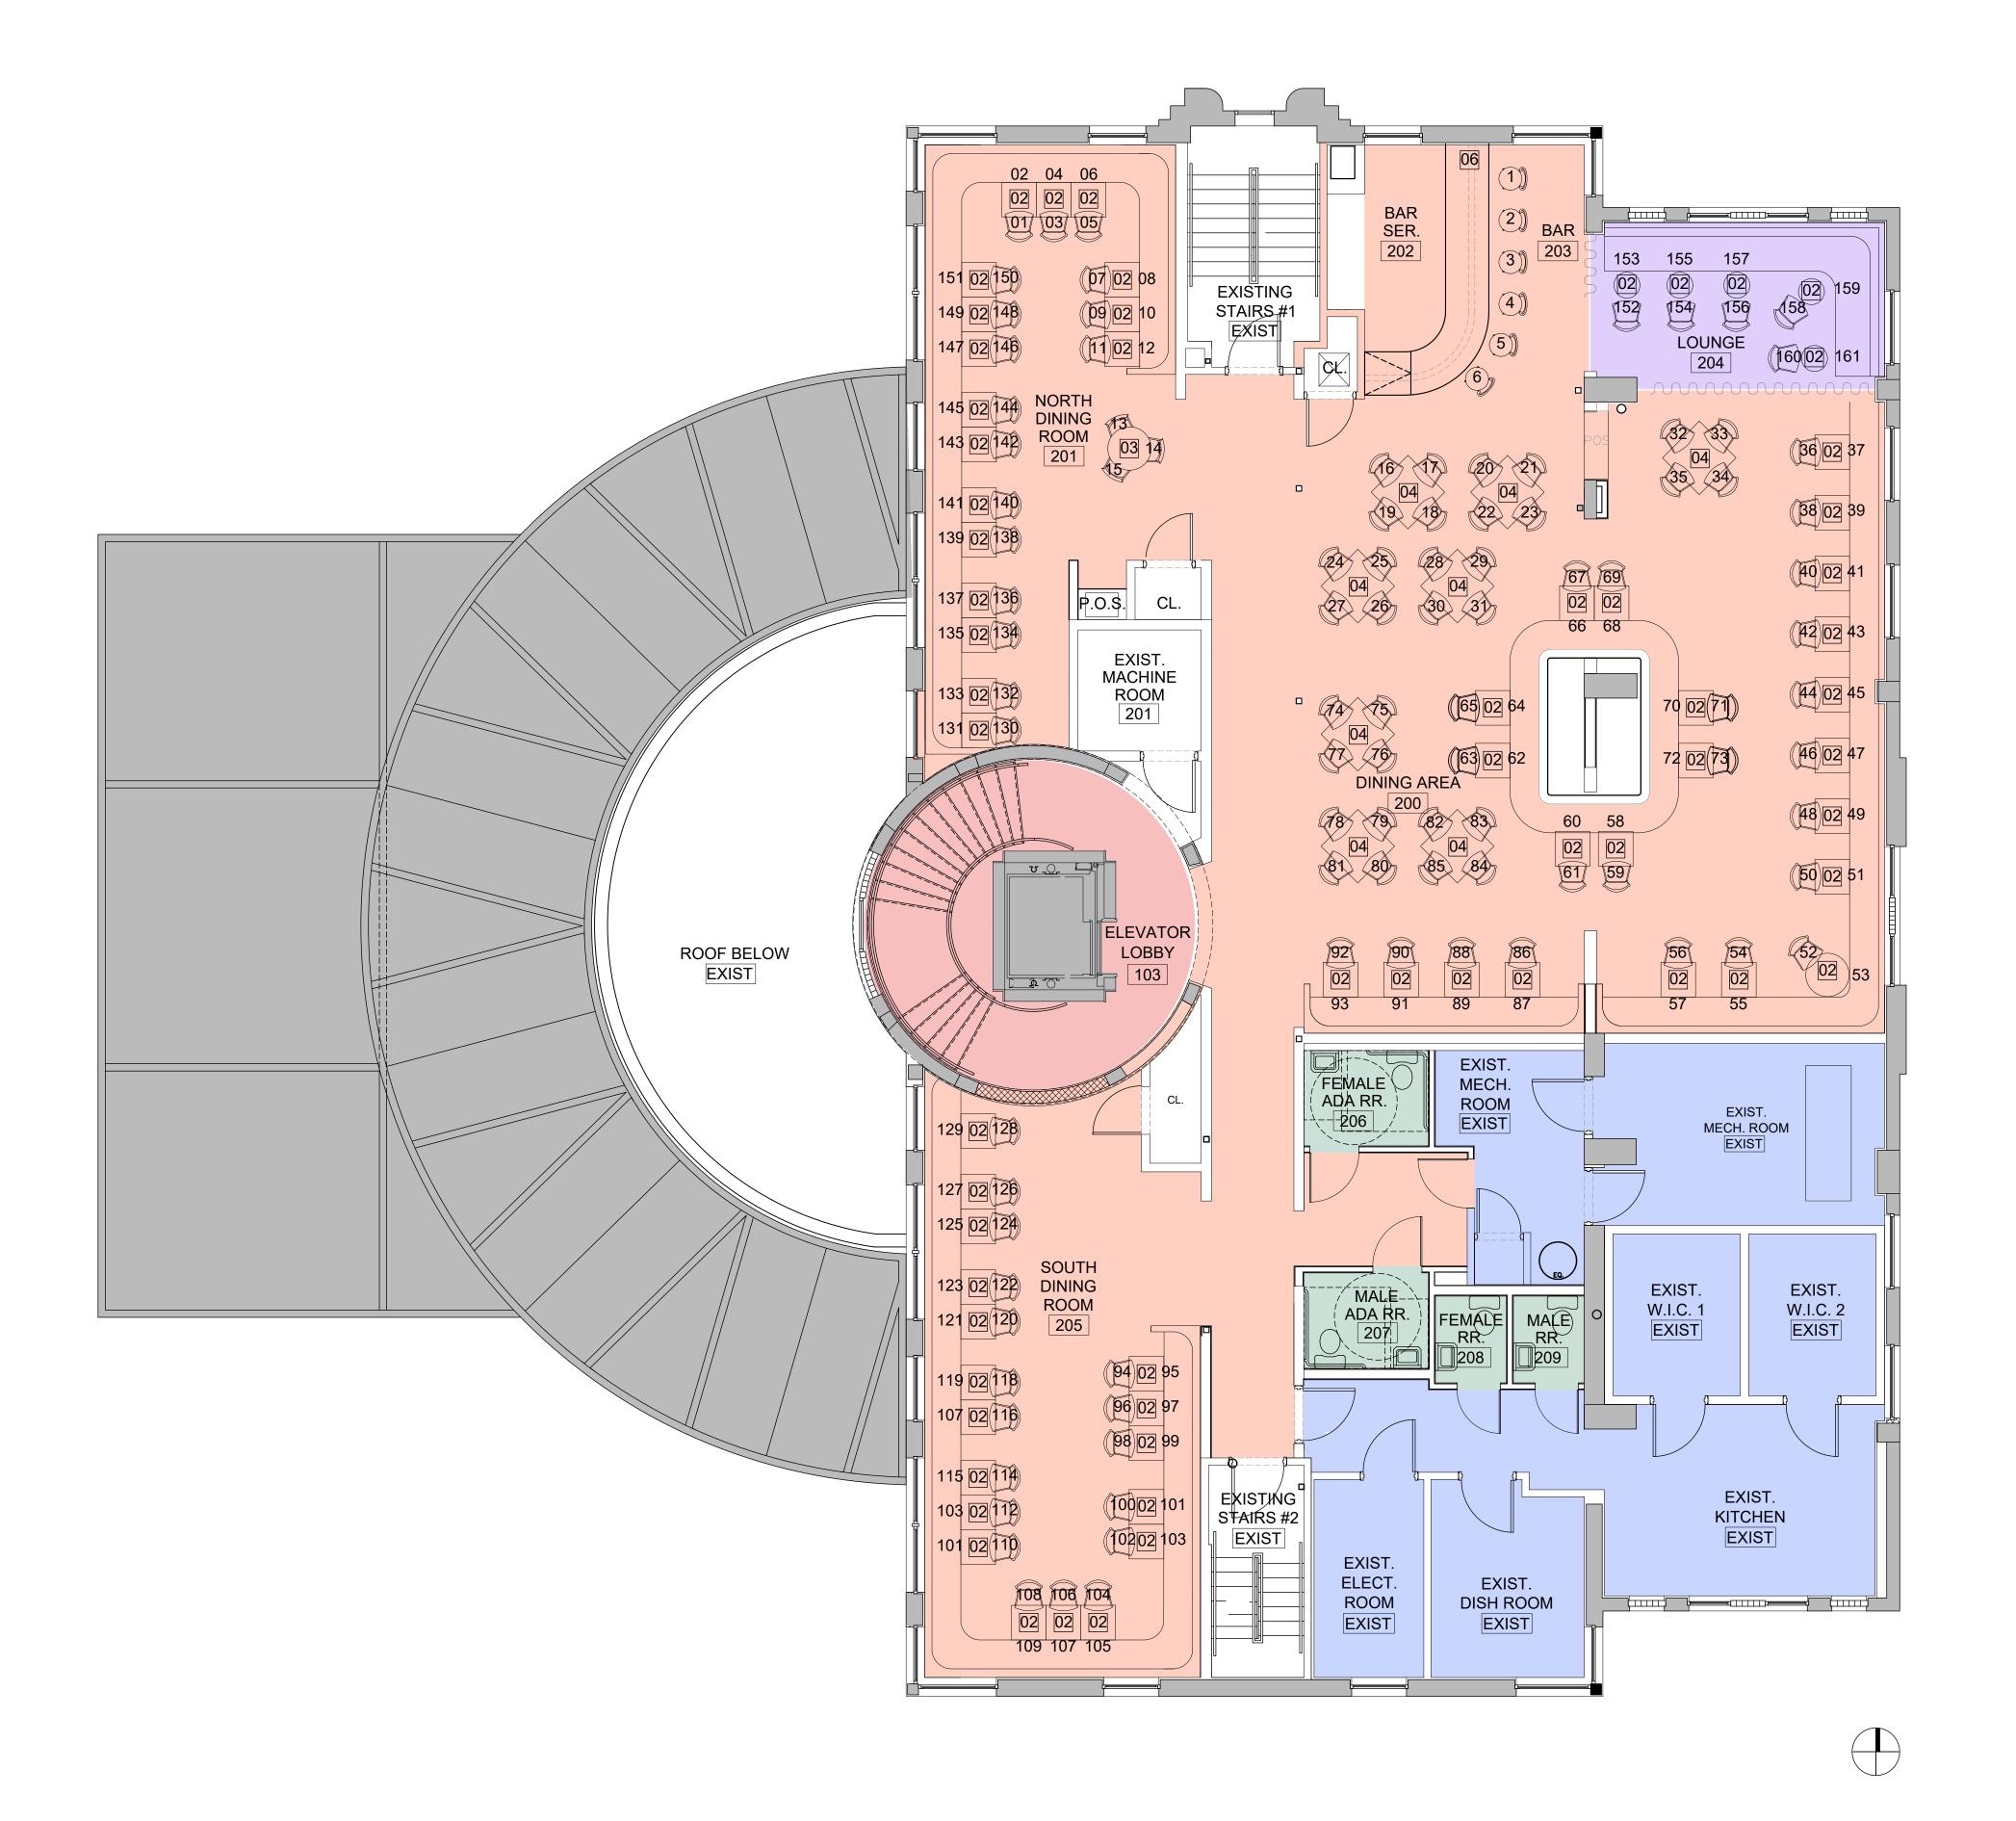



	LABEL	ROOM NAME	NUMBER OF SEATS
	200 DINING AREA 201 NORTH DINING AREA 203 BAR		78
			37
			6
	204	LOUNGE	10
	205	SOUTH DINING AREA	36
	TOTAL # O	F SEATS	167

CANOPY AREA	

CANOPY AREA BELOW = 1648.38 SQ. FT.

OCCUPANT LOAD CALCULATION

ASSEMBLY (A2)

BASED ON NFPA 101 2020 F.F.P.C. TBL. 7.3.1.2 AND 2020F.B.C. TABLE 1004.1.2

HIGHEST OCCUPANCY FACTOR WAS USED TO DETERMINED HIGHEST OCCUPANCY LOAD

	LABEL	ROOM NAME	FUNCTION OF SPACE	AREA /	FBC 2020			F.F.P.C N.F.P.A 101		
		. ROOW NAME	as per table 1004.1.1		FLOOR AREA IN	# OF	TOTAL#	FLOOR AREA IN	# OF	TOTAL#
			F.B.C.		S.F. PER OCCUP.	OCCUP.	OF OCCUP.	S.F. PER OCCUP.	OCCUP.	OF OCCU
	100	DINING AREA	ASSEMBLY (UNCONCENTRATED)	1,953 SQ. FT.	15 NET	130.2	130	15 NET	130.2	130
	101	BAR	ASSEMBLY (CONCENTRATED)	38.25 FT.	<u>L X 4</u> 7	21.85	22	<u>L X 4</u> 7	21.85	22
	102	OYSTER BAR SERVICE	_	191 SQ. FT.	200 GROSS	0.96	1	100 GROSS	1.91	2
	103	ELEVATOR LOBBY	ASSEMBLY (UNCONCENTRATED)	69 SQ. FT.	15 NET	4.6	5	15 NET	4.6	5
	104	STORAGE	STORAGE	123 SQ. FT.	300 GROSS	0.41	1	500 GROSS	0.24	1
- 1	105	BAR SERVICE	KITCHEN	163 SQ. FT.	200 GROSS	0.82	1	100 GROSS	1.63	2
7	106	BAR	ASSEMBLY (CONCENTRATED)	29.16 FT.	<u>L X 4</u> 7	16.66	17	<u>L X 4</u> 7	16.66	17
	107	OUTDOOR DINING	ASSEMBLY (UNCONCENTRATED)	3,254 SQ. FT.	15 NET	216.93	217	15 NET	216.93	217
	EXIST	EXISTING KITCHEN	KITCHEN	1,453 SQ. FT.	200 GROSS	7.27	8	100 GROSS	14.53	15
	EXIST	EXISTING W.I.C.	STORAGE	91 SQ. FT.	300 GROSS	0.30	1	500 GROSS	0.18	1
	EXIST	EXISTING W.I.F.	STORAGE	66 SQ. FT.	300 GROSS	0.22	1	500 GROSS	0.13	1
-	TOTAL # OCCUPANTS 1ST FLOOR						404			413


2nd FLOOR	200	DINING AREA	ASSEMBLY (UNCONCENTRATED)	1,395 SQ. FT.	15 NET	93	93	15 NET	93	93
	201	NORTH DINING AREA	ASSEMBLY (UNCONCENTRATED)	541 SQ. FT.	15 NET	36.06	37	15 NET	36.06	37
	202	BAR SERVICE	KITCHEN	114 SQ. FT.	200 GROSS	0.57	1	100 GROSS	1.14	2
	203	BAR	ASSEMBLY (CONCENTRATED)	17'-2" FT.	<u>L X 4</u> 7	9.8	10	<u>L X 4</u> 7	9.8	10
	204	LOUNGE	ASSEMBLY (UNCONCENTRATED)	148 SQ. FT.	15 NET	9.86	10	15 NET	9.86	10
	205	SOUTH DINING AREA	ASSEMBLY (UNCONCENTRATED)	642 SQ. FT.	15 NET	42.8	43	15 NET	42.8	43
	209	ELEVATOR LOBBY	ASSEMBLY (UNCONCENTRATED)	75 SQ. FT.	15 NET	5	5	15 NET	5	5
	EXIST	EXIST. MECH. ROOM	STORAGE	313 SQ. FT.	300 GROSS	1.04	2	500 GROSS	0.62	1
	EXIST	EXIST. W.I.C. 1	STORAGE	84 SQ. FT.	300 GROSS	0.28	1	500 GROSS	0.16	1
	EXIST	EXIST. W.I.C. 2	STORAGE	89 SQ. FT.	300 GROSS	0.29	1	500 GROSS	0.17	1
	EXIST	KITCHEN	KITCHEN	310 SQ. FT.	200 GROSS	1.55	2	100 GROSS	3.10	4
	EXIST	EXIST. ELECT. ROOM	STORAGE	87 SQ. FT.	300 GROSS	0.29	1	500 GROSS	0.17	1
	EXIST	DISH ROOM	KITCHEN	121 SQ. FT.	200 GROSS	0.61	1	100 GROSS	1.21	2
TC	TOTAL # OCCUPANTS 2ND FLOOR						207			210

TOTAL # OCCUPANTS 1ST & 2ND FLOOR TOTAL S.F. AT 1ST FLOOR = 7,363 S.F. TOTAL S.F. AT 2ND FLOOR = 3,919 S.F.

TOTAL S.F. AT 1ST & 2ND FLOOR = 11,282 S.F.

230 FIRST STREET



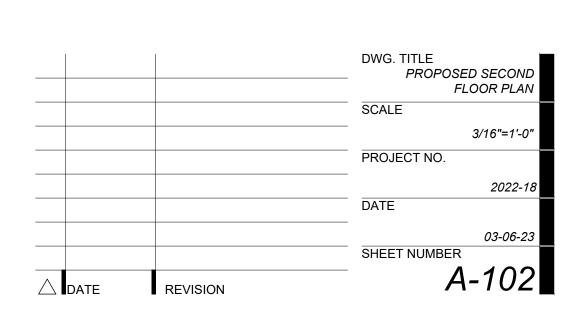

LE JARDIN BOUCHERIE / OMAKASE

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