


1 2 3	4 5 6	7 8	9 10	11	12 13	14	15	16	MIAMIBEACH PLANT DEPARTMENT
		<u> </u>	I	I	ı	ı	·	· · ·	BUILDING DEPARTMENT Reviewed For Compliance
M Tree Sched	dule		Shrub Schedule			Shrub Schedule			BR2106013
Symbol ID Qty Botanical Name Common Name	Cal Height Spread Native Remarks		Common Name Size Height Spread	Spacing Native Remarks	Symbol ID QTY Botanical Name	Common Name Size Heigh		Remarks	03/02/2022 12:02:51 PM
CR 3 Cyrtostachys renda Lipstick Palm -	. 15' N Varied Heights; Triple trunk	Aa 18 Alocasia amazonica 'Polly' Polly		- N -	Hp Hp 278 Heliconia psittocorum	Lady Di 3g 4'	12" - N	-	
DC 5 Dypsis cabadae Cabada Palm 1	10" 12'-17' 15' N Collected Specimen. Multi Trunk with min. 6 stems.	Ac 35 Alocasia odora California Dwarf		- N -	lp 69 Ipomoea pes-caprae	Railroad Vine 1g 12"	36" - Y	-	ARCHITECT INTERIOR DESIGNER LANDSCAPE ARCHITECT
PC 1 Plinia cauliflora Jaboticaba -	- 12' - N Collected Specimen, Multi Stem - Lot Tree	Ao 10 Alcantarea 'Odorata' Bromo		- N -	Lig 4 Licuala Grandis	Ruffled Fan Palm 25g 6'	6' - N	-	LANDSCAPE ARCHITECT
VM 2 Veitchia montgomeryana Montgomery Palm -	- 16'-18' 15' N Varied Heights; Triple trunk	Ci Ci Coton Gold I Calathea 'Indri' Calath		- N Lot Shrub	Nc 15 Neoregelia 'casablanca'	Bromeliad 25g 36"	4' - N	-	
	Groundcover Schedule		inea mun sg m nz	24" Y Lot Shrub	Pg 6 Philodendron giganteum		8' - N	-	TM
K Symbol ID QTY Botanical Name Common against a graph of the state of	Name Size Height Spread Spacing Native Area Remarks Peanut 1g 6" 5" 24" N 94.53	Tionzoniai	contal Cocoplum 7 gal 24" 24" esnake Calathea 3g 15" 12"	24" Y Lot Shrub	Pl 13 Philodendron gloriosum Pn 24 Psychotria nervosa		24" - N	- Lot Chrish	URBAN ROBOT LLC 420 LINCOLN ROAD, S. 600 MIAMI BEACH, FL 33139
bf 101 Bulbine frutescens Bulbine frutescens Bulbine frutescens	ticosa 2g 9" 9" 18" N 15.75 -			- IN -	- Canada		18" - N	Lot Shrub Lot Shrub	T. 786.246.4857 O W N E R :
el 22 Erdonea litoralis Golden Cred	eeper 3g 18" 18" 24" O.C Y 43.05		go i diloii	- N -	Pp Pp 3 Pentas lanceolata Pw Pw 1 Philodendron wilsonii	Egyptian Star Cluster 2g 18" Philodendron 15g 36"	36" - N	Lot Siliub	LUIS FELIPE NEIVA SILVEIRA 28 STAR ISLAND MIAMI BEACH, FL 33139
J fj 128 Farfugium japonicum Leopard Pla	ant 3g 24" 24" N 893.25 -		thea majestica 3g 36" 36"	- IN -	Sbm Sbm 16 Stromanthe 'Burle Marx'		12" - N	-	DESIGN ARCHITECT: SAOTA 109 HATFIELD STREET GARDENS
Ophiopogon japonicus Dwarf Mono (Grass	do 1g 6" 6" N 197.00	Companie a majestica Calati	lilea majestica 3g 30 30	- N Lot Shrub	Submitte Buile Walk Sr S Sr S Serenoa repens	Saw palmetto 3g 12	12 - IN	Lot Shrub	CAPE TOWN 8001, SOUTH AFRICA T: +27 (0)21 468 4400
pb Philodendron 'Burle Marx' 'Burle Marx'	d' 3g 9" 18" N 76.14	CW 5 Colocasia 'white lava' Taro		- N -	Sc S Stromanthe sanguinea	Stromanthe sanguinea	12" - N	Lot official	STRUCTURAL ENGINEER: YHCE ENGINEERING 99 NW 27 AVENUE
ss 128 Stromanthe sanguinea Ctenanthe sanguinea 'Triostar'		20000		- N Lot Shrub	Tg Tg 7 Thunbergia grandiflora	'Tricolor'	4' - N		MIAMI, FL 33125 T: (305) 969-YHCE F: (305) 969-9453 MEP ENGINEER:
Selaginella uncinata Color Color	Ock moss 3g 6" 10" 10" N 222.46		ter Claw 15g 4' 6'	- N -	Tig Tig Tig Till mansorgia granamora	India city vina			CREDO ® Consulting Engineers, LLC 800 EAST BROWARD BLVD., SUITE 601
ts 64 Tradescantia spathacea Oyster Plan	nt 2g 9" 9" 10" N 112.96 -								FORT LAUDERDALE, FL 33301 T: (954) 763-2246 F: (954) 763-2247 CIVIL ENGINEER:
zo - Zoysia Empire	3,157.35 -								OCEAN ENGINEERING INC. 8101 BISCAYNE BLVD., UNITE 508 MIAMI, FL 33138
H Zamia pumila Coontie	7g 24" 24" 18" Y 221.26								T: (786) 518-2008 LIGHTING CONSULTANT: LUX POPULI S.A. de C.V.
									Arteaga 27, San Angel Mexico City, CP 01000, México T: +55 5025 9105
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									URBAN ROBOT LLC AA26002760 IB26001534 LC26000510
B								0	2009 PROJECT NO.
									December 02, 2021
FIRST STORY PLANTING PLAN									DR / JV DRAWN / CHECKED FIRST STORY
A SCALE: 1/16" = 1'-0"								0 8' 16'	PLANTING PLAN
									L201
	4 5 6	7 8	9 10	11	12 13	14	15	16	17

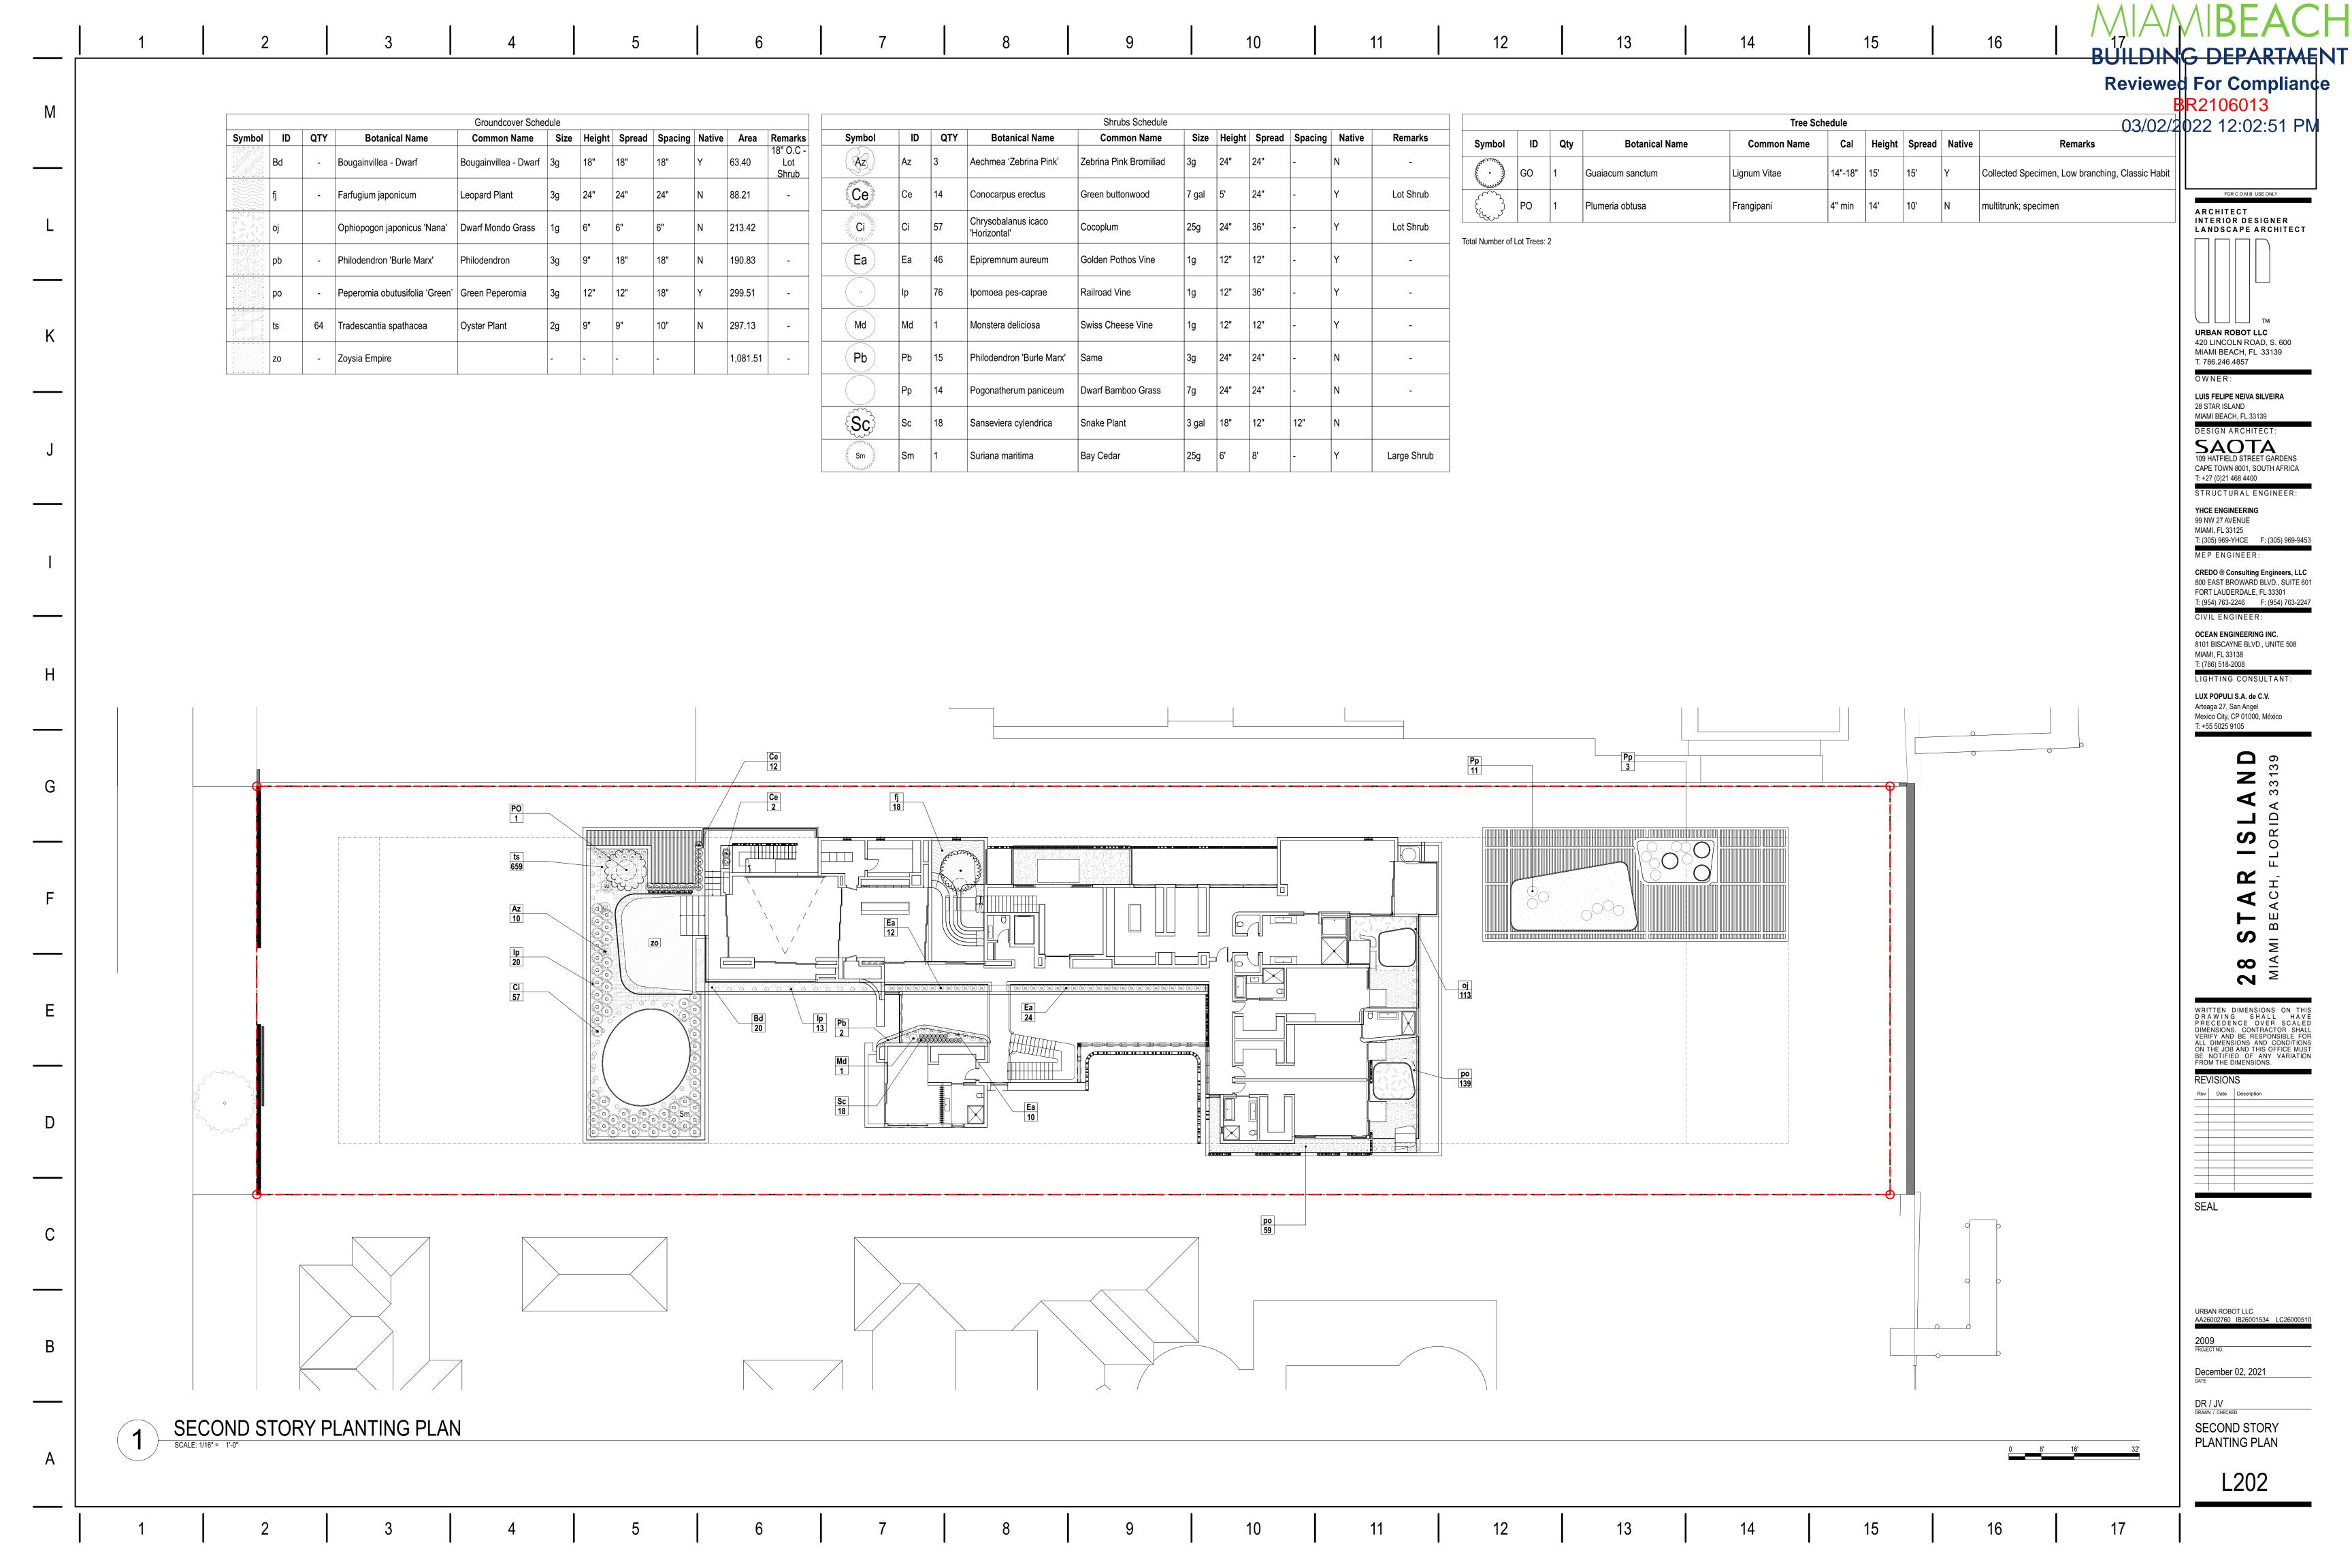

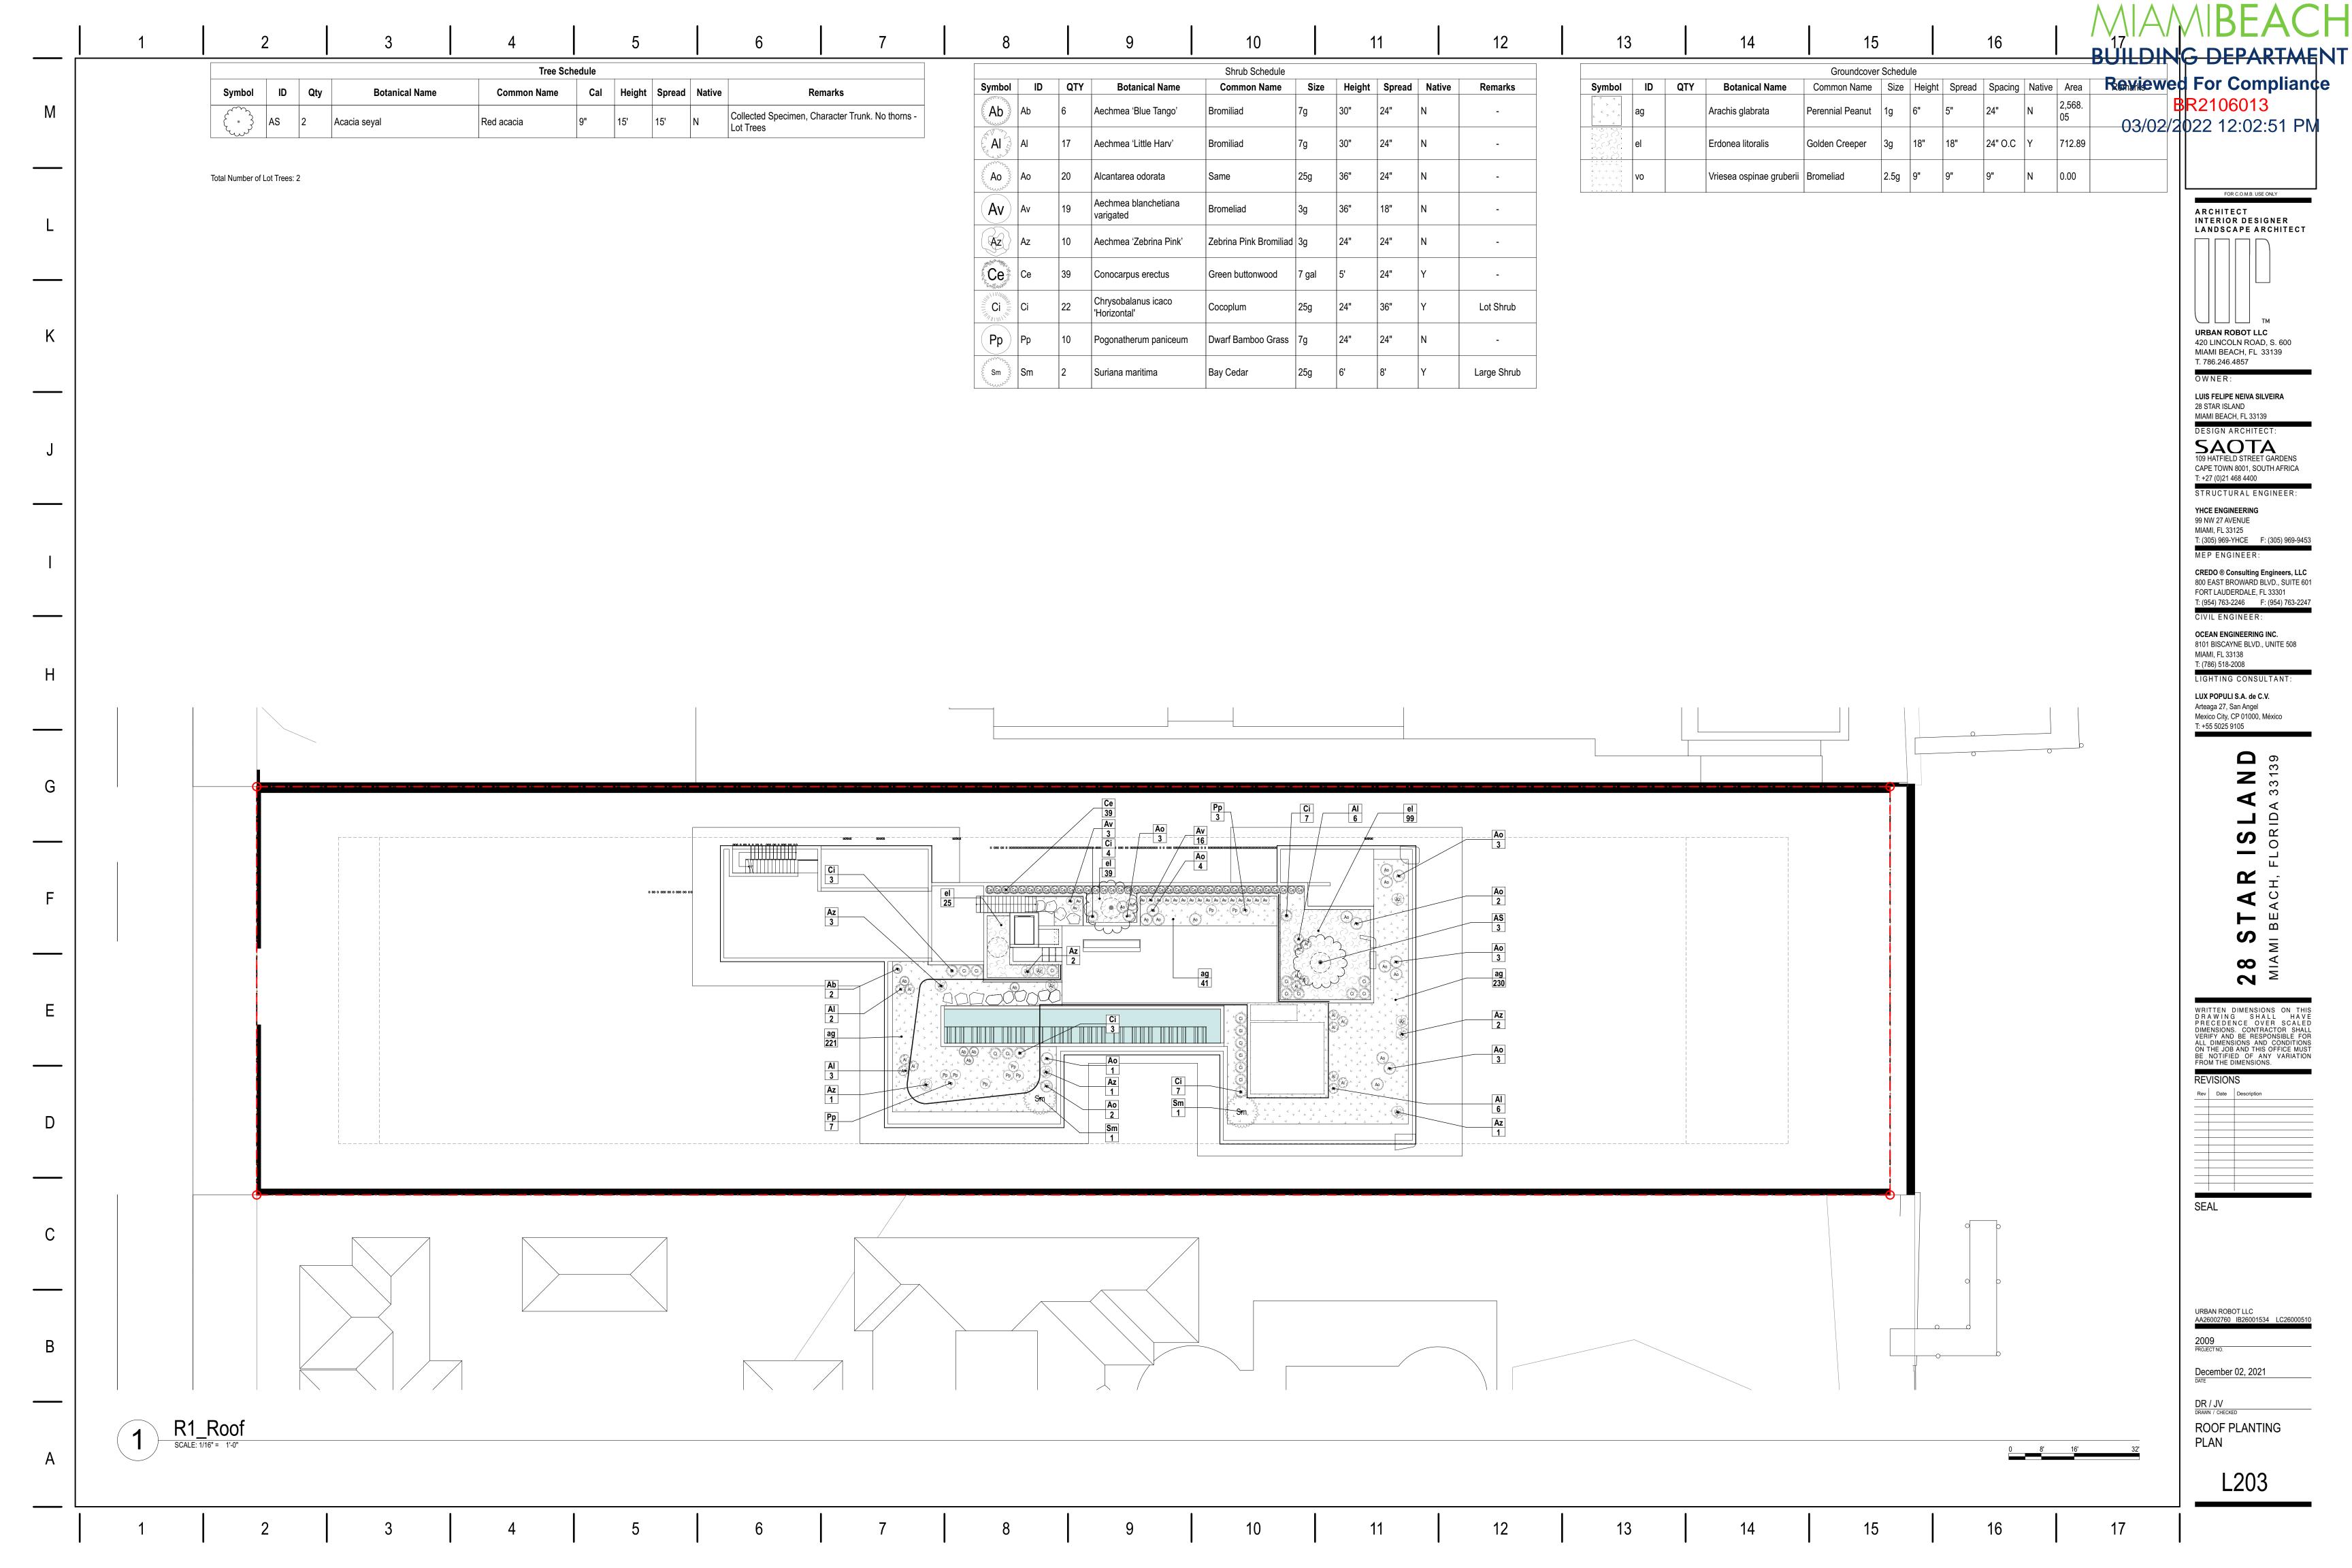



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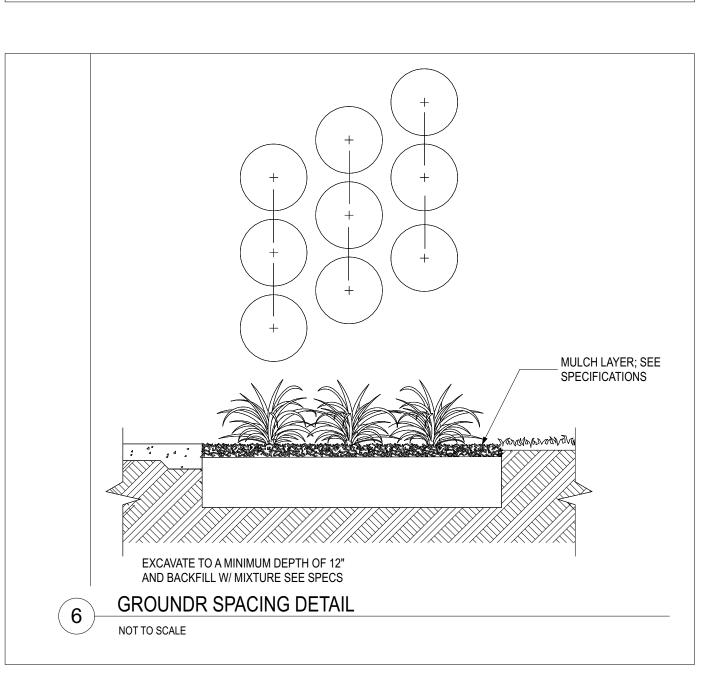
SMALL TREE GUYING DETAIL

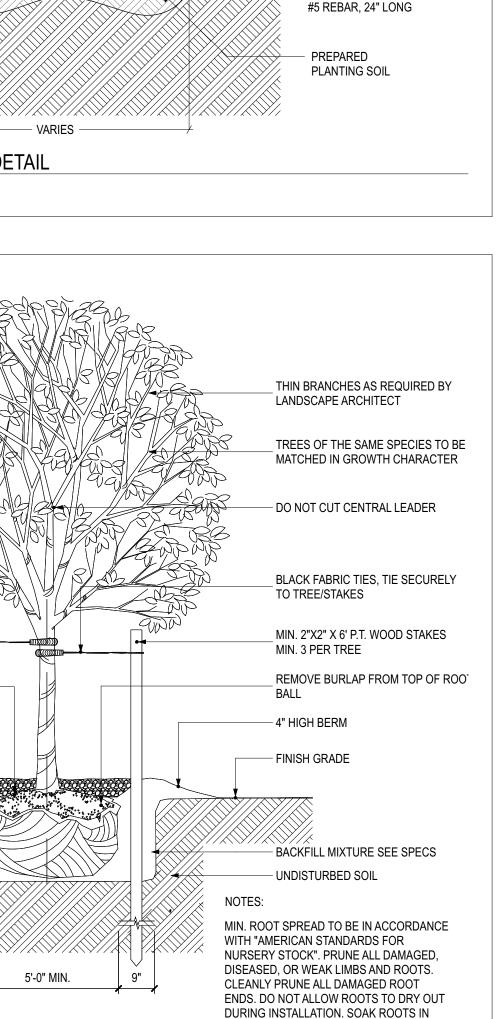


WATER OVERNIGHT BEFORE PLANTING.



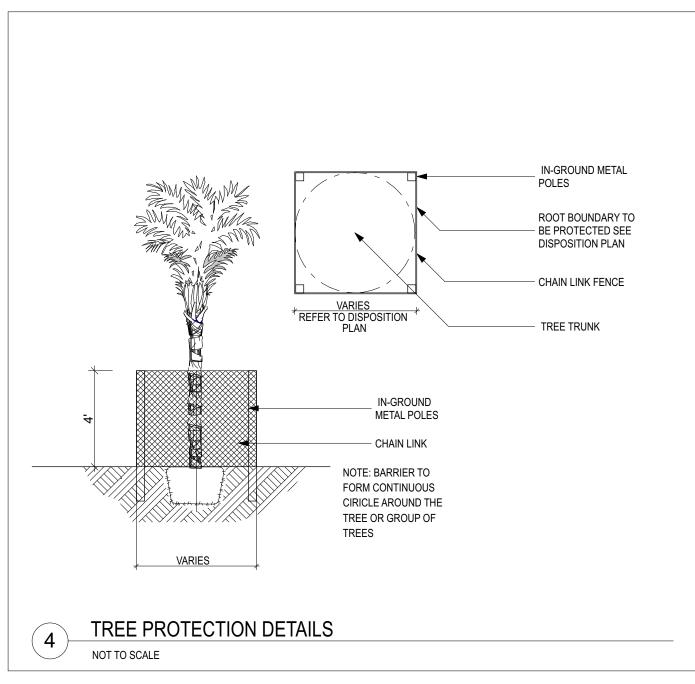

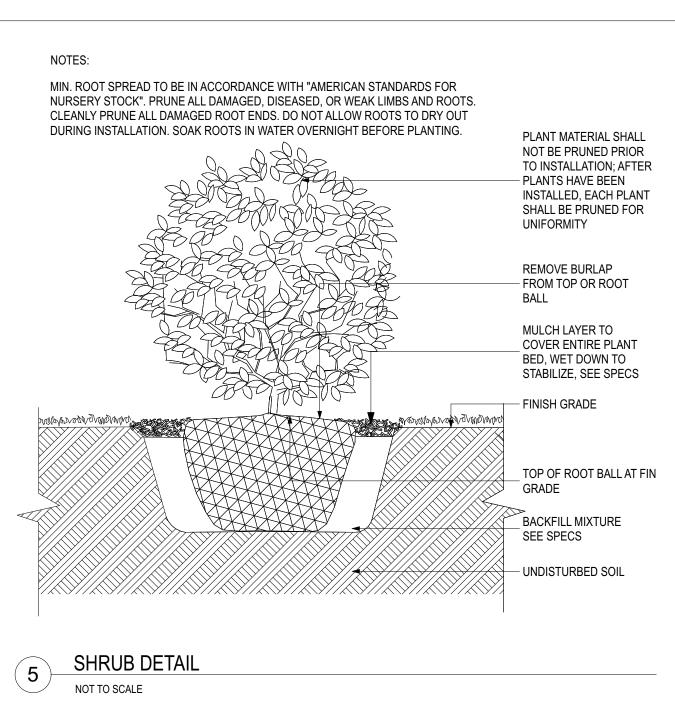

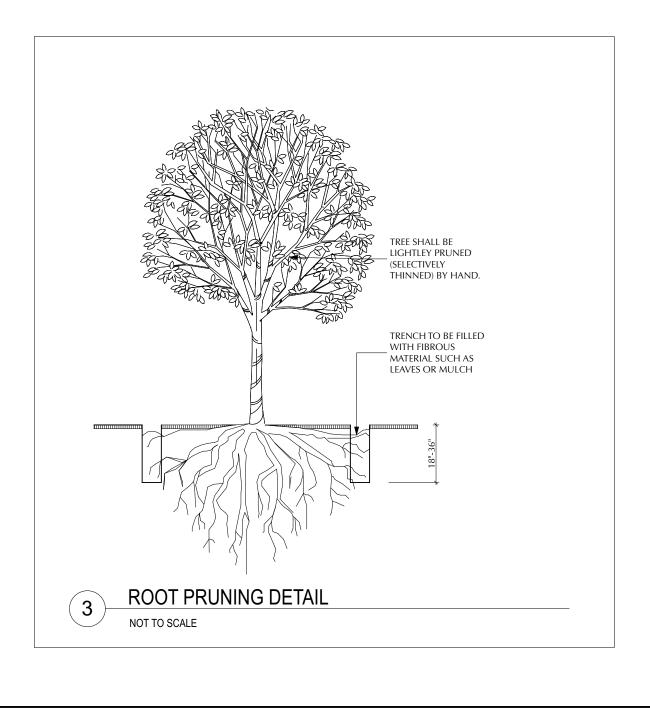

TREE TRANSPLANTING DETAIL

MIN. ROOT SPREAD TO BE IN ACCORDANCE WITH "AMERICAN

STANDARDS FOR NURSERY STOCK"

WEAK LIMBS AND ROOTS. CLEANLY PRUNE ALL DAMAGED ROOT ENDS. DO

NOT ALLOW ROOTS TO DRY OUT DURING INSTALLATION. SOAK ROOTS IN WATER OVERNIGHT BEFORE PLANTING.

THIN BRANCHES AS

DO NOT CUT CENTRAL

4 TURNS BROWN

24" X 2" X 4" BATTEN WITH METAL STRAP OR APP. EQUAL

- 2" X 4" PT WOOD STAKES

MULCH LAYER, SEE SPEC

NAIL BRACES TO 2" X 4" X

3'-0" LONG STAKES, BURY

REMOVE BURLAP FROM

BACKFILL MIXTURE SEE

UNDISTURBED SOIL

SPECS

RIANGLE WOOD

SUPPORT WITH BURLAP

TRANSPLANTING HOLI

SHOULD BE AT LEAST 1/3

THAT WAS TRENCHED

SET THE TREE NO DEEPER

HOLE SHOULD BE FILLED WITH A MIXTURE

ELIMINATE AIR POCKETS WITH THE USE OF

OF GOOD TOPSOIL AND EXISTING SOIL.

HAN IT WAS IN ITS

ORIGINAL GROWING

PROVIDE DISH TO

NAIL AS REQ'D -

1" ABOVE FIN

4" HIGH BERM -

LARGE TREE STAKE DETAIL

TOP PF ROOT BALL

REQUIRED BY LANDSCAPE ARCHITECT PLANTING SPECIFICATIONS

PLANTING SPECIFICATIONS 1. The Contractor is responsible for maintaining, all planting areas (including watering, spraying, mulching, mowing fertilizing, etc.) until the job is accepted, in full, by the Owner and/or Landscape Architect.

2. All root balls shall conform to the size standards set forth in "American Standards for Nursery Stock".

3. All plant material shall be protected during transport and delivery to final location with shade cloth or other acceptable means of windburn prevention.

4. All trees must be guyed or staked as shown in the details.

5. Installation- All plant material shall be installed in a sound, workman- like manner and according to accepted good planting and tree relocation procedures with the quality of plant materials as hereinafter described. All elements of landscaping shall be installed so as to meet all applicable ordinances and code requirements.

6. There shall be no chains or cables used on trees or palms. Handle with two inch (2") minimum width nylon straps or

7. Contractor shall assure drainage and percolation of all planting pits prior to installation of plant material. Contractor shall fill all tree pits with water before planting to assure that proper drainage and percolation is available. Correct if required to assure percolation. Contractor is responsible for replacement of all plants lost due to inadequate drain- age

8. Contractor to request final acceptance of project in writing. If all work is satisfactory and complete in accordance with conditions of contract documents, then the Owner and the Landscape Architect shall declare the project substantially

9. Contractor to replace rejected plant material within one (1) week of written notice.

10. Contractor shall mulch all plant material throughout and completely to a three inch (3") depth of loose, weed free, sterilized Melaleuca mulch.

11. Plant Material which is not installed at the direction of the landscape architect or owner will become the property of the contractor unless it becomes relocated on site. The Contractor shall provide the owner a credit for any plant material not installed on the site.

SOIL PREPARATION AND SOIL MIX

1. All shrub beds shall be provided with a minimum 30" depth of approved planting soil if existing soil is not acceptable to the Landscape Architect. Shrub beds shall be excavated to 30" depth and soil replaced as specified. Acceptable soil composition shall be 70% sand, 30% organic content with an overall pH range between 6.5 and 7.5.

2. Apply Roundup (manufactured by Monsanto Corp. or equal.) according to manufacturer's rate and specification within limits of all areas to be planted. Protect existing plants to remain from overspray or spray within root zone. Contractor to ensure total weed eradication from all areas to be planted.

3. Before replacing topsoil, rake subsoil surface clear of stones (1" diameter and larger), debris, rubbish, and remaining roots from removed plant material.

4. Scarify subsoil to a depth of six inches (6").

6. Planting Soil Mixtures:

5. Contractor to apply "Surflan" or equal, or approved pre-emergent herbicide in accordance with manufacturer's rate and

All plant material on grade with the exception of palms and beach material, shall be planted with the following soil mix: Planting Soil Mixture A: a.) Weed free soil and consist of

70% clean silica sand. 30% everglades muck, and

b.) There must be a slight acidic reaction to the soil with no excess calcium or carbonate. c.) Soil shall be delivered in a loose friable condition.

All palms + beach material on grade shall be planted with the following: Planting Soil Mixture B:

a.) 80% clean sillca sand b.) 20% everglades mack

All elevated planting areas on structure shall be planted with the following unless otherwise approved by L.A Planting Soil Mixture C:

Mix specifically designed to meet project requirements based on climatic region and plant requirements. a.) 50% Coarse Stalite, 5/16" Expanded Aggregate

- b.) 25% Clean Silica Sand
- c.) 10% Pine fines d.) 15% Approved Compost

7. Topsoil shall be natural, fertile, agricultural soil capable of sustaining vigorous plant growth. It shall be of uniform composition throughout, with admixture of subsoil. It shall be free of stones, lumps, live plants an their roots, sticks, and other extraneous matter. Spread topsoil mixture to minimum depth of three inches (3") throughout all lawn areas ...

8. Remove all rocks and other objects over one inches (1") in diameter.

9. Smooth all soil mixture to five inches (5") below top of surrounding pavement edges. This allows room for 3" of mulch and 2" clear space below top of pavement.

10. Smooth topsoil mixture to two inches (2") below finish grade in areas to be sodded.

11. Topsoil shall not be extremely acid or alkaline, nor contain toxic substances which may be harmful to plant growth. The topsoil pH shall be in the range of pH 6.5 to 7.5. If necessary, the Contractor shall apply the appropriate soil amendments adjusting soil pH to assure a pH range of 6.5 to 7.5.

12. Finish grade all topsoil areas to a smooth, even surface, assuring positive drainage away from the structures and eliminate any low areas which may collect water.

13. Contractor shall assure percolation and drainage of all planting pits prior to planting. Contractor will be responsible for all plants lost due to the lack of percolation.

14. Contractor to remove debris and excess material daily from job site. Contractor shall remove all staking of trees and palms after twelve (12) months of substantial completion.

1. Mulch shall be shredded Florimulch (100% Melaleuca mulch). Planting areas not covered by lawn grass/sod shall be mulched to a minimum depth of 3", in order to present a finished appearance.

2. Any other mulch must be must be submitted to and approved.

03/02/2022 12:02:52 PM FOR C.O.M.B. USE ONLY

BUILDING DEPARTMEN

Reviewed For Compliance



URBAN ROBOT LLC 420 LINCOLN ROAD, S. 600 MIAMI BEACH, FL 33139 T. 786.246.4857

LUIS FELIPE NEIVA SILVEIRA 28 STAR ISLAND MIAMI BEACH, FL 33139

SAOTA CAPE TOWN 8001, SOUTH AFRICA T: +27 (0)21 468 4400 STRUCTURAL ENGINEER YHCE ENGINEERING

99 NW 27 AVENUE MIAMI, FL 33125 T: (305) 969-YHCE F: (305) 969-9453 CREDO ® Consulting Engineers, LLC

800 EAST BROWARD BLVD., SUITE 601 FORT LAUDERDALE, FL 33301 T: (954) 763-2246 F: (954) 763-2247 OCEAN ENGINEERING INC.

8101 BISCAYNE BLVD., UNITE 508 MIAMI, FL 33138 T: (786) 518-2008 LUX POPULI S.A. de C.V.

Arteaga 27, San Angel Mexico City, CP 01000, México T: +55 5025 9105

WHITTEN DIMENSIONS ON THIS
DRAWING SHALL HAVE
PRECEDENCE OVER SCALED
DIMENSIONS. CONTRACTOR SHALL
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ALL DIMENSIONS AND CONDITIONS
ON THE JOB AND THIS OFFICE MUST BE NOTIFIED OF ANY VARIATION FROM THE DIMENSIONS.


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WRITTEN DIMENSIONS ON

URBAN ROBOT LLC AA26002760 IB26001534 LC2600051 December 02, 2021

PLANTING DETAILS




BUILDING DEPARTMEN Reviewed For Compliance

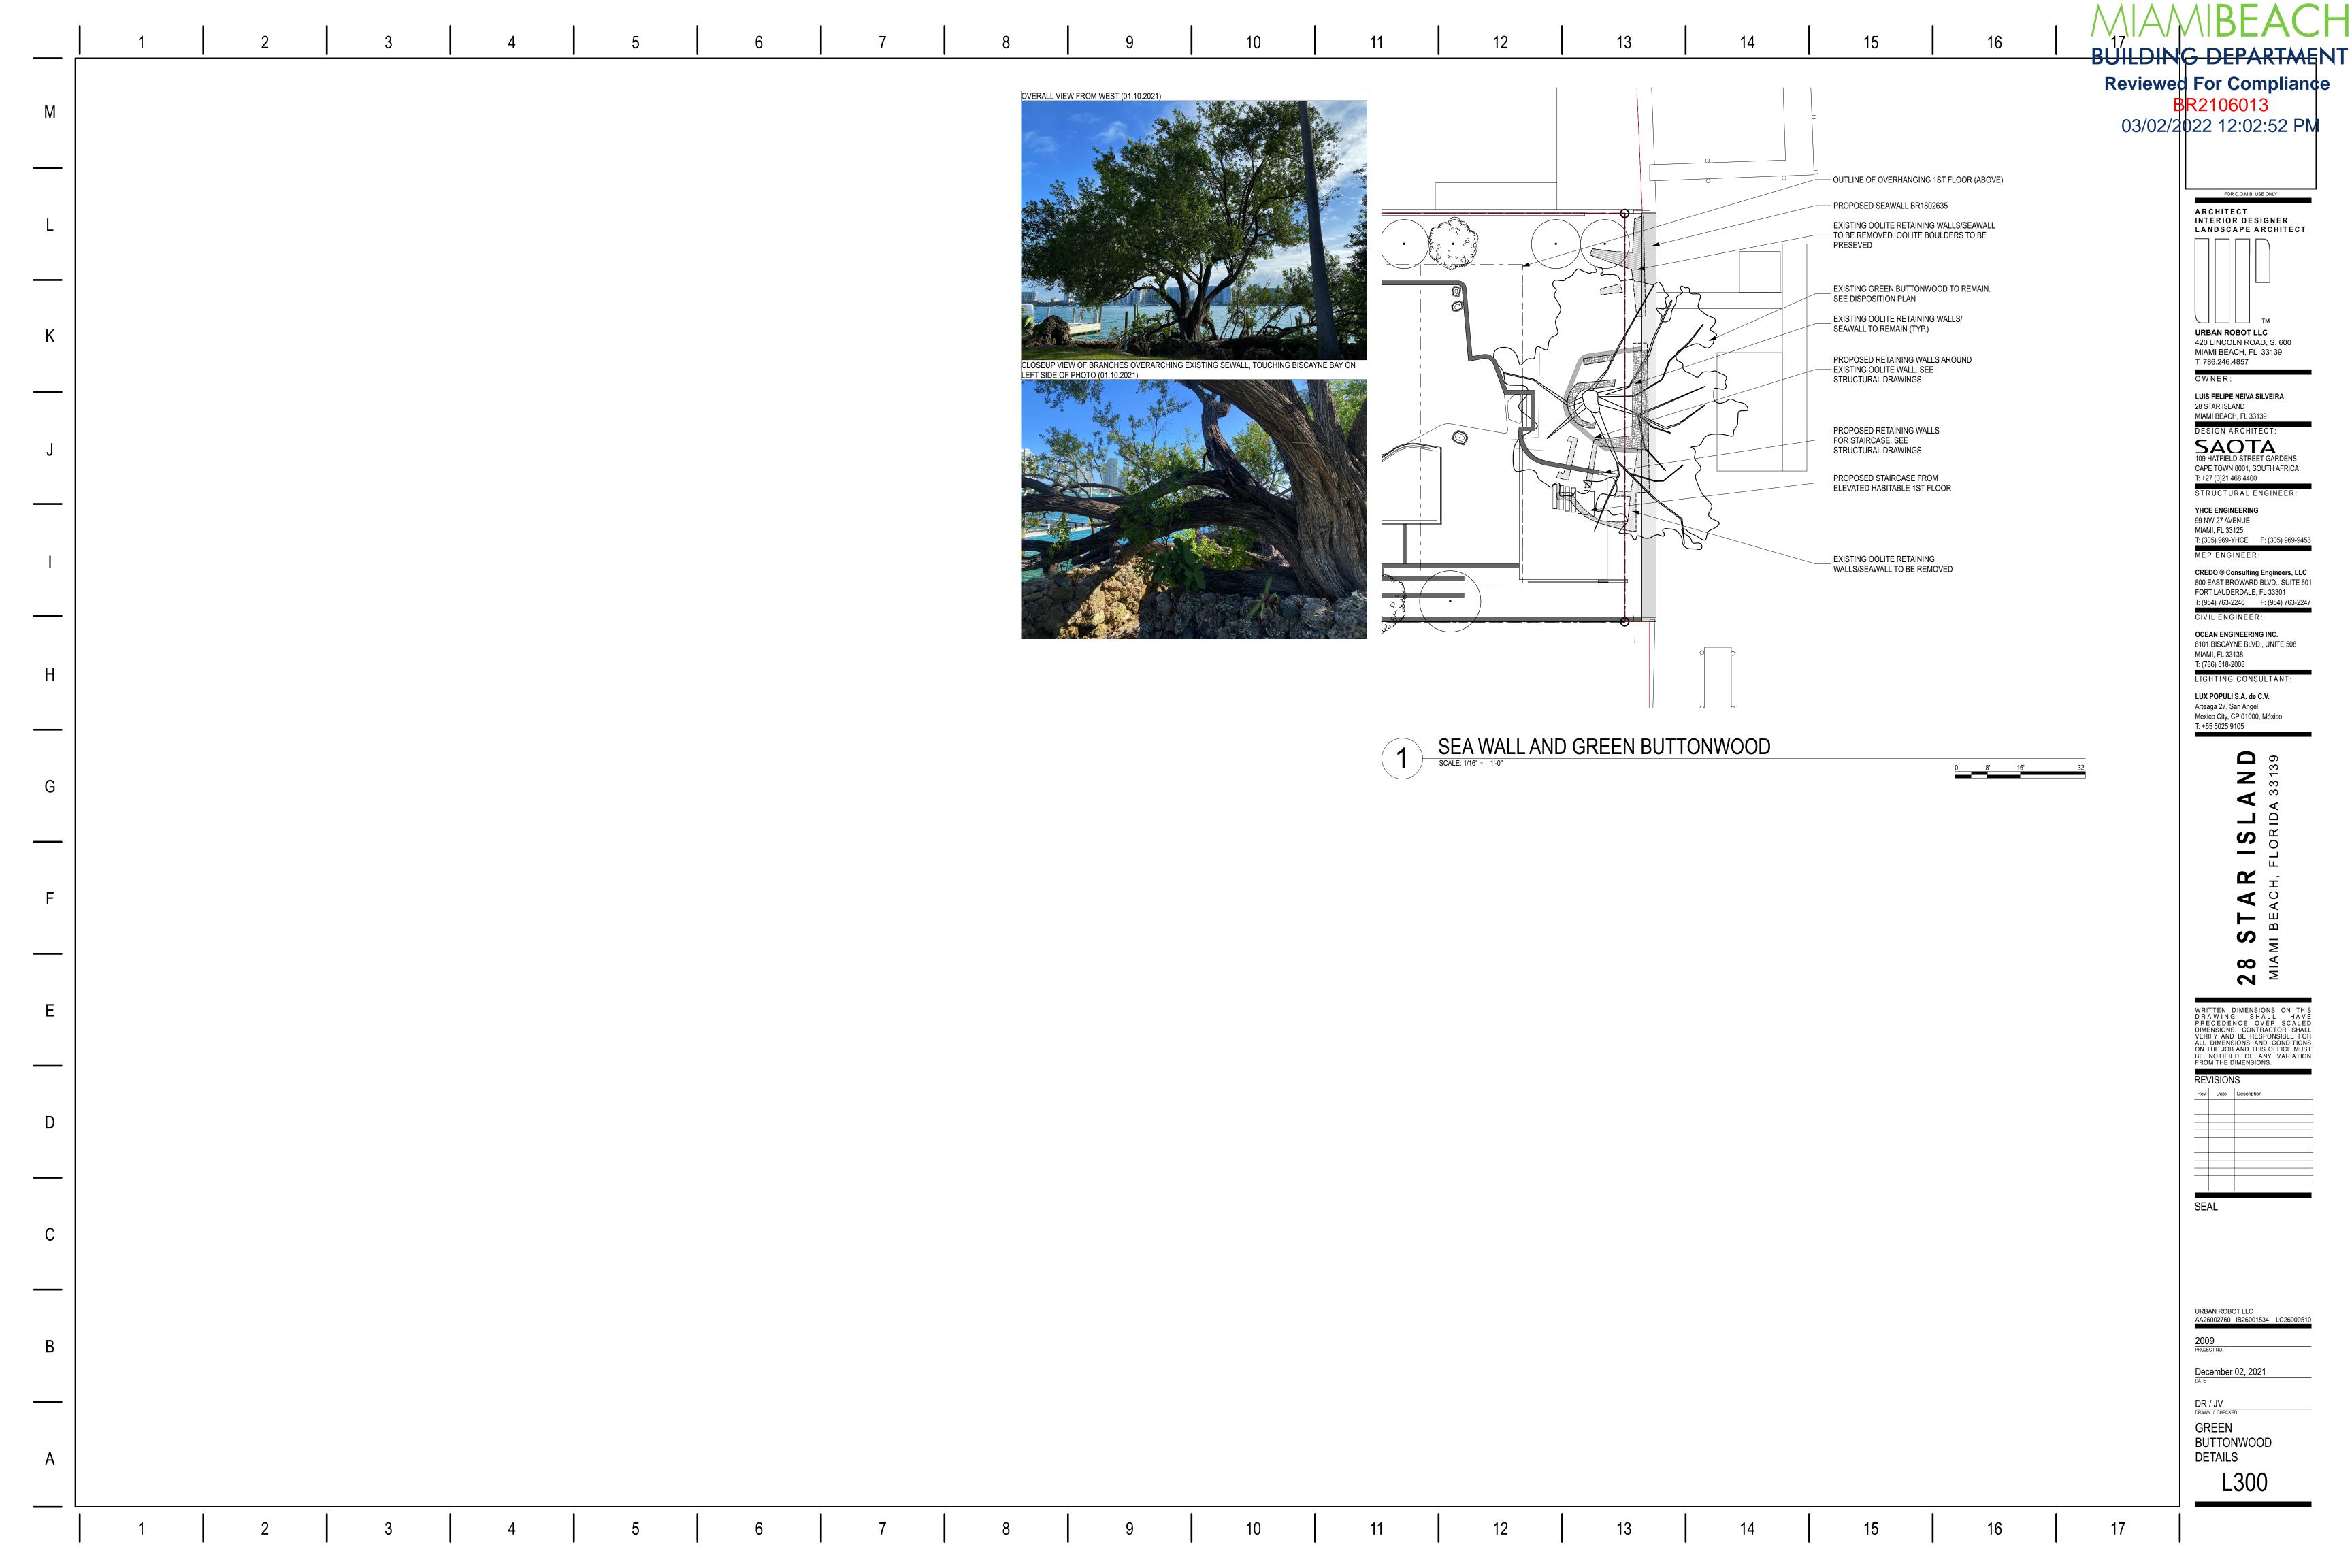BR2106013 PLUMBING DRAWING INDEX 02/2022 12:02:52 PM

#	DESCRIPTION	03/
P001	PLUMBING NOTES, LEGENDS & SYMBOLS	
P100	PLUMBING SITE PLAN	
P101	PLUMBING UNDERSTORY - SANITARY PLAN (A)	
P102	PLUMBING UNDERSTORY - SANITARY PLAN (B)	
P103	PLUMBING UNDERSTORY - SANITARY PLAN (C)	

15

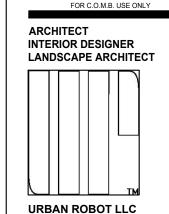

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WRITTEN DIMENSIONS ON THIS DRAWIN SHALL HAVE PRECEDENCE OVER SCALED DIMENSIONS. CONTRACTOR SHALL VERIFY AND BE RESPONSIBLE FOR ALI JOB AND THIS OFFICE MUST BE NOTIFIED ANY VARIATION FROM THI DIMENSIONS.

RT A. SALC No. 49852 STATE OF 1700 M # 19852

September 24, 2021

CONSULTING ENGINEERS, LLC

800 E. BROWARD BLVD, S.601, FT. LAUDERDALE, FL33301 T.(954) 763-2246 P.M. IRINA GOLDENBERG JOB #210103

DESIGN with CONFIDENCE

KEY PLAN

P104 | PLUMBING UNDERSTORY - SANITARY PLAN (D)

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DRAWN / CHECKED PLUMBING NOTES, LEGENDS & SYMBOLS

