

# C.M.B. LANDSCAPE FINAL DRB SUBMITTAL 12.12.22 NEW MIXED USE RESIDENTIAL | 6940 ABBOTT AVE | MIAMI BEACH, FLORIDA

CHRISTOPHER CAWLEY LANDSCAPE **ARCHITECTURE** 

#### 780 NE 69TH STREET SUITE 200 MIAMI, FL 33138 O 786.536.2961 C 305.979.1585 CHRISTOPHERCAWLEY.COM Florida Landscape Architecture Business LLC 26000460

**REVISION SCHEDULE:** SHEET OF INDEX L0-00 LANDSCAPE COVER + SHEET INDEX L1-00 EXISTING TREE SURVEY + DISPOSITION PLAN L1-00 EXISTING TREE SURVEY + DISPOSITION PLAN L1-01 EXISTING TREE CHART, MITIGATION SUMMARY + NOTES L2-00 GROUND LEVEL HARDSCAPE PLAN L2-01 HARDSCAPE MATERIALS + DETAILS L3-00 GROUND LEVEL LANDSCAPE PLAN L3-01 FOURTH LEVEL LANDSCAPE PLAN L3-02 ROOF LEVEL LANDSCAPE PLAN L4-00 PLANT LIST, LANDSCAPE DETAILS + NOTES L4-01 PLANT MATERIAL IMAGES CLIENT / PROPERTY INFORMATION PROPERTY ADDRESS 6940 ABBOTT AVE, MIAMI BEACH, FLORIDA 33141 PROJECT INFO: SCOPE OF WORK NEW LANDSCAPE TO COMPLIMENT NEW MIXED USE RESIDENTIAL MIAMI BEACH LANDSCAPE LEGEND Ζ Ш CITY OF MIAMI BEACH SID LANDSCAPE LEGEND INFORMATION REQUIRED TO BE PERMANENTLY AFFIXED TO PLANS Zoning District\_<u>TC-C</u>Lot Area <u>25,000</u>\_\_\_\_ Acres\_.57 REQUIRED/ Ш OPEN SPACE ALLOWED PROVIDED A. Square feet of required Open Space as indicated on site plan: R Lot Area = <u>25,000</u> s.f.x <u>20</u> % = <u>5,000</u> s.f. 5,000 SF 5,000 SF B. Square feet of parking lot open space required as indicated on site plan: Number of parking spaces \_\_\_\_\_\_ x 10 s.f. parking space = C. Total square feet of landscaped open space required: A+B= \_\_\_\_ N/A AMI LAWN AREA CALCULATION 5,000 SF 5,000 SF 1,000 SF 37 SF A. Square feet of landscaped open space required B. Maximum lawn area (sod) permitted= 20 % x5,000 s.f. L TREES A. Number of trees required per lot or net lot acre, less existing number of trees meeting minimum requirement <u>13 TREES</u> <u>13 TREES</u> 5 GROUND LEVEL <u>4 TREES</u> <u>4 TREES</u> 8 UPPER LEVEL 22 trees x .57 net lot acres - number of existing trees= ш B. % Natives required: Number of trees provided x 30% = C. % Low maintenance / drought and salt tolerant required: S <u>8 TREES</u> 8 TREES Number of trees provided x 50%= D. Street Trees (maximum average spacing of 20' o.c.) 5 TREES 3 TREES <u>100 LF</u> linear feet along street divided by 20'= E. Street tree species allowed directly beneath power lines: MIXED (maximum average spacing of 20' o.c.): <u>100 LF</u> linear feet along street divided by 20'= 5 TREES 1 TREE **SHRUBS** 

276 138

347

A. Number of shrubs required: Sum of lot and street trees required x 12=

A. Number of large shrubs or small trees required: Number of required shrubs


B. % Native large shrubs or small trees required: Number of large shrubs or

B. % Native shrubs required: Number of shrubs provided x 50%=

LARGE SHRUBS OR SMALL TREES

small trees provided x 50%=

x 10%=

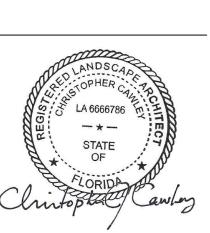


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## CHRISTOPHER CAWLEY, RLA Florida License LA 6666786

DATE: DECEMBER 12, 2022 SHEET NO:



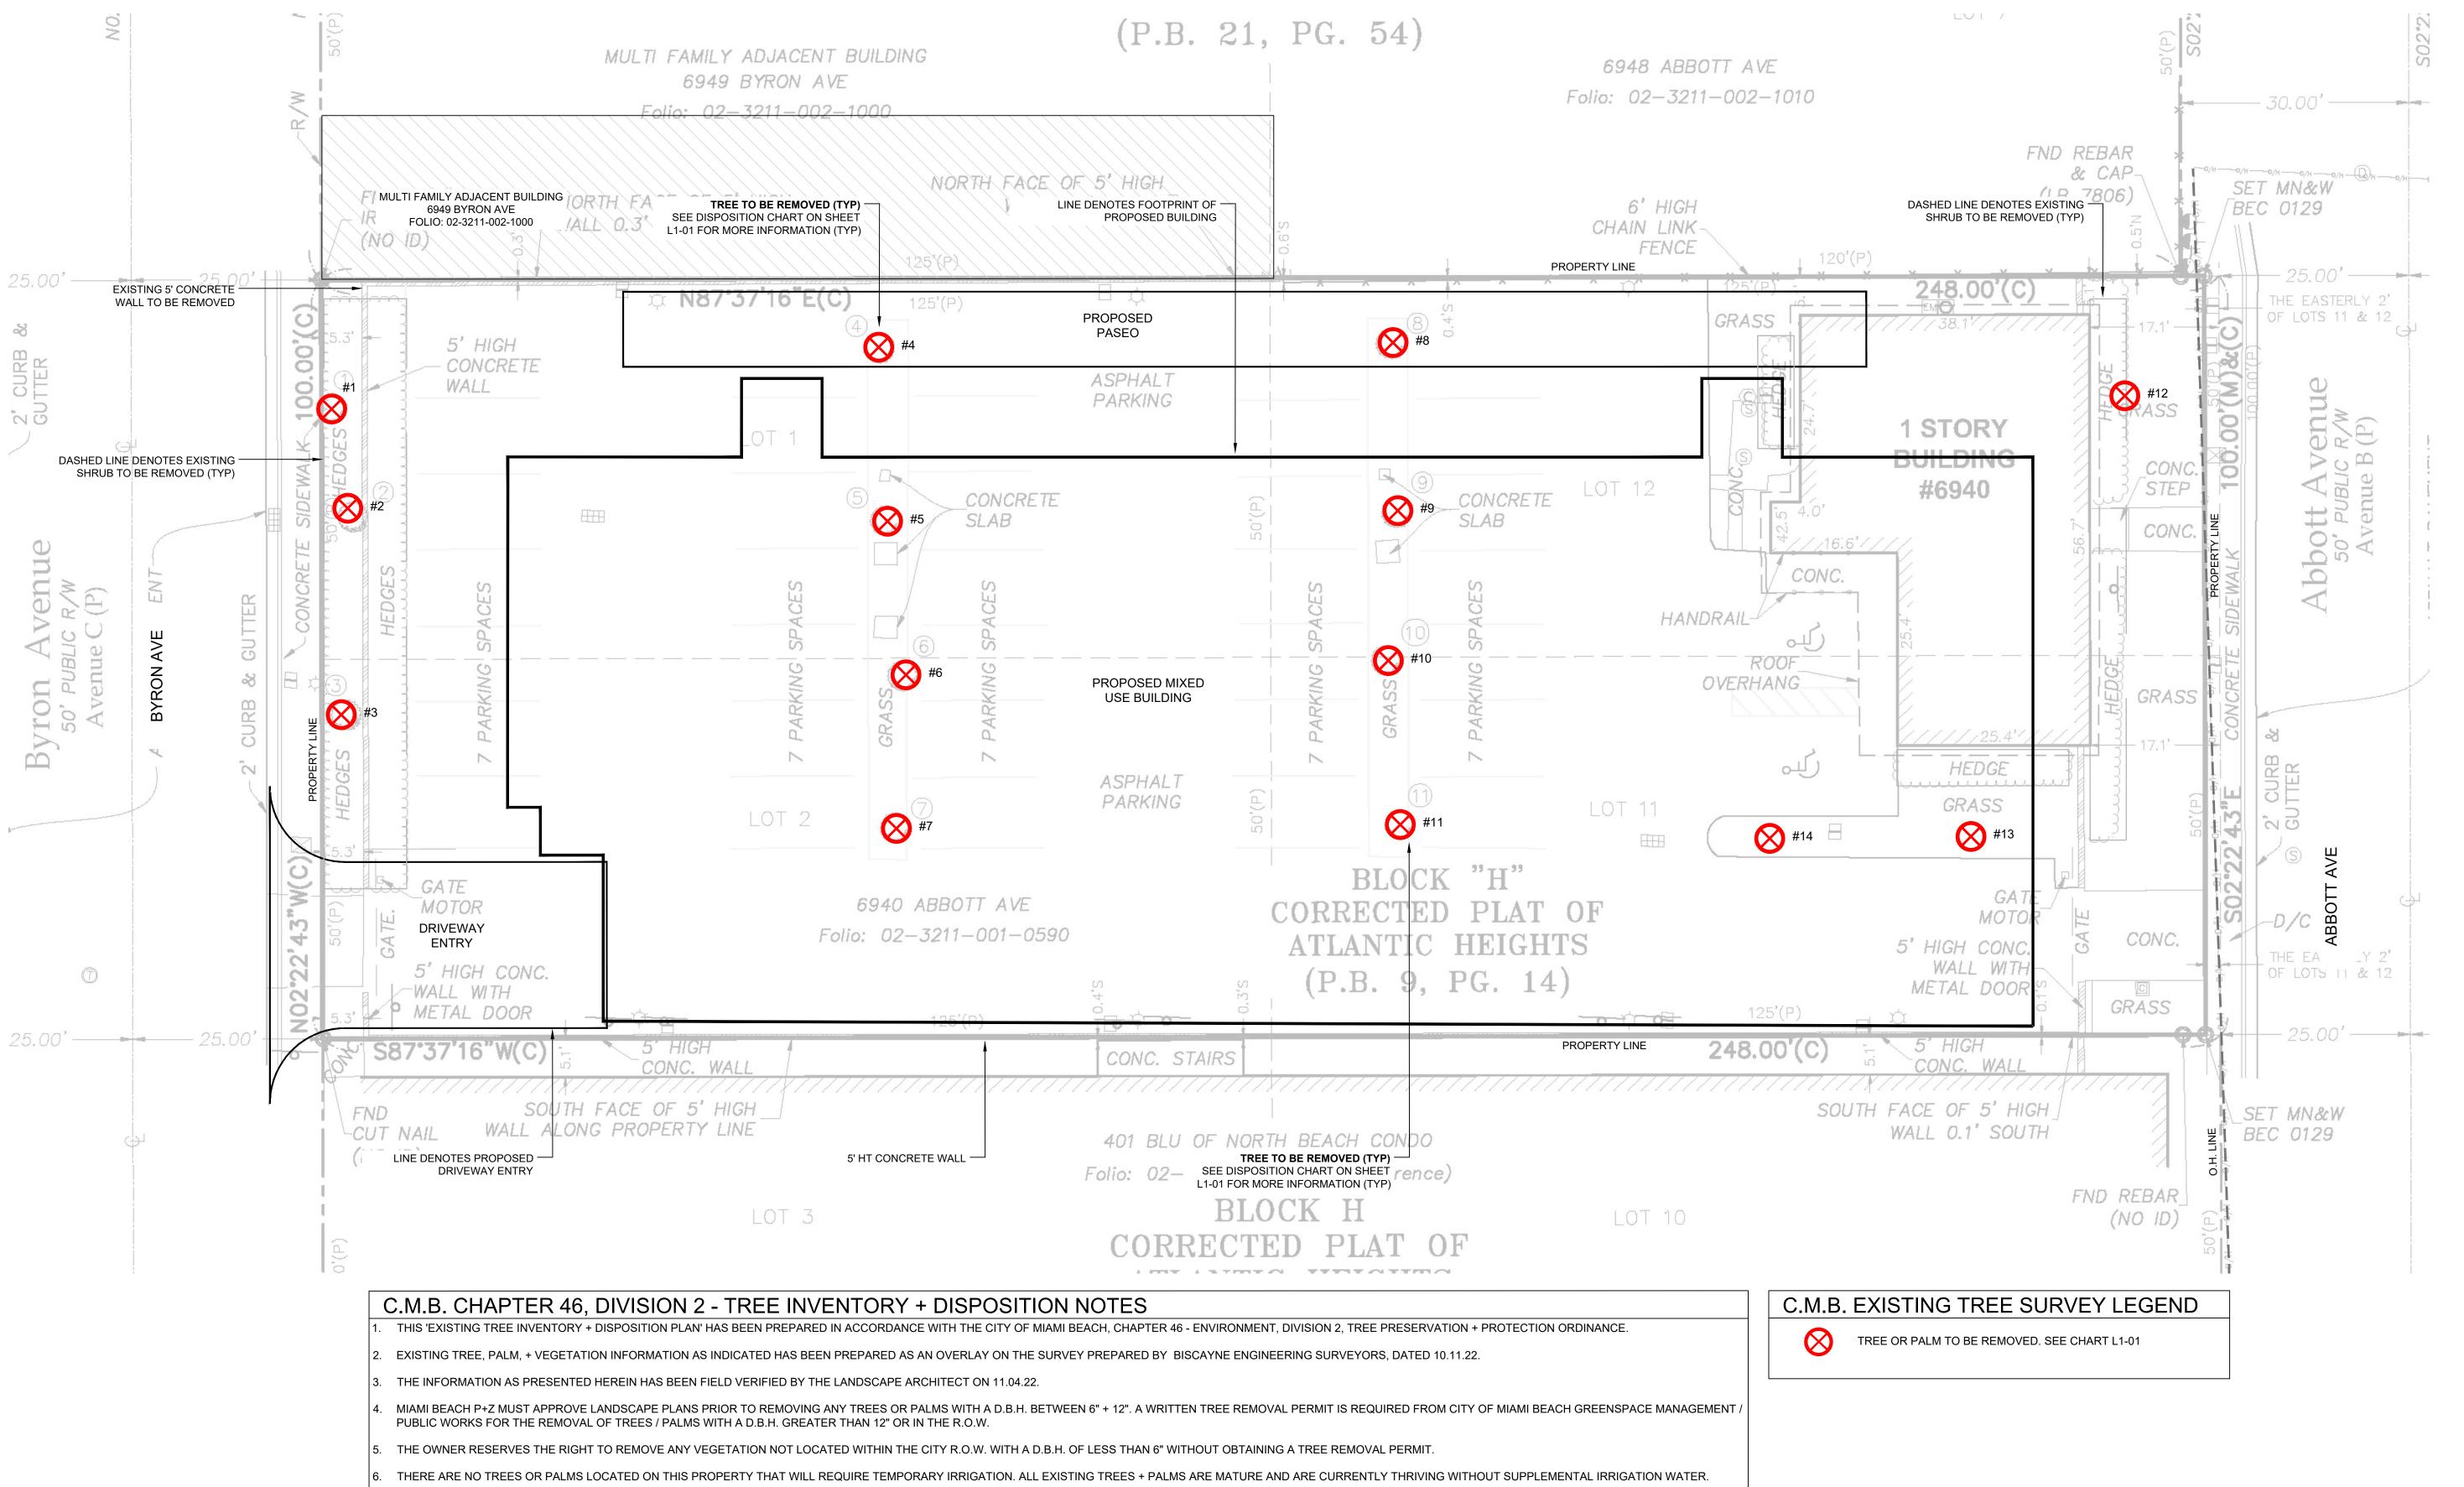

CHRISTOPHER CAWLEY LANDSCAPE ARCHITECTURE

> 780 NE 69TH STREET SUITE 200 MIAMI, FL 33138 O 786.536.2961 C 305.979.1585 CHRISTOPHERCAWLEY.COM Florida Landscape Architecture Business LLC 26000460

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DATE: **DECEMBER 12, 2022** SHEET NO:

L1-00

EXISTING TREE SURVEY + DISPOSITION PLAN 3/32" = 1'-0"



C.M.B.EXISTING TREE INVENTORY + DISPOSITION CHA						
NUMBER	COMMON NAME	BOTANICAL NAME	SPECIMEN	HT (FT)	SP (FT)	D.B.H (IN
1	WHITE TRUMPET	Tabebuia bahamensis	YES	23'	25'	12"
2	WHITE TRUMPET	Tabebuia bahamensis	NO	18'	18'	10"
3	WHITE TRUMPET	Tabebuia bahamensis	YES	23'	20'	12"
4	GUMBO LIMBO	Bursera simaruba	YES	15'	20'	12"
5	GUMBO LIMBO	Bursera simaruba	YES	15'	18'	12"
6	GUMBO LIMBO	Bursera simaruba	YES	15'	18'	12"
7	GUMBO LIMBO	Bursera simaruba	YES	18'	18'	12"
8	GUMBO LIMBO	Bursera simaruba	YES	18'	18'	14"
9	GUMBO LIMBO	Bursera simaruba	NO	10'	14'	10"
10	GUMBO LIMBO	Bursera simaruba	YES	18'	18'	14"
11	GUMBO LIMBO	Bursera simaruba	YES	18'	14'	12"
12	MAHOGANY	Swietenia mahagoni	YES	22'	18'	12"
13	GUMBO LIMBO	Bursera simaruba	YES	15'	15'	10"
14	GUMBO LIMBO	Bursera simaruba	YES	15'	15'	10"

TREE MITIGATION REQUIRED: (56) REPLACEMENT TREES @ 12' HT x 2" D.B.H. x 6' SP

TREE + PALM MITIGATION SUMMARY						
CH 46 TREE PRESERVATION + PROTECTION						
MIAMI BEACH LANDSCAPE ORDINAN	ICE CHAPTER 46 ENVIORNMENT					
TREES						
REMOVED (TOTAL DBH OF TREES)	REPLACEMENT TREES REQ.	REPLACEMENT TREES PROVIDED				
164" OF DBH	56 @ 12' HT + 2" DBH + 6' SP	37 REPLACEMENT TREES PROVIDE				
	OR	BREAKDOWN:				
	28 @ 16' HT + 4" DBH + 8' SP	<ul> <li>(3) BRIDAL VEIL TREES @ 22' HT</li> <li>(1) BRIDAL VEIL TREE @ 16' HT +</li> <li>(5) NATIVE WILD TAMARIND TREE</li> <li>(2) NATIVE LIGNUM VITAE TREES</li> <li>(9) NATIVE SIMPSON STOPPER T</li> </ul>				



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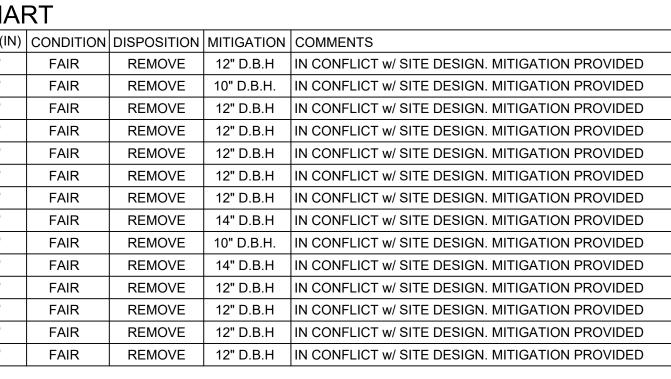




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DECEMBER	12,	2022
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L1-01



TOTAL TREE DBH LOSS: 164"

37 REPLACEMENT TREES PROVIDED @ 12' HT' + 2" DBH + 6' SP

### BREAKDOWN:


(3) BRIDAL VEIL TREES @ 22' HT + 6" DBH + 12' SP = 9 REPLACEMENT TREES

- (1) BRIDAL VEIL TREE @ 16' HT + 4" DBH + 10' SP = 2 REPLACEMENT TREES (5) NATIVE WILD TAMARIND TREES @ 20' HT + 6" DBH + 10' SP = **15 REPLACEMENT TREES**
- (2) NATIVE LIGNUM VITAE TREES @ 14' HT + 3" DBH + 8' SP = 2 REPLACEMENT TREES
  (9) NATIVE SIMPSON STOPPER TREES @ 12' HT + 2" DBH + 6' SP = 9 REPLACEMENT TREES

(9)	NATIVE SIMPSON STOPPER I	REES @ 12' HT + 2	2" DBH + 6' SP = 9	REPLACEMEN

TREE DISPOSITION SUMMARY						
	TOTAL	REMAIN	REMOVE	RELOCATE		
TREES	14	0	14	0		
PALMS	0	0	0	0		

CURRENT SHORTFALL OF 19 TREES @ 12' HT, 6' SP, 2" DBH\*

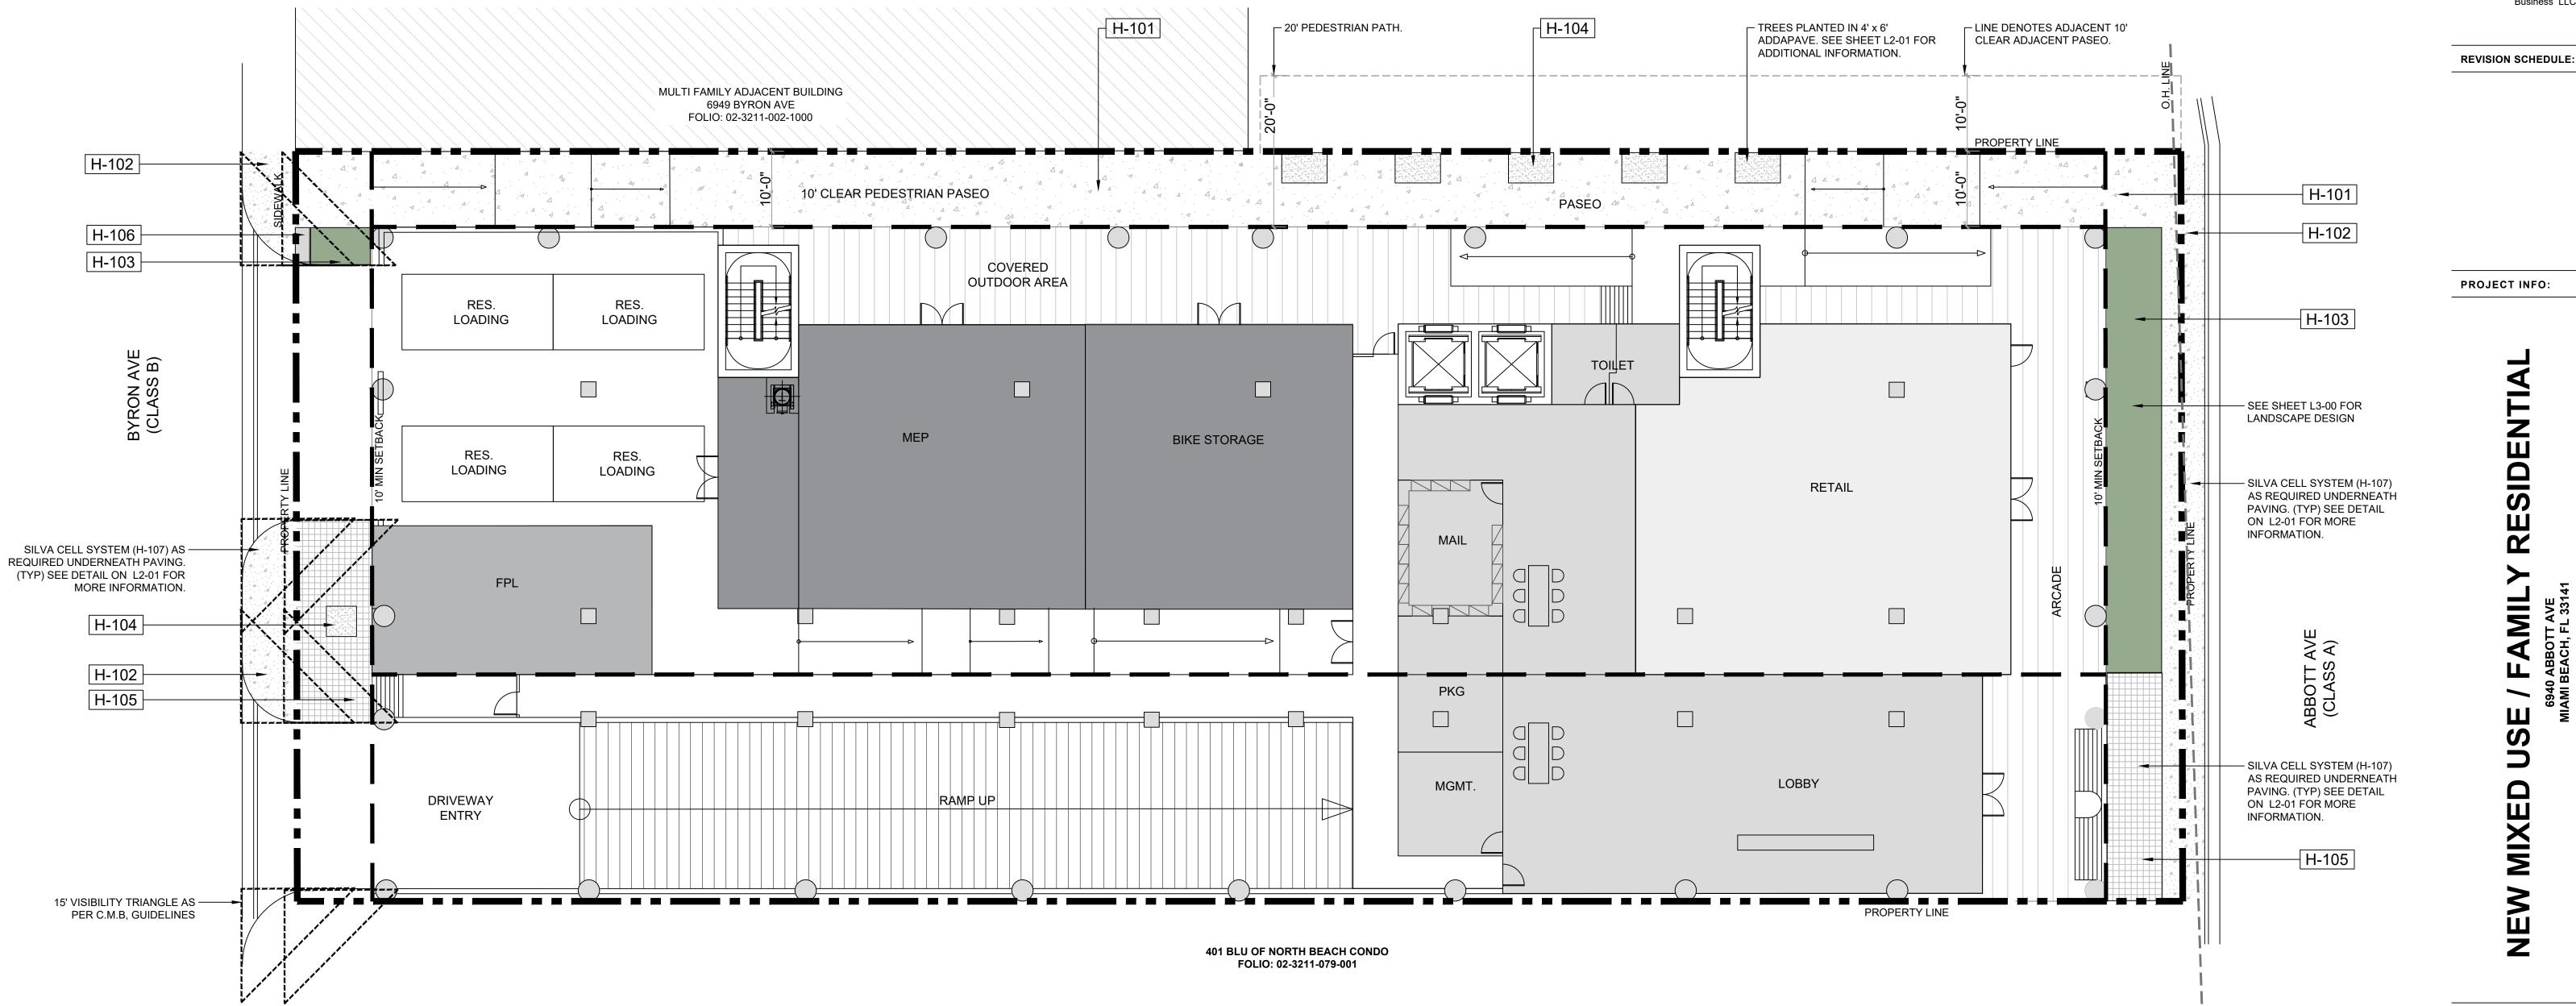

## HARDSCAPE LEGEND

	MATERIALS	
SYMBOL	DESCRIPTION	<u>QTY</u>
H-101	CONCRETE - ROCK SALT FINISH	2,299 SF
H-102	CMB `RED` POURED IN PLACE CONCRETE.	774 SF
H-103	PLANTING AREA (TYP)	473 SF
H-104	ADDAPAVE	136 SF
H-105	GRANITE 4"X4" PAVERS.	464 SF
H-106	EMPIRE TURF ZOYSIA GRASS - OVER 2" TOPSOIL BED	9 SF
H-109	UNIT PAVER W/ SHELLSTONE 12"X12"	7,111 SF



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OTT AVE 331 31, FL 331



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STATE

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GROUND LEVEL HARDSCAPE MATERIAL PLAN 3/32" = 1'-0" 0' 10' 20' 30'



# HARDSCAPE MATERIALS



H-101 | CONCRETE - ROCK SALT FINISH MATERIAL CONCRETE LOCATION: SIDEWALK COLOR: FINISH: SIZE: GREY NON-SLIP ROCK SALT FINISH 2,299 SF MANUFACTURER: TBD SPECIFICATION: AS PER MANUFACTURER



### H-105 | GRANITE 4" x 4" PAVERS LOCATION: COLOR: FINISH:

SIZE: MANUFACTURER: SPECIFICATION:

SIDEWALK / ENTRY GREY / GRANITE NON -SLIP 464 SF TBD AS PER MANUFACTURER



### H-109 | UNIT PAVERS ON SLAB

LOCATION: COLOR: FINISH: SIZE: MANUFACTURER: SPECIFICATION:

ROOF DECK TAN SHELLSTONE FINISH 7,111 SF TBD AS PER MANUFACTURER



### H-102 | CMB SIDEWALK MATERIAL LOCATION: COLOR: SIZE: MANUFACTURER: TBD SPECIFICATION:


CONCRETE SIDEWALK ADJACENT TO THE STREET RED. AS PER CMB. 774 SF AS PER MANUFACTURER





#### 01-06 | EMPIRE TURF ZOYSIA GRASS LOCATION: BYRON AVE 9 SF SIZE: MANUFACTURER: TBD SPECIFICATION: AS PER MANUFACTURER



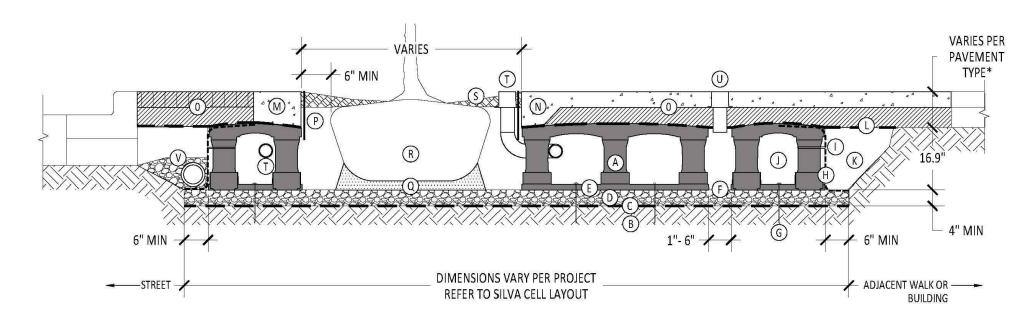

#### SILVA CELL SYSTEM 1X NOT TO SCALE

### KEY PLAN

(A) SILVA CELL SYSTEM (DECK, BASE, AND POSTS)

(B) SUBGRADE, COMPACTED

C GEOTEXTILE FABRIC, PLACED ABOVE SUBGRADE

(D) 4" MIN AGGREGATE SUB BASE, COMPACTED TO 95% PROCTOR

(E) SILVA CELL BASE SLOPE, 10% MAX

(F) 1" TO 6" SPACING BETWEEN SILVA CELLS AT BASE

G ANCHORING SPIKES, CONTACT DEEPROOT FOR ALTERNATIVE

(H) GEOGRID, WRAPPED AROUND PERIMETER OF SYSTEM, WITH 6" TOE (OUTWARD FROM BASE) AND 12" EXCESS (OVER TOP OF DECK)

CABLE TIE, ATTACHING GEOGRID TO SILVA CELL AT BASE OF UPPER LEG FLARE, AS NEEDED

D PLANTING SOIL, PER PROJECT SPECIFICATIONS, PLACED IN LIFTS AND WALK-IN COMPACTED TO 75-85% PROCTOR

(K) COMPACTED BACKFILL, PER PROJECT SPECIFICATIONS

(L) GEOTEXTILE FABRIC TO EDGE OF EXCAVATION

(M) RIBBON CURB AT TREE OPENING (TO BE USED WITH PAVERS OR ASPHALT) (N) THICKENED EDGE AT TREE OPENING (TO BE USED WITH CONCRETE)

O PAVEMENT AND AGGREGATE BASE PER PROJECT \*

	ROFIL	E OPTIONS TO MEET H-20 LOADIN
PAVEMENT	+ AG(	GREGATE BASE COURSE
4" CONCRETE	+ 4"	AGGREGATE
3" PAVER	+ 12"	AGGREGATE
4" ASPHALT	+ 12"	AGGREGATE
2.6" PAVER	+ 5"	CONCRETE

#### (P) DEEPROOT ROOT BARRIER, 12" OR 18", DEPTH DETERMINED BY THICKNESS OF PAVEMENT SECTION, INSTALL DIRECTLY ADJACENT TO CONCRETE EDGE RESTRAINT

(Q) PLANTING SOIL BELOW ROOT BALL, COMPACTED WELL TO PREVENT SETTLING (R) ROOT BALL

(S) TREE OPENING TREATMENT, PER PROJECT SPECIFICATIONS

T DEEPROOT WATER AND AIR VENT, ROOTBALL, WHEN REQUIRED U DEEPROOT WATER AND AIR VENT, WHEN REQUIRED

(V) UNDERDRAIN SYSTEM, WHEN REQUIRED (LOCATION AND DETAILS BY OTHERS)

NOTES

1. EXCAVATION SHALL BE DONE IN ACCORDANCE WITH ALL APPLICABLE HEALTH AND SAFETY REGULATIONS INSTALLATION TO BE COMPLETED IN ACCORDANCE WITH MANUFACTURER'S SPECIFICATIONS

PROVIDE SUPPLEMENTAL IRRIGATION 4. DO NOT SCALE DRAWINGS



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PROJECT INFO:

01-07 | SILVA CELL SYSTEM

MATERIAL: SILVA CELLS MODULAR SUSPENDED PAVEMENT SYSTEM ALL PAVEMENTS AT GROUND FLOOR LOCATION: MANUFACTURER: DEEPROOT SPECIFICATION: AS PER MANUFACTURERS

TREES w/IN PASEO

AS PER MANUFACTURER

GREY


TBD 136 SF

TBD






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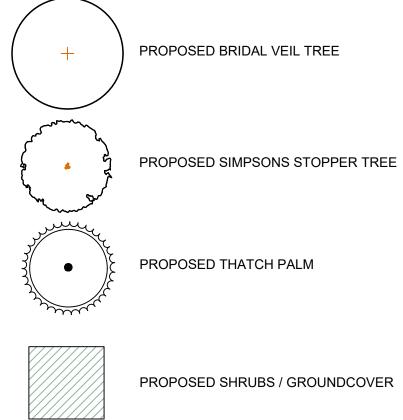


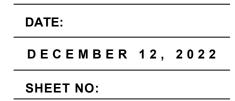


# HARDSCAPE MATERIALS + DETAILS

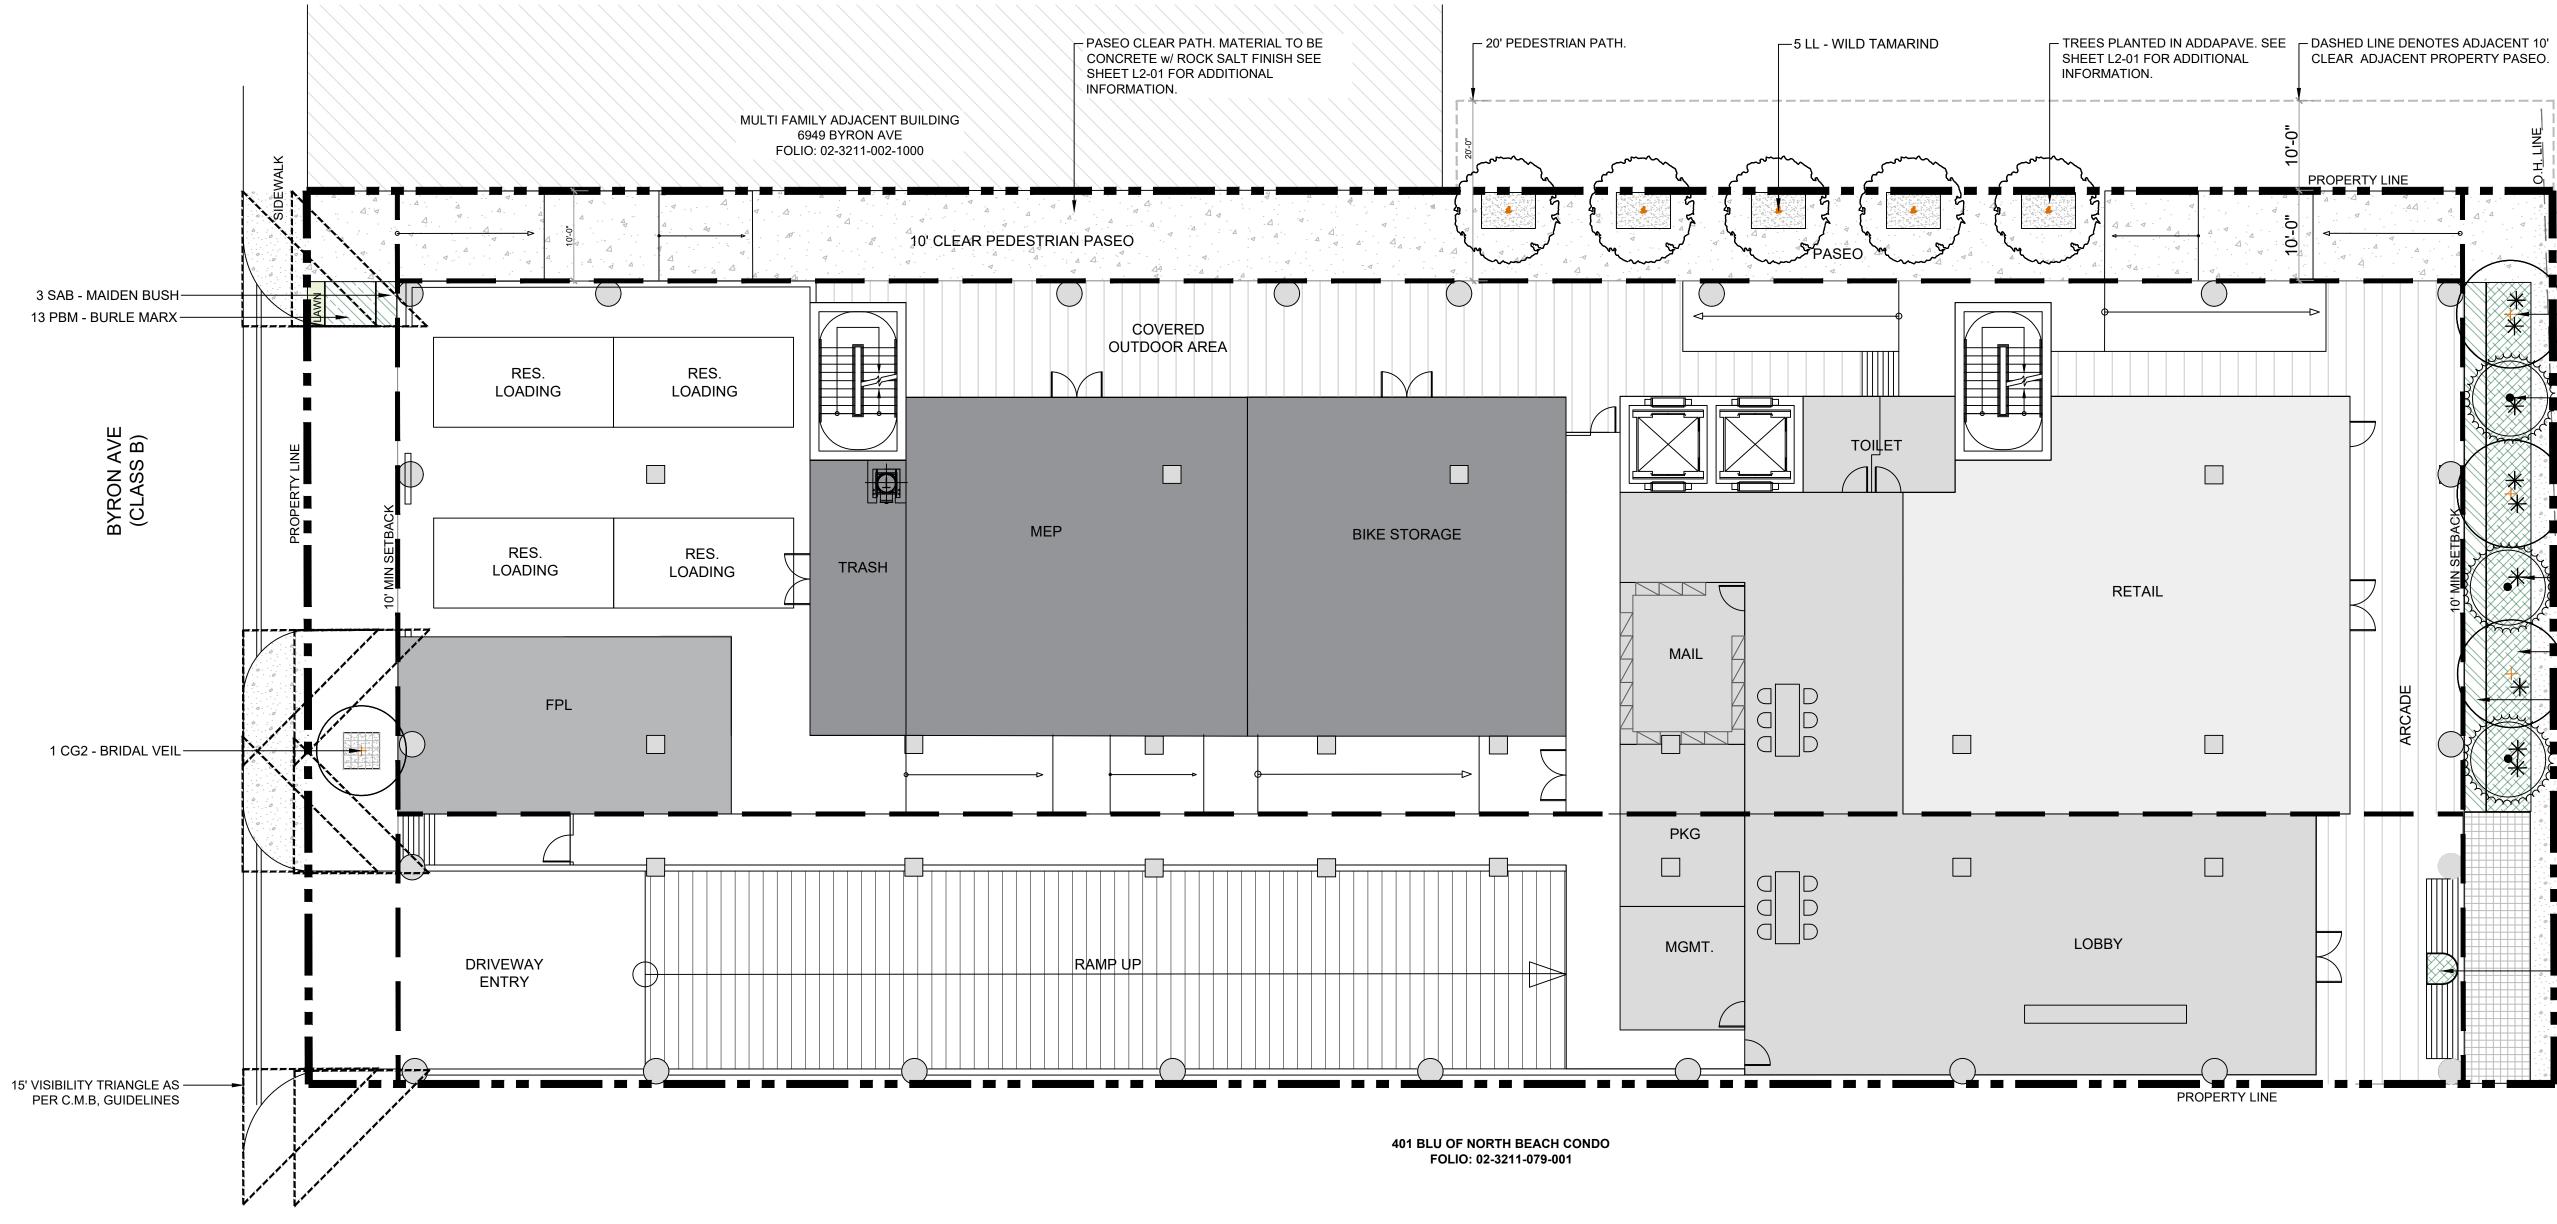

# LANDSCAPE LEGEND



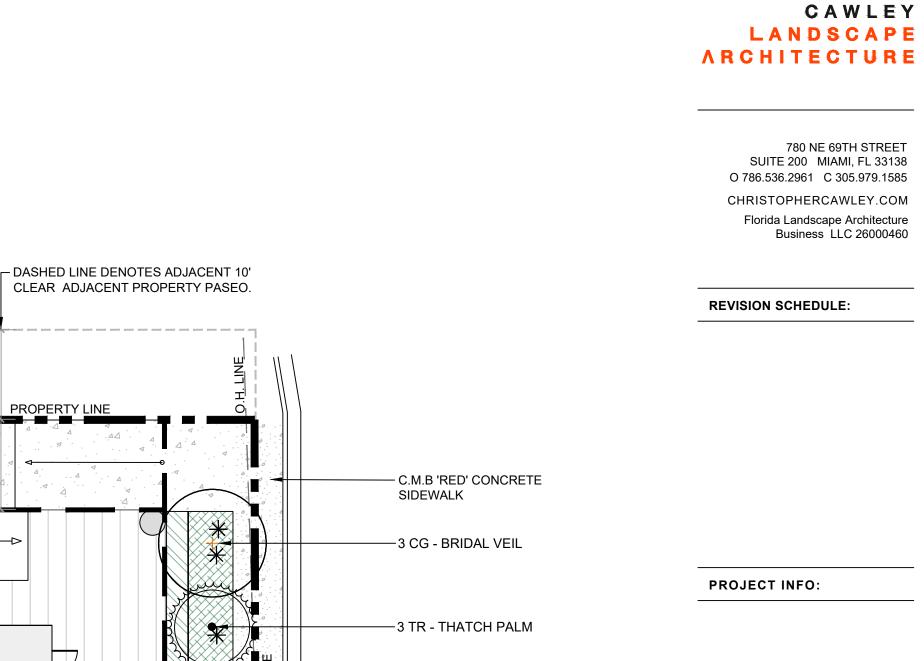




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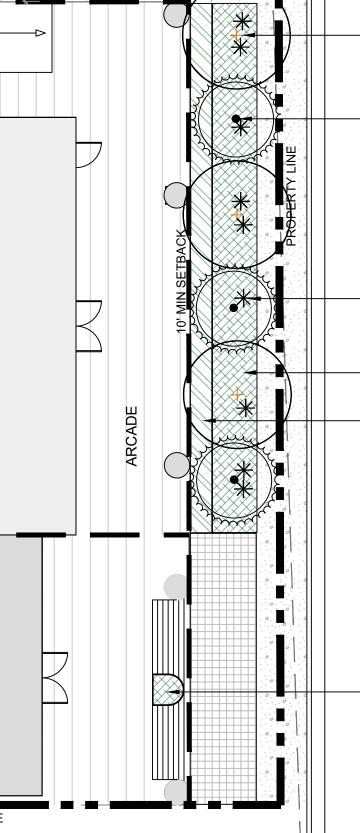


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**L3-00** 



PROPERTY LINE
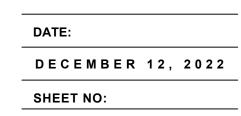
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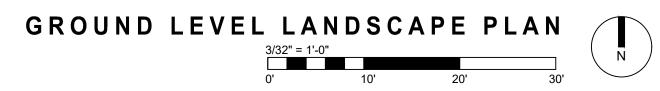
—9 TRF - DWARF FAKAHATCHEE

- 302 ERL - GOLDEN CREEPER


-37 SAB - MAIDEN BUSH



—11 ERL - GOLDEN CREEPER





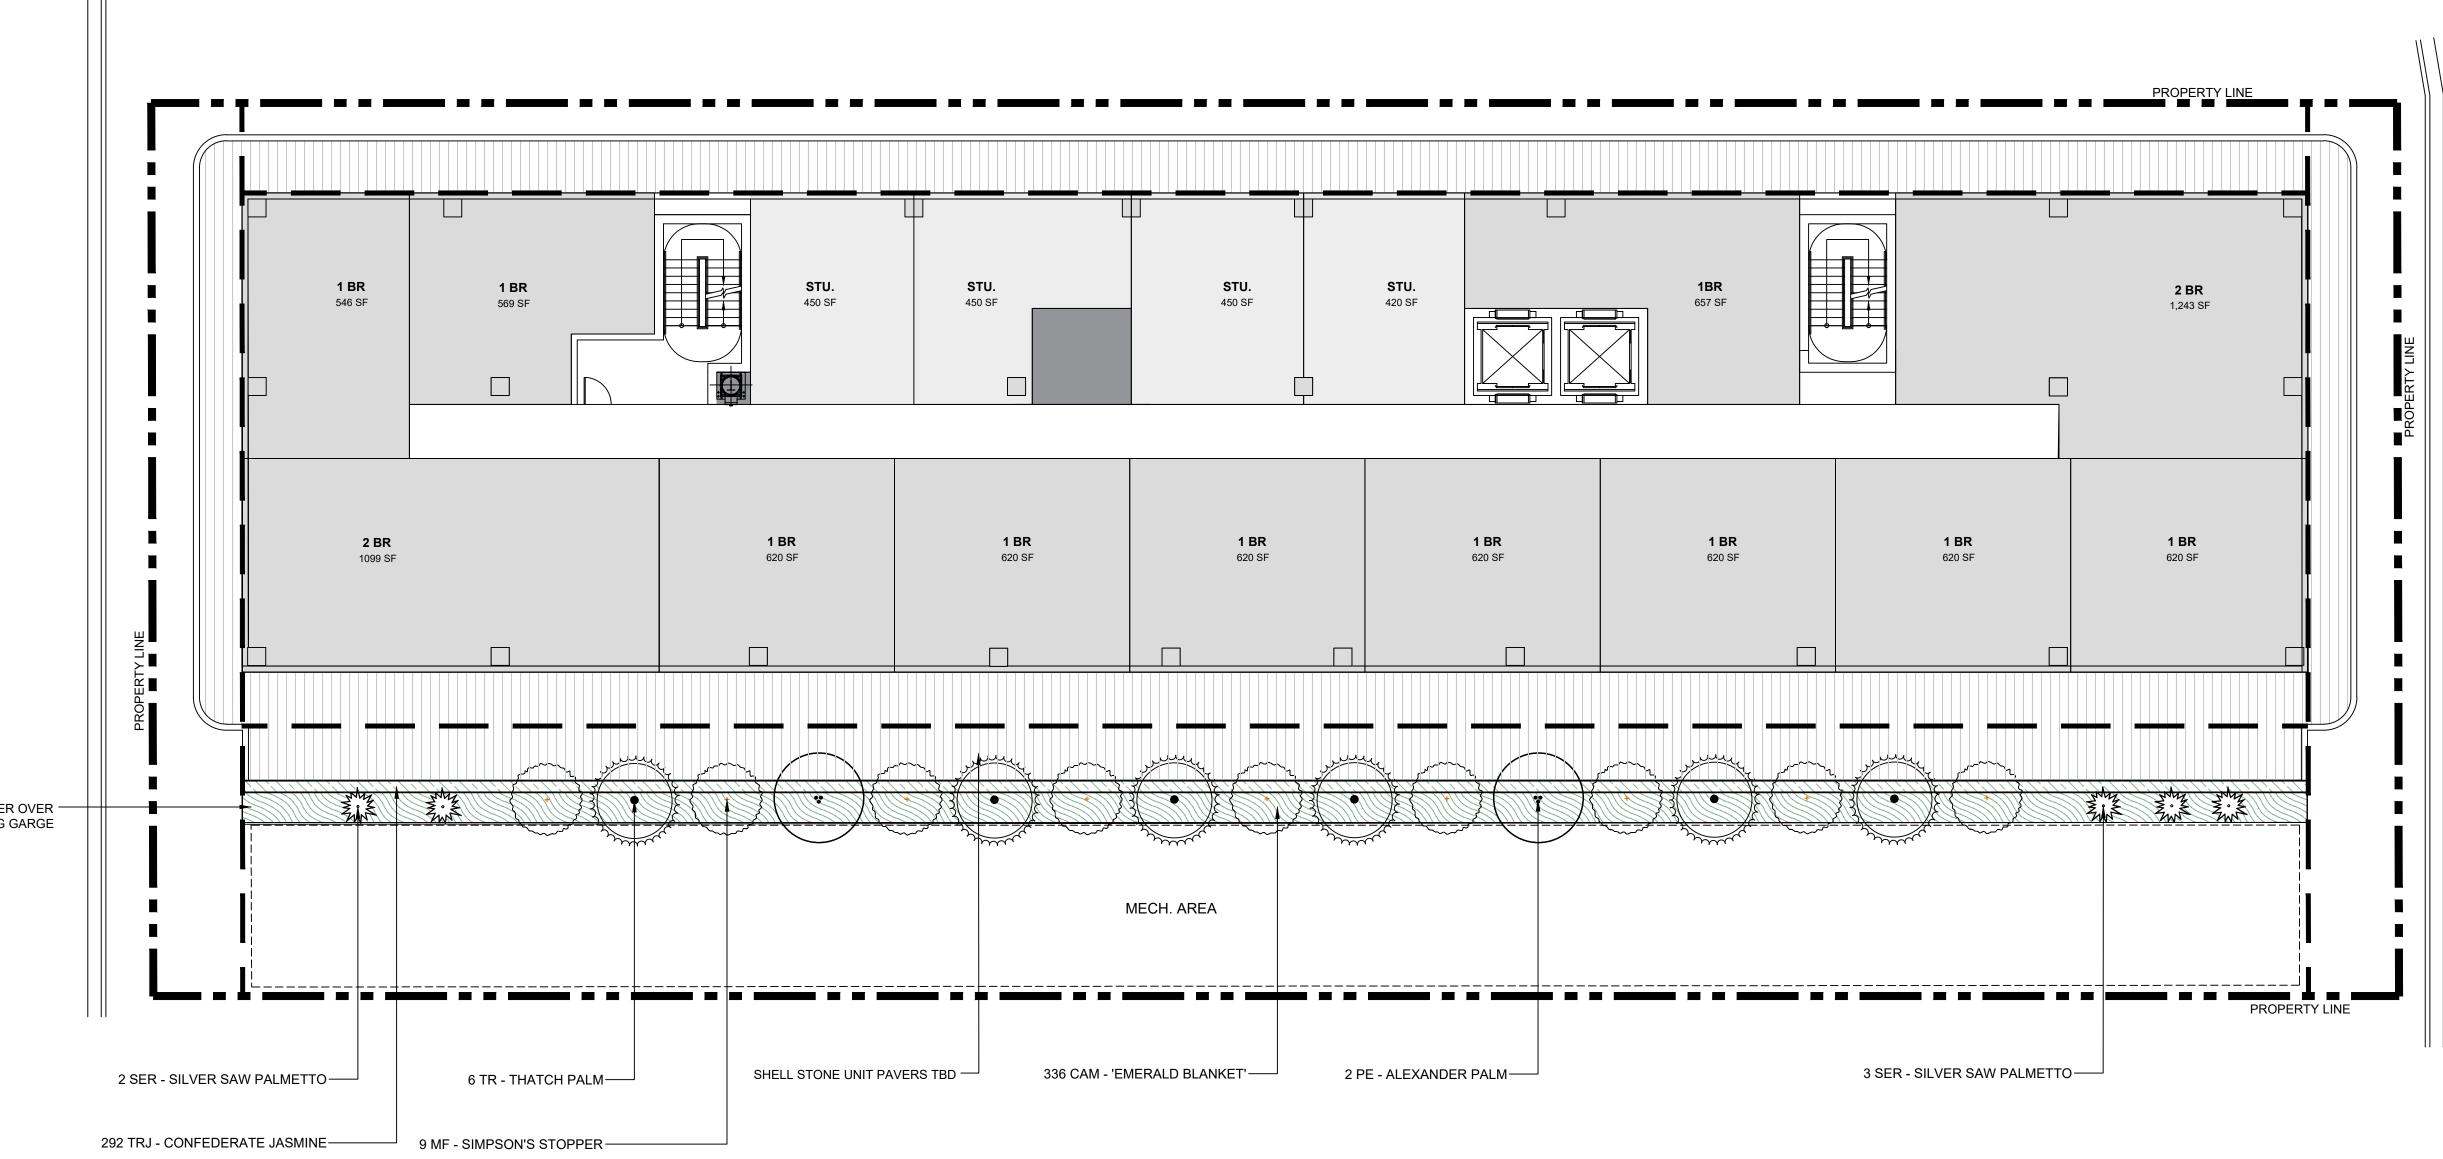

LANDSCAPE BUFFER OVER --PARKING GARGE



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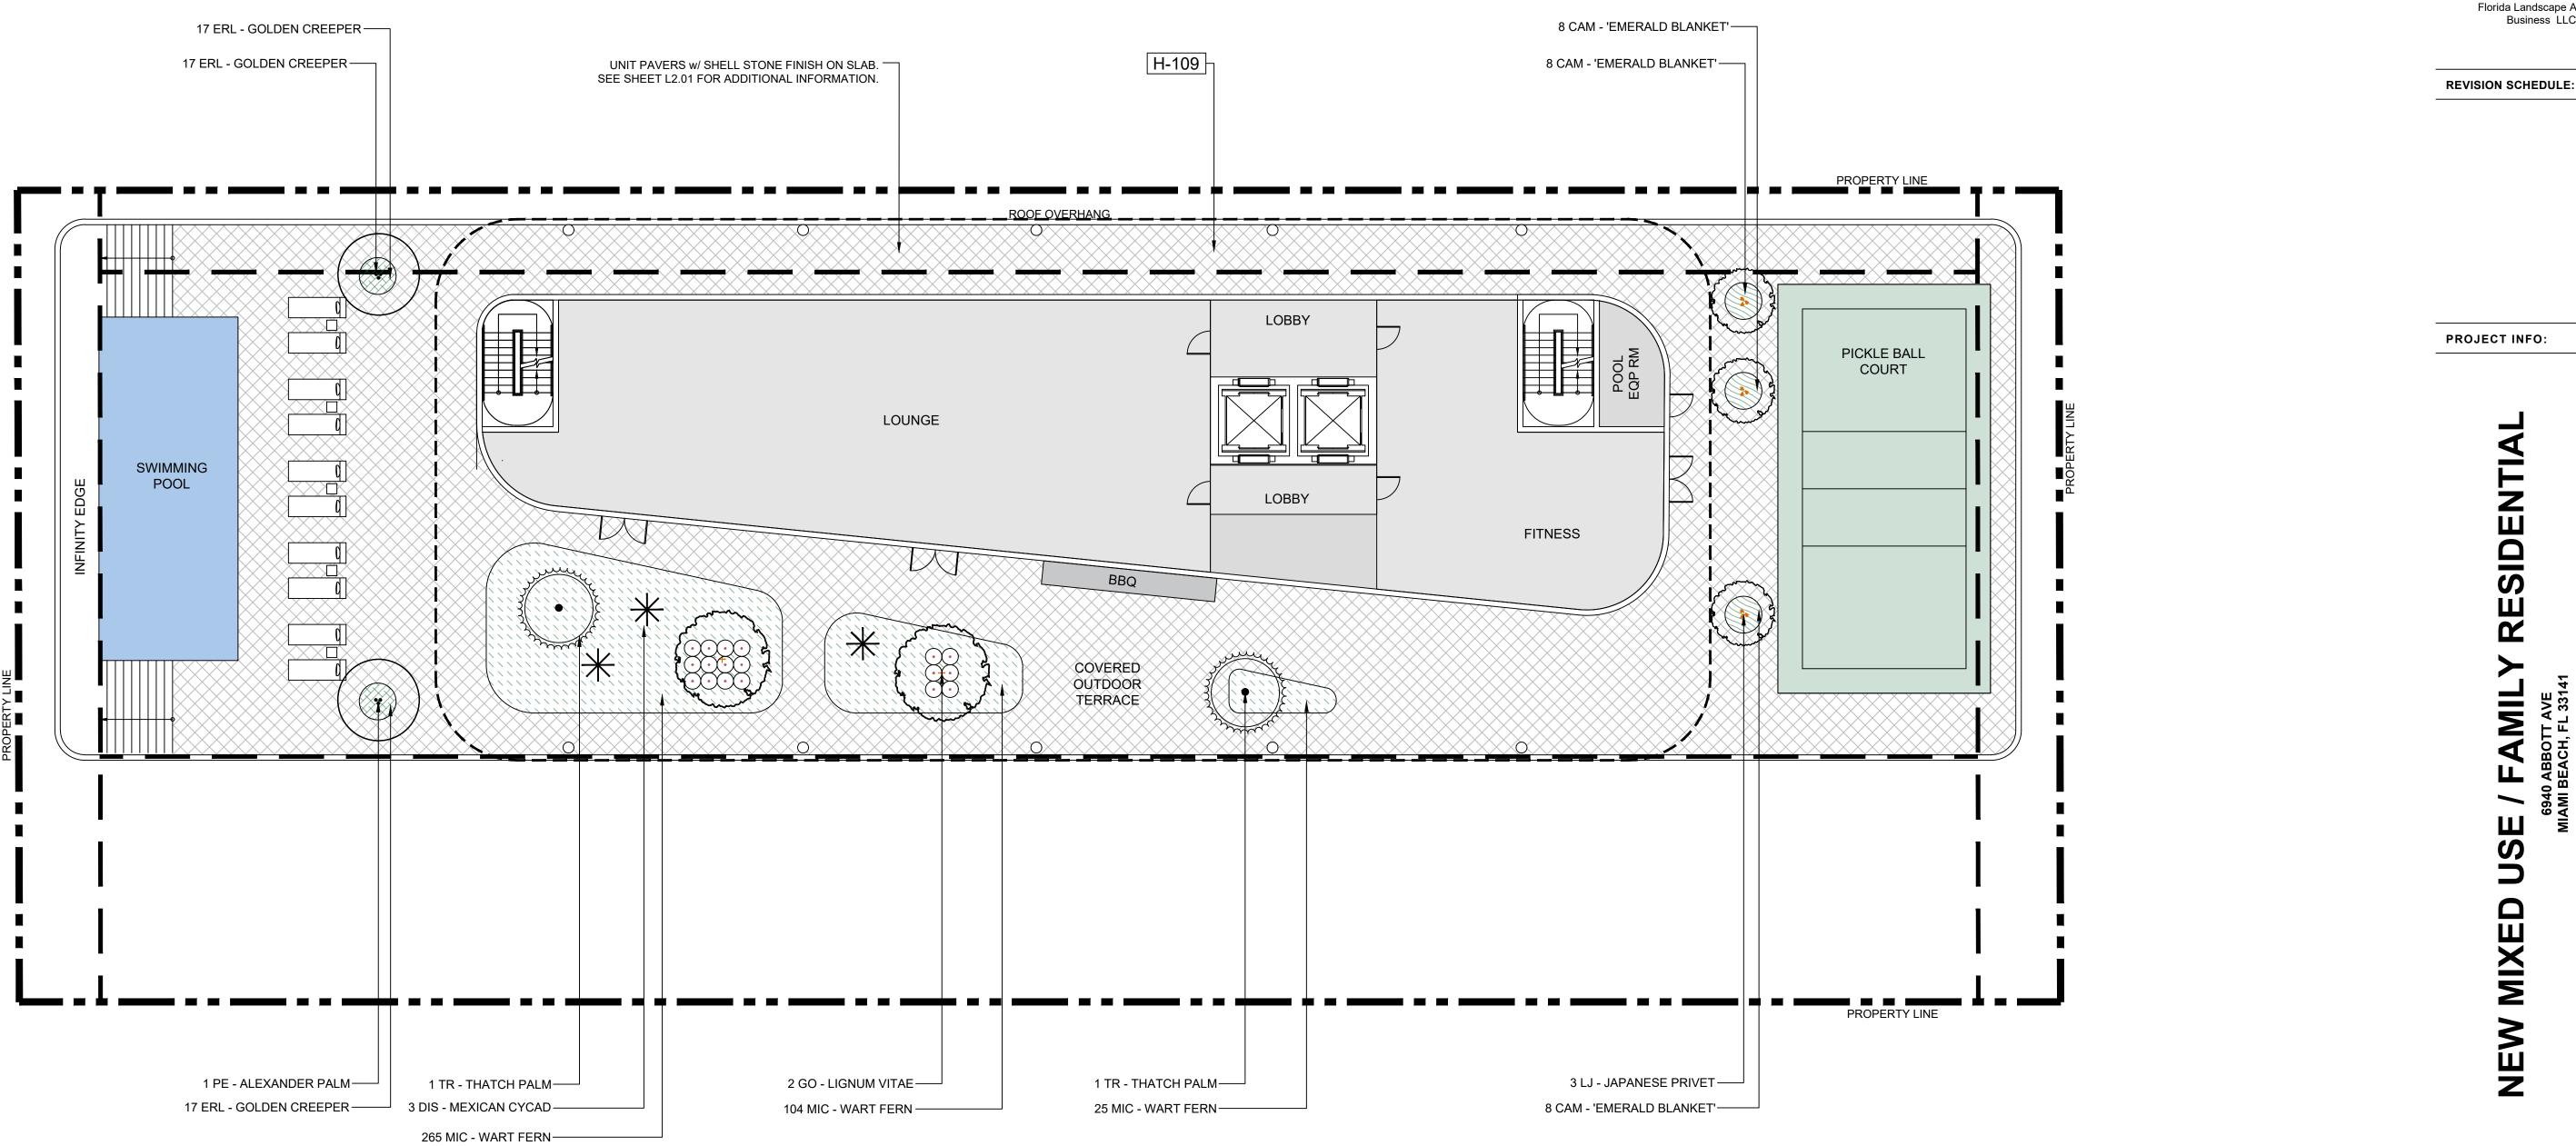
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L3-01


FOURTH LEVEL LANDSCAPE PLAN








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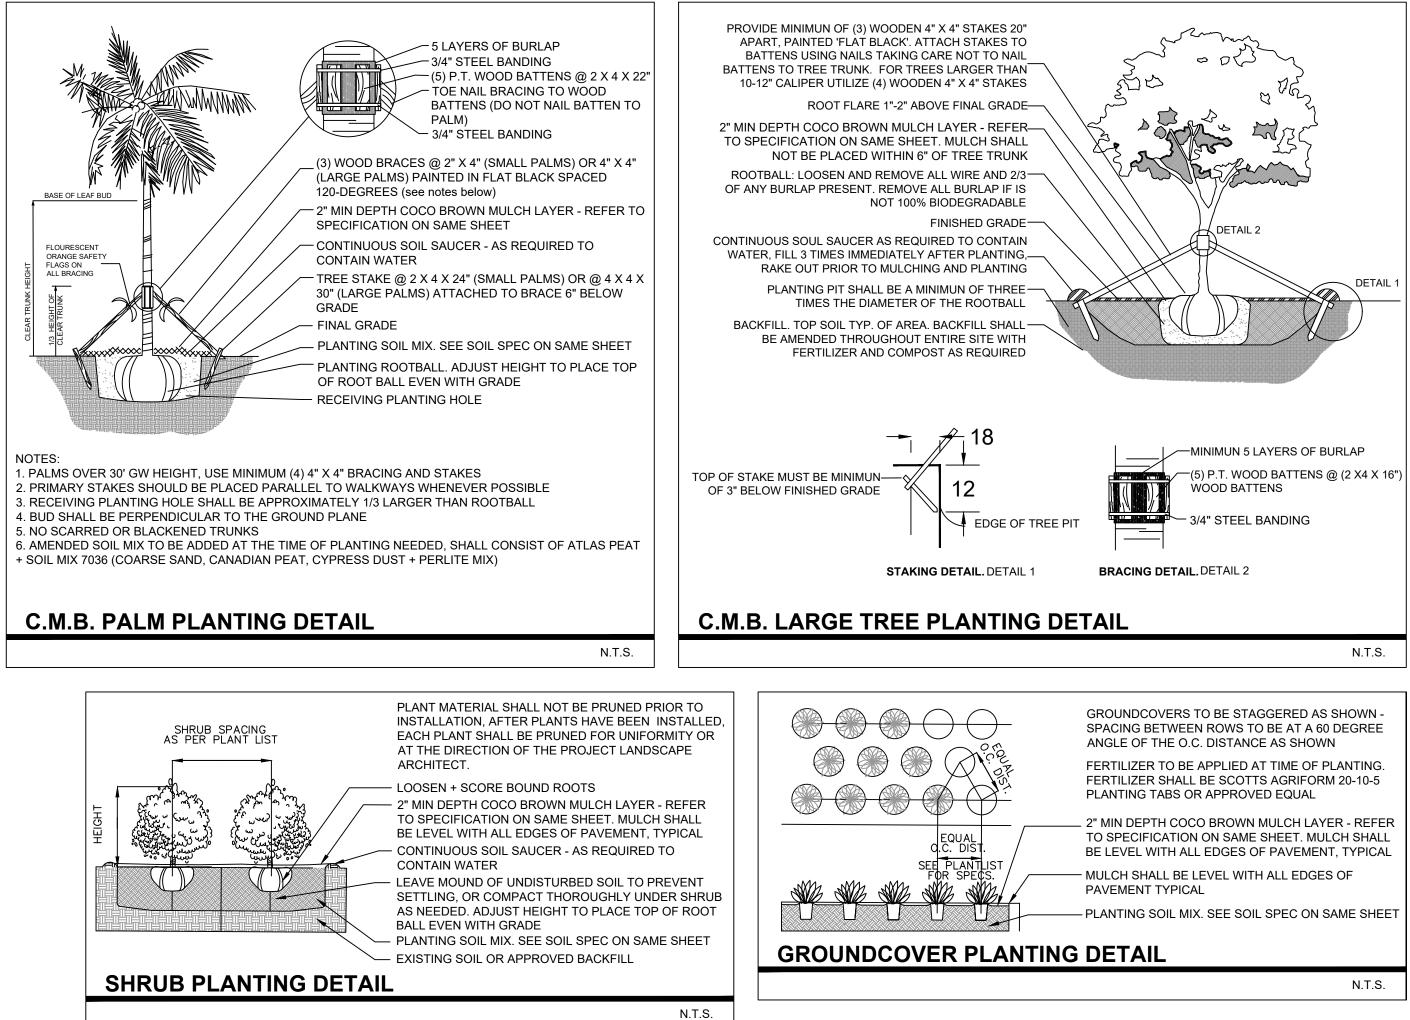


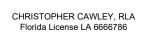ROOF LEVEL LANDSCAPE PLAN

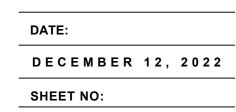

### PLANTING NOTES

- 1. ALL PLANT MATERIAL SHALL BE FLORIDA GRADE NO. 1 OR BETTER.
- 2. CONTRACTOR SHALL BECOME FAMILIAR WITH THE LOCATION OF, AVOID, AND PROTECT ALL UTILITY LINES, BURIED CABLES, AND OTHER UTILITIES.
- 3. TREE, PALM, ACCENT AND BED LINES ARE TO BE LOCATED IN THE FIELD AND APPROVED BY THE LANDSCAPE ARCHITECT PRIOR TO INSTALLATION.
- 4. ALL PLANTING SOIL SHALL BE 50:50 TOPSOIL: SAND MIX, FREE OF CLAY, STONES, ROCKS, OR OTHER FOREIGN MATTER. THIS SPECIFICATION INCLUDES ALL BACKFILL FOR BERMS AND OTHER LANDSCAPE AREAS. CARE SHALL BE TAKEN TO AVOID PLACEMENT OF CONSTRUCTION FILL, GRAVEL, AND OR DEBRIS OVER THE ROOT BALLS OF INSTALLED OR EXISTING TREES AND OR PALMS ON SITE. GROUNDCOVER PLANTING BEDS: 6" DEPTH PLANTING SOIL SPREAD IN PLACE-THROUGHOUT. SHRUB AND HEDGE PLANTING AREAS: 12" DEPTH PLANTING SOIL SPREAD IN PLACE-THROUGHOUT. TREES, PALMS, SPECIMEN PLANT MATERIAL LOCATIONS: REMOVE ALL LIMEROCK PRESENT TO A DEPTH OF AT LEAST 30" BEFORE PLACING NEW PLANTING SOIL. APPLY NEW CLEAN PLANTING SOIL IN PLANTING AREAS AS REQUIRED.
- 5. THE SITE CONTRACTOR SHALL BE RESPONSIBLE TO BRING ALL GRADES TO WITHIN 2" OF FINAL GRADES. THIS SHALL INCLUDE A 2" APPLICATION OF 50:50 TOPSOIL: SAND MIX FOR ALL LANDSCAPE AND AREAS TO BE SODDED.
- 6. THE LANDSCAPE CONTRACTOR SHALL CALCULATE AND SUBMIT AN ITEMIZED PRICE FOR THE 2" APPLICATION OF 50:50 MIX FOR ALL SOD AREAS AS A REFERENCE IN THE CASE THAT THERE WOULD BE A DISCREPANCY BETWEEN SITE AND LANDSCAPE CONTRACTORS AND NOTIFY THE SITE CONTRACTOR OR PROJECT SUPERINTENDENT AS TO THIS DISCREPANCY. IT WILL THEN BE DETERMINED WHICH PARTY WILL PROVIDE THIS 2" TOPSOIL: SAND APPLICATION AND SUBSEQUENT PAYMENT. OTHER PLANTING SOIL MIXES TO BE ADDED, I.E. FOR TREES, PALMS, SPECIMEN PLANTS, SHRUBS AND GROUNDCOVER SHALL BE THE RESPONSIBILITY OF THE LANDSCAPE CONTRACTOR AND BE INCLUSIVE WITH THE LANDSCAPE BID.
- 7. ALL EXISTING TREE + PALM INFORMATION THAT HAS BEEN PROVIDED ON THIS PLAN FOLLOWS THE CITY OF MIAMI BEACH TREE PERMITTING GUIDELINES. ANY TREES OF PALMS CONSIDERED INVASIVE OR THAT FALLS UNDER THE TREE PERMIT EXEMPTION / PROHIBITED SPECIES LIST 24-94 (4) MAY NOT BE SHOWN FOR CLARITY PURPOSES. ANY DISCREPANCIES IF NOTED UPON FURTHER FIELD INSPECTION SHALL BE BROUGHT TO THE IMMEDIATE ATTENTION OF THE LANDSCAPE ARCHITECT.
- 8. IRRIGATION SHALL PROVIDE FOR A 100% COVERAGE WITH 50% OVERLAP MINIMUM AND BE PROVIDED BY A FULLY AUTOMATIC IRRIGATION SYSTEM W/ RAIN MOISTURE SENSOR ATTACHED TO CONTROLLER. ALL FLORIDA BUILDING CODE APPENDIX "F" IRRIGATION REQUIREMENTS SHALL BE STRICTLY ADHERED TO FOR INSTALLATION AND PREVAILING WATER MANAGEMENT DISTRICT RESTRICTIONS AND REGULATIONS SHALL BE IN COMPLIANCE FOR POST-INSTALLATION WATERING SCHEDULES.CONTRACTOR SHALL COORDINATE WITH THE IRRIGATION CONTRACTOR AND LEAVE PROVISIONS FOR ALL SLEEVING AND PIPE ROUTING. ALL UNDERGROUND UTILITIES TO BE LOCATED BY DIALING 811 AS REQUIRED BY LAW.
- 9. ALL PLANTING BEDS SHALL BE MULCHED TO A DEPTH OF 2" w/ APPROVED NATURAL SHREDDED COCO BROWN MULCH MULCH FREE FROM WEEDS AND PESTS. NO 'NUGGETS', 'CYPRESS MULCH' OR 'RED DYED MULCH' TO BE ACCEPTED. KEEP MULCH 6" AWAY FROM TREE OR PALM TRUNKS AS PER INDUSTRY RECOMMENDATIONS.
- 10. ALL TREES, PALMS, SHRUBS AND GROUNDCOVERS, AND SOD / LAWN SHALL CARRY A ONE-YEAR WARRANTY FROM THE DATE OF FINAL ACCEPTANCE.
- 11. NURSERY SUPPORT POLES SHALL BE REMOVED AT THE NURSERY, PRIOR TO TO DELIVERY, AND TREES DELIVERED WITH NURSERY POLES WILL NOT BE ACCEPTED; AND THEREFORE REJECTED, w/ THE EXCEPTION TREE SPECIES: CLUSIA ROSEA + SILVER BUTTONWOOD TREES
- 12. ALL TREES AND PALMS SHALL BE STAKED PER ACCEPTED STANDARDS BY THE FLORIDA NURSERYMEN & GROWERS LANDSCAPE ASSOCIATION (FNGLA) AND ANSI A-300 (PART 6)-2012 TREE, SHRUB, AND OTHER WOODY PLANT MANAGEMENT STANDARD PRACTICES (PLANTING AND TRANSPLANTING). CONTRACTOR SHALL ENSURE THAT THE PLANS, DETAILS, SPECIFICATIONS AND NOTES HAVE BEEN ADHERED TO AND THAT THE LANDSCAPE AND IRRIGATION INSTALLATION IS COMPLIANT TO ALL ITEMS AS DIRECTED ON THE PLANS PRIOR TO SCHEDULING OF THE FINAL INSPECTION. CONTRACTOR SHALL REMOVE ALL BRACING MATERIALS FROM ALL PALMS, TREES WITHIN 1 YEAR OF INSTALLATION.
- 13. THE PLANT LIST IS INTENDED ONLY AS AN AID TO BIDDING. ANY DISCREPANCIES FOUND BETWEEN THE QUANTITIES ON THE PLAN AND PLANT LIST, THE QUANTITIES ON THE PLAN SHALL BE HELD VALID.
- 14. IF NECESSARY, CONTRACTOR SHALL PROVIDE A WATER TRUCK DURING PLANTING TO ENSURE PROPER WATERING-IN DURING INSTALLATION AND CONTRACTOR WILL BE RESPONSIBLE FOR CONTINUAL WATERING UNTIL FINAL ACCEPTANCE BY THE OWNER. A MINIMUM OF 6 MONTHS OF SUPPLEMENTAL HAND OR AUTOMATIC IRRIGATION SYSTEM WATERING SHALL BE REQUIRED TO AID IN NEW TREE OR PALM ESTABLISHMENT.
- 15. FERTILIZATION: ONE COMPLETE APPLICATION OF GRANULAR FERTILIZER SHALL BE APPLIED PRIOR TO FINAL ACCEPTANCE AND APPROVAL BY THE LANDSCAPE ARCHITECT. FERTILIZER SHALL BE SCOTTS AGRIFORM 20-10-5 PLANTING TABS OR APPROVED EQUAL AS RECOMMENDED BY LANDSCAPE CONTRACTOR
- 16. SHOULD ANY TREES OR PALMS BE DAMAGED THEY SHALL BE EVALUATED BY THE CITY URBAN FORESTER TO DETERMINE CORRECTIVE ACTIONS THAT MAY INCLUDE REMOVAL, CORRECTIVE PRUNING AND OR REPLACEMENT. ANY CORRECTIVE ACTION REQUIRED SHALL BE PERFORMED IN ACCORDANCE WITH A CITY OF MIAMI BEACH CODE, ANSI-A 300 PRUNING STANDARDS AND OR AN ISSUED ERM TREE PERMIT OR ENVIRONMENTAL PERMIT. ANY CORRECTIVE PRUNING REQUIRED SHALL BE PERFORMED BY AN ISA CERTIFIED ARBORIST OR ASCA CONSULTING ARBORIST AND THE CITY URBAN FORESTER SHALL BE CONSULTED.
- 17. ALL TREES + PALMS TO REMAIN OR BE RELOCATED ON SITE IN THE VICINITY OF CONSTRUCTION ACTIVITIES, SHALL BE PROTECTED THROUGH THE USE OF TREE PROTECTION BARRICADES INSTALLED AT THE TREE OR PALM DRIP LINE. A TREE PROTECTION FENCE SHALL BE CONSTRUCTED PRIOR TO ANY CONSTRUCTION ACTIVITY INCLUDING GRUBBING AND SHALL REMAIN IN PLACE UNTIL ON SITE CONSTRUCTION HAS BEEN COMPLETED.
- 18. MULCH SHALL NOT BE APPLIED WITHIN 6" OF ANY TREE OR PALM TRUNK THAT IS INSTALLED OR INCORPORATED INTO THE PROJECT. FOR ROW TREES + PALMS, ALL MULCH SHALL BE AMERIGROW 'PREMIUM PINEBARK BROWN' SHREDDED MULCH OR A CITY APPROVED ALTERNATIVE.



## PLANT SCHEDULE

- 2" MIN DEPTH COCO BROWN MULCH LAYER REFER TO SPECIFICATION ON SAME SHEET. MULCH SHALL BE LEVEL WITH ALL EDGES OF PAVEMENT, TYPICAL
- PLANTING SOIL MIX. SEE SOIL SPEC ON SAME SHEET

N.T.S.

TREES	CODE	<u>QTY</u>	BOTANICAL NAME	COMMON NAME	NATIVE	SPECIFICATIONS
+	CG2	1	CAESALPINIA GRANADILLO	BRIDAL VEIL	NO	200 GAL, 16` HT, 10` SP, 4" DBH, 6` CT
+	CG	3	CAESALPINIA GRANADILLO	BRIDAL VEIL	NO	300 GAL, 22` HT, 12` SP, 6" DBH, 8` CT
+	GO	2	GUAIACUM OFFICINALE	LIGNUM VITAE	YES	14` HT, 8` SP, 3" DBH, STANDARD
> }	LJ	3	LIGUSTRUM JAPONICUM	JAPANESE PRIVET	NO	12` HT, 8` SP, 3" DBH, MULTI-TRUNK
	LL	5	LYSILOMA LATISILIQUA	WILD TAMARIND	YES	20` HT, 10` SP, 6" DBH, STANDARD
*	MF	9	MYRCIANTHES FRAGRANS	SIMPSON'S STOPPER	YES	10` HT, 6` SP, 3" DBH, MULTI-TRUNK LIMBED UP
PALMS	CODE	<u>QTY</u>	BOTANICAL NAME	COMMON NAME	NATIVE	SPECIFICATIONS
•	PE	4	PTYCHOSPERMA ELEGANS	ALEXANDER PALM	NO	16 - 18` OA HT, TRIPLE TRUNKS
•	TR	11	THRINAX RADIATA	THATCH PALM	YES	4` CT, 8` MIN SP, SINGLE LEADER, FLORIDA FANCY
SHRUBS	CODE	QTY	BOTANICAL NAME	COMMON NAME	NATIVE	SPECIFICATIONS
$\overline{*}$	DIS	3	DIOON SPINULOSUM	MEXICAN CYCAD	NO	7 GAL, 3` HT X 3` SP`
	MOD	18	MONSTERA DELICIOSA	SWISS CHEESE PLANT	NO	3 GALLON, 24" O.C., FULL TO BASE
ACCENTS	CODE	QTY	BOTANICAL NAME	COMMON NAME	NATIVE	SPECIFICATIONS
My www.	SER	5	SERENOA REPENS 'CINEREA'	SILVER SAW PALMETTO	YES	3 GALLON, 2.5` HT, 2.5` SP, FULL
ZWY						
GRASSES	CODE	<u>QTY</u>	BOTANICAL NAME	COMMON NAME	NATIVE	SPECIFICATIONS
*	TRF	9	TRIPSACUM FLORIDANA	DWARF FAKAHATCHEE	YES	3 GALLON, 2.5` HT, 2.5` SP, FULL
SHRUB AREAS	CODE	<u>QTY</u>	BOTANICAL NAME	COMMON NAME	NATIVE	SPECIFICATIONS
	SAB	40	SAVIA BAHAMENSIS	MAIDEN BUSH	YES	7 GALLON, 2 - 3` HT, FULL TO BASE
GROUND COVERS	CODE	<u>QTY</u>	BOTANICAL NAME	COMMON NAME	NATIVE	SPECIFICATIONS
	CAM	360	CARISSA MACROCARPA 'EMERALD BLANKET'	'EMERALD BLANKET'	NO	3 GALLON, 18" O.C., FULL TO BASE
	ERL	347	ERNODEA LITTORALIS	GOLDEN CREEPER	YES	3 GALLON, 12" O.C., FULL TO BASE
	MIC	394	MICROSORUM SCOLOPENDRIA	WART FERN	NO	3 GALLON, 18" O.C., FULL TO BASE
	PBM	13	PHILODENDRON X 'BURLE MARX'	BURLE MARX	YES	3 GALLON, 18" O.C., FULL TO BASE
	TRJ	292	TRACHELOSPERMUM JASMINOIDES 'CONFEDERATE'	CONFEDERATE JASMINE	NO	3 GALLON, 12" O.C., FULL TO BASE
SOD/SEED	CODE	<u>QTY</u>	BOTANICAL NAME	COMMON NAME	NATIVE	SPECIFICATIONS
	ZX	9 SF	ZOYSIA X 'EMPIRE'	EMPIRE ZOYSIA	NO	
CONTRACTOR TO PROVIDE IMAGES OF ALL MAJOR PLANT MATERIAL TO LANDSCAPE ARCHITECT + OWNER FOR APPROVAL BEFORE PURCHASE + INSTALLATION. LANDSCAPE CONTRACTOR						

CONTRACTOR TO PROVIDE IMAGES OF ALL MAJOR PLANT MATERIAL TO LANDSCAPE ARCHITECT + OWNER FOR APPROVAL BEFORE PURCHASE + INSTALLATION. LANDSCAPE CONTRACTOR TO MEET WITH LANDSCAPE ARCHITECT + OWNER ON SITE TO REVIEW THE PROPOSED DESIGN PRIOR TO SUBMITTING A BID FOR THE PROJECT. THE LANDSCAPE CONTRACTOR IS TO PROVIDE AN ADDITIONAL ALLOWANCE OF \$15,000 DOLLARS FOR POTTED PLANTS + MISCELLANEOUS VEGETATION TO BE SELECTED DURING THE INSTALLATION OF THE PROJECT.



780 NE 69TH STREET

Business LLC 26000460

SUITE 200 MIAMI, FL 33138

O 786.536.2961 C 305.979.1585

CHRISTOPHERCAWLEY.COM Florida Landscape Architecture



**REVISION SCHEDULE:** 

**PROJECT INFO:** 





#### CHRISTOPHER CAWLEY, RLA Florida License LA 6666786

DATE: **DECEMBER 12, 2022** SHEET NO:




# PLANT LIST, LANDSCAPE DETAILS + NOTES

# PLANT MATERIALS



CG | BRIDAL VEIL Caesalpinia grandadillo

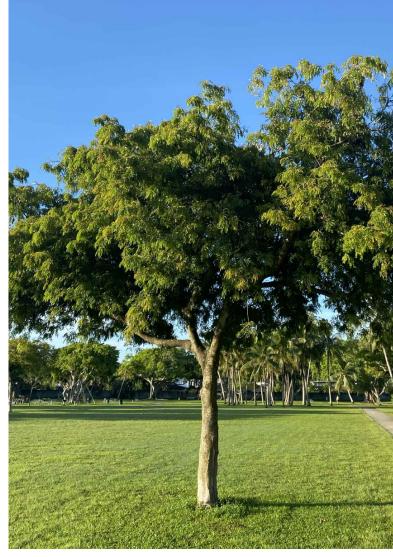

LL | WILD TAMARIND Lysiloma latisiliquum



TR | THATCH PALM Thrinax radiata



MIC | WART FERN *Microsorum scolopendrium* 




PE | ALEXANDER PALM Ptychosperma elegans



CAM | CARISSA 'EMERALD BLANKET' Carissa macrocarpa



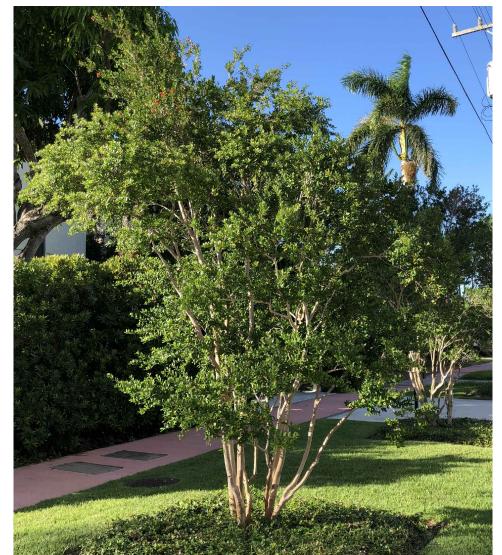

MF | SIMPSON'S STOPPER Myrcianthes fragrans




GO | LIGNUM VITAE Guaiacum officinale

LJ | JAPANESE PRIVET *Ligustrum japonicum* 




DIS | MEXICAN CYCAD Dioon spp.



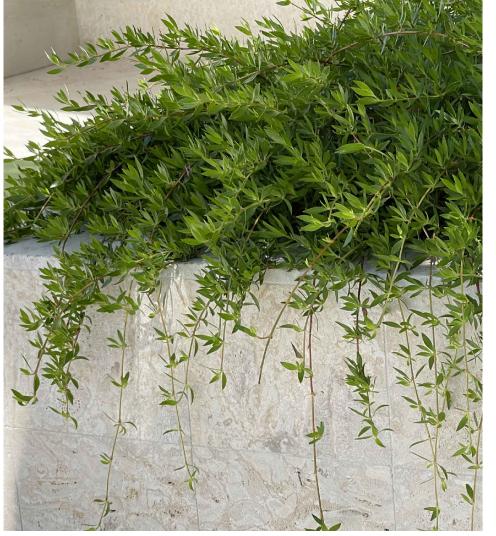

ERL | GOLDEN BEACH CREEPER Ernodea littoralis

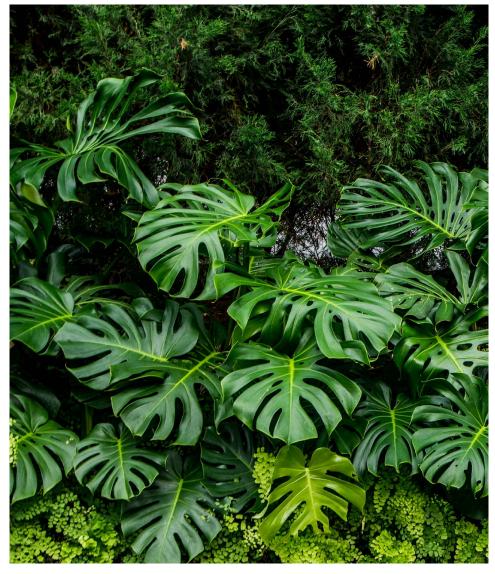

MOD | SWISS CHEESE PLANT *Monstera deliciosa* 



SER | SILVER SAW PALMETTO Serenoa repens

SAB | BAHAMA MAIDEN BUSH Savia bahamensis





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L4-01

SHEET NO:





TRJ | CONFEDERATE JASMINE Trachelospermum jasminoides

# PLANT MATERIAL IMAGES