SITEWORK GENERAL NOTES

- THE GENERAL CONTRACTOR SHALL BE RESPONSIBLE FOR COORDINATING ALL WORK BY THE SUBCONTRACTORS.
- CONTRACTOR SHALL VERIFY ALL CONDITIONS AT JOB SITE AND NOTIFY LANDSCAPE ARCHITECT AND GENERAL CONTRACTOR OF DIMENSIONAL ERRORS, OMISSIONS OR DISCREPANCIES BEFORE BEGINNING ANY WORK.
- CONTRACTOR TO OBTAIN ALL NECESSARY PERMITS PRIOR TO CONSTRUCTION, ALL CONTRACTORS MUST COMPLY WITH PERMIT REQUIREMENTS, LOCAL, STATE AND FEDERAL JURISDICTIONS AND GOVERNING BODIES/AGENCIES RULES AND REGULATIONS AND LAND USE APPROVAL CONDITIONS AT ALL TIMES.
- WORK PERFORMED WITHOUT APPROVAL OF LOCAL, STATE AND FEDERAL JURISDICTIONS AND GOVERNING BODIES/AGENCIES AND/OR NOT IN COMPLIANCE WITH SPECIFICATIONS AND/OR DRAWINGS IS SUBJECT TO REMOVAL AT CONTRACTOR'S
- ALL WORK SHALL CONFORM TO THE APPROPRIATE AGENCIES. CONTRACTOR SHALL VERIFY LOCATION OF ALL EXISTING UTILITIES, LINES AND STRUCTURES PRIOR TO EXCAVATION OR TRENCHING. DAMAGE SHALL BE REPAIRED BY THE CONTRACTOR AT NO COST TO THE OWNER. THE LANDSCAPE ARCHITECT ASSUMES NO RESPONSIBILITY FOR UTILITIES OR STRUCTURES NOT SHOWN ON THE DRAWINGS. CONTRACTOR IS TO VERIFY THE EXACT LOCATION OF UTILITIES PRIOR TO CONSTRUCTION AND NOTIFY THE LANDSCAPE ARCHITECT OF ANY DISCREPANCIES. CONTRACTOR SHALL USE EXTREME CAUTION WHEN WORKING OVER OR NEAR EXISTING GAS AND ELECTRICAL LINES.
- THE CONTRACTOR SHALL BE RESPONSIBLE FOR RESETTING ALL LAND MONUMENTS DISRUPTED BY CONSTRUCTION ACTIVITIES OR NEGLIGENCE ON THE PART OF THE CONTRACTOR. RESETS SHALL BE PERFORMED UNDER THE SUPERVISION OF A REGISTERED LAND SURVEYOR AND MONUMENT RECORDS MUST BE FILED AS REQUIRED BY STATUTE FOR ALL MONUMENTS.
- THE CONTRACTOR SHALL TAKE ALL PRECAUTIONARY MEASURES NECESSARY TO PROTECT EXISTING IMPROVEMENTS FROM DAMAGE AND ALL SUCH IMPROVEMENTS AND STRUCTURES DAMAGED BY THE CONTRACTOR'S OPERATIONS SHALL BE REPAIRED OR RECONSTRUCTED SATISFACTORY TO THE LANDSCAPE ARCHITECT AT THE CONTRACTOR'S EXPENSE.
- ALL BARRICADING AND TEMPORARY TRAFFIC CONTROL DEVICES OR METHODS USED DURING CONSTRUCTION SHALL BE IN ACCORDANCE WITH LOCAL, STATE AND FEDERAL JURISDICTIONS AND GOVERNING BODIES/AGENCIES STANDARDS. PROVIDE ADEQUATE TIME FOR REVIEW AND APPROVAL BY THE ABOVE JURISDICTIONS PRIOR TO COMMENCEMENT.
- THE LANDSCAPE ARCHITECT IS NOT RESPONSIBLE FOR THE CONSTRUCTION MEANS, METHODS, TECHNIQUES, SEQUENCES UTILIZED OR FOR SAFETY PRECAUTIONS OR PROBLEMS IN CONNECTION WITH THE WORK. THE LANDSCAPE ARCHITECT WILL NOT BE RESPONSIBLE FOR THE CONTRACTOR'S FAILURE TO CARRY OUT THE WORK IN ACCORDANCE WITH THE CONTRACT DOCUMENTS. CONTRACT DOCUMENTS INCLUDE THE CONSTRUCTION DOCUMENT DRAWING SET/TECHNICAL SPECIFICATIONS MANUAL/LASIS.
- CONTRACTOR TO VERIFY ALL QUANTITIES. IN CASE OF ANY DISCREPANCIES, GRAPHICALLY SHOWN MATERIAL QUANTITIES SHALL TAKE PRECEDENCE.
- 11. A SYSTEM OF DIAGRAMMATIC SYMBOLS, HATCHES AND NOTATIONS IS USED IN THESE DRAWINGS. REVIEW NOTATIONS CAREFULLY, NOTIFY LANDSCAPE ARCHITECT AND REQUEST CLARIFICATION OF ANY UNCLEAR NOTATION OR DISCREPANCY PRIOR TO COMMENCING WORK.

SITEWORK GENERAL NOTES CONTINUED

- PROVIDE SLEEVES AS REQUIRED FOR DRAINAGE, IRRIGATION AND ELECTRICAL LINES. IRRIGATION AND ELECTRICAL SLEEVES AND SUBSURFACE DRAINAGE SYSTEMS SHALL BE CONSTRUCTED PRIOR TO PAVING AND LANDSCAPE WORK. UTILITY SLEEVES ARE REQUIRED IN ALL PLANT BEDS ISOLATED BY PAVEMENT OR ANY OTHER STRUCTURES.
- SPECIAL CONSIDERATION IS GIVEN TO THE DESIGN AND INTENDED RELATIONSHIP 2. BETWEEN ARCHITECTURE, PLANTING AREAS AND PAVING SYSTEMS. PAVEMENT JOINTING, PAVERS, STONE, FINISHES AND GRADES HAVE BEEN STRICTLY COORDINATED IN THE CONTRACT DOCUMENTS. CONSTRUCTION OF THESE SYSTEMS SHALL BE STRICTLY COORDINATED.
- VEHICLES, EQUIPMENT, AND/OR MATERIALS SHALL NOT BE PARKED OR STORED IN 3. AREAS OF EXISTING VEGETATION. INCLUDING WITHIN THE DRIPLINE OF EXISTING TREES TO REMAIN.
- CONSTRUCTION WASTE-INCLUDING BUT NOT LIMITED TO: PLANT MATERIAL, BUILDING MATERIALS, DEMOLISHED MATERIALS, PACKAGING, LEFTOVER PAINT AND CONCRETE SLURRY-SHOULD BE PROPERLY REUSED, RECYCLED, DISPOSED OF LEGALLY OFF-SITE OR IN DESIGNATED WASH-OUT AREAS DETERMINED BY THE GENERAL CONTRACTOR.
- RECYCLING AND TRASH BINS TO BE PROVIDED ON SITE. SEPARATE BINS FOR 5. CARDBOARD, CO-MINGLED, AND OTHER RECYCLABLE/REUSABLE MATERIALS IDENTIFIED BY THE LOCAL JURISDICTION SHALL BE MAINTAINED. ALL BINS TO BE WILDLIFF-PROOF
- 6. ON-SITE FUEL STORAGE FOR CONSTRUCTION EQUIPMENT IS DISCOURAGED. CONSTRUCTION EQUIPMENT USED ON SITE TO BE CHECKED REGULARLY TO ASSURE CONTAMINATION CONCERNS FROM OILS AND GREASES ARE ELIMINATED. NO TOXIC MATERIALS SHALL BE STORED ON-SITE.
- GENERAL CONTRACTOR TO KEEP ALL ITEMS IMPLEMENTED BY LANDSCAPE 7. ARCHITECT IN PROPER WORKING ORDER THROUGHOUT THE DURATION OF THE PROJECT.
- THE CONSTRUCTION SITE TO BE INSPECTED ON A MONTHLY BASIS BY LANDSCAPE 8. ARCHITECT AND/OR CIVIL ENGINEER TO ASSURE THAT THE SILT FENCE AND MUD TRACKING PAD ARE PROPERLY IN PLACE AND FUNCTIONING AS DESIGNED.
- GREEN BUILDING PRACTICES SHALL BE EMPLOYED TO THE EXTENT FEASIBLE. 9. SUCH PRACTICES INCLUDE: CARPOOLING/VANPOOLING TO JOB SITE, MINIMIZING MATERIALS PACKING BEFORE ARRIVAL TO JOB SITE, REDUCING MATERIAL/RESOURCE INEFFICIENCIES BY COORDINATING WORK.
- THE PROJECT LIMIT OF CONSTRUCTION AND ALL EXISTING VEGETATION TO REMAIN 10. IS TO BE CLEARLY DEFINED BY STURDY, WEATHERPROOF FENCING AT A MINIMUM OF FOUR (4) FEET HIGH.
- WATERPROOFING OF SUBGRADE AND OTHER ARCHITECTURAL SPACES BELOW 11. AND/OR ADJACENT TO IMPROVEMENTS DESIGNED BY THE LANDSCAPE ARCHITECT IS TO BE ADEQUATELY DESIGNED AND DETAILED BY OTHERS TO PERMANENTLY REPEL ALL WATER SOURCES INCLUDING, BUT NOT LIMITED TO: PRECIPITATION, STORM WATER RUNOFF, GROUND WATER, IRRIGATION, ROOF RUNOFF, GROUND WATER. AND PLUMBING LEAKS.
- 12. STRUCTURAL DESIGN TO SUPPORT IMPROVEMENTS DESIGNED BY THE LANDSCAPE ARCHITECT AND LOCATED ABOVE, BELOW, AND/OR ADJACENT TO SUBGRADE AND OTHER ARCHITECTURAL SPACES IS THE RESPONSIBILITY OF THE STRUCTURAL ENGINEER. THE STRUCTURAL DESIGN SHOULD BE ADEQUATELY DESIGNED TO SUPPORT ALL POSSIBLE LOADS INCLUDING, BUT NOT LIMITED TO: BACKFILL, COMPACTION, PLANTINGS, HARDSCAPES, RETAINING AND FREESTANDING SITE WALLS, AND CONSTRUCTION MATERIALS/EQUIPMENT/ACTIVITY.

SOIL EROSION CONTROL NOTES

- 1. PRIOR TO BEGINNING ANY EARTH CHANGE. THE CONTRACTOR SHALL INSTALL AND MAINTAIN ALL SESC MEASURES AS SHOWN ON THE CONTRACT DOCUMENTS AND AS REQUIRED BY ANY GOVERNING AGENCIES.
- 2. ALL SESC MEASURES TO BE MAINTAINED DAILY.
- 3. THE CONTRACTOR TO CONDUCT ALL EXCAVATION, FILLING, GRADING, AND CLEANUP OPERATIONS IN A MANNER SUCH THAT SEDIMENT. GENERATED BY WIND OR WATER IS NOT DISCHARGED INTO ANY STORM SEWER, DRAINAGE DITCH, RIVER, LAKE, AIR, OR UNDERGROUND UTILITY SYSTEM. STAGE WORK TO MINIMIZE THE AREA OF EXPOSED SOIL. THEREBY REDUCING THE OPPORTUNITY FOR SOIL EROSION.
- WATER FROM TRENCHES AND OTHER EXCAVATION TO BE PUMPED INTO A FILTRATION BAG TO REMOVE SEDIMENTS FROM THE WATER.
- NORTH AMERICAN GREEN SC-150 OR EQUIVALENT EROSION CONTROL FABRIC IS REQUIRED ON ALL DISTURBED SLOPES GREATER THAN 3:1 UNTIL PROJECT AREA IS REVEGETATED PER THE PLANTING PLAN.
- PROVIDE POSITIVE DRAINAGE AWAY FROM ALL STRUCTURES.
- 7. CONTRACTOR TO PROVIDE ONSITE WATERING TO REDUCE FUGITIVE DUST LEAVING THE SITE DURING CONSTRUCTION.
- SOIL EROSION CONTROL MEASURES TO BE PROVIDED FOR ALL EXISTING AND PROPOSED DRAINAGE STRUCTURES WITHIN THE PROJECT LIMITS.
- CONSTRUCTION STAGING AND PHASING SHALL OCCUR. WHERE APPLICABLE. TO MINIMIZE SOIL DISTURBANCE TIME.
- 10. BEST MANAGEMENT PRACTICES (BMPs) SHALL BE ADJUSTED AS NEEDED TO MEET ANY OTHER UNFORESEEN CONDITIONS.
- 11. THE GENERAL CONTRACTOR IS RESPONSIBLE FOR INSTALLING A MUD TRACKING PAD/WASHING PAD AT THE CONSTRUCTION ENTRANCES TO MINIMIZE MUD DETACHMENT FROM TRUCK TIRES. 1-1/2 INCH SCREENED ROCK TO BE PLACED ON MIRAFI 140-N FILTER FABRIC. ADDITIONAL CLEAN GRAVEL TO BE ADDED THROUGHOUT THE DURATION OF CONSTRUCTION AS NEEDED.
- 12. CONTRACTOR SHALL ABIDE BY THE LOCAL. STATE AND FEDERAL JURISDICTIONS AND GOVERNING BODIES/AGENCIES CONSTRUCTION MANAGEMENT PLAN REQUIREMENTS.
- 13. RESEED AS INDICATED IN SEEDING NOTES.



JOSE L. SANCHEZ AIA, LEED AP

278 NW 37TH ST. MIAMI, FL. 33127 P 305 576 8063

FL. LIC: AR 0016966 FL. LIC: AA 26000837



SEAL (MARSH C. KRIPLEN-LA6667007

ADDRESS & OWNER

ш 6 **DRIVE** 3313 RESIDENCE ALTO RVO BEA NEW **OWNER:** MIAMI

REVISION & DATE

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DRB SET 08-12-2022

DRAWING TITLE GENERAL SITE NOTES

SHEET NUMBER



CONCRETE WITH ROCK SALT FINISH

GRAY / SMOOTH ROCK SALT

LOCATION: DRIVEWAY SPECS: LAWN JOINTS

SOURCE: TBD

"ALL PAVING AND ROOFING MATERIALS TO MEET REGULATIONS FOR SOLAR REFLECTANCE IN ACCORDANCE WITH **ARTICLE 3.13.2.B OF MIAMI 21"**



PEEBLETEC POOL TILE

WHITE PEARL LOCATION: WATER FEATURE SPECS: 1" X 1" TILES

POOLTECH INC / PEEBLETEC® SOURCE:

PHONE: (631) 694.4752

www.pooltech.net



IPE HARDWOOD DECKING

COLOR: SMOOTH BROWN LOCATION: AS SHOWN ON L210 SPECS: FIRE RATING CLASS A

JANKA HARDNESS - 3600 LBS

BISON INNOVATIVE PRODUCTS SOURCE:

www.bisonip.com



CRUSHED GRANITE FINES

"SALT & PEPPER"

LOCATION: PEDESTRIAN CIRCULATION

SPECS: 1/2" - 1" Ø

SOURCE: BERNIE'S ROCK & GARDEN

www.berniesrockandgarden.com

786.242.4443



PEEBLETEC WATER FEATURE TILE


MATERIAL: BLACK PEARL LOCATION: WATER FEATURE SPECS: 1" X 1" TILES

POOLTECH INC / PEEBLETEC® SOURCE:

PHONE: (631) 694.4752

www.pooltech.net

MATERIALS NOTES

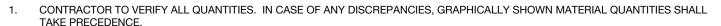

- ALL CONSTRUCTION AND MATERIALS NOT SPECIFICALLY ADDRESSED IN THE CONTRACT DOCUMENTS OR SPECIFICATIONS SHALL BE IN ACCORDANCE WITH LOCAL, STATE AND FEDERAL JURISDICTIONS AND GOVERNING BODIES/AGENCIES STANDARDS.
- THE CONTRACTOR SHALL PROVIDE A FULL-SCALE MOCKUP AND RECEIVE APPROVAL FROM THE LANDSCAPE ARCHITECT FOR ALL SYSTEMS BEFORE BEGINNING CONSTRUCTION OF PAVEMENT.
- EXPANSION JOINTS SHALL BE PROVIDED WHERE FLATWORK MEETS VERTICAL STRUCTURES, SUCH AS WALLS, CURBS, STEPS, AND OTHER HARDSCAPE ELEMENTS. EXPANSION JOINTS SHALL ALSO BE PROVIDED AT MATERIAL CHANGES. EXPANSION JOINT MATERIALS/METHODS SHALL BE SUBMITTED TO THE LANDSCAPE ARCHITECT FOR REVIEW AND APPROVAL PRIOR TO INSTALLATION.
- CONTROL JOINTS SHOULD BE SPACED NO GREATER THAN TEN (10) LINEAR FEET MAXIMUM, UNLESS OTHERWISE SPECIFIED. EXPANSION JOINTS SHOULD BE SPACED NO GREATER THAN FORTY (40) LINEAR FEET MAXIMUM, UNLESS OTHERWISE SPECIFIED. CONTRACTOR SHALL ADVISE ON OTHER JOINTS AS NEEDED TO MINIMIZE CRACKING. THIS INFORMATION SHALL BE SUBMITTED TO THE LANDSCAPE ARCHITECT FOR REVIEW AND APPROVAL PRIOR TO INSTALLATION.
- CONTROL JOINTS SHALL BE PROVIDED AS SPECIFIED IN THE CONTRACT DOCUMENTS. CONTROL JOINT MATERIALS, METHODS AND RECOMMENDATIONS ON ADDITIONAL CONTROL JOINTS TO MINIMIZE CRACKING SHALL BE SUBMITTED TO THE LANDSCAPE ARCHITECT FOR REVIEW AND APPROVAL.
- ALL STEPS SHALL HAVE TWELVE (12) INCH TREADS AND SIX (6) INCH RISERS, UNLESS OTHERWISE SPECIFIED.
- HOLD TOP OF WALLS AND FENCES LEVEL, UNLESS OTHERWISE SPECIFIED.
- CONTRACTOR SHALL NOT INSTALL WORK LOCATED ON TOP OF ARCHITECTURAL STRUCTURES WITHOUT FIRST REVIEWING ARCHITECTURAL DRAWINGS.
- SAMPLES OF SPECIFIED MATERIALS SHALL BE SUBMITTED TO THE LANDSCAPE ARCHITECT FOR REVIEW AND APPROVAL PRIOR TO ORDERING FOR JOB.



FL. LIC: AR 0016966 FL. LIC: AA 26000837



SEAL (MARSH C. KRIPLEN-LA6667007

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> Ŕ REVISION & DATE

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MIAMI

DRB SET 08-12-2022

DRAWING TITLE

MATERIALS SCHEDULE

SHEET NUMBER

MATERIAL A

MATERIAL B

MATERIAL E





MATERIAL C




LAWN AREA



MATERIAL D

REFER TO L200 FOR MATERIALS SPECS

EAST RIVO ALTO DRIVE

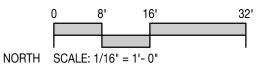

MATERIALS PLAN

SHEET NUMBER

L210

JOSE L. SANCHEZ AIA, LEED AP

278 NW 37TH ST. MIAMI, FL. 33127 P 305 576 8063

FL. LIC: AR 0016966 FL. LIC: AA 26000837

SEAL (MARSH C. KRIPLEN-LA6667007)

ADDRESS & OWNER

333 E. RIVO ALTO DRIVE MIAMI BEACH, FL. 33139 OWNER: MS KERIN K. PETERSON **NEW RESIDENCE**

REVISION & DATE

DRB SET 08-12-2022

DRAWING TITLE

TREES & PALMS PLANTING SCHEDULE

ABR	QTTY	BOTANICAL NAME	COMMON NAME	SPECIFICATIONS					
TRE	ES								
CGR	3	CAESALPINA GRANADILLO	BRIDALVEIL	16' HT / 8' SPREAD					
CRO	6	CLUSIA ROSEA	AUTOGRAPH TREE	20' x 10'					
PALI	MS								
PDA	7	PHOENIX DACTYLIFERA	DATE PALM	25' CT					
NAT	NATIVE UNDERSTORY TREES								
PDI	7	PIMENTA DIOICA	ALLPSICE	16' HT / 8' SPREAD					
HED	GES								
PMA1	66	PODOCARPUS MACROPHYLLUS	PODOCARPUS	12' TALL					
PMA2	26	PODOCARPUS MACROPHYLLUS	PODOCARPUS	6' TALL					
SHR	UBS & GRO	DUNDCOVERS							
AD	35	ASPARAGUS DENSIFLORUS	FOXTAIL FERN	3 GAL /24" O.C.					
CI	643	CHRYSOBALANUS ICACO	COCOPLUM	3 GAL / 12" O.C.					
CN	71	CLUSIA NANA	DUARF CLUSIA	3 GAL / 24" O.C.					
DI	16	DESMODIUM INCANUM	WILD PEANUT	3 GAL / 24" O.C.					
IV	27	IRIS VERSICOLOR	PURPLE IRIS	3 GAL / 24" O.C.					
LM	351	LIRIOPE MUSCARI	LILYTURF	1 GAL / 18" O.C.					
MD	11	MONSTERA DELICIOSA	SWISS CHEESE PLANT	3 GAL / 48" O.C.					
NF	40	NEPHROLEPIS FALCATA	MACHO FERN	3 GAL / 36" O.C.					
GRA	SSES								
ZJ	1073 SF	ZOYSIA JAPONICA	ZOYSIA GRASS	SOD					

PLANTING NOTES

- PLANT MATERIAL IS TO BE HEALTHY SPECIMENS FREE FROM DISEASE OR DAMAGE, AND IS TO BE MAINTAINED IN EXCELLENT CONDITION WHILE ON THE JOBSITE. LANDSCAPE ARCHITECT SHALL INSPECT PLANT MATERIAL UPON ARRIVAL TO JOBSITE AND WILL REJECT PLANT MATERIAL THAT DOES NOT MEET THE STANDARDS DESCRIBED WITHIN THE CONTRACT DOCUMENTS.
- THE LANDSCAPE ARCHITECT WILL PERIODICALLY INSPECT PLANT MATERIAL STOCKPILED AND/OR PLANTED ON SITE DURING THE COURSE OF CONSTRUCTION. PLANT MATERIAL NOT MEETING THE STANDARDS CONTAINED WITHIN CONTRACT DOCUMENTS SHALL BE REPLACED AT NO COST TO THE OWNER.
- PROVIDE MATCHING SIZES AND FORMS FOR EACH PLANT OF THE SAME SPECIES UNLESS OTHERWISE INDICATED.
- CONTRACTOR TO VERIFY ALL QUANTITIES. IN CASE OF DISCREPANCIES, GRAPHICALLY SHOWN QUANTITIES SHALL TAKE PRECEDENCE.
- ALL MATERIALS USED SHALL CONFORM TO THE GUIDELINES ESTABLISHED BY THE CURRENT AMERICAN STANDARDS FOR NURSERY STOCK, PUBLISHED BY THE AMERICAN ASSOCIATION OF NURSERYMEN.
- ALL PLANT MATERIAL SHALL BE INSTALLED PLUMB AND PER THE SPECIFICATIONS CONTAINED WITHIN THE CONTRACT DOCUMENTS. ANY NECESSARY STAKING AND/OR OTHER SUPPORTS MATERIALS/METHODS SHALL BE SUBMITTED TO THE LANDSCAPE ARCHITECT FOR REVIEW AND APPROVAL PRIOR TO INSTALLATION.
- THE CONTRACTOR SHALL PRUNE EXISTING AND/OR NEW TREES ONLY PER LANDSCAPE ARCHITECT DIRECTION.
- THE CONTRACTOR SHALL STAKE THE LOCATIONS OF ALL TREES AND B&B SHRUBS FOR LANDSCAPE ARCHITECT REVIEW AND APPROVAL, PRIOR TO
- ALL ROOT-WRAPPING MATERIALS THAT ARE NOT BIO-DEGRADABLE SHALL BE REMOVED FROM THE ROOT BALL. ROOT BALLS SHALL BE FREE OF WEEDS.
- SPECIFIED PLANT MATERIAL SIZES SHALL BE CONSIDERED MINIMUM SIZES.
- FINISH GRADE OF PLANTING BEDS SHALL BE ONE (1) INCH BELOW ADJACENT FLATWORK, UNLESS SPECIFIED OTHERWISE.
- 12. MULCH OR PLANTING BED DRESSING SHALL BE PLACED IN ALL PLANTING AREAS AS SPECIFIED. MULCH OR PLANTING BED DRESSING SHALL NOT BE PLACED WITHIN SIX (6) INCHES OF TREE TRUNKS. MULCHING SHOULD BE REPEATED ANNUALLY DURING THE AUTUMN TO A THREE (3) INCH DEPTH.
- 13. ALL PLANT MATERIAL SHOULD RECEIVE AN ORGANIC FERTILIZER IN LIMITED APPLICATION FOLLOWING INSTALLATION. TYPE AND APPLICATION RATE AND METHOD OF APPLICATION TO BE SPECIFIED BY THE CONTRACTOR AND APPROVED BY THE LANDSCAPE ARCHITECT.
- EXCESS FERTILIZER SHALL BE DISPOSED OF PROPERLY OFF-SITE. IT SHALL NOT BE DISPOSED OF IN STORM DRAINS AND/OR DRYWELLS.
- STOCKPILED PLANT MATERIAL TO BE PLACED IN THE SHADE AND PROPERLY HAND-WATERED UNTIL PLANTED.
- MINI-NUGGET TYPE DECORATIVE BARK MULCH WILL BE USED TO RETURN NUTRIENTS TO THE SOIL, REDUCE MAINTENANCE AND MINIMIZE EVAPORATION 16. FOR AREAS APPROXIMATE TO THE RESIDENCE. LARGER SHREDDED BARK MULCH WILL BE USED FOR STEEP AREAS SO SLOUGHING IS LESS LIKELY TO OCCUR.
- PRESERVE & PROTECT ALL EXISTING VEGETATION INDICATED TO REMAIN AT ALL TIMES.
- ALL VEGETATION PROPOSED FOR OUTSIDE THE BUILDING ENVELOPE TO BE NATIVE UNLESS OTHERWISE NOTED. PLANTING THAT OCCURS OUTSIDE THE BUILDING ENVELOPE IS FOR RESTORATION PURPOSES ONLY OR IS SPECIFIC TO UTILITIES RESTORATION.
- SIX (6) INCH PLANT MIX SHALL BE PROVIDED FOR ALL LAWN. TURF, AND NATIVE PLANTING ZONES. 18 INCH PLANT MIX SHALL BE PROVIDED FOR ALL PERENNIAL PLANTING BEDS UNLESS OTHERWISE NOTED.

PLANTING LEGEND

	MUNICIPALITY: City of Miami Beach			
ORD	ZONING CLASS: RS-3 LOT AREA: 10,500 INANCE/CODE SECTION: CITY OF MIAMI BEACH SECTION 126	ACRES:	0.2410	
OPEN S	PACE	REQUIRED/ ALLOWED	PROVIDED	
Α.	Sq. Ft. of required Open Space	3,150	3,150	
	Lot area: 10,500 Multiplier: 30%			
В.	Sq. Ft. of parking lot open space Parking Spaces: 2 Multiplier: 10 sf/space	20	20	
C.	Total Sq. Ft. of landscaped Open Space required	3,170	3,170	
LAWN A	AREA			
Α.	Total Sq. Ft. of landscaped Open Space	3,170	3,170	
В.	Maximum Lawn Area (sod) permitted- Open space required: 3,170 Multiplier: 20%	634	766	
TREES				
A.	Number of trees required per lot, less existing trees Required Trees/Lot: 28 Net lot acres: 0.2410 Required Trees: 16 Existing trees: 0	16	16	
В.	% Palms allowed	0	0	
PER CODE	Trees provided: 16 Multiplier: 0% SECTION 126-6.C.10 PALMS DO NOT COUNT TOWARD MIN. TREE REQU	IREMENTS		
C.	% Native required	5	5	
.	Trees provided: 16 Multiplier: 30%			
D.	% Drought tolerant and low maintenance species required Trees provided: 16 Multiplier: 50%	8	8	
STREET	TREES			
NO WORI A.	(IN THE ROW INCLUDED IN THIS SCOPE Street trees (maximum average spacing of 20' o.c.)	3	3	
Lin	ear ft of street frontage: 60 Multiplier: 20 Existing trees: 0			
B. Lin	ZONING CLASS: RS-3 LOT AREA: 10,500 ACR ORDINANCE/CODE SECTION: CITY OF MIAMI BEACH SECTION 126 PEN SPACE REQUIRED CODE SPACE ALLOWER ALLOWER ALLOWER ALLOWER SQ. Ft. of required Open Space Lot area: 10,500 Multiplier: 30% Sq. Ft. of parking lot open space Parking Spaces: 2 Multiplier: 10 sf/space Total Sq. Ft. of landscaped Open Space required 3,170 Multiplier: 20% WN AREA Total Sq. Ft. of landscaped Open Space 3,170 Multiplier: 20% EES Number of trees required per lot, less existing trees 634 Net lot acres: 0,2410 Required Trees/Lot: 28 Net lot acres: 0,2410 Required Trees: 0		0	
CUDIID	· ——			
<u> 3пков:</u> А.		252	252	
Lot ar				
В.	Shrubs provided: 252	126	126	
LARGE	SHRUBS OR SMALL TREES			
A.	Shrubs required: 252	25	25	
В.		33	33	

JOSE L. SANCHEZ AIA, LEED AP

278 NW 37TH ST. MIAMI, FL. 33127 P 305 576 8063

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SEAL (MARSH C.

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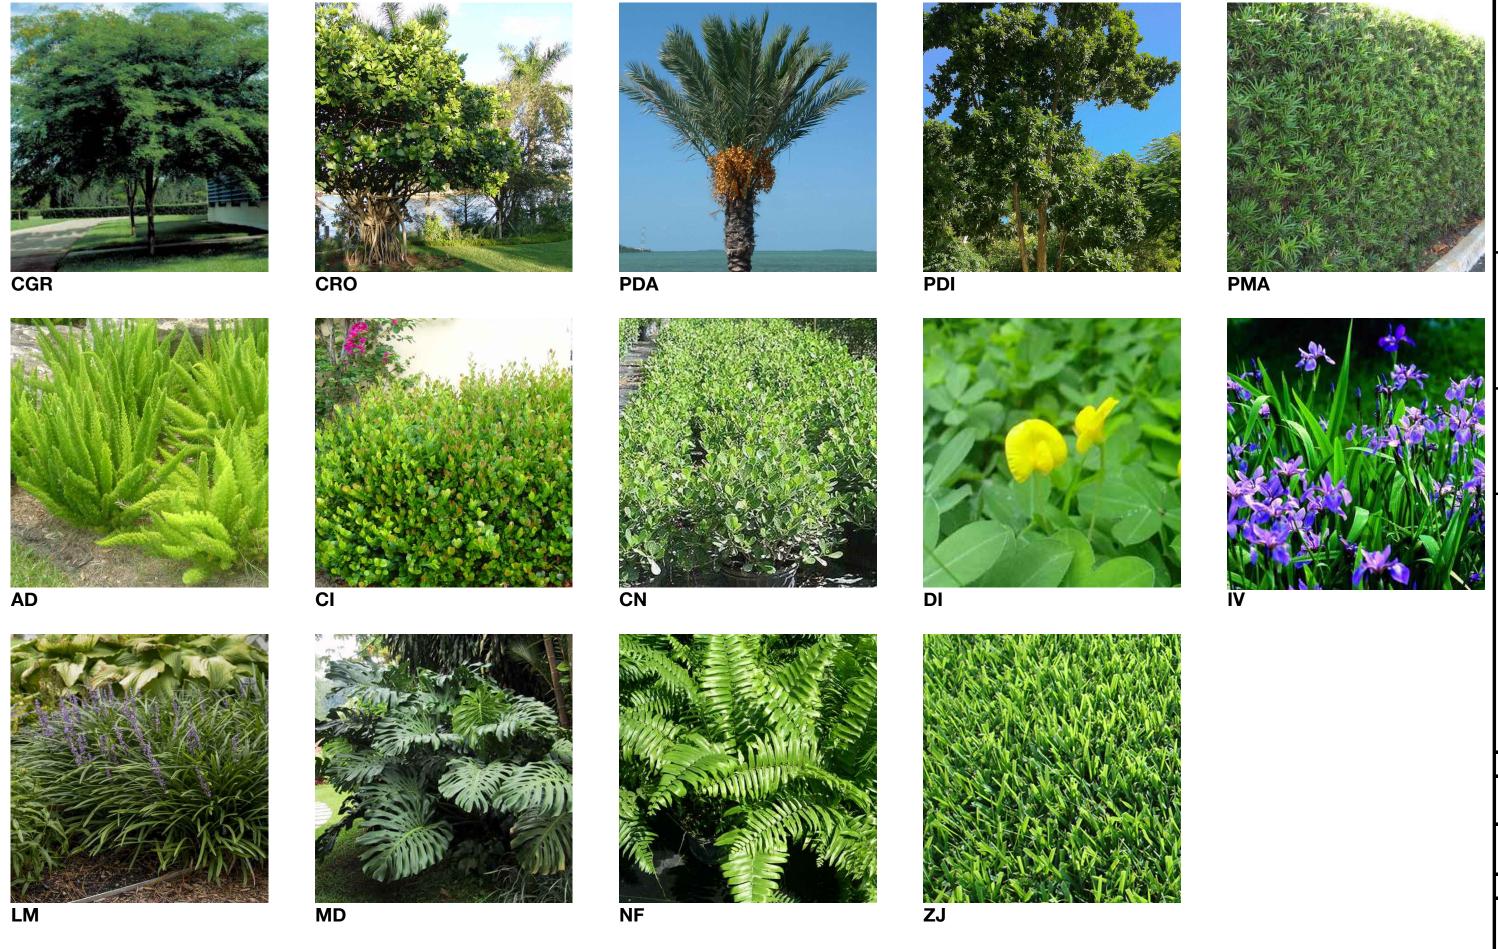
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DRB SET 07-20-202

PLANTING SCHEDULE & NOTES



JOSE L. SANCHEZ AIA, LEED AP

278 NW 37TH ST. MIAMI, FL. 33127 P 305 576 8063

FL. LIC: AR 0016966 FL. LIC: AA 26000837

SEAL (MARSH C. KRIPLEN-LA6667007)

ADDRESS & OWNER

RIVO ALTO DRIVE BEACH, FL. 33139 IAMI BEACH, FL. 3313 OWNER: MS KERIN K. PETERSON **NEW RESIDENCE** 333 E. F MIAMI

REVISION & DATE

DRB SET 08-12-2022

DRAWING TITLE
PLANTING PALETTE


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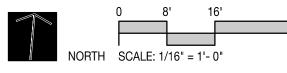
PLANTING LEGEND









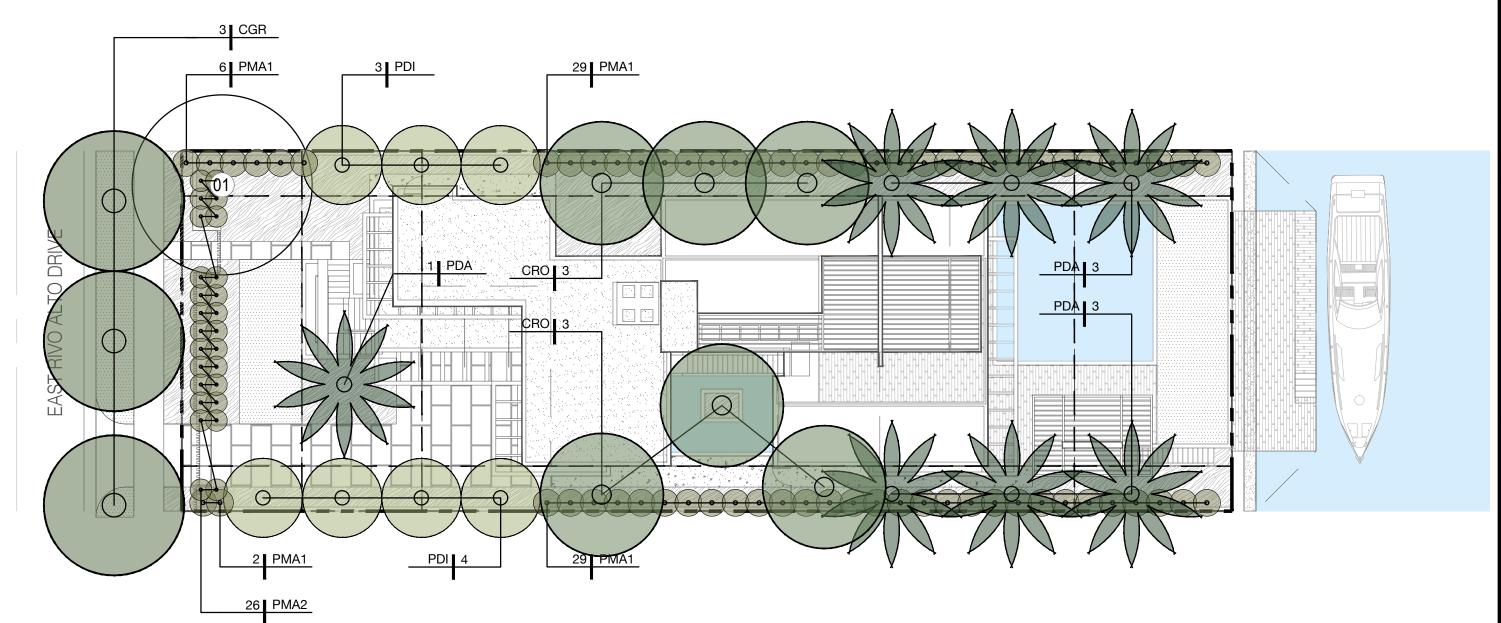

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JOSE L. SANCHEZ AIA, LEED AP

278 NW 37TH ST. MIAMI, FL. 33127 P 305 576 8063

FL. LIC: AR 0016966 FL. LIC: AA 26000837

SEAL (MARSH C. KRIPLEN-LA6667007)

ADDRESS & OWNER

NEW RESIDENCE

333 E. RIVO ALTO DRIVE MIAMI BEACH, FL. 33139 OWNER: MS KERIN K. PETERSON

REVISION & DATE

DRB SET

08-12-2022

DRAWING TITLE
TREES & PALMS PLANTING PLAN

SHEET NUMBER


PLANTING LEGEND

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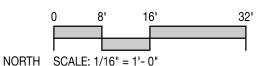
PROPOSED SHRUB OR GROUNDCOVER



PROPOSED LAWN AREA



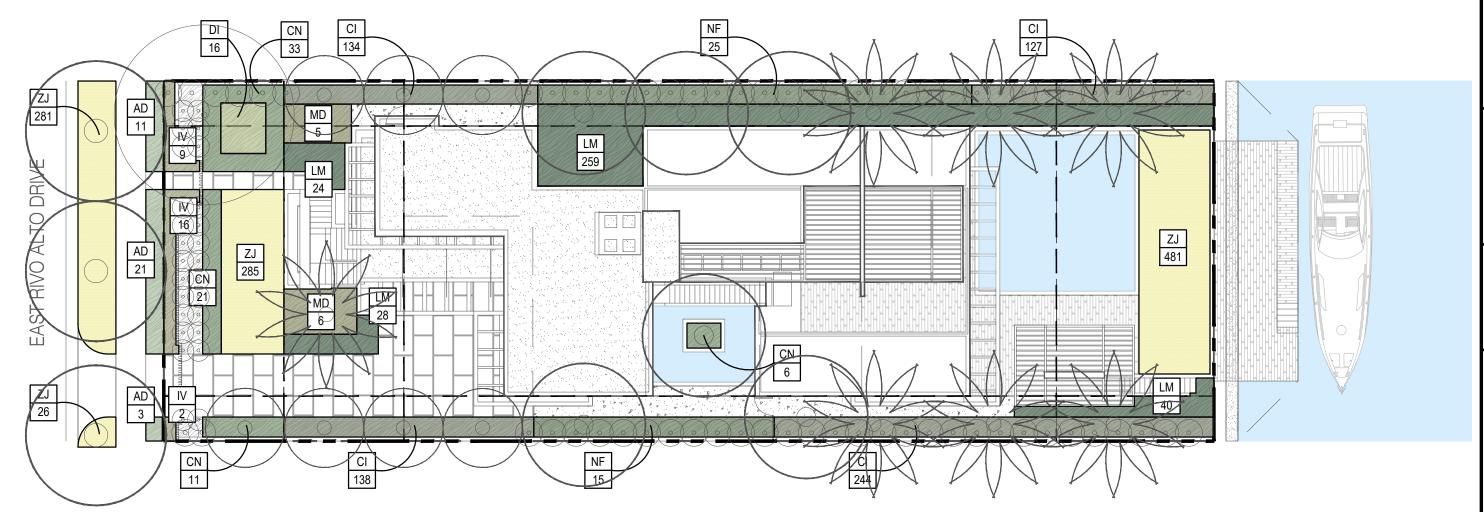



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JOSE L. SANCHEZ AIA, LEED AP

278 NW 37TH ST. MIAMI, FL. 33127 P 305 576 8063

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SEAL (MARSH C. KRIPLEN-LA6667007)

ADDRESS & OWNER

333 E. RIVO ALTO DRIVE MIAMI BEACH, FL. 33139 OWNER: MS KERIN K. PETERSON **NEW RESIDENCE**


REVISION & DATE

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DRAWING TITLE UNDERSTORY PLANTING PLAN


SHEET NUMBER

TOP OF STAKE MUST BE MINIMUM OF 3" BELOW FINISHED GRADE

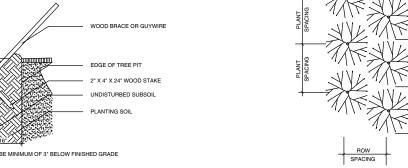

PLANT SPACING

PLANT SPACING
SCALE: NOT TO SOAL 5

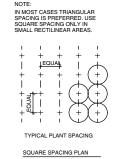

EXCAVATE PLANTING BED AS A WHOLE REMOVE ROOTS, ROCKS, & OTHER
DEBRIS & CONTAMINANTS. TAKE EXISTING
NATIVE SOIL, (ROCKY FILL, SAND OR SIMILAI
AND BLEND "GEOMANTIC MIX" AT 50/50 RAT
AND LAY PLANTING SOIL MINIMUM 6" DEEP.

GRADE

SHRUB- HEDGE AND MASS PLANTING

CLEATS


2 x 4 x 8"

2 x 4 x 12"

CALIPER

3" - 8"

8" - 10"

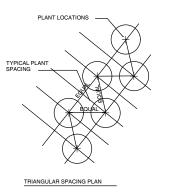

PLACE SO THAT MATURE PLANTS WILL NOT OVERLAP ONTO SIDEWALK OR PAVED AREA VARIES WITH PLANT SPECIES

WALK OR FINISH GRADE


BE 1" BELOW PAVE OR 1" ABOVE SOD

NAILS

2 - 16d

3 - 16d

DECOMPACT EXISTING SUB GRADE TO A DEPTH OF +/- 6" BELOW ROOT BALL WITH BACKHOE TEETH OR SIMILAR CHECK FOR UNDERGROUND UTILITIES PRIOR COMMENCEMEN

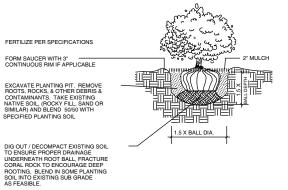

3 SHRUB PLANTING
SCALE: NOT TO SCALE

-2" LAYER OF MULCH - FINISH GRADE / SOD OR PAVING BREAK- UP COMPACTED SUBGRADE & BOCK TO A DEPTH OF 1 1/2 TIMES HE SIZE OF ROOT BALL EXISTING UNDISTURBED SUBSOIL - EXIS IING UNIDIS UNBED SUBSOIL
EXCAVATE PLANTING PIT. REMOVE
ROOTS, ROCKS, & OTHER DEBRIS &
CONTAMINANTS. TAKE EXISTING
NATIVE SOIL, (ROCKY FILL, SAND OR
SIMILAR) AND BLEND 5030 WITH
PLANTING SOIL (7030 SAND/MUCK)

GUYING WIRES OR RUBBER TUBING CAN BE SUBSTITUTED FOR WELLINGTO TAPE FOR BRACING TREES WITH PRIOF APPROVAL BY LANDSCAPE ARCHITECT

9 SHRUB- HEDGE AND MASS PLANTING

BOW SPACING

20.8"

26.0" 31.2"

PREPARATION:
STORE ALL INATERIAL IN DRY, CLEAN AREA, COVER TO PROTECT FROM RAIN AND MINIMIZE DUST. COORDINATE RUN-OFF CONTROL WITH
GENERAL CONTRACTOR.

TEST EXISTING SOIL TO ENSURE IT IS FREE OF EXCESSIVE CLAY OR SALT AND ANY CHEMICALS/PETROCHEMICALS WHICH MAY HARM PLANT HEALTH.

EXISTING MATERIAL: IN INCORPORATING STITE SOIL REMOVE ALL ROOTS, AND ROCK LARGER THAN 2' IN SIZE. REMOVE ALL PLASTIC, METAL AND MANMADE DETRITUS.

MIX: 50% EXISTING SOIL 10% COCO PEAT 20% CLEAN SAND 10% PERLITE

STAKING DETAIL

BLEND QUANTITIES NEEDED BY HAND OR MACHINE

INSTALLATION: REFER TO APPROPRIATE DETAILS FOR AMENDMENTS, COMPACTION DEPTHS ETC. GENERAL: REFER TO LANDSCAPE NOTES FOR ADDITIONAL INFORMATION

4 PLANTING SOIL- TYPICAL

PINE STRAW, FOR USE IN GENERAL PLANTING AREAS AND ON SLOPES GREATER

MULCH B: MINI PINE BARK NUGGETS, FOR USE IN SPECIALTY AREAS

MULCH C: MELALEUCA MULCH, FOR USE IN GENERAL PLANTING AREAS AND ON SLOPES

BLEND QUANTITIES NEEDED BY HAND OR MACHINE.


INSTALLATION: REFER TO APPROPRIATE DETAILS FOR EXTENTS AND DEPTHS.

GENERAL: REFER TO LANDSCAPE NOTES FOR ADDITIONAL INFORMATION, CONFIR
TYPE TO BE USED WITH LANDSCAPE ARCHITECT PRIOR TO INSTALLATION.

MULCH- TYPICAL


SUPPLIER: ATLAS PEAT AND SOIL 561 734 7300

PLANTING SOIL- LAWN TOP DRESSING

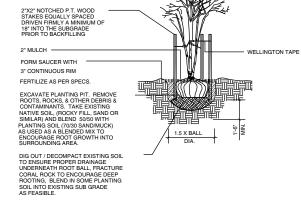



CALIPER	TIES	STRANDS	STAKES
1" - 1 1/2"	2	1 # 12	2-2 X 2
1 1/2" - 2"	3	1 # 12	3-2 X 2
2" - 3"	3	2 # 12	2-2X2

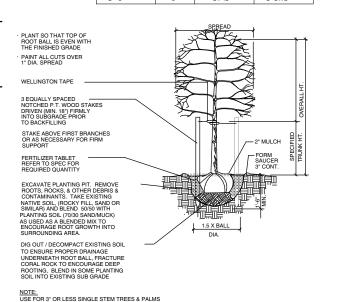

CANOPY AND PALM TREE- PLANTING & VERTICAL STAKING
SCALE: NOT TO SCALE

3 - 16d 10" - 16" 2 # 12 4 - 2 X 4 2 x 4 x 12" NOTE PLANT SO THAT TOP OF ROOT BALL IS EVEN WITH THE FINISHED GRADE STAKE TO FIRST BRANCHES AS NECESSARY FOR FIRM SUPPORT WIRE SHALL NOT TOUCH OR RUB ADJACENT TRUNKS OR BRANCHES WOODEN CLEATS WILL BE EQUALLY SPACED OVER PADDING & SECURED W/ STEEL BANDS EQUALLY SPACED 2" X 4" — P.T. WOOD STAKES NAILED TO CLEATS. DO NOT NAIL TO TRUNK FERTILIZER TABLET REFER TO SPEC FOR REQUIRED QUANTITY EXCAVATE PLANTING PIT. REMOVE ROOTS, ROCKS, & OTHER DEBRIS & CONTAMINANTS. TAKE EXISTING NATIVE SOIL, (ROCKY FILL, SAND OR SIMILAR) AND BLEND 50/50 WITH REFER TO STAKING DETAIL AND BLEND SOISO WITH PLANTING SOIL (70/30 SAND/MUCK) AS USED AS A BLENDED MIX TO ENCOURAGE ROOT GROWTH INTO SURROUNDING AREA. DIG OUT / DECOMPACT EXISTING SOIL

STRAPS

1 # 12

1 # 12


BRACES

3-2X4

3-2X4

- 5 LAYERS OF BURLAP IF SOFT SKIN TRUNK — 5-(2"X4"X16") WOOD BATTENS STEEL BAND TOF NAIL TO BATTEN FORM SAUCER WITH 3" CONT. MIN. 3-(2"X4") REFER TO STAKING DETAIL EXCAVATE PLANTING PIT. REMOVE
ROOTS, ROCKS, & OTHER DEBRIS &
CONTAMINANTS. TAKE EXISTING NATIVE SOIL
(ROCKY FILL, SAND OR SIMILAR) AND BLEND
(SOUTH PLANTING SOIL (2709) AND BLEND 50/50 WITH PLANTING SOIL (70/30 SAND/MUCK AS USED AS A BLENDED MIX TO ENCOURAGE ROOT GROWTH INTO SURROUNDING AREA. - DIG OUT / DECOMPACT EXISTING SOIL TO ENSURE PROPER DRAINAGE UNDERNEATH ROOT BALL, FRACTURE CORAL ROCK TO ENCOURAGE DEEP ROOTING, BLEND IN SOME PLANTING SOIL INTO EXISTING SUB GRADE

PALM- PLANTING & STAKING SCALE: NOT TO SCALE

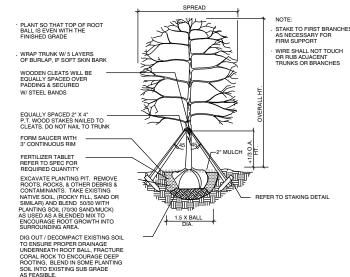

CANOPY TREE- PLANTING & TRIPLE BRACE STAKING
SCALE: NOT TO SCALE

NOTE: USE FOR 3" TO 12" SINGLE TRUNK TREES

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JOSE L. SANCHEZ AIA. LEED AP 278 NW 37TH ST. MIAMI. FL. 33127 P 305 576 8063 FL. LIC: AR 0016966 FL. LIC: AA 26000837

7294

SEAL (MARSH C.

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ADDRESS & OWNER

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MIAMI 3 REVISION & DATE

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3 Ś OWNER:


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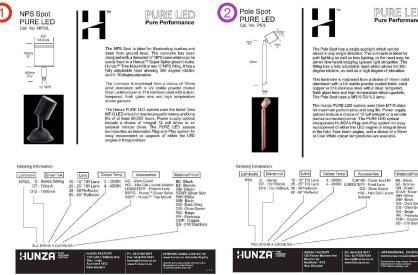
DRAWING TITLE **PLANTING DETAILS**

SCALE: DATE: AS SHOWN 07-20-2022 SHEET NUMBER

LIGHTING LEGEND

	TYPE	MANUFACTURER	SPEC
1	DOWNLIGHT	HUNZA	NPS/L
2	UPLIGHT	HUNZA	PS/L



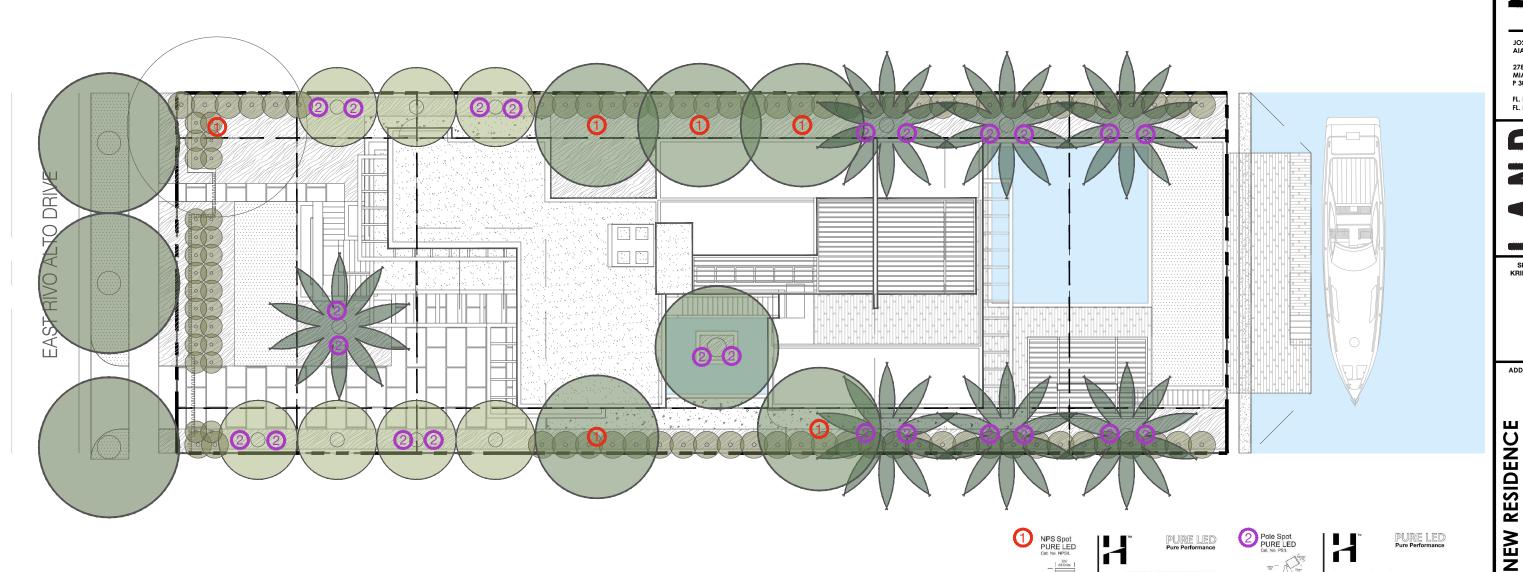



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Draxis

JOSE L. SANCHEZ AIA, LEED AP

278 NW 37TH ST. MIAMI, FL. 33127 P 305 576 8063

FL. LIC: AR 0016966 FL. LIC: AA 26000837

SEAL (MARSH C. KRIPLEN-LA6667007)

ADDRESS & OWNER

333 E. RIVO ALTO DRIVE MIAMI BEACH, FL. 33139 OWNER: MS KERIN K. PETERSON

REVISION & DATE

DRB SET 08-12-2022

DRAWING TITLE LIGHTING PLAN

SHEET NUMBER

SCOPE OF WORK

THE FOLLOWING DRAWINGS ILLUSTRATE THE PROPOSED SCOPE OF WORK FOR 333 E. RIVO ALTO DRIVE, MIAMI, F 33139, TO BE PERMITTED BY CITY OF MIAMI BEACH • NEW LANDSCAPE DESIGN

DRAWING REVISION REGISTER


REV# SHEET # REVISION DESCRIPTION

DRB SUBMIT

SHEET INDEX

LANDSCAPE DRAWINGS **DRAWING NOTES** LCVR COVER PAGE L002 GENERAL SITE NOTES TD100 TREE DISPOSITION SCHEDULE & NOTES TD110 TREE DISPOSITION PLAN L200 MATERIALS SCHEDULE MATERIALS PLAN TREES & PALMS PLANTING SCHEDULE & NOTES L401 PLANTING PALETTE TREES & PALMS PLANTING PLAN L410 L450 PLANTING DETAILS L800 LIGHTING PLAN

LOCATION MAP

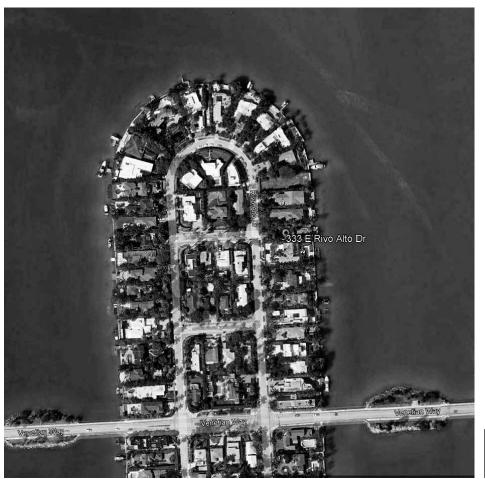



SCALE: AS SHOWN DATE: 07-20-2022 SHEET NUMBER

REVISION & DATE DRB SET

DRAWING TITLE **COVER PAGE**

JOSE L. SANCHEZ AIA, LEED AP

278 NW 37TH ST. MIAMI, FL. 33127 P 305 576 8063

FL. LIC: AR 0016966 FL. LIC: AA 26000837

SEAL (MARSH C. KRIPLEN-LA6667007)

ADDRESS & OWNER

ALTO DRIVE CH, FL. 33139

NEW RESIDENCE

333 E. RIVO ALIO CILLO AIIA MIAMI BEACH, FL. 33139 OWNER: MS KERIN K. PETERSON

08-12-2022

LCVR


TREE	TREE - LATIN NAME	TREE - COMMON NAME	I BREAST HEIGHT (in I	APPROXIMA TE HEIGHT (in feet)	CANOPY DIAMETER (in feet)	CRITICAL ROOTZONE RADIUS (in feet)	CONDITION	DISPOSITION	REMOVAL- MUNICIPAL CRITERIA			
No.									PALM	CANOPY		
									1:1	DBH		
	SWETENIA MAHOGANI	MAHOGANY TREE	33"	28'	40'			REMAIN				
2		PALM	19"	30'	25'			REMOVE	1			
3		PALM	11"	28'	12'			REMOVE	1			
4	1440AUEED 1 141D10 1	PALM MANOO TREE	9"	20'	8'			REMOVE	1	0.4		
	MAGNIFERA INDICA	MANGO TREE	24"	30'	25'			REMOVE		24		
6		PALM PALM	24"	30'	16'			REMOVE	1			
8		PALIVI	24" 30"	30' 20'	14' 10'			REMOVE	1			
	COCOS NUCIFERA	COCONUT PALM	12"	30'	18'			REMOVE REMOVE	1			
	COCOS NUCIFERA	COCONUT PALM	11"	30'	16'			REMOVE	1			
11	COCO NOON LIVA	PALMS CLUSTER	6"	25'	10'			REMOVE	1			
12		PALMS CLUSTER	6"	20'	10			REMOVE	1			
13		PALMS CLUSTER	6"	20'	10'			REMOVE	1			
	MUSA ACUMINATA	BANANA	11"	12'	18'			REMOVE		11		
	LIVISTONA CHINENSIS	CHINESE FAN PALM	66"	10'	12'			REMOVE	1	· · · ·		
	LIVISTONA CHINENSIS	CHINESE FAN PALM	24"	10'	4'			REMOVE	1			
	LIVISTONA CHINENSIS	CHINESE FAN PALM	36"	15'	7'			REMOVE	1			
	COCOS NUCIFERA	COCONUT PALM	11"	25'	18'			REMOVE	1			
19	COCOS NUCIFERA	COCONUT PALM	11"	25'	20'			REMOVE	1			
	COCOS NUCIFERA	COCONUT PALM	11"	25'	18'			REMOVE	1			
21	COCOS NUCIFERA	COCONUT PALM	11"	25'	18'			REMOVE	1			
22		PALM	6"	25'	12'			REMOVE	1			
23	SCHEFFLERA ACTINOPHYLLA	OCTOPUS TREE	12"	20'	18'			REMOVE		12		
24	SCHEFFLERA ACTINOPHYLLA	OCTOPUS TREE	36"	30'	18'			REMOVE		36		
	COCOS NUCIFERA	COCONUT PALM	18"	25'	20'			REMOVE	1			
26	MAGNIFERA INDICA	MANGO TREE	11"	15'	12'			REMOVE		11		
27		PALM	18"	35'	20'			REMOVE	1			
28		PALM	7"	15'	8'			REMOVE	1			
29												
						_						
							ROM PROPOSEI				1.	
							OTAL UNITS TO	BE REMOVED	22	94	inches	
			-	TOTAL ESTIMA	ATED REQUIRE	D ON SITE MITIGA	TION PER CODE	E (2"DBH/12HT):		14	trees	
						PROPOSED ON	SITE MITIGATIO	N BREAKDOWN			·	TREE CREDIT
						С	ANOPY TREE I- 2	2"DBH/12'HT MIN:				0
	CANOPY TREE II- 4"DBH/16"HT MIN:									4	one CT II is equal to two CT I	8
NATIVE - 1.5"DBH/10'HT MIN									10	up to 30% of required CT I	10	
								B"DBH/14'HT MIN			up to 30% of required CT I at 2 palm/tree	0
TOTAL PROPOSED REPLACEMENT TREES (REFER TO PLANTING PLANS):									14	OMBINATION FULFILLS SITE MITIGATION O	18	

TREES & PLANTING TO BE REMOVED NOTES


- THE CONTRACTOR IS TO COMPLETELY REMOVE ALL PLANTER MATERIAL DESIGNATED FOR REMOVAL (I.E. ROOT BALL, DEBRIS, SAW DUST, ETC.).
- THE CONTRACTOR IS TO BACKFILL ALL EXCAVATED ROOT BALLS FLUSH TO THE ADJACENT ELEVATION LEVEL
- CONTRACTOR TO NOTIFY LANDSCAPE ARCHITECT TWO WEEKS IN ADVANCE OF ALL SCHEDULED WORK PERTAINING TO THE RELOCATION OF SITE TREES.

TREES & PLANTING TO BE PRESERVED NOTES

- EXISTING TREES TO BE PRESERVED SHALL BEAR SAME RELATIONSHIP TO FINISHED GRADE AS THEY BEAR TO PRE-CONSTRUCTION GRADE.
- EXISTING TREES TO BE PRESERVED SHALL BE PROTECTED WITH STURDY. WEATHERPROOF FENCING AT A MINIMUM FOUR (4) FEET HEIGHT INSTALLED NO CLOSER TO THE TREE TRUNK THAN ITS DRIPLINE. THIS FENCE SHALL BE MAINTAINED IN WORKING ORDER DURING ALL PHASES OF CONSTRUCTION. MAINTAIN TREE PROTECTION ZONES FREE OF WEEDS AND
- NO WORK SHALL BE CONDUCTED WITHIN THE DRIPLINE, UNLESS REVIEWED AND APPROVED BY THE LANDSCAPE ARCHITECT. ALL WORK APPROVED WITHIN THE DRIPLINE SHALL BE COMPLETED BY HAND. PROTECT ROOT SYSTEMS FROM PONDING, ERODING, OR EXCESSIVE WETTING.
- THE PROJECT LIMIT OF CONSTRUCTION AND ALL EXISTING VEGETATION TO REMAIN IS TO BE CLEARLY DEFINED BY STURDY, WEATHERPROOF FENCING AT A MINIMUM OF FOUR (4) FEET HIGH.

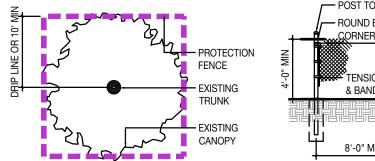

- PROTECTION FENCE SHALL BE GALVANIZED CHAIN LINK STANDARD 2" x 2" MESH
- PROVIDE HINGED GATE
- ALTERNATE: 2" x 4" WOOD POSTS (6'-0" O.C. MAX) WITH THREE EVENLY SPACED WOODEN RAILS. MIN. HT 4'
- POSTS MAY BE SHIFTED TO AVOID ROOTS
- NO STORAGE, DEBRIS, VEHICULAR TRAFFIC OR EQUIPMENT CLEANING IS ALLOWED WITHIN THE PROTECTED AREA.
- REFER TO MUNICIPAL REQUIREMENTS FOR ADDITIONAL INFORMATION

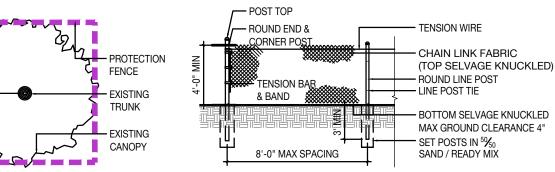

DRAWING TITLE TREE DISPOSITION **SCHEDULE & NOTES**

SHEET NUMBER

TD100

JOSE L. SANCHEZ AIA, LEED AP

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SEAL (MARSH C. KRIPLEN-LA6667007)

ALTO DRIVE CH, FL. 33139

RIVO

333

REVISION & DATE


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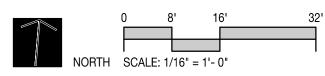
BEACH, F

08-12-2022

OWNER: / MIAMI

NEW RESIDENCE



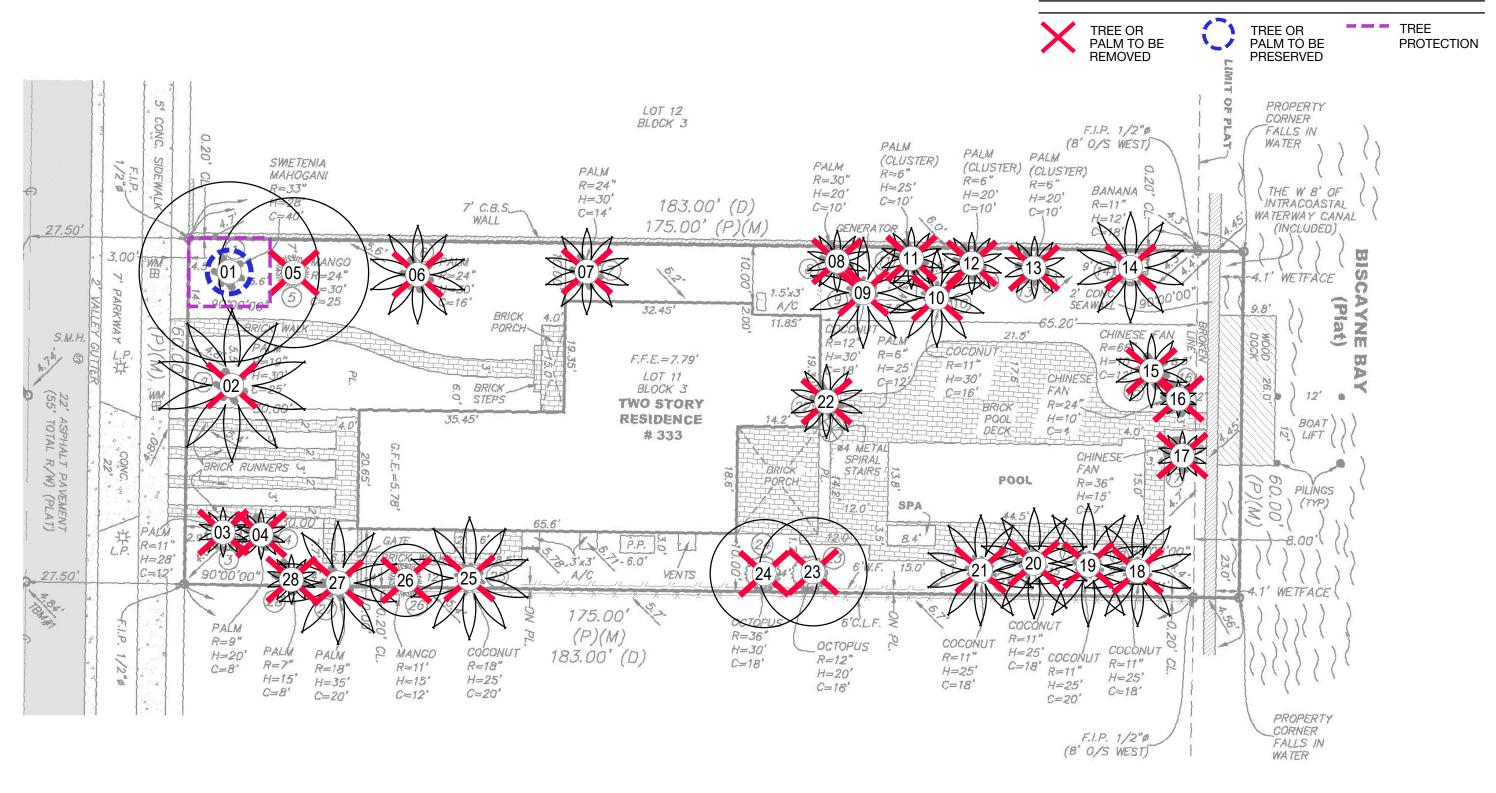

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278 NW 37TH ST. MIAMI, FL. 33127 P 305 576 8063

FL. LIC: AR 0016966 FL. LIC: AA 26000837

SEAL (MARSH C. KRIPLEN-LA6667007)

ADDRESS & OWNER

ALTO DRIVE CH, FL. 33139 MIAMI BEACH, FL. 3313 OWNER: MS KERIN K. PETERSON **NEW RESIDENCE** E. RIVO

REVISION & DATE

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333

TREE DISPOSITION PLAN

SHEET NUMBER

TD110