

1590 BAY DR. 1595 BAY DR. 1600 BAY DR. 1605 BAY DR. 1615 BAY DR. 1624 BAY DR. 1625 BAY DR. 1630 BAY DR. 1631 BAY DR. 10. 1635 BAY DR. 11. 1640 BAY DR.

12. 1650 BAY DR.







CONTEXTUAL ELEVATION



Sanchez Oatro: 2022.09.02 17:10:48

ENCE

1610 BAY DRIVE MIAMI BEACH, FLORIDA. OWNER: NEW RESID

DRAWING TITLE

AERIAL/ **PROPERTY** MAP

SCALE: AS SHOWN DATE: 09-26-2021

August 22, 2022

Design Review Board Members

c/o Michael Belush, Chief of Planning & Zoning Planning Department City of Miami Beach 1700 Convention Center Drive, 2nd Floor Miami Beach, Florida 33139

Re:

DRB22-0874, 1610 Bay Drive, Miami Beach

Letter of Support

Dear Board Members:

I am the owner of 1600 Boy Of We. Miami Beach, Florida, which is abutting or in close proximity to the above-referenced property. I spoke with the applicants and reviewed the plans, renderings and design requests for the proposed new, two-story single-family residence. The home is beautifully-designed, consistent with the scale of surrounding homes, and will be a welcome addition to the neighborhood. The applicants are not proposing a larger home than permitted and the massing is centrally located on the lot. The generous setbacks and lush landscaping minimize any impacts of the new home.

Based on the foregoing, I fully support the applicants' new home and ask the Design Review Board to grant the design review approval with the associated design waiver.

Sincerely,

Signature

Print name

September 6, 2022

James Bodnar, Chair, and Miami Beach Design Review Board Members

c/o Michael Belush, Chief of Planning & Zoning Planning Department City of Miami Beach 1700 Convention Center Drive, 2nd Floor Miami Beach, Florida 33139

DRB22-0874, 1610 Bay Drive, Miami Beach, Miami-Dade County, Florida 33141
 <u>Letter of Support</u>

Dear Mr. Bodnar and Miami Beach Design Review Board Members:

I have been the owner of 1624 Bay Drive, Miami Beach, Florida, for more than 33 years, since 1988, which is the property adjacent to on the west side of the above-referenced property. I have communicated with the applicants and reviewed the plans, renderings and design requests for their proposed new, two-story single-family residence to be constructed at 1610 Bay Drive, Miami Beach, FL. In my opinion, the applicant, his wonderful family and the home as shown on the plans I was provided will be a welcome addition to the neighborhood.

I was informed that a variance or waiver is being requested for the second story on the east side of the new house to be constructed from 60 foot to a requested 65 feet. I have no objections to this variance or waiver.

Based on the foregoing, I fully support the applicants' new home as shown on the plans I was provided and respectfully request the Design Review Board grant the design review approval with the above-stated design waiver or variance for the applicants' new home at 1610 Bay Drive, Miami Beach, Florida.

Yours truly,

Jeff Cynamon 1624 Bay Drive

Miami Beach, Florida 33141





NEIGHBORHOOD CONTEXTUAL VIEW



FRONT VIEW RENDERING 1



SIDE VIEW / 3D PERSPECTIVE



SIDE VIEW / 3D PERSPECTIVE



FRONT VIEW RENDERING 2

architecture . design
. SANCHEZ, AIA, LEED AP
W 37TH ST. MIAMI, FL. 33127



Jose L
Sanchez

Sanchez

Digitally signed by Jose L
Sanchez, c=US
0=Praxis Architecture, Inc.,
email=jaanchez@praxisarch.ct
Date: 2022.09.02 17:31:36 04'00'

COPYRIGHT © 2022. ALL RIGHTS RESERVED.

HESE DRAWINGS AND DOCUMENTS ARE INSTRUMENTS OF ERVICE AND SHALL REMAIN THE PROPERTY OF PRAXIS ARCHITECTURE + DESIGN, WHETHER THE PROJECT FOR WHICH THEY WERE PREPARED IS EXECUTED OR NOT THEY ARE NOT TO BE USED IN ANY MANNER ON OTHER ROJECTS OR EXTENSIONS TO THIS PROJECT EXCEPT BY GREEMENT IN WRITING AND WITH THE APPROPRIATE COMPENSATION TO PRAXIS ARCHITECTURE + DESIGN, BERCOLUCTIONS OF DRAWINGS & SPECIFICATIONS WITHOUT THE WRITTEN CONSENT OF PRAXIS ARCHITECTURE DESIGN IS PROHIBITED. CONTRACTORS RESPONSIBLE FOR ERIFTING ALL SITE CONDITIONS PRIOR TO PROCEEDING

ADDRESS & OWNI

RESIDENCE
10 BAY DRIVE
ACH, FLORIDA. 33141

REVISION & DATE

4


DRAWING TITLE

CONTEXTUAL/ PERSPECTIVE VIEWS


SCALE: AS SHOWN DATE: 09-26-2021

DATE: 09-26-202


3D-1.0

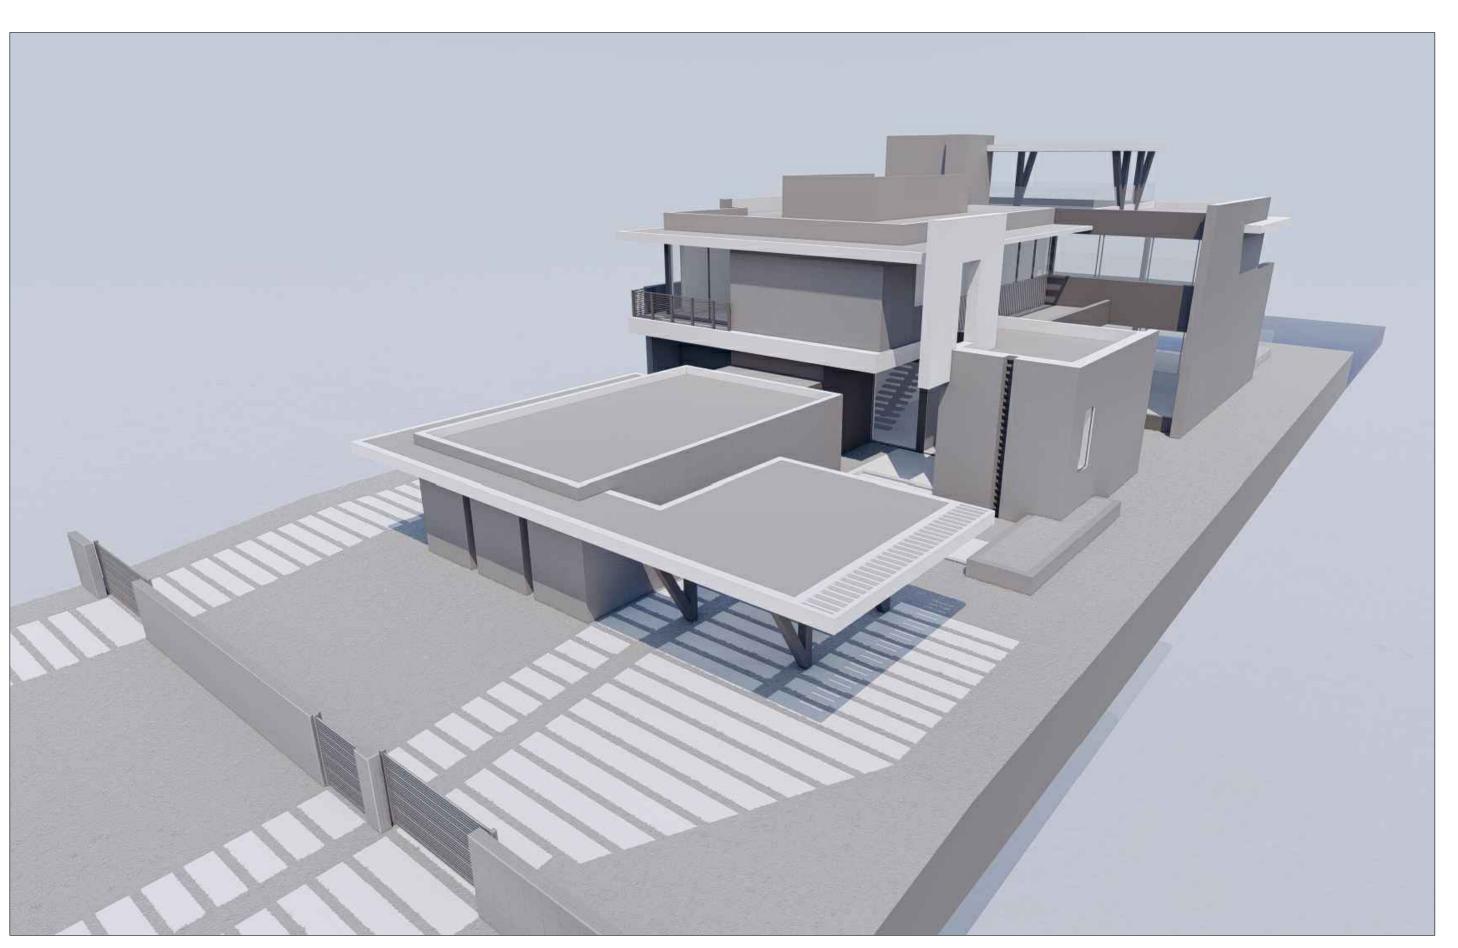


PERSPECTIVE VIEW 1 - SIDE/FRONT

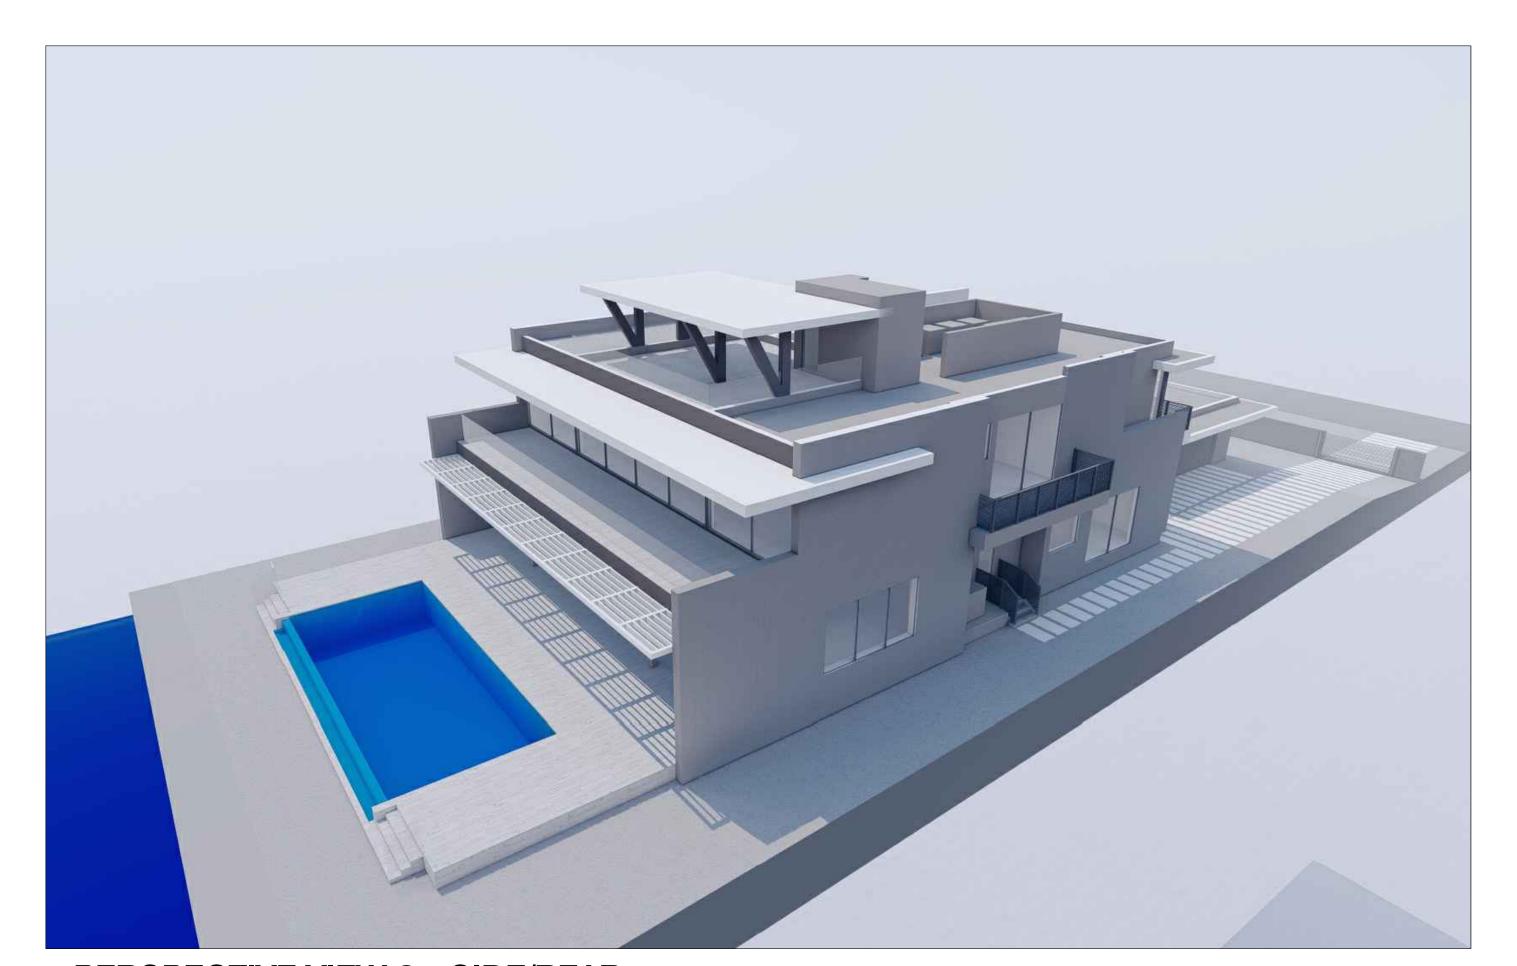

PERSPECTIVE VIEW 3 - SIDE/REAR

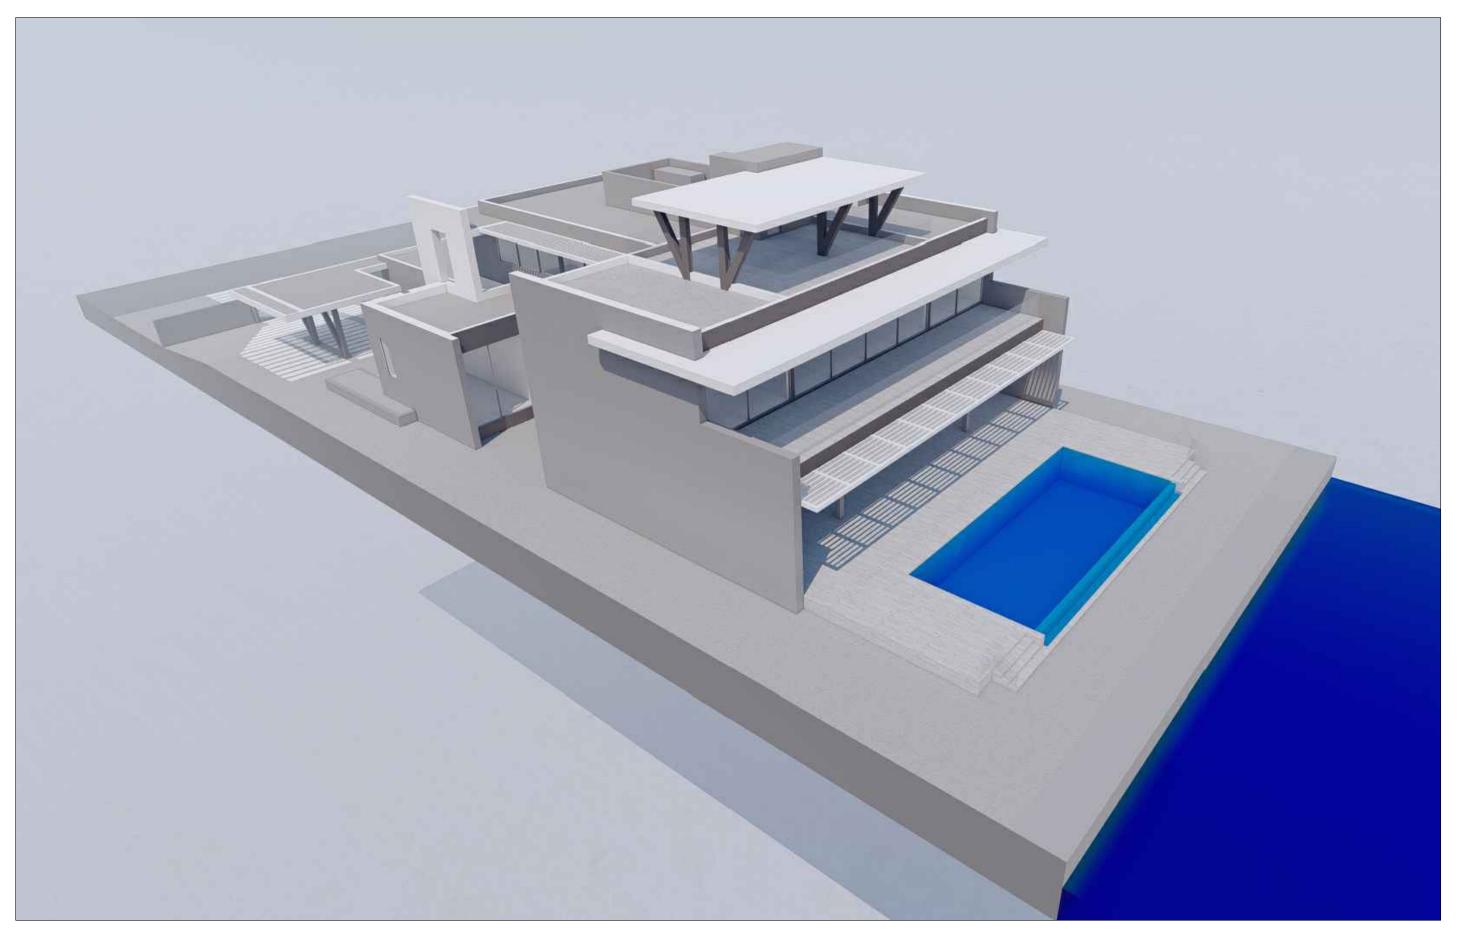

PERSPECTIVE VIEW 2 - SIDE/REAR

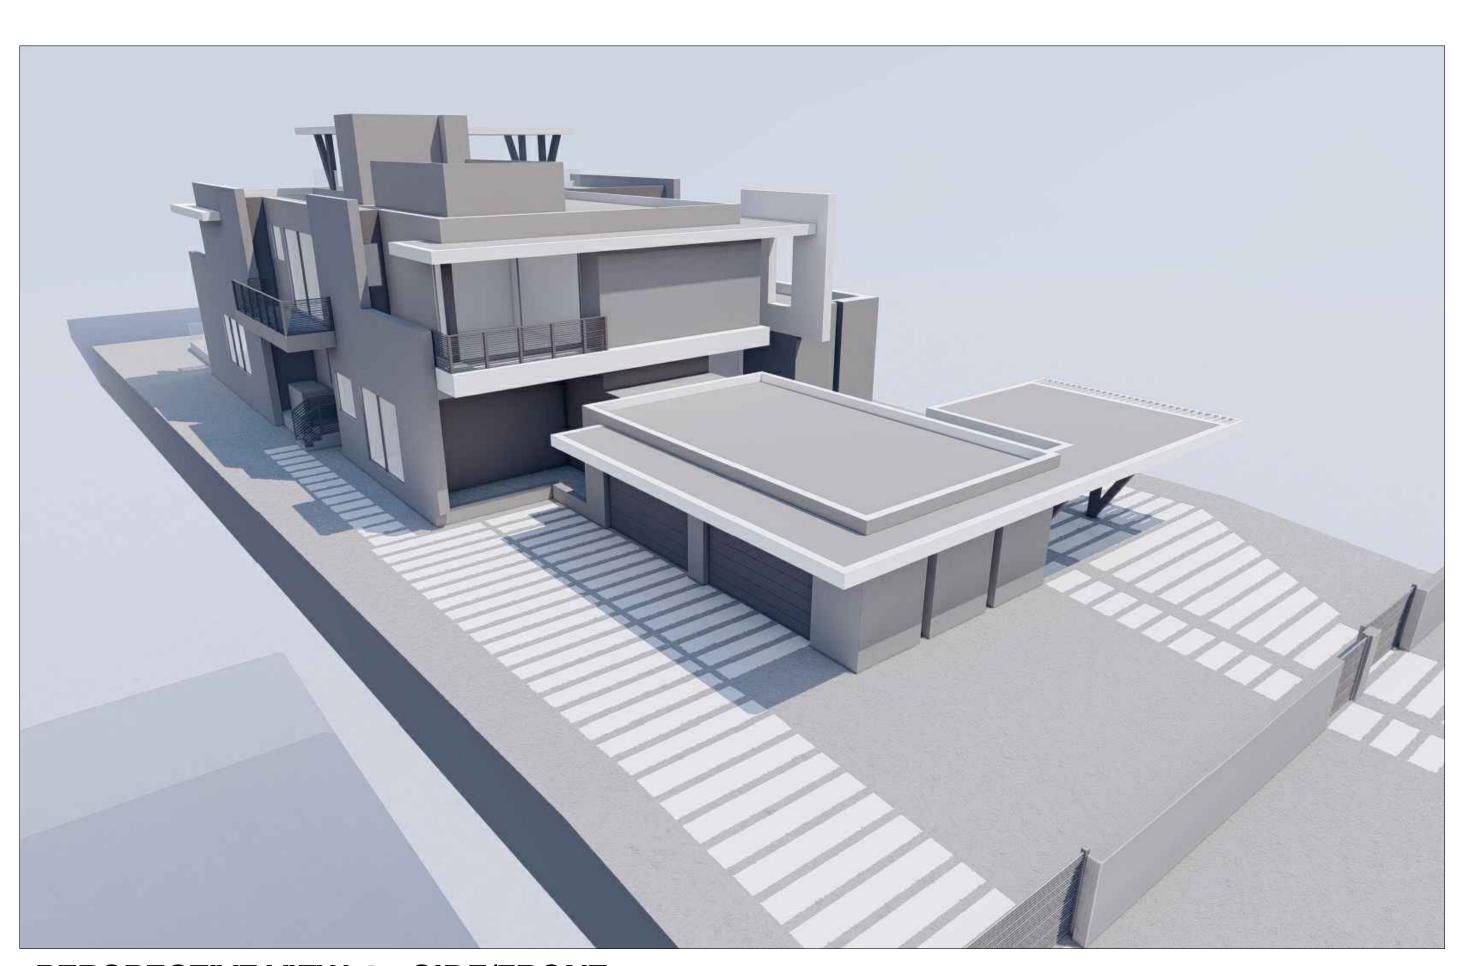

PERSPECTIVE VIEW 4 - SIDE/FRONT




DRAWING TITLE

VOLUMETRIC PERSPECTIVES

SCALE: AS SHOWN DATE: 09-26-2021

3D-1.1

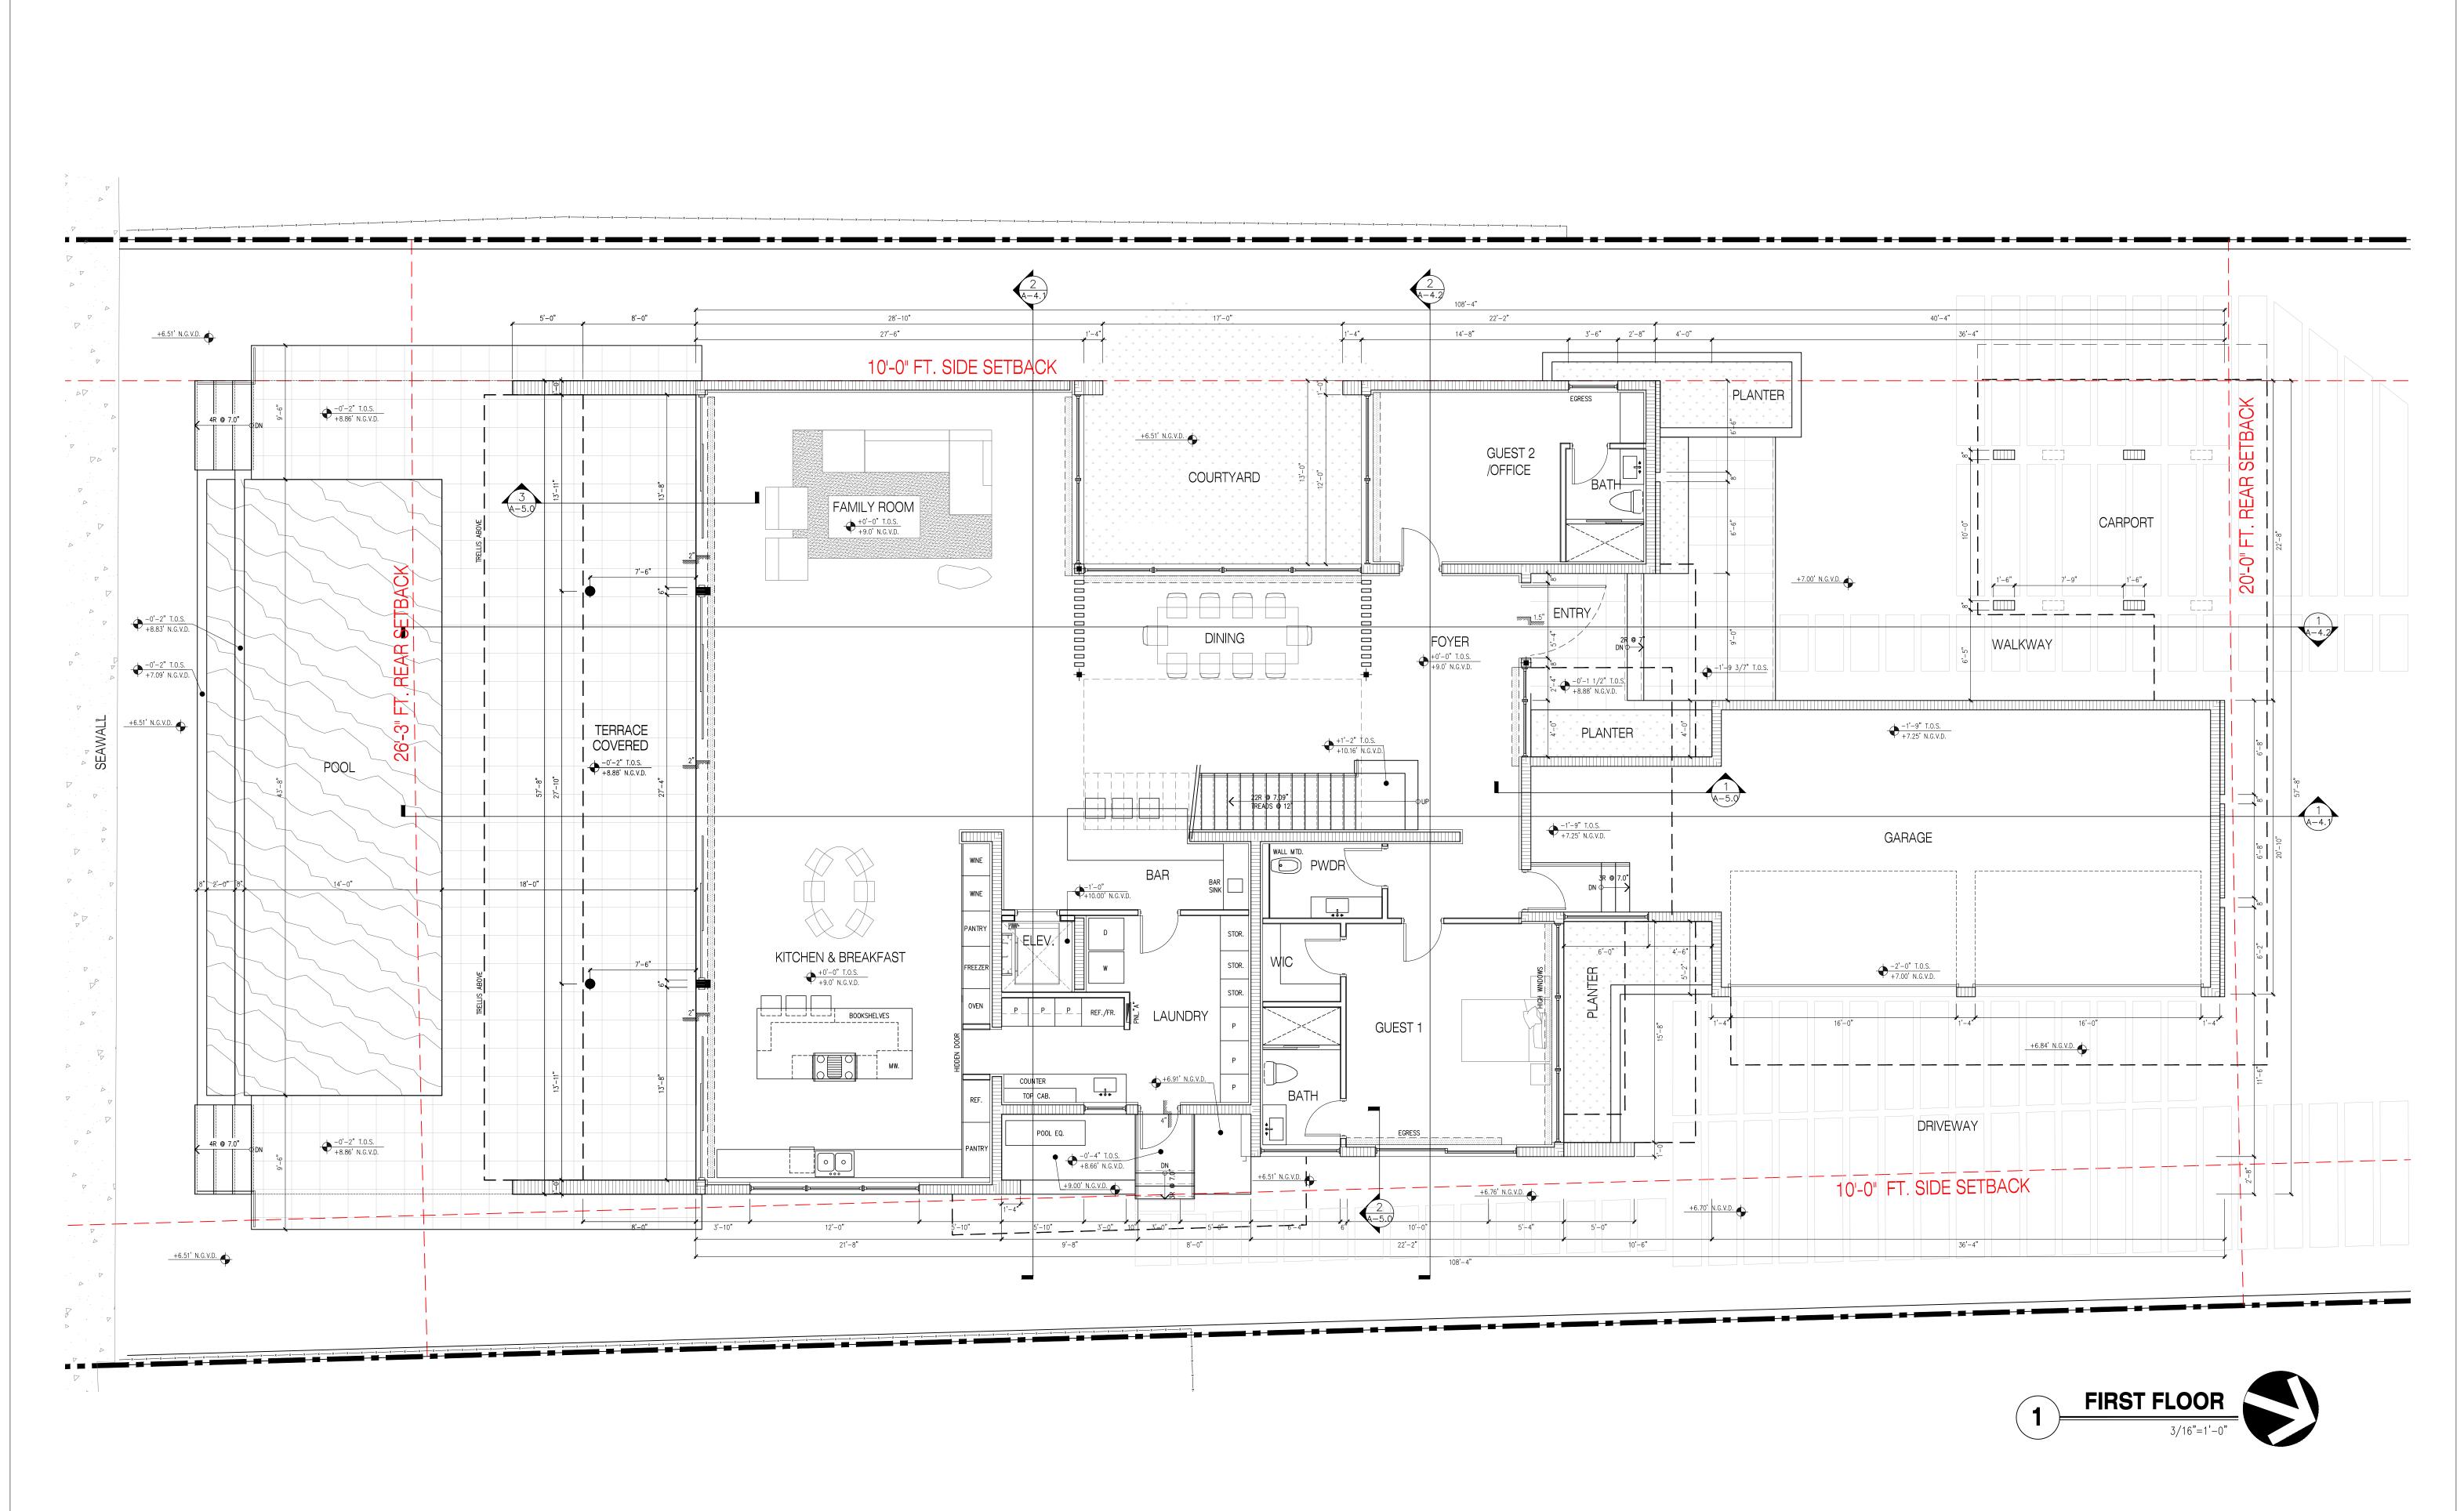

praxis. — ★ — AR 16966



Jose L
Sanchez
Digitally signed by Jose L
Sanchez
Div. cn=Jose L Sanchez, c=l
Digitally signed by Jose L
Sanchez
Div. cn=Jose L Sanchez, c=l
Digitally signed by Jose L
Sanchez
Div. cn=Jose L Sanchez, c=l
Digitally signed by Jose L
Sanchez
Div. cn=Jose L Sanchez, c=l
Digitally signed by Jose L
Sanchez
Div. cn=Jose L Sanchez, c=l
Digitally signed by Jose L
Sanchez
Div. cn=Jose L Sanchez, c=l
Digitally signed by Jose L
Sanchez
Div. cn=Jose L Sanchez, c=l
Div. cn=Jose L Sanchez

ADDRESS & OWNER

ENCE

1610 BAY DRIVE MIAMI BEACH, FLORIDA. NEW RESID


REVISION & DATE


DRAWING TITLE

FIRST FLOOR PLAN

SCALE: AS SHOWN DATE: 09-26-2021

A-2.1

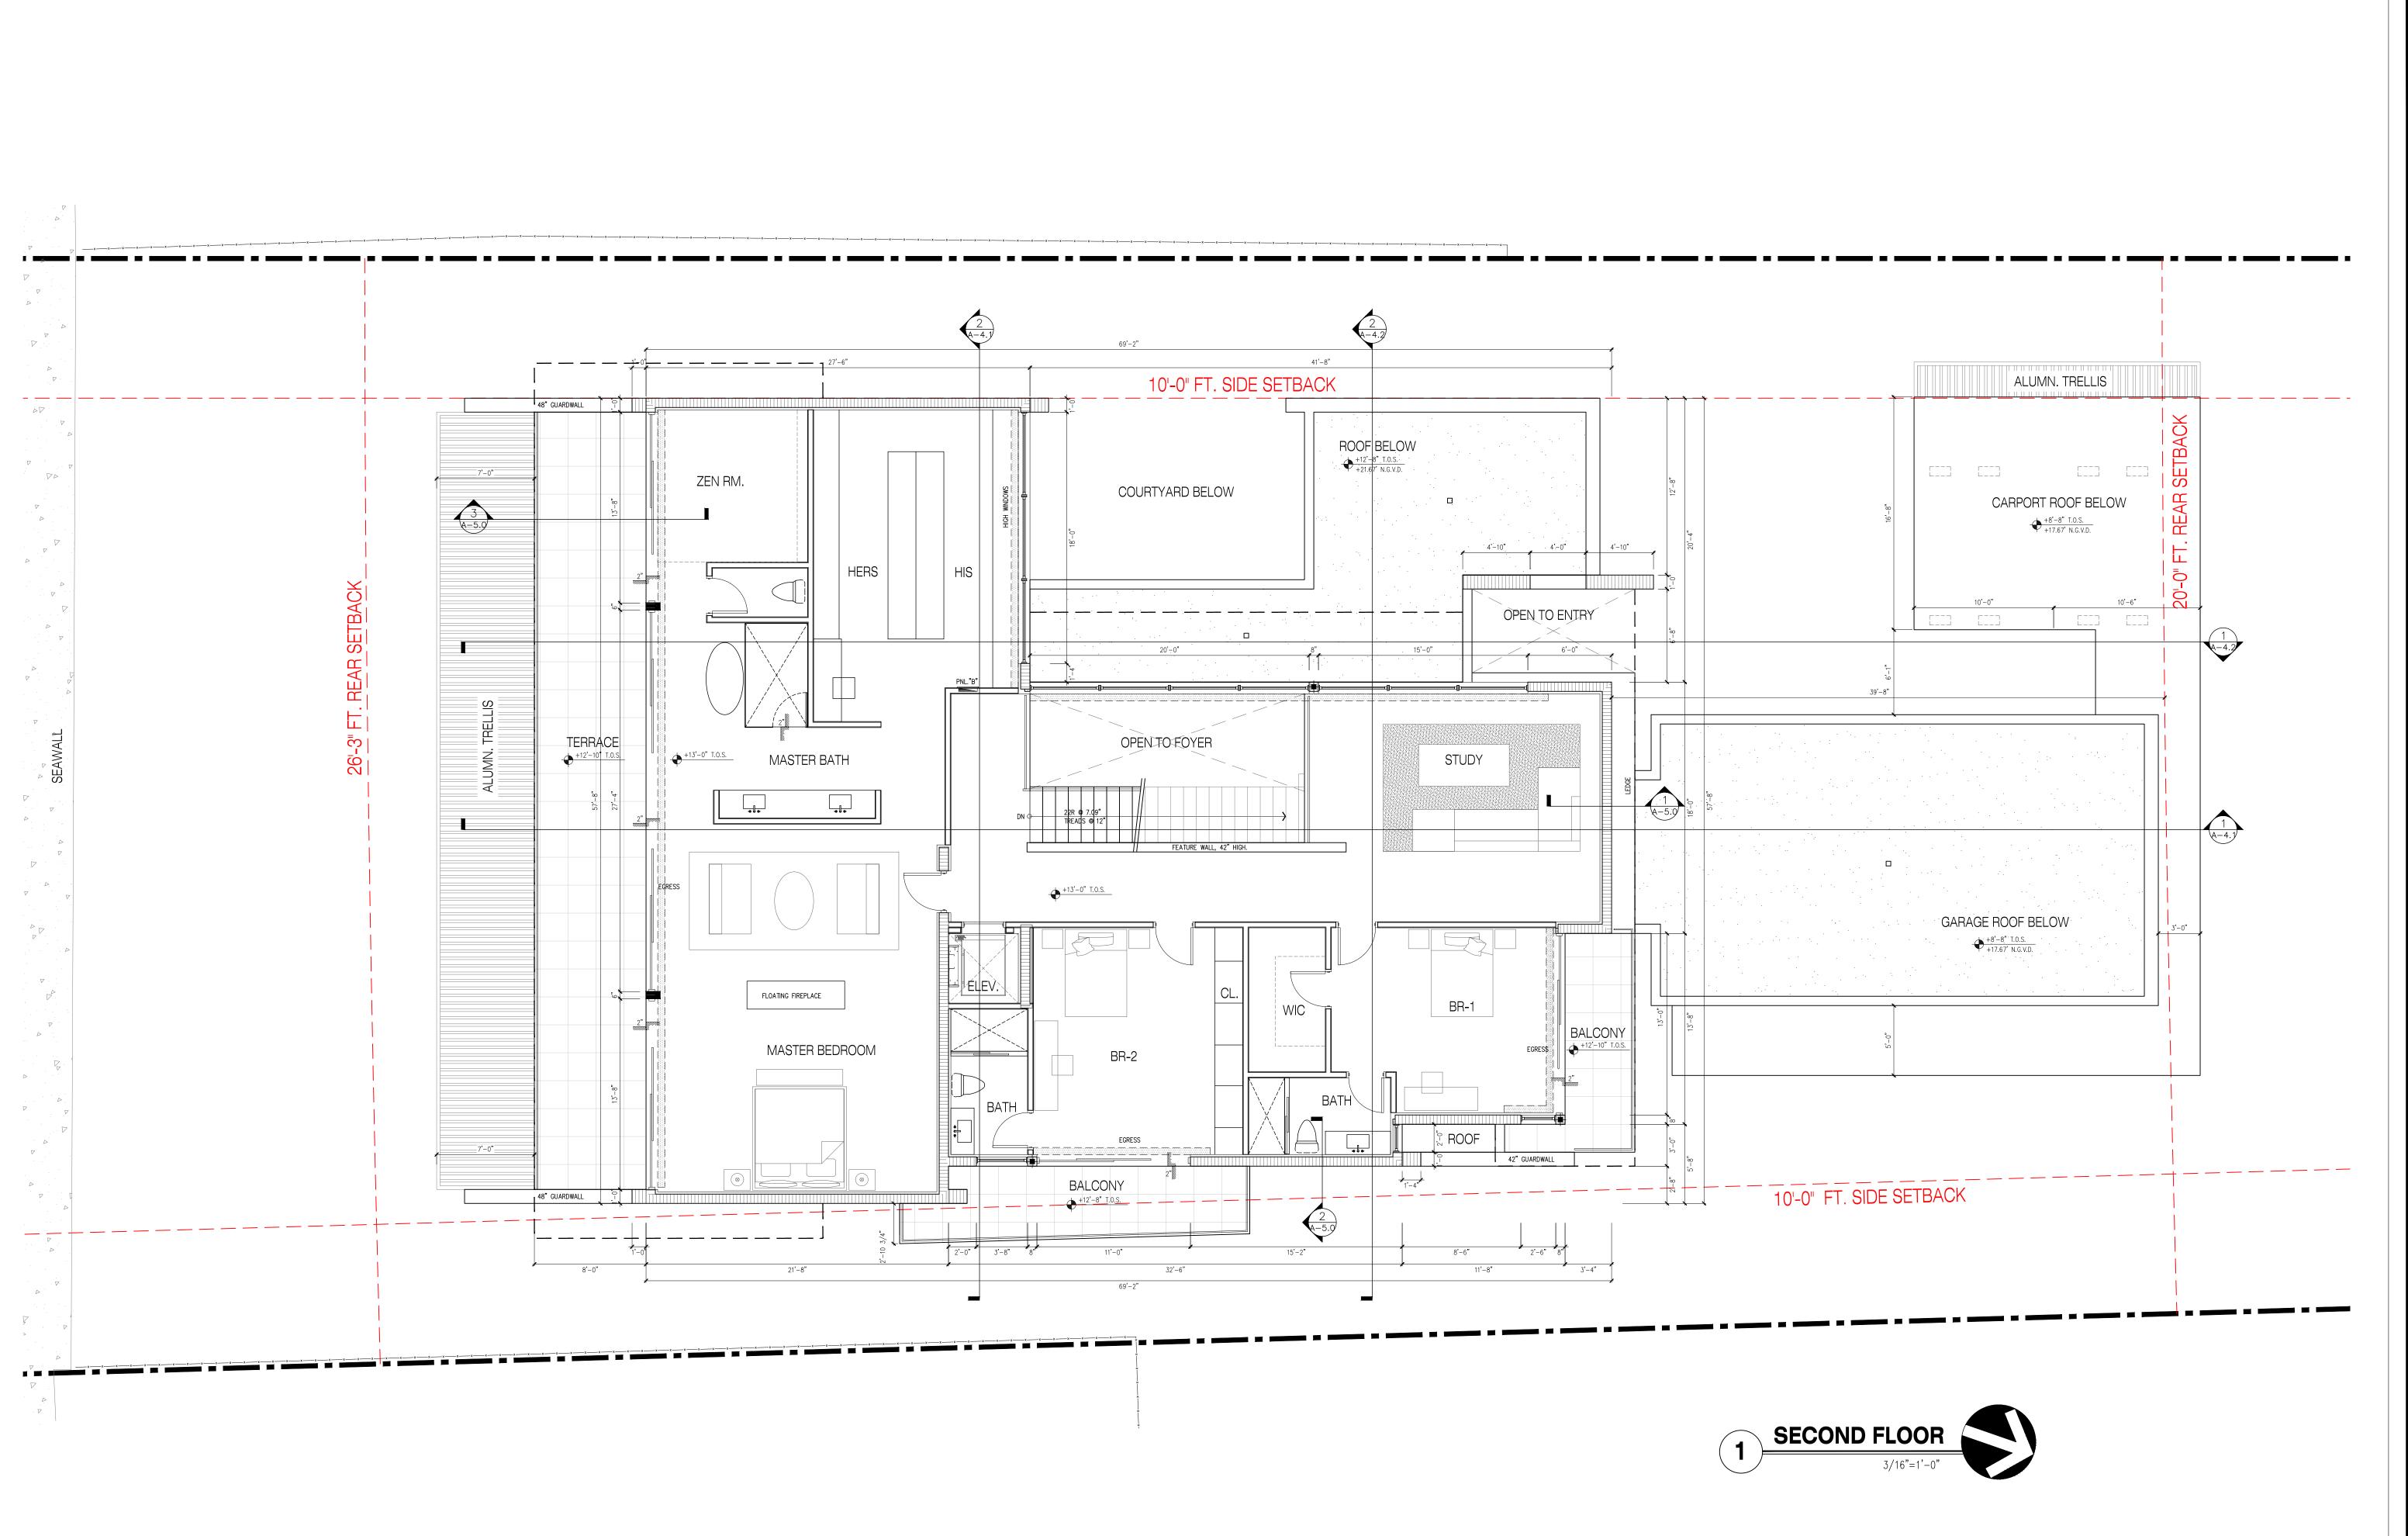

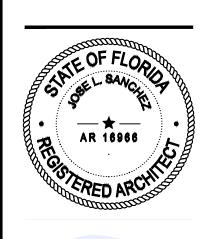

Jose L

Digitally signed by Jose L
Sanchez
DN: cn=Jose L Sanchez, c
o=Praxis Architecture, Inc., Sanchez mail=jsanchez@praxisarch Date: 2022.09.02 17:33:03-04'00'

ADDRESS & OWNER

ENCE 1610 BAY DRIVE MIAMI BEACH, FLORIDA. OWNER: NEW RESID


REVISION & DATE

DRAWING TITLE


SECOND FLOOR PLAN

SCALE: AS SHOWN DATE: 09-26-2021

A-2.2

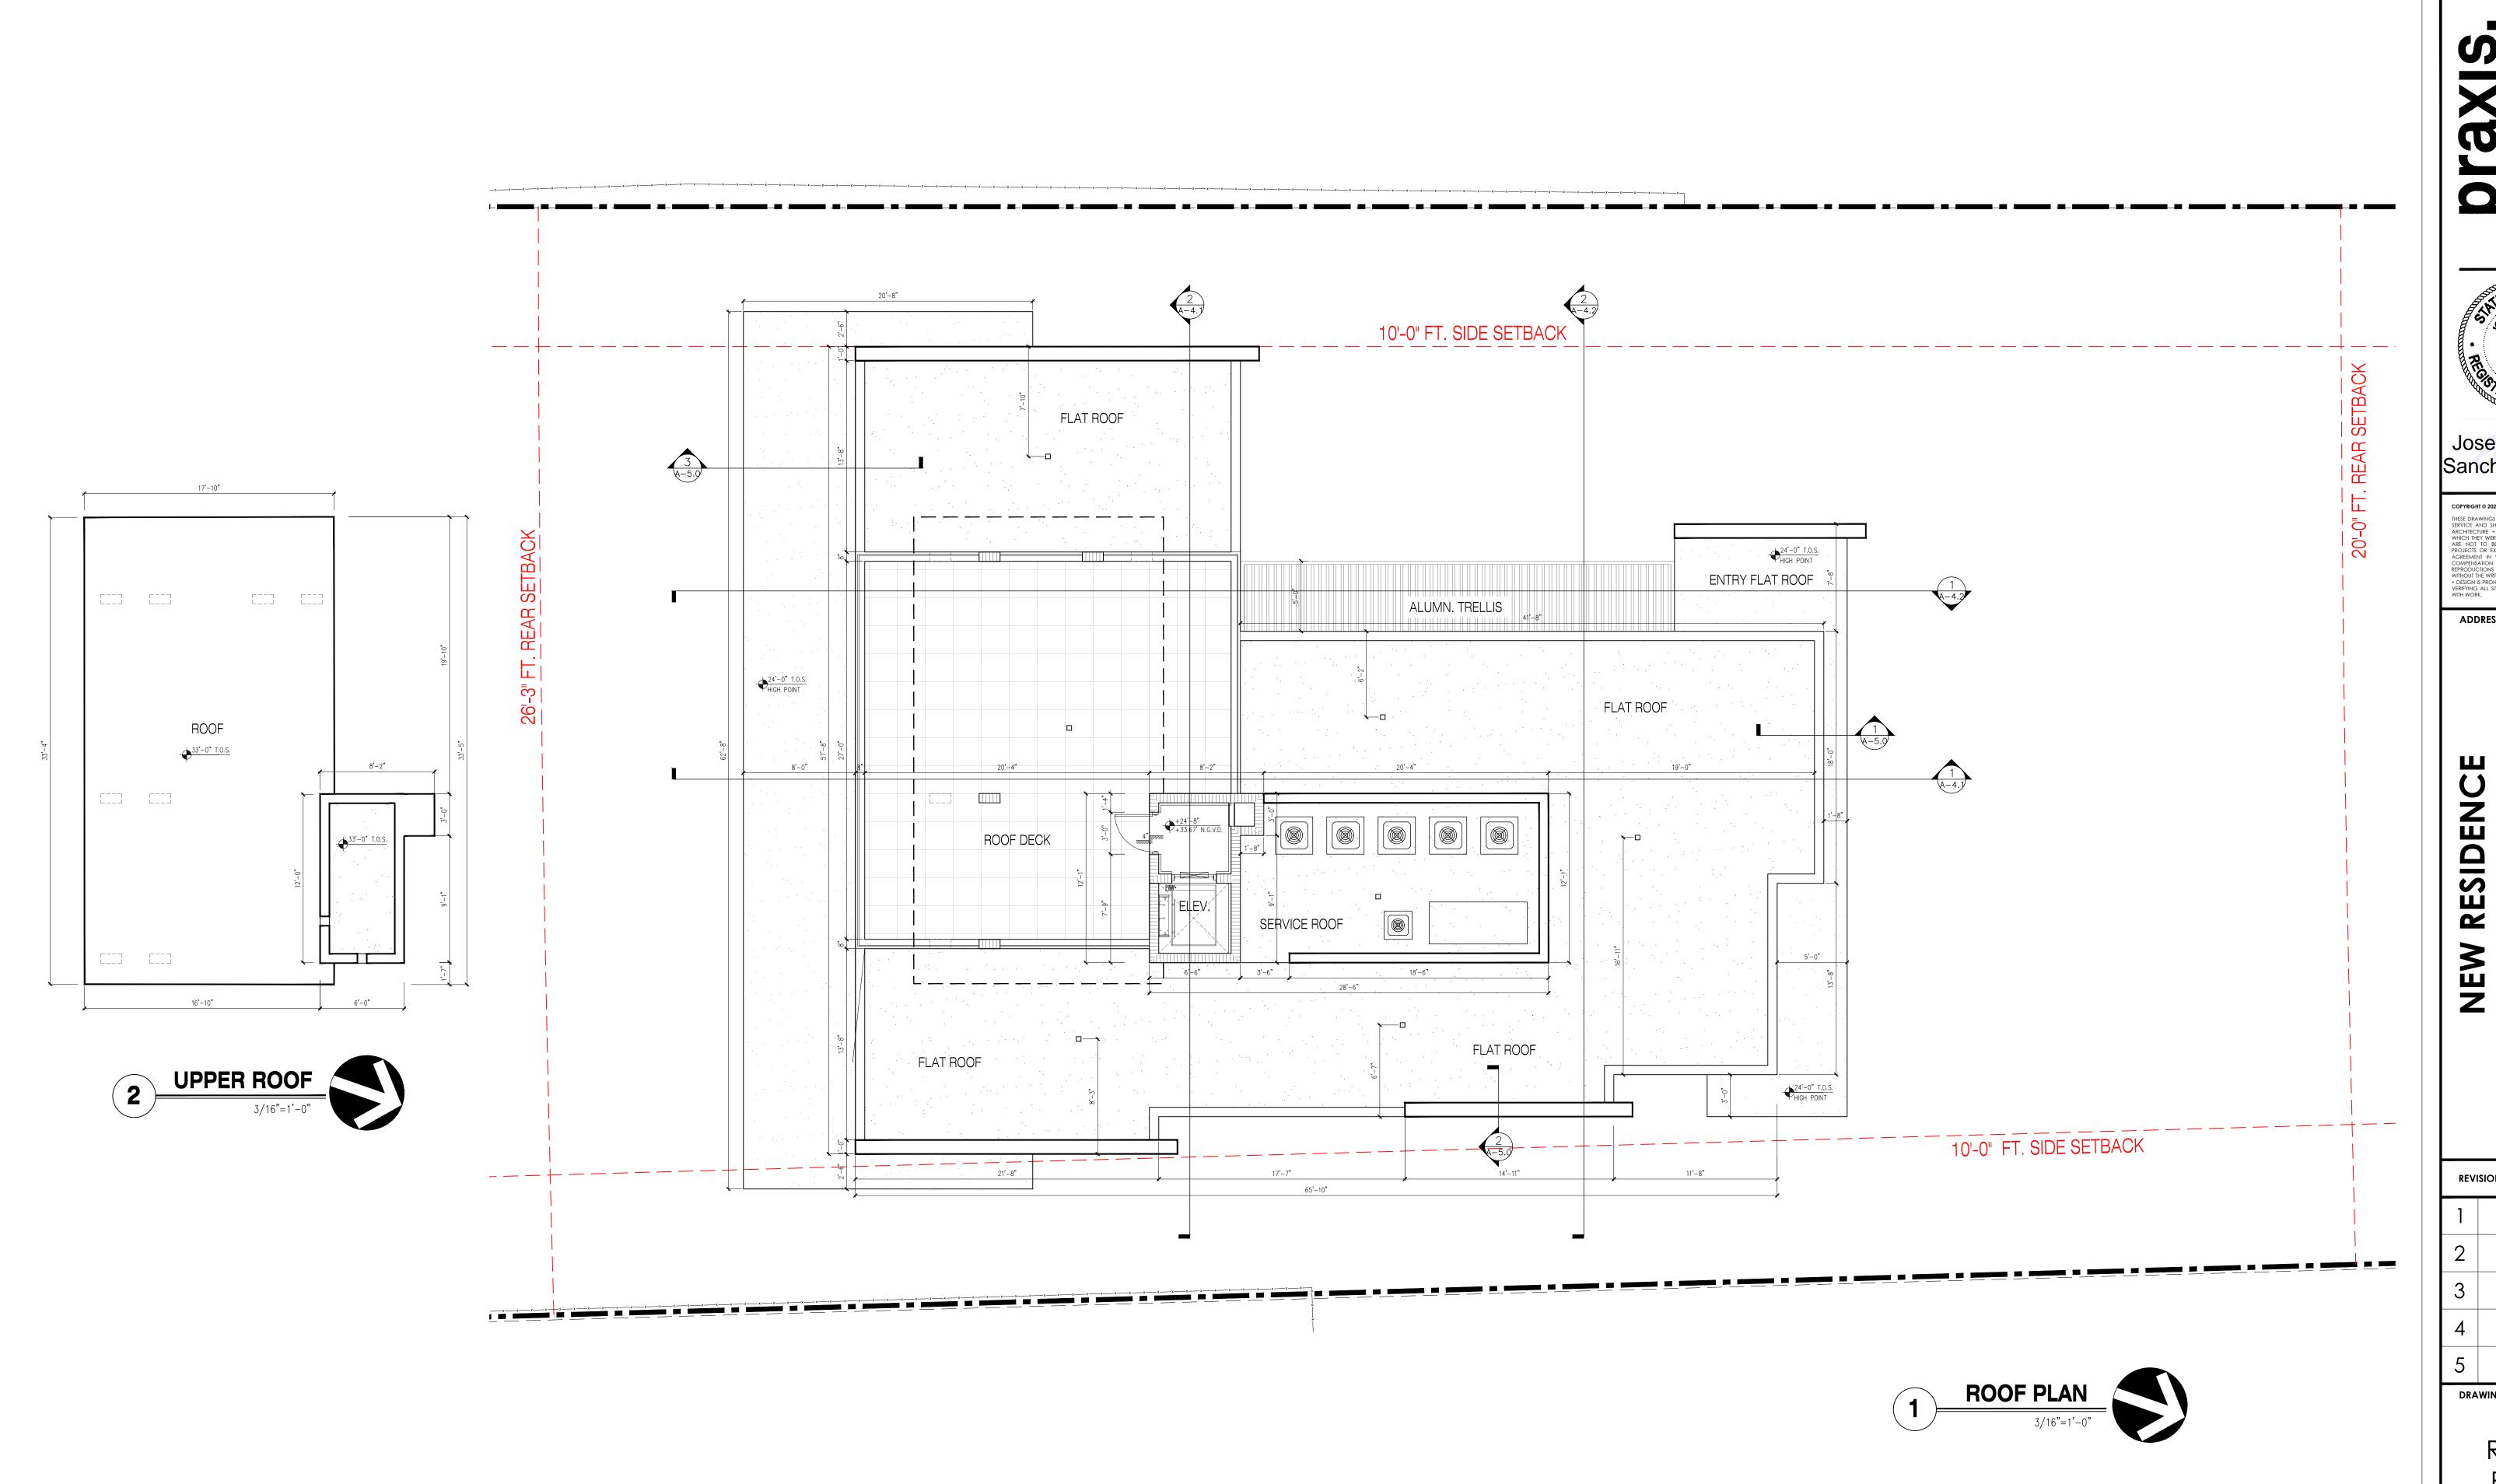

praxi

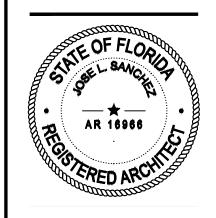

Jose L Digitally signed by Jose L Sanchez, DN: cn=Jose L Sanchez, co=Praxis Architecture, Inc., Sanchez Geralis Architecture, 110., emails jaanchez@praxisarch 2022.09.02 17:33:10-04/00'

ADDRESS & OWNER

1610 BAY DRIVE MIAMI BEACH, FLORIDA.


REVISION & DATE

DRAWING TITLE


ROOF PLAN

SCALE: AS SHOWN DATE: 09-26-2021


A-2.3

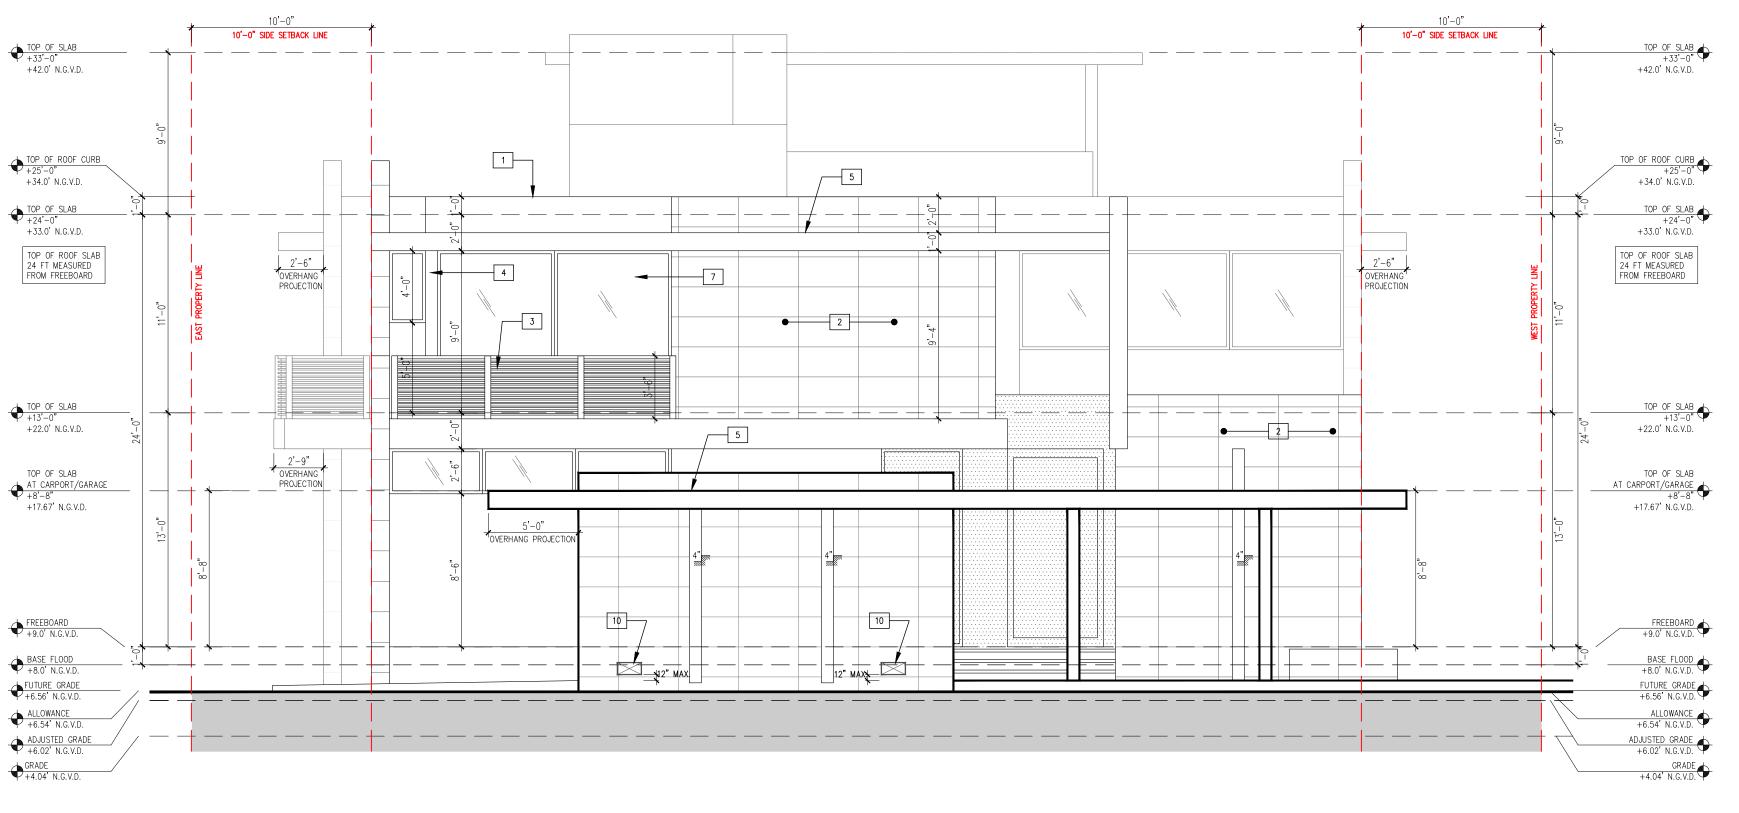

NORTH ELEVATION (FRONT) 3/16"=1'-0"

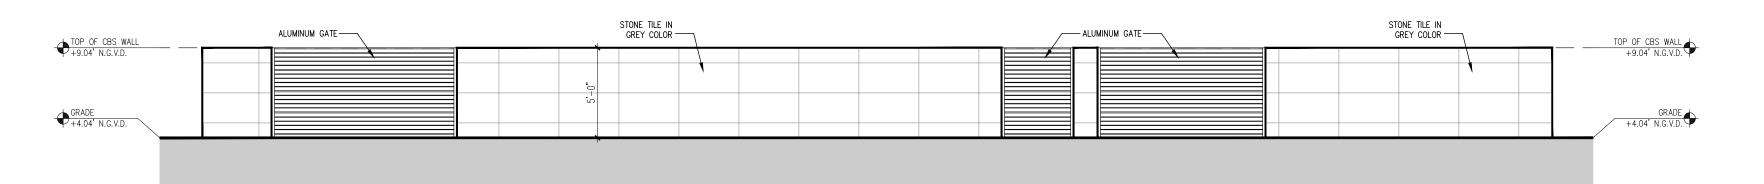



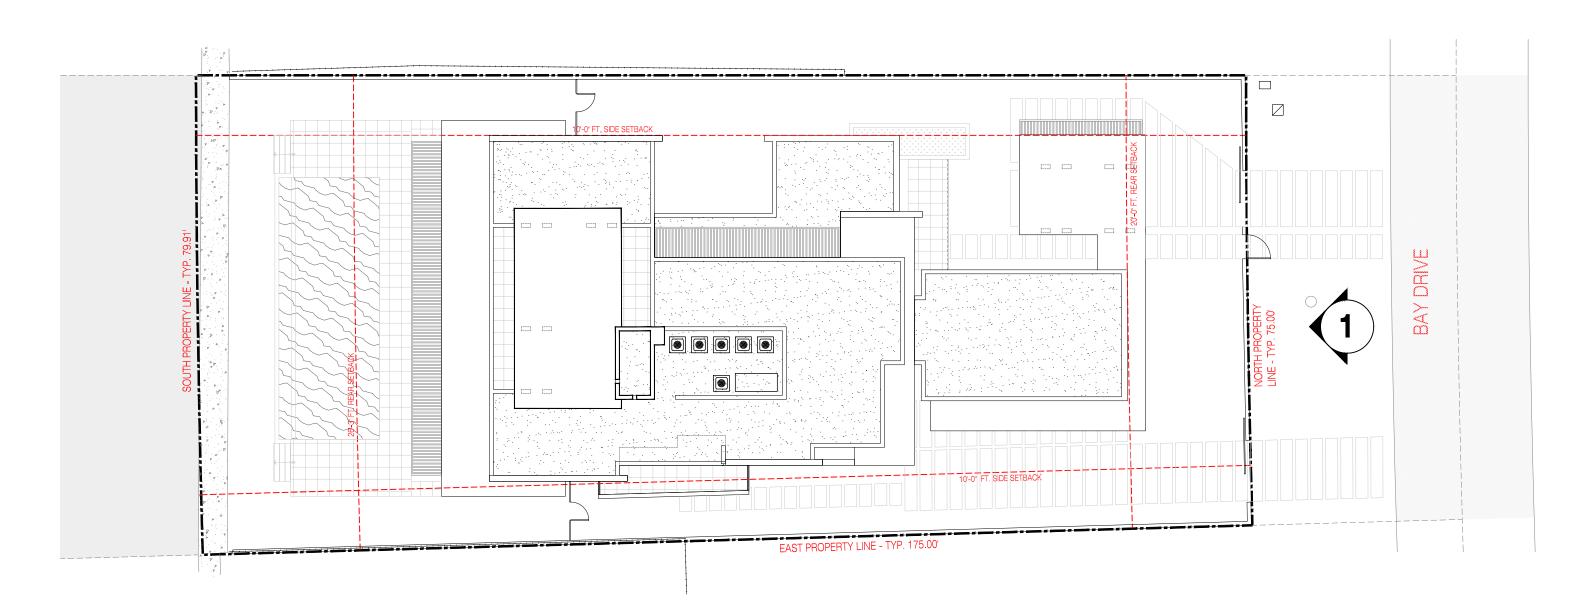

ELEVATION KEYPLAN

NOT TO SCALE

ELEVATIONS KEYNOTES / SPECIFICATIONS

- PARAPET WALL (SEE ROOF PLAN FOR HEIGHT) 2. STONE TILE IN GREY COLOR IN PROPORTION OF STACKED
- BOND CMU 8 X 18. 3. ALUMINUM GUARDRAIL
- 4. GALVANIZED STEEL COLUMN W/ALUMINUM BREAK METAL ENCLOSURE (BY WINDOW DOOR MANUFACTURER) TO MATCH THE WINDOWS. W/ ELECTRO-MATIC PAINTING
- CONCRETE EYEBROW W/SEALOFLEX WATERPROOFING AND DRIP EDGE.
- 6. GLASS/ALUMN. GUARDRAIL (42" A.F.F.) . DADE COUNTY APPROVED ALUM./IMPACT GLASS WINDOWS (IMPACT, BRONZE FINISH). REFER TO ENERGY CALCULATIONS FOR SHADING COEFFICIENT AND U FACTOR
- REQUIRED. PROVIDE FLUID APPLIED WATERPROOFING ON THE INSIDE FACE OF THE ROUGH OPENING. (TYP) DECORATIVE ALUMN. LOUVERS - SPACING BETWEEN
- A WALKING SURFACE.. O. ALUM SCREEN ENCLOSURE FOR CONDENSING UNITS -

LOUVERS SHALL REJECT A 4" SPHERE WHEN ADJACENT TO

- PAINT CMU SCREEN & GATE SAME COLOR AS THE HOUSE. 10. HYDROSTATIC VENTS TYP.-SMART VENTS MODEL 1540-510, EACH CERTIFIED TO COVER 200 S.F.
- 1. OVERHEAD GARAGE DOOR (COLOR TO MATCH ADJACENT



MATERIAL REFERENCE RENDER. DESIGNED BY PRAXIS

MATERIAL LEGEND



1. STONE TILE IN GREY COLOR IN PROPORTION OF STACKED BOND CMU 8 X 18.



2. MATTE FINISHED IONIZED ALUMINUM.



4

3. WHITE SMOOTH STUCCO



4. DARK-BROWN PAINT OVER SMOOTH STUCCO



Jose L Digitally signed by Jose L Sanchez DN: cn=Jose L Sanchez, o=Praxis Architecture, Inc Sanchez email=jsanchez@praxisarch
Date: 2022.09.02 17:33:17
04'00'

THESE DRAWINGS AND DOCUMENTS ARE INSTRUMENTS OF SERVICE AND SHALL REMAIN THE PROPERTY OF PRAXIS ARCHITECTURE + DESIGN, WHETHER THE PROJECT FOR WHICH THEY WERE PREPARED IS EXECUTED OR NOT, THEY ARE NOT TO BE USED IN ANY MANNER ON OTHES PROJECT SOR EXTENSIONS TO THIS PROJECT EXCEPT BY AGREEMENT IN WRITING AND WITH THE APPROPRIATI COMPENSATION TO PRAXIS ARCHITECTURE + DESIGN REPRODUCTIONS OF DRAWINGS & SPECIFICATION. WITHOUT THE WRITTEN CONSENT OF PRAXIS ARCHITECTUR + DESIGN IS PROHIBITED. CONTRACTORS RESPONSIBLE FOI VERIFYING ALL SITE CONDITIONS PRIOR TO PROCEEDINK WITH WORK.

ADDRESS & OWNER

ENCE 331 1610 BAY DRIVI MIAMI BEACH, FLORID RESIDI OWNER: NEW


REVISION & DATE

DRAWING TITLE

NORTH **ELEVATION** (FRONT)

SCALE: AS SHOWN DATE: 09-26-2021

A-3.1

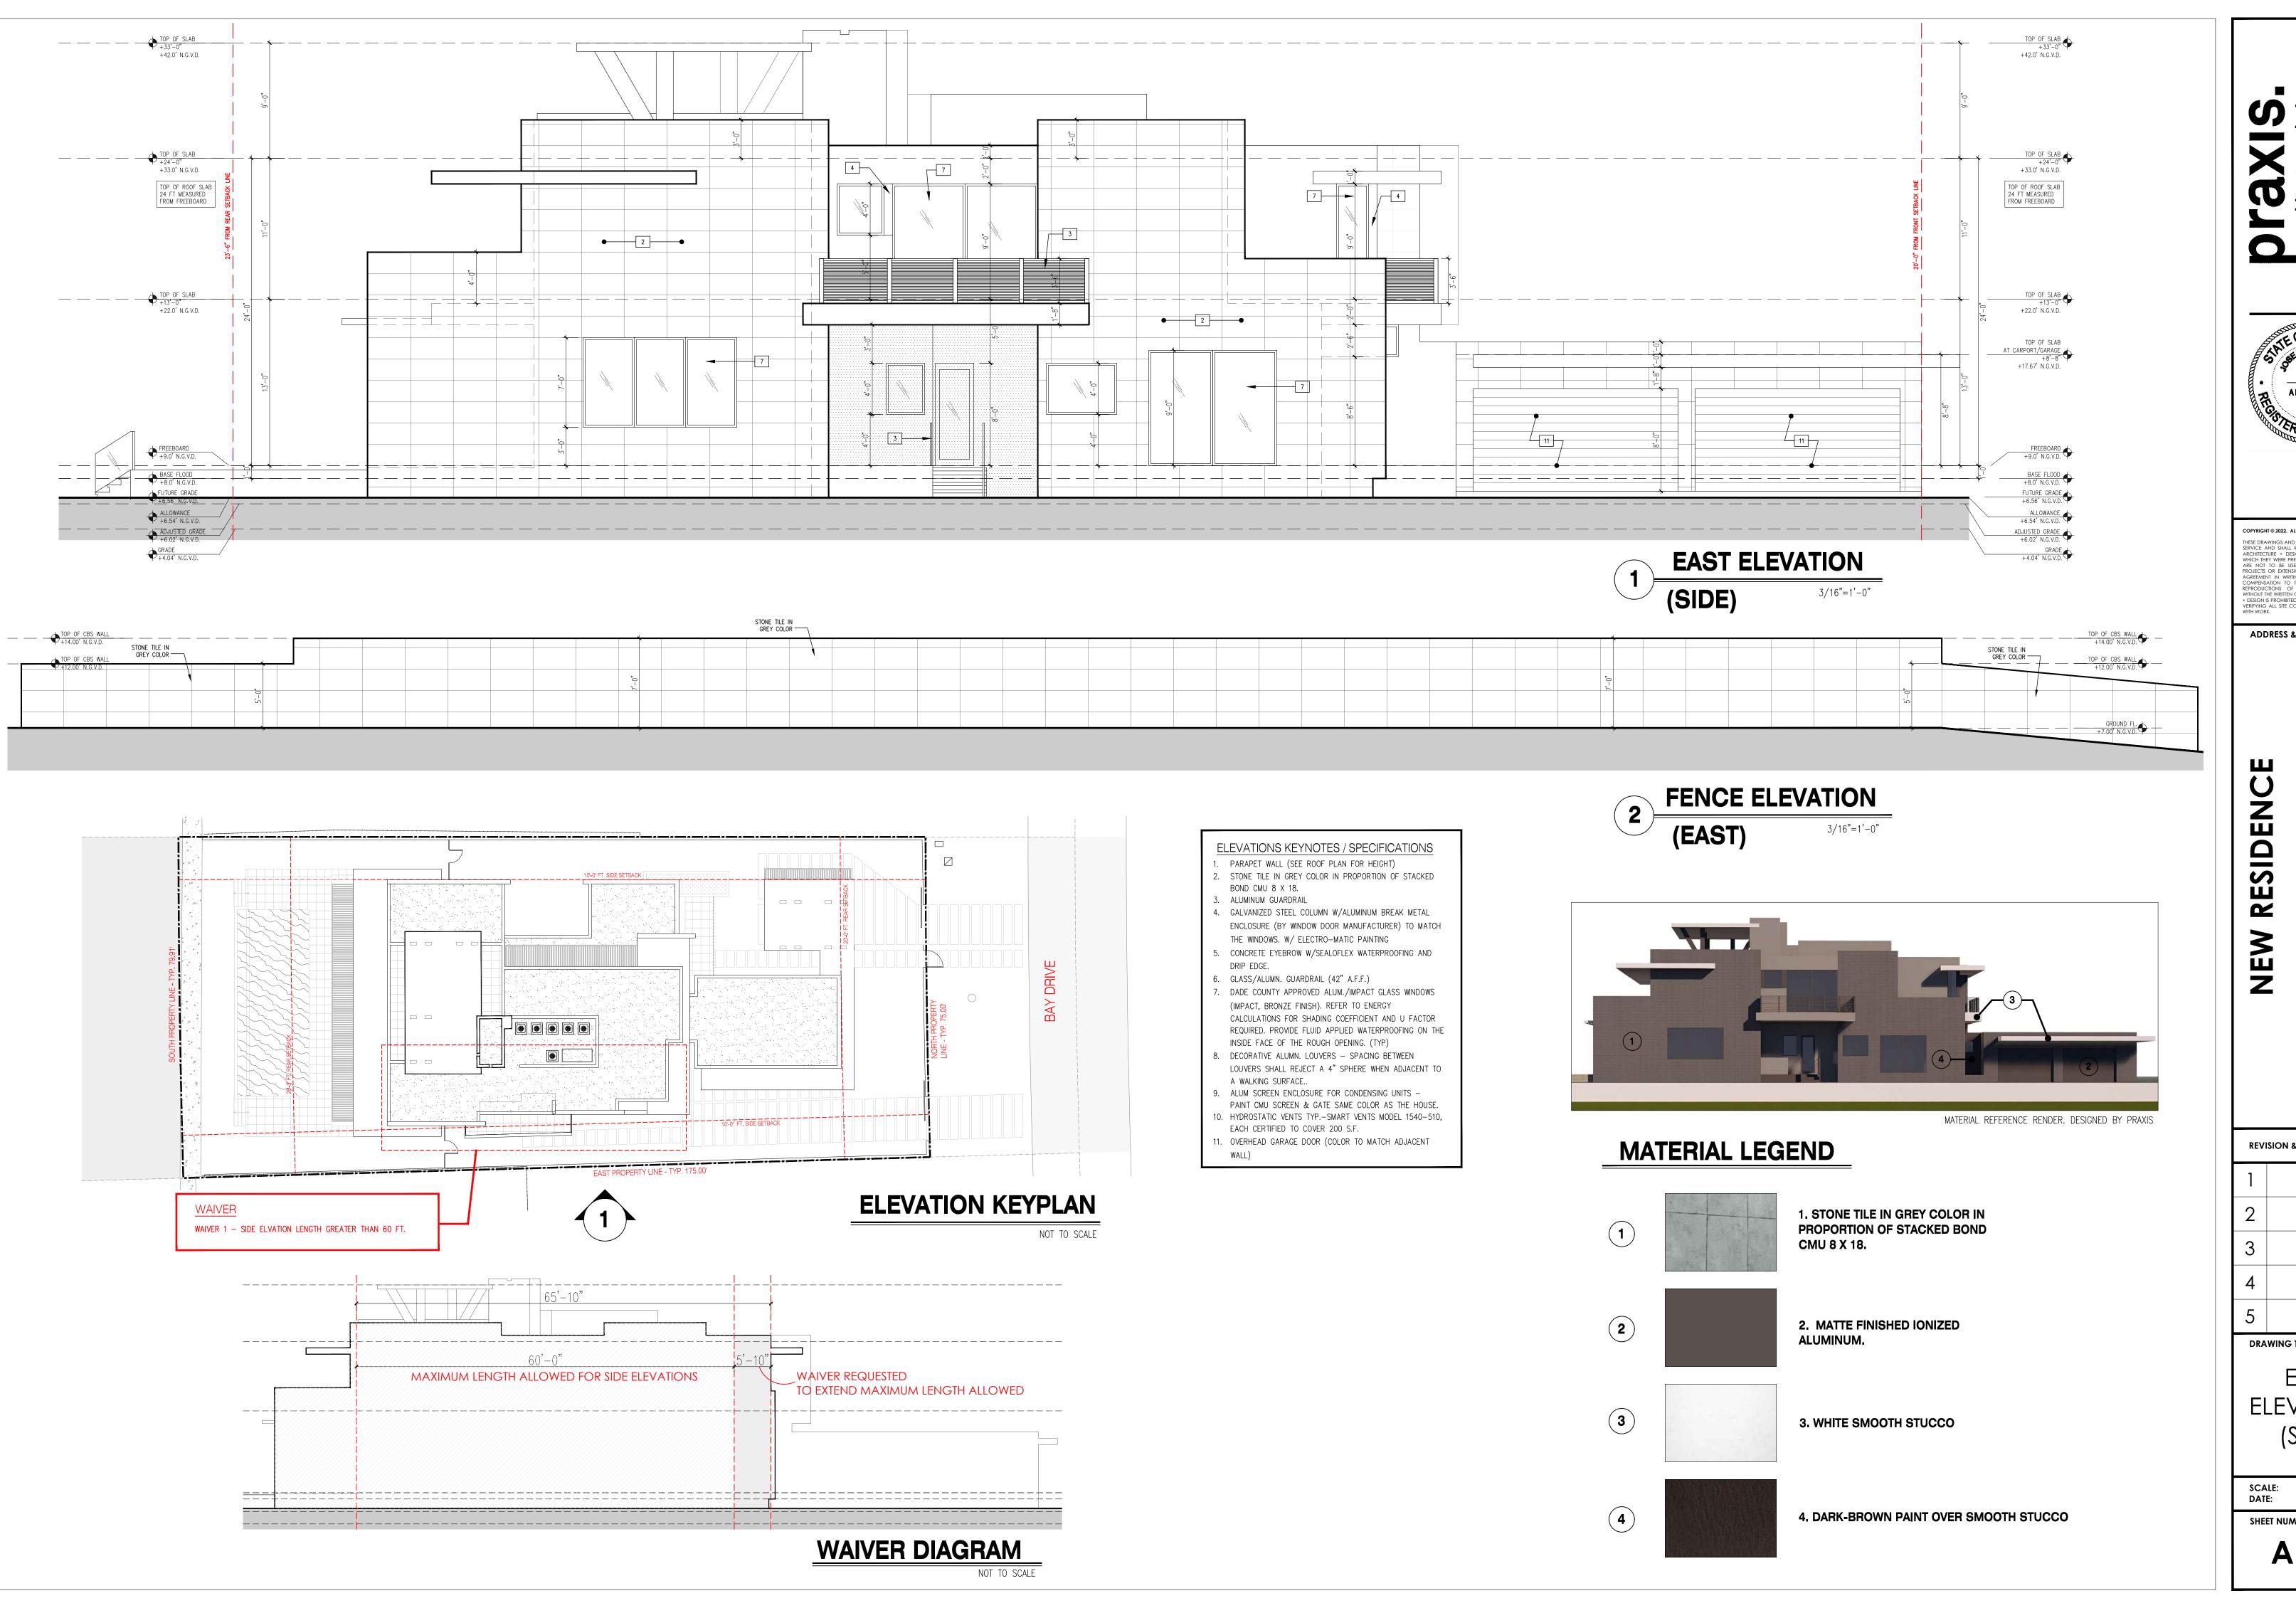



ADDRESS & OWNER

1610 BAY DRIVE I BEACH, FLORIDA. OWNER:

REVISION & DATE


DRAWING TITLE

EAST **ELEVATION** (SIDE)

SCALE: AS SHOWN DATE: 09-26-2021

SHEET NUMBER

A-3.4

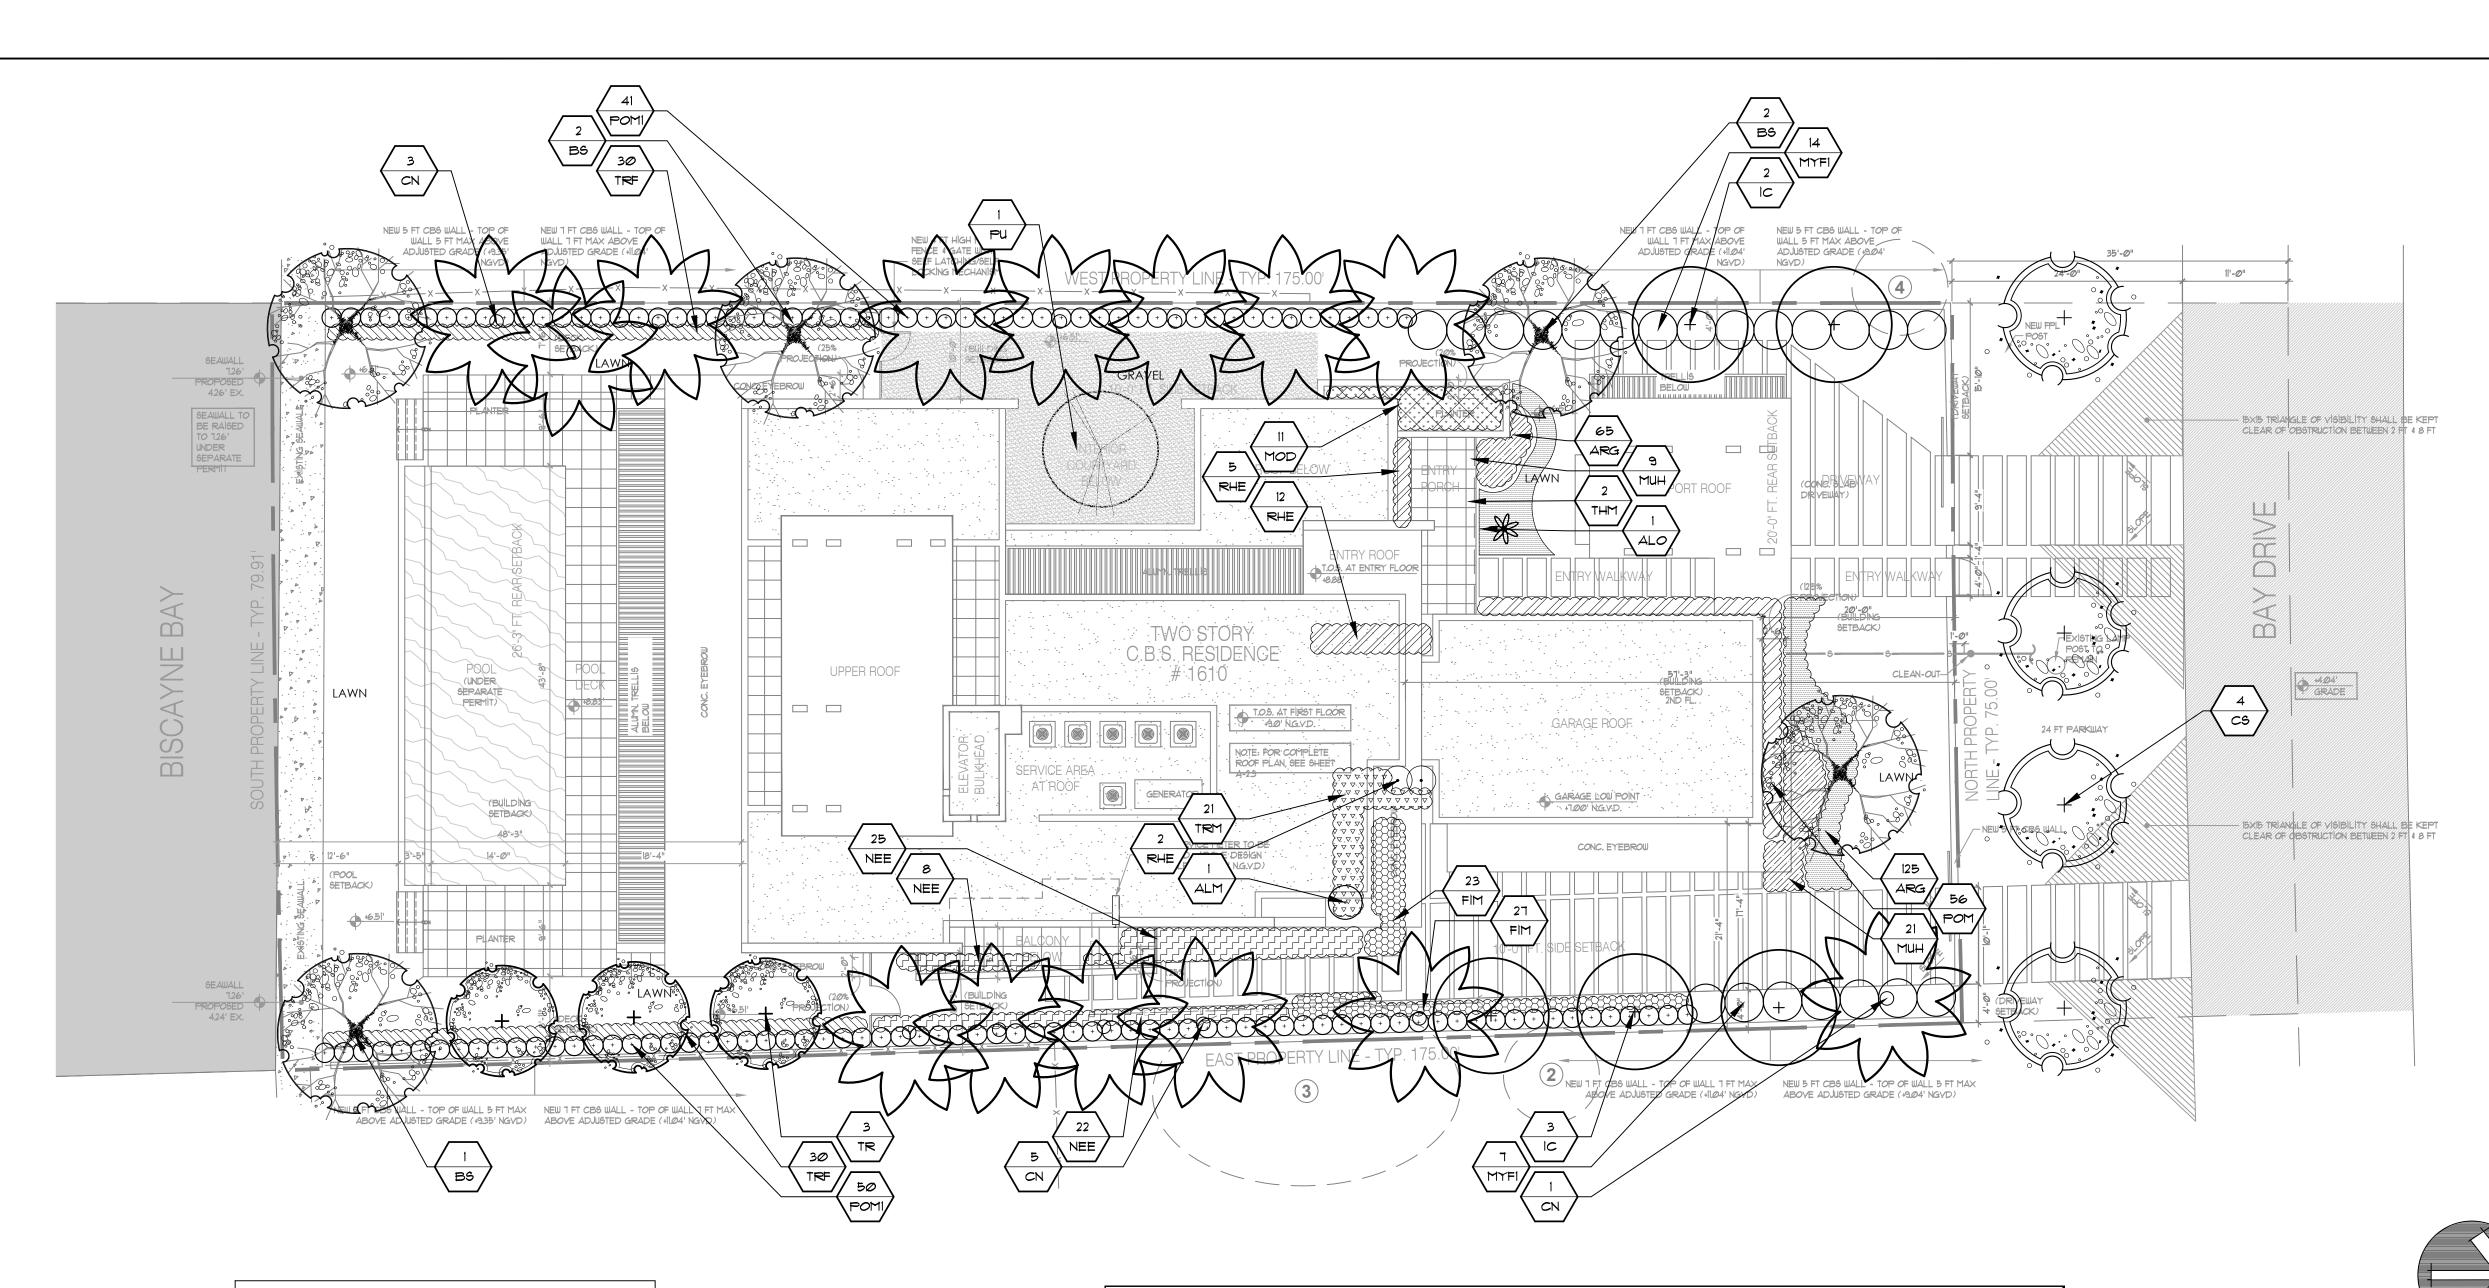



- FOR HARDSCAPE FINISH MATERIALS REFER

 TO A POULTECTURAL DLANG SHEET A LO
- TO ARCHITECTURAL PLANS SHEET A1.0.

 ROOT BARRIERS SHALL BE INSTALLED ADJACENT TO PROPOSED UTILITIES WHEN TREES ARE PROPOSED WITHIN 10 FEET.



Fiantiist							
TREE	S & PA	LMS					
QTY	KEY	BOTANICAL NAME	COMMON NAME	DESCRIPTION			
5	BS	Bursera simaruba	Gumbo Limbo	14' ht, 3" cal, 4' ct			
9	CN	Cocos nucifera	Coconut Palm	18'-26' oa ht			
4	CS	Conocarpus erectus 'sericeus'	Silver Buttonwood	12' ht, 3" cal, 4' ct			
5	IC	llex cassine	Dahoon Holly	12' ht, 2" cal			
1	PU	Pandanus utilis	Screw Pine	12' ht			
3	TR	Tabebuia roseo 'alba'	White Trumpet Tree	12' ht, 2" cal			
2	THM	Thrinax morrisii	Key Thatch Palm	8' oa ht			
SHRU	BS & G	ROUNDCOVERS					
QTY	KEY	BOTANICAL NAME	COMMON NAME	DESCRIPTION			
1	ALO	Alcantarea 'odorata'	Odorata Bromeliad	7 gal			
1	ALM	Alocasia 'macrorhiza'	Elephant Ear	7 gal			
190	ARG	Arachis glabrata	Perennial Peanut	1 gal			
50	FIM	Ficus microcarpa 'green island'	Green Island Ficus	3 gal			
11	MOD	Monestera deliciosa	Swiss Cheese Plant	7 gal			
30	MUH	Muhlenbergia capillaris	Pink Muhly Grass	3 gal			
21	MYF1	Myrcianthes fragans	Simpson Stopper	15 gal, 6' ht			
55	NEE	Nephrolepis exaltata	Boston Fern	3 gal, 24" ht			
56	POM1	Podocarpus macrophyllus	Podocarpus	8' ht			
56	POM	Podocarpus macrophyllus	Podocarpus	3 gal			
19	RHE	Rhapis excelsa	Lady Palm	4' oa ht			
21	TRM	Trimezia martinicensis	Yellow Walking Iris	3 gal			
60	TRF	Tripsacum floridana	Dwarf Fakahatchee Grass	3 gal			



Diego Vanderbiest

Digitally signed by Diego Vanderbiest Date: 2022.09.06 10:30:41 -04'00'

> NEW RESIDENCE 1610 BAY DRIVE MIAMI BEACH, FLORIDA

REVISIONS

7/08/22 SITE PLAN

9/1/22 CLIENT COMMENTS

DRAWN BY

DV

DATE

4/18/2022


4/18/2022 SCALE 1''=10'-0''

DRAWING TITLE

LANDSCAPE PLAN

L200



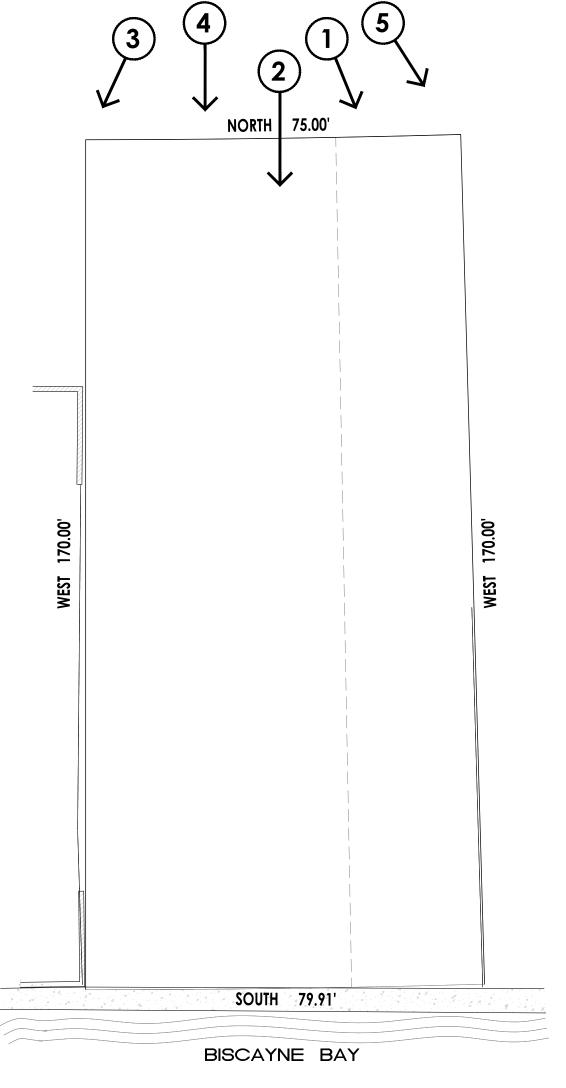

KEY PLAN - VIEWS



1 EXISTING LOT - FRONT




2 EXISTING LOT - FRONT



3 EXISTING LOT - FRONT




4 EXISTING LOT - FRONT

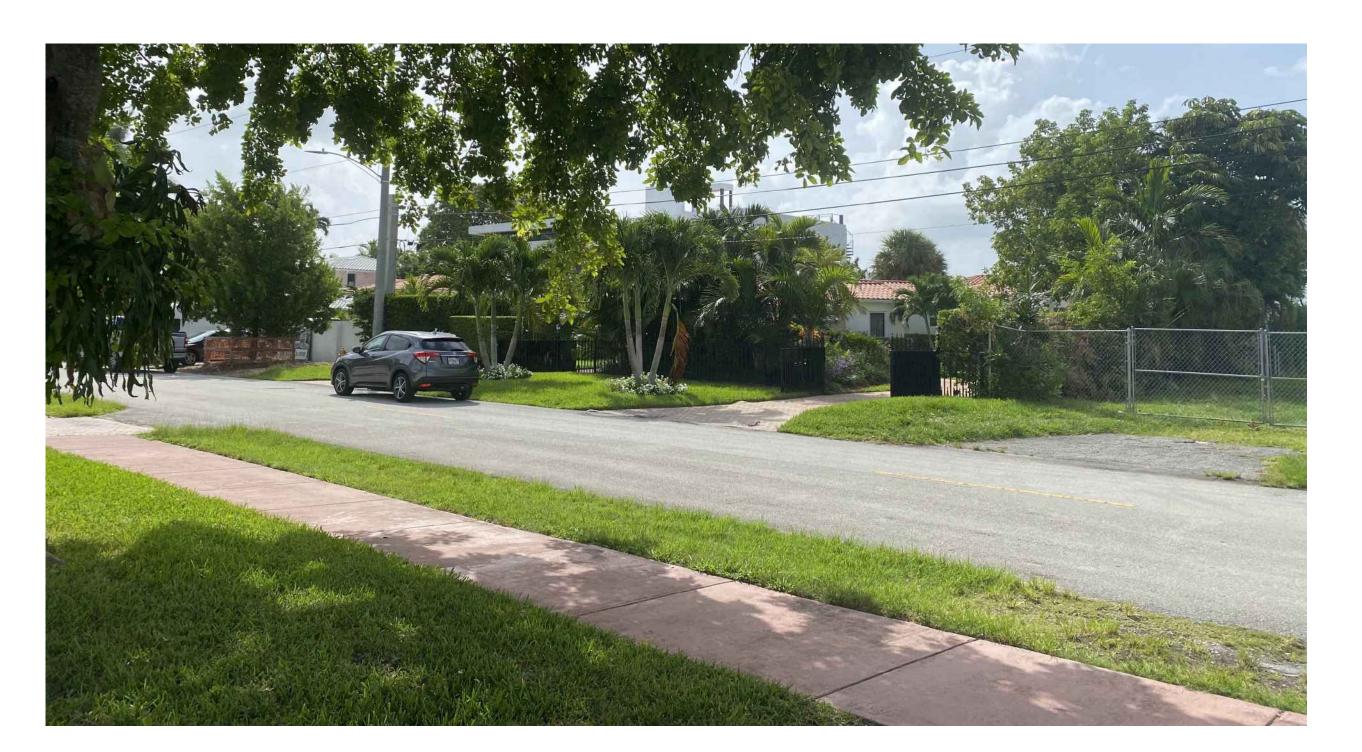

EXISTING LOT - FRONT (EAST)

(VACANT LOT. NO DEMOLITION PLAN NEEDED)

architecture . design
SSE I. SANCHEZ, AIA, LEED AP
78 NW 37TH ST. MIAMI, FL. 33127
305 576 8063 PRAXISARCH.COM

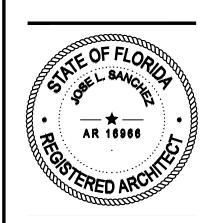

Jose L Sanchez
DN: cn=Jose L Sanchez, c=US,
o=Praxis Architecture, Inc.,
email=jsanchez@praxisarch.cor
Date: 2022.09.02 17:10:25

OPYRIGHT © 2022. ALL RIGHTS RESERVED.

HESE DRAWINGS AND DOCUMENTS ARE INSTRUMENTS OF FRAVIS RCHITECTURE + DESIGN, WHETHER THE PROJECT FOR HIGH THEY WERE PREPARED IS EXECUTED OR NOT. THEY RE NOT TO BE USED IN ANY MANNER ON OTHER ROJECTS OR EXTENSIONS TO THIS PROJECT EXCEPT BY GREEMEN IN WRITING AND WITH THE APPROPRIATE OMPENSATION TO PRAXIS ARCHITECTURE + DESIGN, BY DESIGN, BY DESIGN OF DRAWINGS & SPECIFICATIONS WITHOUT THE WRITTEN CONSENT OF PRAXIS ARCHITECTURE DESIGN IS PROHIBITED. CONTRACTORS RESPONSIBLE FOR REIFVING ALL SITE CONDITIONS PROPOSITIONS PROCEDING

ADDRESS & OWNE

NEW RESIDENCE
1610 BAY DRIVE
IAMI BEACH, FLORIDA. 33141
CWANED.

REVISION & DATE


2 3 4

DRAWING TITLE

EXISTING LOT PHOTOS

SCALE: AS SHOWN DATE: 09-26-2021

PH-1.0

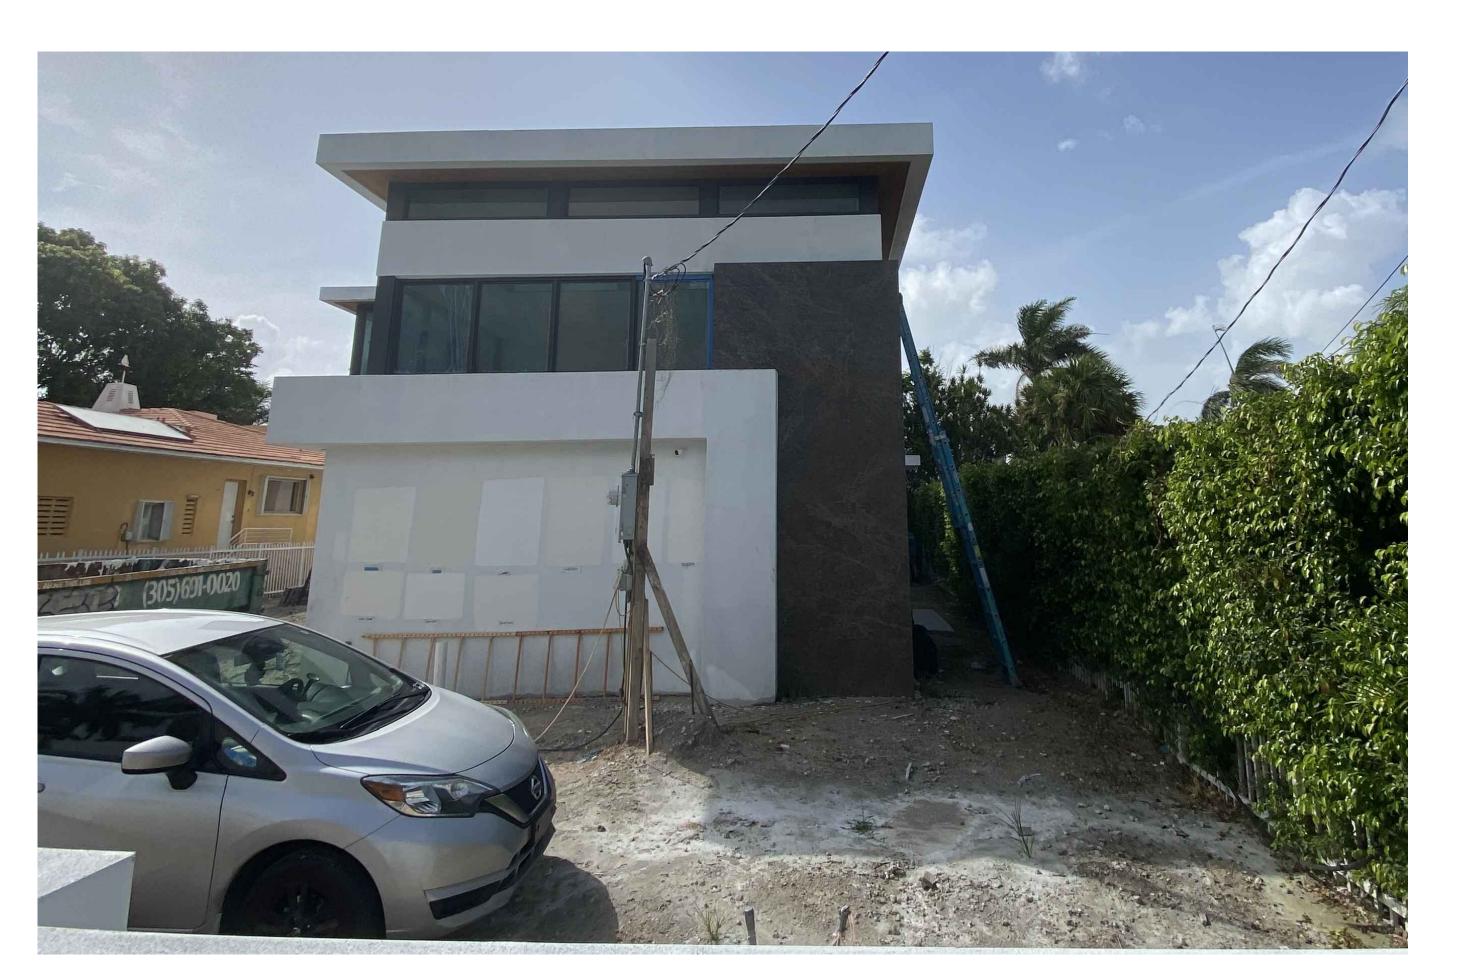


RESIDENCE 1



RESIDENCE 3



RESIDENCE 2

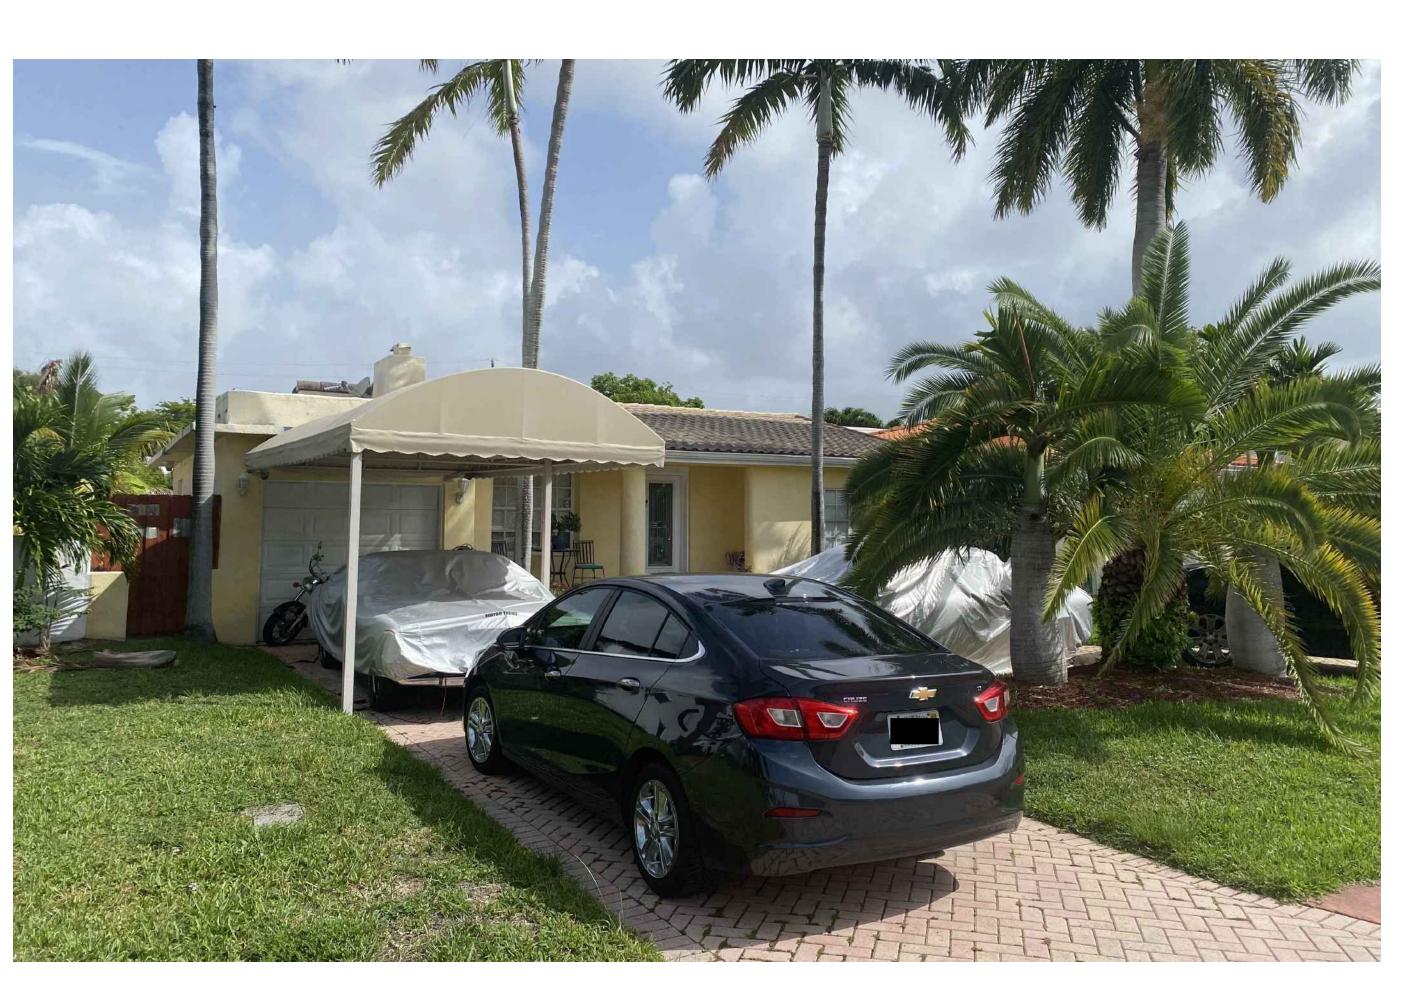

RESIDENCE 4

DRAWING TITLE

SURROUNDING PROPERTY PHOTOS

SCALE: AS SHOWN DATE: 09-26-2021




RESIDENCE 5



RESIDENCE 7



RESIDENCE 6

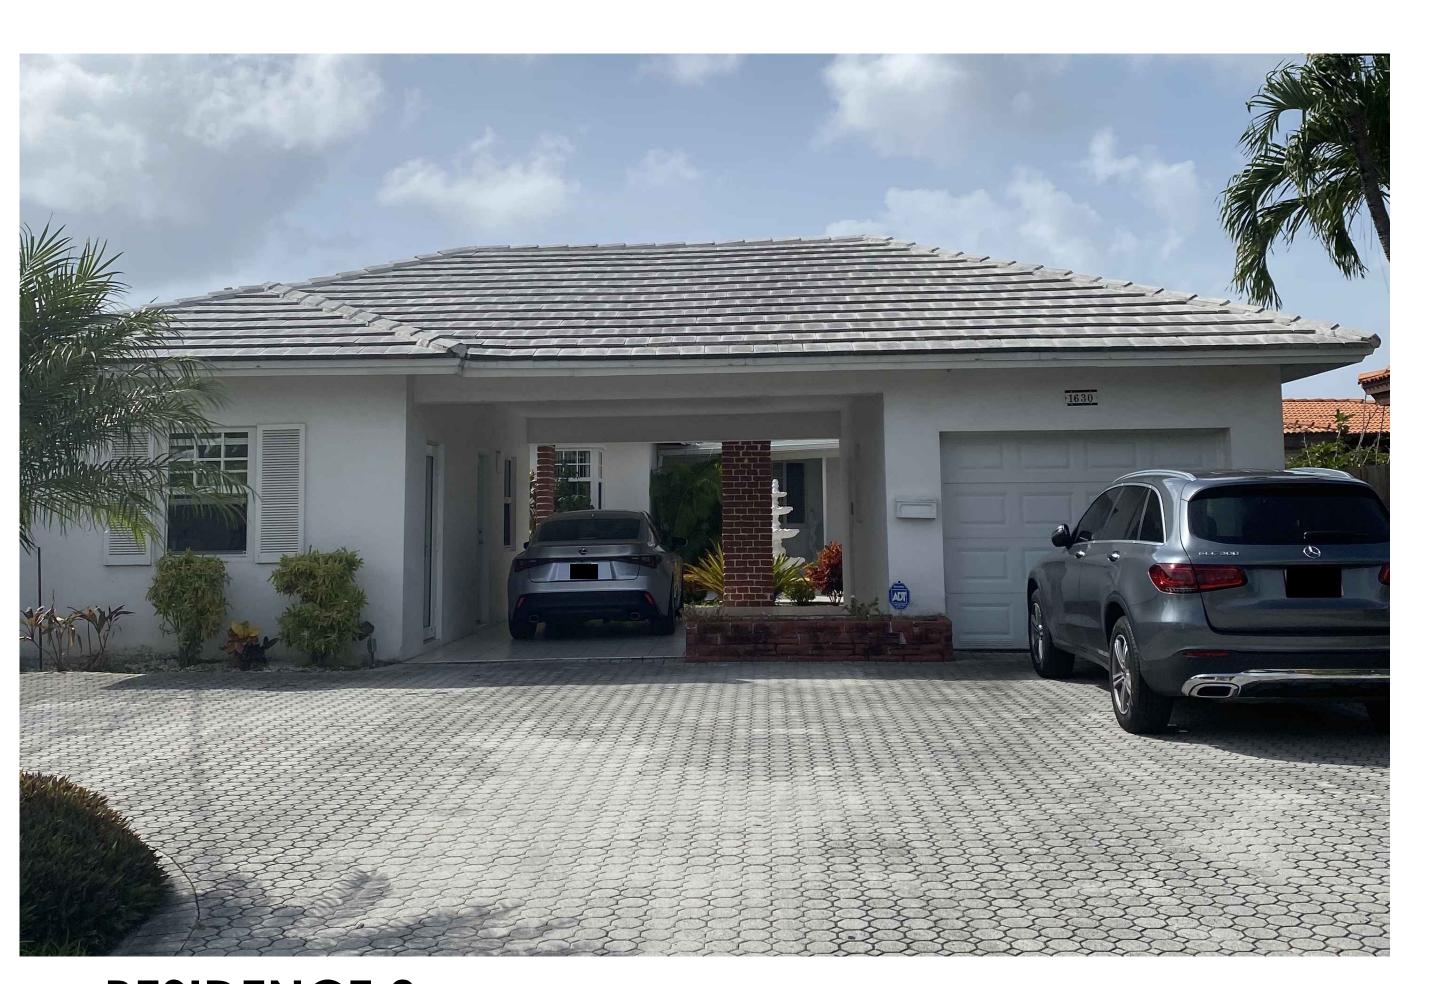

RESIDENCE 8

DRAWING TITLE

SURROUNDING PROPERTY PHOTOS

SCALE: AS SHOWN DATE: 09-26-2021



RESIDENCE 9



RESIDENCE 11



RESIDENCE 10




RESIDENCE 12



DRAWING TITLE


SURROUNDING PROPERTY PHOTOS

SCALE: AS SHOWN DATE: 09-26-2021

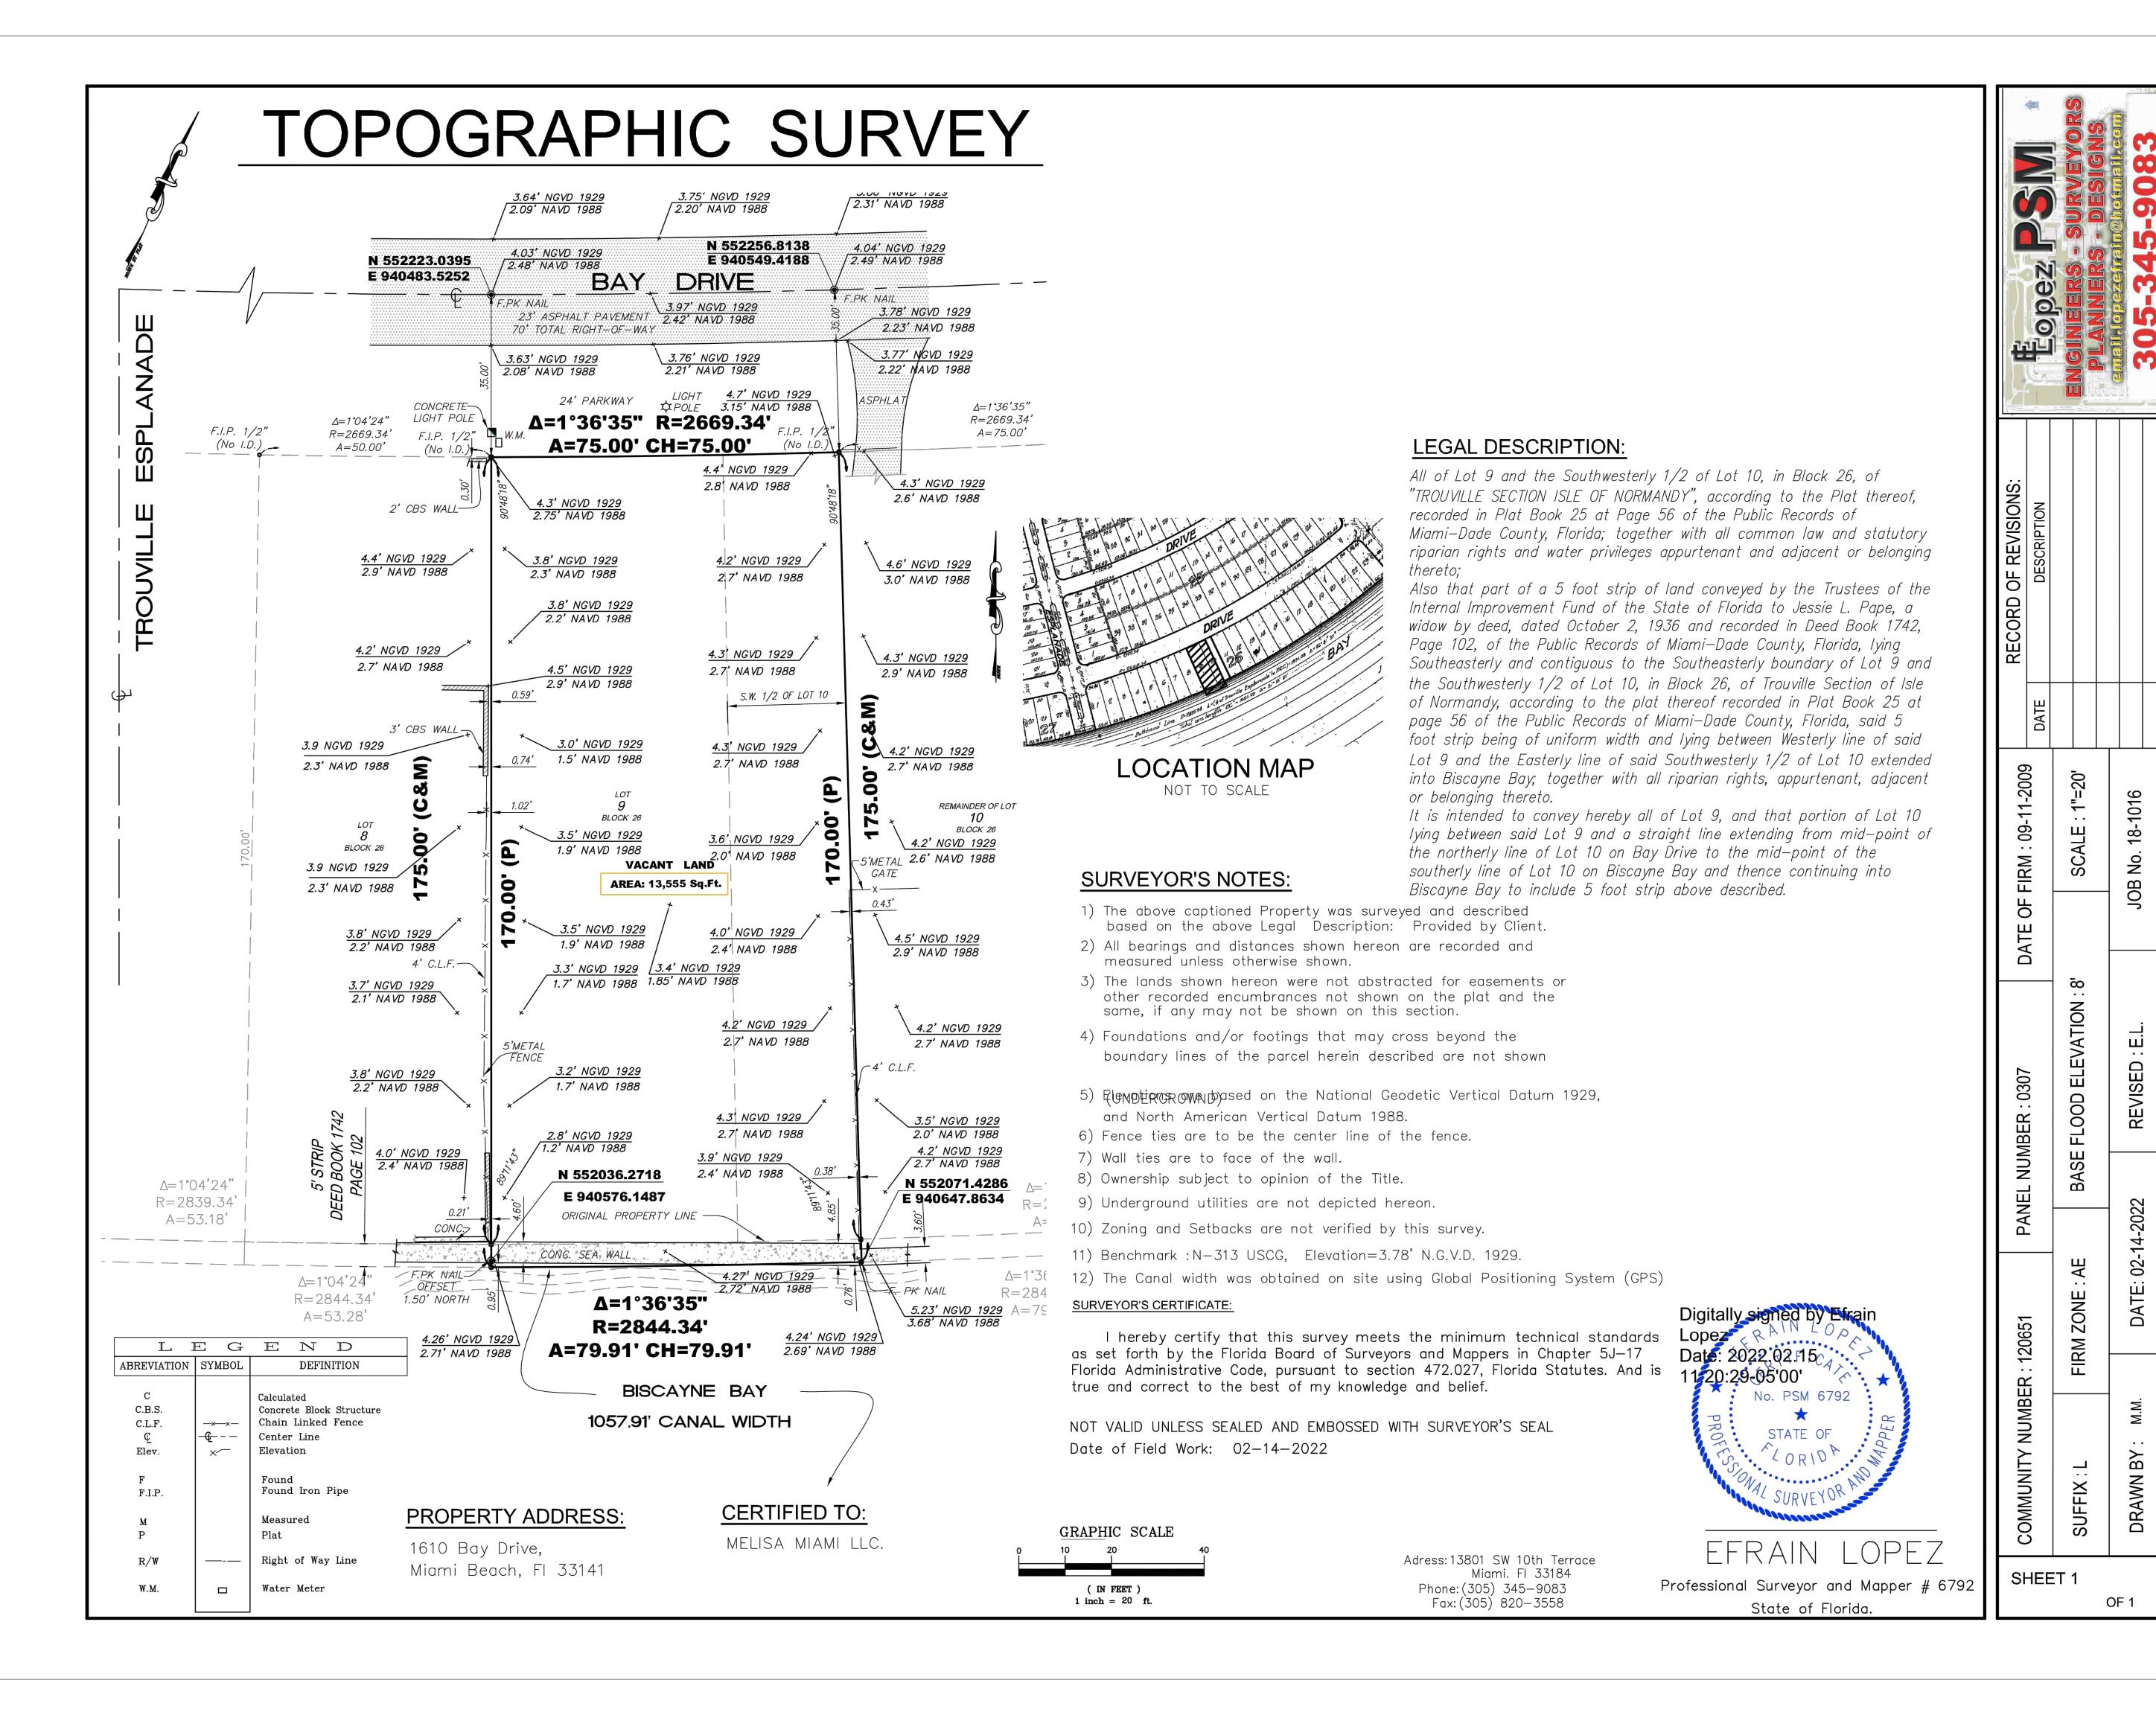

DFAXISA.

architecture . design
JOSE L. SANCHEZ, AIA, LEED AP

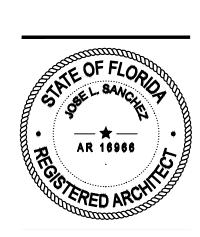

COPYRIGHT © 2022. ALL RIGHTS RESERVED.

THESE DRAWINGS AND DOCUMENTS ARE INSTRUMENTS OF SERVICE AND SHALL REMAIN THE PROPERTY OF PRAXIS ARCHITECTURE + DESIGN, WHETHER THE PROJECT FOR WHICH THEY WERE PREPARED IS EXECUTED OR NOT. THE ARE NOT TO BE USED IN ANY MANNER ON OTHER PROJECTS OR EXTENSIONS TO THIS PROJECT EXCEPT BY AGREEMENT IN WRITING AND WITH THE APPROPRIATE COMPENSATION TO PRAXIS ARCHITECTURE + DESIGN REPRODUCTIONS OF DRAWINGS & SPECIFICATION. WITHOUT THE WRITTEN CONSENT OF PRAXIS ARCHITECTURE + DESIGN IS PROHIBITED. CONTRACTORS RESPONSIBLE FOR

ADDRESS & OWNER

RESIDENCE
10 BAY DRIVE
ACH, FLORIDA. 33141

REVISION & DATE

NEW NEW

DRAWING TITLE

SURVEY


SCALE: AS SHOWN DATE: 09-26-2021

SHEET NUMBER

SURVEY

SINGLE FAMILY RESIDENTIAL - ZONING DATA SHEET

ITEMS#	ZONING INFORMATION								
1	ADDRESS:	1610 BAY DR. MIAMI BEACH. 33141							
2	FOLIO NUMBER(S):	02-3210-001-1020							
3	BOARD AND FILE NUMBERS:	DRB22-0874							
4	YEAR BUILT:	VACANT	ZONING DISTRICT:			RS-4			
5	BASED FLOOD ELEVATION:	+8.0' NGVD	GRADE VALUE IN N.G.V.D:			+4.04' NGVD			
6	ADJUSTED GRADE (FLOOD+GRADE/2)	+6.02' NGVD	FREE BOARD:			+9.0' NGVD (+1')			
7	LOT AREA:	13,555 S.F.							
8	LOT WIDTH:	75'-6"	LOT DEPTH:			175'-0"			
9	MAX. LOT COVERAGE SF AND %:	4,067 SF (30%)	PROPOSED LOT COVERAGE	SF AND %:		4,046 SF (29.84%)			
10	EXISTING LOT COVERAGE SF AND %:	N/A	LOT COVERAGE DEDUCTED	(GARAGE-STORAGE)	SF:	N/A			
11	FRONT YARD OPEN SPACE SF AND %:	845 SF (56.10%)	REAR YARD OPEN SPACE	SF AND %:		1,467 SF (70.25%)			
12	MAX. UNIT SIZE SF AND %:	6,778 SF (50%)	PROPOSED UNIT SIZE SF A	AND %:		6,549 SF (48.31%)			
13	EXISTING FIRST FLOOR UNIT SIZE%:	N/A	PROPOSED FIRST FLOOR U	PROPOSED FIRST FLOOR UNIT SIZE:					
14	EXISTING SECOND FLOOR UNIT SIZE:	N/A	PROPOSED SECOND FLOOR SF AND % (NOTE: TO EX OF THE MAIN HOME REQUI	N/A					
15			PROPOSED SECOND FLOOR	2,924 SF (21.57%)					
16			PROPOSED ROOF DECK AR OF THE ENCLOSED FLOOR	729 SF (24.93%)					
			REQUIRED	EXISTING	PROPOSED	DEFICIENCIES			
17	HEIGHT:		24 FT.		24'-0"	SEE ELEVATION SHEETS			
18	SETBACKS:			,					
19	FRONT FIRST LEVEL:		20 FT.	N/A	20'-0"				
20	FRONT SECOND LEVEL:		20 FT.	N/A	57'-3"				
	SIDEYARDS:								
21	SIDE 1 — EAST:		THE SUM OF THE REQUIRE SIDE YARDS SHALL BE AT	Г	10'-3"				
22	SIDE 2 - WEST:		LEAST 25% OF LOT WIDTH $(75.5' \times 25\% = 18.875')$		10'-0"				
23	REAR: 15% OF 175 FT		26'-3"		48'-3"				
24	ACCESSORY STRUCTURE SIDE 1:		N/A	N/A	N/A				
25	ACCESSORY STRUCTURE SIDE 2 OR (FACING STREET):		N/A	N/A	N/A				
26	ACCESSORY STRUCTURE REAR:		N/A	N/A	N/A				
27	LOCATED WITHIN A LOCAL HISTORIC DIST		NO NO						
28	SINGLE FAMILY RESIDENCE?	NO NO							
29	DETERMINATE TO BE ARCHITECTURALLY	SIGNIFICANT?	NO						

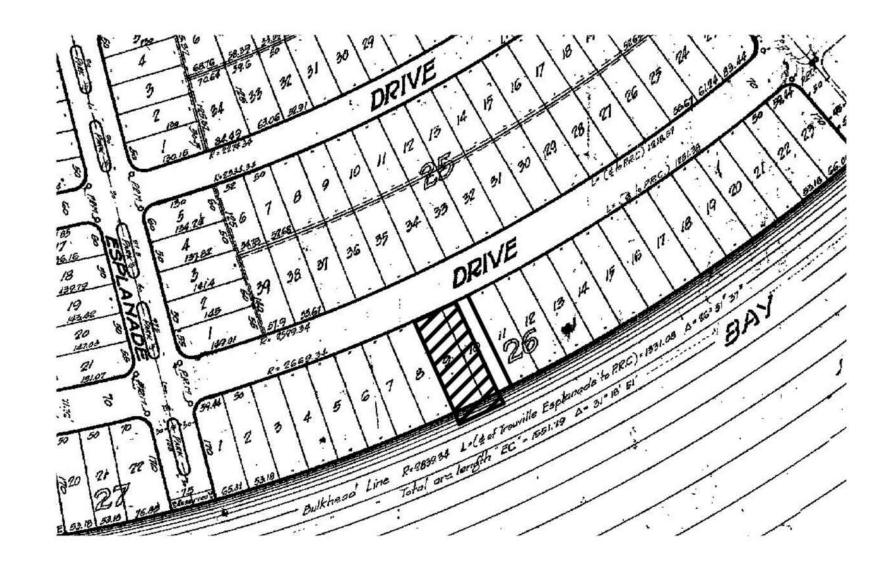



SCOPE OF WORK

- NEW SINGLE FAMILY RESIDENCE

APPLICABLE CODES

- FLORIDA BUILDING CODE 2020 7TH EDITION, RESIDENTIAL
- FLORIDA BUILDING CODE 2020 7TH EDITION, MECHANICAL
 FLORIDA BUILDING CODE 2020 7TH EDITION, PLUMBING
- NATIONAL ELECTRICAL CODE (NEC) 2017
- CITY OF MIAMI BEACH LOCAL ORDINANCE (RS-4)

LEGAL DESCRIPTION

ALL OF LOT 9 AND THE SOUTHWESTERLY 1/2 OF LOT 10, IN BLOCK 26, OF "TROUVILLE SECTION ISLE OF NORMANDY", ACCORDING TO THE PLAT THEREOF, RECORDED IN PLAT BOOK 25 AT PAGE 56 OF THE PUBLIC RECORDS OF MIAMI-DADE COUNTY, FLORIDA; TOGETHER WITH ALL COMMON LAW AND STATUTORY RIPARIAN RIGHTS AND WATER PRIVILEGES APPURTENANT AND ADJACENT OR BELONGING THERETO;

ALSO THAT PART OF A 5 FOOT STRIP OF LAND CONVEYED BY THE TRUSTEES OF THE INTERNAL IMPROVEMENT FUND OF THE STATE OF FLORIDA TO JESSIE L. PAPE, A WIDOW BY DEED, DATED OCTOBER 2, 1936 AND RECORDED IN DEED BOOK 1742, PAGE 102, OF THE PUBLIC RECORDS OF MIAMI—DADE COUNTY, FLORIDA, LYING SOUTHEASTERLY AND CONTIGUOUS TO THE SOUTHEASTERLY BOUNDARY OF LOT 9 AND THE SOUTHWESTERLY 1/2 OF LOT 10, IN BLOCK 26, OF TROUVILLE SECTION OF ISLE OF NORMANDY, ACCORDING TO THE PLAT THEREOF RECORDED IN PLAT BOOK 25 AT PAGE 56 OF THE PUBLIC RECORDS OF MIAMI—DADE COUNTY, FLORIDA, SAID 5 FOOT STRIP BEING OF UNIFORM WIDTH AND LYING BETWEEN WESTERLY LINE OF SAID LOT 9 AND THE EASTERLY LINE OF SAID SOUTHWESTERLY 1/2 OF LOT 10 EXTENDED INTO BISCAYNE BAY; TOGETHER WITH ALL RIPARIAN RIGHTS, APPURTENANT, ADJACENT OR BELONGING THERETO.

IT IS INTENDED TO CONVEY HEREBY ALL OF LOT 9, AND THAT PORTION OF LOT 10 LYING BETWEEN SAID LOT 9 AND A STRAIGHT LINE EXTENDING FROM MID-POINT OF THE NORTHERLY LINE OF LOT 10 ON BAY DRIVE TO THE MID-POINT OF THE SOUTHERLY LINE OF LOT 10 ON BISCAYNE BAY AND THENCE CONTINUING INTO BISCAYNE BAY TO INCLUDE 5 FOOT STRIP ABOVE DESCRIBED.

OFAXIS. architecture . design



Jose L Sanchez DN: cn=Jose L Sanchez, c=l DN: cn=Jose L Sanchez, c=l Praxis Architecture, Inc., email=jsanchez@praxisarch Date: 2022.09.02 17:31:56 - 04'00'

COPYRIGHT © 2022. ALL RIGHTS RESERVED.

THESE DRAWINGS AND DOCUMENTS ARE INSTRUMENTS OF SERVICE AND SHALL REMAIN THE PROPERTY OF PRAXIS ARCHITECTURE + DESIGN, WHETHER THE PROJECT FOR WHICH THEY WERE PREPARED IS EXECUTED OR NOT. THE ARE NOT TO BE USED IN ANY MANNER ON OTHER PROJECTS OR EXTENSIONS TO THIS PROJECT SOR OF SERVICENT OF THE APPROPRIATION OF DRAWINGS & SPECIFICATIONS WITHOUT THE WRITTEN CONSENT OF PRAXIS ARCHITECTURE!

+ DESIGN IS PROHBITED. CONTRACTORS RESPONSIBLE FOR VERIFYING ALL SITE CONDITIONS PRIOR TO PROCEEDING

ADDRESS & OWNER

NEW RESIDENCE
1610 BAY DRIVE
IAMI BEACH, FLORIDA. 33141
OWNER:

REVISION & DATE

2

4


5

ZONING
DATA/
LOCATION
PLAN


SCALE: AS SHOWN DATE: 09-26-2021

SHEET NUMBER

A-1.0

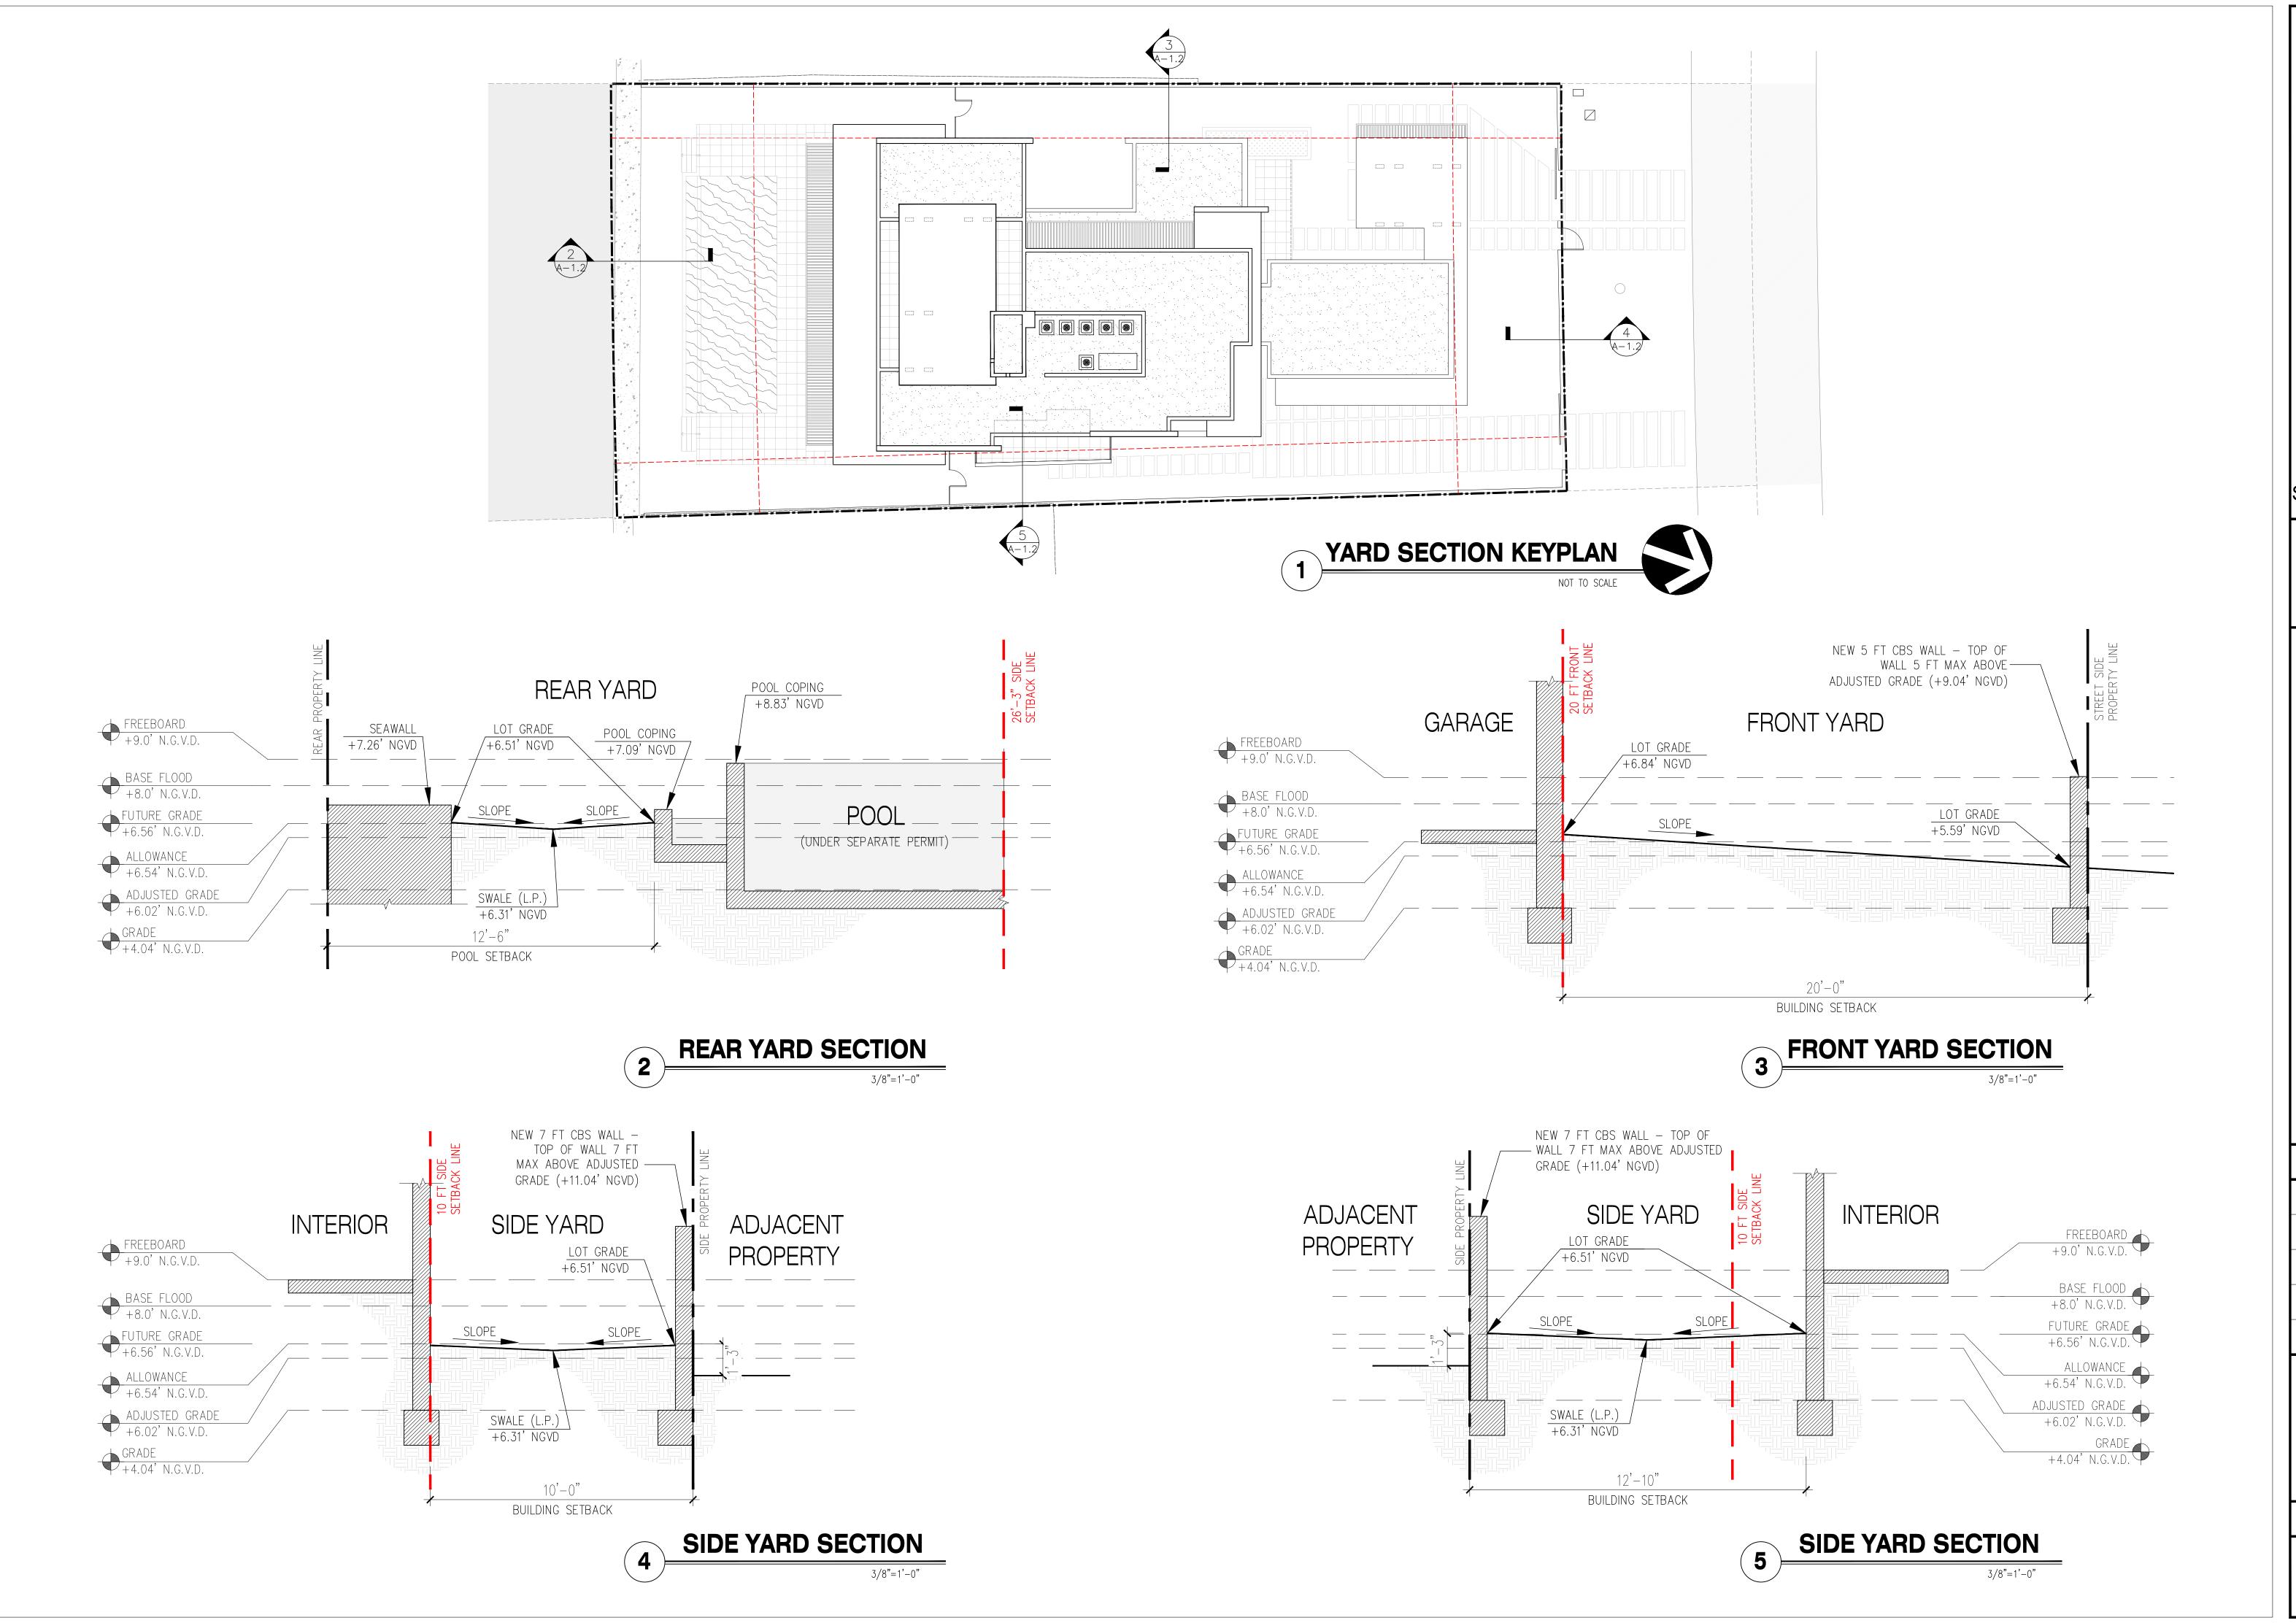

Draxis architecture, design

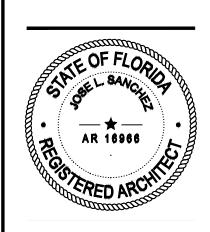

Jose L
Sanchez
Digitally signed by Jose L
Sanchez
Div. cn=Jose L Sanchez, c=US,
o=Praxis Architecture, Inc.,
email=jsanchez@praxisarch.com
Date: 2022.09.02 17:32:37 04'00'

COPYRIGHT © 2022. ALL RIGHTS RESERVED.

THESE DRAWINGS AND DOCUMENTS ARE INSTRUMENTS OF SERVICE AND SHALL REMAIN THE PROPERTY OF PRAXIS ARCHITECTURE + DESIGN, WHETHER THE PROJECT FOR WHICH THEY WERE PREPARED IS EXECUTED OR NOT. THEY ARE NOT TO BE USED IN ANY MANNER ON OTHER PROJECTS OR EXTENSIONS TO THIS PROJECT EXCEPT BY AGREEMENT IN WRITING AND WITH THE APPROPRIATE COMPENSATION TO PRAXIS ARCHITECTURE + DESIGN. REPRODUCTIONS OF DRAWINGS & SPECIFICATIONS WITHOUT THE WRITTEN CONSENT OF PRAXIS ARCHITECTURE + DESIGN IS PROHIBITED, CONTRACTORS RESPONSIBLE FOR VERIFYING ALL SITE CONDITIONS PRIOR TO PROCEEDING WITH WORK.

ADDRESS & OWNER

ADDRESS & OWNER

NEW RESIDENCE
1610 BAY DRIVE
MIAMI BEACH, FLORIDA. 33141
OWNER:

REVISION & DATE

2 3 4


5
DRAWING TITLE

YARD SECTIONS

SCALE: AS SHOWN DATE: 09-26-2021

SHEET NUMBER

A-1.2

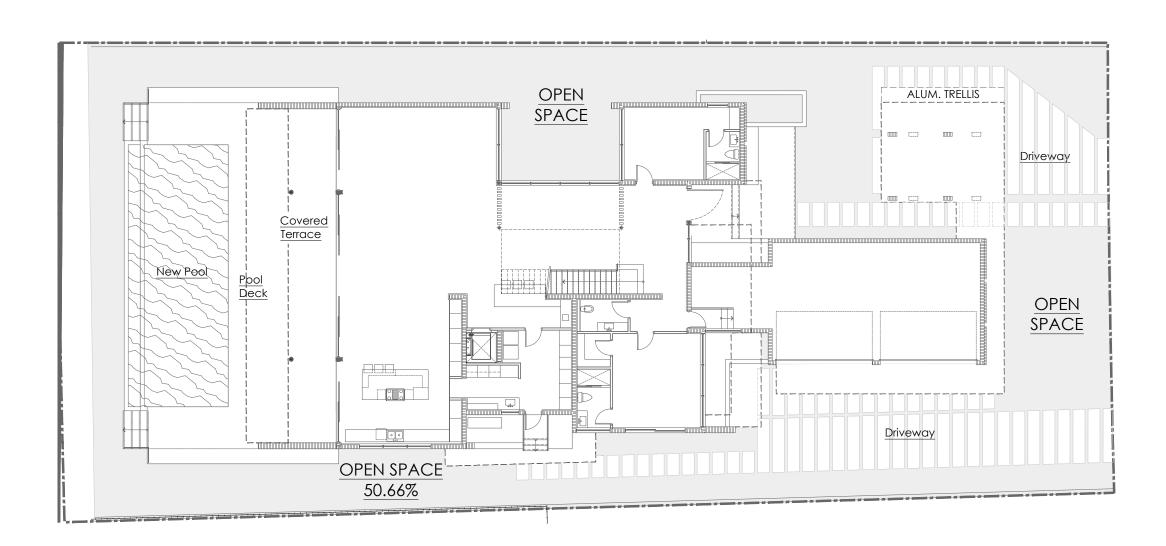

SITE OPEN SPACE

1/16" = 1'-0"


PRONT/REAR YARD OPEN SPACE

1/16" = 1'-0"

LOT AREA: 13,555 S.F.

COMPLETE SITE OPEN SPACE 338 S.F. POOL WATER (AT 50%) 6,530 S.F. OPEN SPACE TOTAL OPEN SPACE 6,868 S.F 50.66 %

OPEN SPACE (GREEN)

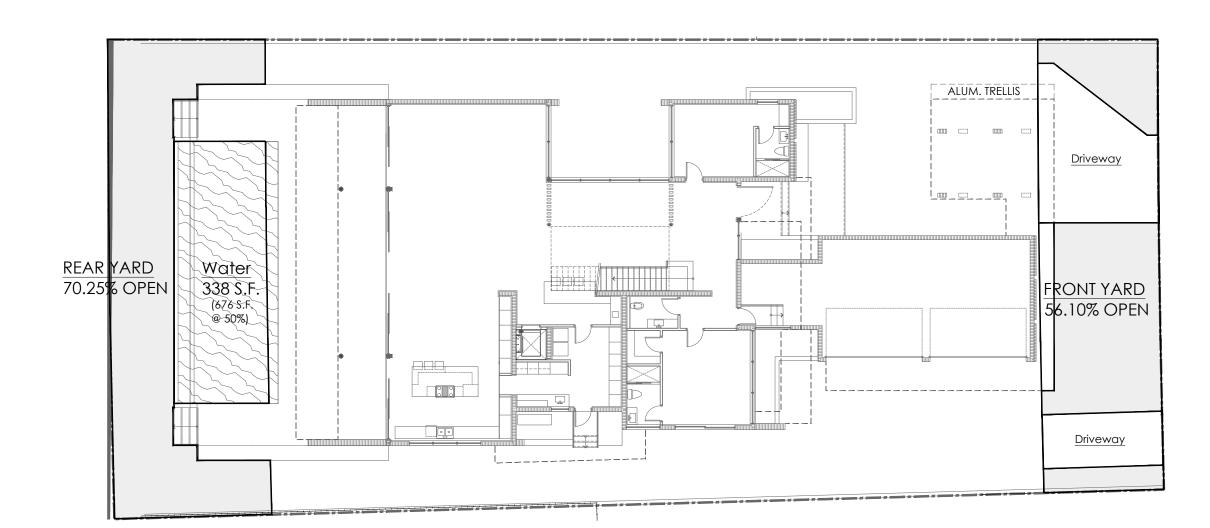



REAR YARD OPEN SPACE	
REAR YARD AREA MIN. REQUIRED (70%)	2,088 S.F. 1,462 S.F.
GREEN SPACE POOL WATER	1,129 S.F. 338 S.F.
TOTAL OPEN SPACE	1,467 S.F

OPEN SPACE (GREEN)

70.25%

FRONT YARD OPEN SPACE	
FRONT YARD AREA MIN. REQUIRED (50%)	1,506 S.F. 753 S.F.
TOTAL OPEN SPACE	845 S.F 56.10%

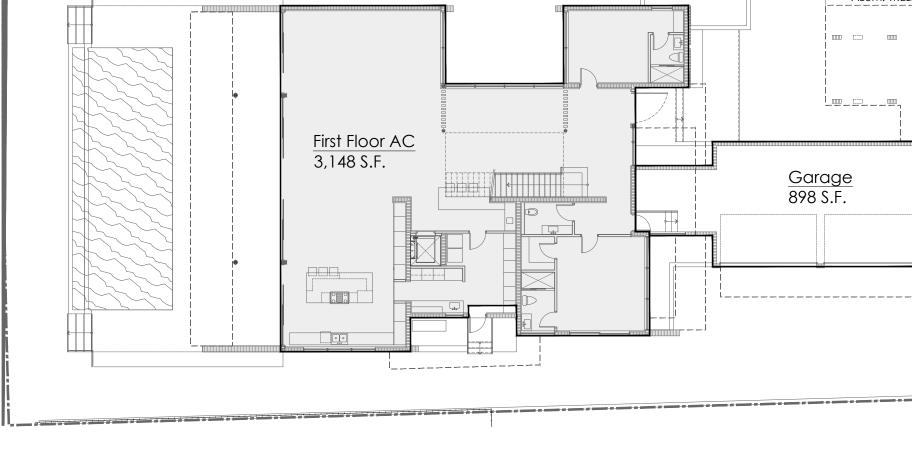

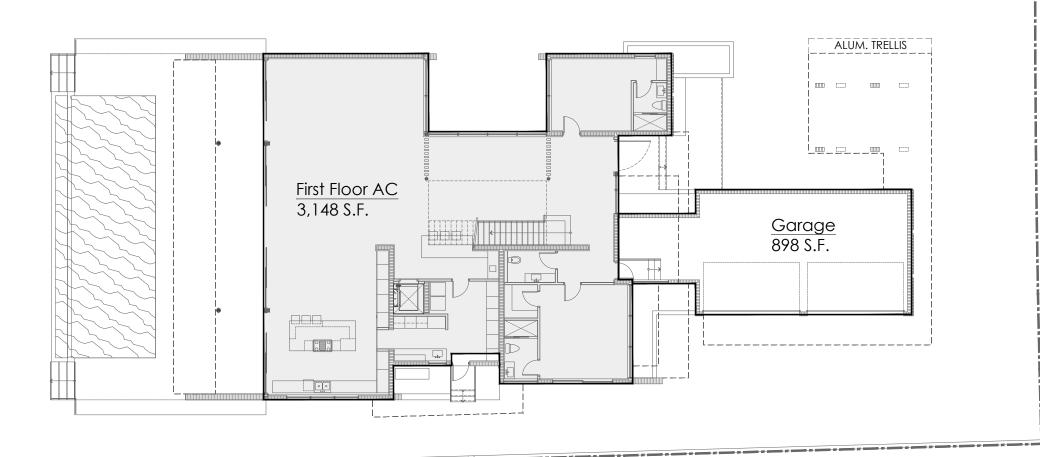



UNIT SIZE MAX ALLOWED (50%) 6,778 S.F. 3,148 S.F. FIRST FL. AC 398 S.F. GARAGE 2,924 S.F. SECOND FL. AC 79 S.F. TOTAL 6,549 S.F 48.31%


LOT AREA: 13,555 S.F.


1. GARAGE - EXCLUDING, FIRST 2. TERRACE (1ST FL) -EXCLUDED, OPEN ON 1 SIDE.

3. BALCONIES - EXCLUDED, UNENCLOSED. 4. TERRACE (2ND FL) -EXCLUDED.

FIRST AND SECOND FL. AREA COUNTED UNIT SIZE


NON-AC AREA COUNTED IN UNIT SIZE

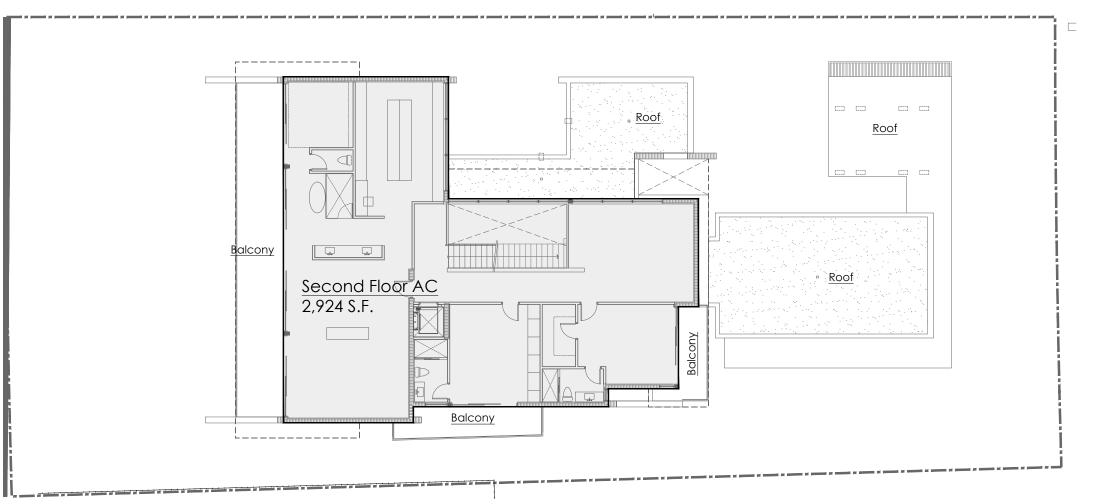

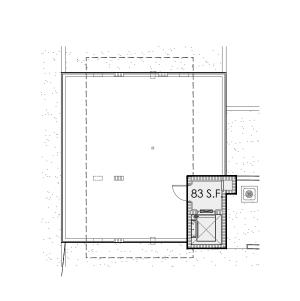





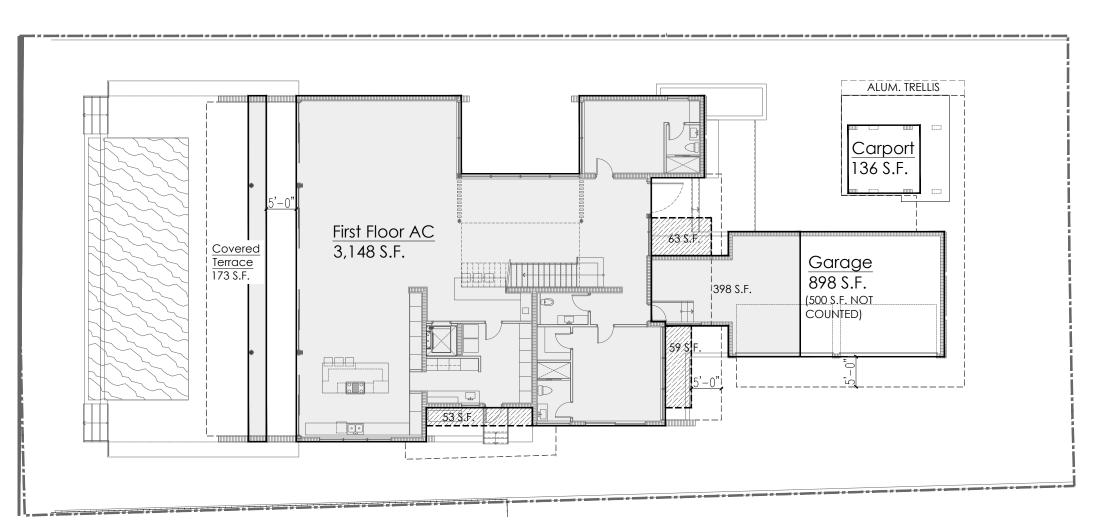

LOT AREA: 13,555 S.F.

LOT COVERAGE MAX ALLOWED (30%) 4,067 S.F. FIRST FL. AC 3,148 S.F.
SECOND FL. PROJEC. 175 S.F.
COVERED TERRACE 173 S.F.
CARPORT & GARAGE 534 S.F. 4,046 S.F

29.84%

. GARAGE - INCLUDING FIRST TERRACE (1ST FL) - COUNTED AREA COVERED BY ENCLOSED SPACE ABOVE.

FIRST FL. AREA
COUNTED COVERAGE

SECOND FL. (AC) PROJECTION COUNTED IN COVERAGE

FIRST FLOOR COVERAGE

1/16" = 1'-0"



AR 16966 Jose L

Digitally signed by Jose L
Sanchez
DN: cn=Jose L Sanchez, o=Praxis Architecture, Inc. Sanchez email=jsanchez@praxisarch
Date: 2022.09.02 17:32:4604'00'

ADDRESS & OWNER

ENCE 1610 BAY DRIVE MIAMI BEACH, FLORIDA RESID NEW


REVISION & DATE

DRAWING TITLE

COVERAGE & UNIT SIZE DIAGRAM

SCALE: AS SHOWN DATE: 09-26-2021

A-1.3

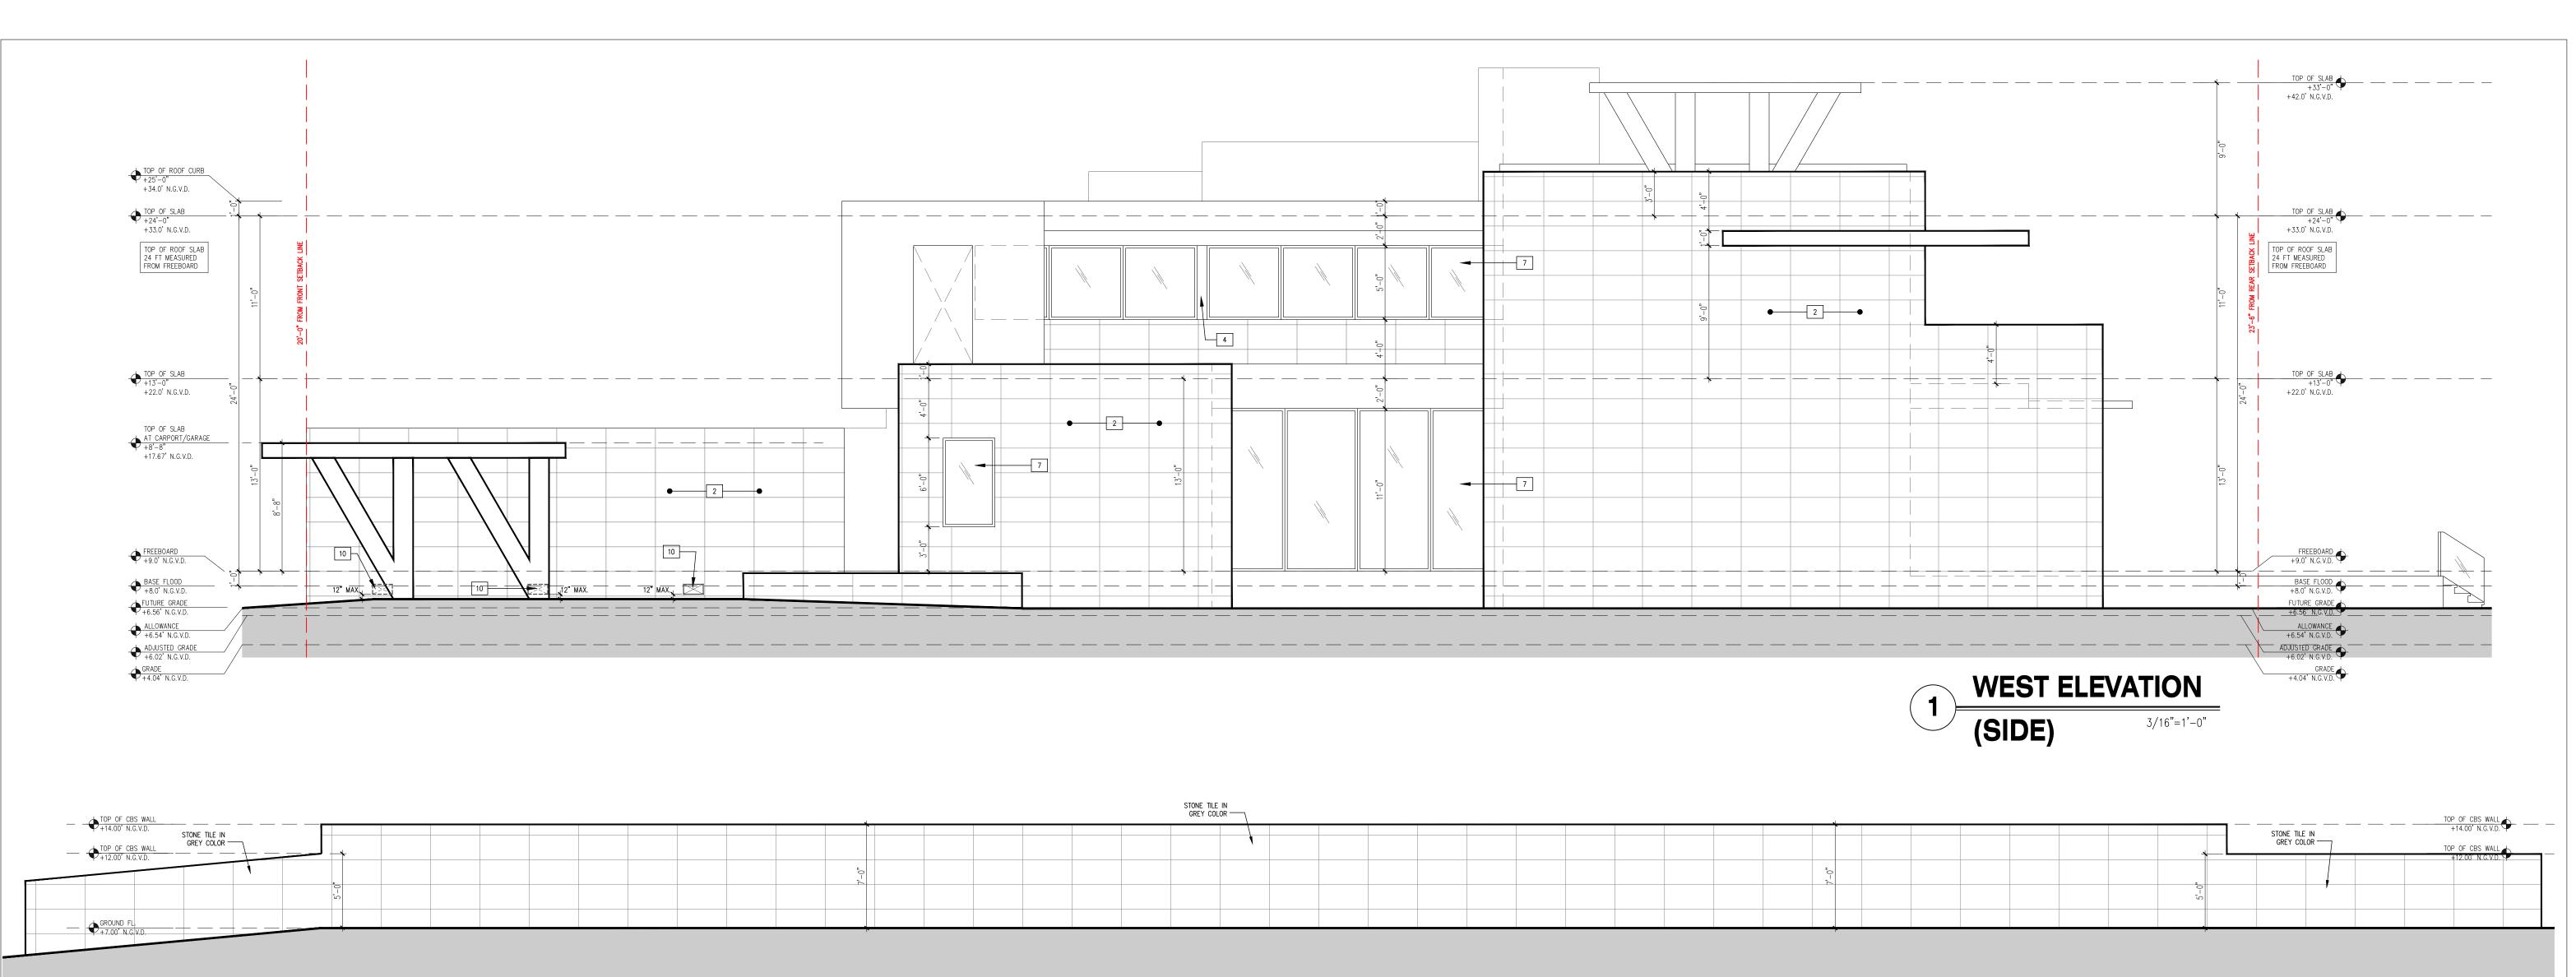

ELEVATIONS KEYNOTES / SPECIFICATIONS

2. STONE TILE IN GREY COLOR IN PROPORTION OF STACKED

4. GALVANIZED STEEL COLUMN W/ALUMINUM BREAK METAL

5. CONCRETE EYEBROW W/SEALOFLEX WATERPROOFING AND

7. DADE COUNTY APPROVED ALUM./IMPACT GLASS WINDOWS

CALCULATIONS FOR SHADING COEFFICIENT AND U FACTOR

REQUIRED. PROVIDE FLUID APPLIED WATERPROOFING ON THE

LOUVERS SHALL REJECT A 4" SPHERE WHEN ADJACENT TO

PAINT CMU SCREEN & GATE SAME COLOR AS THE HOUSE.

10. HYDROSTATIC VENTS TYP.-SMART VENTS MODEL 1540-510,

11. OVERHEAD GARAGE DOOR (COLOR TO MATCH ADJACENT

ENCLOSURE (BY WINDOW DOOR MANUFACTURER) TO MATCH

I. PARAPET WALL (SEE ROOF PLAN FOR HEIGHT)

THE WINDOWS. W/ ELECTRO-MATIC PAINTING

(IMPACT, BRONZE FINISH). REFER TO ENERGY

INSIDE FACE OF THE ROUGH OPENING. (TYP) B. DECORATIVE ALUMN. LOUVERS — SPACING BETWEEN

). ALUM SCREEN ENCLOSURE FOR CONDENSING UNITS -


6. GLASS/ALUMN. GUARDRAIL (42" A.F.F.)

EACH CERTIFIED TO COVER 200 S.F.

BOND CMU 8 X 18. 3. ALUMINUM GUARDRAIL

DRIP EDGE.


A WALKING SURFACE..

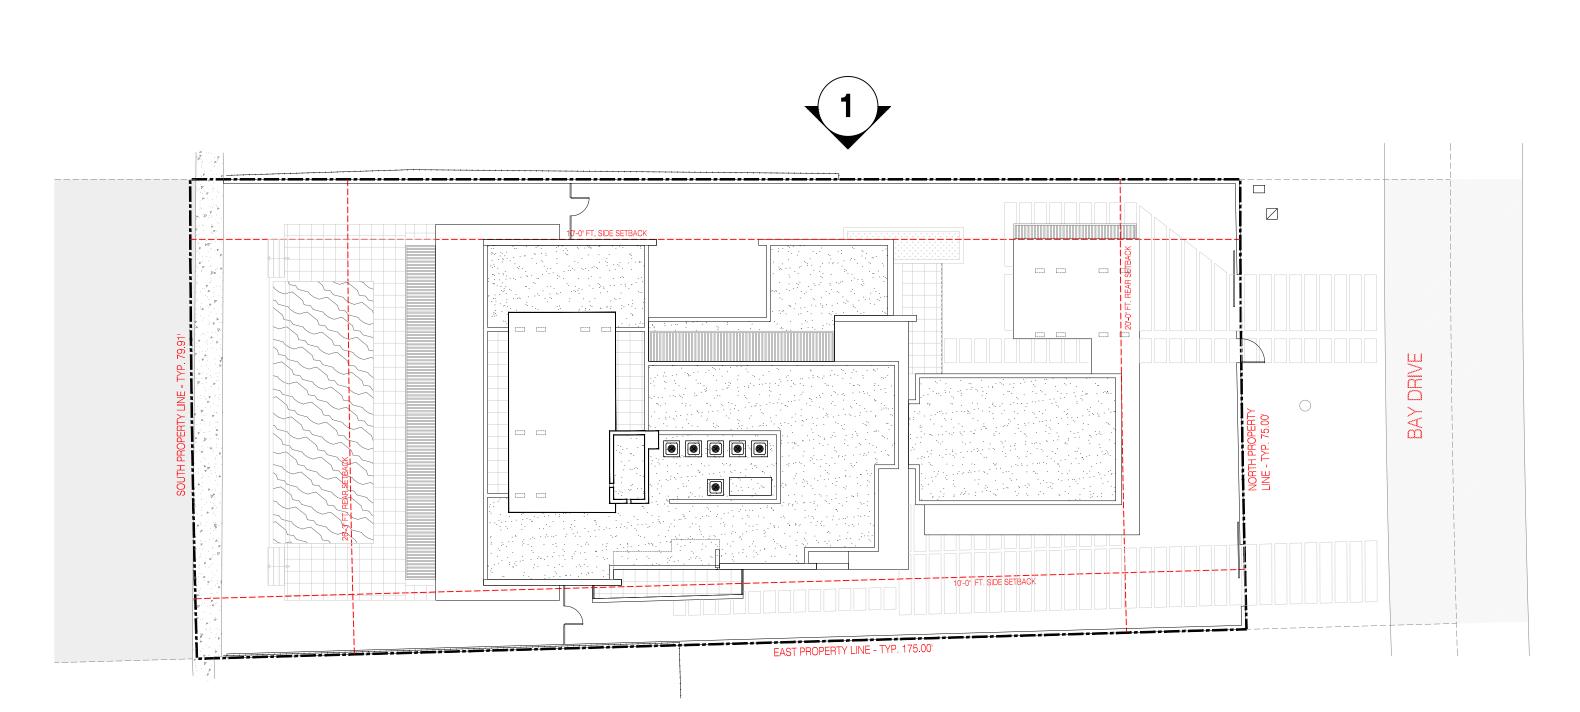

ELEVATION KEYPLAN

NOT TO SCALE



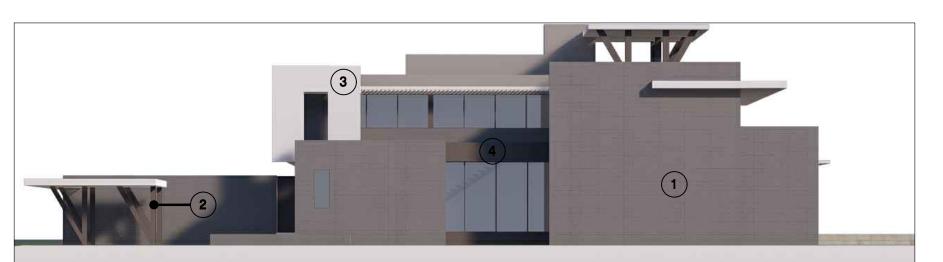

MATERIAL REFERENCE RENDER. DESIGNED BY PRAXIS

MATERIAL LEGEND



1. STONE TILE IN GREY COLOR IN PROPORTION OF STACKED BOND CMU 8 X 18.



2. MATTE FINISHED IONIZED ALUMINUM.





3. WHITE SMOOTH STUCCO



4. DARK-BROWN PAINT OVER SMOOTH STUCCO

ADDRESS & OWNER

ENCE 1610 BAY DRIVE I BEACH, FLORIDA. OWNER: RESID NEW


REVISION & DATE


DRAWING TITLE

WEST **ELEVATION** (SIDE)

SCALE: AS SHOWN DATE: 09-26-2021

SHEET NUMBER

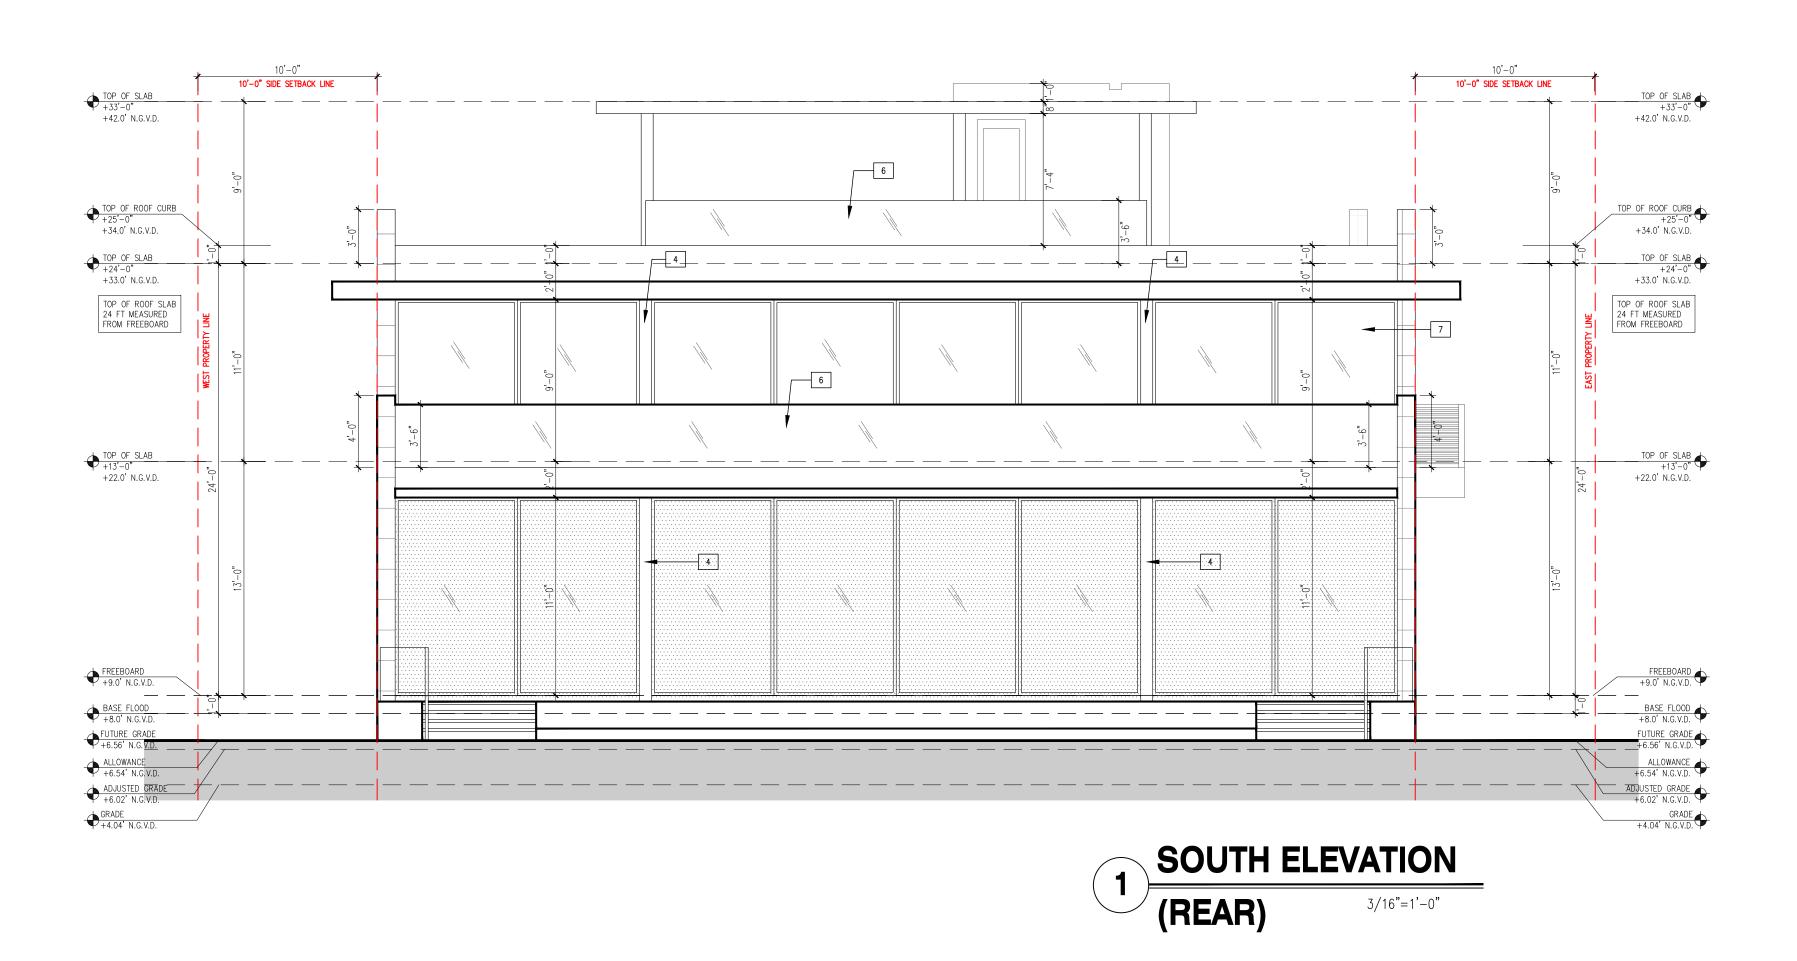

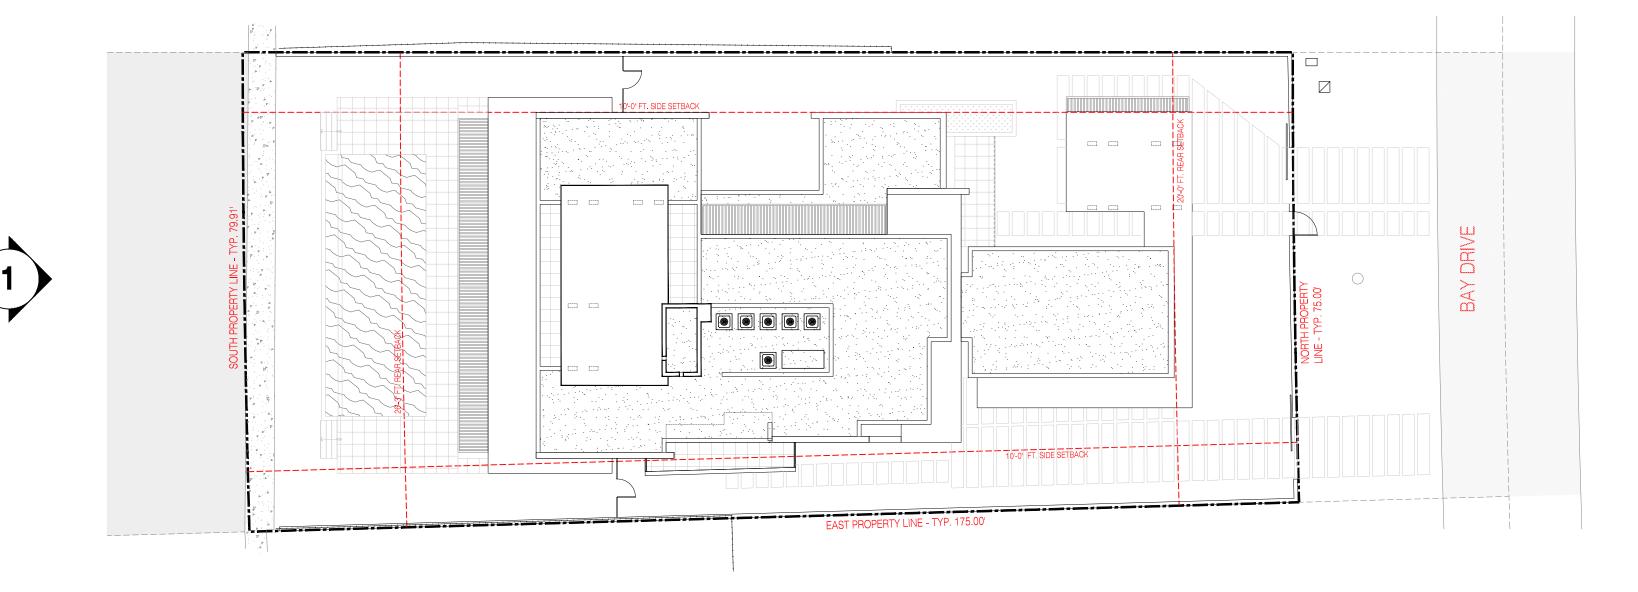

ELEVATION KEYPLAN

NOT TO SCALE

ELEVATIONS KEYNOTES / SPECIFICATIONS

- PARAPET WALL (SEE ROOF PLAN FOR HEIGHT)
- STONE TILE IN GREY COLOR IN PROPORTION OF STACKED BOND CMU 8 X 18.
- ALUMINUM GUARDRAIL 4. GALVANIZED STEEL COLUMN W/ALUMINUM BREAK METAL ENCLOSURE (BY WINDOW DOOR MANUFACTURER) TO MATCH
- THE WINDOWS. W/ ELECTRO-MATIC PAINTING CONCRETE EYEBROW W/SEALOFLEX WATERPROOFING AND
- DRIP EDGE. GLASS/ALUMN. GUARDRAIL (42" A.F.F.)
- DADE COUNTY APPROVED ALUM./IMPACT GLASS WINDOWS (IMPACT, BRONZE FINISH). REFER TO ENERGY CALCULATIONS FOR SHADING COEFFICIENT AND U FACTOR REQUIRED. PROVIDE FLUID APPLIED WATERPROOFING ON THE INSIDE FACE OF THE ROUGH OPENING. (TYP)
- DECORATIVE ALUMN. LOUVERS SPACING BETWEEN LOUVERS SHALL REJECT A 4" SPHERE WHEN ADJACENT TO A WALKING SURFACE..
- ALUM SCREEN ENCLOSURE FOR CONDENSING UNITS -PAINT CMU SCREEN & GATE SAME COLOR AS THE HOUSE.

. HYDROSTATIC VENTS TYP.-SMART VENTS MODEL 1540-510,

EACH CERTIFIED TO COVER 200 S.F. 1. OVERHEAD GARAGE DOOR (COLOR TO MATCH ADJACENT





MATERIAL REFERENCE RENDER. DESIGNED BY PRAXIS

MATERIAL LEGEND



1. STONE TILE IN GREY COLOR IN PROPORTION OF STACKED BOND CMU 8 X 18.



2. MATTE FINISHED IONIZED ALUMINUM.



3. WHITE SMOOTH STUCCO



4. DARK-BROWN PAINT OVER SMOOTH STUCCO



ADDRESS & OWNER

ENCE 1610 BAY DRIVE MIAMI BEACH, FLORIDA RESIDI N N N


REVISION & DATE


DRAWING TITLE

SOUTH **ELEVATION** (REAR)

SCALE: AS SHOWN DATE: 09-26-2021

A-3.3

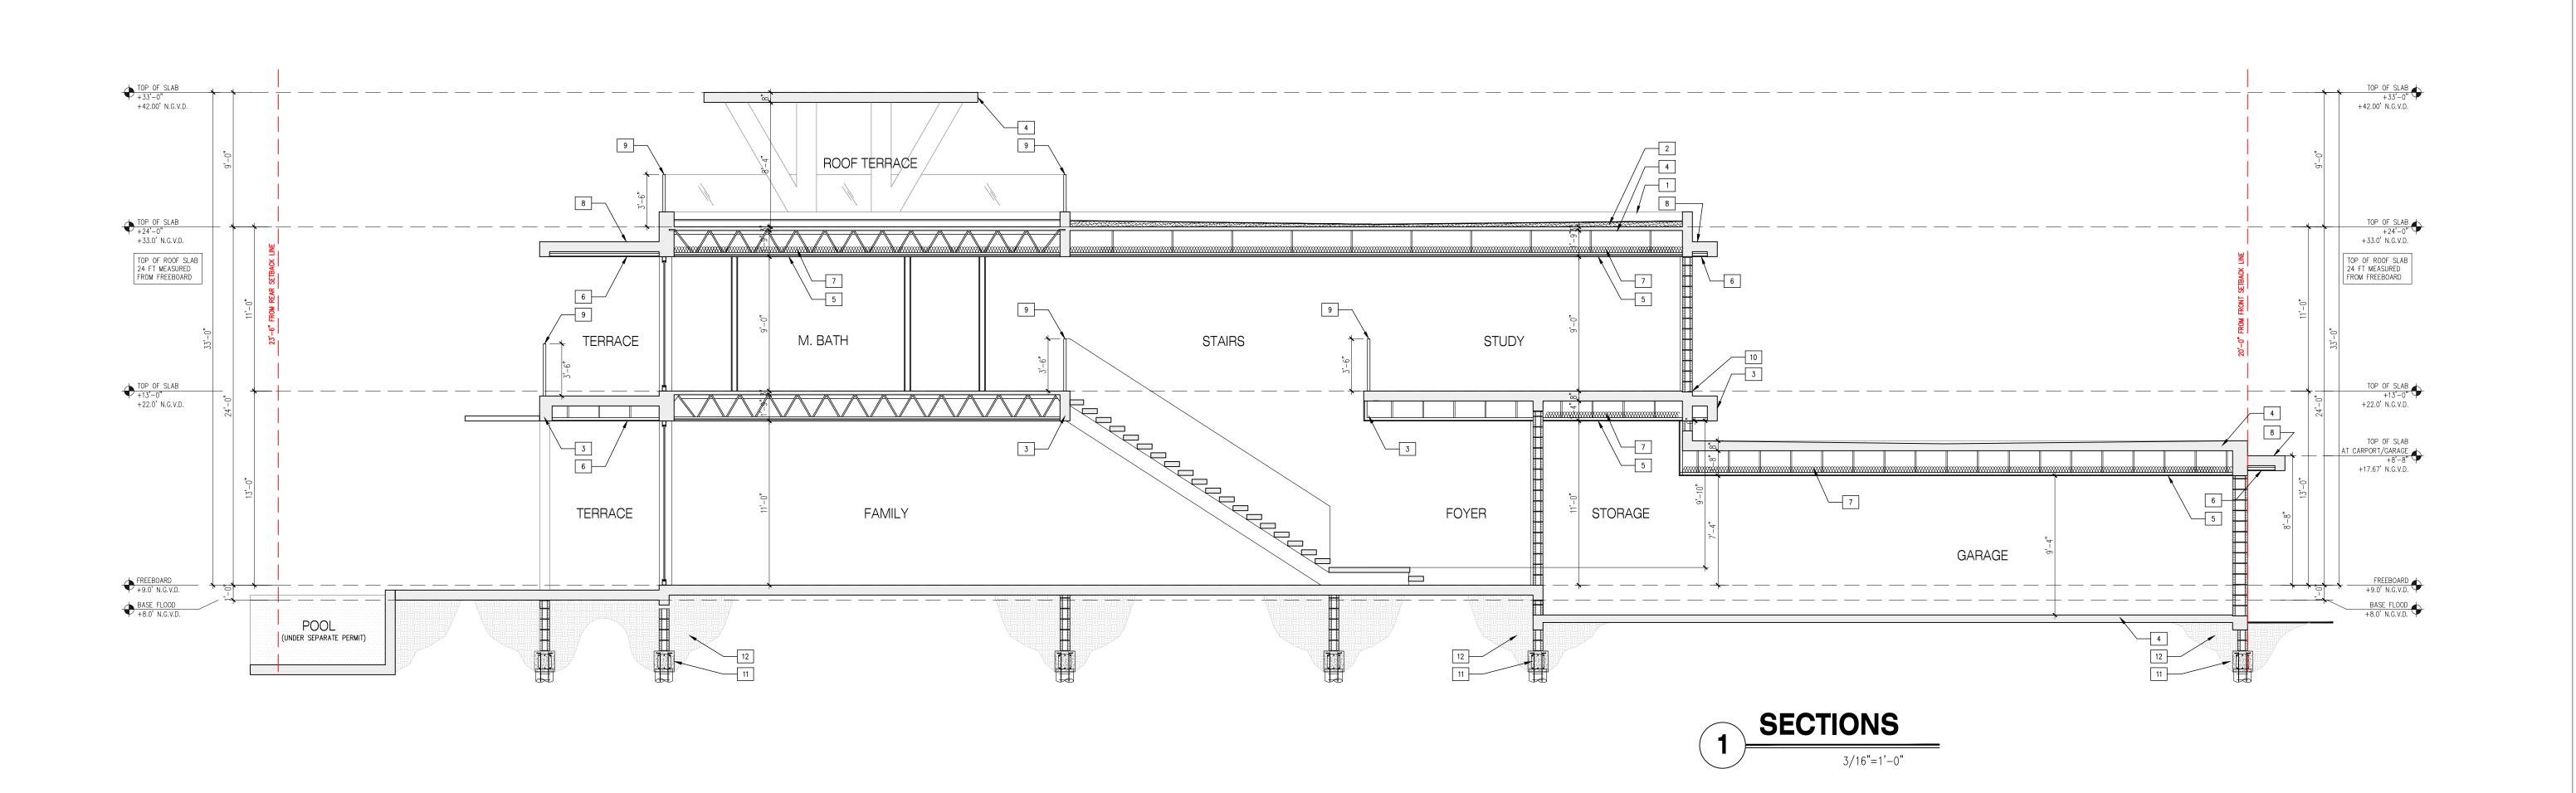

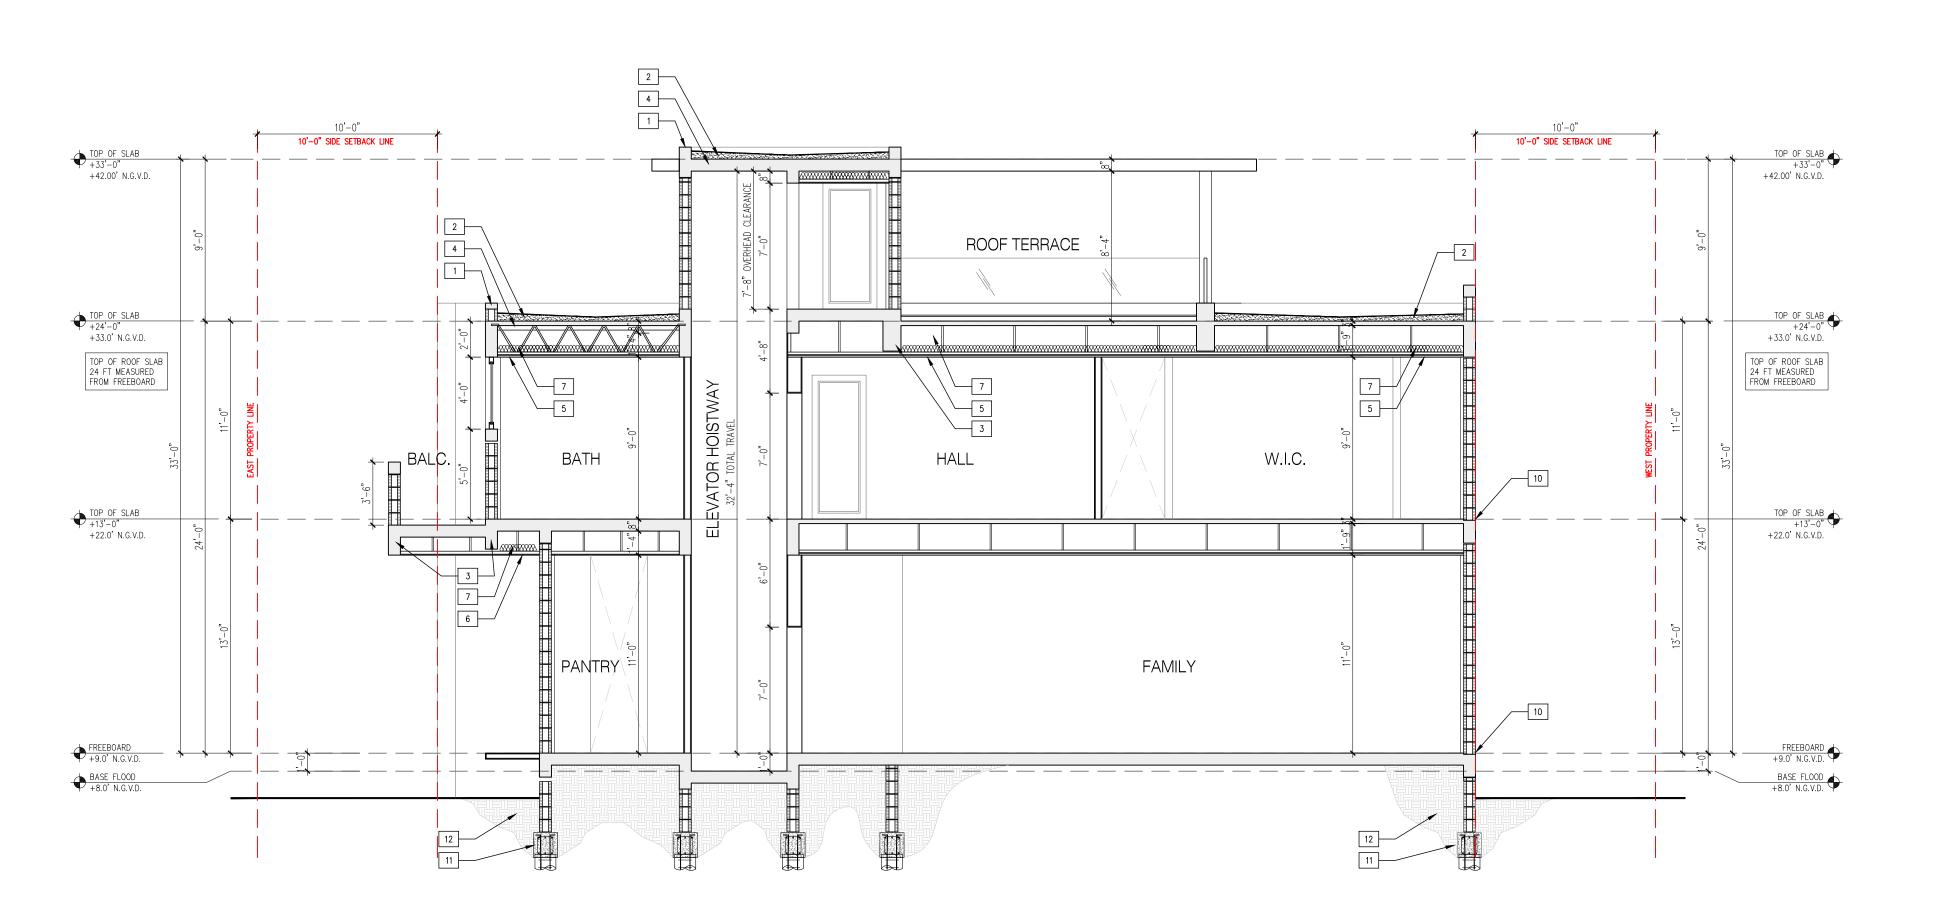

SECTION KEYNOTES

- PARAPET WALL (SEE ROOF PLAN FOR HEIGHT)
- 2. PROVIDE 10 YR WARRANTY ROOFING SYSTEM. ROOFING SYSTEM INSTALLATION SHALL BE PERFORMED PER MANUFACTURER'S RECOMMENDATIONS AND PER NATIONAL ROOFING CONTRACTORS ASSOCIATION STANDARD DETAILS.
- CONCRETE BEAM (SEE STRUCT. DWGS. FOR REINF.)
 CONCRETE SLAB (SEE STRUCT. DWGS. FOR REINF.)
- 4. CUNCRETE SLAB (SEE STRUCT, DWGS, FOR REINF.)

 5. SUSPENDED 5/8" GYPSUM CEILING ON METAL STUD FRAMING, INSTALL AFTER
- DUCTWORK AND PLUMBING IS IN PLACE.
- 6. SMOOTH STUCCO CEILING ON METAL STUD SUBSTRATE. (EXTERIOR CEILING)7. R-30 BATT INSULATION OVER GYPSUM CEILING.
- 7. R-30 BATT INSULATION OVER GYPSUM CEILING.

 8. SEALOFLEX WATERPROOFING, TYP. AT ALL CANOPIES AND DRIP EDGE.
- 9. GLASS GUARDRAIL/HANDRAILS (42" OR 36" HIGH A.F.F.) PROVIDE SHOP DRAWINGS AND ENGINEERING CALCULATIONS, GUARDRAILS SHALL NOT HAVE POSTS, SHALL BE ST. STEEL "U" CHANNEL TYPE INSTALLATION OR SIDE WALL
- WITH STAINLESS STEEL BUTTONS TYPE INSTALLATION UNDER SEPARATE PERMIT 10. 3/4" RECESS AT ALL SLABS SUPPORTING EXTERIOR WALLS (TYP.)
- 11. FOR FOUNDATION (SEE STRUCT. DWGS.)
- 12. COMPACTED FILL TO 95% COMPACTION WITH PROCTOR TEST.
- 13. EPS BOARD INSULATION UNDER CONCRETE SLAB. (R-5) CRAWLSPACE 14. ALUMN. TRELLIS. PROVIDE SHOP DRAWINGS.
- NOTES:

 ALL PLANTERS SHALL RECEIVE WATERPROOFING COATING, SEE STANDARD DETAIL.

 CEILING HEIGHTS INDICATED IN SECTIONS ARE FOR BIDDING PURPOSES ONLY.

 THE ACTUAL HEIGHT MAY VARY DEPENDING ON ALL SYSTEMS INSTALLED. THE
- THE ACTUAL HEIGHT MAY VARY DEPENDING ON ALL SYSTEMS INSTALLED. THE MEP INSTALLATION SHOULD BE PERFORMED PRIOR TO THE CEILING SYSTEM INSTALLATION. PIPING AND DUCTS SHALL BE INSTALLED AS HIGH AS PRACTICALLY POSSIBLE.



DraxIS. architecture.design



Jose L
Sanchez
DN: cn=Jose L Sanchez, c=US
O=Praxis Architecture, Inc.,
email=isanchez@praxisarch.cc
ate: 2022.09.02 17:40:43 04'00'

COPYRIGHT © 2022. ALL RIGHTS RESERVED.

THESE DRAWINGS AND DOCUMENTS ARE INSTRUMENTS OF SERVICE AND SHALL REMAIN THE PROPERTY OF PRAYS ARCHITECTURE + DESIGN, WHETHER THE PROJECT FOR WHICH THEY WERE PREPARED IS EXECUTED OR NOT. THE ARE NOT TO BE USED IN ANY MANNER ON OTH PROJECTS OR EXTENSIONS TO THIS PROJECT EXCEPT AGREEMENT IN WRITING AND WITH THE APPROPRIA COMPENSATION TO PRAXIS ARCHITECTURE + DESIGNER PRODUCTIONS OF DRAWINGS & SPECIFICATION WITHOUT THE WRITTEN CONSENT OF PRAXIS ARCHITECTURE + DESIGN IS PROHIBITED. CONTRACTORS RESPONSIBLE FOR VERIFYING ALL SITE CONDITIONS PRIOR TO PROCEEDING WITH WORK.

ADDRESS & OWNER

NEW RESIDENCE
1610 BAY DRIVE
IAMI BEACH, FLORIDA. 33141
OWNER:

REVISION & DATE

2 3 4


DRAWING TITLE


SECTIONS

SCALE: AS SHOWN DATE: 09-26-2021

SHEET NUMBER

A-4.1

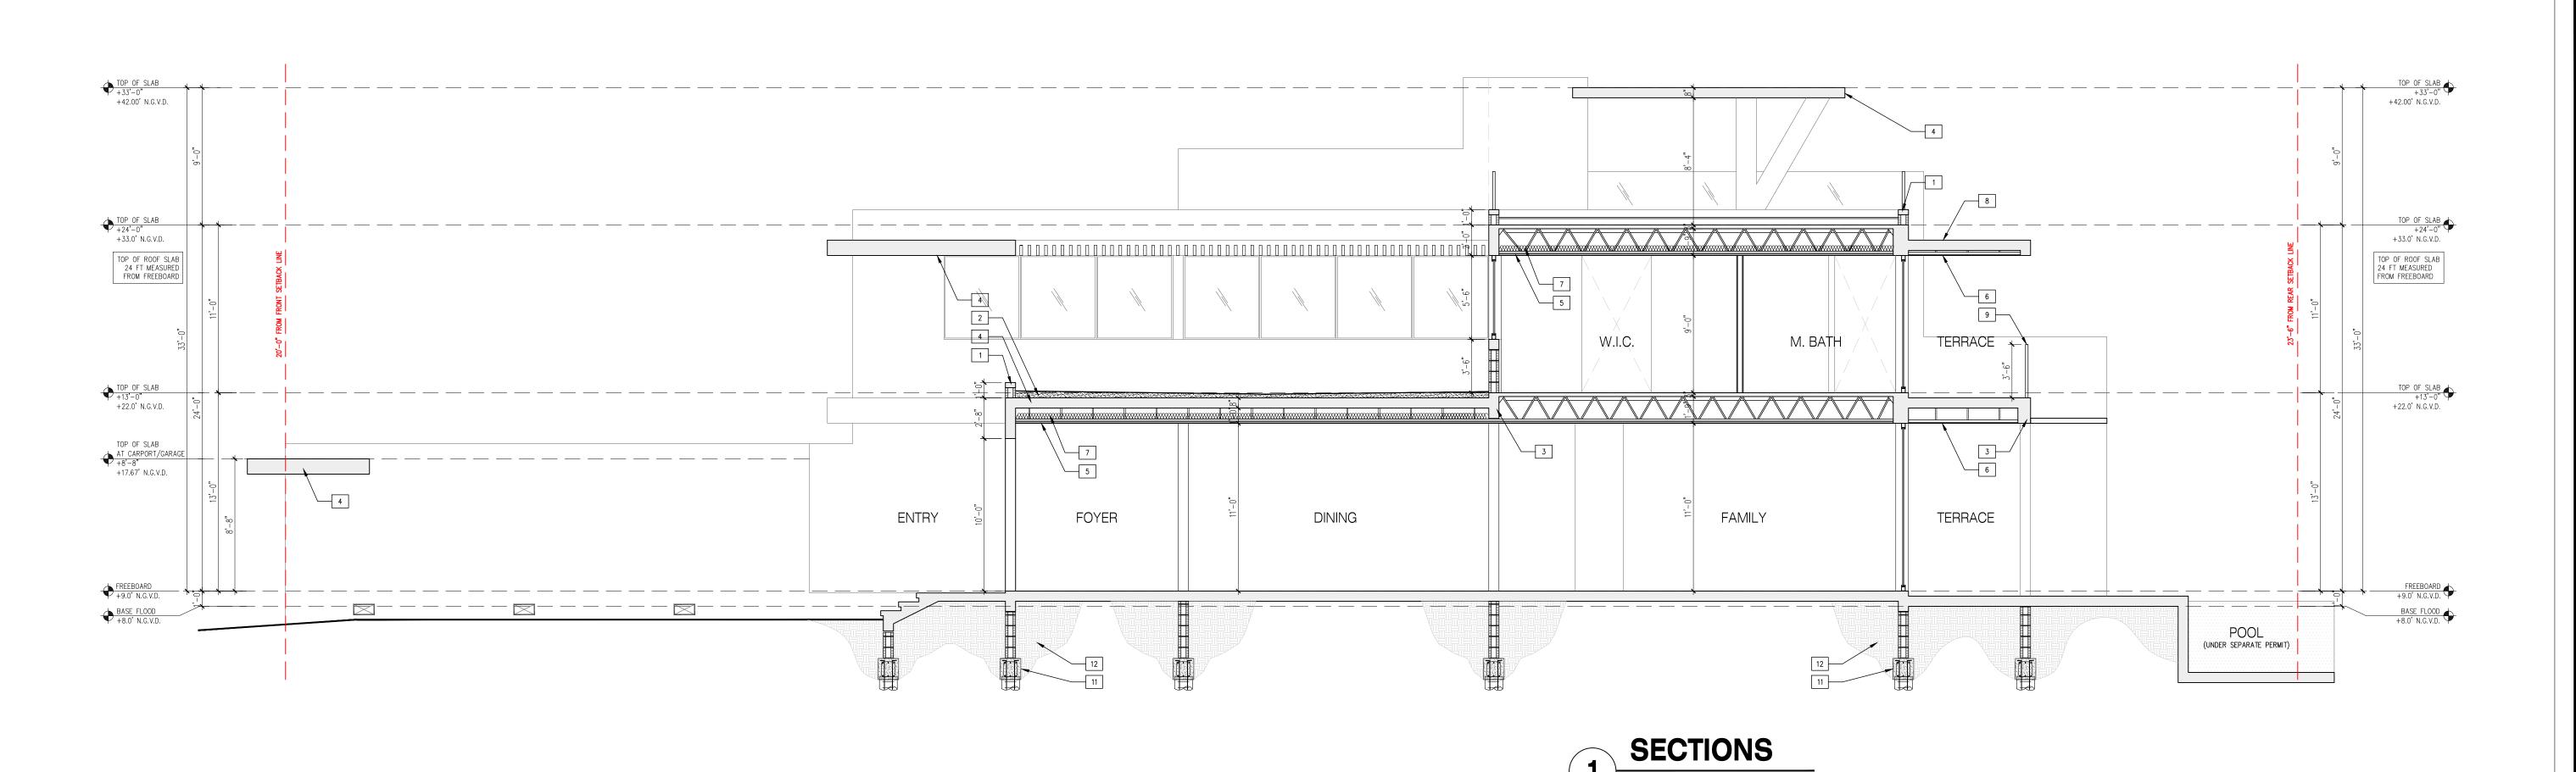

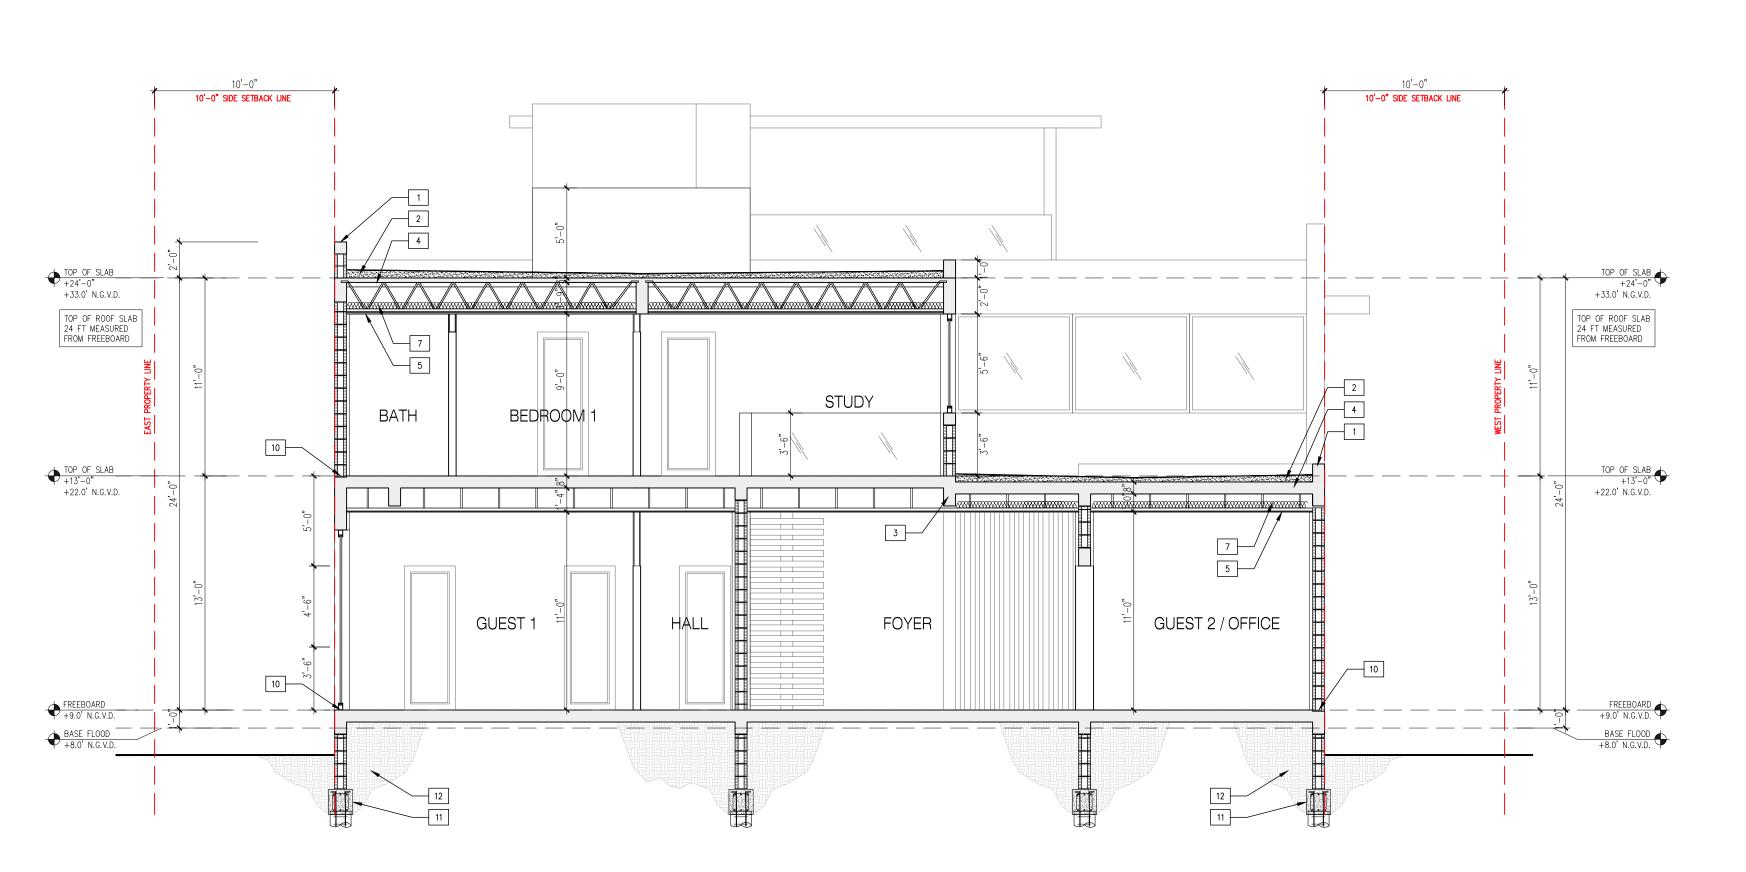

SECTION KEYNOTES

- 1. PARAPET WALL (SEE ROOF PLAN FOR HEIGHT)
- 2. PROVIDE 10 YR WARRANTY ROOFING SYSTEM. ROOFING SYSTEM INSTALLATION SHALL BE PERFORMED PER MANUFACTURER'S RECOMMENDATIONS AND PER NATIONAL ROOFING CONTRACTORS ASSOCIATION STANDARD DETAILS.
- 3. CONCRETE BEAM (SEE STRUCT. DWGS. FOR REINF.)
- 4. CONCRETE SLAB (SEE STRUCT. DWGS. FOR REINF.)
- 5. SUSPENDED 5/8" GYPSUM CEILING ON METAL STUD FRAMING. INSTALL AFTER DUCTWORK AND PLUMBING IS IN PLACE.
- 6. SMOOTH STUCCO CEILING ON METAL STUD SUBSTRATE. (EXTERIOR CEILING)
- 7. R-30 BATT INSULATION OVER GYPSUM CEILING.
- 8. SEALOFLEX WATERPROOFING, TYP. AT ALL CANOPIES AND DRIP EDGE.
- 9. GLASS GUARDRAIL/HANDRAILS (42" OR 36" HIGH A.F.F.) PROVIDE SHOP DRAWINGS AND ENGINEERING CALCULATIONS, GUARDRAILS SHALL NOT HAVE POSTS, SHALL BE ST. STEEL "U" CHANNEL TYPE INSTALLATION OR SIDE WALL WITH STAINLESS STEEL BUTTONS TYPE INSTALLATION - UNDER SEPARATE PERMIT
- 10. 3/4" RECESS AT ALL SLABS SUPPORTING EXTERIOR WALLS (TYP.)
- 11. FOR FOUNDATION (SEE STRUCT. DWGS.)
- 12. COMPACTED FILL TO 95% COMPACTION WITH PROCTOR TEST.
- 13. EPS BOARD INSULATION UNDER CONCRETE SLAB. (R-5) CRAWLSPACE 14. ALUMN. TRELLIS. PROVIDE SHOP DRAWINGS.

 ALL PLANTERS SHALL RECEIVE WATERPROOFING COATING. SEE STANDARD DETAIL. CEILING HEIGHTS INDICATED IN SECTIONS ARE FOR BIDDING PURPOSES ONLY. THE ACTUAL HEIGHT MAY VARY DEPENDING ON ALL SYSTEMS INSTALLED. THE MEP INSTALLATION SHOULD BE PERFORMED PRIOR TO THE CEILING SYSTEM INSTALLATION. PIPING AND DUCTS SHALL BE INSTALLED AS HIGH AS PRACTICALLY POSSIBLE.



Jose L Sanchez DN: cn=Jose L Sanchez, c=US Osenchez DN: cn=Jose L Sanchez, c=US Osenchez, c=US Osenchez DN: cn=Jose L Sanchez, c=US Osenchez DN: cn=Jose L Sanchez, c=US Osenchez, c=US Osench

ADDRESS & OWNER

ENCE 1610 BAY DRIVE I BEACH, FLORIDA. OWNER: RESID NEW


REVISION & DATE						
1						
2						
3						

DRAWING TITLE

SECTIONS

SCALE: AS SHOWN DATE: 09-26-2021

SHEET NUMBER

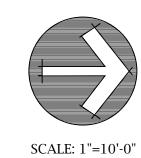

Tree Disposition								
No	Botanical Name	Common Name	DBH (in)	Height (ft)	Spread (ft)			
1	Schinus terebinthifolia	Florida Holly	8	14	10			
2	Livistona chinensis	Chinese Fan Palm	~10	12	10			
3	Schefflera actinophylla	Umbrella Tree	~16	35	30			
4	Sabal palmetto	Sabal Palm	~12	20	10			

LANDSCAPE ARCHITECTURE

DIEGO J. VANDERBIEST

305-528-4001 DIEGOJV@GMAIL.COM

Diego Vanderbiest

Digitally signed by Diego Vanderbiest Date: 2022.09.06 10:29:56 -04'00'

> NEW RESIDENCE 1610 BAY DRIVE MIAMI BEACH, FLORIDA

REVISIONS
7/08/22 SITE PLAN
8/14/22 CLIENT COMMENTS
9/1/22 CLIENT COMMENTS

DRAWN BY

DV
DATE
4/18/2022


SCALE

1''=10'-0''

DRAWING TITLE


TREE SURVEY PLAN

SHEET 1

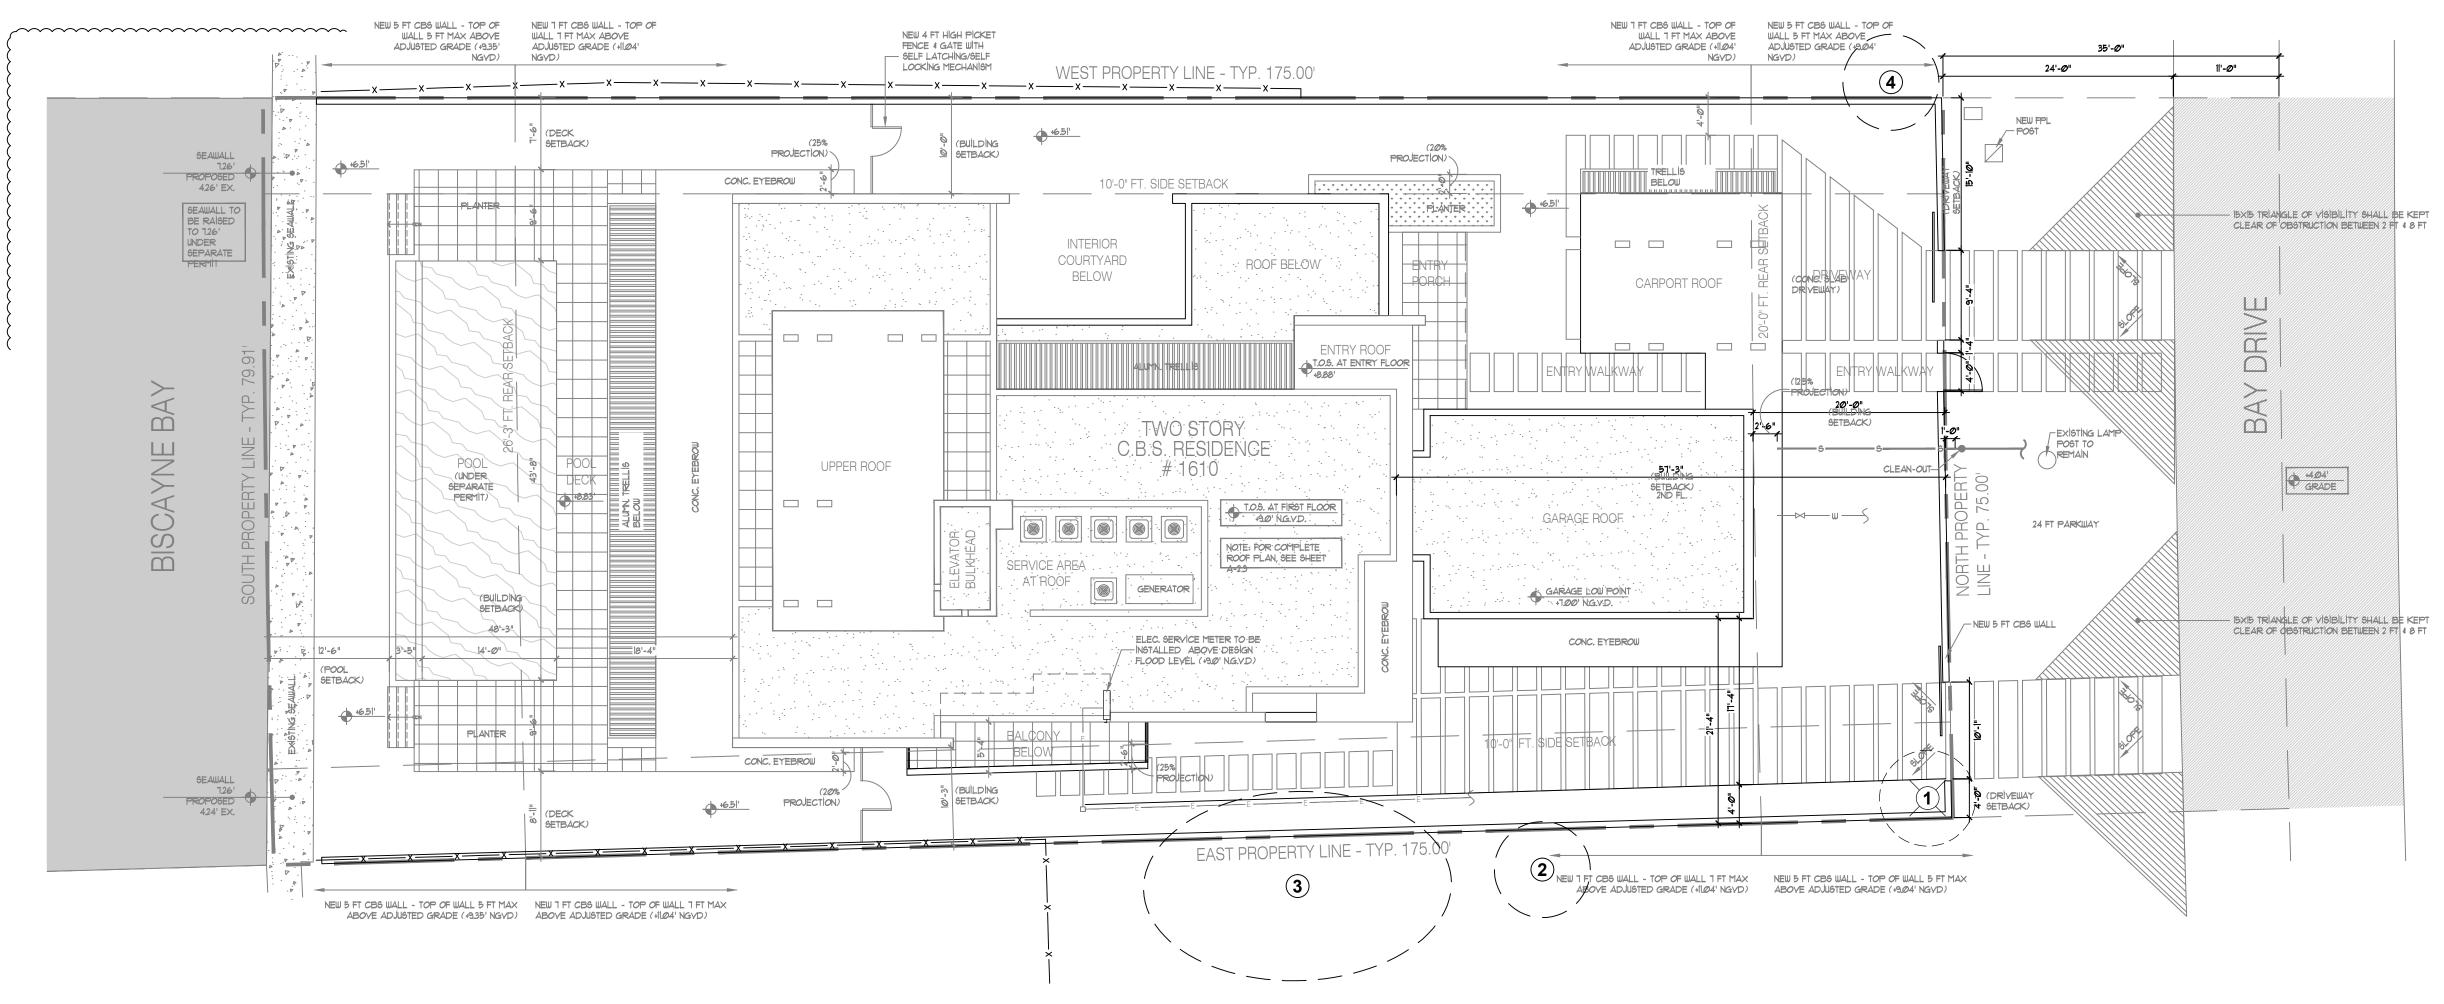



No	Botanical Name	Common Name	DBH (in)	Height (ft)	Spread (ft)	Disposition	Remarks
1	Schinus terebinthifolia	Florida Holly	8	14	10	Remove	Invasive
2	Livistona chinensis	Chinese Fan Palm	~10	12	10	Remain	Neighbor's tree
3	Schefflera actinophylla	Umbrella Tree	~16	35	30	Remain	Neighbor's tree
4	Sabal palmetto	Sabal Palm	~12	20	10	Remain	Neighbor's tree

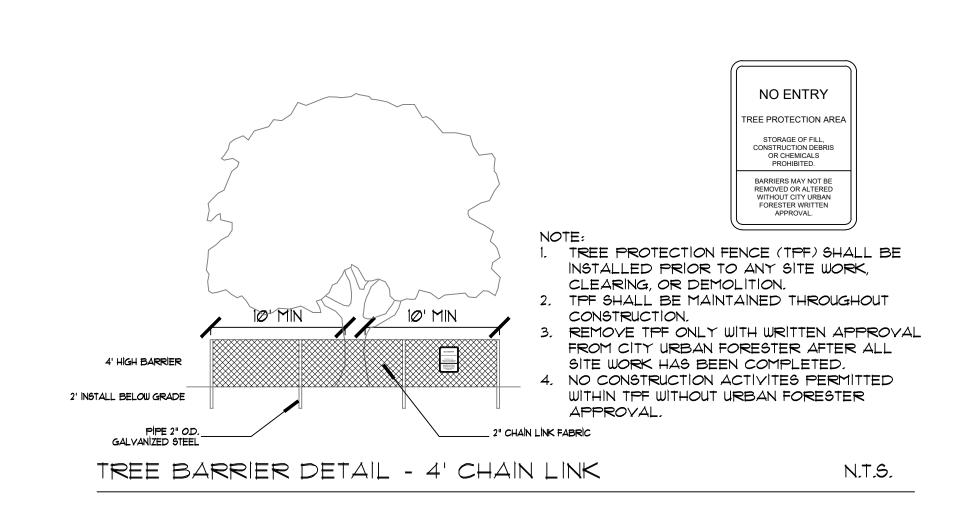

LANDSCAPE ARCHITECTURE

DIEGO J. VANDERBIEST
305-528-4001 DIEGOJV@GMAIL.COM

Diego Vanderbiest

Digitally signed by Diego Vanderbiest Date: 2022.09.06 10:30:11 -04'00'

> NEW RESIDENCE 1610 BAY DRIVE

REVISIONS

7/08/22 SITE PLAN

8/14/22 CLIENT COMMENTS

9/1/22 CLIENT COMMENTS

DRAWN BY
DV
DATE
4/18/2022
SCALE


1"=10'-0"


DRAWING TITLE


TREE DISPOSITION

PLAN

SHEET

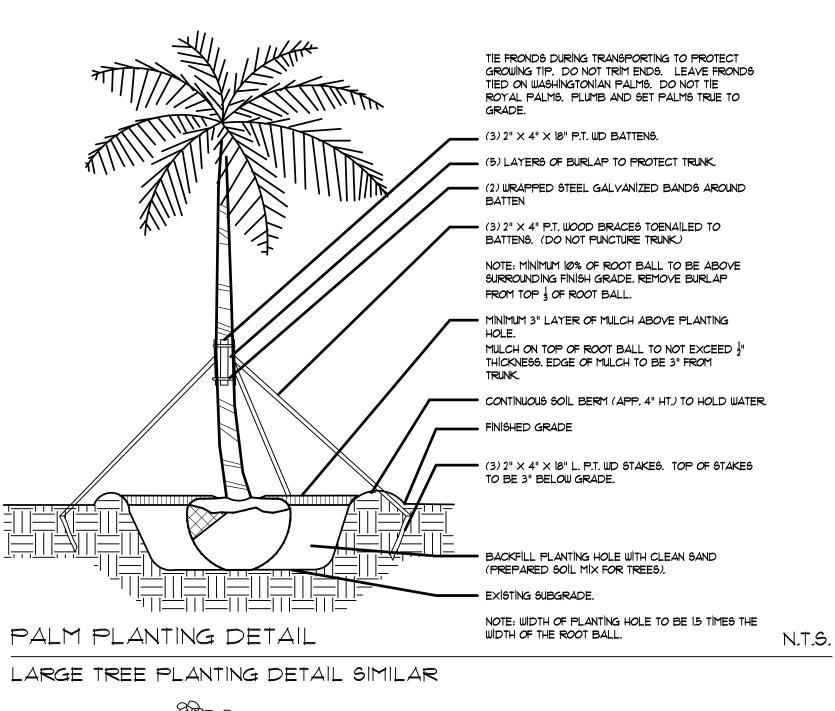

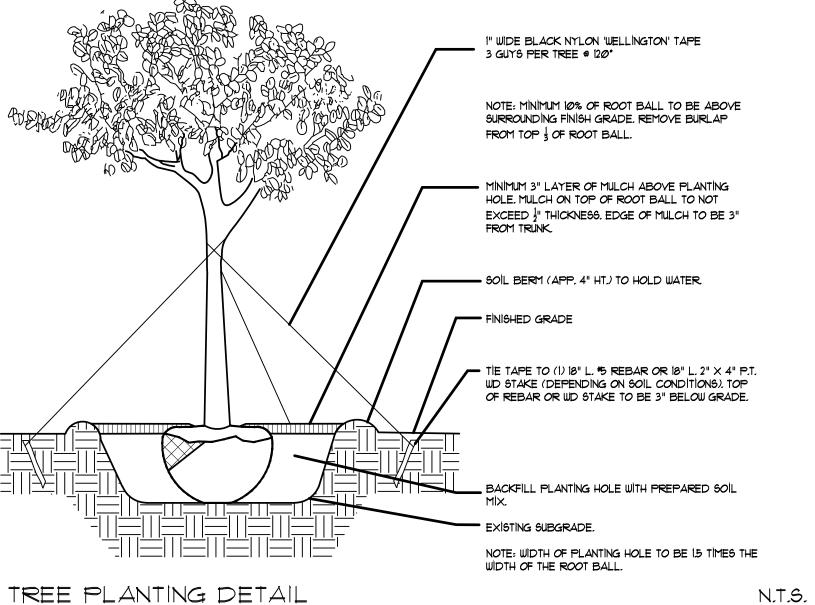

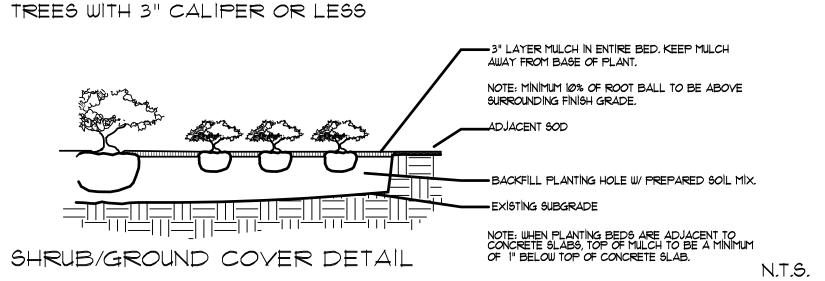

PLANT NOTES

- 1. ALL PLANT MATERIAL TO BE FLORIDA NO. 1 OR BETTER FLORIDA DEPARTMENT OF AGRICULTURE GRADES AND STANDARDS: PARTS AND 11, 2ND EDITION: FEBRUARY 1998, RESPECTIVELY.
- 2. ALL PLANTING BEDS TO BE TOPPED WITH 3" MULCH EXCLUDING TOP OF ROOT BALL (SEE PALM/ TREE PLANTING DETAIL).
- 3. ALLTrees TO BE STAKED IN A GOOD WORKMANLIKE MANNER, NO NAIL STAKING IN TRUNKS PERMITTED.
- 4. LANDSCAPE PLAN SHALL BE INSTALLED IN COMPLIANCE WITH ALL LOCAL CODES.
- 5. ALL SOD SHALL BE ZOYSIA JAPONICA SOLID SOD, (UNLESS OTHERWISE NOTED) AND LAID WITH ALTERNATING AND ABUTTING JOINTS.
- 6. ALL PLANTING BEDS TO BE WEED AND GRASS FREE.

- 1. LANDSCAPE CONTRACTOR SHALL REVIEW ALL DRAWINGS AND PREPARE ONES OWN QUANTITY COUNTS(PRIOR TO BID COST AND COMPARE TO ARCHITECT'S PLANT LIST), LANDSCAPE CONTRACTOR IS RESPONSIBLE FOR ATTAINING ACCURATE COUNT OF PLANT MATERIALS SPECIFIED. IN THE EVENT OF DISCREPANCIES, LANDSCAPE CONTRACTORS SHALL BRING TO THE ATTENTION OF LANDSCAPE ARCHITECT. PLAN SHALL TAKE PRECEDENCE OVER PLANT LIST.
- 8. LANDSCAPE CONTRACTOR SHALL LOCATE AND VERIFY ALL UNDER-GROUND UTILITIES PRIOR TO DIGGING.
- 9. NO CHANGES SHALL BE MADE WITHOUT THE PRIOR CONSENT OF THE LANDSCAPE ARCHITECT.
- 10. ALL PLANTED AREAS TO RECEIVE 100% COVERAGE BY AN AUTOMATIC IRRIGATION SYSTEM, WITH A MINIMUM OF 50% OVERLAP. RAIN SENSOR TO BE PROVIDED.

CITY OF MIAMI BEACH

LANDSCAPE LEGEND

	INFORMATION REQUIRED TO BE PERM			
	Zoning District: RS-R	Lot Area <u>13,543 S.F.</u>	Acres <u>0.310</u>	
			REQUIRED/	
	OPEN SPACE		ALLOWED	PROVIDED
Α.	Square feet of required Open Space as	s indicated on site plan:		
	Lot Area = $\underline{13,543}$ s.f.x $\underline{50}$ % = $\underline{6,771}$ s.	f.	6,771	7,739
В.	Square feet of parking lot open space	required as indicated on site		
	Number of parking spaces x 1	0 s.f. parking space =	N/A	N/A
C.	Total square feet of landscaped open	space required: A+B=	6,771	7,739
	LAWN AREA CALCULATION			
Α.		required	6,771	7739
В.	Maximum lawn area (sod) permitted=	<u>50</u> % x <u>7739</u> s.f.	3,870	1,595
B. C. D.	Number of trees required per lot or not of trees meeting minimum requirement trees x net lot acrows Natives required: Number of trees possible Mumber of trees provided x 50%= Street Trees (maximum average spacing linear feet along street trees species allowed directly be (maximum average spacing of 20' o.c. 75 linear feet along street divided by 25 linear fee	ents= es - number of existing trees= provided x 30% = tolerant required: ng of 20' o.c.) divided by 20'= eneath power lines:):		13 10 10 N/A 4
	SHRUBS			
A.	Number of shrubs required: Sum of lo	t and street trees required x 1	12=156	302
В.	% Native shrubs required: Number of	shrubs provided x 50%=	151	166
Α.	LARGE SHRUBS OR SMALL TREES Number of large shrubs or small trees shrubs x 10%=	required: Number of require	d 16	21

B. % Native large shrubs or small trees required: Number of large shrubs

or small trees provided x 50%=



Diego Vanderbiest

Digitally signed by Diego Vanderbiest Date: 2022.09.06 10:30:26 -04'00'

NEV 161

REVISIONS 7/08/22 SITE PLAN 9/1/22 CLIENT COMMENTS

> DRAWN BY DV

4/18/2022 SCALE

1''=10'-0'' DRAWING TITLE

LANDSCAPE PLAN

SHEET

_20