# FINAL SUBMITTAL 06.21.22 DRB #22-0825 NEW APARTMENT BUILDING AT: 1311 15TH TERRACE MIAMI BEACH, FLORIDA 33139



# PROJECT TEAM

Architect	Landscaping Architect			
ANTHONY LEON #0016752 3 DESIGN, INC. 3260 NW 7th St. MIAMI, FLORIDA 33125	PATRICK K. HODGES #0000850 C. RIGHT STUDIOS 1810 E. TERRA MAR DRIVE. POMPANO BEACH, FL. 33062			
Off: 305.438.9377	Off: 954.591.6864			
Fax: 305.438.9379	E-mail: corey@crightstudios.com			
E-mail: 3dtony@3designonline.com				

#### **GENERAL NOTES**

- 1. THESE DOCUMENTS, AS INSTRUMENTS OF SERVICE, ARE THE PROPERTY OF 3DESIGN, Inc. AND MAY NOT BE USED
- OR REPRODUCED IN ANY MANNER WITHOUT EXPRESSED WRITTEN CONSENT

  1. IT IS NOT THE INTENT OF THESE PLANS TO SHOW EVERY MINOR DETAIL OF
  CONSTRUCTION. THE GENERAL CONTRACTOR IS EXPECTED TO FURNISH
  AND INSTALL ALL ITEMS REQUIRED TO COMPLETE ALL BUILDING SYSTEMS
  AND PROVIDE ALL NECESSARY APPURTENANCES FOR EQUIPMENT TO BE
  PLACED IN PROPER WORKING ORDER WITH QUALITY CRAFTMANSHIP WITHOUT
- INCREASING THE CONTRACT SUM OR CONTRACT COMPLETION DATE.

  3. ALL WORK DESCRIBED BY THSE DOCUMENTS MUST BE PERFORMED BY CONSTRUCTION PROFESSIONALS LICENCED & INSURED IN THE STATE OF FLORIDA (F.B.C. REQUIRED). ALL WORK SHALL BE PERFORMED IN ACCORDANCE W/ THE NATIONAL ELECTRIC CODE AND F.B.C.
- 4. THE GENERAL CONTRACTOR SHALL VERIFY ALL CONDITIONS AND DIMENSIONS AT THE JOB SITE PRIOR TO COMMENCING THE WORK. IF THERE ANY DISCREPANCIES BETWEEN THESE DRAWINGS AND FIELD CONDITIONS, THE CONTRACTOR SHALL NOTIFY THE ARCHITECT PRIOR TO COMMENCING THE WORK FOR CLEAR INSTRUCTION.
- DO NOT SCALE THE DRAWINGS. REFER TO FIGURED DIMENSIONS.
   THE CONTRACTOR IS TO ACQUIRE ALL REQUIRED PERMITS FOR THE DEMOLITION, CONSTRUCTION, FINISHING, AND OCCUPANCY OF THE PROJECT ALL WORK SHALL BE PERFORMED IN ACCORDANCE WITH THE F.B.C.,

7. ALL WORK DONE UNDER THE SUPERVISION OF THE GENERAL CONTRACTOR

- SHALL BE IN A NEAT AND WORKMAN-LIKE MANNER IN ACCORDANCE WITH FEDERAL, STATE, AND LOCAL GOVERNING AGENCIES HAVING JURISDICTION.

  8. THE GENERAL CONTRACTOR IS TO PROVIDE, LOCATE AND BUILD INTO THE WORK ALL SUPPLEMENTARY MATERIALS (INSERTS, ANCHORS, ANGLES, PLATES, OPENINGS, SLEEVES, HANGERS, SLAB DEPRESSIONS, PITCHES, ETC.) AS REQUIRED TO PROPERLY INSTALL, SUPPORT, BRACE, AND SHORE ALL
- BUILDING COMPONENTS WITHIN THE SCOPE OF THE PROJECT.

  9. THE GENERAL CONTRACTOR SHALL REPAIR ALL DAMAGES TO THE EXISTING BUILDING DURING CONSTRUCTION RESULTING FROM SUCH LACK OF CARE AND DUE DILIGENCE AND MAY NOT CLAIM MONETARY DAMAGES OR TIME DELAYS AGAINST THE CONTRACT SUM OR CONTRACT
- 10. THE GENERAL CONTRACTOR SHALL COORDINATE AND SCHEDULE THE WORK OF ALL TRADES TO INSURE THAT THE PROJECT IS COMPLETED BY THE CONTRACT COMPLETION DATE.
- 11. PRIOR TO COMMENCING WORK, THE GENERAL CONTRACTOR SHALL SITE VERIFY THE LOCATION OF ALL EQUIPMENT TO BE REMOVED/RELOCATED. REMOVALS SHALL BE COORDINATED WITH THE OWNER. IF SO DIRECTED, THE G.C. MAY INCLUDE ANY ADDITIONAL COSTS TO THE RID.
- 12. THE GENERAL CONTRACTOR SHALL PROVIDE AN ONSITE DUMPSTER IN A LOCATION COORDINATED WITH THE OWNER FOR THE DISPOSAL OF REMOVED MATERIAL/CONSTRUCTION DEBRIS. THE DUMPSTER SHALL BE EMPTIED AT APPROPRIATE INTERVALS TO PREVENT OVERFLOW AND UNSIGHTLY CONDITIONS.
- 13. IT IS THE INTENT OF 3DESIGN, Inc. THAT
  THIS WORK BE IN CONFORMANCE WITH ALL REQUIREMENTS OF THE
  BUILDING AUTHORITIES HAVING JURISDICTION OVER THIS TYPE OF
  CONSTRUCTION AND OCCUPANCY. THE G.C. SHALL NOTIFY THE
  ARCHITECT/ENGINEERS OF RECORD IMMEDIATELY IF
  ANY DISCREPANCIES ARE ENCOUNTERED BETWEEN THE DRAWINGS AND
  THESE REQUIREMENTS. ANY DISCREPANCIES WILL BE RESOLVED BY
  ARCHITECT / ENGINEER OF RECORD PRIOR
  TO PROCEEDING WITH THE WORK.
- THE GENERAL CONTRACTOR SHALL PROVIDE THE ARCHITECT WITH RED-LINE AS-BUILT DRAWINGS FOR ALL FIELD
- CHANGES/ADDITIONS TO THE WORK INCLUDED IN THE WORK.

  15. THE GENERAL CONTRACTOR SHALL PROVIDE AN ITEMIZED COST BREAKDOWN OF ALL ITEMS AND PHASES OF CONSTRUCTION AT THE TIME
- 16. 3DESIGN, Inc. IS NOT RESPONSIBLE FOR
  CONSTRUCTION MEANS, METHODS, SEQUENCES, PROCEDURES, PRECAUTIONS,
  OR PROGRAMS RELATED TO THIS PROJECT'S CONSTRUCTION.
  17. ALL WORK IS TO BE PLUM, LINE, SQUARE, AND ADEQUATELY SUPPORTED.
  FILL ALL VOIDS BETWEEN COMPONENTS. ALL ITEMS THAT DO NOT MEET
  3DESIGN, Inc. SATISFACTION AS TO GOOD
  TRADE PRACTICES AND QUALITY CRAFTMANSHIP WILL BE REDONE AT
- THE G.C.'S EXPENSE.

  18. THE GENERAL CONTRACTOR IS TO MAINTAIN A SAFE SITE, CLEAR O
- DEBRIS AT ALL TIMES.

  19. THE GENERAL CONTRACTOR AND ALL SUBCONTRACTORS ARE TO GUARANTEE THEIR WORK FOR A MINIMUM PERIOD OF ONE YEAR IN
- WRITING SUBMITTED WITH THE BID.

  20. ALL DETAILS AND SECTIONS SHOWN ON THESE DRAWINGS ARE INTENDED TO BE TYPICAL AND SHALL BE CONSTRUTED TO APPLY TO ANY SIMILAR SITUATION ELSEWHERE IN THE WORK EXCEPT WHERE A DIFFERENT DETAIL IS SHOWN. IT IS THE G.C.'S RESPONSIBILITY TO FORSEE ADDITIONAL CONDITIONS PRIOR TO COMMENCING THE WORK AND NOTIFY THE ARCHITECT
- IMMEDIATELY.

  21. ALL ASSEMBLIES REFERRED TO AS FIRE-RATED SHALL BE A MINIMUM
  OF ONE HOUR UNLESS OTHERWISE INDICATED. ALL PENETRATIONS THROUGH
  ANY RATED ASSEMBLY SHALL BE PROVIDED W/ APPROVED PENETRATION
- RATED DEVICES.

  22. THE GENERAL CONTRACTOR SHALL PROVIDE CUSTOM AND MULTI-COLOR PAINT SELECTIONS FOR OWNER'S APPROVAL.
- 23. ALL HARDWARE, LIGHTING & BATHROOM FIXTURES AND MISC. SPECIFICATIONS NOT SPECIFICALLY CALLED OUT ON THE DRAWINGS SHALL BE PROVIDED BY THE OWNER.
- 24. THE GENERAL CONTRACTOR SHALL PROVIDE SHOP DRAWINGS FOR TRUSSES, STORM SHUTTERS, REINFORCING STEEL, WINDOWS, DOORS, CAST CONCRETE, ORNAMENTAL IRON, STEEL CONNECTORS, ORNAMENTAL WOOD, ETC. TO THE ARCHITECT FOR REVIEW PRIOR TO COMMENCING
- 25. THE GENERAL CONTRACTOR SHALL PROVIDE A TELEPHONE AND TELEPHONE LINE AT THE JOB SITE. THE G.C. IS RESPONSIBLE FOR IT'S USE.

# FOLIO NUMBER

02-3233-016-0050

#### LEGAL DESCRIPTION

ALTON BEACH BAY FRONT RE-SUB PB 16-1. LOT 8 &  $E_2^1$  LOT 9 BLK 67 A LOT SIZE 75 X 100 OR 17892-3688 1097 4

COC 22840-4139 11 2004 1

BASE FLOOD ELEVATION:..

FLOOR FINISH ELEVATION: ..... +7.08' N.G.V.D.

#### **GOVERNING CODES:**

FLORIDA BUILDING CODE 2020 7th EDITION - BUILDING FLORIDA FIRE PREVENTION CODE 2020 7th EDITION CITY OF MIAMI ZONING CODE MIAMI 21 - LATEST EDITION SCOPE OF WORK:

# DEMOLITION

REMOVE PRE-EXISTING CMU AND STUCCO TWO STORY HOUSE


#### TE WORK

REMOVAL AND REPLACEMENT EXISTING LANDSCAPING AS INDICATED IN THE DRAWINGS.

#### DESIGN VARIANCES & WAIVER

- A VARIANCE TO REDUCE THE MINIMUM REQUIRED PARKING SPACE.
   A VARIANCE TO REDUCE THE MINIMUM REQUIRED BACKUP SPACE
   A WAIVER FOR PERMEABLE PAVERS NOT COUNTING TOWARDS LOT COVERAGE.
- CLASSIFICATION OF WORK:
  NEW 5-STORY MULTI-FAMILY BUILDING

### — SUBJECT PROPERTY

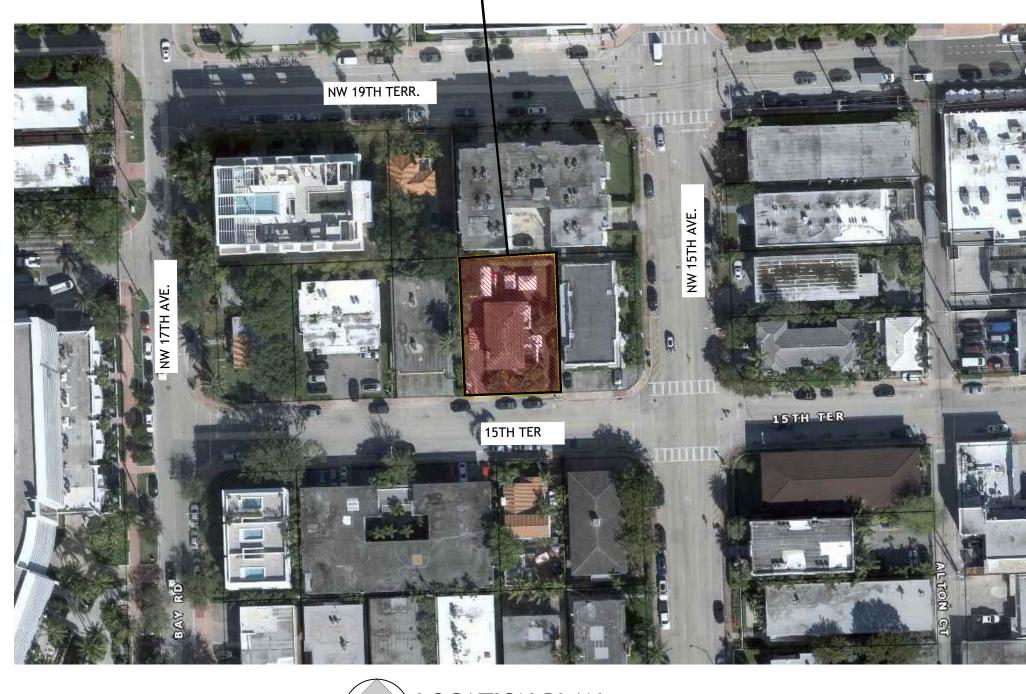



# INDEX OF DRAWINGS:

# **ARCHITECTURAL**

- A-0.0 COVER SHEET & INDEX
- A-0.1 REFERENCE SURVEY
- A-0.2 EXISTING BUILDING
- A-0.3 DEMOLITION
- A-0.4 CONTEXT PICTURES
- A-0.5 CONTEXT PICTURES
- A-1.0 DATA & SITE PLAN
- A-1.1 LOT COVERAGE UNIT SIZE & F.A.R DRAWINGS
- A-2.0 2nd & 3RD FLOOR PLAN PROPOSED
- A-2.1 4th & ROOF|POOL DECK PLAN PROPOSED
- A-3.0 SECTIONS
- A-3.1 SECTIONS
- A-3.2 SECTIONS
- A-4.0 NORTH ELEVATION
- A-4.1 EAST ELEVATION
- A-4.2 SOUTH ELEVATION
- A-4.3 WEST ELEVATION
- A-5.0 VIEWS RENDERS
- A-6.0 MATERIAL PROPOSED


# LANSCAPING

- L-1 TREE DISPOSITION PLAN
- L-2 GROUND MATERIALS PLAN
- L-3 CANOPY PLAN GROUND LEVEL
- L-3A CANOPY PLAN GROUND LEVEL
- L-4 PLANT IMAGE BOARD GROUND LEVEL
- L-5 SITE RENDERING FRONT VIEW EAST
- L-6 REAR VIEW NEAST
- L-7 PLANTING PLAN & IMAGERY ROOF LEVEL
- L-7A PLANTING PLAN LEVEL 2,3,4 & ROOF
- L-8 ROOF LEVEL
- L-9 LIGHTING LEVEL GROUND LEVEL
- L-10 LIGHTING PLAN ROOF LEVEL

DRAWN BY:
REVISIONS:

AAOOO356 ANTHONY LEON 0016752

ARCHITECTURE
3260 NW 7TH ST, Miami, FL 33125

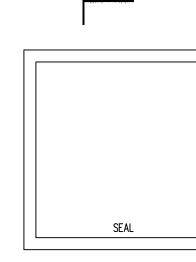


MULTI-FAMILY UNITS 1311 15th TER

THESE PLANS ARE FOR BUILDING
DEPARTMENT REVIEW ONLY. THEY ARE NO
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DOCUMENTS UNTIL ALL BUILDING
DEPARTMENT APPROVALS ARE OBTAINED.


A-0.0

COVER SHEET

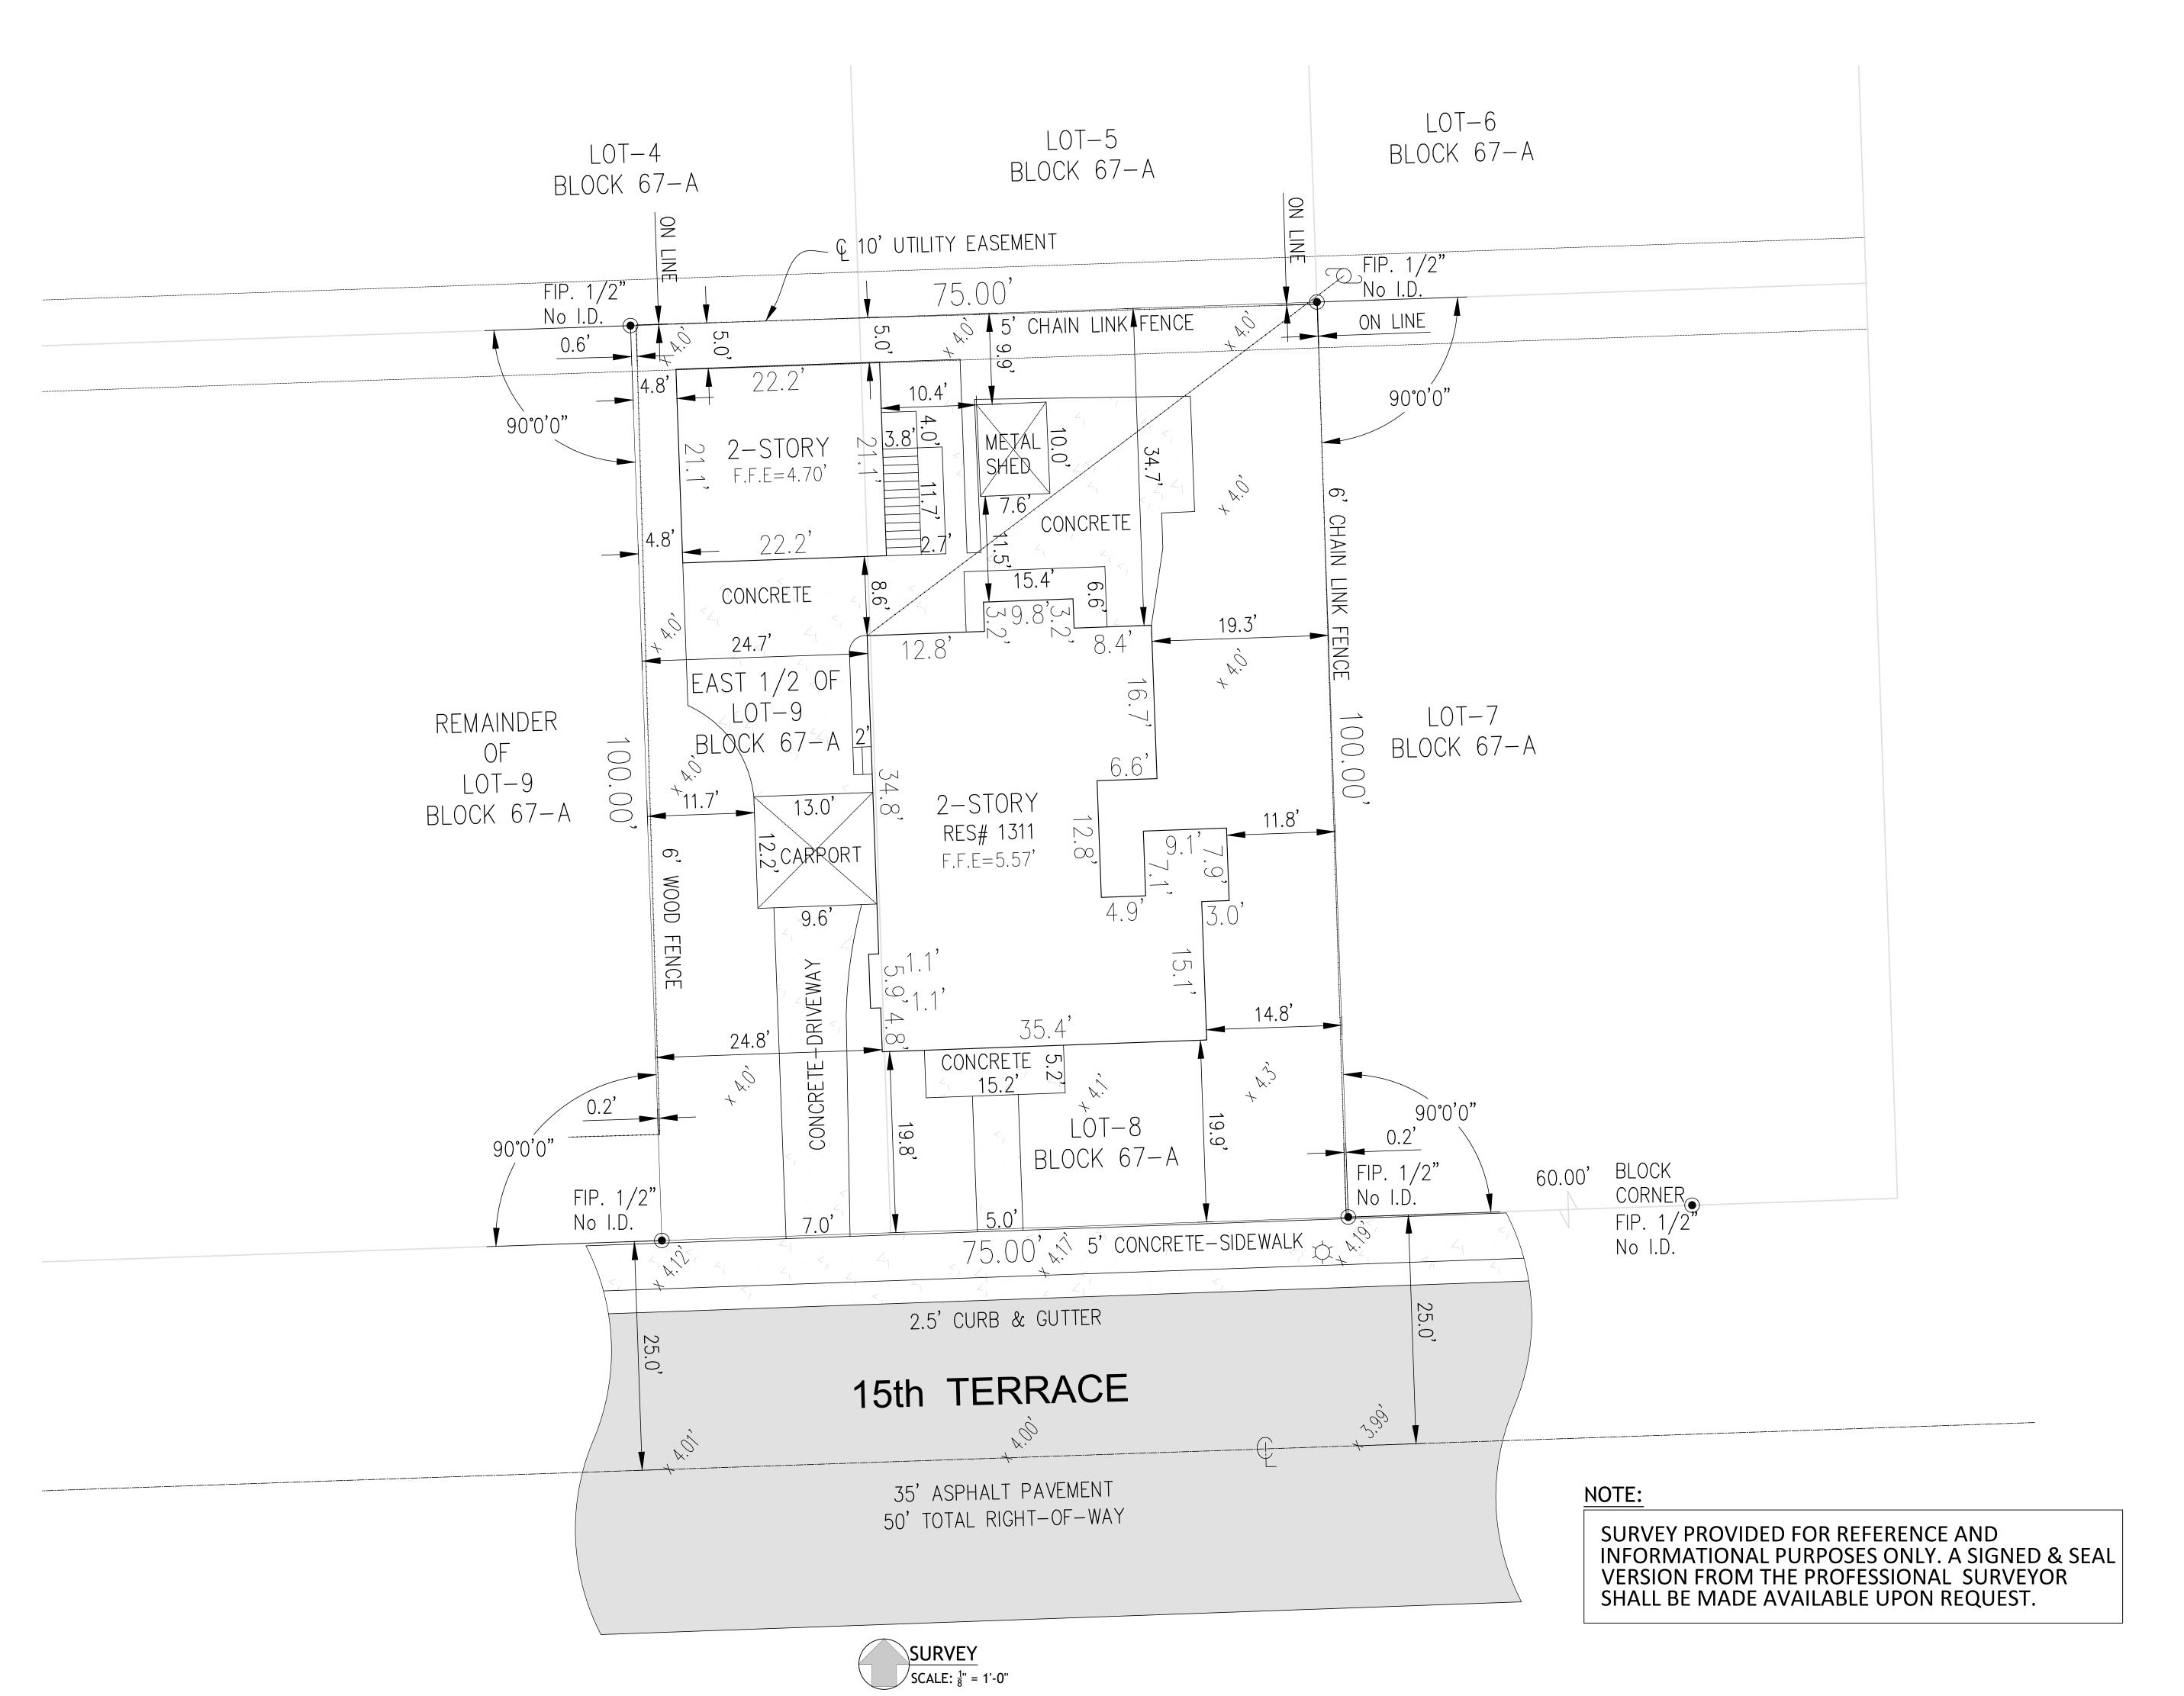





ARCHITECTURE
3260 NW 7TH ST, Miami, FL 33125

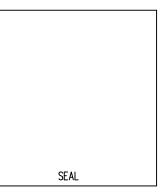

MULTI-FAMILY UNITS
1311 15th TER

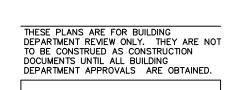



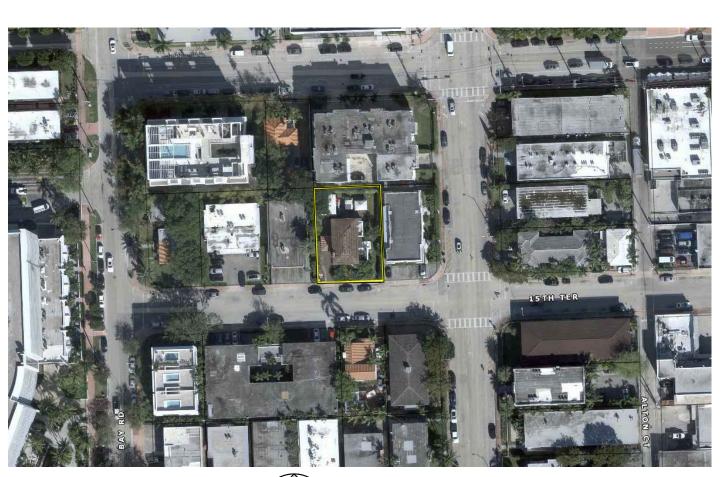





STREET VIEW 15 TER
SCALE N.T.S



STREET VIEW 15 TER
SCALE N.T.S



DRIVEWAY EXISTING
SCALE N.T.S



SCALE N.T.S



BUILDING EXISTING
SCALE N.T.S



BUILDING EXISTING
SCALE N.T.S



BUILDING EXISTING
SCALE N.T.S



REAR YARD EXISTING
SCALE N.T.S




LIVING EXISTING
SCALE N.T.S



LIVING EXISTING
SCALE N.T.S



STUDIO EXISTING
SCALE N.T.S

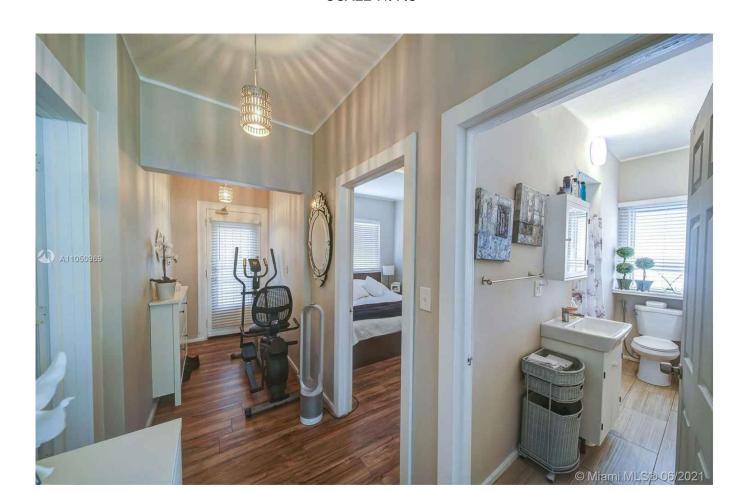


BATHROOM & BEDROOM EXISTING
SCALE N.T.S




SCALE N.T.S



STUDIO EXISTING
SCALE N.T.S

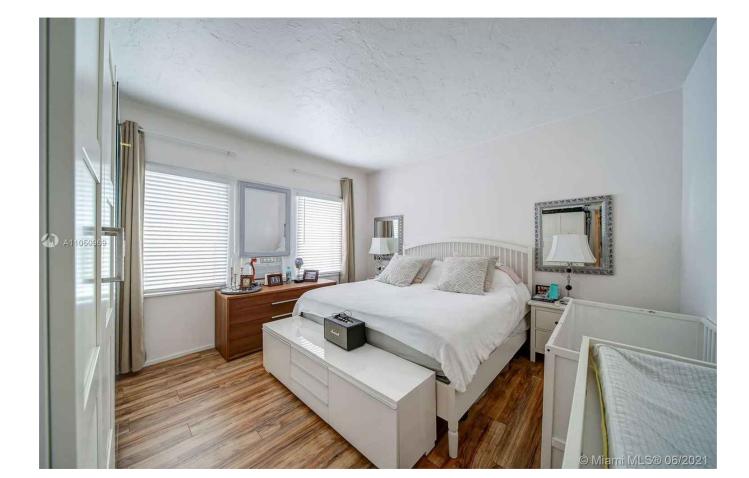

BEDROOM EXISTING
SCALE N.T.S

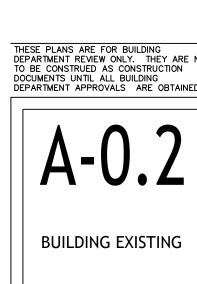

REVISIONS:

DRAWN BY:

**AAOOO3569**ANTHONY LEON
0016752

3260 NW 7TH ST, Miami, FL 33125 P: 305.438.9377 1 F: 305.438.9379

SEAL

MULTI-FAMILY UNITS 1311 15th TER MIAMI BEACH, FL 33139

#### **GENERAL DEMOLITION NOTES:**

- 1) SECURE ANY DEMOLITION PERMITS REQUIRED BY LOCAL AUTHORITIES HAVING JURISDICTION OVER SUCH WORK. NO WORK SHALL COMMENCE PRIOR TO OBTAINING REQUIRED PERMITS. 2) CONTRACTOR TO VERIFY ALL EXISTING CONDITIONS AND DIMENSIONS PRIOR TO BIDDING
- AND AGAIN PRIOR TO COMMENCEMENT OF ANY WORK. REPORT ANY DISCREPANCIES TO ARCHITECT IMMEDIATELY.
- 3) CONTRACTOR TO ARRANGE ON SITE CONSTRUCTION MEETING WITH ARCHITECT PRIOR TO ANY DEMOLITION OR CONSTRUCTION.
- 4) REVIEW DEMOLITION/CONSTRUCTION SEQUENCE WITH ARCHITECT. COORDINATE WORK WITH OWNER TO MINIMIZE DISRUPTION TO OCCUPIED AREAS. PROVIDE TEMPORARY CLOSURES AND/OR DUST BARRIERS AT LIMITS OF CONSTRUCTION AS REQUIRED.
- 5) ALL WORK SHALL COMPLY WITH ANY GOVERNING AND APPLICABLE CODES.
- 6) REVIEW LOCATION OF DUMPSTER WITH OWNER. KEEP AREA CLEAN AND FREE OF DEBRIS.
- REMOVE ALL UNUSABLE DEBRIS DAILY.
- 7) SHORE AREAS OF EXISTING AND NEW CONSTRUCTION AS REQUIRED. 8) VERIFY ALL ITEMS TO BE SALVAGED WITH OWNER. REVIEW SALVAGE OF EXISTING PLUMBING FIXTURES WITH OWNER.
- 9) VERIFY LOCATION OF EXISTING UTILITY LINES PRIOR TO DEMOLITION/ EXCAVATION. COORDINATE WITH OWNER TO MINIMIZE INTERRUPTION OF SERVICE.
- 10) DISCONNECT ANY EXISTING ELECTRICAL, MECHANICAL AND PLUMBING AS REQUIRED. CAP ANY ABANDONED PLUMBING LINES AS REQUIRED.
- 11) EXERCISE EXTREME CARE WHEN WORKING AROUND SUSPECTED ASBESTOS; INCLUDING DUCT COVERINGS, PIPE COVERINGS, TANK COVERINGS, FLOOR TILE AND ACOUSTICAL TILE. REPORT SUCH FINDINGS TO THE ARCHITECT IMMEDIATELY. REMOVAL OF ALL ASBESTOS CONTAINING MATERIALS SHALL BE BY A CONTRACTOR LICENSED FOR THE REMOVAL OF ASBESTOS.
- 12) COORDINATE CONSTRUCTION SITE ACCESS AND HOURS OF WORKING WITH THE OWNER.
- 13) AT DEMOLITION STAGE ELECTRICAL CONTRACTOR WILL BE RESPONSIBLE FOR IDENTIFYING, TAGGING OUT AND LOCKING OUT ALL AFFECTED CIRCUITS PRIOR TO DEMOLITION WORK BEGINNING.
- 14) CONTRACTOR WILL ALSO BE REQUIRED TO REMOVE ALL UNUSED CONDUITS AND CONDUCTORS AND PROPERLY SUPPORT ALL EXISTING CONDUITS AND CONDUCTORS THAT WILL REMAIN PRIOR TO START OF NEW WORK.
- 15.) DUST CONTROL DURING DEMOLITION IS TO BE PROVIDED EITHER THROUGH: A. STRUCTURAL CONTAINMENT, OR
  - B. WET DUST SUPPRESSION


# DEMOLITION - SCOPE OF WORK KEY


- A DEMOLITION ALL EXISTING BUILDING
- (B) DEMOLITION ALL DRIVEWAYS & PAVERS
- RELOCATED EXISTING LANDSCAPING ( SEE LANDSCAPING PLAN)
- REMOVE ALL PERIMETER WOOD AND METAL FENCE

#### **DEMOLITION LEGEND**

DEMOLITION

WALL TO REMAIN

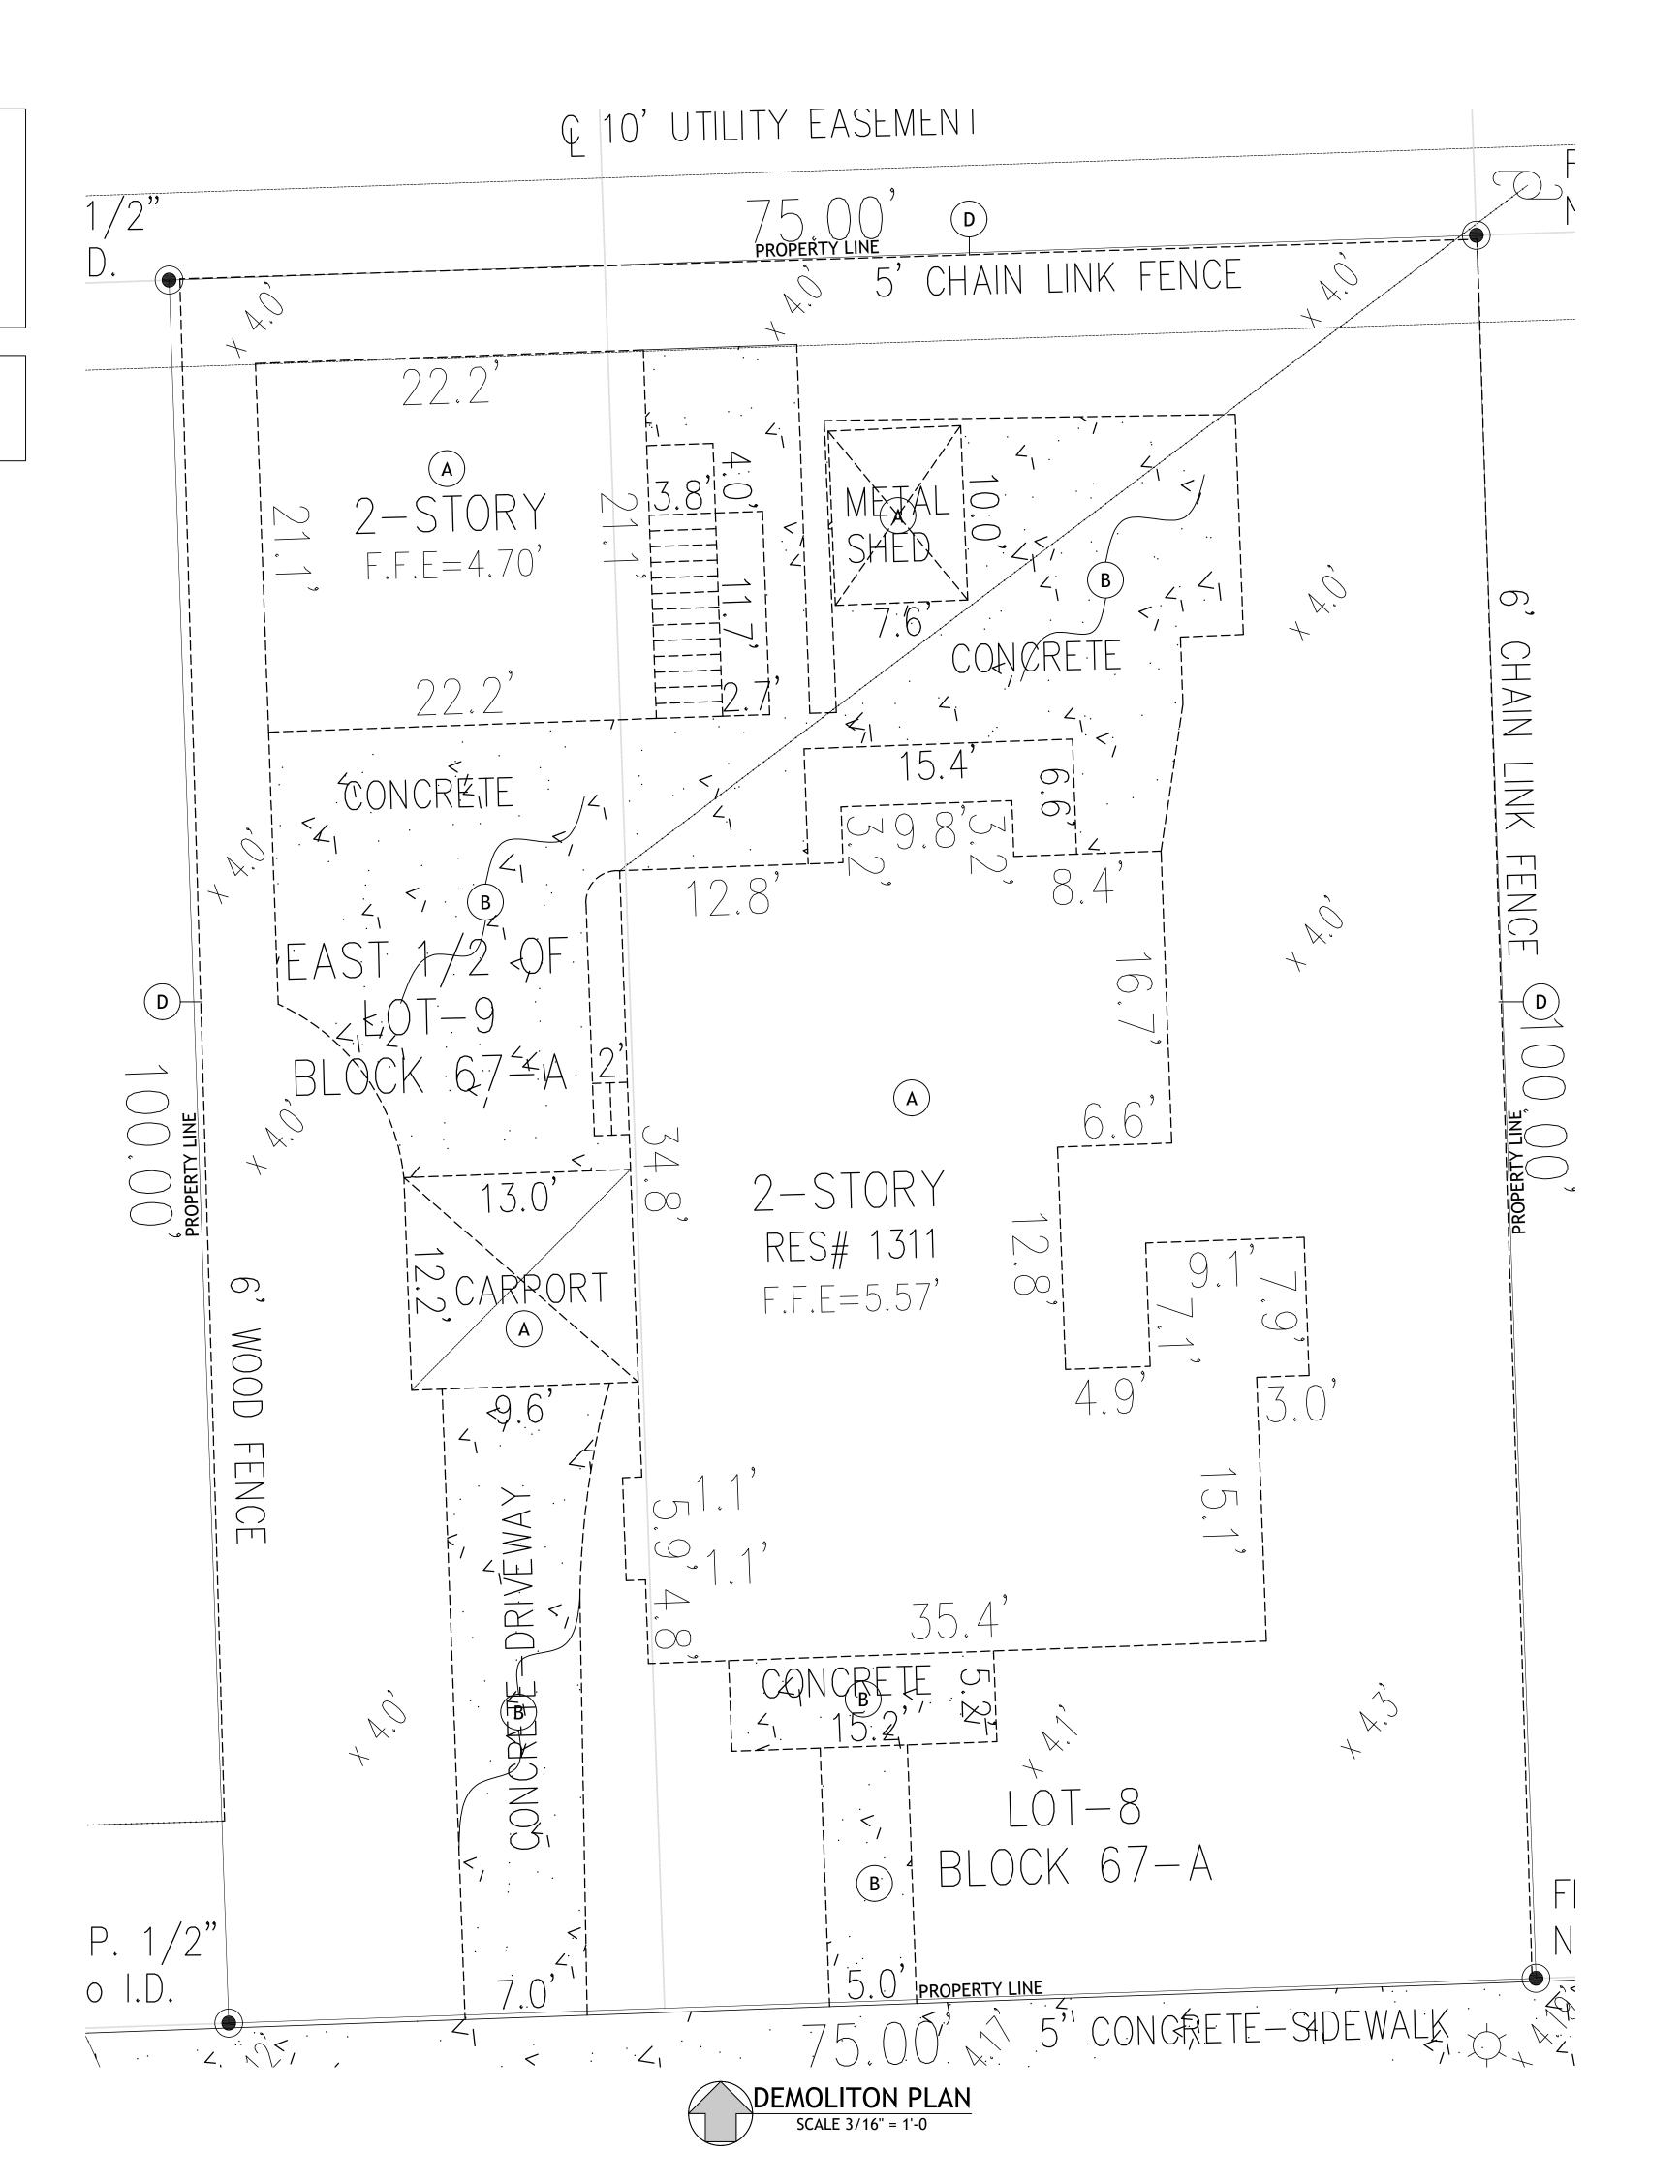

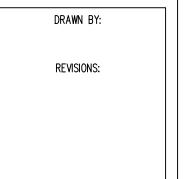



THESE PLANS ARE FOR BUILDING
DEPARTMENT REVIEW ONLY. THEY ARE NOT
TO BE CONSTRUED AS CONSTRUCTION
DOCUMENTS UNTIL ALL BUILDING
DEPARTMENT APPROVALS ARE OBTAINED. A-0.3

DEMOLITION PLAN





1320 15 TER
SCALE N.T.S









1335 15 TER
SCALE N.T.S

1320 TER
SCALE N.T.S







15 BAY RD
SCALE N.T.S






DRAWN BY:



DESCRIPTION OF THE ST, Miami, FL 331

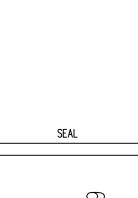

MULTI-FAMILY UNITS 1311 15th TER MIAMI REACH FI 33130

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1335 15 TER
SCALE N.T.S







1577 BAY RD
SCALE N.T.S



1501 BAY RD
SCALE N.T.S

1560 WEST AVE SCALE N.T.S



1445 WEST AVE SCALE N.T.S



1535 WEST AVE SCALE N.T.S

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DRAWN BY:

REVISIONS:

CONTEXT PICTURES





# MIAMI BEACH, FLORIDA 33139, WWW.MIAMIBEACHFL.GOV

305.673.7550

1	PROJECT INFORMATION ADDRESS:	1311 15 TER, MIAMI	BEACH, FL 33139		
2	FOLIO NUMBER:	02-3233-016-0050	BEAGII, I E 00103		
<u>-</u> 3	BOARD AND FILE NUMBER:	02 0200 010 0000			
4	YEAR BUILT:	N/A	ZONING DISTRICT:		RM-1
<u>.</u> 5	BASE FLOOD ELEVATION:	8'	GRADE VALUE IN NGVD:		4.17' NGVD
<u>-</u> ჩ	ADJUSTED GRADE (FLOOD+GRADE/2):	•	FREE BOARD:		1'
<del>5</del> 7	LOT AREA:	7,500 SQ FT	TREE BOTHES.		•
<u>′                                    </u>	LOT WIDTH:	75'	LOT DEPTH:		100'
9	MINIMUM UNIT SIZE:	550 SQ FT	AVERAGE UNIT SIZE:		1300 SQ FT
9 9	EXISTING USE:	30 - MULTI-FAMILY,	PROPOSE USE: 0803 MUL	TIEAMII V 2.0 LINITS · MIII T	·
9	EXISTING USE.	LOW-DENSITY		C 142-152 (3)	II AWILL 3 OK WO
	ZONING INFORMATION/ CALCULATIONS	REQUIRED	EXISTING	PROPOSED	DEFICIENCIES
10	MAX LOT COVERAGE FT 45 %:	3,375 SF (45%)	LAIGTING	3,205.73 <b>S</b> .F. (42.74%)	DEI IOIENOIEO
10 11	HEIGHT	55'	+25-0'	+52.7'	
12	# OF STORIES		2 STORIES	5 STORIES	
13	FAR	(1.25) 9,375 SQ FT	N/A		
		(1.20) 9,373 3Q F1		9,162.33 SQ FT	
14	GROSS SQUARE FOOTAGE	NI/A	3,216 SQ FT	17,897.46 SQ FT	
15	SQUARE FOOTAGE BY USE	N/A	N/A 7		
16	# OF UNITS RESIDENTIAL	LOW DENSITY	1	6	
17	# OF UNITS HOTEL	N/A			
18	# OF SEATS	N/A		D 4	
19	OCCUPANCY LOAD			R-1	
20					
	SETBACKS	REQUIRED	EXISTING	PROPOSED	DEFICIENCIES
	SUBTERRANEAN			21/2	
21	FRONT SETBACK	20 FT		N/A	
22	SIDE SETBACK	10 FT		N/A	
23	SIDE SETBACK	10 FT		N/A	
24	SITE SETBACK FACING STREET	10 FT		N/A	
25	REAR SETBACK	10% = 10%		N/A	
26	AT GRADE PARKING				
27	FRONT SETBACK	20 FT		20.00'	
28	SIDE SETBACK	10 FT		10.00'	
29	SIDE SETBACK	10 FT		10.00'	
30	SITE SETBACK FACING STREET	10 FT or 8%			
31	REAR SETBACK	10%=10 ft		10.00'	
	PEDESTAL				
32	FRONT SETBACK	20 FT		20.00'	
33	SIDE SETBACK	10 FT		10.00'	
34	SIDE SETBACK	10 FT		10.00'	
35	SITE SETBACK FACING STREET	N/A		N/A	
36	REAR SETBACK	10 FT		10.00'	
	TOWER				
37	FRONT SETBACK	20 FT		20'	
38	SIDE SETBACK	25%		14.62'	
	PARKING	REQUIRED	EXISTING	PROPOSED	DEFICIENCIES
39	PARKING DISTRICT	1	1	1	
40	# OF PARKING SPACES:	6	5	5 + ADA	
41	# OF PARKING SPACES PER USE:	N/A	N/A	N/A	
42	(PROVIDE SEPARATE CHART FOR A BREAKDOWN CALCULATION)				
43	# OF PARKING SPACES PER LEVEL:				
	(PROVIDE SEPARATE CHART FOR A BREAKDOWN CALCULATION)	N/A	N/A	N/A	
44	PARKING SPACE DIMENSION:	8'-6" x 18'-0"		8'-6" x 16'-10"	VARIANCE
	PARKING SPACE CONFIG.:	N/A		90°	
45	(45°-60°-90°-PARALLEL)			30	
46	ADA SPACES:	1		1	VARIANCE
47	TANDEM SPACES:	0		0	
48	DRIVE AISLE WIDTH:	0		21'-0" Two way traffic	VARIANCE
49	VALET DROP OFF AND PICK UP	NONE	NONE	NONE	
50	LOADING ZONE AND TRASH			ENCLOSED: 4'-2" x 8'-8"	
51	COLLECTION AREAS				
52	RACKS	0	0	0	

WALL LEGEND (PLAN)


DIMENSION LINES ARE FROM FACE TO FACE


OF METAL STUD WALL AND/OR CMU &/OR


CONCRETE WALL (U.O.N.)

NEW CONCRETE WALL


NEW STUD PARTITION WALL

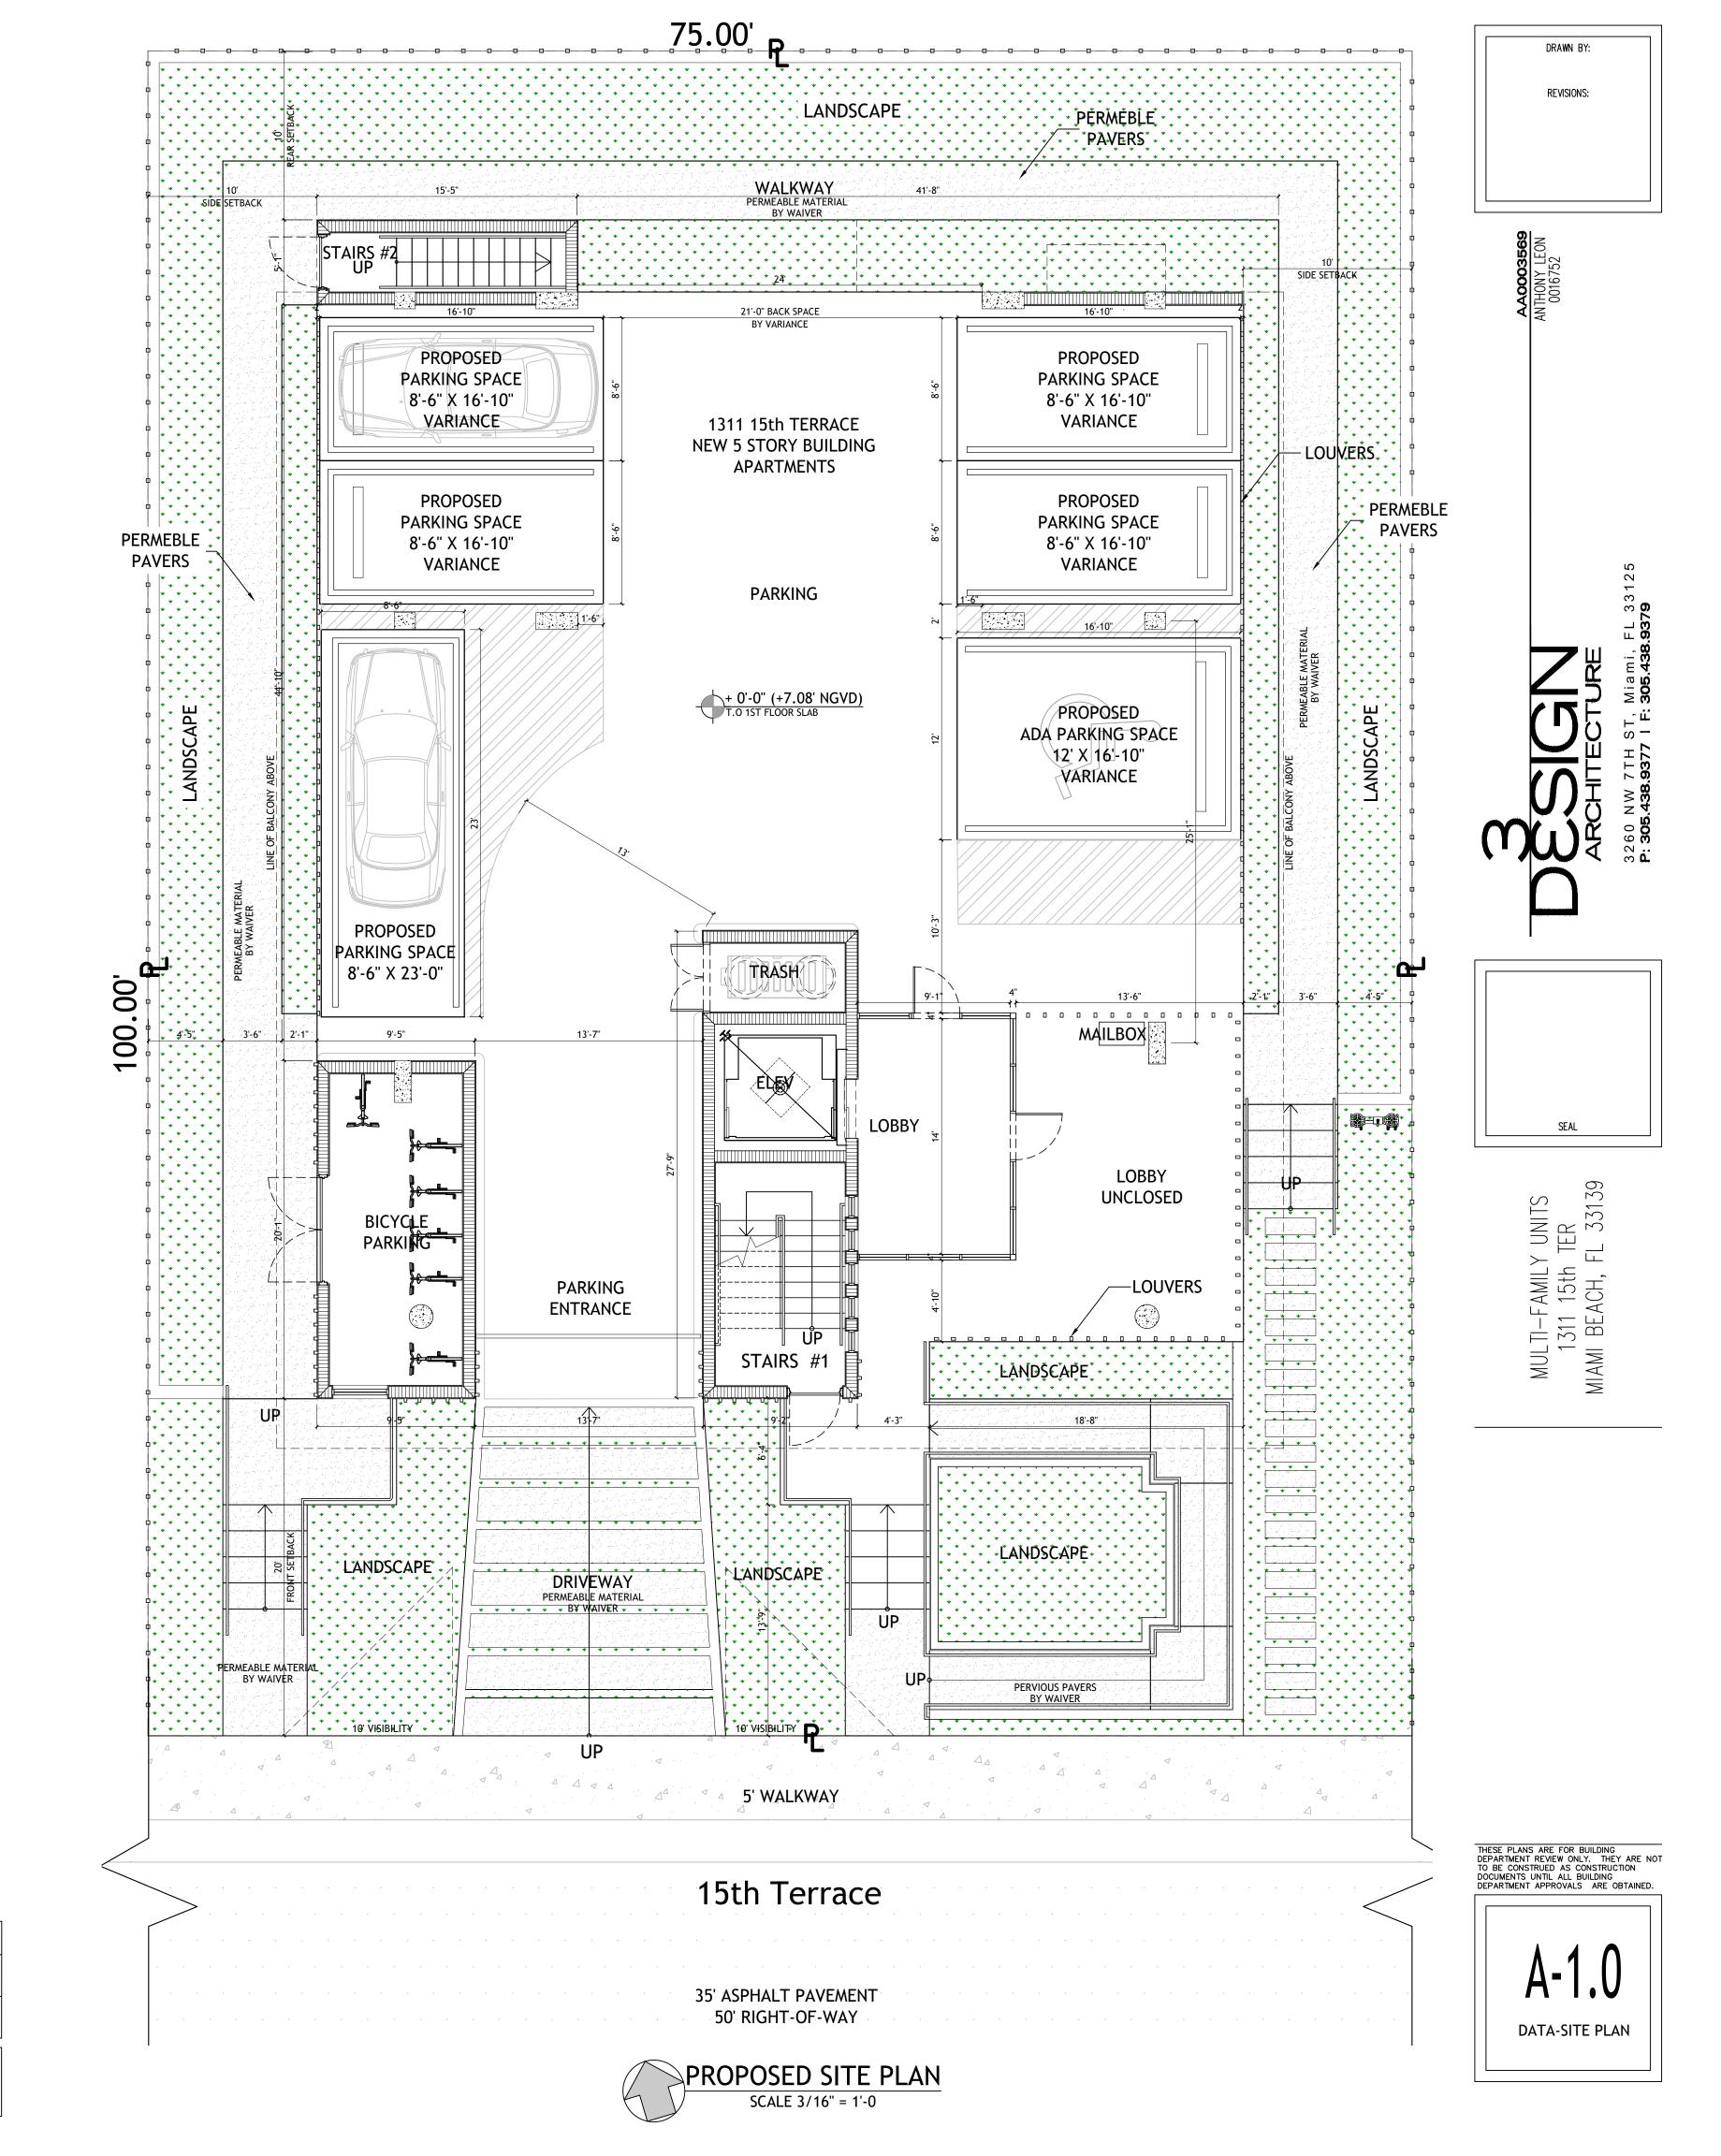

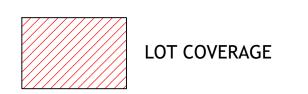


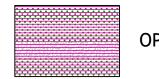

OPEN SPACE AREA

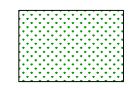

GREENSPACE AREA

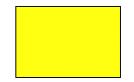



PERMEABLE AREA PROPOSED

# FLOOR AREA RATIO:

FAR ALLOWED RM-1:

1.25 X 7,500 SF = 9,375 SF


FAR PROVIDED:

1,310.58 SF X 6 = 7,999.19 SF

9,162.62 SF


UNITS STAIRS, ELEVATOR AND HALLWAYS: 1,163.14 SF

TOTAL

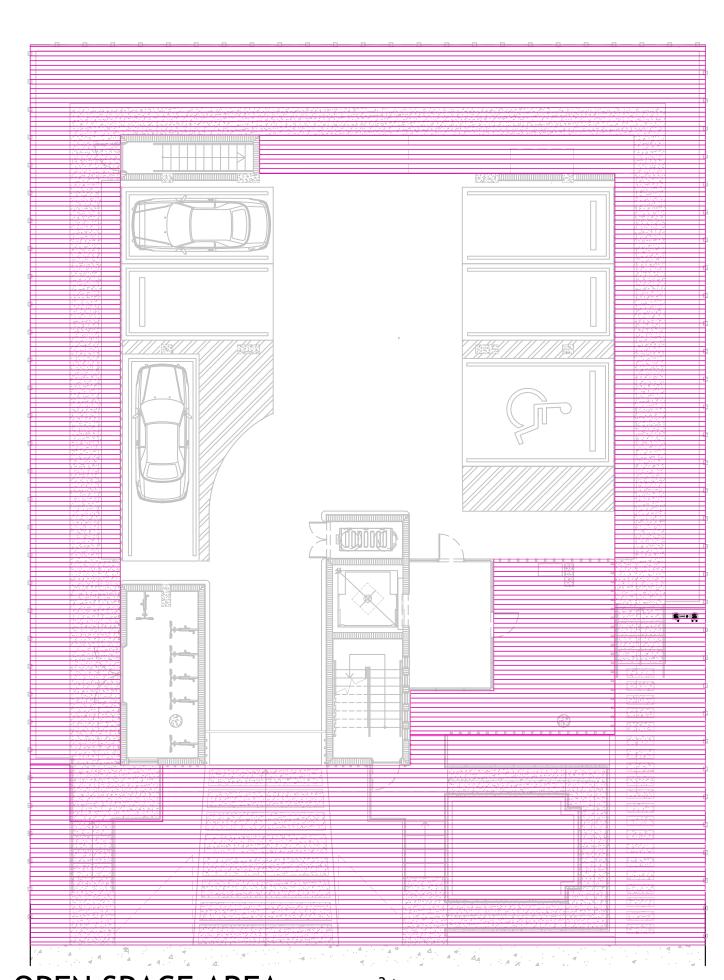

OPEN SPACE AREA: SCALE: 3/32" - 1'-0"

LOT AREA: 7,500 SF (75 x100) MAX. LOT COVERAGE 45%: 3,375 SF **OPEN SPACE REQUIRED 55%:** 4,125 SF 4,206.76 SF **OPEN SPACE PROPOSED 56%:** 

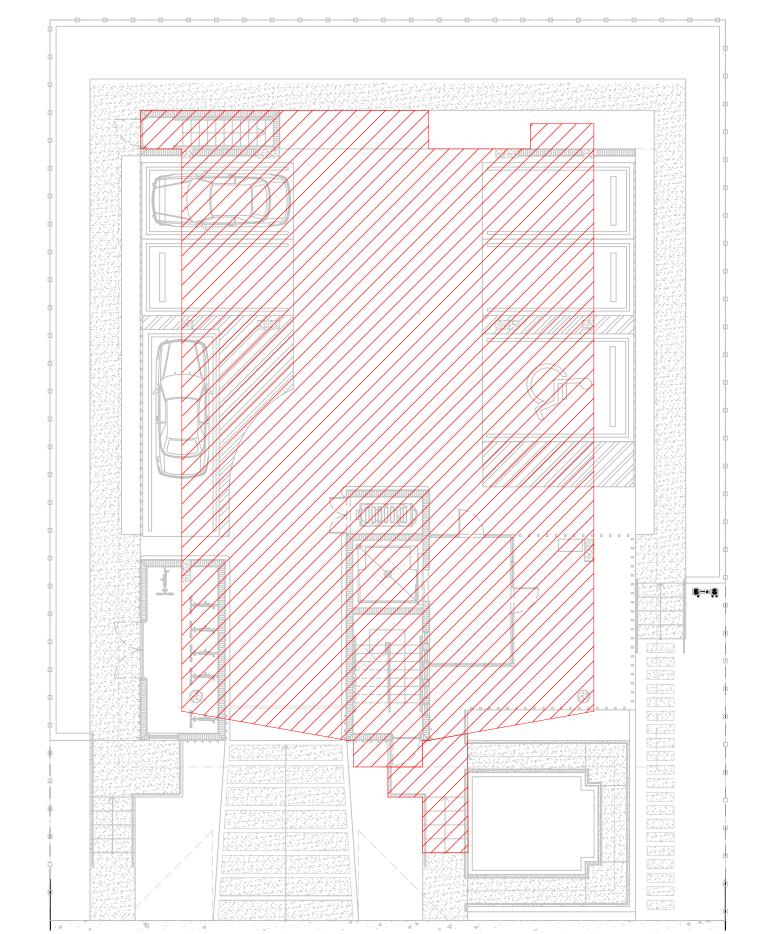

LOT COVERAGE: SCALE: 3/32" - 1'-0"


ZONNING DISTRICT: RM-1

LOT AREA:

3,375 SF MAX. LOT COVERAGE 45%: 3,205.73 SF LOT COVERAGE PROPOSED 42.74%:

RAMP, DRIVEWAYS, WALKWAYS WILL WILL BE PERMEABLE BY WAIVER.

7,500 SF (75'x100')

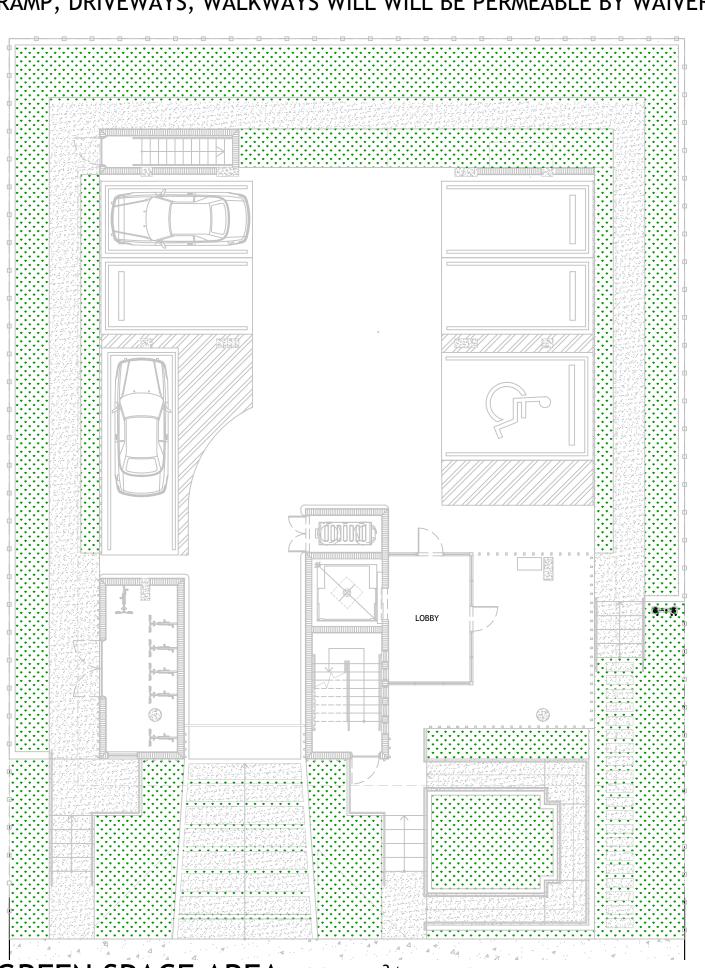


GREEN SPACE AREA: SCALE: 3/32" - 1'-0"

MAX. LAWN AREA % OF REQUIRED OPEN SPACE RM-1 30% REQUIRED= 1237.5 SF GREENSPACE PROPOSED:


27%= 1,121.37 SF PERMEABLE AREA DRIVEWAYS, WALKWAY, RAMP.


1ST FLOOR F.A.R

SCALE: 1/16" -1'-0"

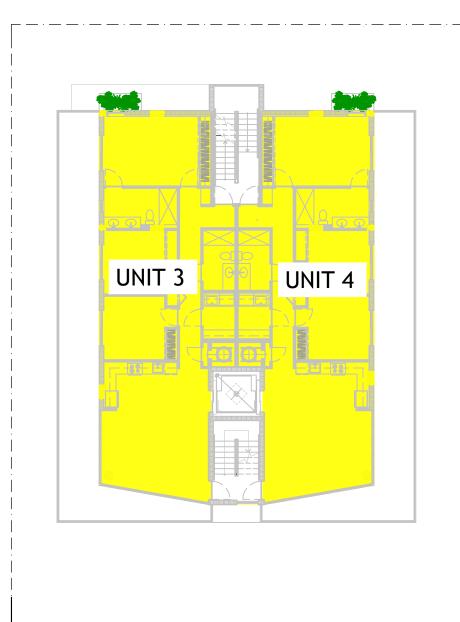


3RD FLOOR F.A.R SCALE: 1/16" - 1'-0"

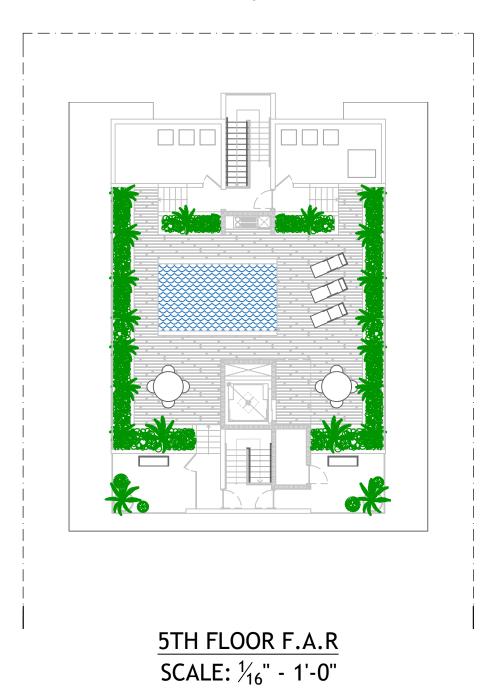

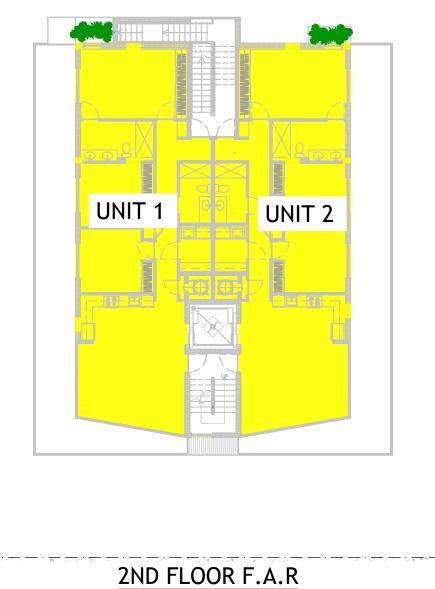


SCALE: ½6" -1'-0"

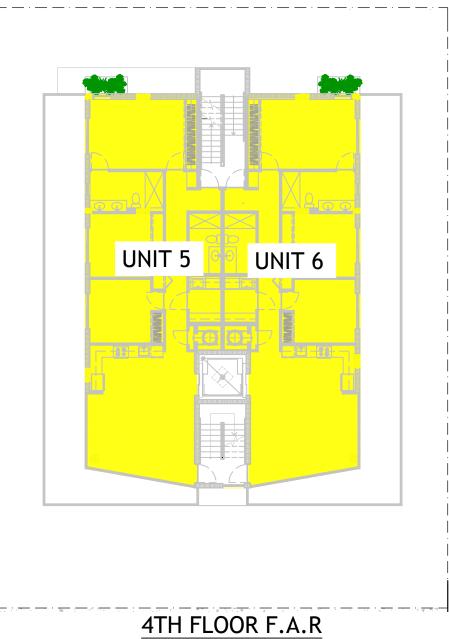


SCALE: 1/16" - 1'-0"


UNDER AC SQ. FT.	
1ST FLOOR	135.71 SF
2nd FLOOR	
UNIT 1	1,310.58 SF
UNIT 2	1,310.58 SF
3rd FLOOR	
UNIT 3	1,310.58 SF
UNIT 4	1,310.58 SF
4th FLOOR	
UNIT 5	1,310.58 SF
UNIT 6	1,310.58 SF
TOTAL	7,999.19 SF

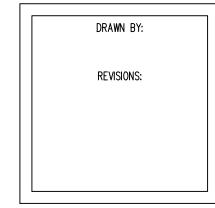






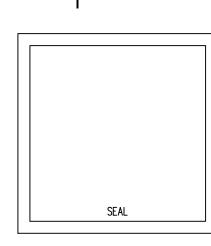

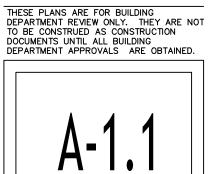

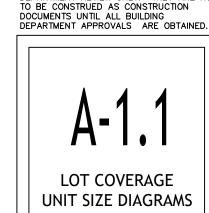




DIMENSION LINES ARE FROM FACE TO FACE

OF METAL STUD WALL AND/OR CMU &/OR CONCRETE WALL (U.O.N.)

DRAWN BY: REVISIONS:

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DEPARTMENT REVIEW ONLY. THEY ARE NOT
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DOCUMENTS UNTIL ALL BUILDING
DEPARTMENT APPROVALS ARE OBTAINED.

2ND FLOOR PROPOSAL 3RD FLOOR PROPOSAL

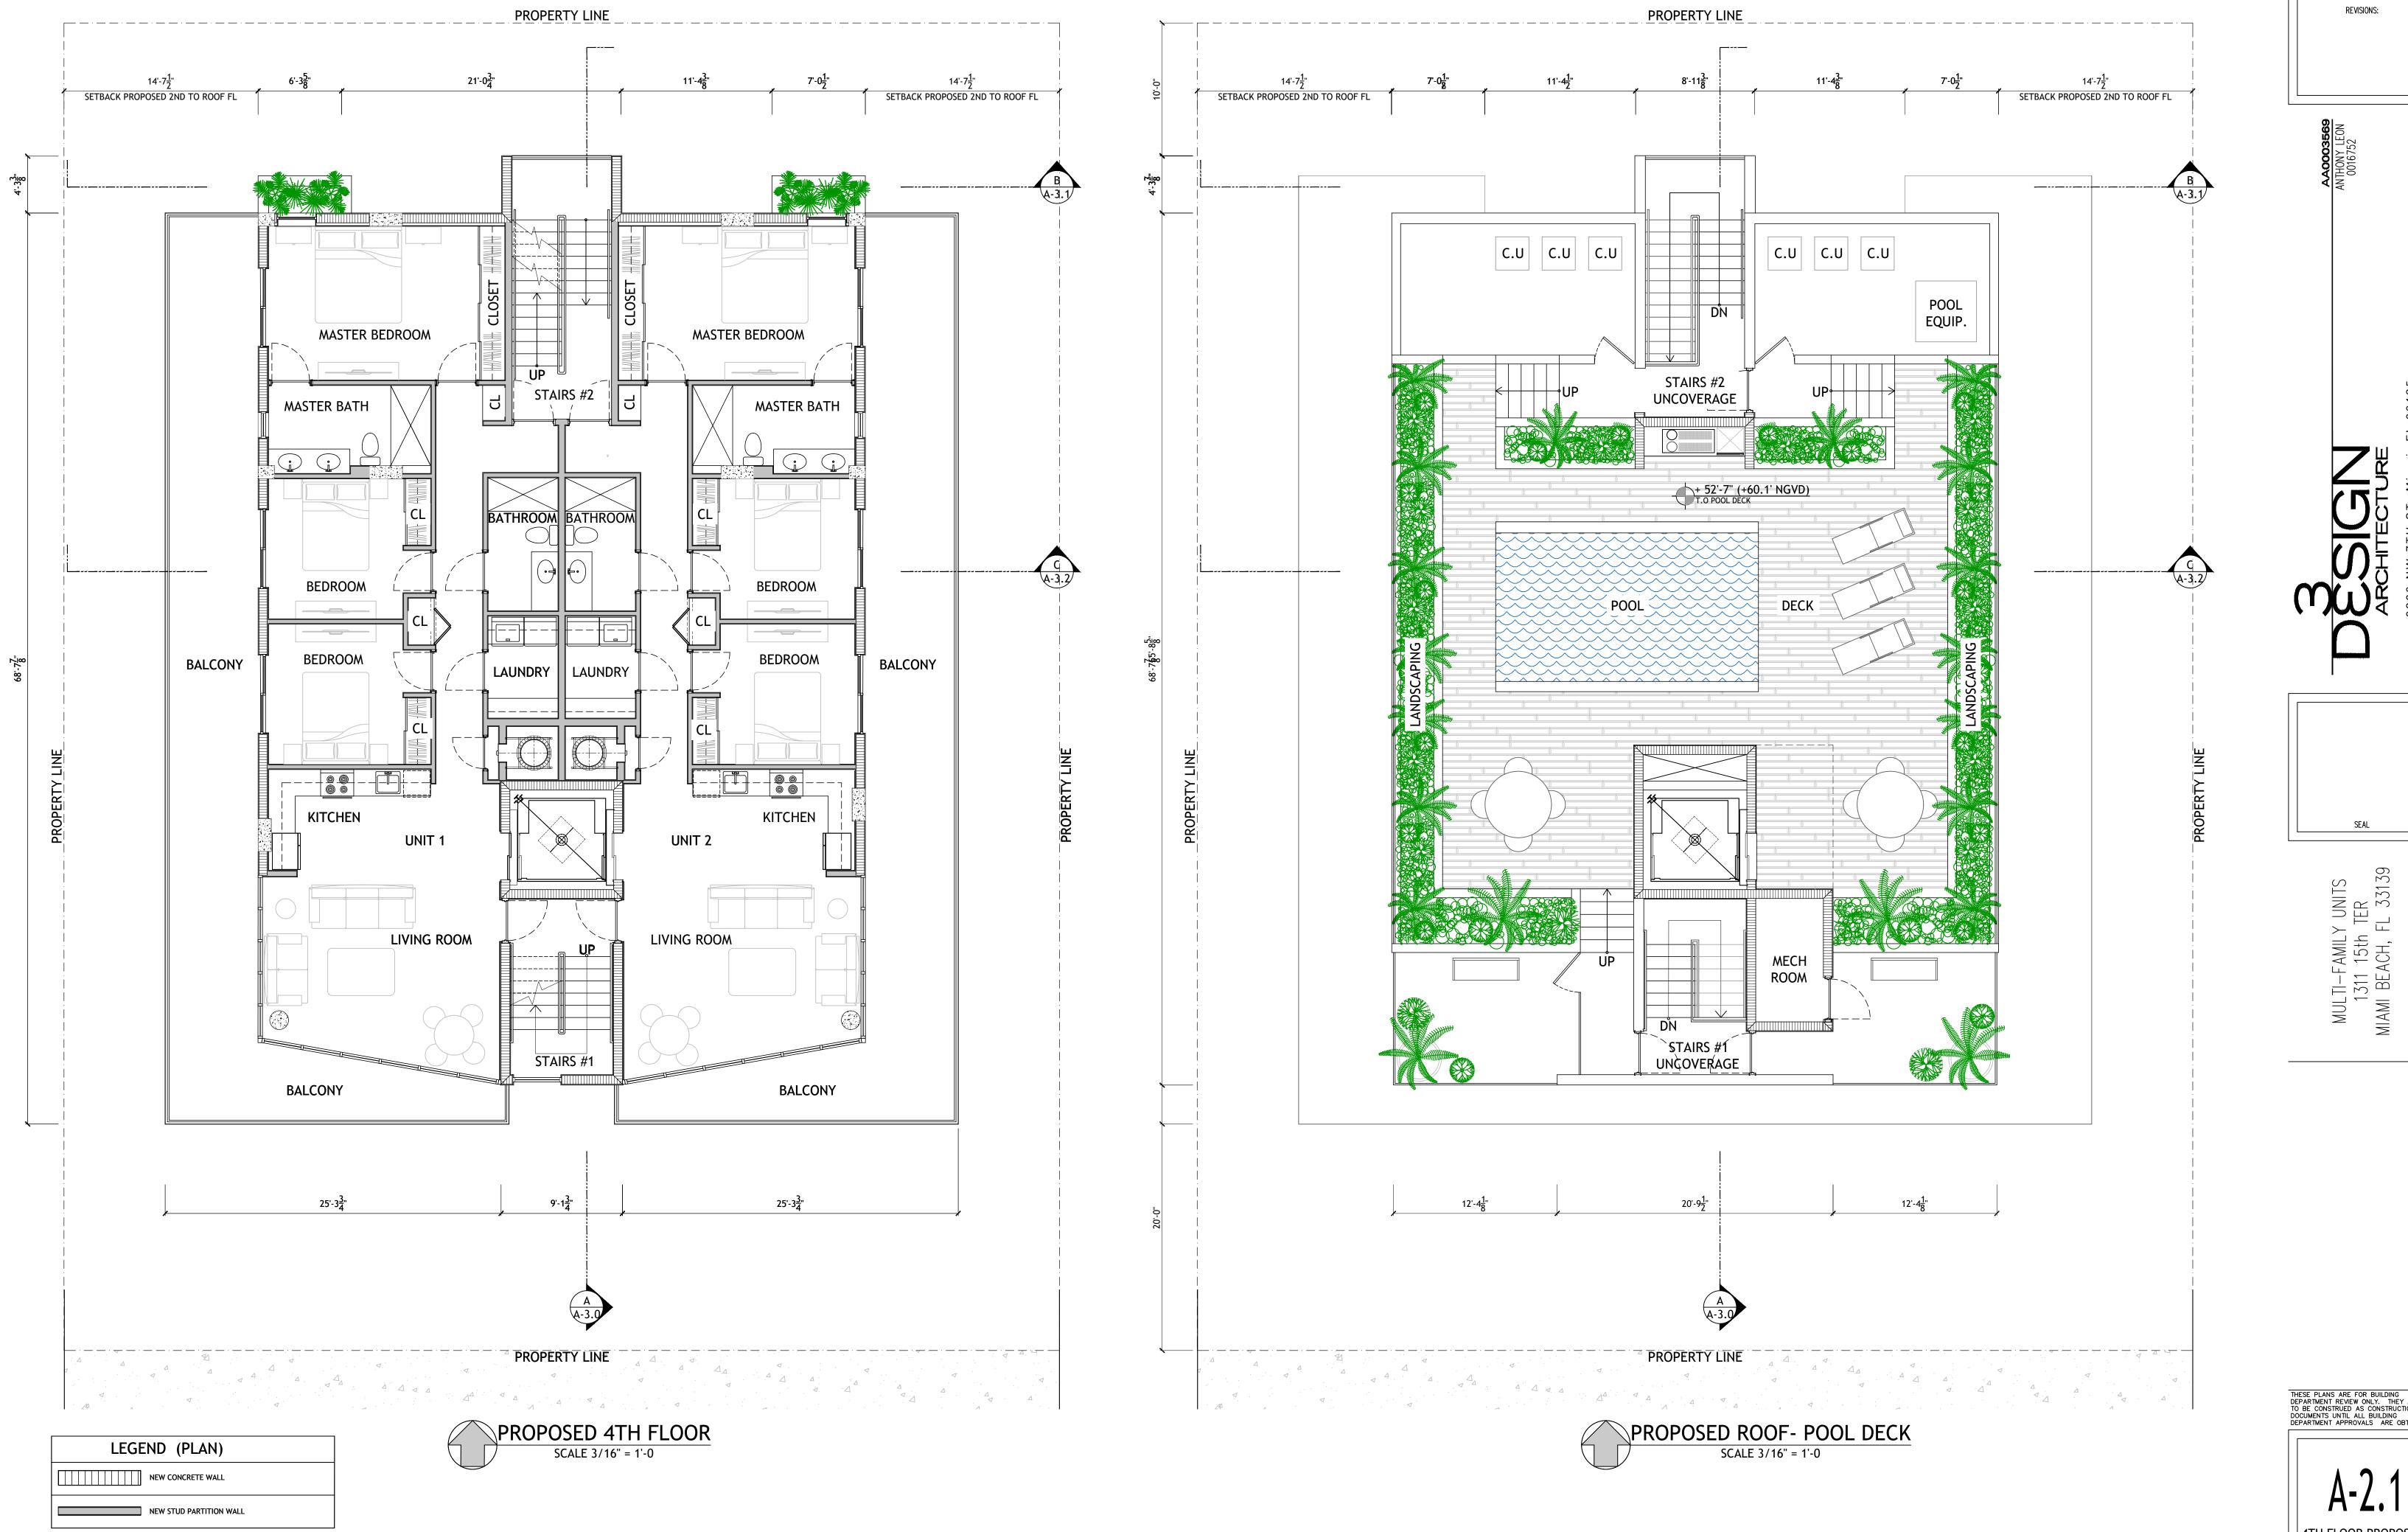

DIMENSION LINES ARE FROM FACE TO FACE OF METAL STUD WALL AND/OR CMU &/OR CONCRETE WALL (U.O.N.)

DRAWN BY:

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4TH FLOOR PROPOSED ROOF PLAN

SCALE 1/4"=1'-0"

DRAWN BY:

REVISIONS:

AAOOO3566 ANTHONY LEON 0016752

ARCHITECTURE

SEAL

MULTI-FAMILY UNITS 1311 15th TER MIAMI BEACH, FL 33139

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A-3.U SECTIONS

AAOOO3569 ANTHONY LEON 0016752

ARCHITECTURE
260 NW 7TH ST, Miami, FL 33125
305,438,9377 | F. 305,438,9379

SEAL

MULTI-FAMILY UNITS 1311 15th TER MIAMI BEACH, FL 3313

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A-3.1
SECTIONS

AAOOO3568 ANTHONY LEON 0016752


ARCHITECTURE
3260 NW 7TH ST, Miami, FL 33125

SEAL

MULTI-FAMILY UNITS 1311 15th TER MIAMI BEACH, FL 33139

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A-3.2
SECTIONS

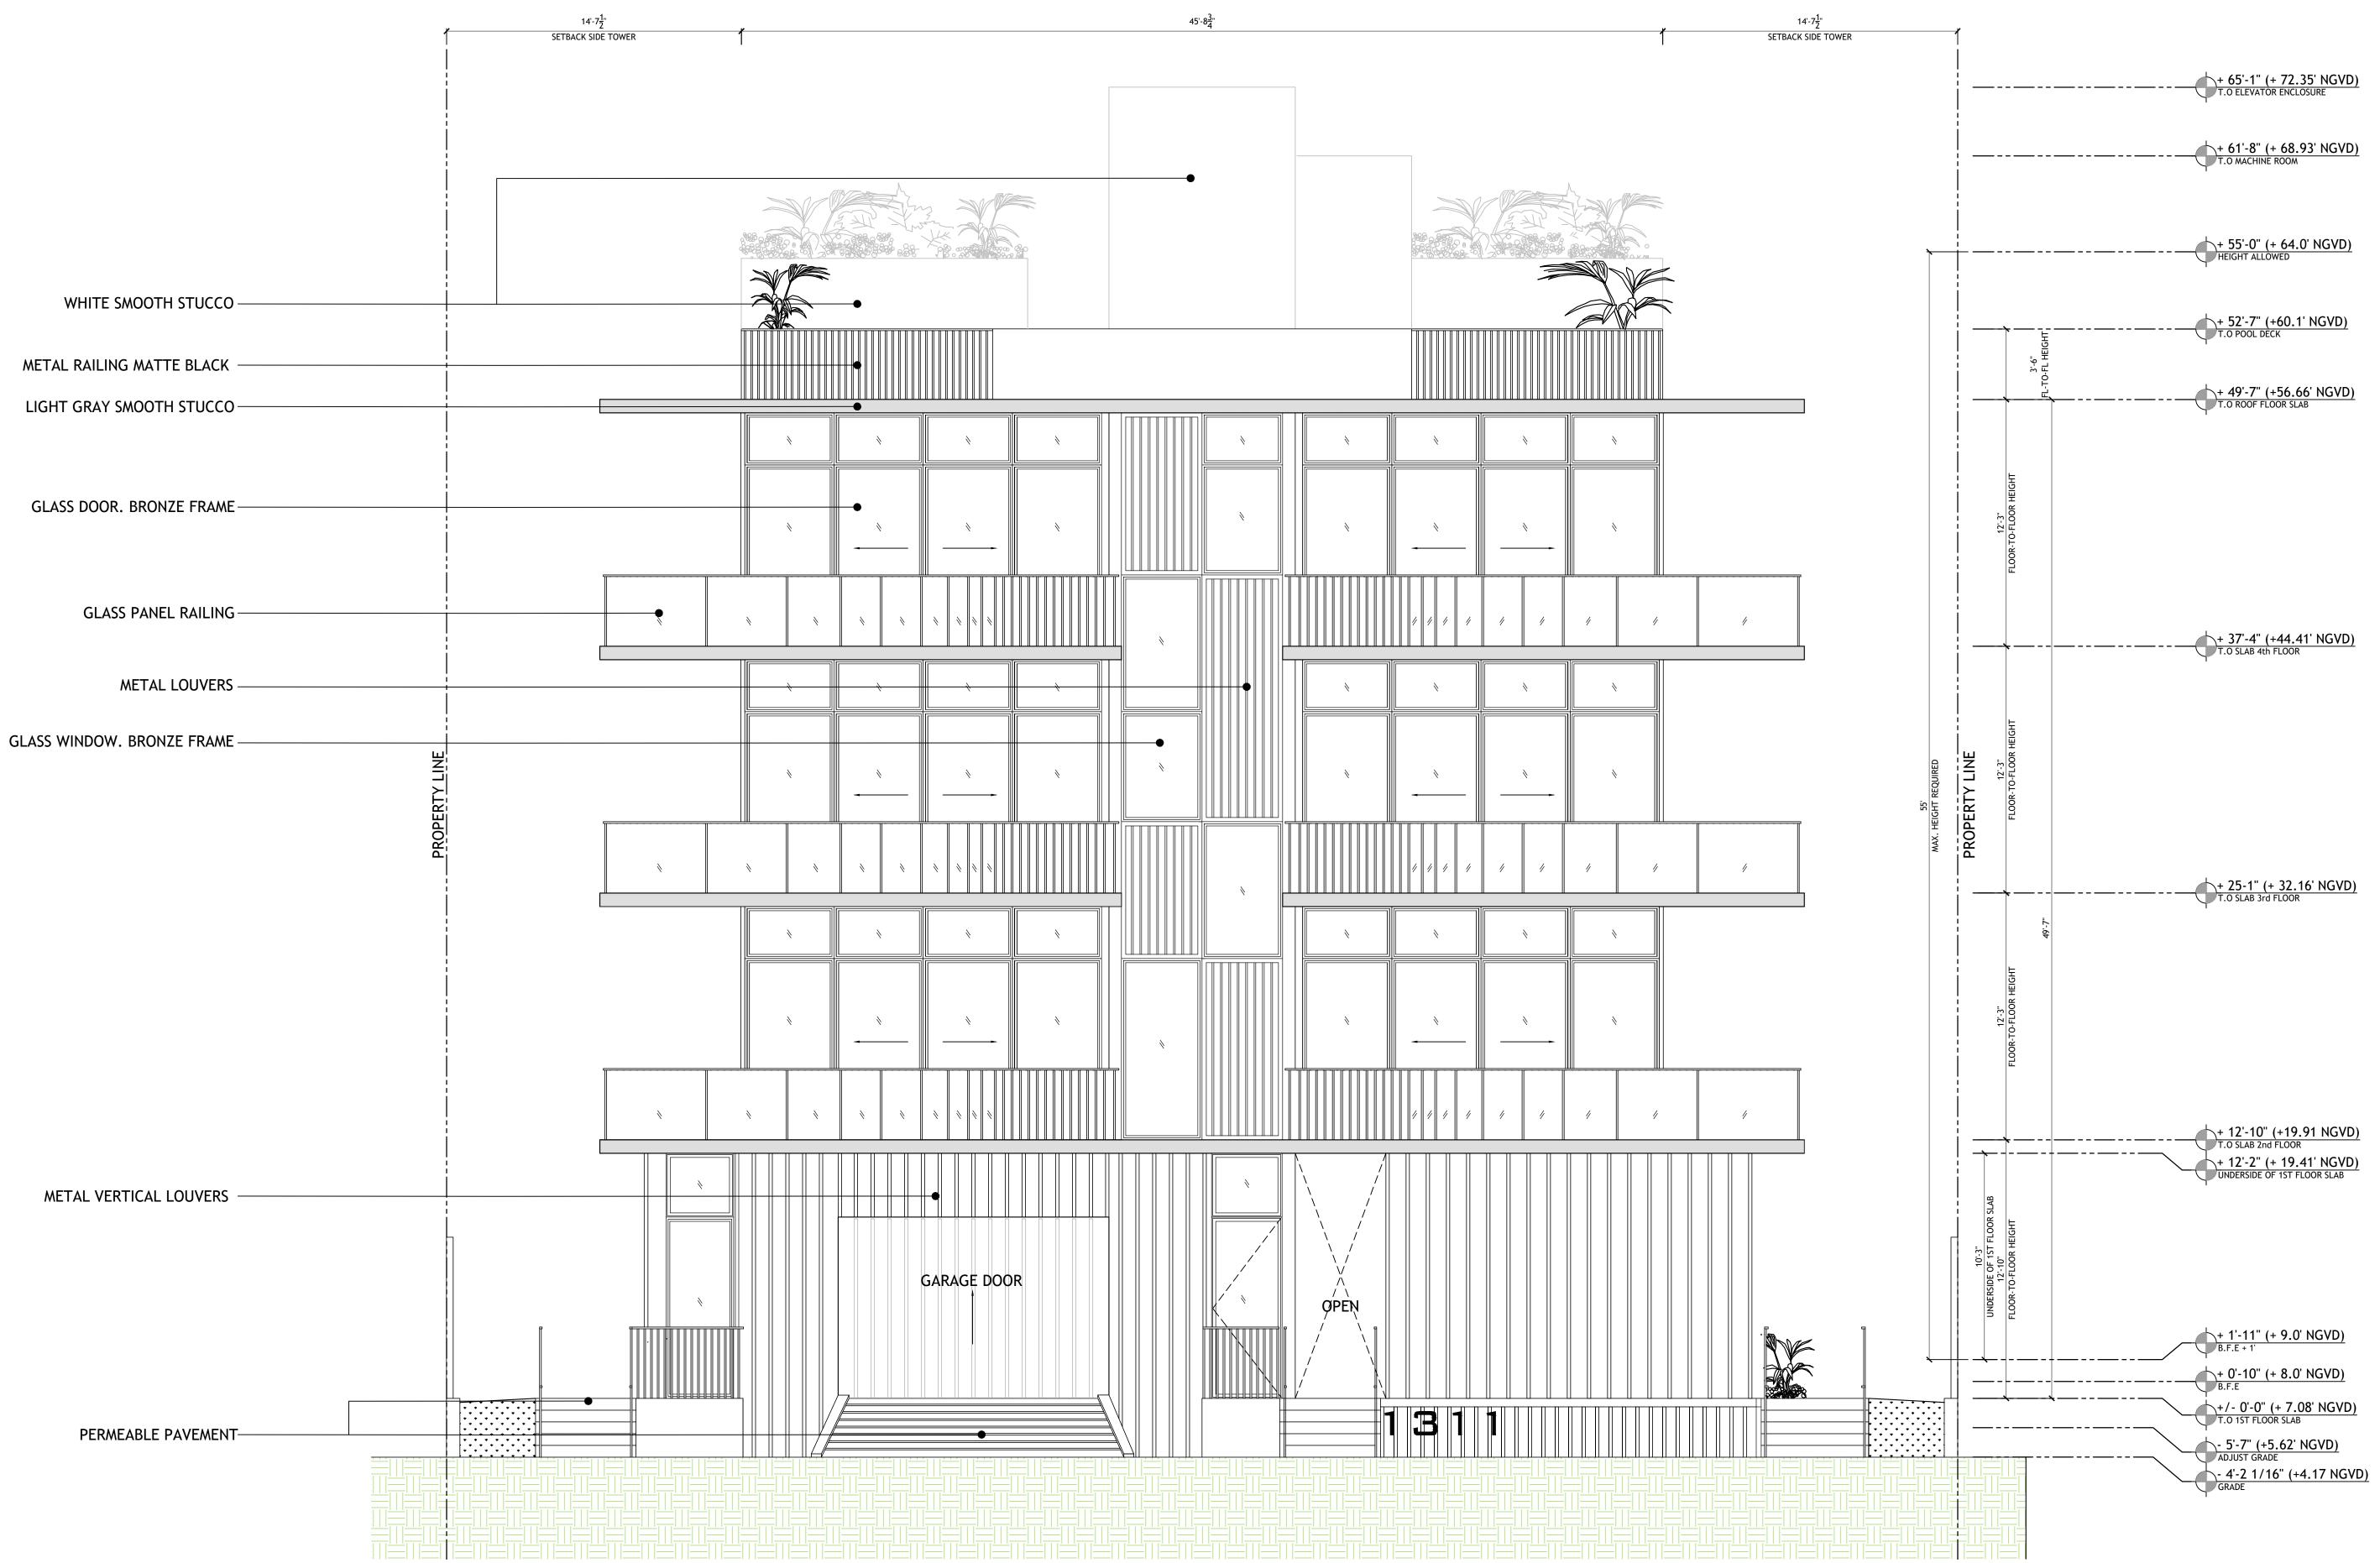

ARCHITECTURE
3260 NW 7TH ST, Miami, FL 33125
8:305.438.9377 1 F: 305.438.9379

DRAWN BY:

REVISIONS:

SEAL


MULTI-FAMILY UNITS 1311 15th TER MIAMI BFACH, FI 33139

SCALE 1/4"=1'-0"


SUBDIVISION II- RM-1 RESIDENTIAL MULTIFAMILY LOW INTENSITY SEC. 142-151 & 142-155

f.Ground floor requirements. When parking or amenity areas are provided at the ground floor level below the first habitable level, the following requirements shall

1. A minimum height of 12 feet shall be provided, as measured from base flood elevation plus minimum freeboard to the underside of the first floor slab. The design review board or historic preservation board, as applicable, may waive this height requirement by up to two feet, in accordance with the design review of certificate of appropriateness criteria, as applicable.

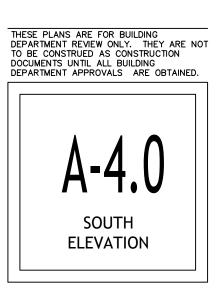



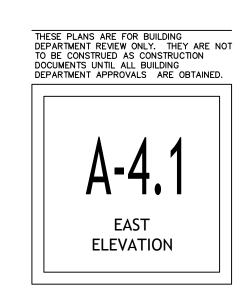

DRAWN BY:

SCALE 1/4"=1'-0"

DRAWN BY:
REVISIONS:

AAOOO356 ANTHONY LEON

> JGS LITECTURE V 7TH ST, Miami, FL 33125

SEAL

MULTI-FAMILY UNITS 1311 15th TER MIAMI BEACH, FL 33139

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A-4.2

NORTH
ELEVATION



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WEST
ELEVATION

DRAWN BY:




PROPOSED FRONT VIEW 15 TER
RENDERING



PROPOSED POOL DECK VIEW RENDERING



PROPOSED REAR VIEW EAST RENDERING

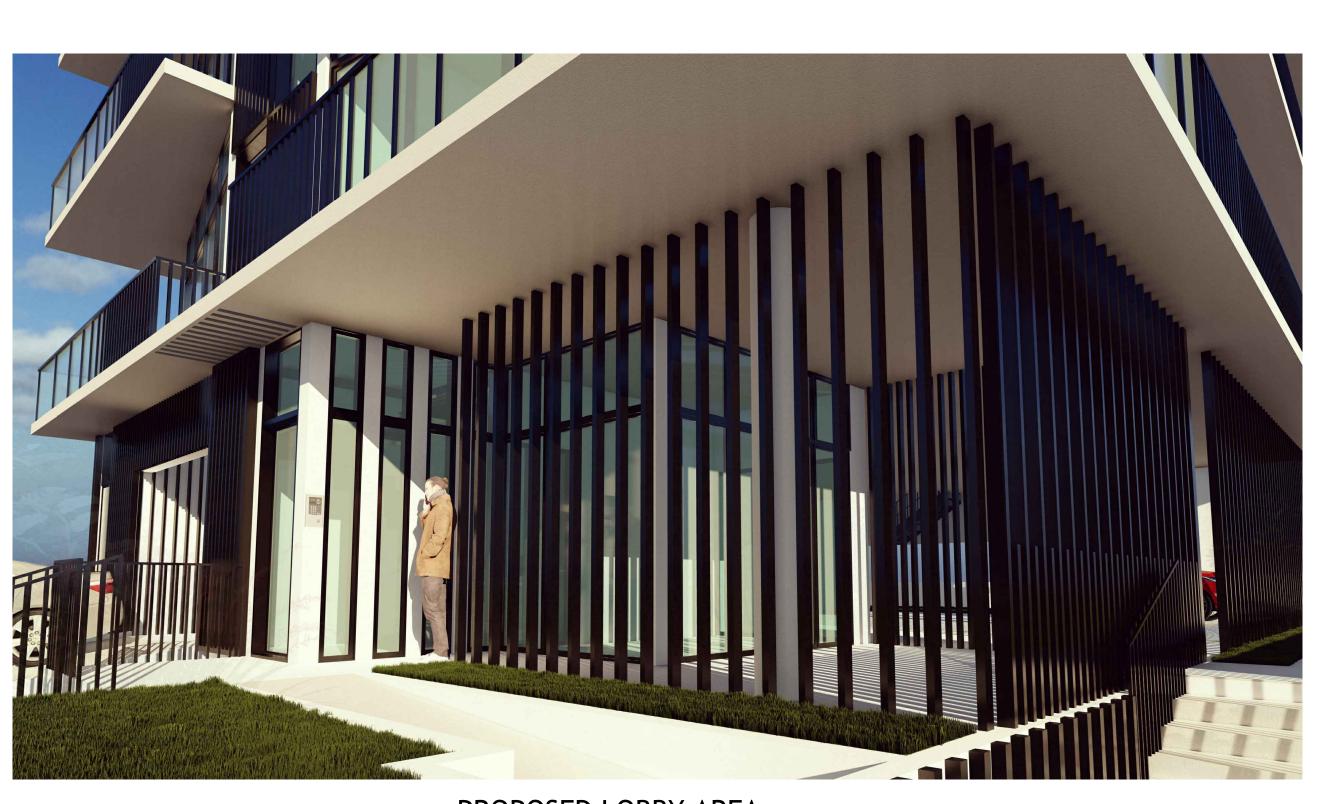

PROPOSED LOBBY AREA RENDERING

AAOOO3569 ANTHONY LEON 0016752

ARCHITECTURE
3260 NW 7TH ST, Miami, FL 33128
P: 305.438.9377 1 F: 305.438.9379

SEAL

MULTI-FAMILY UNITS 1311 15th TER MIAMI BEACH, FL 33139

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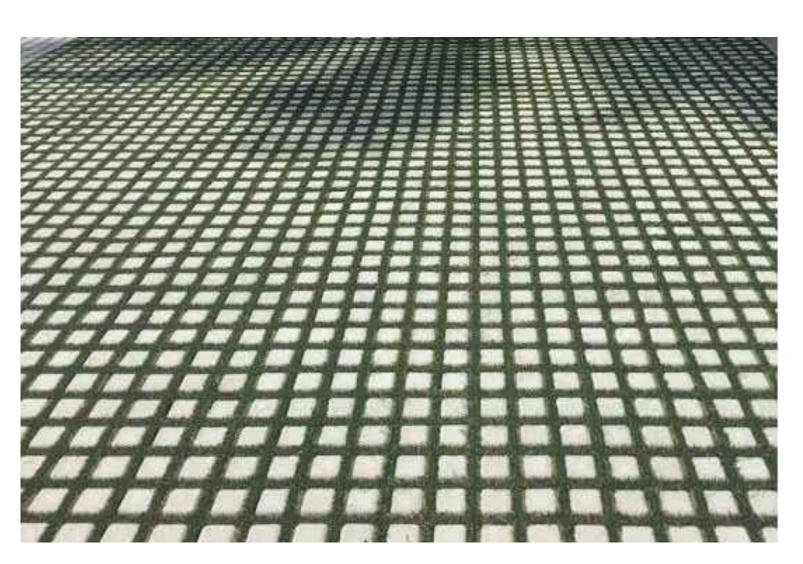
A-5.0 RENDERINGS

DRAWN BY:



METAL VERTICAL LOUVERS





PERMEABLE PAVERS




LIGHT GRAY STUCCO

WHITE SMOOTH STUCCO



BRUSHED CONCRETE EXTERIOR

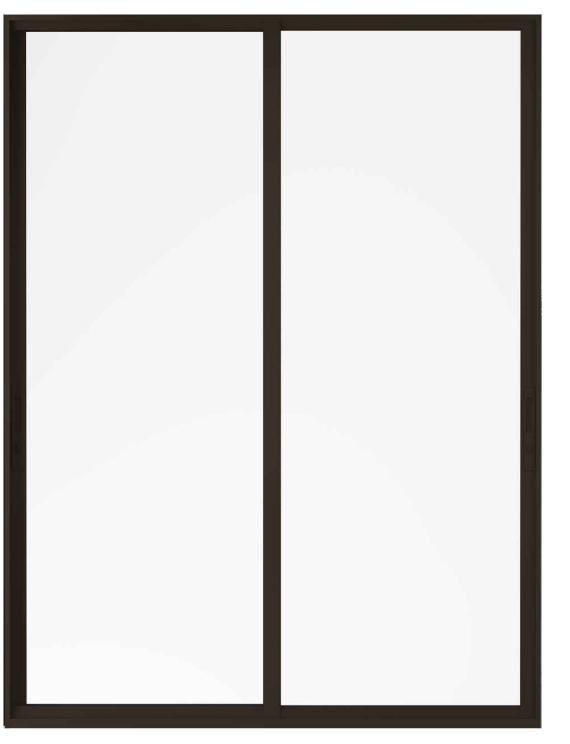

GLASS DOOR. BRONZE FRAME

MATERIAL PROPOSAL