100% COMPLETE LANDSCAPE ARCHITECTURAL DESIGN REVIEW BOARD SET (FINAL SUBMITTAL) FOR: 621 WEST 44TH STREET MIAMI BEACH, FLORIDA 33140 TREE DISPOSITION | SITE | PLANTING

Landscape Architectural Design



SHEET INDEX

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 PROJECT SITE / LOCATION MAP

 LC-001
 EXISTING CONDITIONS

COASTAL OPERATIONS Landscape architecture LLC

AK SOMM FEIRAAL INGWAY USTI, SUITE P2 FORT LAUREBALE, FLOREDA 33001 P2: 954.266.8932 FIRM LICENSE: FL LA 6667411 WWW.COASTAL-OPS.COM PROJECT LOCATION: 621 WEST 44TH STREET

621 WEST 441H STREET Miami Beach, Florida 33140

PROJECT CLIENT(S) | OWNER(S): MRS. MARY AILEEN MURPHY / LJM DEVELOPMENT

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PROJECT NAME: 621 WEST 44TH STREET GARDEN					
PROFESSIONAL SEAL(S): Digitally signed by TRAVIS M HARRISON Date: 2022.07.00 12:26:03 -04'00'					
	06/21/2022	DRB FIRST SUBMITTAL DRB FINAL SUBMITTAL			
	0//11/2022	UKD FINAL SUDMITTAL			
	DATE	DESCRIPTION			

SHEET ISSUE / REVISION LOG

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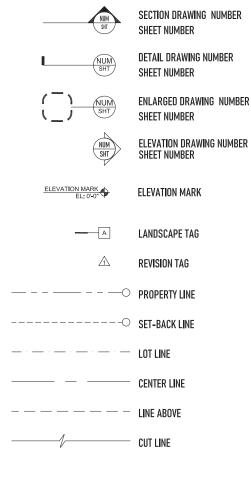
Project ID: 2022-621W44 Print Date: July 11, 2022 Scale: As Indicated Drawn By: TH

Sheet Title:

LANDSCAPE COVER + INDEX

LC-001

SYMBOL LEGEND



C.A CR FG G٨ G١

INSTALL AND MAINTAIN ALL

SION CONTROL NOTES:	
GINNING ANY EARTH CHANGE, THE CONTRACTOR S	SHALL

SOIL FROS

1 PRIOR TO BE

SESC MEASURES AS SHOWN ON THE CONTRACT DOCUMENTS AND AS REQUIRED BY ANY GOVERNING AGENCIES. 2. ALL SESC MEASURES TO BE MAINTAINED DAILY

3. THE CONTRACTOR TO CONDUCT ALL EXCAVATION, FILLING, GRADING, AND CLEANUP OPERATIONS IN A MANNER SUCH THAT SEDIMENT, GENERATED BY WIND OR WATER IS NOT DISCHARGED INTO ANY STORM SEWER, DRAINAGE DITCH, RIVER, LAKE, AIR, OR UNDERGROUND UTILITY SYSTEM, STAGE WORK TO MINIMIZE THE AREA OF EXPOSED SOIL, THEREBY REDUCING THE OPPORTUNITY FOR SOIL FROSION

ARCHITECT IN PROPER WORKING ORDER THROUGHOUT THE DURATION OF THE PROJECT. 4. WATER FROM TRENCHES AND OTHER EXCAVATION TO BE PUMPED INTO A FILTRATION BAG TO REMOVE SEDIMENTS FROM THE WATER

5. NORTH AMERICAN GREEN SC-150 OR FOUNALENT EROSION CONTROL FABRIC IS REQUIRED ON ALL DISTURBED SLOPES GREATER THAN 3:1 UNTIL PROJECT AREA IS RE-VEGETATED PER THE PLANTING PLAN.

6. PROVIDE POSITIVE DRAINAGE AWAY FROM ALL STRUCTURES.

7. CONTRACTOR TO PROVIDE ONSITE WATERING TO REDUCE FUGITIVE DUST LEAVING THE SITE DURING CONSTRUCTION

8. SOIL EROSION CONTROL MEASURES TO BE PROVIDED FOR ALL EXISTING AND PROPOSED DRAINAGE STRUCTURES WITHIN THE PROJECT LIMITS.

9. CONSTRUCTION STAGING AND PHASING SHALL OCCUR, WHERE APPLICABLE, TO MINIMIZE SOIL DISTURBANCE TIME.

10. BEST MANAGEMENT PRACTICES (BMPs) SHALL BE ADJUSTED AS NEEDED TO MEET ANY OTHER UNFORESEEN CONDITIONS.

11. THE GENERAL CONTRACTOR IS RESPONSIBLE FOR INSTALLING A MUD TRACKING PAD/WASHING PAD AT THE CONSTRUCTION ENTRANCES TO MINIMIZE MUD DETACHMENT FROM TRUCK TIRES 1-1/2 INCH SCREENED ROCK TO BE PLACED ON MIRAFI 140 - N FILTER FABRIC. ADDITIONAL CLEAN GRAVEL TO BE ADDED THROUGHOUT THE DURATION OF CONSTRUCTION AS NEEDED

12. CONTRACTOR SHALL ABIDE BY THE LOCAL, STATE AND FEDERAL JURISDICTIONS AND GOVERNING BODIES/AGENCIES CONSTRUCTION MANAGEMENT PLAN REQUIREMENTS. 13. RESEED AS INDICATED IN SEEDING NOTES.

PLANTING SPECIFICATIONS:

- 1. ALL PLANT MATERIAL SHALL BE FLORIDA NO. 1 OR BETTER AS GIVEN IN THE CURRENT GRADES AND STANDARDS FOR NURSERY PLANTS, 2ND EDITION, FEBRUARY 1998, FLORIDA DEPARTMENT OF AGRICULTURE AND CONSUMER SERVICES, DIVISION OF PLANT INDUSTRY. CO-DOMINANT TREES AND TREES WITH BARK INCLUSION WILL NOT BE ACCEPTED
- 2. ALL PLANT MATERIAL USED SHALL BE TRUE TO NAME AND SIZE IN CONFORMITY WITH THE FLORIDA NURSERYMEN'S GRADES AND STANDARDS. PLANTS THAT DO NOT MEET THE SPECIFICATIONS WILL NOT BE ACCEPTED.
- 3. THE PLAN AND PLANT LIST SHALL DETERMINE ALL PLANT QUANTITIES, SIZES AND LOCATION. THE SIZE SPECIFIED ON THE PLANT LIST SHALL TAKE PRECEDENT OVER A CONTAINER SIZE. SPACING OF GROUND COVERS WILL BE DETERMINED BY THE PLANT LIST. QUANTITIES SHOWN ON PLANT LISTS ARE TO BE USED AS A GUIDELINE ONLY. CONTRACTOR WILL BE RESPONSIBLE FOR VERIFICATION OF ACTUAL QUANTITIES CALLED FOR ON PLANS. DISCREPANCIES SHOULD BE BROUGHT TO THE ATTENTION OF THE LANDSCAPE ARCHITECT.
- 4. ALL PLANT MATERIALS SCHEDULED FOR INSTALLATION SHALL BE INSPECTED AND PHOTOGRAPHED BY LANDSCAPE ARCHITECT 30 DAYS PRIOR TO SCHEDULED INSTALLATION, LANDSCAPE ARCHITECT SHALL VERIFY PLANT MATERIAL FOR THEIR CONFORMITY TO SPECIFICATION, CONTRACTOR SHALL BE RESPONSIBLE FOR MAINTAINING THE CONDITION OF ALL PLANT MATERIAL FROM TIME OF INSPECTION BY THE LANDSCAPE ARCHITECT TO THE TIME OF INSTALLATION, IF CONDITION OF THE PLANT MATERIAL (SIZE QUALITY & HEALTH) IS REDUCED FROM THE TIME OF INSPECTION. THAT PLANT MATERIAL WILL BE REJECTED.
- 5. CONTRACTOR SHALL NOTIFY/VERIFY WITH LANDSCAPE ARCHITECT, THE AVAILABILITY (QUANTITY AND QUALITY DESCRIBED IN THE DRAWINGS) OF ALL PLANT MATERIAL SPECIFIED AT THE TIME OF THE BID.
- 6. CONTRACTOR SHALL SUBMIT TO THE LANDSCAPE ARCHITECT, PROOF THAT MATERIALS HAVE BEEN SECURED 60 DAYS PRIOR TO THE SCHEDULED INSTALLATION. IF SUBSTITUTIONS ARE REQUIRED, LANDSCAPE ARCHITECT WILL RE-SPECIFY AND CONFIRM THAT NEWLY SPECIFIED MATERIALS ARE AVAILARIE (DIJANTITY AND DIJALITY DESCRIPTED IN THE DRAWINGS) CONTRACTOR TO SUBMIT TO THE LANDSCAPE ARCHITECT. PROOF THAT THE NEWLY SPECIFIED MATERIALS HAVE REEN SECURED AS DAYS PRIOR TO SCHEDILLED INSTALLATION
- 7. NO SUBSTITUTIONS SHALL BE ACCEPTED WITHOUT PRIOR WRITTEN CONSENT OF LANDSCAPE ARCHITECT. ANY INTENDED SUBSTITUTIONS SHALL BE DETAILED ON THE BID.
- 8. CONTRACTOR SHALL NOTIFY SUN SHINE. (1-800-432-4770) FOR LOCATIONS OF EXISTING UTILITY LINES 48 HOURS PRIOR TO BEGINNING WORK. CONTRACTOR SHALL VERIFY LOCATION OF ALL UTILITY LINES AND EASEMENTS PRIOR TO COMMENCING ANY WORK. EXCAVATION IN THE VICINITY OF UNDERGROUND UTILITIES SHALL BE UNDERTAKEN WITH CARE AND BY HAND, IF NECESSARY. THE CONTRACTOR BEARS FULL RESPONSIBILITY FOR THIS WORK AND DISRUPTION OR DAMAGE TO UTILITIES SHALL BE REPARED IMMEDIATELY AT NO EXPENSE TO THE OWNER.
- 9. ALL TREES SHALL BE WARRANTED BY THE CONTRACTOR AND WILL BE HEALTHY AND IN FLOURISHING CONDITION OF ACTIVE GROWTH ONE YEAR FROM DATE OF FINAL ACCEPTANCE.
- 10. ALL SHRUBS, GROUNDCOVERS, VINES AND SOD SHALL BE FULLY WARRANTED FOR 180 DAYS UNDER SAME CONDITION AS ABOVE.
- 11. ALL PLANTS SHALL BE EXCEPTIONALLY HEAVY, SYMMETRICAL, TIGHT KNIT AND SO TRAINED IN APPEARANCE AS TO BE SUPERIOR TO FORM, BRANCHING AND SYMMETRY
- 12. ALL LANDSCAPE SHALL BE INSTALLED IN COMPLIANCE WITH ALL LOCAL CODES.
- 13. THE PLAN SHALL TAKE PRECEDENCE OVER THE PLANT LIST, SHOULD THERE BE ANY DISCREPANCY BETWEEN THE TWO.
- 14. GRADE R+ SHREDDED MEI ALFUEA OR APPROVED NON-CYPRESS MULCH MINIMUM 3" DEEP. SHALL BE USED IN ALL MASS PLANTING REDS AND FOR INDIVIDUAL TREE PITS ALL TREES SHALL HAVE A MULCH RING WITH A MINIMUM DEPTH OF 3" AND A DIAMETER OF 3-4 AROUND THEIR BASE, ALL MULCH SHALL BE KEPT 2 FROM THE BASE OF ALL PLANT MATERIAL, MULCH BEDS SHALL BE A MINIMUM OF 12 WIDER THAN PLANTS MEASURED FROM OUTSIDE EDGE OF FOLIAGE, NO EUCAL/PTUS OR RED COLORED MULCH WILL BE ACCEPTED
- 15, SOD SHALL BE 'EMPIRE TURF' ZOYSIA OR ST, AUGUSTINE 'FLORATAM' SOLID AND FREE OF WEEDS, INSECTS, FUNGUS AND DISEASE, LAID WITH ALTERNATING AND ABUTTING JOINTS, CONTRACTOR TO DETERMINE QUANTITY,
- 16. ALL TREES AND SHRUBS SHALL BE BACKFILLED WITH A SUITABLE PLANTING SOIL CONSISTING OF 50 PERCENT SAND AND 50 PERCENT APPROVED COMPOST, (NOTE: FIELD OBSERVATION AND SOIL ANALYSIS MAY REQUIRE A DIFFERENT SOIL COMPOSITION TO BE PROVIDED.) ALL PLANT MATERIALS SHALL BE PLANTED WITH A MINIMUM OF EIGHT TO TWELVE INCHES OF THIS PLANTING SOIL AROUND AND BENEATH THE ROOT BALL, REFER TO PLANTING DETAILS, PLANTING BEDS AND PLANTING SOIL SHALL BE FREE FROM ROAD, PEA, EGG, OR COLORED ROCK, BUILDING MATERIALS, DEBRIS, WEEDS, NOXIOUS PESTS AND DISEASE.
- 17. ALL SODDED AREAS TO HAVE A MINIMUM OF 2" OF PLANTING SOIL AS DESCRIBED IN CONDITION ABOVE. SOD SHALL BE DENSE, GREEN AND WELL ROOTED AND FREE OF DEBRIS, WEEDS, OBJECTIONAL GRASSES, DISEASE OR INFECTUOUS INSECTS. A COMPLETE 6-6-6 FETILIZER SHALL BE SPREAD AT A RATE OF 5 LBS. PER 100 SO. FT. SOD SHAL BE WATERED TO A DEPTH OF 4 AFTER LAYING. ALL AREAS TO BE SODDED SHALL BE RAKED SMOOTH AND ALL DEBRIS REMOVED PRIOR TO INSTALLATION. 18. ALL SYNTHETIC BURLAP, SYNTHETIC STRING OR CORDS OR WIRE BASKETS SHALL BE REMOVED BEFORE ANY TREES ARE PLANTED. ALL SYNTHETIC TAPE SHALL BE REMOVED FROM TRUNKS, BRANCHES, ETC. BEFORE INSPECTION. THE TOP 1/3 OF ANY NATURAL
- BURLAP SHALL BE REMOVED OR TUCKED INTO THE PLANTING HOLE BEFORE TREES ARE BACK FILLED. PLANTING SOIL TO BE BACKFILLED INTO PLANT PITS BY WASHING IN.

19. ALL TREES, PALMS AND OTHER PLANTS SHALL BE PLANTED WITH THE TOP OF THEIR ROOT BALLS NO DEEPER THAN THE FINAL GRADE SURROUNDING THE PLANTING AREA. 20. ALL TREES & OR TALLER SHALL BE GUYED OR STAKED TO PROVIDE AMPLE SUPPORT SUCH THAT THE MATERIAL WILL STAY UPRIGHT AND TRUE THROUGH THE GUARANTEE PERIOD. METHODS USED WILL BE SUCH THAT NO INJURY IS CAUSED TO PLANTS, GUYING SHALL BE DONE AT THE OPTION OF THE CONTRACTOR UNLESS SPECIFICALLY REQUESTED BY THE LANDSCAPE ARCHITECT, HOWEVER, CONTRACTOR SHALL STILL BE RESPONSIBLE FOR ALL TREES AND PALMS REMAINING STRAIGHT AND TRUE THROUGHOUT THE GUARANTEE PFRIOD 21. IN AREAS WHERE PAVED SURFACES ABUT SOD OR MULCH, THE FINAL GRADE LEVEL OF BOTH SURFACES SHALL BE EVEN.

- 22. ALL PLANTING SHALL BE INSTALLED IN A SOUND, WORKMANLIKE MANNER AND ACCORDING TO GOOD PLANTING PROCEDURES. INSTALLATION SHALL INCLUDE WATERING, WEEDING, FERTILIZING, MULCHING, SELECTIVE PRUNING, AND REMOVAL OF REFUSE AND
- DEBRIS ON REGULAR BASIS SO AS TO PRESENT A NEAT AND WELL KEPT APPEARANCE AT ALL TIMES.
- 23. MILORGANITE FERTILIZER SHALL BE APPLIED AFTER PLANTING AND PRIOR TO MULCHING AT THE MANUFACTURERS RECOMMENDED APPLICATION RATES. IN ADDITION, AGRIFORM TABLETS (FORMULA 20-10-5) SHALL ALSO BE APPLIED AT THE MANUFACTURERS' RECOMMENDED RATES TO ALL PLANTS LARGER THAN 3 GAL. SIZE.
- 24. ALL TREES AND LARGE PALMS INCLUDING ROYAL AND DATE PALMS SHALL BE PLANTED A MINIMUM OF 5-0" FROM ANY HARDSCAPE AREA AND MINIMUM OF 8-0" FROM ALL STRUCTURES

25. ALL PALMS NOT INCLUDING ROYAL AND DATE PALMS SHALL BE PLANTED A MINIMUM OF 3-0 FROM ANY HARDSCAPE AREA AND MINIMUM OF 5-0 FROM ALL STRUCTURES, DEPENDING ON SPECIES AND LENGTH OF PALM FROND 26. ALL PLANTS SHALL BE PLANTED AT SOIL LEVELS AT WHICH THEY WERE PREVIOULSY GROWN. SHRUB AND HEDGE MATERIAL SHALL BE PLANTED A MIN. 2 AWAY FROM WALLS OR OTHER OBSTRUCTIONS, MATERIAL WITH A MATURE SIZE GREATER THAN ANY OVERHANGS SHALL BE PLANTED AWAY FROM OVERHANGS SO AS NOT TO IMPEDE THE NATURAL GROWTH HABIT. SABAL PALMS ARE TO BE PLANTED DIRECTLY IN SAND. IF NECESSARY, EXCAVATE THROUGH ANY COMPACTED BUILDING SUBGRADE TO UNDISTURBED SOIL AND BACKFILL WITH PLANTING SOIL, BEFORE PLANTING ALL PLANTING BEDS SHALL BE FREE OF DEBRIS AND ROADROCK. REMOVAL OF DEBRIS AND ROADROCK SHALL EXTEND TO A DEPTH OF 30 INCHES BELOW FINISHED GRADE.

27. ALL PLANT MATERIAL SHALL BE WATERED THOROUGHLY AFTER INSTALLATION SO AS TO REMOVE ALL AIR POCKETS, B & B MATERIAL SHALL BE WATERED EVERYDAY FOR A MINIMUM ONE WEEK PERIOD AND THEREAFTER SO AS TO KEEP CONTINUALLY MOIST UNTIL FINAL ACCEPTANCE OF THE LANDSCAPE INSTALLATION. CONTRACTOR SHALL NOTIFY OWNER OF OTHER WATERING REQUIREMENTS AFTER INSTALLATION.

28. ALL LANDSCAPE AND SOD AREAS SHALL HAVE AN AUTOMATIC UNDERGROUND IRRIGATION SYSTEM INSTALLED. SYSTEM SHALL BE DESIGNED TO HAVE A MIN, 110% COVERAGE WITH A MIN, 50% OVERLAP FROM A RUST FREE WATER SOURCE, THE IRRIGATION SYSTEM SHALL BE INSTALLED WITH A RAIN-SWITCH DEVICE THAT SHALL BE MOUNTED ACCORDING TO FLORIDA BUILDING CODE APPENDIX F. ALL IRRIGATION SHALL MINIMIZE SPRAY UPON PUBLIC SIDEWALKS, STREETS AND ADJACENT PROPERTIES, SODDED AREAS AND SHRUB/GROUNDCOVER BEDS SHOULD BE ON SEPARATE IRRIGATION ZONES FOR A MORE EFFICIENT SYSTEM

SITEWORK GENERAL NOTES

1. THE GENERAL CONTRACTOR SHALL BE RESPONSIBLE FOR COORDINATING ALL WORK BY THE SUBCONTRACTORS. 2. CONTRACTOR SHALL VERIFY ALL CONDITIONS AT JOB SITE AND NOTIFY LANDSCAPE ARCHITECT AND GENERAL CONTRACTOR OF DIMENSIONAL ERRORS, OMISSIONS OR

DISCREPANCIES BEFORE BEGINNING ANY WORK. 3. CONTRACTOR TO OBTAIN ALL NECESSARY PERMITS PRIOR TO CONSTRUCTION. ALL CONTRACTORS MUST COMPLY WITH PERMIT REQUIREMENTS, LOCAL, STATE AND FEDERAL JURISDICTIONS AND GOVERNING BODIES/AGENCIES RULES AND REGULATIONS

AND LAND USE APPROVAL CONDITIONS AT ALL TIMES. 4. WORK PERFORMED WITHOUT APPROVAL OF LOCAL, STATE AND FEDERAL JURISDICTIONS AND GOVERNING BODIES/AGENCIES AND/OR NOT IN COMPLIANCE WITH

SPECIFICATIONS AND/OR DRAWINGS IS SUBJECT TO REMOVAL AT CONTRACTOR'S

5. ALL WORK SHALL CONFORM TO THE APPROPRIATE AGENCIES. CONTRACTOR SHALL VERIFY LOCATION OF ALL EXISTING UTILITIES. LINES AND STRUCTURES PRIOR TO EXCAVATION OF TRENCHING DAMAGE SHALL BE REPAIRED BY THE CONTRACTOR AT NO 13 PROVIDE SLEEVES AS REQUIRED FOR DRAINAGE. IRRIGATION AND FLECTRICAL COST TO THE OWNER. THE LANDSCAPE ARCHITECT ASSUMES NO RESPONSIBILITY FOR UTILITIES OR STRUCTURES NOT SHOWN ON THE DRAWINGS. CONTRACTOR IS TO VERIFY THE EXACT LOCATION OF UTILITIES PRIOR TO CONSTRUCTION AND NOTIFY THE LANDSCAPE ARCHITECT OF ANY DISCREPANCIES. CONTRACTOR SHALL USE EXTREME CAUTION WHEN WORKING OVER OR NEAR EXISTING GAS AND ELECTRICAL LINES. 6. THE CONTRACTOR SHALL BE RESPONSIBLE FOR RESETTING ALL LAND MONUMENTS DISRUPTED BY CONSTRUCTION ACTIVITIES OR NEGLIGENCE ON THE PART OF THE CONTRACTOR RESETS SHALL BE PERFORMED UNDER THE SUPERVISION OF A REGISTERED LAND SURVEYOR AND MONUMENT RECORDS MUST BE FILED AS REQUIRED BY STATUTE FOR ALL MONUMENTS.

7 THE CONTRACTOR SHALL TAKE ALL PRECAUTIONARY MEASURES NECESSARY TO PROTECT EXISTING IMPROVEMENTS FROM DAMAGE AND ALL SUCH IMPROVEMENTS AND STRUCTURES DAMAGED BY THE CONTRACTOR'S OPERATIONS SHALL BE REPAIRED OR RECONSTRUCTED SATISFACTORY TO THE LANDSCAPE ARCHITECT AT THE CONTRACTOR'S EXPENSE

8. ALL BARRICADING AND TEMPORARY TRAFFIC CONTROL DEVICES OR METHODS USED OFF-SITE OR IN DESIGNATED WASH-OUT AREAS DETERMINED BY THE GENERAL DURING CONSTRUCTION SHALL BE IN ACCORDANCE WITH LOCAL. STATE AND FEDERAL CONTRACTOR.

JURISDICTIONS AND GOVERNING BODIES/AGENCIES STANDARDS. PROVIDE ADEQUATE TIME FOR REVIEW AND APPROVAL BY THE ABOVE JURISDICTIONS PRIOR TO COMMENCEMENT

9. THE LANDSCAPE ARCHITECT IS NOT RESPONSIBLE FOR THE CONSTRUCTION MEANS, METHODS, TECHNIQUES, SEQUENCES UTILIZED OR FOR SAFETY PRECAUTIONS OR PROBLEMS IN CONNECTION WITH THE WORK. THE LANDSCAPE ARCHITECT WILL NOT BE RESPONSIBLE FOR THE CONTRACTOR'S FAILURE TO CARRY OUT THE WORK IN ACCORDANCE WITH THE CONTRACT DOCUMENTS. CONTRACT DOCUMENTS INCLUDE THE CONSTRUCTION DOCUMENT DRAWING SET/TECHNICAL SPECIFICATIONS MANUAULASIS. 10. CONTRACTOR TO VERIFY ALL QUANTITIES. IN CASE OF ANY DISCREPANCIES, GRAPHICALLY SHOWN MATERIAL QUANTITIES SHALL TAKE PRECEDENCE. 11. A SYSTEM OF DIAGRAMMATIC SYMBOLS, HATCHES AND NOTATIONS IS USED IN THESE DRAWINGS, REVIEW NOTATIONS CAREFULLY, NOTIFY LANDSCAPE ARCHITECT

AND REQUEST CLARIFICATION OF ANY UNCLEAR NOTATION OR DISCREPANCY PRIOR TO COMMENCING WORK.

LINES. IRRIGATION AND ELECTRICAL SLEEVES AND SUBSURFACE DRAINAGE SYSTEMS SHALL BE CONSTRUCTED PRIOR TO PAVING AND LANDSCAPE WORK, UTILITY SLEEVES ARE REQUIRED IN ALL PLANT BEDS ISOLATED BY PAVEMENT OR ANY OTHER STRUCTURES.

14. SPECIAL CONSIDERATION IS GIVEN TO THE DESIGN AND INTENDED RELATIONSHIP BETWEEN ARCHITECTURE, PLANTING AREAS AND PAVING SYSTEMS. PAVEMENT JOINTING, PAVERS, STONE, FINISHES AND GRADES HAVE BEEN STRICTLY COORDINATED IN THE CONTRACT DOCUMENTS, CONSTRUCTION OF THESE SYSTEMS SHALL BE STRICTLY COORDINATED

15. VEHICLES, EQUIPMENT, AND/OR MATERIALS SHALL NOT BE PARKED OR STORED IN AREAS OF EXISTING VEGETATION. INCLUDING WITHIN THE DRIPLINE OF EXISTING TREES. TO REMAIN.

16. CONSTRUCTION WASTE-INCLUDING BUT NOT LIMITED TO: PLANT MATERIAL BUILDING MATERIALS, DEMOLISHED MATERIALS, PACKAGING, LEFTOVER PAINT AND CONCRETE SLURRY-SHOULD BE PROPERLY REUSED, RECYCLED, DISPOSED OF LEGALLY

17. RECYCLING AND TRASH BINS TO BE PROVIDED ON SITE, SEPARATE BINS FOR CARDROARD, CO-MINGLED, AND OTHER RECYCLARI E/RELISABLE MATERIALS. IDENTIFIED BY THE LOCAL JURISDICTION SHALL BE MAINTAINED. ALL BINS TO BE WILDLIFE-PROO

18. ON-SITE FUEL STORAGE FOR CONSTRUCTION FOUIPMENT IS DISCOURAGED. CONSTRUCTION EQUIPMENT USED ON SITE TO BE CHECKED REGULARLY TO ASSURE CONTAMINATION CONCERNS FROM OILS AND GREASES ARE ELIMINATED. NO TOXIC MATERIALS SHALL BE STORED ON-SITE.

19. GENERAL CONTRACTOR TO KEEP ALL ITEMS IMPLEMENTED BY LANDSCAPE 20. THE CONSTRUCTION SITE TO BE INSPECTED ON A MONTHLY BASIS BY LANDSCAPE ARCHITECT AND/OR CIVIL ENGINEER TO ASSURE THAT THE SILT FENCE AND MUD TRACKING PAD ARE PROPERLY IN PLACE AND FUNCTIONING AS DESIGNED. 21. GREEN BUILDING PRACTICES SHALL BE EMPLOYED TO THE EXTENT FEASIBLE. SUCH PRACTICES INCLUDE: CARPOOLING/VANPOOLING TO JOB SITE. MINIMIZING MATERIALS PACKING BEFORE ARRIVAL TO JOB SITE, REDUCING MATERIAL / RESOURCE INEFFICIENCIES BY COORDINATING WORK.

22. THE PROJECT LIMIT OF CONSTRUCTION AND ALL EXISTING VEGETATION TO REMAIN IS TO BE CLEARLY DEFINED BY STURDY, WEATHERPROOF FENCING AT A MINIMUM OF FOUR (4) FEET HIGH. 23. WATERPROOFING OF SUBGRADE AND OTHER ARCHITECTURAL SPACES BELOW AND/OR ADJACENT TO IMPROVEMENTS DESIGNED BY THE LANDSCAPE ARCHITECT IS TO BE ADEQUATELY DESIGNED AND DETAILED BY OTHERS TO PERMANENTLY REPEL ALL WATER SOURCES INCLUDING. BUT NOT LIMITED TO: PRECIPITATION, STORM WATER RUNOFF, GROUND WATER, IRRIGATION, ROOF

RUNOFF, GROUND WATER, AND PLUMBING LEAKS. 24. Structural design to support improvements designed by the landscape ARCHITECT AND LOCATED ABOVE, BELOW, AND/OR ADJACENT TO SUBGRADE AND OTHER ARCHITECTURAL SPACES IS THE RESPONSIBILITY OF THE STRUCTURAL ENGINEER. THE STRUCTURAL DESIGN SHOULD BE ADEQUATELY DESIGNED TO SUPPORT ALL POSSIBLE LOADS INCLUDING, BUT NOT LIMITED TO: BACKFILL, COMPACTION, PLANTINGS, HARDSCAPES, RETAINING AND FREESTANDING SITE WALLS, AND CONSTRUCTION MATERIALS/EQUIPMENT/ACTIVITY.

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621 WEST 44TH STREET MIAMI BEACH, FLORIDA 33140

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GRADING LEGEND:

EXISTING SPOT ELEVATION PROPOSED SPOT ELEVATION / NOTE +0.00

LP / HP TW / BW TR / BR TS / BS \wedge (+0.00) LOW POINT / HIGH POINT TOP OF WALL / BOTTOM OF WAL TOP OF RAMP/ BOTTOM OF RAMP

TOP OF STEP/ BOTTOM OF STEP SLOPE DIRECTION

EXISTING CONTOUR LINE

PROPOSED CONTOUR LIN

SHALLOW RETENTION AREA

LANDSCAPE ABBREVIATIONS:

PLANTING ABBREVIATIONS GENERAL ABBREVIATIONS

B&B Cal. C.T. Crz F.G. Gal. G.W. HT.	CALIPER CLEAR TRUNK CRITICAL ROOT ZONE FIELD GROWN GALLON GREY WOOD	BLDG. B.O.C. CJ CLR EJ EQ FFE F.O.B.	BACK OF CURB Control Joint Clear Expansion Joint Equal Finish Floor Elevation
MAX.			LANDSCAPE ARCHITECT Limit of construction
QTY. Sprd Typ. U.N.O.	SPREAD	MAX. N.I.C. O.C.	MINIMUM Maximum Not in contract on center
		PA. QTY. R.O.W. SIM. TD T.O.C. TW	QUANTITY RIGHT OF WAY SIMILAR DETAIL TOP OF DRAIN TOP OF CURB TOP OF WALL TYPICAL




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Sheet Title: GENERAL NOTES. ABBREVIATIONS + PLANTING SPECIFICATIONS SHEET

LC-002



COASTAL OPERATIONS LANDSCAPE ARCHITECTURE LLC

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Sheet Title:

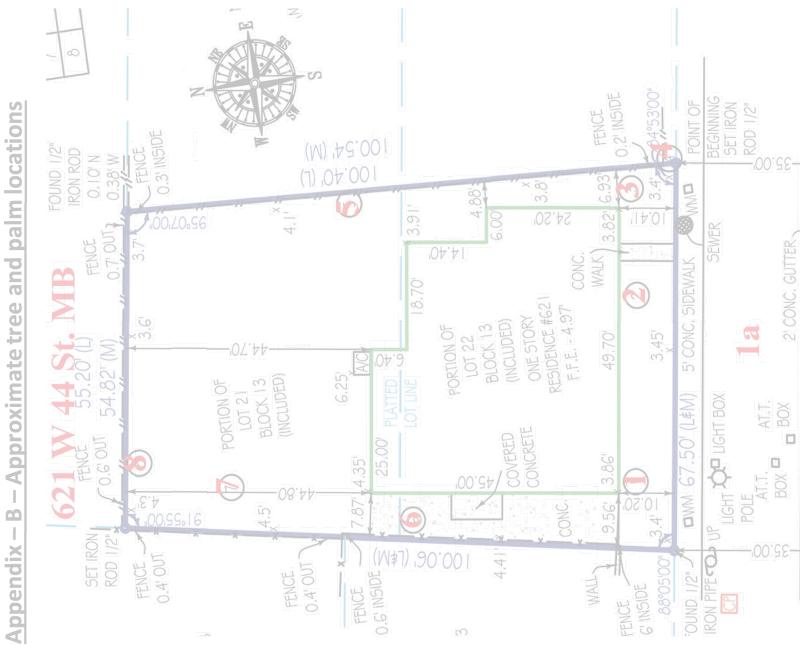EXISTING TREE SURVEY



" 8' 16' SCALE: 1/8"=1'-0"





1

L

N

S

7

4

4


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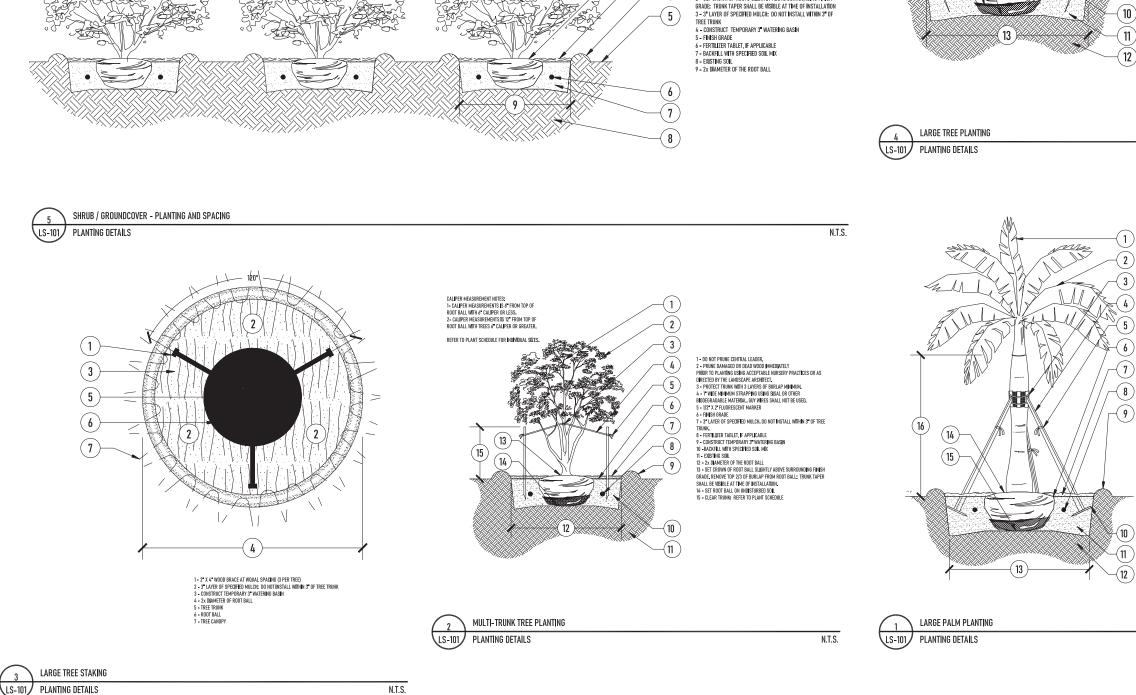
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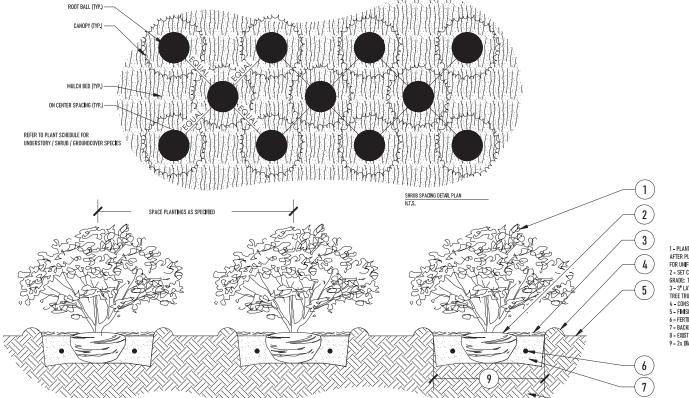
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Page 19


621 W 44th Street, Miami Beach Tropical Designs of Florida





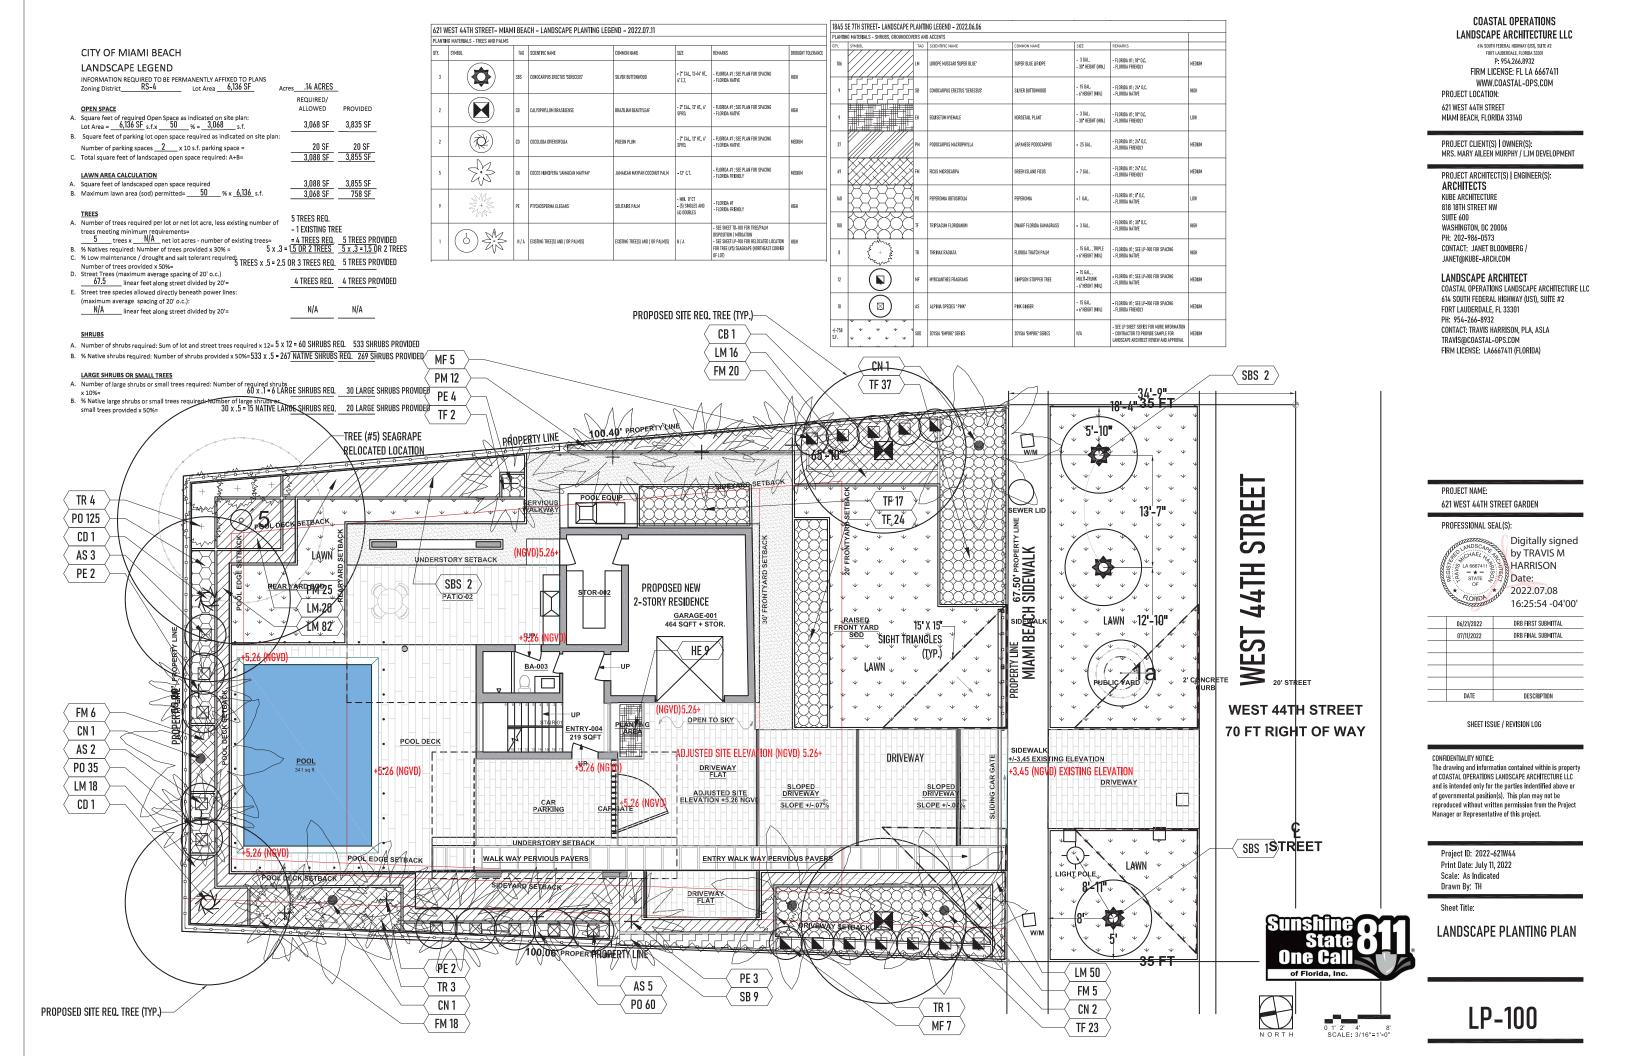

1 - PLANT MATERIAL SHALL NOT BE PRUNED PRIOR TO INSTALLATION: AFTER PLANTS HAVE BEEN INSTALLED, EACH PLANT SHALL AIDR FOR UNIFORMITY OR AS DIRECTED BY THE LANDSCAPE ARCHITECT 2 - SET CROWN OF ROOTS SLIGHTLY ABOVE SURROUNDING FINISH

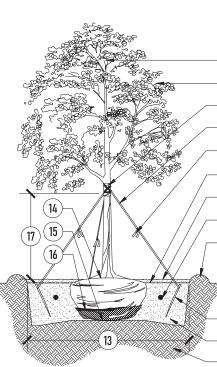

COASTAL OPERATIONS LANDSCAPE ARCHITECTURE LLC

514 SOUTH FEDERAL HIGHWAY (US1), SUITE #2 Fort Lauderdale, florida 33301 P: 954.266.8932 FIRM LICENSE: FL LA 6667411 WWW.COASTAL-OPS.COM PROJECT LOCATION:

621 WEST 44TH STREET MIAMI BEACH, FLORIDA 33140

PROJECT CLIENT(S) | OWNER(S): MRS. MARY AILEEN MURPHY / LJM DEVELOPMENT

PROJECT ARCHITECT(S) | ENGINEER(S):

ARCHITECTS KUBE ARCHITECTURE 818 18TH STREET NW SUITE 600 WASHINGTON, DC 20006 PH: 202-986-0573 CONTACT: JANET BLOOMBERG / JANET@KUBE-ARCH.COM

LANDSCAPE ARCHITECT

COASTAL OPERATIONS LANDSCAPE ARCHITECTURE LLC 614 SOUTH FEDERAL HIGHWAY (US1), SUITE #2 FORT LAUDERDALE, FL 33301 PH: 954-266-8932 CONTACT: TRAVIS HARRISON, PLA, ASLA TRAVIS@COASTAL-OPS.COM FIRM LICENSE: LA6667411 (FLORIDA)

N.T.S.

PROJECT NAME: 621 West 44th street garden					
PROFESSIONAL SEAL(S):					
A NDSCI A	Digitally signed				
PAR CHAEL N. 2	👌 by TRAVIS M				
5 S LA 6667411	HARRISON				
SO LA 6667411 A	S Date:				
At	2022.07.08				
AZORIDA CORIDA	13:57:27 -04'00'				
06/21/2022	DRB FIRST SUBMITTAL				
07/11/2022	DRB FINAL SUBMITTAL				
DATE	DESCRIPTION				

SHEET ISSUE / REVISION LOG

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Project ID: 2022-621W44 Print Date: July 11, 2022 Scale: As Indicated Drawn By: TH

Sheet Title:

LANDSCAPE PLANTING DETAILS



LP-101

- 8 FERTILIZER TABLET, IF APPLICABLE 9 Construct Temporary 3" Watering Basin 10 -2" X 4" X 8" Stake: Set 2" Below Finish Grade 11 - SPECIFIED SOIL MIX 12 - Existing Soil 13 - 2x diameter of the root Ball

TRUNK

- 14 SET CROWN OF ROOT BALL SLIGHTLY ABOVE SURROUNDING FINISH GRADE. REMOVE TOP 2/3 OF BURLAP FROM ROOT BALL: TRUNK TAPER
- SHALL BE VISIBLE AT TIME OF INSTALLATION.

2 - PRUNE DAMAGED OR DEAD WOOD IMMEDIATELY PRIOR TO PLANTING USING ACCEPTABLE NURSERY PRACTICES OR AS

6 - FINISH GRADE 7 - 3" Layer of specified Mulch. Do not install within 3" of tree

3 - PROTECT TRUNK WITH 3 LAYERS OF BURLAP MINIMUM. 4 - T WIDE MINIMUM STRAPPING USING SISAL OR OTHER BIODEGRADABLE MATERIAL GUY WIRES SHALL NOT BE USED.

1 - DO NOT PRUNE CENTRAL LEADER.

DIRECTED BY THE LANDSCAPE ARCHITECT.

5 - 1/2" X 2" FLUORESCENT MARKER

- 15 SET ROOT BALL ON UNDISTURBED SOIL 16 REMOVE 2/3 OF BURLAP / WIRE BASKET FROM ROOT BALL
- 17 CLEAR TRUNK: REFER TO PLANT SCHEDULE

(10) [^]11

12


- TERMINAL BUD / FROND
- 1 TERMINAL BUD / FROND 2 UMTEF RONDS PROTO TURSECTION 3 METAL STRAPS SECURING 2* X4 "WOOD BATTENS, MMMANIM 5 LAYERS OF RURKAY TO PAN LA BRACES TO 2* X4 "WOOD BATTENS, DO NOT MAL STARES DIRECTLY INTO TRUM, 4 2* X4 "WOOD BACK AT EDUILA SPACING (3 PER PALM) 5 V/2* XX OF RUGRESCENT MARKER

- FINISH GRADE 3" Layer of specified mulch, do not install within 3" of tree

- T- VERE OF SPECIFIED MULLI, DO NOT INSTALL WITHIN 3" OF TREE TRUNK.
 FRETHLICK TABLET, F- APPLEABLE
 CONSTRUCT ENDORARY 3" WATERING BASIN
 2. CONSTRUCT ENDORARY 3" WATERING BASIN
 2. ACKILL WITH SPECIFIED DO. MAL
 2. BACKFLL WITH SPECIFIED DO. MAL
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621 WES	621 WEST 44TH STREET – MIAMI BEACH – LANDSCAPE MATERIALS LEGEND – 2022.07.11					
SITE WORK MATERIALS						
QTY.	SYMBOL	TAG	NAME	SIZE	REMARKS	
+/-1,273 S.F.		P.1	- DRIVEWAY: 2ª THICK (5cm) PORCELAIN PAVER SET on Sand with Linear Led In-grade Lights - Permeable Paving	- SEE LS-100 FOR LAYOUT AND DIMENSIONS - SEE LS SHEET SERIES FOR MORE INFORMATION	– CONTRACTOR TO PROVIDE SAMPLE FOR LANDSCAPE Architect review and approval	
+/-660 S.F.		P.2	– POOL DECK: 3/4" THICK (2cm) PORCELAIN PAVERS Set on Sand – Permeable Paving	- SEE LS-100 FOR LAYOUT AND DIMENSIONS - SEE LS SHEET SERIES FOR MORE INFORMATION - Pool DECK - (L)x(W)x(H): TO BE DETERMINED - Pool Coping - (L)x(W)x(H): TO BE DETERMINED	- CONTRACTOR TO PROVIDE SAMPLE FOR LANDSCAPE Architect Review and Approval	
+/-462 S.F.		P.3	– CRUSHED GRAVEL: GRANITE CHIP (DARK GREY) – Permeable Paying	- SEE LS-100 FOR LAYOUT AND DIMENSIONS - 1/4" minus, 3" depth with filter Fabric (Uninoven)	- SEE LS SHEET SERIES FOR MORE INFORMATION - Edde restraint detal: to be deternined - Contractor to provide sample for landscape Architect Review and Approval	
+/-340 S.F.		POOL	SWIMMING POOL: - Pool Coping, finish and water line tile (TBD)	- SEE LS SHEET SERIES FOR MORE INFORMATION	- SEE LP SHEET SERIES FOR MORE INFORMATION - Contractor to provide sample for lanoscape Architect Review and Approval	
+/-758 S.F.	+ + + + + + + + + + + + + +	SOD	– ZOYSIA 'EMPIRE' SPECIES	– ZOYSIA YEMPIRE' SPECIES	- SEE LP SHEET SERIES FOR MORE INFORMATION - Contractor to provide sample for landscape Architect Review and Approval	
+/-1,206 S.F.		PLA	- LANDSCAPE PLANTING AREA	- LANDSCAPE PLANTING AREA	- SEE LP SHEET SERIES FOR MORE INFORMATION	

QTY: 5		ប	– LINEAR, IN-GRADE, LED LIGHTS – DRIVEWAY	- SEE LS SHEET SERIES FOR MORE INFORMATION	- SEE LS SHEET SERIES FOR MORE MFORMATION - Contractor to provide sample for landscape Architect Review and Approval
ENTIRE SITE Perimeter Fencing	0	F.1	– CUSTOM PEDESTRIAN FENCE – Powder Coated Aluminum Post/Rail – Color / Finish: To Match Architecture	- SEE LS SHEET SERIES - HEIGHT: TBD (MN, 48°) - To convort with florida Bullding Code For Residential Swimwing Pool Barrier Redurements, Sections R45017 Through R450177.3	– SEE LS SHEET SERIES FOR MORE INFORMATION – Contractor to provide shop drawings for client and Landscape architect renew and approval
1 VEHICULAR Sliding gate (driveway)	P	F.2	– CUSTOM VEHICULAR SLIDING GATE – Automant, Self-Alosma, Self-Aatching – Powder Catal Juminum Postral – Color / Finsh: to match architecture	- SEE LS SWEET SERIES - HEIGHT: TBD (MNL 48°) - To condraw with florida Building Code For Residential Swidwing Pool Barrier Redurements, Sections Rasol't Through Rasol17.3	- SEE LS SHEET SERIES FOR MORE INFORMATION - Contractor to provide shop drawings for client and Landscape architect renew and approval
+/-152 Linear feet		W.1	- RETAINING WALL (TO BE ENGINEERED) With Alumanian Vertical Picket Fence Fixed to Wall, (F.1) - Fence Color / Finish: To Match Architecture	- SEE LS SHEET SERIES - TOP OF FRICE HEIGHT. 48" MINIMUM HEIGHT Above Aduitsfor Grade - To Comform with Florida Building Code For Residential Sympanyig Pool Barrier Redurements, Sections R4501/7 Through R4501/7.3	- SEE LS SHEET SERIES FOR MORE INFORMATION - Contractor to provide shop drawings for client and Landscape architect renew and approval
+/-102 Linear feet		W.2	- VINYL SHEET PILE RETAINING WALL - For site adjusted grade: +/-1.87 of elevation Change to adjacent properties	- SEE LS SHEET SERIES	- SEE LS SHEET SERIES FOR MORE INFORMATION - Contractor to provide shop drawings for client and Landscape architect review and approval

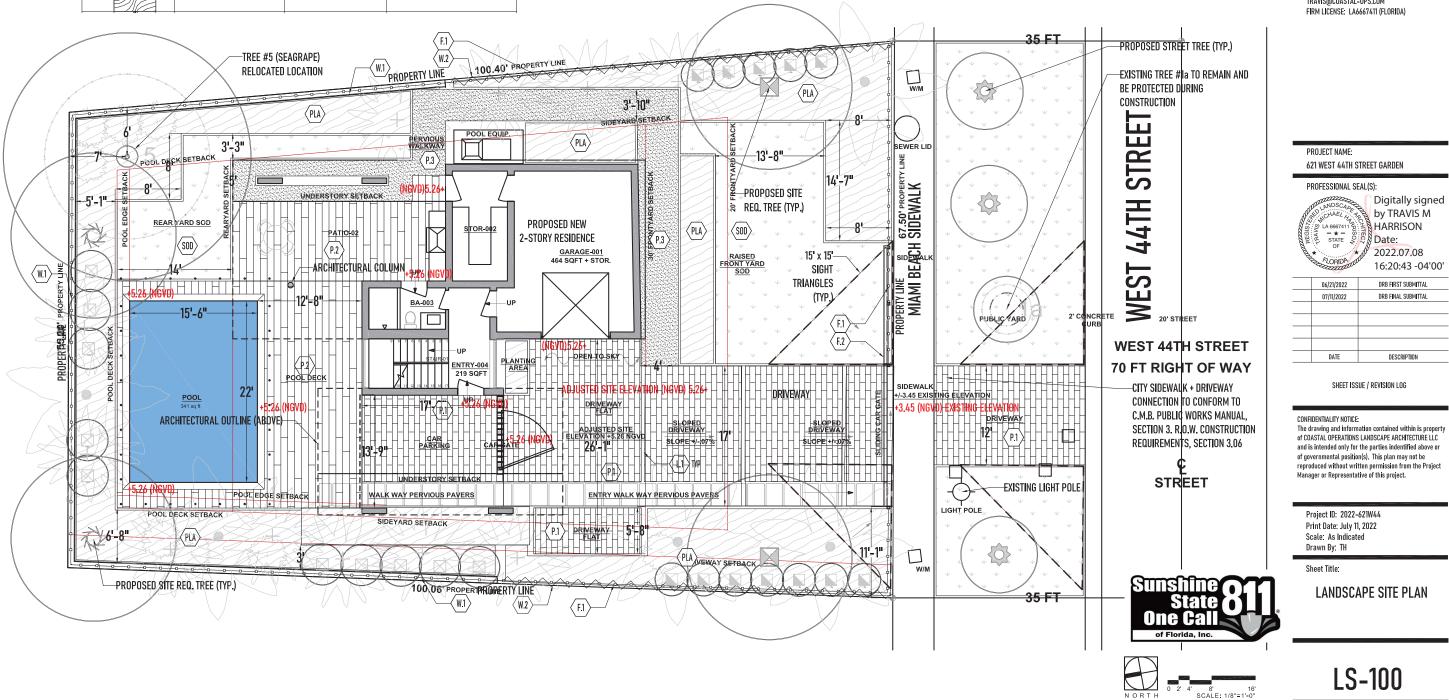

COASTAL OPERATIONS LANDSCAPE ARCHITECTURE LLC

AK SOUTH FEIREAL HIGHWAY USET, SUITE #2 FORT LUNERBALE, FLOREDA 33001 P: 954.266.8932 FIRM LICENSE: FL LA 6667411 WWW.COASTAL-OPS.COM PROJECT LOCATION: 621 WEST 46TH STREFT

621 WEST 44TH STREET Miami Beach, Florida 33140


PROJECT CLIENT(S) | OWNER(S): MRS. MARY AILEEN MURPHY / LJM DEVELOPMENT

PROJECT ARCHITECT(S) | ENGINEER(S) ARCHITECTS KUBE ARCHITECTURE

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TREE DISPOSITION SCHEDULE - 621 WEST 44TH STREET CANOPY DBH HEIGHT/C.T. CONDITION DISPOSITION COMMON NAME / BOTANICAL NAME TP7 SPREAD BURSERA SIMARUBA / GUMBO LIMBO 28 GOOD REMOVE CONOCARPUS ERECTUS VAR. SERICEUS 13' GOOD REMAIN SILVER BUTTONWOOD BOUGAINVILLEA SP. / BOUGAINVILLEA 20' GOOD REMOVE 10' DYPSIS LUTESCENS / ARECA PALM MODERATE REMOVE FICUS BENJAMINA / WEEPING FIG 15ª 28' 24 POOR REMOVE 31" 20' 30' COCCOLOBA UVIFERA / SEAGRAPE GOOD RELOCATE GOOD REMOVE SABAL PALMETTO / SABAL PALM MANILKARA ZAPOTA / SAPODILLA 33" 40' 45 POOR REMOVE MANILKARA ZAPOTA / SAPODILLA 6 18' 25' GOOD REMOVE

VEGETATION MITIGATION CALCULATIONS PER CITY OF MIAMI BEACH REQUIREMENTS

TOTAL DIAMETER OF TREE(S) TO BE REMOVED = +/-72" 72" = 24 NEW 2" DBH x 6' SPRD x 12' HEIGHT TREES OR 12 NEW 4" DBH x 8' SPRD x 16' HEIGHT TREES OR A C.M.B. TREE FUND PAYMENT OF +/-\$24,000 USD.
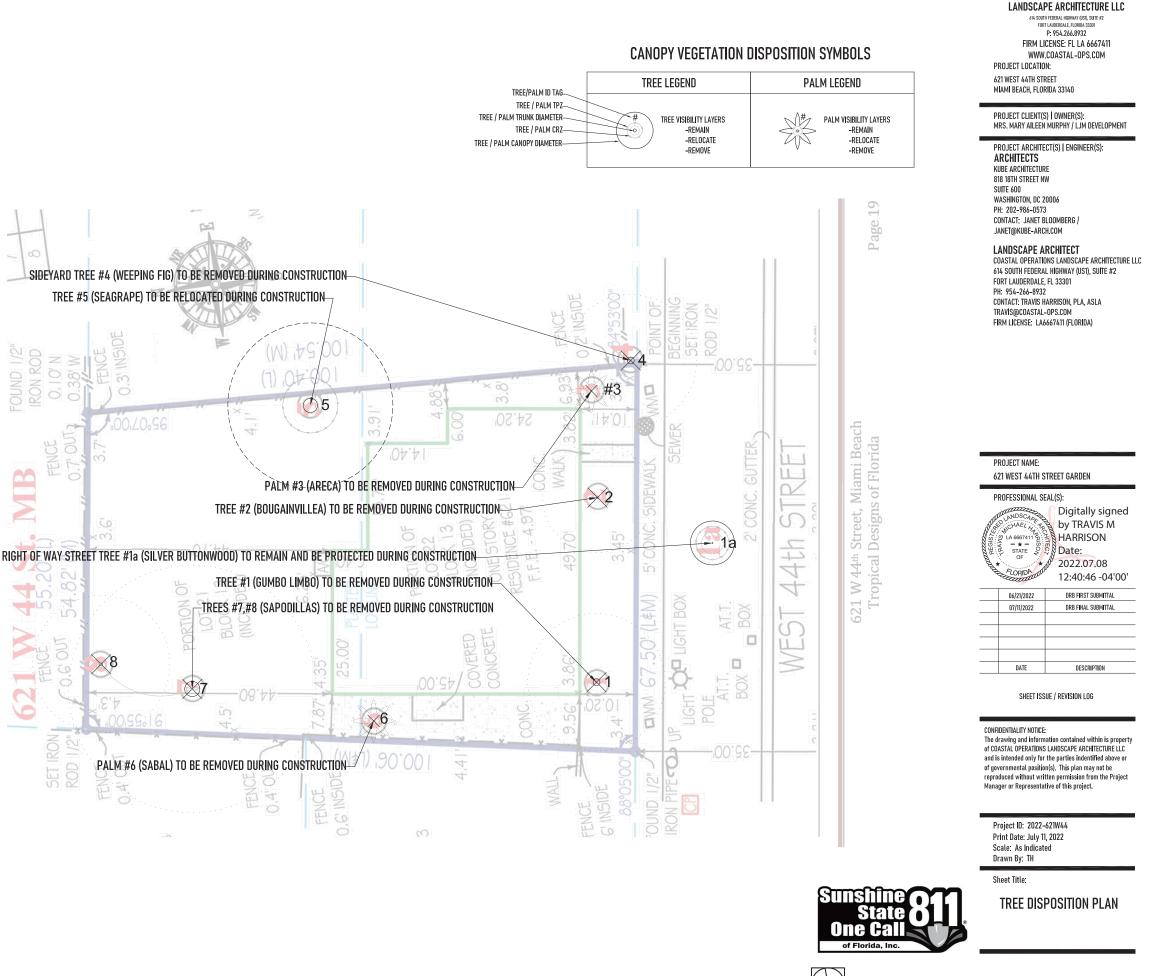
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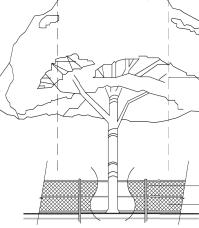
COASTAL OPERATIONS

SCALE: 1/8"=1'-0



C.M.B. TREE / PALM PROTEC. DETAIL

PROTECTION DETAIL NOTE: CONTRACTOR TO INSTALL TREE/PALM PROTECTION FENCE BARRIERS' AROUND ALL EXISTING TREES OR PALMS AT THE START OF THE PROJECT. BARRIERS TO REMAIN IN PLACE THROUGHOUT THE DURATION OF THE PROJECT AND SHOULD NOT BE REMOVED OR DOROPPED FOR ANY REASON WITHOUT AUTHORIZATION FROM THE CITY OF MIAMI BEACH URBAN FORESTER + PLANNING + ZONING DEPARTMENT



NO ACTIVITY OR DISTURBANCE SHOULD OCCUR WHITHIN THE FENCED AREAS, INCLUDING VEHICLE USE, STORAGE OF MATERIALS, DURNING OF LIQUIDS OR MATERIALS, GRADE CHANGES, GRUBBING, AND MECHANICAL TRENCHING FOR IRRIGATION, ELECTRICAL, LIGHTING, FLC.

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PROJECT ARCHITECT(S) | ENGINEER(S):

ARCHITECTS KUBE ARCHITECTURE 818 18TH STREET NW SUITE 600 WASHINGTON, DC 20006 PH: 202-986-0573 Contact: Janet Bloomberg / JANET@KUBE-ARCH.COM

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Project ID: 2022-621W44 Print Date: July 11, 2022 Scale: As Indicated Drawn By: TH

Sheet Title:

TREE PROTECTION DETAILS

TREE/ PALM PROTECTION FENCES SHALL BE CONSTRUCTED PRIOR TO ANY CONSTRUCTION ACTIVITY INCLUDING GRUBBING FOR ALL TREES/PALMS THAT ARE 'TO REMAIN, BE PROTECTED OR BE RELOCATED'

TREE + PALM PROTECTION BARRIERS TO EXTEND BEVOND THE 'DRIPINE' OR TO THE 'CRITICAL ROOT ZONE AREA' OF ALL TREES/PALMS TO BE PROTECTED. EXTEND WHERE NECESSARY TO PROTECT TREE CANOPY ROOTS

IN NO CASE SHALL THE FENCE BE INSTALLED LESS THAN TEN FEET FROM THE TRUNK

BARRIERS SHALL BE A MINIMUM OF FOUR FEET HIGH, AND SHALL BE CONSTRUCTED OF CONTINUOUS CHAIN LINK FENCE WITH METAL POSTS AT EIGHT-FOOT SPACING OR 2*x4" POSTS WITH THREE EQUALLY SPACED 2*x4" RAILS, POSTS MAY BE SHIFTED TO AVOID ROOTS.





TD-101