
ONE ISLAND PARK DRB FINAL SUBMITTAL

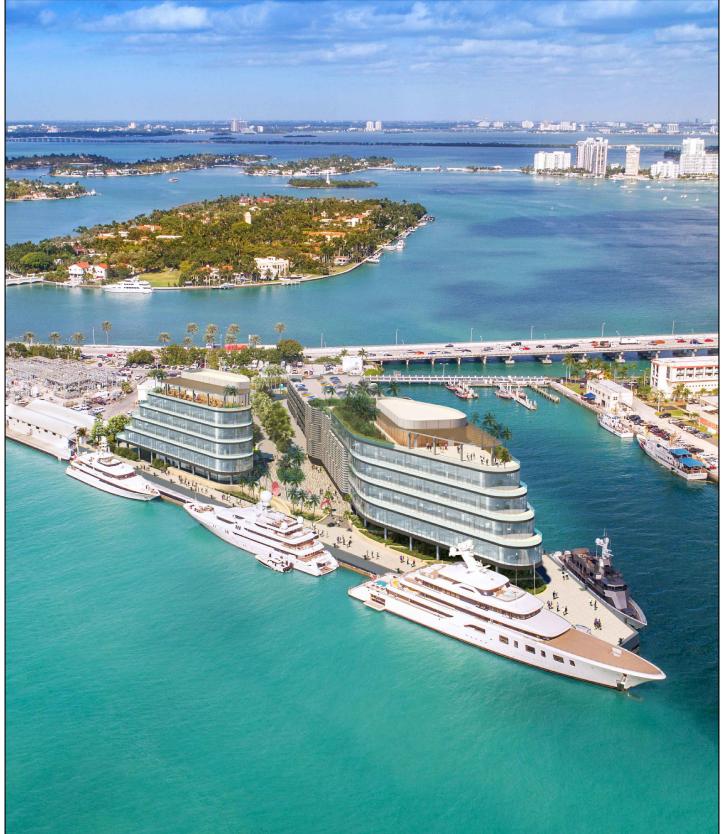


SHEET LIST	
SHEET NAME	SHEET NUMBER
ARCHITECTURAL	
COVER	A0-00
SURVEY	A0-01
LOCATION MAP	A0-02
ZONING DATA	A0-03
CONTEXT - AERIAL VIEWS	A0-04
CONTEXT STUDY	A0-05
CONTEXT STREET AND AERIAL VIEWS	A0-06
SITE PLAN	A0-07
PROJECT DATA	A0-08
OVERALL OFFICE BUILDINGS LOWER LEVEL - FAR	A0-09
OVERALL OFFICE BUILDINGS LEVEL 01 - FAR	A0-10
OVERALL OFFICE BUILDINGS LEVEL 02 - FAR	A0-11
OVERALL OFFICE BUILDINGS LEVEL 03 - FAR	A0-12
OVERALL OFFICE BUILDINGS LEVEL 04 - FAR	A0-13
OVERALL OFFICE BUILDINGS LEVEL 05 - FAR	A0-14
OVERALL OFFICE BUILDINGS LEVEL 06 - FAR	A0-15
OVERALL OFFICE BUILDINGS ROOF LEVEL - FAR	A0-16
SITE ENTRANCE LEVEL 01 - FAR	A0-17
SITE ENTRANCE ROOF LEVEL - FAR	A0-18
LOT COVERAGE OPEN SPACE DIAGRAM	A0-19
RENDERED SITE PLAN	A1-00
RENDERED SITE PLAN ENTRANCE AREA	A1-00a
OVERALL OFFICE BUILDINGS LOWER LEVEL	A1-01
OVERALL OFFICE BUILDINGS LEVEL 01	A1-02
OVERALL OFFICE BUILDINGS LEVEL 02	A1-03
OVERALL OFFICE BUILDINGS LEVEL 03	A1-04
OVERALL OFFICE BUILDINGS LEVEL 04	A1-05
OVERALL OFFICE BUILDINGS LEVEL 05	A1-06
OVERALL OFFICE BUILDINGS LEVEL 06	A1-07
OVERALL OFFICE BUILDINGS ROOF LEVEL	A1-08
RENDERED ROOF PLAN	A1-09
SITE ENTRANCE LEVEL 01	A1-10
SITE ENTRANCE ROOF LEVEL	A1-11
PARKING GARAGE LEVEL 01	A1-13
PARKING GARAGE LEVEL 02	A1-14
PARKING GARAGE LEVEL 03	A1-15
PARKING GARAGE LEVEL 04	A1-16
PARKING GARAGE LEVEL 05	A1-17
PARKING GARAGE LEVEL 06	A1-18

SHEET LIST	
SHEET NAME	SHEET NUMBER
MACARTHUR CAUSEWAY ACCESS PLAN	A1-19
PEDESTRIAN PATH PLAN	A1-20
TRASH OPERATION PLAN	A1-21
LOADING OPERATION PLAN	A1-22
TYPICAL TRUCK MANEUVERING DIAGRAMS	A1-23
MANEUVERING DIAGRAM SU-30 TRUCK	A1-24
MANEUVERING DIAGRAM SU-30 TRUCK	A1-24B
MANEUVERING DIAGRAM SU-30 TRUCK	A1-25
MANEUVERING DIAGRAM FIRE TRUCK	A1-26
MANEUVERING DIAGRAM PASSENGER VEHICLE	A1-27
EAST ELEVATION	A2-01
EAST ELEVATION RENDERED	A2-02
NORTH ELEVATION	A2-03
NORTH ELEVATION RENDERED	A2-04
WEST ELEVATION	A2-05
WEST ELEVATION RENDERED	A2-06
SOUTH ELEVATION	A2-07
SOUTH ELEVATION RENDERED	A2-08
NORTH-EAST ELEVATION	A2-09
NORTH EAST ELEVATION RENDERED	A2-10
SIGNAGE ELEVATION	A2-11
SIGNAGE ELEVATION - RENDERED	A2-12
ROOF DECK SOUTH ELEVATIONS	A2-13
ROOF DECK SOUTH ELEVATIONS RENDERED	A2-14
GROUND LEVEL SOUTH ELEVATION	A2-15
GROUND LEVEL SOUTH ELEVATION RENDERED	A2-16
DIAGRAMMATIC CROSS-SECTION	A3-01
LONG SECTION	A3-02
SECTION THROUGH SEAWALL	A3-03
MATERIAL BOARD	A3-04
PROPOSED PARKING GARAGE STRUCTURE	A3-05
ROOF DECK TRELLIS STRUCTURE	A3-06
RENDERING	A4-01
RENDERING	A4-02
RENDERING	A4-03
RENDERING	A4-04
RENDERING	A4-05
RENDERING	A4-06
RENDERING	A4-07
LANDSCAPE	
GROUND LEVEL LANDSCAPE PLAN	L-1
GROUND LEVEL LANDSCAPE PLAN	L-2
LEVEL 05 AMENITY DECK LANDSCAPE PLAN	L-3
ROOF LEVEL LANDSCAPE PLAN	L-4
LANDSCAPE NOTES AND DETAILS	L-5
GROUND LEVEL LANDSCAPE PLAN LEVEL 05 AMENITY DECK LANDSCAPE PLAN ROOF LEVEL LANDSCAPE PLAN	L-2 L-3 L-4

ARQUITECTONICA

2900 Oak Avenue, Miami, FL 33133 T 305.372.1812 F 305.372.1175

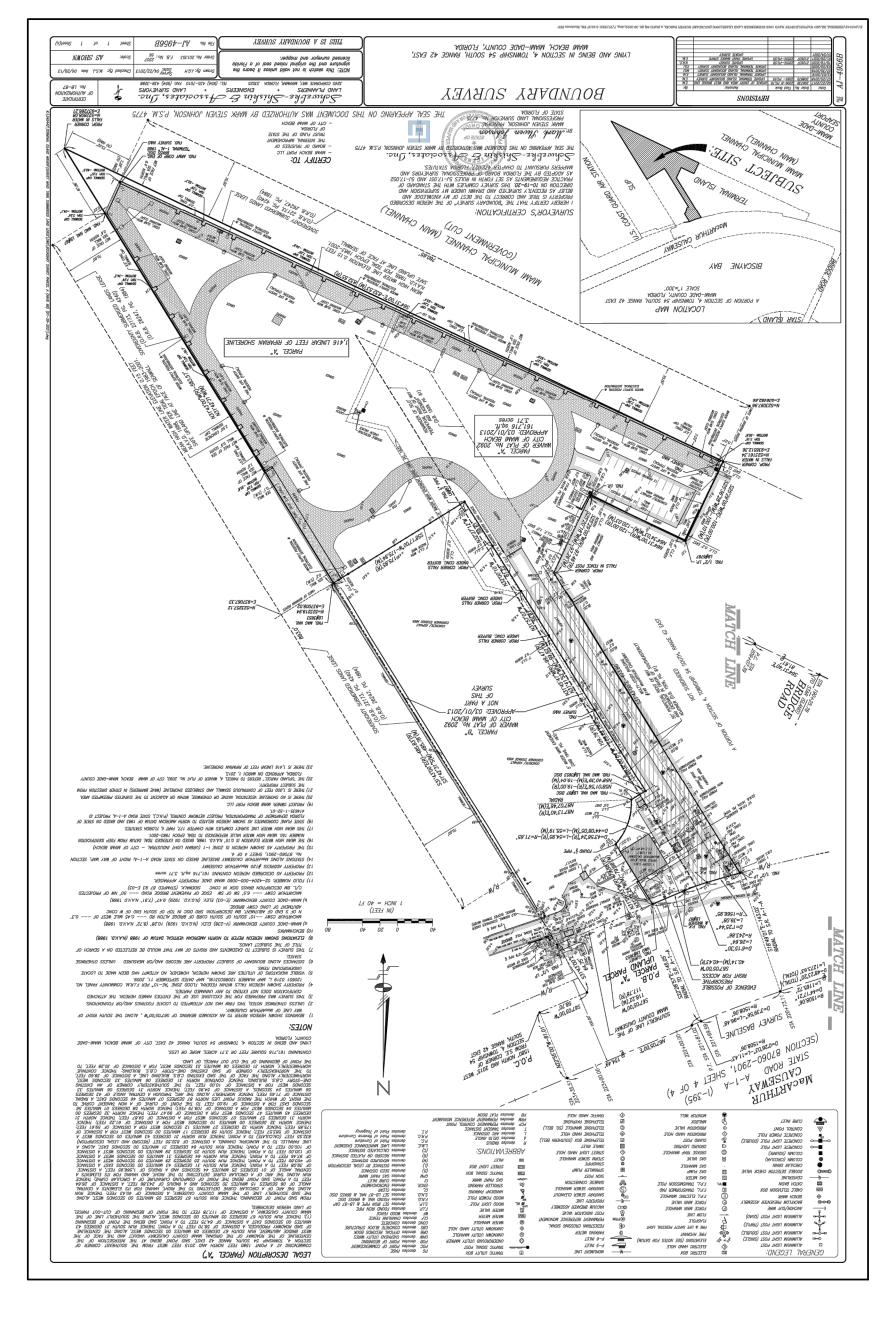



2900 Oak Avenue, Miami, FL 33133 T 305.372.1812 F 305.372.1175

ALL DESIGNS INDICATED IN THESE DRAWINGS ARE PROPERTY OF ARQUITECTONICA INTERNATIONAL CORP. NO COPIES, TRANSMISSIONS, REPRODUCTIONS OR ELECTRONIC MANIPULATION OF ANY PORTION OF THESE DRAWINGS IN THE WHOLE OR IN PART ARE TO BE MADE WITHOUT THE EXPRESS OF WRITTEN AUTHORIZATION OF ARQUITECTONICA INTERNATIONAL CORP. DESIGN INTENT SHOWN IS SUBJECT TO REVIEW AND APPROVAL OF ALL APPLICABLE LOCAL AND GOVERNMENTAL AUTHORITIES HAVING JURISDICTION. ALL COPYRIGHTS RESERVED © 2021. THE DATA INCLUDED IN THIS STUDY IS CONCEPTUAL IN NATURE AND WILL CONTINUE TO BE MODIFIED THROUGHOUT THE COURSE OF THE PROJECTS DEVELOPMENT WITH THE EVENTUAL INTEGRATION OF STRUCTURAL, MEP AND LIFE SAFETY SYSTEMS. AS THESE ARE FURTHER REFINED, THE NUMBERS WILL BE ADJUSTED ACCORDINGLY.

DRB FINAL SUBMITTAL 120 MACARTHUR CAUSEWAY MIAMI BEACH, FL

LOCATION MAP

DATE: 03/28/2022

Zoning Information

120 MacArthur Causeway, Miami Beach, FL 331319 Lot addresses:

02-4204-000-0060 Folio numbers

Zoning District: Division 11. I-1 Light Industry District Flood Zone AE - Elevation : 10'-0" NGVD FEMA Zone:

15'-0" NGVD (BFE +5'-0") FFE Grade:

One Island Park				*
1_Lot Occupation	Required	Proposed	Allowed / Required	Provided
Lot Area				161,716 sf (3.71 acre)
FAR	1.0 FAR max.		161,716 x 1 = 161,716 sf	161,716 sf (3.71 acre)
2_Building Setbacks	Required	Proposed	Allowed / Required	Provided
Front	0'-0" min.	0'-0" min.	0'-0" min.	0,-0,,
Side (South)	0'-0" min.	25'-0" min. from edge of sea wall	0'-0" min.	25'-0"
Side (North)	0'-0" min.	25'-0" min. from edge of sea wall	0'-0" min.	25'-0"
Rear	0'-0" min.	0'-0" min.	0'-0" min.	0'-0"
4_Building Height	Required	Proposed	Allowed / Required	Provided
Max. building height	75'-0" max. above FFE (BFE +5'-0")			75'-0"
5_Office Floorplate FAR	Required	Proposed	Allowed / Required	Provided
Office Floorplate				varies / 23,207 SF max
7_Open Space	Required	Proposed	Allowed / Required	Provided
Open Space	20%		161,716 sf x .2 = 32,343.2 sf	65,767.8 sf (40.67%)

Parking District #1				_	
8_Parking Requirements	Required	Proposed	Allowed / Required	Provided (current)	
	Office parking: min. 1 space per 400 sf of NSF		122,262 SF / 400 SF = 306 spaces		
Office	Office parking: min. 1 space per 300 sf of NSF for Ground level		825 SF/ 300 SF = 3 spaces	309 spaces	
	Total office parking req.		309 spaces		
			30 tables of 4 seats = 30 spaces		
F&B	1 space per 4 seats		30 spaces	30 spaces	
		Office: 10% of parking spaces, 10% of 309 spaces = 31 spaces		61 spaces	
Valet		F&B: 100% of parking spaces, 100% of 30 spaces = 30 spaces.		(included in total above	
	=Alexandran		7 wet slips x 2 = 14 spaces		
Marina	2 space per 1 wet slip		14 spaces	14 spaces	
ADA Spaces	5 standard spaces + 2 van spaces (for a facility with 201-300 spaces)		7 spaces (included in total above)	7 spaces (included in total above)	
TOTAL	- 1-	K-	353 spaces	353 spaces	
Parking spaces for electric vehicle	2 % of total required parking		7 spaces	7 spaces	
TOTAL			353 spaces	353 spaces	
8b_Shared Parking Reductions		Proposed reduction (current)	Max. reduction allowed / Required	Provided (current)	
SEE TABLE 11					
Shared Parking reduction Total			338 spaces		
Parking spaces for electric vehicle	2 % of total required parking		7 spaces		
TOTAL			338 spaces	338 spaces	

ARQUITECTONICA

2900 Oak Avenue, Miami, FL 33133 T 305.372.1812 F 305.372.1175

8c_Additional Parking Reductions		Proposed reduction (current)	Max. reduction allowed / Required	Provided (current)
		w. shared reduc,	w. shared reduc.	w. shared reduc.
Bicycle parking short-term	Reduction of 1 parking space for every 10 short-term bicycle parking spaces provided (not to exceed a reduction of more than 15% of total off street parking)	-16 spaces	-42 spaces	160 bicycle spaces
Bicycle parking long-term	Reduction of 1 parking space for every 5 long-term bicycle parking spaces provided (not to exceed a reduction of more than 15% of total off street parking)	-31 spaces	-42 spaces	155 bicycle spaces
Carpool/vanpool parking	Reduction of 3 parking spaces for every 1 carpool parking space. (not to exceed a reduction of more than 10% of total off street parking)	0 spaces	-28 spaces	0 Carpool spaces
Drop-off and loading zones reductions	Reduction of 3 parking spaces for every 1 curb side drop off stalls. (max. 9 off-street parking spaces)	0 spaces	-9 spaces	2 Curb side drop off stalls
Scooter,moped and motorcycle parking	Reduction of 1 parking space for every 3 scooter, moped, or motorcycle parking space (not to exceed 15 off-street parking spaces)	-8 spaces	-15 spaces	24 Scooter, moped, or motorcycle spaces
Showers	Reduction of 2 parking spaces for each separate shower facility. (not to exceed 8 off-street parking spaces)	0 spaces	-8 spaces	0 Separate shower facilities
	The sum of all parking reductions shall not exceed S0% of the required off- street parking	16%	41%	0%
TOTAL Proposed / Allowed Reduction		-55 spaces	-144 spaces	0 spaces
TOTAL (with applied reductions)		283 spaces	194 spaces	283 spaces

9_Bicycle parking Requirements			V	
Short-term bicycle space	Required		Allowed/ Required (Bicycle spaces)	Provided (Bicycle spaces)
			w. shared reduc.	w. shared reduc.
Office -	N/A		N/A	4 spaces
F&B	N/A	N/A	N/A	2 spaces
Additional bicycle spaces			N/A	154 spaces
Total (Short-term)			N/A	160 spaces
Long-term bicycle space	Required	111	Allowed/ Required (Bicycle spaces)	Provided (Bicycle spaces)
25 200 25 200			w. shared reduc.	w. shared reduc.
Office -	N/A		N/A	20 spaces
Retail	N/A	N/A	N/A	3 spaces
Additional bicycle spaces			N/A	132 spaces
Total (Long-term)			N/A	155 spaces
TOTAL Combined Bicycle spaces		10,11	N/A	315 spaces

10_Loading Requirements	Required	Allowed/Required	Provided (current)
Office	Over 100,000 sf but not over 200,000 sf: 3 spaces	3 loading bays 3 loading b	
Jiffice	For each additional 100,000 over 200,000 sf: 1 space	3 loading days	3 loading bays
Retail / F&B	Over 10,000 but not over 20,000 sf: 2 spaces	2 loading bays	2 loading bays
Total		5 loading bays	5 loading bays

Table 11	Weekdays		Weekends		
	Daytime (6:00 a.m 6 p.m.) %	Evening (6:00 a.m 6 p.m.) %	Daytime (6:00 a.m 6 p.m.) %	Daytime (6:00 a.m 6 p.m.) %	Daytime (6:00 a.m 6 p.m.) %
	100%	5%	10%	5%	50%
Office	309	15.45	30.9	15.45	30.9
	50%	75%	75%	90%	10%
Retail	15	22.5	22.5	27.0	3
	100%	100%	100%	100%	100%
Marina	14	14	14	14	14
Total	338	52	67	56	48

2900 Oak Avenue, Miami, FL 33133 T 305.372.1812 F 305.372.1175

Zoning Information 120 MacArthur Causeway, Miami Beach, FL 331319 The total usable office area Lot addresses: increased from 122, 262sf to 02-4204-000-0060 Folio numbers: 131,180 sf. The total FAR area slightly The parking calculation was Division 11. I-1 Light Industry District **Zoning District:** decrease from 161,716 sf revised accordingly. **FEMA Zone:** Flood Zone AE - Elevation: 10'-0" NGVD to 161,580sf FFE Grade: 15'-0" NGVD (BFE +5'-0") One Island Park _Lot Occupation Required Allowed / Required Proposed Provided Slight adjustments 161,694 sf (3.71 acre) Lot Area were made to the 161,580 sf 1.0 FAR max. 161,716 x 1 = 161,716 sf 2_Building Setbacks Required Proposed Allowed / Required Provided building slab footprints 0'-0" min. 0'-0" min. 0'-0" min. 0'-0" and vehicular driveway Side (South) 0'-0" min. 25'-0" min. from edge of sea wall 0'-0" min. 25'-0" layouts. The lot Side (North) 0'-0" min. 25'-0" min. from edge of sea wall 0'-0" min. 25'-0" coverage and open 0'-0" min. 0'-0" min. 0'-0" min. 0'-0" 4_Building Height Required Proposed Allowed / Required Provided space calculations Max. building height 75'-0" max. above FFE (BFE +5'-0") 75'-0" have been revised 5_Office Floorplate FAR Allowed / Required Provided Required Proposed accordingly varies / 23,652 SF max. Office Floorplate 6_Open Space Required Proposed Allowed / Required Provided The seating capacity 161,716 sf x 0.2 = 32,343.2 sf Open Space 20% 35,931 sf (22.2%) of the rooftop restaurant amenity Parking District #1 remains unchanged 7 Parking Requirements Allowed / Required Provided Required Proposed (100 seats). 123,295 SF / 400 SF = 309 spaces Office parking: min. 1 space per 400 sf of Usable SF Office 335 spaces 7,885 SF/ 300 SF = 26 spaces Office parking: min. 1 space per 300 sf of Usable SF for Grnd Ivl The seating capacity of 335 spaces Total office parking req. the ground level cafe 1 space per 4 seats 100 seats / 4 = 25 spaces 25 spaces Restauran was increased from 20 seats to 36 seats Café 1 space per 4 seats 36 seats / 4 = 9 spaces 9 spaces The number of Office: 10% of parking spaces, 10% of 385 spaces = 39 provided accessible Valet 37 spaces (included in total above) spaces spaces and spaces for electrical vehicle has 7 wet slips x 2 = 14 spaces been revised based on Marina 2 space per 1 wet slip 14 spaces 14 spaces the total parking 8 spaces 6 standard spaces + 2 van spaces (for a facility with 301-400 8 spaces number. ADA Spaces (included in total below) (included in total below) TOTAL 383 spaces 383 spaces The total number of Parking spaces for electric vehicle 2 % of total required parking 8 spaces (included in total below) 8 spaces (included in total below) provided parking paces increased from TOTAL 383 spaces 383 spaces 353 to 388 spaces on 10_Loading Requirements Required Allowed/Required Provided (current) the over. Over 100,000 sf but not over 200,000 sf: 3 spaces No parking reduction Office 3 loading bays 3 loading bays For each additional 100,000 over 200,000 sf: 1 space have been applied. F&B Over 2,000 but not over 10,000: 1 space 1 loading bays 1 loading bays

ARQUITECTONICA

2900 Oak Avenue, Miami, FL 33133 T 305.372.1812 F 305.372.1175

TOTAL

DRB FINAL SUBMITTAL 120 MACARTHUR CAUSEWAY MIAMI BEACH, FL


70NING DATA

DATE: 03/28/2022 *A0-03*

4 loading bays

4 loading bays

ALL DESIGNS INDICATED IN THESE DRAWINGS ARE PROPERTY OF ARQUITECTONICA INTERNATIONAL CORP. NO COPIES, TRANSMISSIONS, REPRODUCTIONS OR ELECTRONIC MANIPULATION

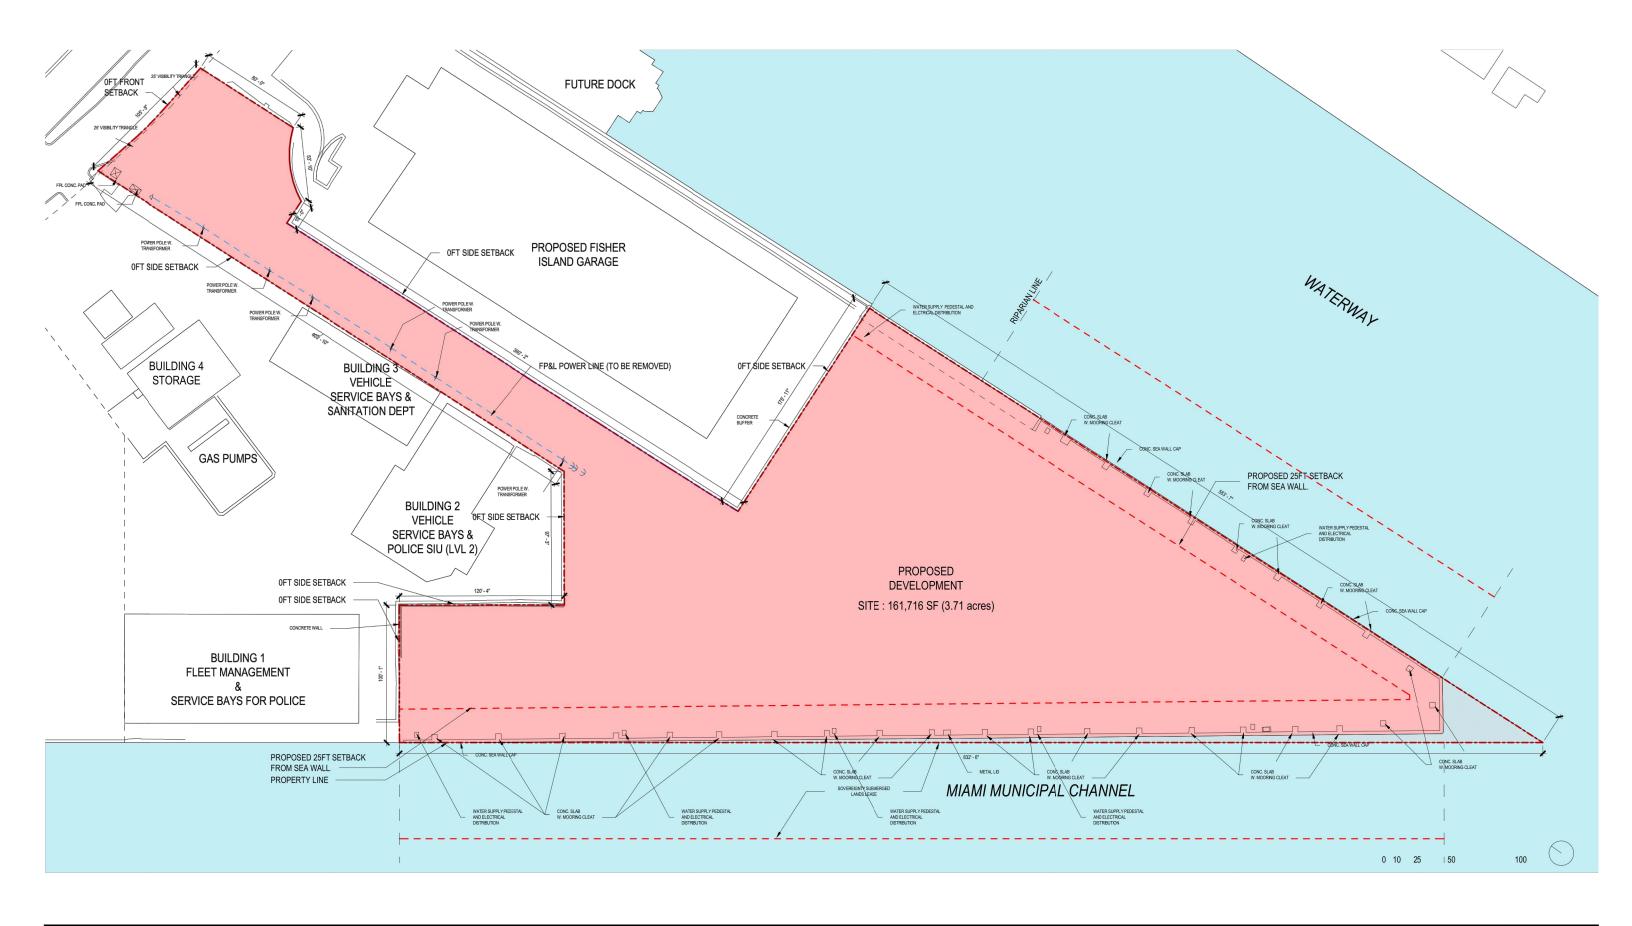

2900 Oak Avenue, Miami, FL 33133 T 305.372.1812 F 305.372.1175

ALL DESIGNS INDICATED IN THESE DRAWINGS ARE PROPERTY OF ARQUITECTONICA INTERNATIONAL CORP. NO COPIES, TRANSMISSIONS, REPRODUCTIONS OR ELECTRONIC MANIPULATION OF ANY PORTION OF THESE DRAWINGS IN THE WHOLE OR IN PART ARE TO BE MADE WITHOUT THE EXPRESS OF WRITTEN AUTHORIZATION OF ARQUITECTONICA INTERNATIONAL CORP. DESIGN INTENT SHOWN IS SUBJECT TO REVIEW AND APPROVAL OF ALL APPLICABLE LOCAL AND GOVERNMENTAL AUTHORITIES HAVING JURISDICTION. ALL COPYRIGHTS RESERVED © 2021. THE DATA INCLUDED IN THIS STUDY IS CONCEPTUAL IN NATURE AND WILL CONTINUE TO BE MODIFIED THROUGHOUT THE COURSE OF THE PROJECTS DEVELOPMENT WITH THE EVENTUAL INTEGRATION OF STRUCTURAL, MEP AND LIFE SAFETY SYSTEMS. AS THESE ARE FURTHER REFINED, THE NUMBERS WILL BE ADJUSTED ACCORDINGLY.


DRB FINAL SUBMITTAL 120 MACARTHUR CAUSEWAY MIAMI BEACH, FL

SITE PLAN

DATE: 03/28/2022

PROPOSED

TE: **A0-07**

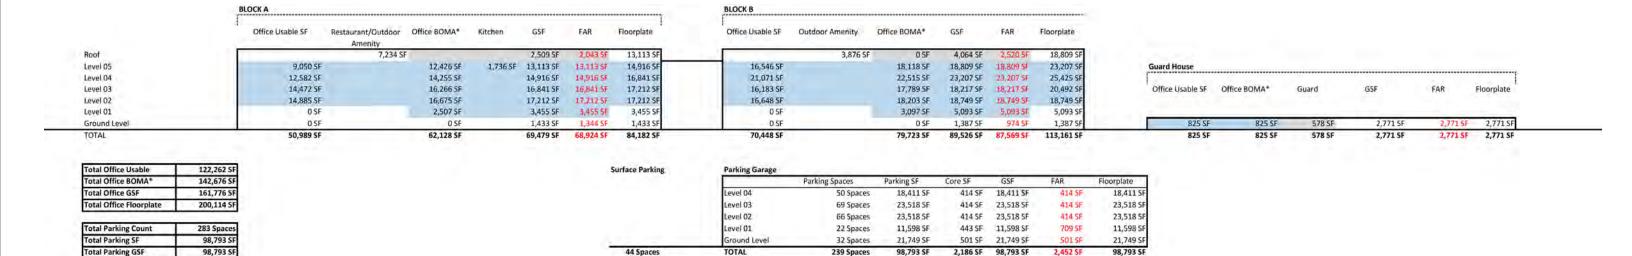

Leftover FAR

Total Parking Floorplate

Total FAR

Total GSF **Total Floorplate**

(Max FAR Allowed: 161,716 SF)


98,793 SF

161,716 SF 260,570 SF

298,908 SF

ARQUITECTONICA 2900 Oak Avenue, Miami, FL 33133

T 305.372.1812 F 305.372.1175 ALL DESIGNS INDICATED IN THESE DRAWINGS ARE PROPERTY OF ARQUITECTONICA INTERNATIONAL CORP. NO COPES, TRANSMISSIONS, REPRODUCTIONS OR ELECTRONIC MANIPULATION OF ANY PORTION OF THESE DRAWINGS IN THE WHOLE OR IN PART ARE TO BE MADE WITHOUT THE EXPRESS OF WRITTEN AUTHORIZATION OF ARQUITECTONICA INTERNATIONAL CORP. DESIGN INTENT SHOWN IS SUBJECT TO REVIEW AND APPROVAL OF ALL APPLICABLE LOCAL AND GOVERNMENTAL AUTHORITES HAVING JURISDICTION. ALL COPYRIGHTS RESERVED © 2019. THE DATA INCLUDED IN THIS STUDY IS CONCEPTUAL IN NATURE AND WILL CONTINUE TO BE MODIFIED THROUGHOUT THE COURSE OF THE PROJECTS DEVELOPMENT WITH THE EVENTUAL INTEGRATION OF STRUCTURAL, MEP AND LIFE SAFETY SYSTEMS. AS THESE ARE FURTHER REFINED, THE NUMBERS WILL BE ADJUSTED ACCORDINGLY.

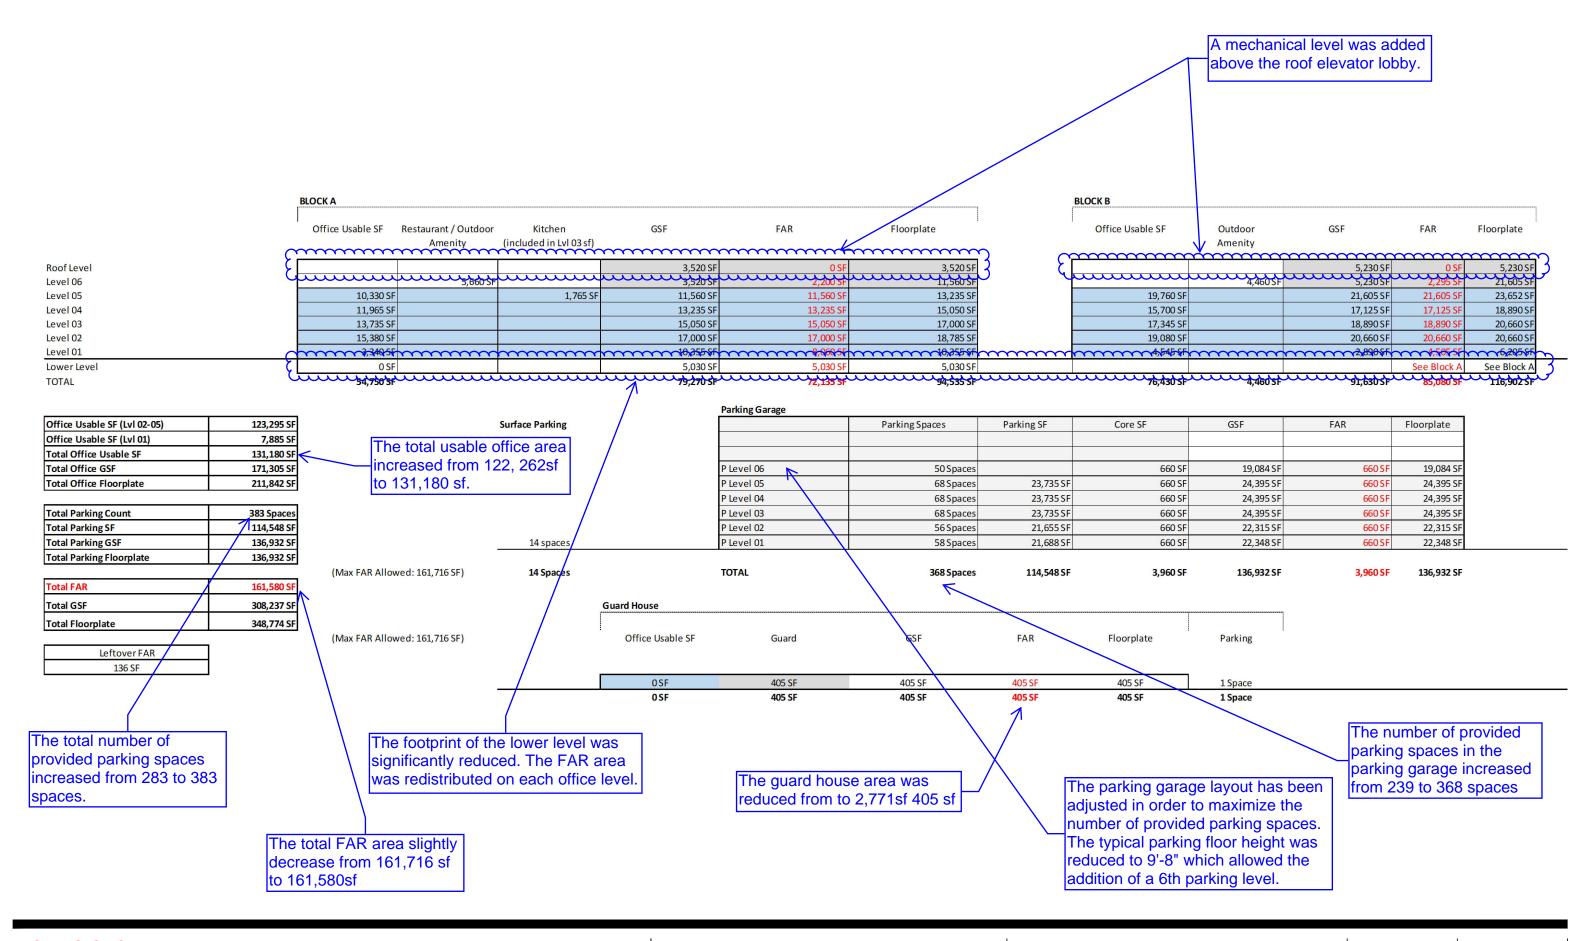

2900 Oak Avenue, Miami, FL 33133 T 305.372.1812 F 305.372.1175


ALL DESIGNS INDICATED IN THESE DRAWINGS ARE PROPERTY OF ARQUITECTONICA INTERNATIONAL CORP. NO COPIES, TRANSMISSIONS, REPRODUCTIONS OR ELECTRONIC MANIPULATION OF ANY PORTION OF THESE DRAWINGS IN THE WHOLE OR IN PART ARE TO BE MADE WITHOUT THE EXPRESS OF WRITTEN AUTHORIZATION OF ARQUITECTONICA INTERNATIONAL CORP.
DESIGN INTENT SHOWN IS SUBJECT TO REVIEW AND APPROVAL OF ALL APPLICABLE LOCAL AND GOVERNMENTAL AUTHORIZATION OF ARQUITECTONICA INTERNATIONAL CORP.
THE DATA INCLUDED IN THIS STUDY IS CONCEPTUAL IN NATURE AND WILL CONTINUE TO BE MODIFIED THROUGHOUT THE COURSE OF THE PROJECTS DEVELOPMENT WITH THE EVENTUAL INTEGRATION OF STRUCTURAL, MEP AND LIFE SAFETY SYSTEMS. AS THESE ARE FURTHER REFINED, THE NUMBERS WILL BE ADJUSTED ACCORDINGLY

DRB FINAL SUBMITTAL 120 MACARTHUR CAUSEWAY MIAMI BEACH, FL

SELF PARKING OPTION PROJECT DATA **PROPOSED**

SCALE:

DATE: 03/28/2022

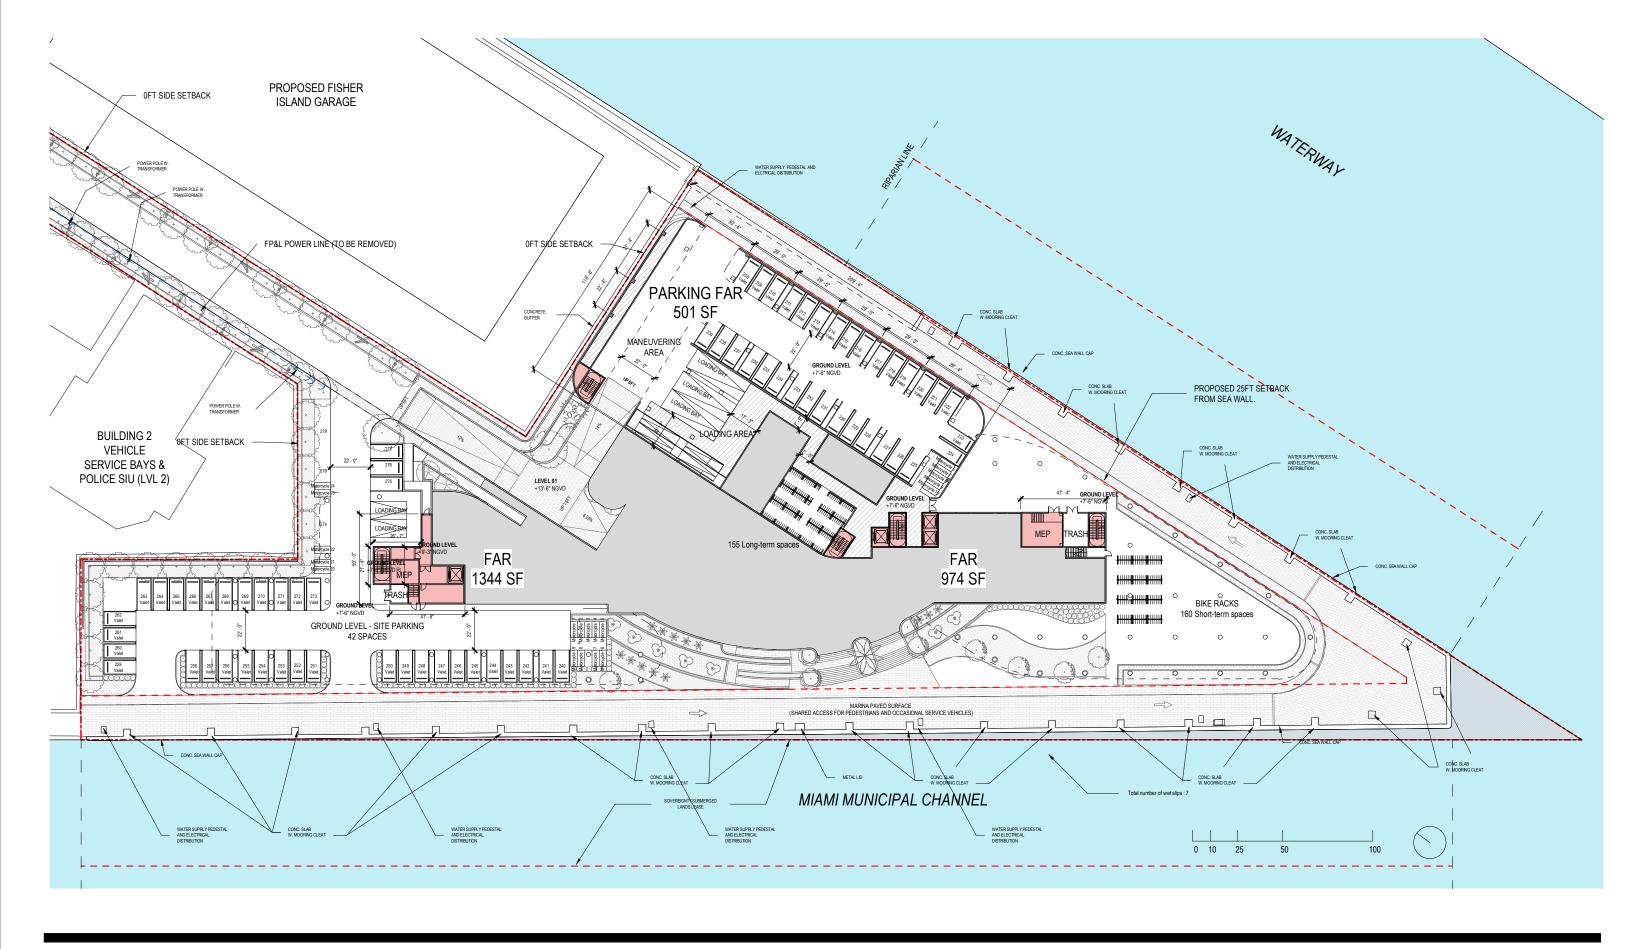


2900 Oak Avenue, Miami, FL 33133 T 305.372.1812 F 305.372.1175

ALL DESIGNS INDICATED IN THESE DRAWINGS ARE PROPERTY OF ARQUITECTONICA INTERNATIONAL CORP. NO COPES, TRANSMISSIONS, REPRODUCTIONS OR ELECTRONIC MANIPULATION OF ANY PORTION OF THESE DRAWINGS IN THE WHOLE OR IN PART ARE TO BE MADE WITHOUT THE EXPRESS OF WRITTEN AUTHORIZATION OF ARQUITECTONICA INTERNATIONAL CORP. DESIGN INTENT SHOWN IS SUBJECT TO REVIEW AND APPROVAL OF ALL APPLICABLE LOCAL AND GOVERNMENTAL AUTHORITES HAVING JURISDICTION. ALL COPYRIGHTS RESERVED @ 2019. THE DATA INCLUDED IN THIS STUDY IS CONCEPTUAL IN NATURE AND WILL CONTINUE TO BE MODIFIED THROUGHOUT THE COURSE OF THE PROJECTS DEVELOPMENT WITH THE EVENTUAL INTEGRATION OF STRUCTURAL, MEP AND LIFE SAFETY SYSTEMS. AS THESE ARE FURTHER REFINED, THE NUMBERS WILL BE ADJUSTED ACCORDINGLY.

DRB FINAL SUBMITTAL 120 MACARTHUR CAUSEWAY MIAMI BEACH, FL, 33139

OVERALL OFFICE BUILDINGS GROUND FLOOR - FAR

DATE: 12/07/2020

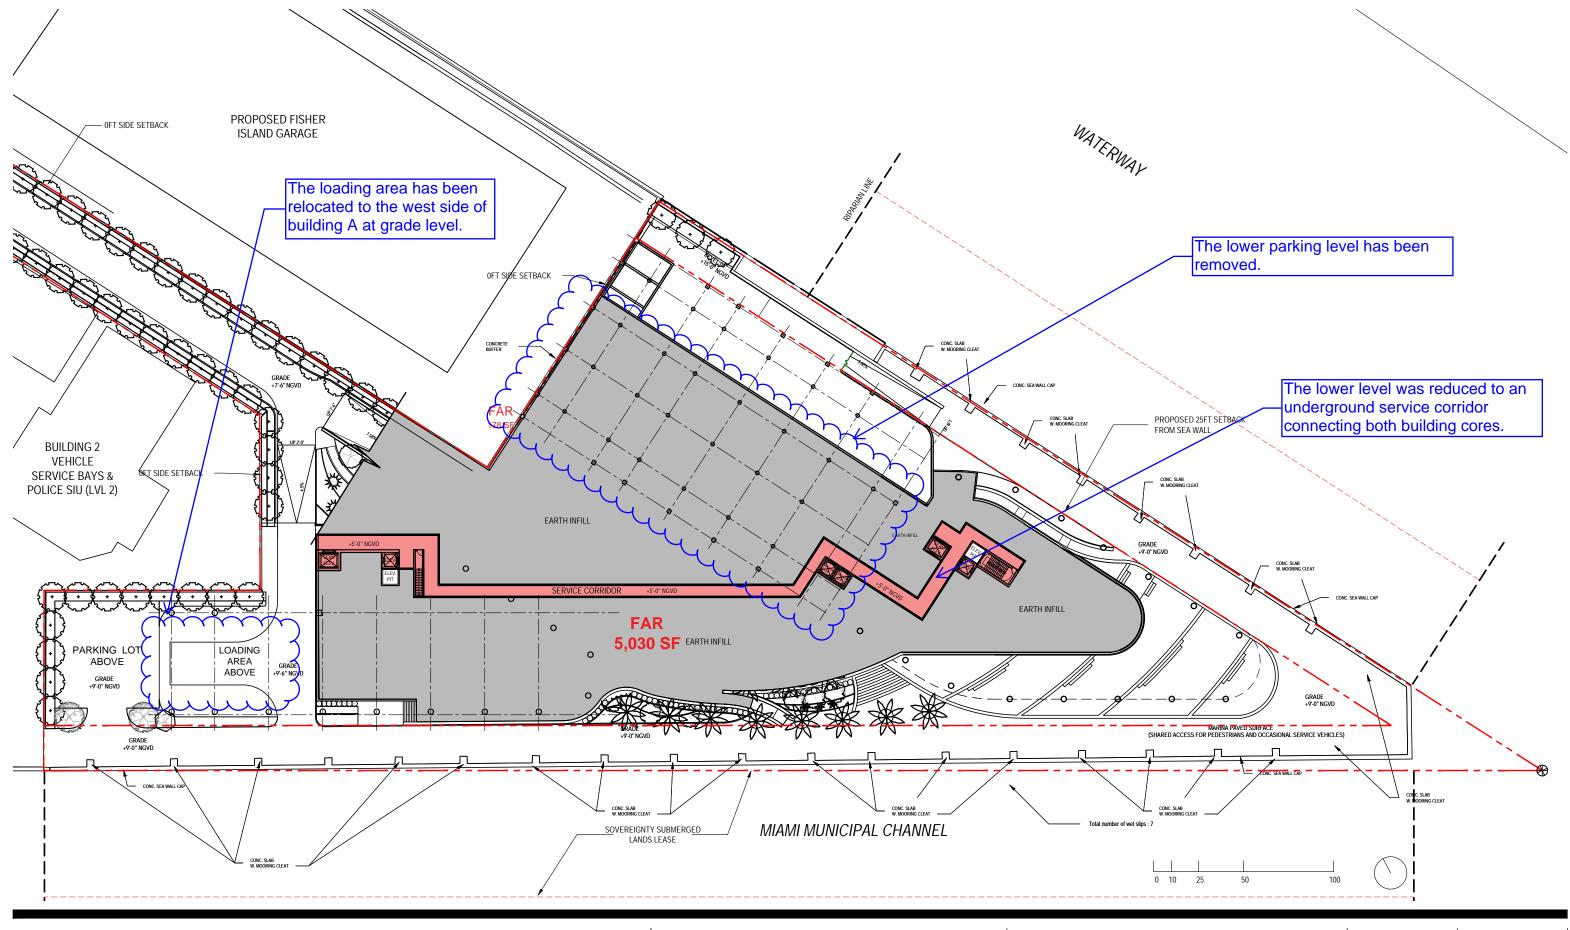


2900 Oak Avenue, Miami, FL 33133 T 305.372.1812 F 305.372.1175

ALL DESIGNS INDICATED IN THESE DRAWINGS ARE PROPERTY OF ARQUITECTONICA INTERNATIONAL CORP. NO COPIES, TRANSMISSIONS, REPRODUCTIONS OR ELECTRONIC MANIPULATION OF ANY PORTION OF THESE DRAWINGS IN THE WHOLE OR IN PART ARE TO BE MADE WITHOUT THE EXPRESS OF WRITTEN AUTHORIZATION OF ARQUITECTONICA INTERNATIONAL CORP. DESIGN INTENT SHOWN IS SUBJECT TO REVIEW AND APPROVAL OF ALL APPLICABLE LOCAL AND GOVERNMENTAL AUTHORITIES HAVING JURISDICTION. ALL COPYRIGHTS RESERVED © 2021. THE DATA INCLUDED IN THIS STUDY IS CONCEPTUAL IN NATURE AND WILL CONTINUE TO BE MODIFIED THROUGHOUT THE COURSE OF THE PROJECTS DEVELOPMENT WITH THE EVENTUAL INTEGRATION OF STRUCTURAL, MEP AND LIFE SAFETY SYSTEMS. AS THESE ARE FURTHER REFINED, THE NUMBERS WILL BE ADJUSTED ACCORDINGLY.

DRB FINAL SUBMITTAL 120 MACARTHUR CAUSEWAY MIAMI BEACH, FL

OVERALL OFFICE BUILDINGS
LOWER LEVEL - FAR
SCALE: 1:640 PROPOSED


DATE: 03/28/2022

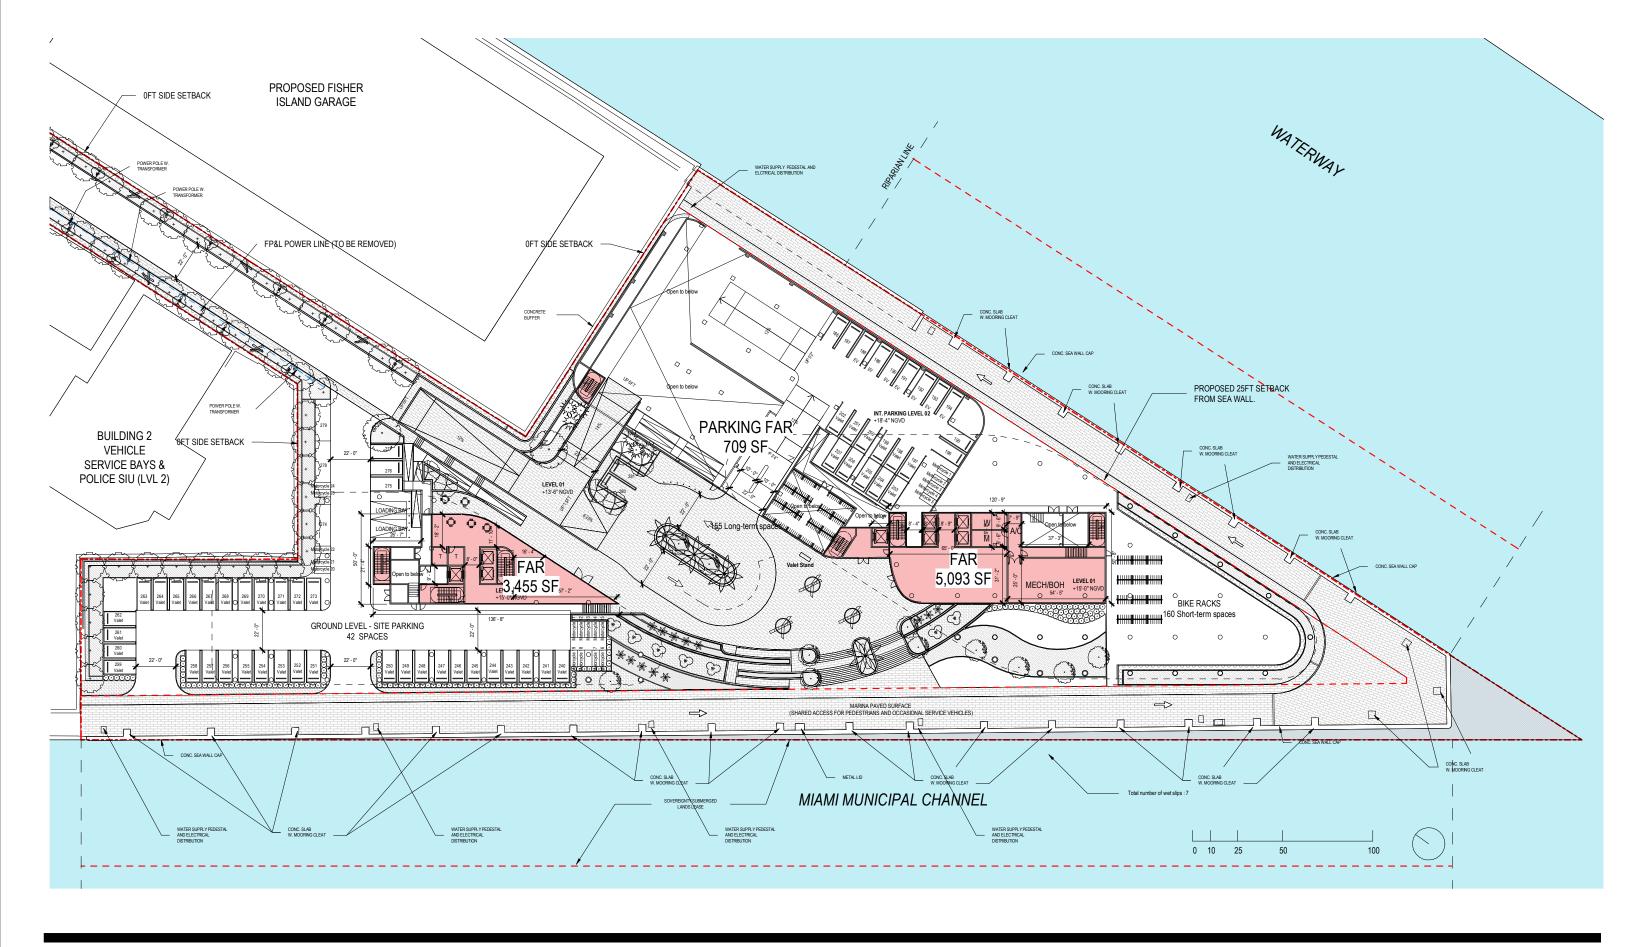

2900 Oak Avenue, Miami, FL 33133 T 305.372.1812 F 305.372.1175

ALL DESIGNS INDICATED IN THESE DRAWINGS ARE PROPERTY OF ARQUITECTONICA INTERNATIONAL CORP. NO COPES, TRANSMISSIONS, REPRODUCTIONS OR ELECTRONIC MANIPULATION OF ANY PORTION OF THESE DRAWINGS IN THE WHOLE OR IN PART ARE TO BE MADE WITHOUT THE EXPRESS OF WRITTEN AUTHORIZATION OF ARQUITECTONICA INTERNATIONAL CORP. DESIGN INTENT SHOWN IS SUBJECT TO REVIEW AND APPROVAL OF ALL APPLICABLE LOCAL AND GOVERNMENTAL AUTHORITES HAVING JURISDICTION. ALL COPYRIGHTS RESERVED @ 2019. THE DATA INCLUDED IN THIS STUDY IS CONCEPTUAL IN NATURE AND WILL CONTINUE TO BE MODIFIED THROUGHOUT THE COURSE OF THE PROJECTS DEVELOPMENT WITH THE EVENTUAL INTEGRATION OF STRUCTURAL, MEP AND LIFE SAFETY SYSTEMS. AS THESE ARE FURTHER REFINED, THE NUMBERS WILL BE ADJUSTED ACCORDINGLY.

SCALE: 1:640

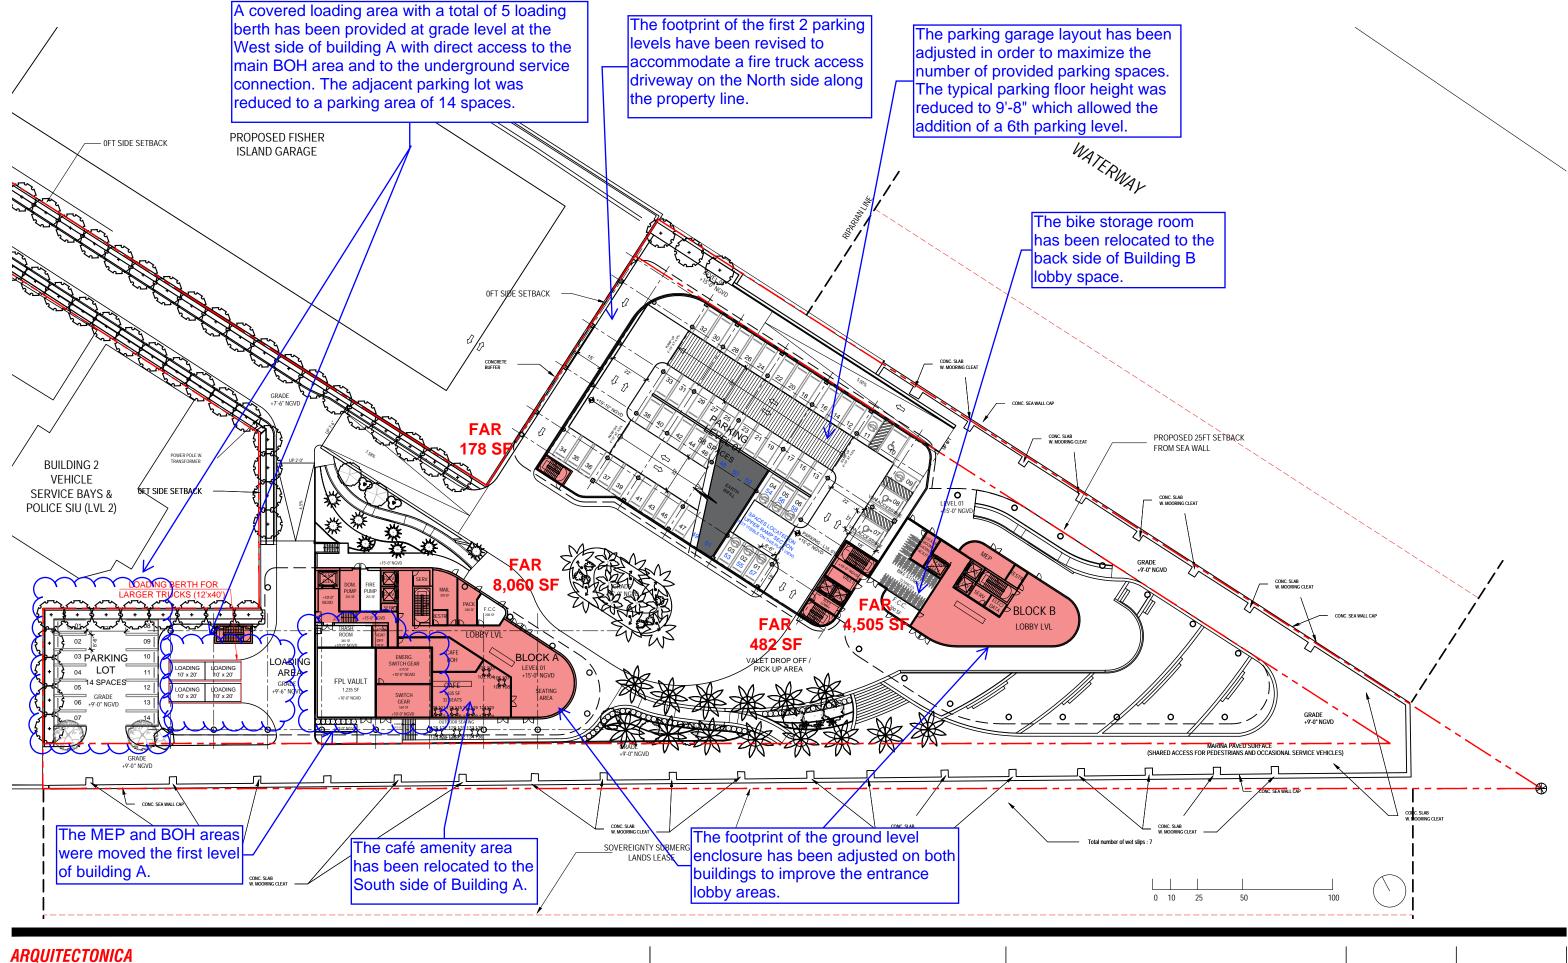

2900 Oak Avenue, Miami, FL 33133 T 305.372.1812 F 305.372.1175

ALL DESIGNS INDICATED IN THESE DRAWINGS ARE PROPERTY OF ARQUITECTONICA INTERNATIONAL CORP. NO COPIES, TRANSMISSIONS, REPRODUCTIONS OR ELECTRONIC MANIPULATION OF ANY PORTION OF THESE DRAWINGS IN THE WHOLE OR IN PART ARE TO BE MADE WITHOUT THE EXPRESS OF WRITTEN AUTHORIZATION OF ARQUITECTONICA INTERNATIONAL CORP. DESIGN INTENT SHOWN IS SUBJECT TO REVIEW AND APPROVAL OF ALL APPLICABLE LOCAL AND GOVERNMENTAL AUTHORITIES HAVING JURISDICTION. ALL COPYRIGHTS RESERVED © 2021. THE DATA INCLUDED IN THIS STUDY IS CONCEPTUAL IN NATURE AND WILL CONTINUE TO BE MODIFIED THROUGHOUT THE COURSE OF THE PROJECTS DEVELOPMENT WITH THE EVENTUAL INTEGRATION OF STRUCTURAL, MEP AND LIFE SAFETY SYSTEMS. AS THESE ARE FURTHER REFINED, THE NUMBERS WILL BE ADJUSTED ACCORDINGLY.

DRB FINAL SUBMITTAL 120 MACARTHUR CAUSEWAY MIAMI BEACH, FL

OVERALL OFFICE BUILDINGS
LEVEL 01 - FAR
SCALE: 1:640
PROPOSED

DATE: 03/28/2022