PRIVATE RESIDENCE

6470 ALLISON ROAD MIAMI BEACH, FL 33141

DRB FINAL SUBMITTAL PACKAGE 04-11-2022 DRB NO. 22-0802



ARCHITECT KOBI KARP ARCHITECTURE AND INTERIOR DESIGN, INC.

571 NW 28 th St. Miami , Florida 33127 Tel: (305) 573-1818 Fax: (305) 573-3766

_	Rev.	Date	Rev.	Date
_				_
_				
_				
_				
L				
_	KOBI KARP AIA, AND MAY NOT BE DUPLICATE	D, USED, OR I	IN CONSTITUTE THE ORIGINAL AND UNPUBLISH DISCLOSED WITHOUT THE EXPRESS WRITTEN O TERIOR DESIGN, INC. AIA. (c) 2020	ED WORK OF ONSENT OF

PRIVATE RESIDENCE 6470 ALLISON RD MIAMI BEACH, FL 33141

_	
	Owner:
_	Name
	Address
	Address
_	Tel:
	Email
_	Consultant:
	Name
	Address
_	Address
	Tel:
	Email
-	
	Consultant:
	Name
-	Address





KOBI KARP Lic. # AR0012578

COVER

_	Date	04-11-2022	Sheet No.
_	Scale	-	A0.00
	Project	0000	



6470 ALLISON RD. SITE OF PROJECT



IMAGES ON SHEET A0.04-CONTEXT

C1 - ALLISON RD - LOOKING NORTH C2 - ALLISON RD - LOOKING SOUTH

IMAGES ON SHEET A0.05-EXISTING PROPERTY E1 - FRONT YARD E2 - SIDE YARD - NORTH E3 - SIDE YARD - SOUTH E4 - REAR YARD

IMAGES ON SHEET A0.06-NEIGHBOR PROPERTY N1 - 6480 ALLISON RD

N2 - 6450 ALLISON RD

N3 - 6475 ALLISON RD N4 - 6455 ALLISON RD

N5 - 6445 ALLISON RD

RADIUS SITE LOCATION & IMAGE KEY PLAN

NO SCALE



C1 - ALLISON RD. (VIEW TO NORTH)



C2 - ALLISON RD. (VIEW TO SOUTH)

KOBI KARP ARCHITECTURE	& INTERIOR DESIGN, INC. AIA.

	PRIVATE RESIDENCE
	6470 ALLISON RD
-	MIAMI BEACH, FL 33141

Architect:
Kobi Karp Architecture and Interior Design, Inc.
571 NW 28th Street,
Miami, Florida 33127 USA
Tel: +1(305) 573 1818
Fax: +1(305) 573 3766



KOBI KARP Lic. # AR0012578

IMAGE KEY

-	Date	04-11-2022	Sheet No.
_	Scale	**	A0.02
	Project	0000	



		-
		-

Date Rev.

PRIVATE RESIDENCE 64/70 ALLISON FID MAMIRIEACH, FL 33141

General Service Addition of Consultant Addition of Consultant Addition of Consultant Service Office Service Addition of Consultant Service Office Office Service Office Service Office Office Service Office Office



KOBI KARIF Lis. # ARKO12578

SITE PLAN

	Sim 94-11-2022	Stoot No.
1	train -	A2.01
- 1	Street SEE	- B.C. (2.4)



PRIVATE RESIDENCE 8470 ALLBON FID MANUBEACH, FL 33141

Architect
Kate Apolitecture and Interior Straige, Inc.
271 NV State Street
Interior Foots 37127 USA,
Tel: +1205-571-1786
File: +1205-571-1786



KOBI KARP Lie. # API0012576

PROPOSED PLANS

PROPOSED LEVEL 2

-	Gale 0411-3500	Brood No.
	took -	A3.02
	Project. SICH	100000000000000000000000000000000000000



Rev	Date Rev	Date
	The state of the s	AND THE RESERVE
Print State	SEASON NAMED OF THE	garantari
DDIVATE	RESIDENCE	
8470 ALLISON		
MAWEBEACH,	FL 33141	
Owner:		
Nerte		
Access Access		
Tel		
Desail		
Consultant		
Name		
Acidona		
Acchora: Tel:		
Ereinel		
Consultant: Name		
Appense .		
Access		
Ter		
Consider		



KOBI KARP Lie. # AFRO1267E

KARP

PROPOSED LEVEL ROOF

-	G46 94113655	Breat No.
	took -	A3.03
	Prost SIA	



Rev.	Date	Rev.	Date

ALL DRAWINGS AND WRITTEN MATERIAL APPEARING HEREIN CONSTITUTE THE ORIGINAL AND UNPUBLISHED WORK OF KOBI KARP AIA, AND MAY NOT BE DUPLICATED, USEO, OR DISCLOSED WITHOUT THE EXPRESS WRITTEN CONSENT OF KOBI KARP AGE (SEE)

PRIVATE RESIDENCE 6470 ALLISON RD MIAMI BEACH, FL 33141

Architect:
Kabi Karp Architecture and Interior Design, Inc.
571 MV 28th Street.
Miami, Florida 33127 USA.
Tel: +1(305) 573 1818
Fax: +1(305) 573 3766



KOBI KARP Lic. # AR0012578

COVER

-	Date	04-11-2022	Sheet No.	
_	Scale		A1.30	
	Project	0000		



-	Rev.	Date	Rev.	Date
_				
_				
_				

Architect:
Kobi Karp Architecture and Interior Design, Inc.
571 NW 28th Street,
Miami, Florida 33127 USA
Tel: +1(305) 573 1818
Fax: +1(305) 573 3766



KOBI KARP Lic. # AR0012578

COVER

-	Date	04-11-2022	Sheet No.
_	Scale	**	A1.31
	Project	0000	



Architect:
Kobi Karp Architecture and Interior Design, Inc. 571 NW 26th Street.
Miam, Florida 33 Ct USA.
T6: +1(305) 573 1818
Fax: +1(305) 573 3766



KOBI KARP Lic. # AR0012578

COVER

NE AXONOMETRIC

H	Date	04-11-2022	Sheet No.
_	Scale		A1.32
	Project	0000	



Architect:
Kobi Karp Architecture and Interior Design, Inc. 57 i NW 28th Street.
Miami, Florida 35127 USA
Tei: +1(309) 573 3768
Fax: +1(309) 573 3768



KOBI KARP Lic. # AR0012578

COVER

NW AXONOMETRIC

NO SCALE

H	Date	04-11-2022	Sheet No.
_	Scale	-	A1.33
	Project	0000	



Architect:
Kobi Karp Architecture and Interior Design, Inc.
571 NW 28th Street,
Miami, Florida 33127 USA
Tel: +1(305) 573 1818
Fax: +1(305) 573 3766



KOBI KARP Lic. # AR0012578

COVER

SE AXONOMETRIC

NO SCALE

	-	Date	04-11-2022	Sheet No.
-	-	Scale		A1.34
		Project	0000	



Owner:
Name
Address
Address
Tel:
Email

Consultant:
Name
Address
Address
Tel:
Email

Architect:
Kobi Karp Architecture and Interior Design, Inc.
571 NW 28th Street,
Miami, Florida 33127 USA
Tel: +1(305) 573 1818
Fax: +1(305) 573 3766



KOBI KARP Lic. # AR0012578

COVER

SW AXONOMETRIC

NO SCALE

-	Date	04-11-2022	Sheet No.
_	Scale		A1.35
	Project	0000	



1 - METAL ROOF



3 - LIGHT STONE




2 - DARK STONE



5 - FRAMES



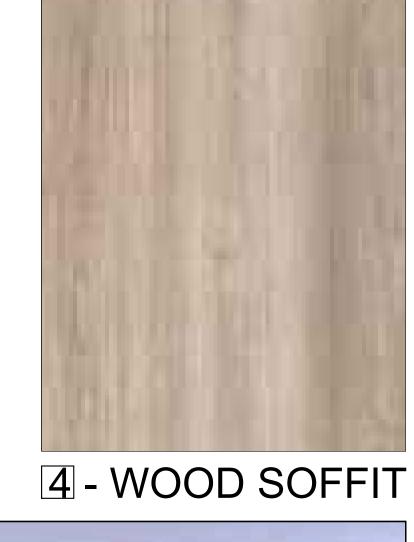



6 - LOUVERED SCREEN 7 - RAIL

	Rev.	Date	Rev.	Date
_				

ALL DRAWINGS AND WRITTEN MATERIAL APPEARING HEREIN CONSTITUTE THE ORIGINAL AND UNPUBLISHED WORK OF KOBI KARP AIA, AND MAY NOT BE DUPLICATED, USED, OR DISCLOSED WITHOUT THE EXPRESS WRITTEN CONSENT OF KOBI KARP ARCHITECTURE & INTERIOR DESIGN, INC. AIA. (c) 2020

PRIVATE RESIDENCE 6470 ALLISON RD MIAMI BEACH, FL 33141

_	Owner:	
	Name	
	Address	
	Address	
_	Tel:	
	Email	

Consultant: Name Address Address Tel: Email

Architect:
Kobi Karp Architecture and Interior Design, Inc.
571 NW 28th Street,
Miami, Florida 33127 USA
Tel: +1(305) 573 1818
Fax: +1(305) 573 3766



MATERIAL PALETTE

	Date	04-11-2022	Sheet No.
_	Scale		A1.32
	Project	0000	

PRIVATE RESIDENCE

6470 ALLISON ROAD MIAMI BEACH, FL 33141

DRB FINAL SUBMITTAL PACKAGE 04-11-2022 DRB NO. 22-0802



ARCHITECT KOBI KARP ARCHITECTURE AND INTERIOR DESIGN, INC.

571 NW 28 th St. Miami , Florida 33127 Tel: (305) 573-1818 Fax: (305) 573-3766

_	Rev.	Date	Rev.	Date
_				
_				
-				
-				
_	KOBI KARP AIA, AND MAY N	IOT BE DUPLICATED, USED, OR I	IN CONSTITUTE THE ORIGINAL AND UNF DISCLOSED WITHOUT THE EXPRESS WR TERIOR DESIGN, INC. AIA. (c) 2020	UBLISHED WORK OF ITTEN CONSENT OF
_				

PRIVATE RESIDENCE 6470 ALLISON RD MIAMI BEACH, FL 33141

-	
-	
	Owner:
	lame
	Address
	ddress
Ţ	el:
Е	mail
-	
c	consultant:
	lame
	ddress
	address
	'el:
Е	mail
_	
_	consultant:
	lame
	ddress
	ddress
	el:

rnaii Architect: (obi Karp Architecture and Interior Design, Inc. 71 NW 28th Street

Miami, Florida 33127 US Tel: +1(305) 573 1818 Fax: +1(305) 573 3766



KOBI KARP Lic. # AR0012578

COVER

04-11-2022 Sheet No.
-- A0.00



Planning Department, 1700 Convention Center Drive, 2nd Floor Miami Beach, Florida 33139, www.miamibeachfl.gov 305.673.7550

SINGLE FAMILY RESIDENTIAL - ZONING DATA SHEET

ITEM #	Project Information				
1	Address:	6470 ALLISON ROAD	, MIAMI BEACH, FL 33141		
2	Folio number(s):	02-3211-003-0390			
3	Board and file numbers :				
4	Year built:(EXISTING TO BE DEMO'D.)	1935	Zoning District:	RS-3	
5	Base Flood Elevation:	+8.00' NGVD	Grade value in NGVD: +4.50' NGVD - CROWN	OF ROAD	
6	Adjusted grade (Flood+Grade/2):	+6.75' NGVD	Free board:	+2 = +10.00' N	GVD
7	Lot Area:	21,600 SF			
8	Lot width:	100'-0"	Lot Depth: 215'-6"		
9	Max Lot Coverage SF and %	6,480 SF (30.00%)	Proposed Lot Coverage SF and %:	6,431 SF (29.7	7%) (500 SF CREDIT
10	Existing Lot Coverage SF and %:		Lot coverage deducted (garage-storage) SF:		
11	Front Yard Open Space SF and %:	1,623 SF (81.15 %)	Rear Yard Open Space SF and %:	2,696 SF (83.33	3 %)
12	Max Unit Size SF and %:	11,300 SF (50.00 %)	Proposed Unit Size SF and %:	10,761 SF (49.8	31 %)
13	Existing First Floor Unit Size:		Proposed First Floor Unit Size:	5,879 SF (27.2	1 %)
14	Existing Second Floor Unit Size		Proposed Second Floor volumetric Unit Size SF and % (Note: to exceed 70% of the first floor of the main home requires Board Approval)		
15			Proposed Second Floor Unit Size SF and %:	4,882 SF (22.60	0 %)
16			Proposed Roof Deck Area SF and % (Note: Maximum is 25% of the enclosed floor area immediately below):	N/A	

	Zoning Information / Calculations	Required	Existing	Proposed	Deficiencies	
17	Height:	27'-0" MIDPOINT		31'-0" MIDPOINT	4'-0" WAIVER REQUIF	RE
18	Setbacks:					
19	Front First level:	20'-0"		41'-0"		
20	Front Second level:	30'-0"		56'-0"		
21	Side 1: NORTH SIDE 1:	12'-6" MIN.		13'-5"		
22	Side 2 or (facing street): SOUTH SIDE 2:	12'-6" MIN.		13'-5"		
23	Rear:	32'-6"		49'-6"		
	Accessory Structure Side 1:	N/A		N/A		
24	Accessory Structure Side 2 or (facing street) :	N / A		N/A		
25	Accessory Structure Rear:	N/A		N/A		
26	Sum of side yard :	25'-0" MIN.		26'-10"		
27	Located within a Local Historic District?	·		Yes or N	0	
28	Designated as an individual Historic Single Family Residence Site?			Yes or N	0	
29	Determined to be Architecturally Significant	?		Yes or N	0	
	Additional data or information must be pres	ented in the format outlined	in this section			

Notes:

If not applicable write N/A

App/PlanRev1-16v.1

SHEET	INDEX
NUMBER	SHEET NAME
	ARCHITECTURAL DRAWINGS
A0.00	COVER
A0.01	PROJECT DATA / DRAWING INDEX & GENERAL NOTES
	SURVEY
A0.02	LOCATION KEY
A0.03	CONTEXT IMAGES
A0.04	CONTEXT IMAGES
A0.05	CONTEXT IMAGES
A1.01	RENDERINGS
A1.02	RENDERINGS
A1.10	ZONING DIAGRAMS - PERVIOUS REQ.
A1.11	ZONING DIAGRAMS - LOT COVERAGE
A1.12	ZONING DIAGRAMS - UNIT SIZE LEVEL 1
A1.13	ZONING DIAGRAMS - UNIT SIZE LEVEL 2
A1.20	CONTEXT ELEVATIONS
A1.21	CONTEXT ELEVATIONS
A1.21	UNDERSTORY DIAGRAM
A1.30	FRONT RENDERING
A1.31	REAR RENDERING
A1.32	AXONOMETRIC
A1.33	AXONOMETRIC
A1.34	AXONOMETRIC
A1.35	AXONOMETRIC
A2.00	EXISTING SURVEY
A2.01	SITE PLAN
A3.01	LEVEL 1 FLOOR PLAN
A3.02	LEVEL 2 FLOOR PLAN
A3.03	ROOF PLAN
A4.01	FRONT & REAR ELEVATIONS
A4.02	WEST & EAST ELEVATIONS
A4.03	RENDERED FRONT & REAR ELEVATIONS
A4.04	RENDERED WEST & EAST ELEVATIONS
A5.01	SECTIONS
A5.02	SECTIONS
A5.10	SITE SECTIONS
	LANDSCAPE DRAWINGS
	CIVIL DRAWINGS
	MEP DRAWINGS

<u>^</u> .			
2 .			
. 💰 .			
<u>4</u> .			
5 .			
6 .			
<u></u>			
<u>*</u>			
<u>\$</u> .			
<u>√9</u> .			
<u>/10\</u> ·			
<u>/ih</u> .			
<u>/12\</u> .			
٦			
Rev.	Date	Rev.	Dat
ALL DRAWINGS AND WRITTE	N MATERIAL APPEARING HEREI OT BE DUPLICATED, USED, OR D OBI KARP ARCHITECTURE & INT	N CONSTITUTE THE ORIGINAL ORIGINA ORIGINA ORIGINA ORIGINA ORIGINA ORIGINA O	INAL AND UNPUBLISHED WORK
KOBI KANP AIA, AND MAY NO	DBI KARP ARCHITECTURE & INT	TERIOR DESIGN, INC. AIA.	(c) 2020
PRIVATE	RESIDE	NCE	
6470 ALLISON			
MIAMI BEACH	, FL 33141		
Owner:			
Name Address			
Address Address Tel:			
Tel: Email			
Consultant:			
Name			
Address Address			
Tel: Email			
Consultant: Name			
Address Address			
Tel: Email			
Consultant:			
Name Address			
Address Tel:			
Email			
Architect:			
Kobi Karp Architect 571 NW 28th Stree	ure and Interior Des	sign, Inc.	
Kobi Karp Architect 571 NW 28th Stree Miami, Florida 3312 Tel: +1(305) 573	ure and Interior Des t, 27 USA 1818 3766	sign, Inc.	



DATA SHEET

	Date	04-11-2022	Sheet No.	
_	Scale		A0.01	
	Project	0000		



E1 - 6470 ALLISON RD - VIEW TO FRONT (EXISTING STRUCTURE)



E2 - 6470 ALLISON RD - VIEW TO NORTH SIDE (EXISTING STRUCTURE)



E3 - 6470 ALLISON RD - VIEW TO SOUTH SIDE (EXISTING STRUCTURE)



E4 - 6470 ALLISON RD - VIEW TO REAR (EXISTING STRUCTURE)

1	EXISTING CONDITIONS

IMAGES ON SHEET A0.05-EXISTING PROPERTY
E1 - FRONT YARD
E2 - SIDE YARD - NORTH
E3 - SIDE YARD - SOUTH
E4 - REAR YARD

NO SCALE

Architect:
Kobi Karp Architecture and Interior Design, Inc.
571 NW 28th Street,
Miami, Florida 33127 USA
Tel: +1(305) 573 1818
Fax: +1(305) 573 3766



KOBI KARP Lic. # AR0012578

EXISTING CONDITIONS

H	Date	04-11-2022	Sheet No.
_	Scale	**	A0.03
	Project	0000	




N1 - 6480 ALLISON RD (NEIGHBOR)



N2 - 6450 ALLISON RD (NEIGHBOR)



N5 - 6445 ALLISON RD (NEIGHBOR)

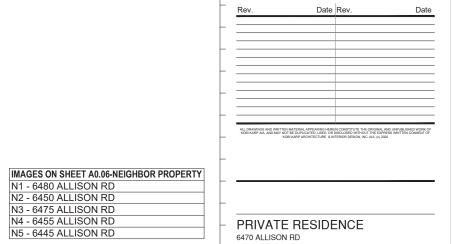

Architect:
Kobi Karp Architecture and Interior Design, Inc.
571 NW 28th Street,
Miami, Florida 33127 USA
Tel: +1(305) 573 1818
Fax: +1(305) 573 3766



KOBI KARP Lic. # AR0012578

CONTEXT IMAGES


-	Date	04-11-2022	Sheet No.	
-	Scale	**	A0.04	
	Project	0000		



N3 - 6475 ALLISON RD (NEIGHBOR)



N4 - 6455 ALLISON RD (NEIGHBOR)

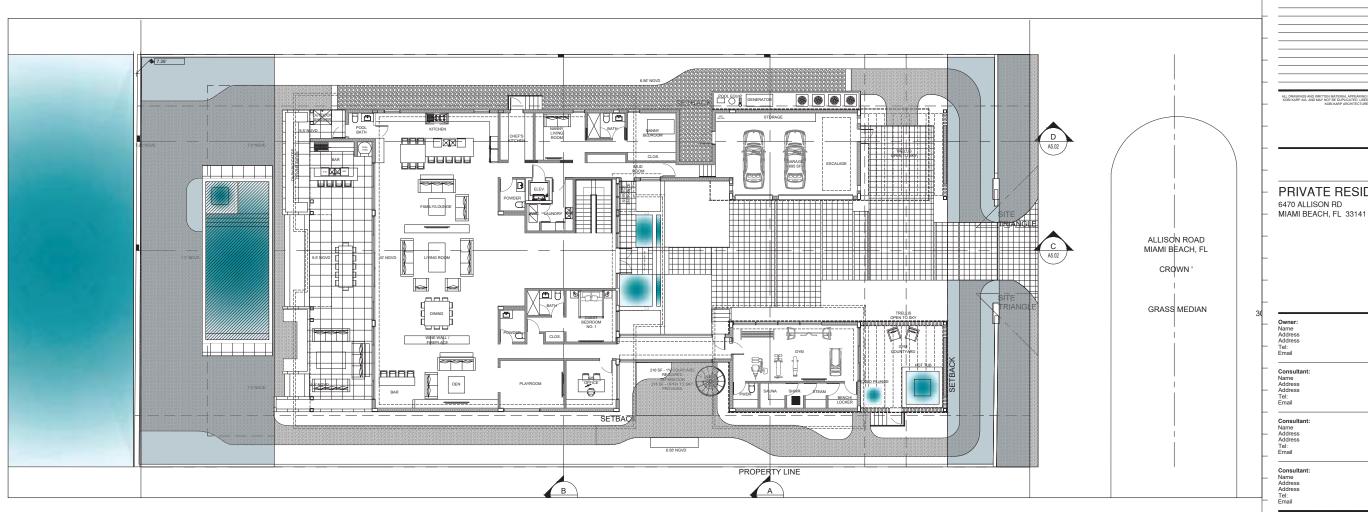

PROPOSED PERVIOUS CALCULATION REQUIRED FRONT YARD (30'-0" SETBACK)
2,000 SF = 1,000 SF (50%) MIN. PERVIOUS SPACE REQUIRED
1,623 (81.15%) PERVIOUS SPACE PROPOSED REQUIRED REAR YARD

3,235 SF = 2,278 SF (70%) MIN. PERVIOUS SPACE REQUIRED 2,696 SF (83.33%) PERVIOUS SPACE PROPOSED

PERVIOUS CALCULATIONS

Rev.	Date	Rev.	Date
KOBI KARP AIA, AND MAY NOT	BE DUPLICATED, USED, OR I	IN CONSTITUTE THE ORIGINAL AND DISCLOSED WITHOUT THE EXPRESS TERIOR DESIGN, INC. AIA. (c) 2020	UNPUBLISHED WORK OF 8 WRITTEN CONSENT OF

PRIVATE RESIDENCE

Architect:
Kobi Karp Architecture and Interior Design, Inc.
571 NW 28th Shreet,
Miami, Florida 33127 USA
Tel: +1(305) 573 1818
Fax: +1(305) 573 3766


KOBI KARP





ZONING DIAGRAMS

Sheet No. A1.10 Scale --Project 0000

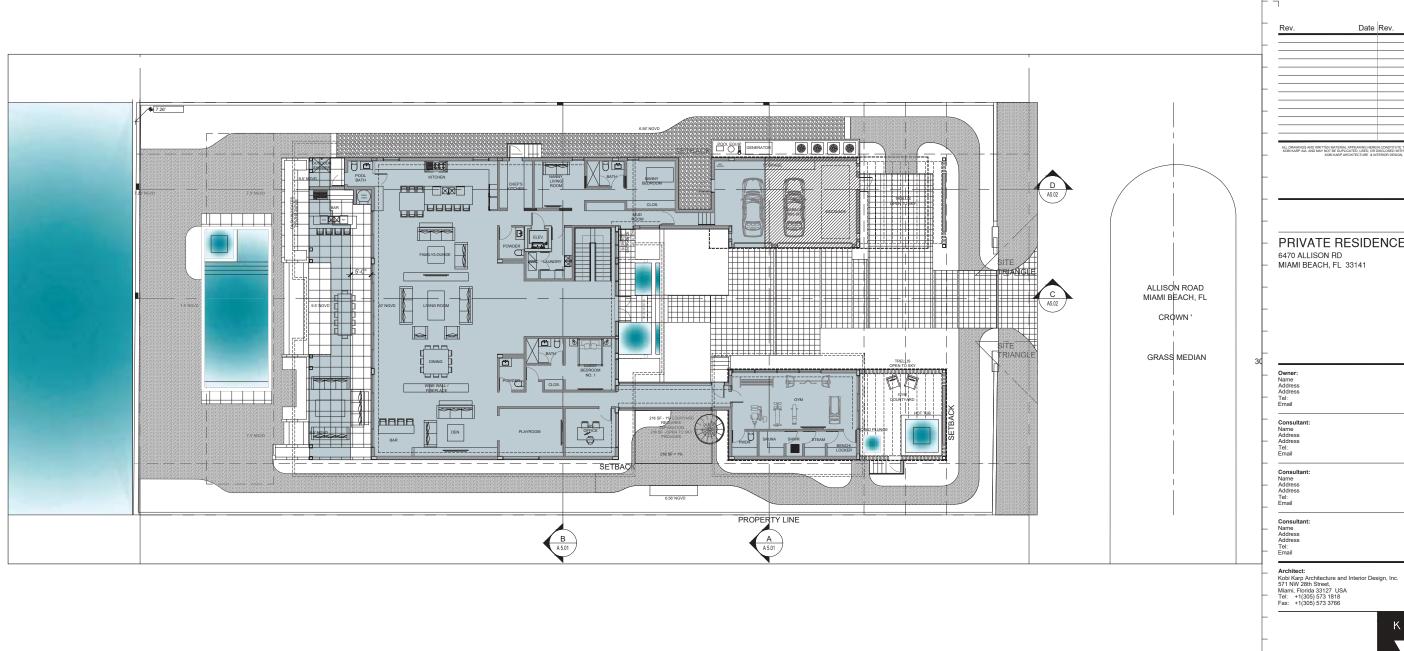

PROPOSED LOT COVERAGE CALCULATION

6,431 SF (29.77%)

LOT SIZE
21,600 SF
MAXIMUM LOT COVERAGE
6,480 SF (30.00%)
MAIN RESIDENCE 6,

TOTAL

PRIVATE RESIDENCE 6470 ALLISON RD MIAMI BEACH, FL 33141


KOBI KARP Lic. # AR0012578

Scale: 3/32" = 1'-0"

1 LOT COVERAGE

ZONING DIAGRAMS

Date	04-11-2022	Sheet No.	
Scale		A1.11	
Project	0000		

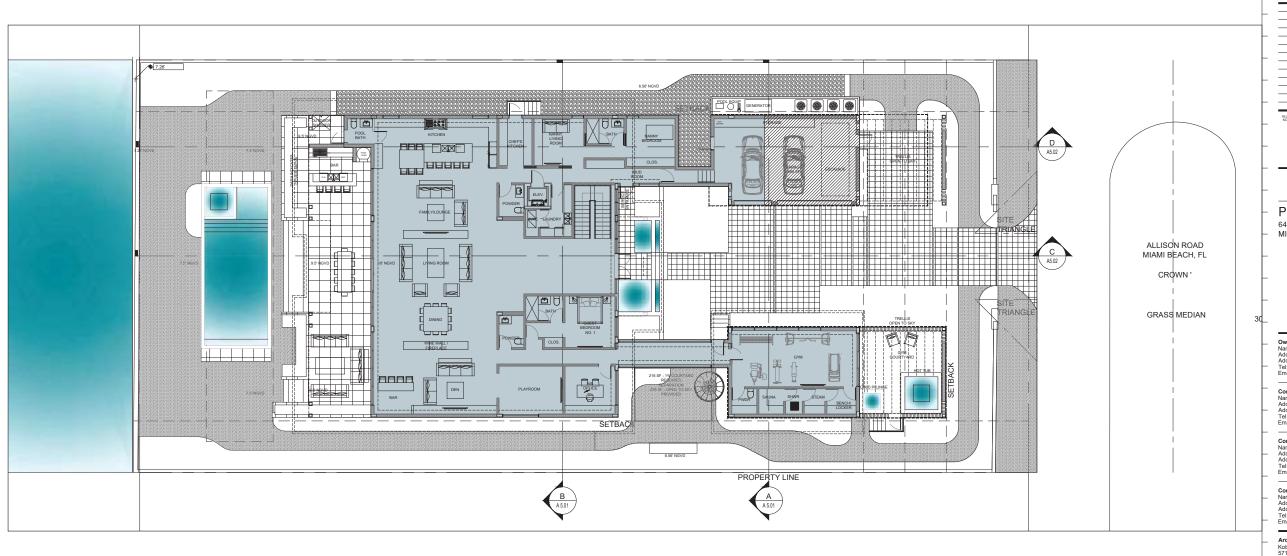

PRIVATE RESIDENCE 6470 ALLISON RD MIAMI BEACH, FL 33141 Architect:
Kobi Karp Architecture and Interior Design, Inc.
571 NW 28th Street,
Miami, Florida 33127 USA
Tel: +1(305) 573 1818
Fax: +1(305) 573 3766

PROPOSED TOTAL UNIT SIZE CALCULATION	
LEVEL 1 MAIN RESIDENCE	5,879 SF
LEVEL 1 GARAGE LEVEL 2 MAIN RESIDENCE	500 SF NOT INCLUDED 4,882 SF
LEVEL ROOF	0 SF
TOTAL	10,761 SF (49.81%)

LOT SIZE = 21,600 SF MAX 11,300 SF MAIN RESIDENCE = 10,761 SF (49.81%)

PROPOSED UNIT SIZE CALCULATION LEV	/EL 1	ı
MAIN RESIDENCE	5,879 SF	
ΤΟΤΔΙ	5.879 SF	(27.21%)

UNIT SIZES


Scale: 1/8" = 1'-0"

KOBI KARP Lic. # AR0012578

Date 04-11-2022 Sheet No.

Scale -- Project 0000

ZONING DIAGRAMS

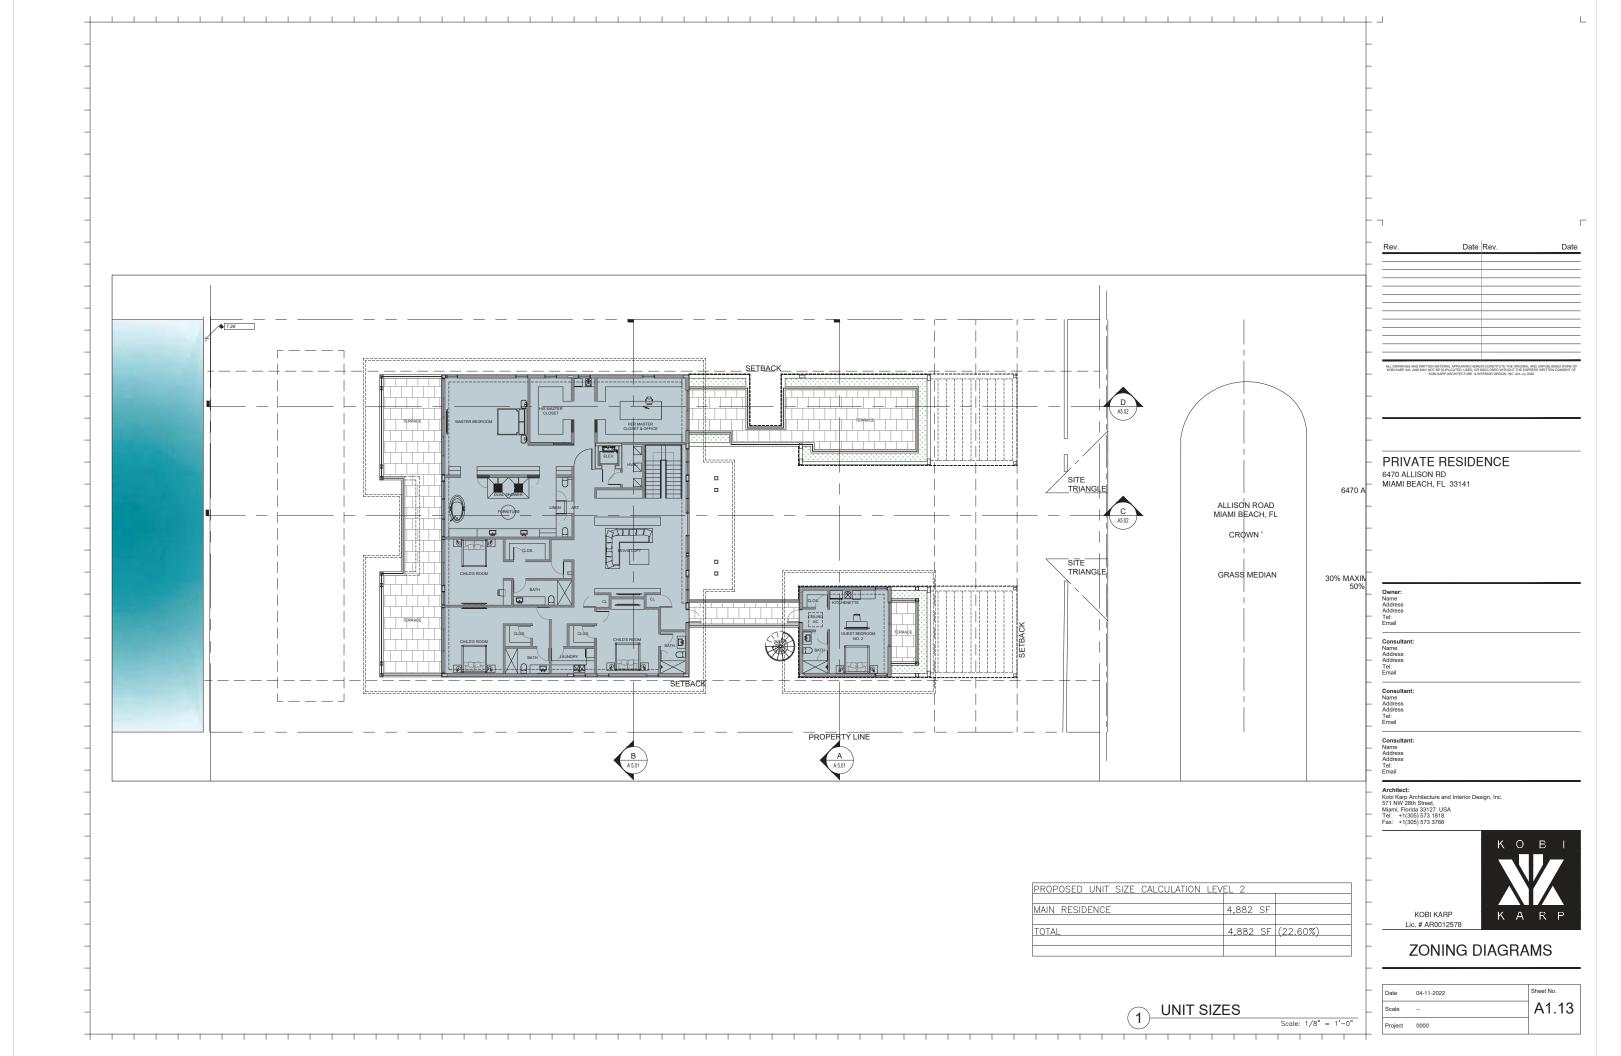










CONTEXT ELEVATIONS (FRONT VIEW)

Scale: 3/32" = 1'-0"

PRIVATE RESIDENCE 6470 ALLISON RD MIAMI BEACH, FL 33141

6480 ALLISON RD., MIAMI BEACH, FL 33141



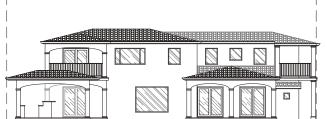

EXISTING REAR OF 6470 ALLISON RD., MIAMI BEACH, FL 33141





KOBI KARP Lic. # AR0012578


Architect:
Kobi Karp Architecture and Interior Design, Inc.
571 NW 28th Street,
Miami, Florida 33127 USA
Tel: +1(305) 573 1818
Fax: +1(305) 573 3766

CONTEXT ELEVATIONS

A1.20 Scale --

2 CONTEXT ELEVATIONS (REAR VIEW)



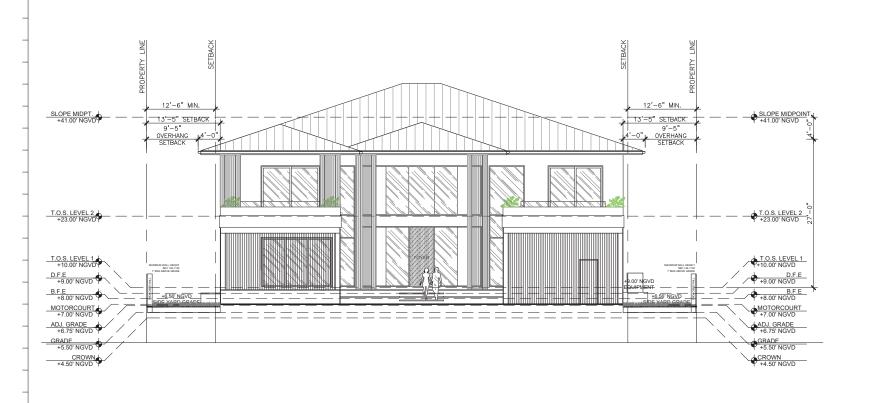





ELEVATION MATERIAL LEGEND









1 - METAL ROOF

2 - DARK STONE 3 - LIGHT STONE


4- WOOD SOFFIT







6 - LOUVERED Z-RAIL SCREEN

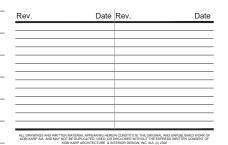

PRIVATE RESIDENCE 6470 ALLISON RD MIAMI BEACH, FL 33141

Owner:		
Name		
Address		
Address		
Tel:		
Email		
Email		
Consultant:		
Name		
Address		
Address		
Tel:		
Email		
Consultant:		
Name		
Address		
Address		
Tel:		
Email		
Consultant:		
Name		
Address		
Addross		


Architect:
Kobi Karp Architecture and Interior Design, Inc.
571 NW 28th Street,
Miami, Florida 33127 USA
Tel: +1(305) 573 1818
Fax: +1(305) 573 3766



ELEVATIONS

-	Date	04-11-2022	Sheet No.
_	Scale	**	A4.01
	Project	0000	

REAR ELEVATION

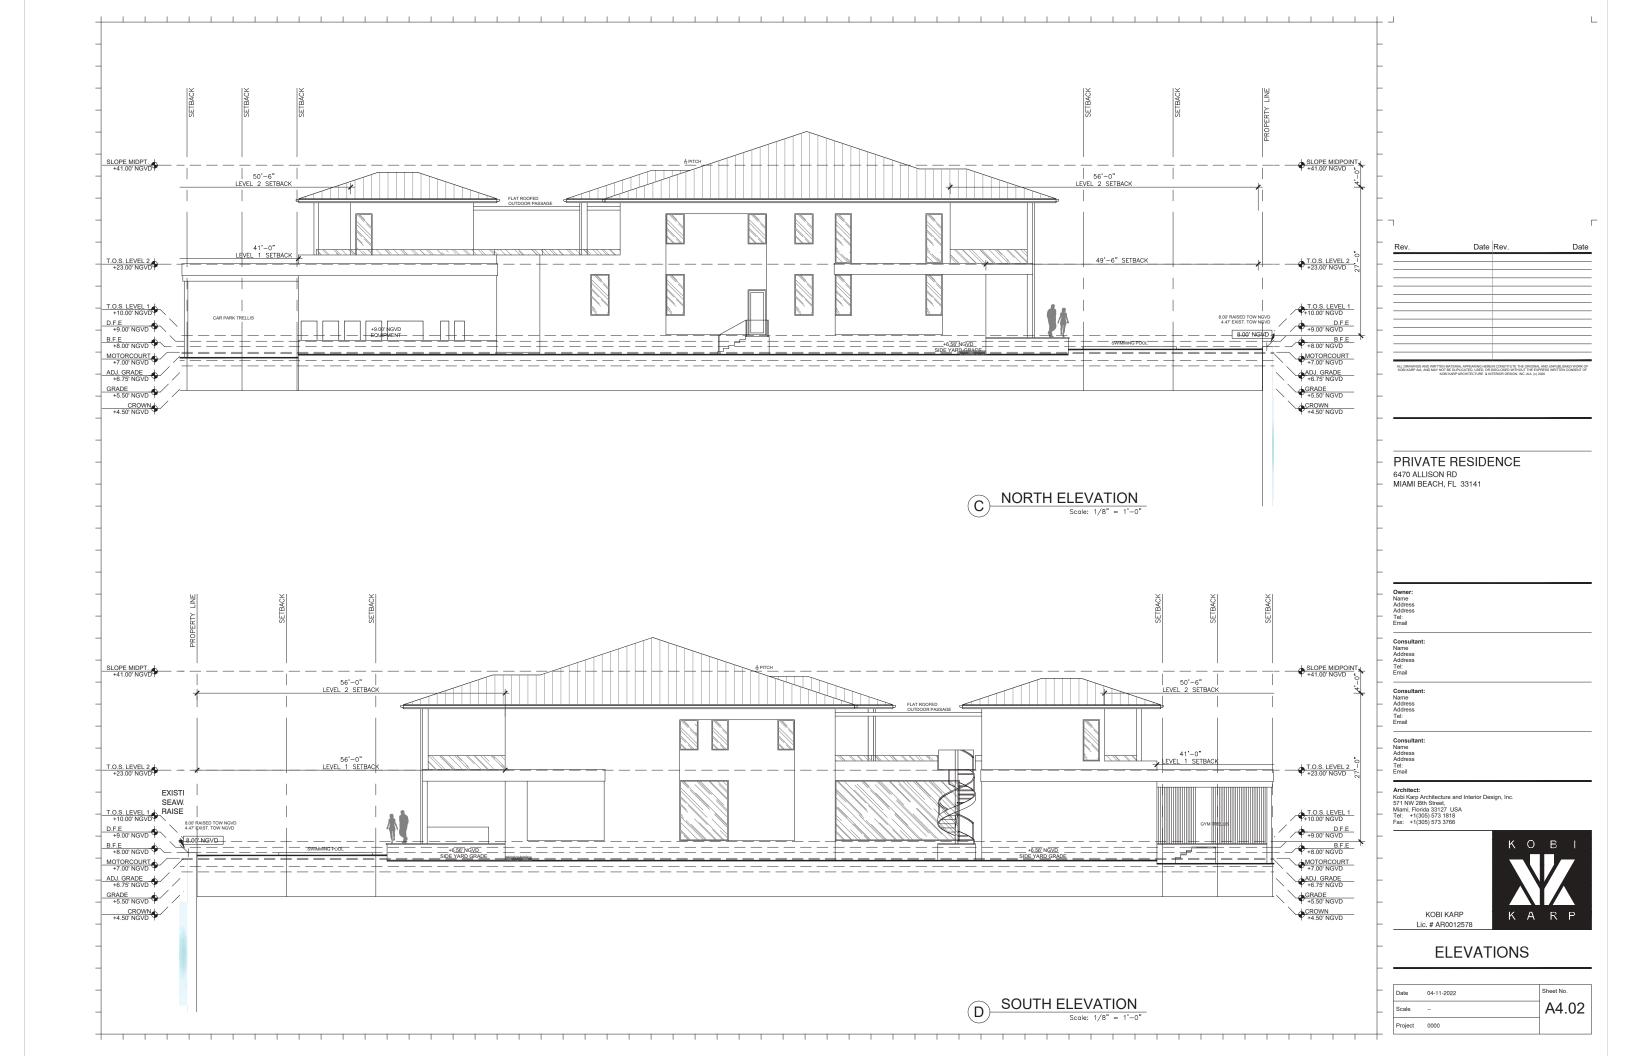







Architect:
Kobi Karp Architecture and Interior Design, Inc.
571 NW 28th Street,
Miami, Florida 33127 USA
Tel: +1(305) 573 1818
Fax: +1(305) 573 3766



KOBI KARP Lic. # AR0012578

RENDERED ELEVATIONS

Sheet No. Scale --A4.03 Project 0000



NORTH ELEVATION

Scale: 1/8" = 1'-0"


D SOUTH ELEVATION




KOBI KARP Lic. # AR0012578

Sheet No. Scale --A4.04



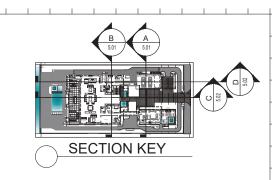



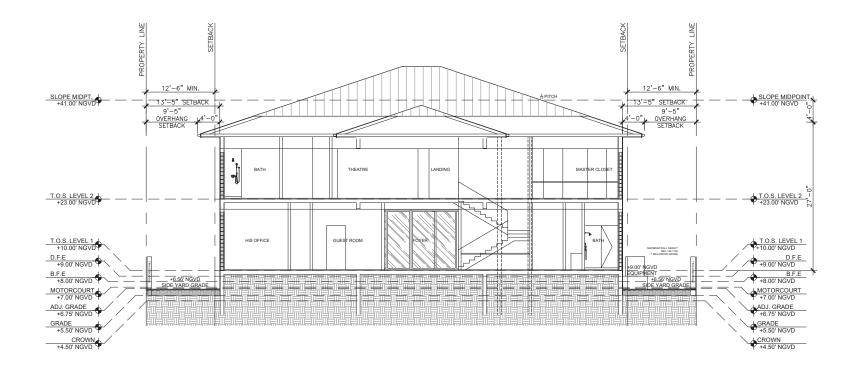



SECTIONS

KOBI KARP Lic. # AR0012578

F	Date	04-11-2022	Sheet No.
L	Scale		A5.01
	Project	0000	

B SECTIONS
Scale: 1/8"

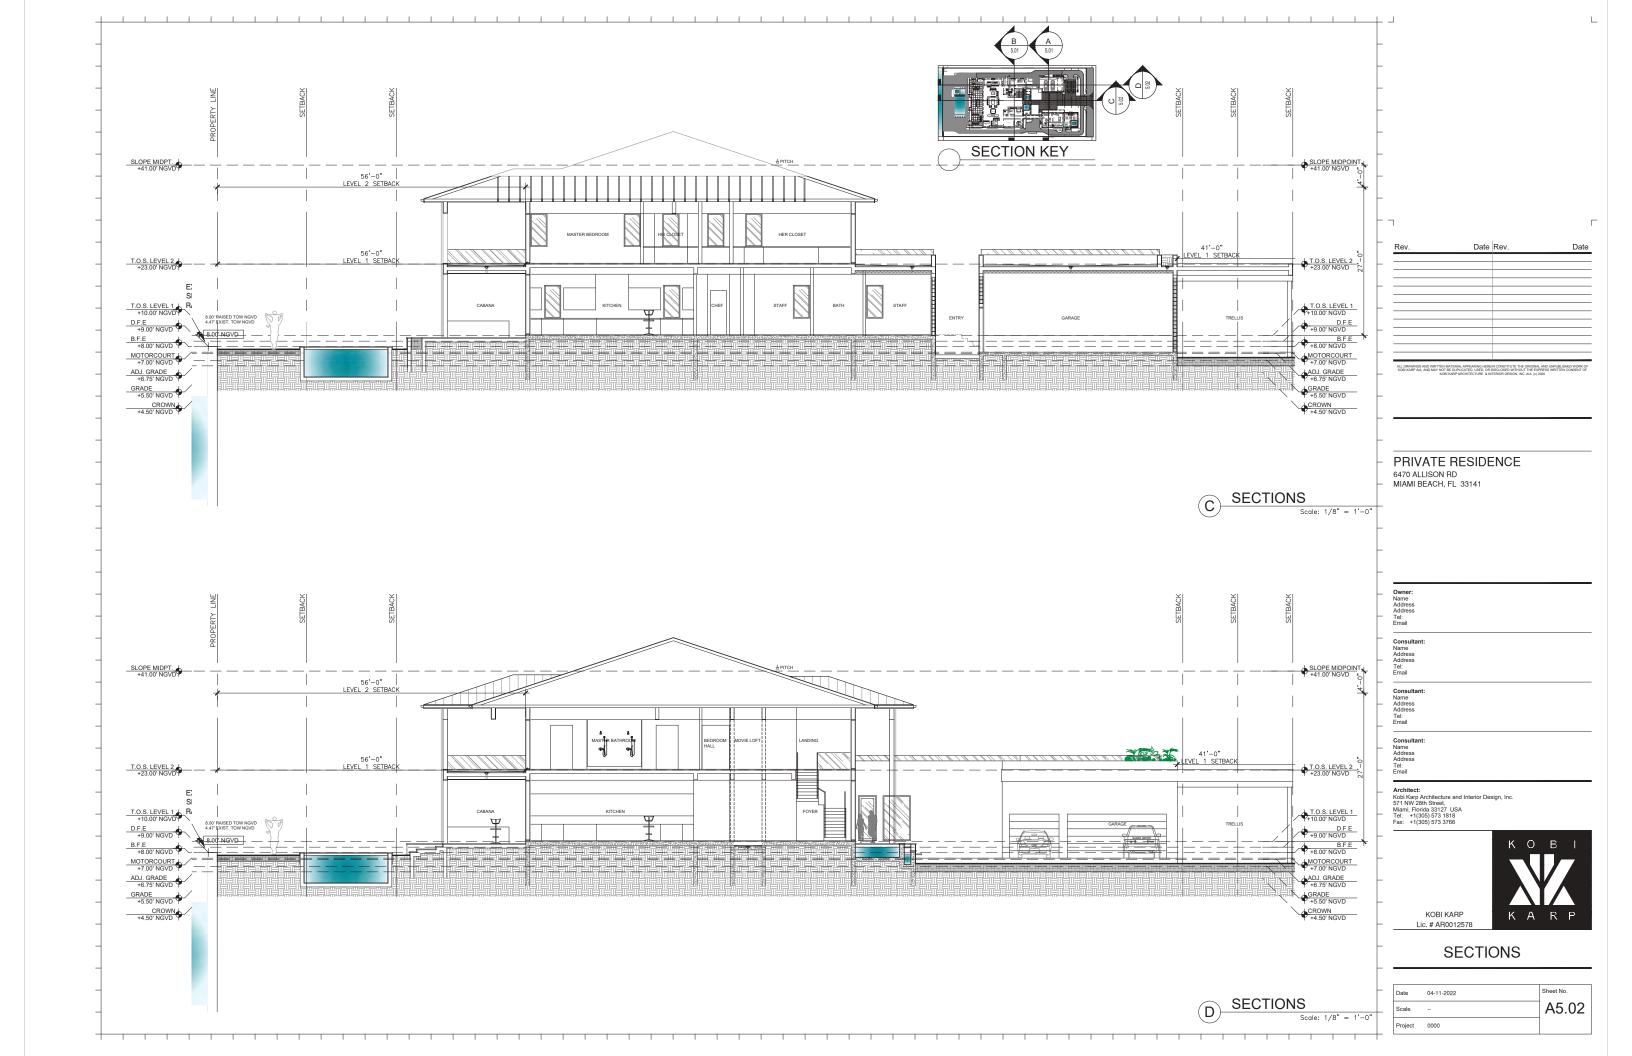

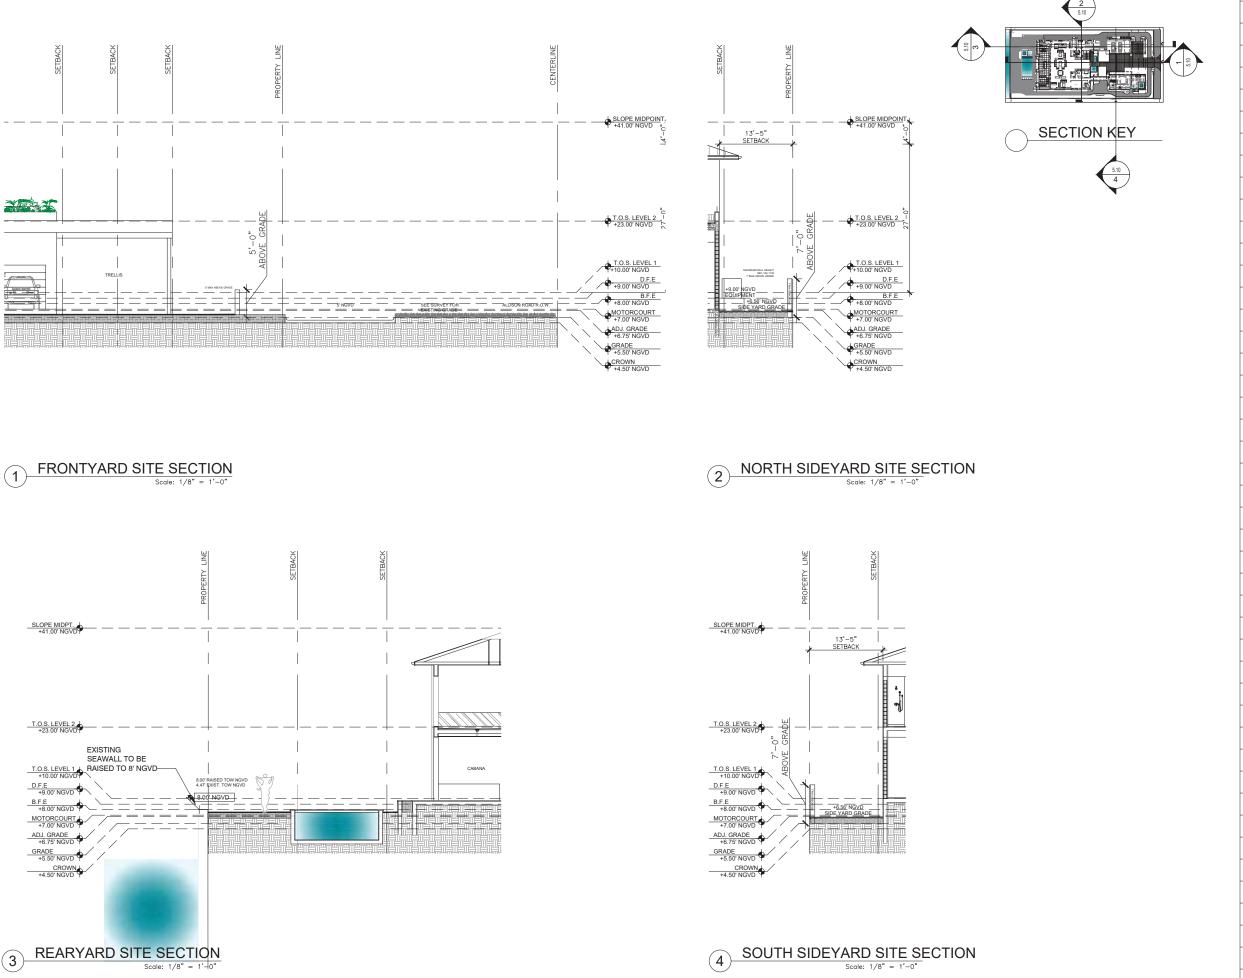

Architect:
Kobi Karp Architecture and Interior Design, Inc.
571 NW 28th Street,
Miami, Florida 33127 USA.
Tel: +1(305) 573 1818
Fax: +1(305) 573 3766



KOBI KARP Lic. # AR0012578

SITE SECTIONS

_	Date	04-11-2022	Sheet No.	
_	Scale		A5.10	
	Project	0000		

LOCATION MAP





SCOPE OF WORK

THE FOLLOWING DRAWINGS ILLUSTRATE THE PROPOSED SCOPE OF WORK FOR **6470 ALLISON ROAD** TO BE APPROVED BY MIAMI DADE COUNTY:

- INSTALLATION NEW LANDSCAPE PLANTINGS
 INSTALLATION OF NEW IRRIGATION SYSTEM
 INSTALLATION OF NEW HARDSCAPE
 INSTALLATION OF NEW FRONT ENTRY DRIVEWAY
 INSTALLATION OF NEW LANDSCAPE LIGHTING



357 cypress drive, 10 tequesta, fl 33469 561.402.9414

www.nielsenlandarch.com

THE SALTER GARDEN


ond Garden 1970 ALLISON RD. IMMM BEACH, FLORIDAS 23147

04.06.2022

COVER PAGE DATE ISSUE

03.21.2022 COORDINATION 04.06.2022 REVISION 1



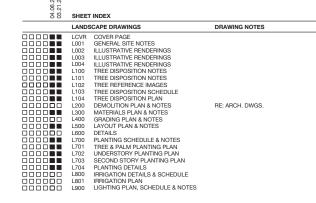

SITEWORK GENERAL NOTES

- THE GENERAL CONTRACTOR SHALL BE RESPONSIBLE FOR COORDINATING ALL WORK BY THE SUBCONTRACTORS
- CONTRACTOR SHALL VERIFY ALL CONDITIONS AT JOB SITE AND NOTIFY LANDSCAPE ARCHITECT AND GENERAL CONTRACTOR OF DIMENSIONAL ERRORS, OMISSIONS OR
- CONTRACTOR TO OBTAIN ALL NECESSARY PERMITS PRIOR TO CONSTRUCTION. ALL CONTRACTORS MUST COMPLY WITH PERMIT REQUIREMENTS, LOCAL, STATE AND FEDERAL JURISDICTIONS AND GOVERNING BODIES/AGENCIES RULES AND REGULATIONS AND LAND USE APPROVAL CONDITIONS AT ALL TIMES.
- WORK PERFORMED WITHOUT APPROVAL OF LOCAL, STATE AND FEDERAL JURISDICTIONS AND GOVERNING BODIES/AGENCIES AND/OR NOT IN COMPLIANCE WITH SPECIFICATIONS AND/OR DRAWINGS IS SUBJECT TO REMOVAL AT CONTRACTOR'S
- ALL WORK SHALL CONFORM TO THE APPROPRIATE AGENCIES. CONTRACTOR SHALL VERIFY LOCATION OF ALL EXISTING UTILITIES, LINES AND STRUCTURES PRIOR TO EXCAVATION OR TRENCHING. DAMAGE SHALL BE REPAIRED BY THE CONTRACTOR AT NO COST TO THE OWNER. THE LANDSCAPE ARCHITECT ASSUMES NO RESPONSIBILITY FOR UTILITIES OR STRUCTURES NOT SHOWN ON THE DRAWINGS. CONTRACTOR IS TO VERIFY THE EXACT LOCATION OF UTILITIES PRIOR TO CONSTRUCTION AND NOTIFY THE LANDSCAPE ARCHITECT OF ANY DISCREPANCIES. CONTRACTOR SHALL LISE EXTREME CAUTION WHEN WORKING OVER OR NEAR EXISTING GAS AND ELECTRICAL LINES.
- THE CONTRACTOR SHALL BE RESPONSIBLE FOR RESETTING ALL LAND MONUMENTS. DISRUPTED BY CONSTRUCTION ACTIVITIES OR NEGLIGENCE ON THE PART OF THE CONTRACTOR. RESETS SHALL BE PERFORMED UNDER THE SUPERVISION OF A REGISTERED LAND SURVEYOR AND MONUMENT RECORDS MUST BE FILED AS REQUIRED BY STATUTE FOR ALL MONUMENTS.
- THE CONTRACTOR SHALL TAKE ALL PRECAUTIONARY MEASURES NECESSARY TO PROTECT EXISTING IMPROVEMENTS FROM DAMAGE AND ALL SUCH IMPROVEMENTS AND STRUCTURES DAMAGED BY THE CONTRACTOR'S OPERATIONS SHALL BE REPAIRED OR RECONSTRUCTED SATISFACTORY TO THE LANDSCAPE ARCHITECT AT THE CONTRACTOR'S EXPENSE.
- ALL BARRICADING AND TEMPORARY TRAFFIC CONTROL DEVICES OR METHODS USED DURING CONSTRUCTION SHALL BE IN ACCORDANCE WITH LOCAL, STATE AND FEDERAL JURISDICTIONS AND GOVERNING BODIES/AGENCIES STANDARDS. PROVIDE ADEQUATE TIME FOR REVIEW AND APPROVAL BY THE ABOVE JURISDICTIONS PRIOR TO COMMENCEMENT
- THE LANDSCAPE ARCHITECT IS NOT RESPONSIBLE FOR THE CONSTRUCTION MEANS, METHODS, TECHNIQUES, SEQUENCES UTILIZED OR FOR SAFETY PRECAUTIONS OR PROBLEMS IN CONNECTION WITH THE WORK. THE LANDSCAPE ARCHITECT WILL NOT BE RESPONSIBLE FOR THE CONTRACTOR'S FAILURE TO CARRY OUT THE WORK IN ACCORDANCE WITH THE CONTRACT DOCUMENTS. CONTRACT DOCUMENTS INCLUDE THE CONSTRUCTION DOCUMENT DRAWING SET/TECHNICAL SPECIFICATIONS MANUAL /LASIS
- CONTRACTOR TO VERIFY ALL QUANTITIES. IN CASE OF ANY DISCREPANCIES, GRAPHICALLY SHOWN MATERIAL QUANTITIES SHALL TAKE PRECEDENCE.
- A SYSTEM OF DIAGRAMMATIC SYMBOLS, HATCHES AND NOTATIONS IS USED IN THESE DRAWINGS. REVIEW NOTATIONS CAREFULLY, NOTIFY LANDSCAPE ARCHITECT AND REQUEST CLARIFICATION OF ANY UNCLEAR NOTATION OR DISCREPANCY PRIOR TO COMMENCING WORK

SITEWORK GENERAL NOTES CONTINUED

- PROVIDE SLEEVES AS REQUIRED FOR DRAINAGE, IRRIGATION AND ELECTRICAL LINES IRRIGATION AND ELECTRICAL SLEEVES AND SUBSUBFACE DRAINAGE SYSTEMS SHALL BE CONSTRUCTED PRIOR TO PAVING AND LANDSCAPE WORK UTILITY SLEEVES ARE REQUIRED IN ALL PLANT BEDS ISOLATED BY PAVEMENT OR ANY OTHER STRUCTURES.
- SPECIAL CONSIDERATION IS GIVEN TO THE DESIGN AND INTENDED RELATIONSHIP BETWEEN ARCHITECTURE, PLANTING AREAS AND PAVING SYSTEMS. PAVEMENT JOINTING, PAVERS, STONE, FINISHES AND GRADES HAVE BEEN STRICTLY COORDINATED IN THE CONTRACT DOCUMENTS. CONSTRUCTION OF THESE SYSTEMS SHALL BE STRICTLY COORDINATED.
- VEHICLES FOLIPMENT AND/OR MATERIALS SHALL NOT BE PARKED OR STORED IN AREAS OF EXISTING VEGETATION, INCLUDING WITHIN THE DRIPLINE OF EXISTING
- CONSTRUCTION WASTE-INCLUDING BUT NOT LIMITED TO: PLANT MATERIAL BUILDING MATERIALS, DEMOLISHED MATERIALS, PACKAGING, LEFTOVER PAINT AND CONCRETE SLURRY-SHOULD BE PROPERLY REUSED, RECYCLED, DISPOSED OF LEGALLY OFF-SITE OR IN DESIGNATED WASH-OUT AREAS DETERMINED BY THE GENERAL CONTRACTOR
- RECYCLING AND TRASH BINS TO BE PROVIDED ON SITE. SEPARATE BINS FOR CARDBOARD CO-MINGLED AND OTHER RECYCLARI E/RELISABLE MATERIALS IDENTIFIED BY THE LOCAL JURISDICTION SHALL BE MAINTAINED. ALL BINS TO BE WILDLIFE-PROOF
- ON-SITE FUEL STORAGE FOR CONSTRUCTION EQUIPMENT IS DISCOURAGED. CONSTRUCTION EQUIPMENT USED ON SITE TO BE CHECKED REGULARLY TO ASSURE CONTAMINATION CONCERNS FROM OILS AND GREASES ARE ELIMINATED. NO TOXIC MATERIALS SHALL BE STORED ON-SITE
- GENERAL CONTRACTOR TO KEEP ALL ITEMS IMPLEMENTED BY LANDSCAPE ARCHITECT IN PROPER WORKING ORDER THROUGHOUT THE DURATION OF THE PROJECT
- THE CONSTRUCTION SITE TO BE INSPECTED ON A MONTHLY BASIS BY LANDSCAPE ARCHITECT AND/OR CIVIL ENGINEER TO ASSURE THAT THE SILT FENCE AND MUD TRACKING PAD ARE PROPERLY IN PLACE AND FUNCTIONING AS DESIGNED.
- GREEN BUILDING PRACTICES SHALL BE EMPLOYED TO THE EXTENT FEASIBLE. SUCH PRACTICES INCLUDE: CARPOOLING/VANPOOLING TO JOB SITE, MINIMIZING MATERIALS PACKING REFORE ARRIVAL TO JOB SITE REDUCING
- THE PROJECT LIMIT OF CONSTRUCTION AND ALL EXISTING VEGETATION TO REMAIN IS TO BE CLEARLY DEFINED BY STURDY, WEATHERPROOF FENCING AT A MINIMUM OF FOUR (4) FEET HIGH.
- WATERPROOFING OF SUBGRADE AND OTHER ARCHITECTURAL SPACES BELOW AND/OR ADJACENT TO IMPROVEMENTS DESIGNED BY THE LANDSCAPE ARCHITECT IS TO BE ADEQUATELY DESIGNED AND DETAILED BY OTHERS TO PERMANENTLY REPEL ALL WATER SOURCES INCLUDING, BUT NOT LIMITED TO: PRECIPITATION, STORM WATER RUNOFF, GROUND WATER, IRRIGATION, ROOF RUNOFF, GROUND WATER, AND PLUMBING LEAKS.
- STRUCTURAL DESIGN TO SUPPORT IMPROVEMENTS DESIGNED BY THE LANDSCAPE ARCHITECT AND LOCATED ABOVE, BELOW, AND/OR ADJACENT TO SUBGRADE AND OTHER ARCHITECTURAL SPACES IS THE RESPONSIBILITY OF THE STRUCTURAL ENGINEER. THE STRUCTURAL DESIGN SHOULD BE ADEQUATELY DESIGNED TO SUPPORT ALL POSSIBLE LOADS INCLUDING, BUT NOT LIMITED TO: BACKFILL, COMPACTION PLANTINGS HARDSCAPES RETAINING AND ERFESTANDING SITE WALLS, AND CONSTRUCTION MATERIALS/EQUIPMENT/ACTIVITY.

SOIL EROSION CONTROL NOTES

- PRIOR TO BEGINNING ANY EARTH CHANGE, THE CONTRACTOR SHALL INSTALL AND MAINTAIN ALL SESC MEASURES AS SHOWN ON THE CONTRACT DOCUMENTS AND AS
- ALL SESC MEASURES TO BE MAINTAINED DAILY.
- THE CONTRACTOR TO CONDUCT ALL EXCAVATION, FILLING, GRADING, AND CLEANUP OPERATIONS IN A MANNER SUCH THAT SEDIMENT, GENERATED BY WIND OR WATER IS NOT DISCHARGED INTO ANY STORM SEWER, DRAINAGE DITCH, RIVER, LAKE, AIR, OR UNDERGROUND UTILITY SYSTEM. STAGE WORK TO MINIMIZE THE AREA OF EXPOSED SOIL, THEREBY REDUCING THE OPPORTUNITY FOR SOIL EROSION.
- WATER FROM TRENCHES AND OTHER EXCAVATION TO BE PUMPED INTO A FILTRATION BAG TO REMOVE SEDIMENTS FROM THE WATER.
- NORTH AMERICAN GREEN SC-150 OR EQUIVALENT EROSION CONTROL FABRIC IS REQUIRED ON ALL DISTURBED SLOPES GREATER THAN 3:1 UNTIL PROJECT AREA IS REVEGETATED PER THE PLANTING PLAN.
- 6. PROVIDE POSITIVE DRAINAGE AWAY FROM ALL STRUCTURES.
- CONTRACTOR TO PROVIDE ONSITE WATERING TO REDUCE FUGITIVE DUST LEAVING THE
- SOIL EROSION CONTROL MEASURES TO BE PROVIDED FOR ALL EXISTING AND PROPOSED
- CONSTRUCTION STAGING AND PHASING SHALL OCCUR, WHERE APPLICABLE, TO
- 10. BEST MANAGEMENT PRACTICES (BMPs) SHALL BE ADJUSTED AS NEEDED TO MEET ANY OTHER LINEORESEEN CONDITION'S
- 11. THE GENERAL CONTRACTOR IS RESPONSIBLE FOR INSTALLING A MUD TRACKING PAD/WASHING PAD AT THE CONSTRUCTION ENTRANCES TO MINIMIZE MUD DETACHMENT FROM TRUCK TIRES. 1-1/2 INCH SCREENED ROCK TO BE PLACED ON MIRAFI 140-N FILTER FABRIC. ADDITIONAL CLEAN GRAVEL TO BE ADDED THROUGHOUT THE DURATION OF
- 12. CONTRACTOR SHALL ABIDE BY THE LOCAL STATE AND FEDERAL JURISDICTIONS AND
- 13. RESEED AS INDICATED IN SEEDING NOTES.



www.nielsenlandarch.com





SEAL (S TYLER NIELSEN - LA6667067)



GENERAL SITE NOTES ISSUE

03.21.2022 COORDINATION 04.06.2022 REVISION 1



357 cypress drive, tequesta, fl 33469 561.402.9414

www.nielsenlandarch.com

THE SALTER GARDEN

ond of the Companies of the Companies

SEAL (S TYLER NIELSEN - LA6667067)



ILLUSTRATIVE SITE PLAN

ISSUE

03.21.2022 COORDINATION 04.06.2022 REVISION 1



5. HOT PLUNGE

6. MAIN ENTRY

7. WATER FEATURE

12. GRAVEL WALKWAY

13 ZOYSIA ZEON LAWN

14. IPE DOCK

8. SPECIMEN FLOWERING TREE

CONTRACTOR QUALIFICATIONS

- 1. CONTRACTOR MUST BE A LICENSED LANDSCAPE CONTRACTOR.
- 2 CONTRACTOR MUST HAVE A MINIMUM OF 10 YEARS OF PROVEN EXPERIENCE RELOCATING LARGE SPECIMEN TREES AND PALMS IN SOUTH FLORIDA
- 3 CONTRACTOR MUST HAVE PROVEN EXPERIENCE BELOCATING TREES AND PALMS OF THE SAME SPECIES AND SIZE AS THOSE TO BE RELOCATED FOR THE CURRENT
- 4. CONTRACTOR MUST HAVE A CERTIFIED ARBORIST ON STAFF

CONTRACTOR REQUIREMENTS

- CONTRACTOR MUST VISIT THE JOBSITE AND INSPECT ALL TREES AND PALMS TO BE RELOCATED AS WELL AS EXISTING SITE CONDITIONS AND RESTRICTIONS PRIOR TO PREPARING RID
- 2. CONTRACTOR MUST VERIFY AND ENSURE THAT ALL TREES AND PALMS IDENTIFIED ON THE PLANS AND THOSE TAGGED ON THE JOBSITE CORRESPOND AS TO NUMBER AND DESCRIPTION. ANY DISCREPANCIES MUST BE BROUGHT TO THE ATTENTION OF THE LANDSCAPE ARCHITECT IMMEDIATELY, PRIOR TO PREPARING BID.
- 3. CONTRACTOR MUST CONDUCT ALL WORK ASSOCIATED WITH RELOCATION AND MAINTENANCE OF TREES AND PALMS TO BE RELOCATED. NO WORK IS TO BE SUBCONTRACTED WITHOUT PRIOR WRITTEN CONSENT OF THE OWNER AND/OR LANDSCAPE ARCHITECT.
- CONTRACTOR MUST DESIGNATE A COMPETENT, ENGLISH-SPEAKING SUPERVISOR OR FOREMAN OVERSEE AND DIRECT ALL RELOCATION AND MAINTENANCE ACTIVITIES AS **OUTLINED IN THESE SPECIFICATIONS**
- CONTRACTOR MUST SCHEDULE ROOT PRUNING TO PROVIDE THE MAXIMUM POSSIBLE TIME FOR NEW ROOT GROWTH. EVEN TREES AND PALMS THAT TYPICALLY DO NOT REQUIRE LONG (OR ANY) ROOT PRUNING WILL BENEFIT FROM MORE ROOT PRUNING TIME: THEREFORE, ALL TREES AND PALMS TO BE RELOCATED MUST BE ROOT PRUNED. CONTRACTOR MUST PROVIDE A ROOT PRUNE SCHEDULE FOR EACH TREE OR PALM TO BE RELOCATED AS AN ATTACHMENT TO THE BID.
- CONTRACTOR MUST CALL SUNSHINE 811 TO HAVE ALL UNDERGROUND UTILITIES LOCATED UNDER OR IN THE VICINITY OF THE CURRENT OF FUTURE LOCATIONS OF ALL TREES AND PALMS TO BE RELOCATED PRIOR TO WORK COMMENCING.
- CONTRACTOR MUST VERIFY WITH THE GENERAL CONTRACTOR THE ABSENCE OF ANY UNDERGROUND CONSTRUCTION OR OBSTRUCTIONS (E.G., BULKHEADS, SEPTIC SYSTEMS, ETC.) IN THE CURRENT AND FUTURE LOCATIONS OF ALL TREES AND PALMS TO BE RELOCATED
- 8. CONTRACTOR MUST ALERT THE LANDSCAPE ARCHITECT OF ANY TREES OR PALMS
 THAT WILL NOT SUCCESSFULLY RELOCATE DUE TO POOR HEALTH PRIOR TO BEGINNING
- 9. CONTRACTOR MUST FLAG ALL PROPOSED TRANSPLANT LOCATION FOR THE LANDSCAPE ARCHITECT'S APPROVAL A MINIMUM OF 15 DAYS PRIOR TO RELOCATION.
- 10. CONTRACTOR MUST ENSURE THAT ALL TREES AND PALMS TO BE RELOCATED ARE INSTALLED AT THE CORRECT GRADE OR ELEVATION, ACCORDING TO THE GRADING
- 11. CONTRACTOR MUST BE ENSURE THAT ALL ROOT FLARES ARE EXPOSED AFTER RELOCATION
- 12. CONTRACTOR MUST REMOVE ALL RESIDUAL ROOTS, STUMPS, AND PORTIONS THEREOF AND BACKFILL PITS FROM WHICH RELOCATED TREES AND PALMS WERE REMOVED WITH CLEAN FILL FLUSH WITH THE SURROUNDING GRADE.
- 13. CONTRACTOR MUST BE REPAIR ANY DAMAGE TO OTHER PLANTS, LAWN, HARDSCAPES, OR NEW CONSTRUCTION WITHIN THE RELOCATION AREA AT CONTRACTOR'S EXPENSE. HARDSCAPES INCLUDE BUT ARE NOT LIMITED TO CURBS. WALKS, ROADS, FENCES. SITE
- 14. CONTRACTOR MUST PHOTOGRAPHICALLY DOCUMENT NEW ROOT GROWTH FOLLOWING EACH ROOT PRUNE AND SUBMIT THIS DOCUMENTATION TO THE LANDSCAPE ARCHITECT, THE PURPOSE OF THIS REQUIREMENT IS TO ENSURE THAT SUFFICIENT ROOT GROWTH HAS OCCURRED PRIOR TO THE SECOND AND SUBSEQUENT ROOT PRUNES AND FOLLOWING THE FINAL ROOT PRUNE PRIOR TO RELOCATION
- 15. CONTRACTOR MUST INSTALL AND MAINTAIN PROTECTION FENCING AROUND EACH TREE AND PALM TO BE RELOCATED BOTH DURING ROOT PRUNING AND AFTER RELOCATION. PROTECTION FENCING MUST CONSIST OF GALVANIZED WELDED WIRE FABRIC OR PLASTIC MESH ATTACHED TO 4" X 4" POSTS INSERTED AROUND THE PERIMETER OF THE DRIPLINE OF THE TREE OR PALM. PROTECTION FENCING MUST BE PLUMB, TAUT, AND STURDY AT ALL TIMES AND MUST REMAIN IN PLACE THROUGHOUT THE ROOT PRUNING AND WARRANTY PERIODS, OR AS DIRECTED BY THE LANDSCAPE
- 16. CONTRACTOR MUST OBTAIN ALL NECESSARY OR REQUIRED PERMITS FOR THE RELOCATION AND TRANSPORTATION OF THE TREES AND PALMS TO BE RELOCATED.
- 17. CONTRACTOR MUST GUARANTEE ALL RELOCATED TREES AND PALMS FOR ONE YEAR FROM THE DATE OF RELOCATION TO THE FINAL LOCATION. GUARANTEE MUST INCLUDE REE HEALTH AND SETTLING
- 18. CONTRACTOR MUST PROVIDE ALL MATERIAL NECESSARY TO PERFORM THE WORK COVERED HEREIN, INCLUDING BUT NOT LIMITED TO BACKFILL MATERIAL, PROTECTION FENCING, FLAGGING, ADDITIVES AND SUPPLEMENTS, TEMPORARY IRRIGATION, BURLAP, WIRE, SHRINK WRAP, AND ALL NECESSARY TOOLS AND EQUIPMENT

TREE ROOT PRUNING SPECIFICATIONS

- ALL TREES AND PALMS TO BE RELOCATED MUST BE WATERED DAILY FOR AT LEAST 2-3 DAYS PRIOR TO ANY ROOTS BEING CUT TO ENSURE THAT THEY ARE FULLY HYDRATED. EACH WATERING MUST THOROUGHLY SATURATE THE ROOTBALL TO ITS FULL DEPTH.
- EACH TREE AND PALMS MUST THEN BE WATERED EVERY OTHER DAY, NOT RELYING ON BAIN DUBING THE ENTIRE BOOT PRUNING PROCESS FITHER BY A TEMPORARY IRRIGATION SYSTEM OR BY HAND. EACH WATERING MUST THOROUGHLY SATURATE THE ROOTBALL TO ITS FULL DEPTH
- TREE AND PALM RELOCATION ACTIVITIES MUST BE SCHEDULED SO THAT REMOVAL AND REPLANTING TAKE PLACE IN THE SAME 24-HOUR PERIOD. NO TREES OR PALMS MAY BE "STOCKPILED" ONSITE OR OFFSITE FOR ANY PERIOD OF TIME WITHOUT PRIOR WRITTEN APPROVAL OF THE LANDSCAPE ARCHITECT. WHEN ALLOWED, APPROVAL FOR THE METHOD OF "STOCKPILING" MUST BE OBTAINED FROM THE LANDSCAPE ARCHITECT.
- ALL DIGGING IN THE ROOT ZONE DURING THE ROOT PRUNE PROCESS MUST BE DONE BY HAND: NO MACHINERY WILL BE ALLOWED, PRUNING OF ROOTS MUST BE DONE BY HAND WITH CLEAN, SHARP TOOLS. DO NOT PAINT CUT ROOTS WITH TREE PAINT OR ANY KIND
- MYCORRHIZA (ROOTS® TRANSPLANT OR EQUIVALENT) MUST BE INCORPORATED INTO THE BACKFILL SOIL PRIOR TO BACKFILLING AS PER MANUFACTURER'S RECOMMENDATIONS.
- 6 AFTER EACH ROOT PRUNE FACH SECTION OF BOOTBALL THAT IS PRUNED MUST BE WRAPPED WITH BLACK PLASTIC AND THE TRENCH BACKFILLED WITH ORIGINAL EXCAVATED SOIL. A TREE RING WITH A MINIMUM HEIGHT OF 6" MUST BE CONSTRUCTED 6-12" OUTSIDE THE OUTERMOST EDGE OF THE ROOTBALL AND AROUND THE ENTIRE PERIMETER OF THE ROOTBALL TO DIRECT IRRIGATION WATER AND ANY ADDED SUPPLEMENTS DOWN INTO THE ROOTBALL DURING ROOT REGENERATION
- ONCE THE TREE RING IS CONSTRUCTED AFTER EACH ROOT PRUNE, A HIGH-PHOSPHORUS ROOT STIMULANT MUST BE LIBERALLY APPLIED TO THE SURFACE OF THE ROOTBALL AND THOROUGHLY WATERED IN TO ENCOURAGE NEW ROOT GROWTH.
- PRIOR TO ANY ROOTS BEING CUT. ALL MAJOR ROOTS MUST BE IDENTIFIED TO DETERMINE THE ROOTBALL DIAMETER BASED ON THE RELATIVE LOCATION AND SIZE OF
- MANY TREE RELOCATION SPECIFICATIONS USE "GENERAL RULES" TO CALCULATE MINIMUM ROOTBALL DIAMETER, SUCH AS MULTIPLYING THE DIAMETER AT BREAST HEIGHT (DBH) OF THE TREE BY A FACTOR OF 10 OR ALLOWING A MINIMUM OF 9"-12" OF ROOTBALL FOR EVERY 1" OF TREE CALIPER. OTHERS LIST UNREALISTIC MINIMUM SIZES FOR THE ROOTBALLS OF VARIOUS TREE CALIPERS OR OTHERS LIST UNREALISTIC MINIMUM SIZES FOR THE ROOTBALLS OF VARIOUS TREE CALIPERS OR HEIGHTS. IN MANY CASES, SUCH APPROACHES RESULT IN ROOTBALLS THAT ARE EITHER TOO LARGE OR TOO SMALL FOR A GIVEN TREE. THE FOLLOWING TABLE LIST MINIMUM ROOTBALL DIAMETERS BASED ON REAL-WORLD EXPERIENCE OF TREE RELOCATION SPECIALISTS IN

.CALIPER	MIN. ROOTBALL	CALIPER	MIN. ROOTBALL
(inches)	DIA. (feet)	(inches)	DIA. (feet)
1-4	3	12-14	8
4-5	4	15-17	10
6-7	5	18-24	12-15
8-9	6	25-30	15-25
10-11	7	30+	as needed

- WHENEVER POSSIBLE, ROOTBALLS MUST BE CIRCULAR IN SHAPE WITH AN EQUAL DISTANCE FROM THE TRUNK TO THE EDGE OF BOOTBALL ALL ABOUND.
- MINIMUM ROOTBALL DEPTH MUST BE 24"-36" FOR ALL TREES TO BE RELOCATED, WITH THE ACTUAL DEPTH TO BE DETERMINED ONLY AFTER A THOROUGH EXAMINATION OF ALL ROOTS DURING THE INITIAL ROOT INSPECTION AND BASED ON THE ABSENCE OF MAJOR ROOTS AT THE BOTTOM OF THE ROOTBALL. ROOTBALLS DEEPER THAN 36" MAY BE REQUIRED FOR LARGE SPECIMEN TREES, DEPENDING ON THE RELATIVE LOCATIONS AND DEPTHS OF THE MAJOR ROOTS AS OBSERVED DURING THE INITIAL ROOT
- AS A GENERAL RULE, MINIMUM ROOT PRUNE TIME FOR TREES WITH A DBH OF LESS THAN 10" IS 12 WEEKS. THE FIRST ROOT PRUNE MUST BE ON TWO OPPOSING SIDES OF THE ROOTBALL, WITH THE SECOND ROOT PRUNE ON ONE OF THE OTHER TWO SIDES DONE A MINIMUM OF 6 WEEKS LATER, AND A THIRD ROOT PRUNE ON THE LAST SIDE DONE A MINIMUM OF 3 WEEKS AFTER THAT. THE SECOND AND THIRD ROOT PRUNES MAY ONLY BE DONE WHEN HEALTHY NEW ROOT GROWTH FROM EARLIER ROOT PRUNES IS EVIDENT (SEE SECTION 2.14 ABOVE FOR SPECIFICATIONS ON PHOTOGRAPHICALLY DOCUMENTING NEW ROOT GROWTH DURING THE ROOT PRUNE PROCESS). MORE TIME MAY BE NEEDED DURING THE COOLER MONTHS OF THE YEAR.
- AS A GENERAL RULE, MINIMUM ROOT PRUNE TIME FOR TREES WITH A DBH OF 10" OR GREATER IS 24 WEEKS, THE FIRST ROOT PRUNE MUST BE ON TWO OPPOSING SIDES OF THE ROOTBALL, WITH THE SECOND ROOT PRUNE ON ONE OF THE OTHER TWO SIDES DONE A MINIMUM OF 12 WEEKS LATER, AND A THIRD ROOT PRUNE ON THE LAST SIDE DONE A MINIMUM OF 6 WEEKS AFTER THAT. THE SECOND AND THIRD ROOT PRUNES MAY ONLY BE DONE WHEN HEALTHY NEW ROOT GROWTH FROM EARLIER ROOT PRUNES IS EVIDENT (SEE SECTION 2.14 ABOVE FOR SPECIFICATIONS ON PHOTOGRAPHICALLY DOCUMENTING NEW ROOT GROWTH DURING THE ROOT PRUNE PROCESS). MORE TIME MAY BE NEEDED DURING THE COOLER MONTHS OF THE YEAR.
- CERTAIN HARDWOOD TREES AND GYMNOSPERMS REQUIRE LONGER ROOT PRUNING TIMES. THESE INCLUDE, BUT ARE NOT LIMITED TO, THE FOLLOWING
- AVOCADO (PERSEA AMERICANA)
- BLACK OLIVE (BUCIDA BUCERAS)
- BRIDALVEIL (CAESALPINIA GRANADILLO) CASSIAS (ALL SPECIES OF CASSIA)
- LIGNUM VITAE (GUA/ACUM SANCTUM & G. OFFICINALE)
- PODOCARPUS (PODOCARPUS SP.) LIVE OAK (QUERCUS VIRGINIANA)
- MAHOGANY (SWIETENIA MAHAGONI)
- MANGO (MANGIFERA INDICA)

PALM ROOT PRUNING SPECIFICATIONS

THE FOLLOWING TABLE LISTS MINIMUM ROOTBALL DIAMETERS FOR VARIOUS SPECIES OF PALMS BASED ON REAL-WORLD EXPERIENCE OF RELOCATION SPECIALISTS IN SOUTH FLORIDA.

> PALM SPECIES QUEEN & FOXTAIL PALMS ROYAL & COCONUT PALM: CANARY DATE PALM SLOW-GROWING PALMS

ROOTBALL SPECIFICATIONS 36" diameter 12"from trunk in all directions 8-24" from trunk in all direction

- PALM ROOTBALL MUST BE A MINIMUM OF 24" DEEP, WHENEVER POSSIBLE, ROOTBALLS MUST BE CIRCULAR IN SHAPE WITH AN EQUAL DISTANCE FROM THE TRUNK TO THE EDGE OF THE ROOTBALL ALL AROUND
- AS A GENERAL BUILE MINIMUM BOOT PRUNE TIME FOR PALMS IS 6-8 WEEKS. THE FIRST ROOT PRUNE MUST BE ON TWO OPPOSING SIDES OF THE ROOTBALL, WITH THE SECOND ROOT PRUNE ON ONE OF THE OTHER TWO SIDES DONE A MINIMUN OF 3-4 WEEKS LATER, AND A THIRD ROOT PRUNE ON THE LAST SIDE DONE A MINIMUM OF 4.5-6 WEEKS AFTER THAT. THE SECOND AND THIRD ROOT PRUNES MAY ONLY BE DONE WHEN HEALTHY NEW ROOT GROWTH FROM EARLIER ROOT PRUNES IS EVIDENT (SEE SECTION 2.14 ABOVE FOR SPECIFICATIONS ON PHOTOGRAPHICALLY DOCUMENTING NEW ROOT GROWTH DURING THE ROOT PRUNE PROCESS). MORE TIME MAY BE NEEDED DURING THE COOLER MONTHS OF THE YEAR
- CERTAIN PALMS, IN PARTICULAR THOSE THAT ARE SLOW GROWING, REQUIRE LONGER ROOT PRUNING TIME. THESE INCLUDE, BUT ARE NOT LIMITED TO, THE FOLLOWING
 - ALL SPECIES OF ARCHONTOPHOENIX
 - ALL SPECIES OF CORYPHA
 - AMERICAN OIL PALMS (ALL SPECIES OF ATTALEA)
 - BISMARCK PALM (BISMARCKIA NOBILIS) CUBAN & CARIBBEAN COPERNICIA

 - CUBAN BELLY PALM (GASTROCOCOS CRISPA) GINGERBREAD/DOUM PALMS (ALL SPECIES OF HYPHAENE)
 - PALMYRA PALMS (ALL SPECIES OF BORASSUS)
 - SATAKE PALM (SATAKENTIA LIUKIUENSIS)
 - SAW PAI METTO (SERENOA REPENS)
 - SILVER PALM (COCCOTHRINAX ARGENTATA)
 - ZOMBIE PALM (ZOMBIA ANTILLARUM)

FOR THESE PALMS, THE MINIMUM ROOT PRUNING TIME IS 4-6 MONTHS OR GREATER. ONLY WHEN SUFFICIENT NEW ROOT GROWTH HAS TAKEN PLACE FOLLOWING AN EARLIER ROOT PRUNE CAN THE NEXT ROOT PRUNE BE DONE, AND ONLY WHEN SUFFICIENT NEW ROOT GROWTH HAS TAKEN PLACE FOLLOWING THE FINAL ROOT PRUNE MAY THE TREE BE RELOCATED (SEE SECTION 2.14 ABOVE FOR SPECIFICATIONS ON PHOTOGRAPHICALLY DOCUMENTING NEW ROOT GROWTH DURING THE ROOT PRUNE PROCESS)

TREE CANOPY PRUNING SPECIFICATIONS

- PRIOR TO RELOCATION, THE CANOPY OF EACH TREE TO BE RELOCATED MUST BE SELECTIVELY PRUNED TO REMOVE CROSSING DEAD, DISEASED, BROKEN, AND LOW HANGING BRANCHES THAT MAY INTERFERE WITH CONSTRUCTION ACTIVITIES. OR THAT MAY INTERFERE OR RESTRICT STRAPPING OR LIFTING THE TREE DURING RELOCATION.
- FOR TREES BEING RELOCATED ONSITE, THE CANOPY MAY BE SELECTIVELY THINNED AND REDUCED BY NO MORE THAN 1/3 OF THE OVERALL CANOPY MASS, AT THE DIRECTION OF THE LANDSCAPE ARCHITECT: HOWEVER, THE BASIC SHAPE, FORM, AND CHARACTER OF THE TREES MUST BE PRESERVED.
- 3. FOR TREES BEING RELOCATED OFFSITE, THE CANOPY MUST BE PRUNED, AT THE DIRECTIONS OF THE LANDSCAPE ARCHITECT, TO FIT ON THE TRAILER FOR TRANSPORT EVERY EFFORT MUST BE MADE TO RETAIN AS MANY BRANCHES AS POSSIBLE. TO THE WIDEST LOAD WIDTH ALLOWABLE BY THE FLORIDA DEPARTMENT OF TRANSPORTATION. CONTRACTOR MUST OBTAIN ALL NECESSARY PERMITS AND ESCORTS TO TRANSPORT WIDE LOADS, PER FLORIDA LAW
- 4. ALL CANOPY PRUNING MUST BE CONDUCTED FOLLOWING ANSI A-300 TREE PRUNING STANDARDS AND BEST MANAGEMENT PRACTICES
- ALL DEBRIS GENERATED DURING CANOPY PRUNING MUST BE REMOVED OFFSITE AND DISPOSED.

PALM CANOPY PRUNING SPECIFICATIONS

- IT IS WELL KNOW THAT SOME PALMS SURVIVE RELOCATION BETTER WHEN ALL OF THE LEAVES ARE REMOVED (E.G., CABBAGE PALM, SABAL PALMETTO), AND THAT OTHER PALMS BENEFIT FROM HAVING THEIR LEAVES CUT IN HALF DURING RELOCATION (E.G., COCONUT PALM, COCOS NUCIFERA). BOTH OF THESE HORTICULTURAL PRACTICES, WHILE TRUE, ARE ONLY APPLICABLE WHEN PALMS ARE NOT ROOT PRUNED. LEAVES DO NOT NEED TO BE CUT IN HALF OR REMOVED FROM PALMS THAT ARE ADEQUATELY ROOT PRUNED. ON OCCASION WHEN SUFFICIENT ROOT PRUNING TIME IS NOT AVAILABLE, PALMS TO BE RELOCATED MAY HAVE THEIR LEAVES CUT IN HALF OR REMOVED ENTIRELY AT THE DIRECTION OF THE LANDSCAPE ARCHITECT
- PALMS LEAVES MUST BE TIED UP WITH 2-PLY BIODEGRADABLE TWINE PRIOR TO RELOCATION TO PREVENT MECHANICAL DAMAGE DURING THE RELOCATION PROCESS
- PALM TRUNKS SHALL ONLY BE 'CLEANED UP' ACCORDING TO THE LANDSCAPE ARCHITECT'S SPECIFICATIONS SPECIFIC TO EACH PALM



tequesta, fl 561.402.9414

www.nielsenlandarch.com

TER

SEAL (S TYLER NIELSEN - LA6667067)



TREE DISPOSITION NOTES ISSUE

03.21.2022 COORDINATION 04.06.2022 REVISION 1

TREES PROTECTION NOTES

- CONTRACTOR TO PROTECT ALL EXISTING TREES PRIOR TO THE DEMOLITION OF THE
- UPON COMPLETION OF OF SITE DEMOLITION, CONTRACTOR TO RELOCATE ALL SPECIFIED TREES AND PALMS FOR RELOCATION. CONTRACTOR TO REINSTALL TREE PROTECTION FENCE AROUND BELOCATED AND EXISTING TREES.
- FENCING AT A MINIMUM FOUR (4) FEET HEIGHT INSTALLED NO CLOSER TO THE TREE TRUNK THAN ITS DRIPLINE. THIS FENCE SHALL BE MAINTAINED IN WORKING ORDER DURING ALL PHASES OF CONSTRUCTION. MAINTAIN TREE PROTECTION ZONES FREE OF
- THE PROJECT LIMIT OF CONSTRUCTION AND ALL EXISTING VEGETATION TO REMAIN IS TO BE CLEARLY DEFINED BY STURDY, WEATHERPROOF FENCING AT A MINIMUM OF
- STURDY TEMPORARY BARRIERS SHALL BE INSTALLED AROUND ALL TREE PROTECTION ZONES. BARRIERS SHALL BE A MINIMUM OF FOUR FEET HIGH, AND SHALL BE CONSTRUCTED OF CONTINUOUS CHAIN LINK FENCE WITH METAL POSTS AT EIGHT-FOOT SPACING, OR OF TWO-BY-FOUR INCH POSTS WITH THREE EQUALLY SPACED TWO-BY-FOUR RAILS. POSTS MAY BE SHIFTED TO AVOID ROOTS

MAINTENANCE SPECIFICATIONS


- ALL RELOCATED TREES AND PALMS MUST BE MAINTAINED FOR ONE YEAR FROM THE DATE OF RELOCATION TO THEIR FINAL LOCATIONS
- 2 CONTRACTOR MUST MAINTAIN ALL RELOCATED TREES AND PALMS FOR ONE FULL YEAR FROM THE DATE OF RELOCATION TO THE FINAL LOCATION
- 3. WHENEVER POSSIBLE, EACH TREE AND PALM MUST BE WATERED BY A PERMANENT UTOMATIC IRRIGATION SYSTEM FOLLOWING RELOCATION. EACH WATERING MUST THOROUGHLY SATURATE THE ROOTBALL TO ITS FULL DEPTH: THIS WILL REQUIRE 25-50 GALLONS OF WATER FOR SMALL TREES AND PALMS DEPENDING ON ROOTBALL SIZE, WHILE LARGE TREES WILL REQUIRE A MINIMUM OF 10 GALLONS PER FOOT OF ROOTBALL DIAMETER (I.E., A 10' DIAMETER ROOTBALL WILL REQUIRE A MINIMUM OF 100 GALLONS PER WATERING EVENT). WATERING FREQUENCY MUST BE EVERY DAY FOR THE FIRST TWO WEEKS, EVERY OTHER DAY FOR THE NEXT THREE WEEKS, AND EVERY THIRD DAY FOR THE NEXT 6-8 WEEKS
- 4. WHEN AN AUTOMATIC IRRIGATION SYSTEM IS NOT POSSIBLE, CONTRACTOR IS RESPONSIBLE FOR HAND WATERING RELOCATED TREES AND PALMS THROUGHOUT THE MAINTENANCE PERIOD AND UNTIL FINAL ACCEPTANCE BY THE LANDSCAPE ARCHITECT AND/OR CLIENT
- 5. IMMEDIATELY AFTER RELOCATION TO THE FINAL LOCATION. A HIGH-PHOSPHORUS ROOT STIMULANT MUST BE APPLIED TO THE SURFACE OF THE ROOTBALL AT THE RECOMMENDED LABEL RATE AND WATERED IN WITH A DRENCH CONSISTING OF A SYSTEMIC INSECTICIDE AND A CONTACT ROOT ROT FUNGICIDE, FOLLOWING LABEL INSTRUCTIONS. AS INITIAL PREVENTATIVE MAINTENANCE
- 6. EVERY THREE MONTHS THEREAFTER. A HIGH-PHOSPHORUS ROOT STIMLII ANT MUST BE APPLIED TO THE SURFACE OF THE ROOTBALL AT THE RECOMMENDED LABEL RATE AND WATERED IN WITH A DRENCH CONSISTING OF A SYSTEMIC INSECTICIDE AND A BROAD-SPECTRUM SYSTEMIC FUNGICIDE, FOLLOWING LABEL INSTRUCTIONS, AS CONTINUING PREVENTATIVE MAINTENANCE.
- 7. IBRIGATION AND BRACING MUST BE CHECKED AND EACH TREE OR PALM THOROUGHLY INSPECTED FOR SIGNS OF STRESS, DISEASE, OR PEST PROBLEMS ON A MONTHLY BASIS.
- 8. IMMEDIATELY AFTER RELOCATION TO THE FINAL LOCATION AND EVERY THREE MONTHS THEREAFTER, A HIGH-QUALITY, SLOW-RELEASE 15-2-15 GRANULAR FERTILIZER MUST BE APPLIED, AT THE RECOMMENDED LABEL RATE, SPREAD EVENLY ACROSS THE SURFACE OF THE BOOTBALL
- IMMEDIATELY AFTER RELOCATION TO THE FINAL LOCATION AND EVERY THREE MONTHS THEREAFTER A HIGH-QUALITY, SLOW-RELEASE 15-2-15 GRANULAR FERTILIZER MUST BE APPLIED, AT THE RECOMMENDED LABEL RATE, SPREAD EVENLY ACROSS THE SURFACE OF THE ROOTBALL
- 10. FOLIAR FEED FOUR TIMES PER YEAR.
- 11. STRING MUST BE REMOVED FROM THE TIED UP LEAVES IMMEDIATELY AFTER RELOCATION TO THE FINAL LOCATION IF THE PALM WAS BOOT PRUNED OR WITHIN 30-45 DAYS AFTER RELOCATION ON THE OCCASION THE LANDSCAPE ARCHITECT APPROVED RELOCATION WITHOUT ROOT PRUNING DUE TO TIME CONSTRAINTS
- 12. IMMEDIATELY AFTER RELOCATION TO THE FINAL LOCATION AND EVERY THREE MONTHS THEREAFTER A HIGH-QUALITY, SLOW-RELEASE 8-4-12 GRANULAR PALM FERTILIZER WITH MINORS MUST BE APPLIED. AT THE RECOMMENDED LABEL RATE, SPREAD EVENLY
- 13. FOLIAR FEED PALMS SIX TIMES PER YEAR.

RELOCATION SPECIFICATIONS

- LANDSCAPE CONTRACTOR TO FLAG ALL PROPOSED PLANT LOCATIONS FOR LANDSCAPE ARCHITECT'S APPROVAL PRIOR TO INSTALLATION. NOTIFY LANDSCAPE ARCHITECT A MINIMUM OF 15 DAYS PRIOR TO REVIEW
- 2. ALL TREES AND PALMS TO BE RELOCATED MUST BE WATERED DAILY FOR AT LEAST 5. DAYS PRIOR TO ANY RELOCATION TO ENSURE THAT THEY ARE FULLY HYDRATED. EACH WATERING MUST THOROUGHLY SATURATE THE ROOTBALL TO ITS FULL DEPTH.
- ALL ROOTBALLS MUST BE WRAPPED IN BURLAP AND THE TIGHTLY WIRE-WRAPPED (USING REDLINE HORSE WIRE OR EQUIVALENT) TO KEEP THE ENTIRE ROOTBALL INTACT DURING RELOCATION. TREES AND PALMS GROWING IN LIMESTONE MUST BE DUG AND RELOCATED WITH THE ROOT ATTACHED TO A SECTION OF ROCK AS PART OF THE ROOTBALL SLICH THAT THE BOOTS REMAIN INTACT. BOOTBALLS COMING FROM SAND OR SANDY SOIL MAY ALSO NEED TO BE BOXED PRIOR TO RELOCATION, AT THE DISCRETION OF THE LANDSCAPE ARCHITECT.
- TREES AND PALMS BEING RELOCATED OFFSITE MUST HAVE THEIR ENTIRE ROOTBALLS THOROUGHLY AND TIGHTLY WRAPPED WITH PLASTIC SHRINK WRAP ON THE OUTSIDE OF THE WIRE WRAP, AND THE ENTIRE TREE OR PALM (INCLUDING CANOPY, TRUNK, AND ROOTBALL) MUST BE COVERED WITH A BREATHABLE TARP (E.G., SHADE CLOTH) DURING
- NEW PLANTING PITS FOR RELOCATED TREES AND PALMS MUST BE PREPARED PRIOR TO LIFTING THE PALM OR TREE FROM ITS CLIBRENT LOCATION AND MUST BE AT LEAST 3-4 FEET WIDER THAN THE ROOTBALL AND THE SAME DEPTH AS THE ROOTBALL, SUCH THAT THE FINAL ELEVATION OF THE TOP OF THE ROOTBALL IS AT OR SLIGHTLY ABOVE (NO MORE THAN 2" HIGHERO FINAL GRADE.
- TREES AND PALMS TO BE BELOCATED MUST BE LIFTED BY THE BOOTBALL ONLY JUSING APPROPRIATELY SIZED (LENGTH AND STRENGTH) LIFTING STRAPS OR CHAINS. DURING LIFTING, THE TREE OR PALM MUST BE BALANCED IN A MORE-OR-LESS UPRIGHT POSITION, WITH THE STRAP THE TRUNK USED ONLY FOR BALANCING AND MANEUVERING THE TREE OR PALM INTO A POSITION. NO CHAINS MAY BE USED AROUND OR AGAINST THE TRUNK AT ANY TIME. AT NO TIME SHALL 100% OF THE WEIGHT OF THE TREE OR PALM BE ON THE STRAP ATTACHED TO THE TRUNK TRUNKS MUST BE HEAVILY PADDED WITH 30-60 LAYERS (DEPENDING ON SIZE AND WEIGHT) OF BURLAP BENEATH THE BALANCING STRAP.
- TREES AND PALMS MUST BE LIFTED WITH A CRANE OR BACKHOE APPROPRIATELY SIZED FOR THE SIZE AND WEIGHT OF THE TREE OR PALM AND LIFTED OR CARRIED DIRECTLY TO THE FINAL INSTALL LOCATION OR TRANSPORT TRAILER.
- ONCE LIFTING BEINGS, ANY UNCUT ROOTS UNDER OR AROUND THE ROOTBALL THAT MAY YET REMAIN MUST BE IMMEDIATELY SEVERED WITH HAND PRUNING TOOLS TO MINIMIZE TEARING AND ROOT DAMAGE.
- AGRIFORM PLANTING TABLETS (OR APPROVED EQUIVALENT) MUST BE EVENLY DISTRIBUTED AROUND THE PERIMETER OF THE PLANTING PIT AT THE RATE OF 2 TABLETS PER 1" TRUNK CALIPER PRIOR TO BACKFILLING.
- MYCORRHIZA (ROOTS® TRANSPLANT OR EQUIVALENT) MUST BE INCORPORATED INTO THE BACKFILL SOIL PRIOR TO BACKFILLING.
- RELOCATED TREES AND PALMS MUST BE CENTERED IN THE PLANTING PIT AND THE PIT BACKFILLED USING A 1:1 MIXTURE OF EXISTING SOIL AND 80:20 (DOT SAND:MUCK) SOIL MIX THOROUGHLY BLENDED TOGETHER. DO NOT USE MUDDY SOIL AS BACKFILL
- 12. SMALL TREES AND PALMS MUST BE FIRMLY BRACED USING A MINIMUM OF FOUR 4"X 4" WOODEN BRACES ATTACHED TO 2" X 4" WOODEN BATTENS HELD IN PLACE WITH TWO STEEL BANDS. LARGER TREES MAY REQUIRE 6"X 6" WOODEN POSTS OR EVEN TELEPHONE POLES TO PROVIDE SUFFICIENT BRACING STRENGTH TO PREVENT TOPPLING DURING WIND EVENTS, A SUFFICIENT NUMBER OF BATTENS MUST BE STRATEGICALLY PLACED AROUND THE TRUNK SUCH THAT THE STEEL BANDS NEVER CONTACT THE TRUNK. NO BURLAP IS TO REMAIN UNDER THE WOODEN BATTENS ON TREES DURING BRACING BUT SEVERAL LAYERS OF BURLAP SHOULD BE LEFT LINDER THE WOODEN BATTENS WHEN BRACING PALMS. NAILS SHALL NEVER BE DRIVEN DIRECTLY INTO THE TRUNK DURING BRACING. BRACING MUST REMAIN IN PLACE FOR A MINIMUM OF ONE YEAR
- 13. A TREE RING WITH A MINIMUM HEIGHT OF 6" MUST BE CONSTRUCTED 6-12" OUTSIDE THE OUTERMOST EDGE OF THE ROOTBALL AND AROUND THE ENTIRE PERIMETER OF THE ROOTBALL TO DIRECT IRRIGATION WATER AND ANY SUPPLEMENTS THAT ARE ADDED DOWN INTO THE ROOTBALL DURING ROOT REGENERATION
- 14. ONCE THE TREE RING IS CONSTRUCTED, A HIGH-PHOSPHORUS ROOT STIMULANT MUST BE LIBERALLY APPLIED TO THE SURFACE AND THOROUGHLY WATERED IN
- ROOTBALLS MUST BE A THOROUGHLY WATERED IN USING A HOSE AND JOHNSON BAR INSERTED TO THE VERY BOTTOM OF THE ROOTBALL AND SWUNG BACK AND FORTH TO PREVENT FORMATION OF AIR POCKETS. THE JOHNSON BAR TECHNIQUE MUST BE REPEATED AT LEAST ONCE MORE WITHIN 6" OF THE TRUNK. MULCH MUST NOT BE APPLIED OR ALLOWED TO ACCUMULATE DIRECTLY AGAINST THE TRUNK.
- 16 ORGANIC MUI CH (MEI ALFLICA IS PREFERRED) MUST BE APPLIED WITHIN 48 HOURS OF RELOCATION AT A DEPTH OF 3-4" OVER THE ENTIRE TOP OF THE ROOTBALL FROM THE TREE RING TO WITHIN 6" OF THE TRUNK. MULCH MUST NOT BE APPLIED OR ALLOWED TO ACCUMULATE DIRECTLY AGAINST THE TRUNK
- PITS FROM WHICH THE RELOCATED TREES AND PALMS WERE REMOVED MUST BE CLEANED OFF ALL RESIDUAL ROOTS, STUMPS, AND PORTIONS THEREOF AND BACKFILLED WITH CLEAN FILL FLUSH WITH THE SURROUNDING GRADE.
- 18. RESTORE THE SURFACE WITH MATERIAL TO MATCH ADJACENT AREAS, MATERIAL TO BE APPROVED BY LANDSCAPE ARCHITECT. CONTRACTOR TO PROVIDE A MINIMUM OF ONE YEAR WARRANTY ON SETTLING AND PLANT MATERIAL FROM THE SUBSTANTIAL
- MULTI-TRUNK TREES AND PALMS MUST BE RELOCATED AS ONE UNIT WITH A SINGLE
- PLANTING PITS FOR EDIBLE DATE PALMS (PHOENIX DACTYLIFERA) MUST BE BACKFILLED

WARRANTY NOTES

- ALL RELOCATED TREES AND PALMS MUST BE GUARANTEED FOR ONE YEAR FROM THE TE OF RELOCATION TO THEIR FINAL LOCATIONS
- IF A TREE OR PALM DIES WITHIN THE 1-YEAR WARRANTY PERIOD, IT MUST BE REMOVED AND REPLACED AT CONTRACTOR'S EXPENSE.
- IF A TREE OR PALM PERFORMS POORLY WITHIN THE 1-YEAR WARRANTY PERIOD, IT MUST BE REMOVED AND REPLACED AT CONTRACTOR'S EXPENSE. THE DECISION TO REPLACE BASED ON POOR HEALTH IS AT THE DISCRETION OF THE LANDSCAPE
- IF A TREE OR PALM SETTLES TO AN UNHEALTHY DEPTH WITHIN THE 1-YEAR WARRANTY PERIOD, AS DEEMED BY THE BY THE LANDSCAPE ARCHITECT, IT MUST BE RAISED TO THE CORRECT GRADE AT CONTRACTOR'S EXPENSE.

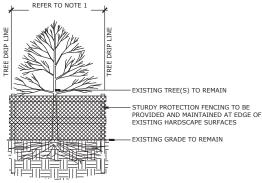

- CONTINUOUS TO PROTECT MULTIPLE TREES. TREE PROTECTION FENCE TO BE INSTALLED AT EDGE OF EXISTING HARDSCAPE. WHERE SPACE ALLOWS TREE PROTECTION FENCE TO ALIGN WITH DRIPLINE OF TREE / PALM. MAINTAIN FENCE THROUGHOUT CONSTRUCTION.

TREE PROTECTION FENCE

REFER TO LOCAL, STATE AND FEDERAL JURISDICTIONS AND GOVERNING BODIES/AGENCIES FOR ADDITIONAL REQUIREMENTS.

Scale: 1/4" = 1'- 0"

tequesta, fl 561.402.9414

www.nielsenlandarch.com

TER

SEAL (S TYLER NIELSEN - LA6667067)




TREE DISPOSITION NOTES ISSUE


COORDINATION 03.21.2022 04.06.2022 REVISION 1

REFERENCE IMAGERY





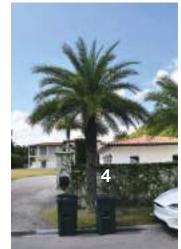

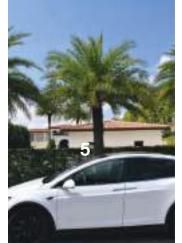













TREE DISPOSITION SCHEDULE

#	BOTANICAL NAME	COMMON NAME	DBH.	HT.	SPREAD	ACTION	NOTES
1	PHOENIX SYLVESTRIS	SYLVESTER DATE PALM	10"	16'	12'	PRESERVE	CONTRACTOR TO PROTECT AND CARE FOR PLANT MATERIAL
2	PHOENIX SYLVESTRIS	SYLVESTER DATE PALM	10"	16'	12'	PRESERVE	CONTRACTOR TO PROTECT AND CARE FOR PLANT MATERIAL
3	PHOENIX SYLVESTRIS	SYLVESTER DATE PALM	10"	16'	12'	PRESERVE	CONTRACTOR TO PROTECT AND CARE FOR PLANT MATERIAL
4	PHOENIX SYLVESTRIS	SYLVESTER DATE PALM	10"	16'	12'	PRESERVE	CONTRACTOR TO PROTECT AND CARE FOR PLANT MATERIAL
5	PHOENIX SYLVESTRIS	SYLVESTER DATE PALM	10"	16'	12'	PRESERVE	CONTRACTOR TO PROTECT AND CARE FOR PLANT MATERIAL
6	PHOENIX SYLVESTRIS	SYLVESTER DATE PALM	10"	16'	12'	PRESERVE	CONTRACTOR TO PROTECT AND CARE FOR PLANT MATERIAL
7	PHOENIX SYLVESTRIS	SYLVESTER DATE PALM	12"	24'	18'	RELOCATE	LOCATION OF PLANT MATERIAL CONFLICTS WITH CONSTRUCTION ENVELOPE
8	PHOENIX SYLVESTRIS	SYLVESTER DATE PALM	12"	24'	18'	RELOCATE	LOCATION OF PLANT MATERIAL CONFLICTS WITH CONSTRUCTION ENVELOPE
9	PHOENIX SYLVESTRIS	SYLVESTER DATE PALM	10"	18'	12'	RELOCATE	LOCATION OF PLANT MATERIAL CONFLICTS WITH CONSTRUCTION ENVELOPE
10	PHOENIX ROEBELENII	PYGMY DATE PALM	4"	12'	20'	REMOVE	PLANT MATERIAL DOES NOT CORRESPOND WITH PROPOSED PLANT COMPOSITION
11	PHOENIX SYLVESTRIS	SYLVESTER DATE PALM	8"	12'	8'	RELOCATE	LOCATION OF PLANT MATERIAL CONFLICTS WITH CONSTRUCTION ENVELOPE



www.nielsenlandarch.com

THE SALTER GARDEN | SALL ON PD. 1 MIMMI BEACH, FLORIDA 33141

SEAL (S TYLER NIELSEN - LA6667067)



DATE ISSUE

03.21.2022 COORDINATION 04.06.2022 REVISION 1




www.nielsenlandarch.com

THE SALTER GARDEN

TREE DISPOSITION SCHEDULE

THEE BIOF CONTON CONTEDUCE							
#	BOTANICAL NAME	COMMON NAME	ACTION				
1	PHOENIX SYLBESTRIS	SYLVESTER DATE PALM	PRESERVE				
2	PHOENIX SYLBESTRIS	SYLVESTER DATE PALM	PRESERVE				
3	PHOENIX SYLBESTRIS	SYLVESTER DATE PALM	PRESERVE				
4	PHOENIX SYLBESTRIS	SYLVESTER DATE PALM	PRESERVE				
5	PHOENIX SYLBESTRIS	SYLVESTER DATE PALM	PRESERVE				
6	PHOENIX SYLBESTRIS	SYLVESTER DATE PALM	PRESERVE				
7	PHOENIX SYLVESTRIS	SYLVESTER DATE PALM	RELOCATE				
8	PHOENIX SYLVESTRIS	SYLVESTER DATE PALM	RELOCATE				
9	PHOENIX SYLVESTRIS	SYLVESTER DATE PALM	RELOCATE				
10	PHOENIX ROEBELENII	PYGMY DATE PALM	REMOVE				
11	PHOENIX SYLVESTRIS	SYLVESTER DATE PALM	RELOCATE				

TREE DISPOSITION LEGEND

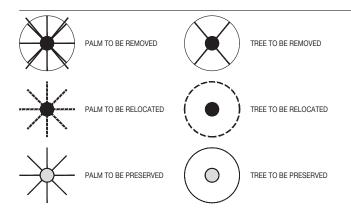

SEAL (S TYLER NIELSEN - LA6667067)




TREE DISPOSITION PLAN

DATE ISSUE

03.21.2022 COORDINATION
04.06.2022 REVISION 1



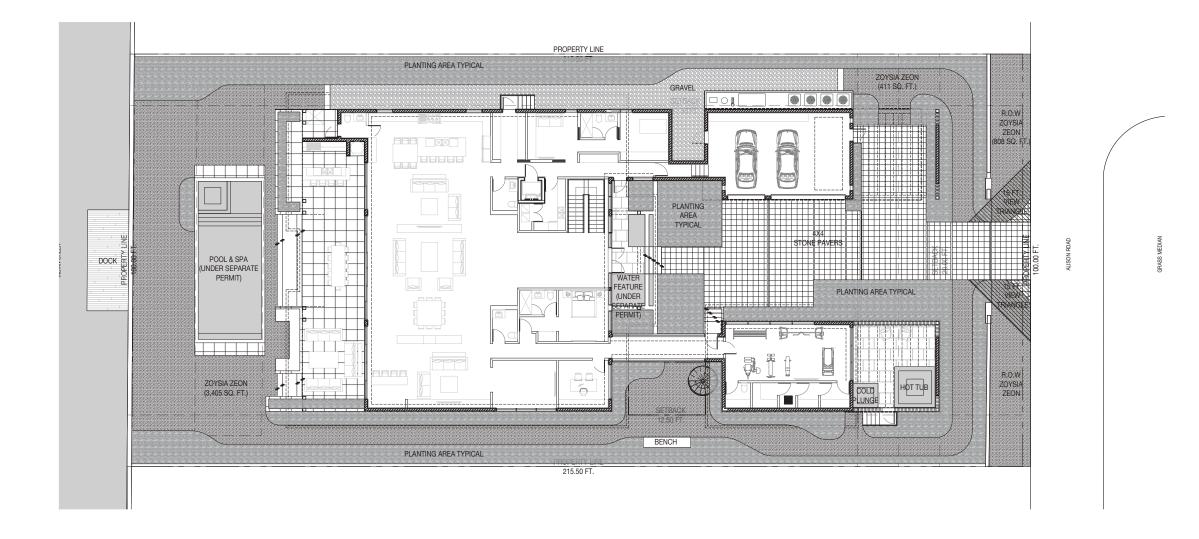



www.nielsenlandarch.com

THE SALTER GARDEN

MATERIALS NOTES

- CONTRACTOR TO VERIFY ALL QUANTITIES. IN CASE OF ANY DISCREPANCIES, GRAPHICALLY SHOWN MATERIAL QUANTITIES SHALL TAKE PRECEDENCE.
- 2. ALL CONSTRUCTION AND MATERIALS NOT SPECIFICALLY ADDRESSED IN THE CONTRACT DOCUMENTS OR SPECIFICATIONS SHALL BE IN ACCORDANCE WITH LOCAL, STATE AND FEDERAL JURISDICTIONS AND GOVERNING BODIES/AGENCIES STANDARDS.
- THE CONTRACTOR SHALL PROVIDE A FULL-SCALE MOCKUP AND RECEIVE APPROVAL FROM THE LANDSCAPE ARCHITECT FOR ALL SYSTEMS BEFORE BEGINNING CONSTRUCTION OF PAVEMENT.
- 4. EXPANSION JOINTS SHALL BE PROVIDED WHERE FLATWORK MEETS VERTICAL STRUCTURES, SUCH AS WALLS, CURBS, STEPS, AND OTHER HARDSCAPE ELEMENTS. EXPANSION JOINTS SHALL ALSO BE PROVIDED AT MATERIAL CHANGES. EXPANSION JOINT MATERIALS/METHODS SHALL BE SUBMITTED TO THE LANDSCAPE ARCHITECT FOR REVIEW AND APPROVAL PRIOR TO INSTALLATION.
- 5. CONTROL JOINTS SHOULD BE SPACED NO GREATER THAN TEN (10) LINEAR FEET MAXIMUM, UNLESS OTHERWISE SPECIFIED. EXPANSION JOINTS SHOULD BE SPACED NO GREATER THAN FORTY (40) LINEAR FEET MAXIMUM, UNLESS OTHERWISE SPECIFIED. CONTRACTOR SHALL ADVISE ON OTHER JOINTS AS NEEDED TO MINIMIZE CRACKING. THIS INFORMATION SHALL BE SUBMITTED TO THE LANDSCAPE ARCHITECT FOR REVIEW AND APPROVAL PRIOR TO INSTALLATION.
- 6. CONTROL JOINTS SHALL BE PROVIDED AS SPECIFIED IN THE CONTRACT DOCUMENTS. CONTROL JOINT MATERIALS, METHODS AND RECOMMENDATIONS ON ADDITIONAL CONTROL JOINTS TO MINIMIZE CRACKING SHALL BE SUBMITTED TO THE LANDSCAPE ARCHITECT FOR REVIEW AND APPROVAL.
- 7. ALL STEPS SHALL HAVE TWELVE (12) INCH TREADS AND SIX (6) INCH RISERS, UNLESS OTHERWISE SPECIFIED.
- 8. HOLD TOP OF WALLS AND FENCES LEVEL, UNLESS OTHERWISE SPECIFIED.
- 9. CONTRACTOR SHALL NOT INSTALL WORK LOCATED ON TOP OF ARCHITECTURAL STRUCTURES WITHOUT FIRST REVIEWING ARCHITECTURAL DRAWINGS.
- SAMPLES OF SPECIFIED MATERIALS SHALL BE SUBMITTED TO THE LANDSCAPE ARCHITECT FOR REVIEW AND APPROVAL PRIOR TO ORDERING FOR JOB.

MATERIALS LEGEND

PLANTING AREA TYPICAL

ZOYSIA SOD

O4.06.2022

DOMINICAN CORALSTONE

4X4 STONE PAVERS (1,826 SQ. FT.)

GRAVEL (814 SQ. FT.)

WATER

 DATE
 ISSUE

 03.21.2022
 COORDINATION


 04.06.2022
 REVISION 1

MATERIALS PLAN

SEAL (S TYLER NIELSEN - LA6667067)



L300

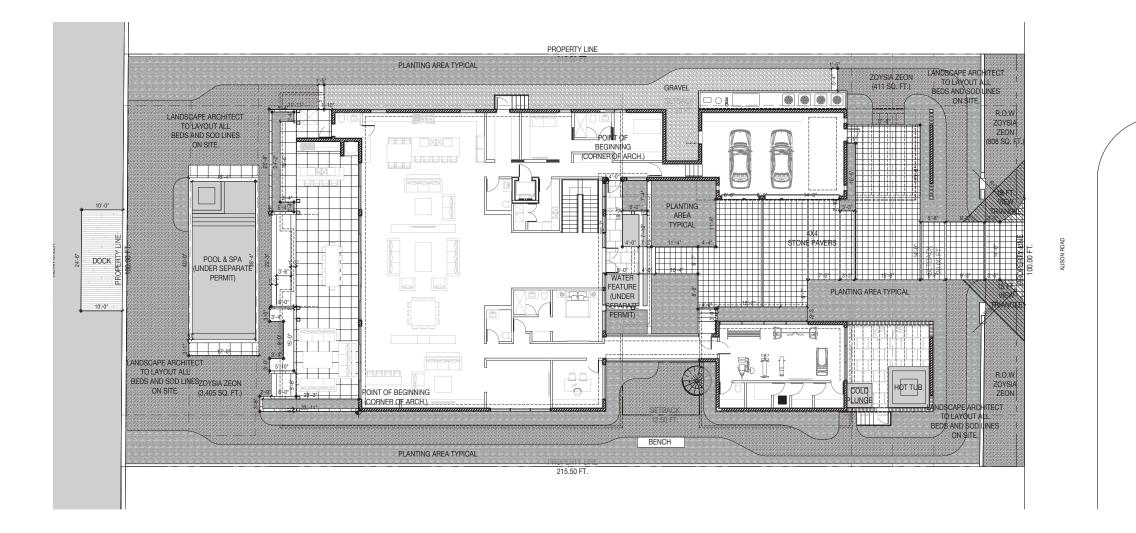



357 cypress drive, tequesta, fl 33469 561.402.9414

www.nielsenlandarch.com

THE SALTER GARDEN

LAYOUT NOTES

- LAYOUT AND VERIFY DIMENSIONS PRIOR TO CONSTRUCTION.
 NOTIFY LANDSCAPE ARCHITECT OF ANY DISCREPANCIES.
 LANDSCAPE ARCHITECT TO REVIEW AND APPROVE ALL
 LAYOUTS CONTAINED IN THE CONSTRUCTION DOCUMENTS
 PRIOR TO CONSTRUCTION.
- WRITTEN DIMENSIONS SHALL TAKE PRECEDENCE OVER SCALED DIMENSIONS. DO NOT SCALE DIMENSIONS FROM REDUCED DRAWINGS.
- 3. DIMENSIONS REFERRED TO AS "EQUAL" INDICATE SPACING WHICH IS EQUIDISTANT MEASURED TO THE CENTERLINES.
- 4. MEASUREMENTS ARE TO THE FINISHED FACE OF BUILDINGS, WALLS, OR OTHER FIXED SITE IMPROVEMENTS. DIMENSIONS TO CENTERLINES ARE IDENTIFIED AS SUCH.
- INSTALL INTERSECTING ELEMENTS AT 90-DEGREE ANGLES, UNLESS OTHERWISE INDICATED. MAINTAIN HORIZONTAL ALIGNMENT OF ADJACENT ELEMENTS AS INDICATED IN CONTRACT DOCUMENTS.
- 6. SPECIAL CONSIDERATION IS GIVEN TO THE DESIGN AND INTENDED RELATIONSHIP BETWEEN ARCHITECTURE, PLANTING AREAS AND PAVING SYSTEMS. PAVEMENT JOINTING, PAVERS, STONE, FINISHES AND GRADES HAVE BEEN STRICTLY COORDINATED IN THE CONTRACT DOCUMENTS. CONSTRUCTION OF THESE SYSTEMS SHALL BE STRICTLY COORDINATED.

SEAL (S TYLER NIELSEN - LA6667067)



04.06.2022

DATE ISSUE

03.21.2022 COORDINATION 04.06.2022 REVISION 1



L500

PLANTING NOTES

- PLANT MATERIAL IS TO BE HEALTHY SPECIMENS FREE FROM DISEASE OR DAMAGE, AND IS TO BE MAINTAINED IN EXCELLENT CONDITION WHILE ON THE JOBSITE. LANDSCAPE ARCHITECT SHALL INSPECT PLANT MATERIAL UPON ARRIVAL TO JOBSITE AND WILL REJECT PLANT MATERIAL THAT DOES NOT MEET THE STANDARDS DESCRIBED WITHIN THE CONTRACT DOCUMENTS.
- THE LANDSCAPE ARCHITECT WILL PERIODICALLY INSPECT PLANT MATERIAL STOCKPILED AND/OR PLANTED ON SITE DURING THE COURSE OF CONSTRUCTION. PLANT MATERIAL NOT MEETING THE STANDARDS CONTAINED WITHIN CONTRACT DOCUMENTS SHALL BE REPLACED AT NO COST TO THE OWNER.
- PROVIDE MATCHING SIZES AND FORMS FOR EACH PLANT OF THE SAME SPECIES UNLESS OTHERWISE INDICATED.
- CONTRACTOR TO VERIFY ALL QUANTITIES. IN CASE OF DISCREPANCIES, GRAPHICALLY SHOWN QUANTITIES SHALL
- ALL MATERIALS USED SHALL CONFORM TO THE GUIDELINES ESTABLISHED BY THE CURRENT AMERICAN STANDARDS FOR NURSERY STOCK, PUBLISHED BY THE AMERICAN ASSOCIATION OF NURSERYMEN.
- ALL PLANT MATERIAL SHALL BE INSTALLED PLUMB AND PER THE SPECIFICATIONS CONTAINED WITHIN THE CONTRACT DOCUMENTS. ANY NECESSARY STAKING AND/OR OTHER SUPPORTS MATERIALS/METHODS SHALL BE SUBMITTED TO THE LANDSCAPE ARCHITECT FOR REVIEW AND APPROVAL PRIOR TO INSTALLATION.
- THE CONTRACTOR SHALL PRUNE EXISTING AND/OR NEW TREES ONLY PER LANDSCAPE ARCHITECT DIRECTION.
- THE CONTRACTOR SHALL STAKE THE LOCATIONS OF ALL TREES AND B&B SHRUBS FOR LANDSCAPE ARCHITECT REVIEW AND APPROVAL, PRIOR TO INSTALLATION.
- ALL ROOT-WRAPPING MATERIALS THAT ARE NOT BIO-DEGRADABLE SHALL BE REMOVED FROM THE ROOT BALL. ROOT BALLS SHALL BE FREE OF WEEDS.
- 10. SPECIFIED PLANT MATERIAL SIZES SHALL BE CONSIDERED MINIMUM SIZES.
- FINISH GRADE OF PLANTING BEDS SHALL BE ONE (1) INCH BELOW ADJACENT FLATWORK, UNLESS SPECIFIED OTHERWISE
- MULCH OR PLANTING BED DRESSING SHALL BE PLACED IN ALL PLANTING AREAS AS SPECIFIED. MULCH OR PLANTING BED DRESSING SHALL NOT BE PLACED WITHIN SIX (6) INCHES OF TREE TRUNKS. MULCHING SHOULD BE REPEATED
- ALL PLANT MATERIAL SHOULD RECEIVE AN ORGANIC FERTILIZER IN LIMITED APPLICATION FOLLOWING INSTALLATION. TYPE AND APPLICATION RATE AND METHOD OF APPLICATION TO BE SPECIFIED BY THE CONTRACTOR AND APPROVED BY THE LANDSCAPE ARCHITECT.
- 14. EXCESS FERTILIZER SHALL BE DISPOSED OF PROPERLY OFF-SITE. IT SHALL NOT BE DISPOSED OF IN STORM DRAINS
- 15. STOCKPILED PLANT MATERIAL TO BE PLACED IN THE SHADE AND PROPERLY HAND-WATERED UNTIL PLANTED.
- MINI-NUGGET TYPE DECORATIVE BARK MULCH WILL BE USED TO RETURN NUTRIENTS TO THE SOIL, REDUCE MAINTENANCE AND MINIMIZE EVAPORATION FOR AREAS APPROXIMATE TO THE RESIDENCE. LARGER SHREDDED BARK MULCH WILL BE USED FOR STEEP AREAS SO SLOUGHING IS LESS LIKELY TO OCCUR.
- 17. PRESERVE & PROTECT ALL EXISTING VEGETATION INDICATED TO REMAIN AT ALL TIMES.
- ALL VEGETATION PROPOSED FOR OUTSIDE THE BUILDING ENVELOPE TO BE NATIVE UNLESS OTHERWISE NOTED. PLANTING THAT OCCURS OUTSIDE THE BUILDING ENVELOPE IS FOR RESTORATION PURPOSES ONLY OR IS SPECIFIC
- SIX (6) INCH PLANT MIX SHALL BE PROVIDED FOR ALL LAWN, TURF, AND NATIVE PLANTING ZONES. 18 INCH PLANT MIX SHALL BE PROVIDED FOR ALL PERENNIAL PLANTING BEDS UNLESS OTHERWISE NOTED.
- ALL PLANT MATERIAL SHALL BE FLORIDA GRADE #1 OR BETTER AS OUTLINED IN GRADES AND STANDARDS FOR NURSERY PLANTS, PARTS I AND II OF THE LATEST EDITION, PUBLISHED BY THE FLORIDA DEPARTMENT OF AGRICULTRE AND CONSUMER SERVICES.

CITY OF MIAMI BEACH LANDSCAPE LEGEND

	CITY OF MIAMI BEACH		
	LANDSCAPE LEGEND INFORMATION REQUIRED TO BE PERMANENTLY AFFIXED TO PLANS Zoning District, RS-3 Lot Area 21,600 Acre	.50	
	OPEN SPACE	REQUIRED/ ALLOWED	PROVIDED
Α.	Square feet of required Open Space as indicated on site plan: Lot Area = 21,600 s.f.x 09 % = 1,944 s.f.	1.944	8,313
B.	Square feet of parking lot open space required as indicated on site plan:	- NIA	
	Number of parking spaces NA x 10 s.f. parking space =	NA	NA
C.	Total square feet of landscaped open space required: A+B=	1,944	8,313
A.	LAWN AREA CALCULATION Square feet of landscaped open space required	1,944	8,313
B.	Maximum lawn area (sod) permitted= 50 %x8,313.f.	4,157	3,816
A	TREES Number of trees required per lot or net lot acre, less existing number of trees meeting minimum requirements=		
	trees xnet lot acres - number of existing trees=	21	33
	% Natives required: Number of trees provided x 30% =	10	32
C.	% Low maintenance / drought and salt tolerant required: Number of trees provided x 50%=	17	32
D.	Street Trees (maximum average spacing of 20' o.c.) 100 linear feet along street divided by 20'=	5	6 (EXISTING
E.	Street tree species allowed directly beneath power lines: (maximum average spacing of 20' o.c.):		PALMS)
	N/A linear feet along street divided by 20'=	N/A	N/A
	SHRUBS		
A	Number of shrubs required: Sum of lot and street trees required x 12=	396	405
B.	% Native shrubs required: Number of shrubs provided x 50%=	203	296
	LARGE SHRUBS OR SMALL TREES		
	Number of large shrubs or small trees required: Number of required shrubs $\times10\%$	40	319
	% Native large shrubs or small trees required: Number of large shrubs or	160	296

PLANTING SCHEDULE

. г	4 D.D.	OLIANITITY	DOTANIOAL NAME	COMMONIANT	ODEO(EIO ATIONIO		
- ⊢			BOTANICAL NAME	COMMON NAME	SPECIFICATIONS		
	TREE						
٠ ل	SFO 32 SIDEROXYLON FOETIDISSIMUM M/		SIDEROXYLON FOETIDISSIMUM	MASTIC TREE	16 FT. OA 4 IN. DBH		
	CSP	1	CHORISIA SPECIOSA	FLOSS SILK TREE	COLLECTED 30 FT. OA HT.		
. [PALI	/IS					
	PRO	35	PHOENIX ROEBELENII	PYGMY DATE PALM	SINGLES - STAGGERED HT. 6-9-12 FT. CT , TRIPLE - 12 FT. CT		
	PSY	11	PHOENIX SYLVESTRIS	SYLVESTER DATE PALM	18 FT. CT		
· [PRE	1	PHOENIX RECLINATA HYBRID	FLORIDA HYBRID DATE PALM	MULTI-TRUNK 30 FT. OA HT.		
	UND	ERSTORY T	REES & SHRUBS				
· L	GL	170	GYMNANTHES LUCIDA	CRABWOOD	25 GAL. 6 FT. HT. OA		
	FM1	86	FICUS MICROCARPA 'GREEN ISLAND'	FICUS 'GREEN ISLAND'	15 GAL. 3 FT. OA		
. [FM2	12	FICUS MICROCARPA 'GREEN ISLAND'	FICUS 'GREEN ISLAND'	25 GAL. BUSH 5 FT. HT.		
	FM3	69	FICUS MICROCARPA 'GREEN ISLAND' FICUS 'GREEN ISLAND'		3 GAL.		
	CI	73	CHRYSOBALANUS ICACO 'RED TIP'	COCOPLUM	15 GAL. 4 FT. HT.		
· [ZP	35	ZAMIA PUMILA	COONTIE	15 GAL. 3 FT. X 3 FT.		
	CZ	18	CALYPTRANTHES ZUZYGIUM	MYTLE-OF-THE-RIVER	25 GAL. 6 FT. HT.		
,	PL	5	POLYALTHIA LONGIFOLIA	MAST TREE	25 GAL. 10 FT. HT.		
Γ	PR	23	PHILODENDRON 'RON WEEKS'	SAME	7 GAL.		
	ACC	ENTS					
` [PB	10	PHILODENDRON BIPINNATIFIDUM	SPLIT-LEAF PHILODENDRON	7 GAL.		
	BI	8	BOUGAINVILLEA ' IMPERIAL THAI'	SAME	25 GAL. TRELLIS TRAINED TO TRUNK OF PALMS		
	GRO	UNDCOVER	S				
	LM	1,355	LIRIOPE MUSCARI	LILYTURF	3 GAL. 18 OC.		
, [MISC).					
	ALL:	SOD AREAS	TO BE REPLACED WITH ZOYSIA 'ZEON'				
	LANI	SCAPE ARG	CHITECT TO HAVE \$2000 WHOLESALE ACCENT	PLANT ALLOWANCE			

TREE RELOCATION SCHEDULE

#	BOTANICAL NAME	COMMON NAME	DBH.	HT.	SPREAD	ACTION	NOTES
7	PHOENIX SYLVESTRIS	SYLVESTER DATE PALM	12"	24'	18'	RELOCATE	LOCATION OF PLANT MATERIAL CONFLICTS WITH CONSTRUCTION ENVELOPE
8	PHOENIX SYLVESTRIS	SYLVESTER DATE PALM	12"	24'	18'	RELOCATE	LOCATION OF PLANT MATERIAL CONFLICTS WITH CONSTRUCTION ENVELOPE
9	PHOENIX SYLVESTRIS	SYLVESTER DATE PALM	10"	18'	12'	RELOCATE	LOCATION OF PLANT MATERIAL CONFLICTS WITH CONSTRUCTION ENVELOPE
11	PHOENIX SYLVESTRIS	SYLVESTER DATE PALM	8"	12'	8'	RELOCATE	LOCATION OF PLANT MATERIAL CONFLICTS WITH CONSTRUCTION ENVELOPE

PLANT REFERENCE IMAGERY















SEAL (S TYLER NIELSEN - LA6667067)

tequesta, fl 561.402.9414

www.nielsenlandarch.com

ALTER GARD



NTING	SCHEDULE & NOTES	
E	ISSUE	


COORDINATION

REVISION 1

03.21.2022

04.06.2022



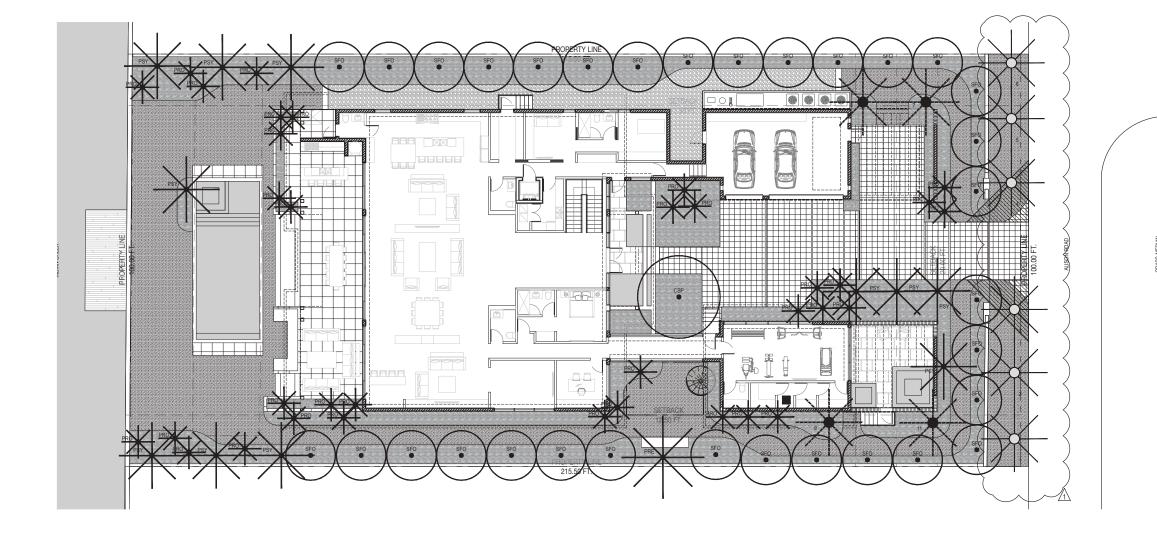



www.nielsenlandarch.com

THE SALTER GARDEN
6470 GARDEN 16470 ALLISON RD. 1 MIMMI BEACH, RORIDAS 3141

PLANTING SCHEDULE

	ABR. (YTITMAUÇ	BOTANICAL NAME	COMMON NAME	SPECIFICATIONS				
	TREES								
	SFO	32	SIDEROXYLON FOETIDISSIMUM	MASTIC TREE	16 FT. OA 4 IN. DBH				
	CSP 1 CHORISIA SPECIOSA		CHORISIA SPECIOSA	FLOSS SILK TREE	COLLECTED 30 FT. OA HT.				
	PALMS								
/	PRO	35	PHOENIX ROEBELENII	PYGMY DATE PALM	SINGLES - STAGGERED HT. 6-9-12 FT. CT , TRIPLE - 9 FT. CT				
(PSY	11	PHOENIX SYLVESTRIS	SYLVESTER DATE PALM	18 FT. CT				
>	PRE	1	PHOENIX RECLINATA HYBRID	FLORIDA HYBRID DATE PALM	MULTI-TRUNK 30 FT. OA HT.				

TREE RELOCATION SCHEDULE

-									
	#	BOTANICAL NAME	COMMON NAME	DBH.	HT.	SPREAD	ACTION	NOTES	
	7	PHOENIX SYLVESTRIS	SYLVESTER DATE PALM	12"	24'	18'	RELOCATE	LOCATION OF PLANT MATERIAL CONFLICTS WITH CONSTRUCTION ENVELOPE	
	8	PHOENIX SYLVESTRIS	SYLVESTER DATE PALM	12"	24'	18'	RELOCATE	LOCATION OF PLANT MATERIAL CONFLICTS WITH CONSTRUCTION ENVELOPE	
	9	PHOENIX SYLVESTRIS	SYLVESTER DATE PALM	10"	18'	12'	RELOCATE	LOCATION OF PLANT MATERIAL CONFLICTS WITH CONSTRUCTION ENVELOPE	
	11	PHOENIX SYLVESTRIS	SYLVESTER DATE PALM	8"	12'	8'	RELOCATE	LOCATION OF PLANT MATERIAL CONFLICTS WITH CONSTRUCTION ENVELOPE	

PLANTING LEGEND
















SEAL (S TYLER NIELSEN - LA6667067)

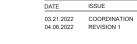



L701

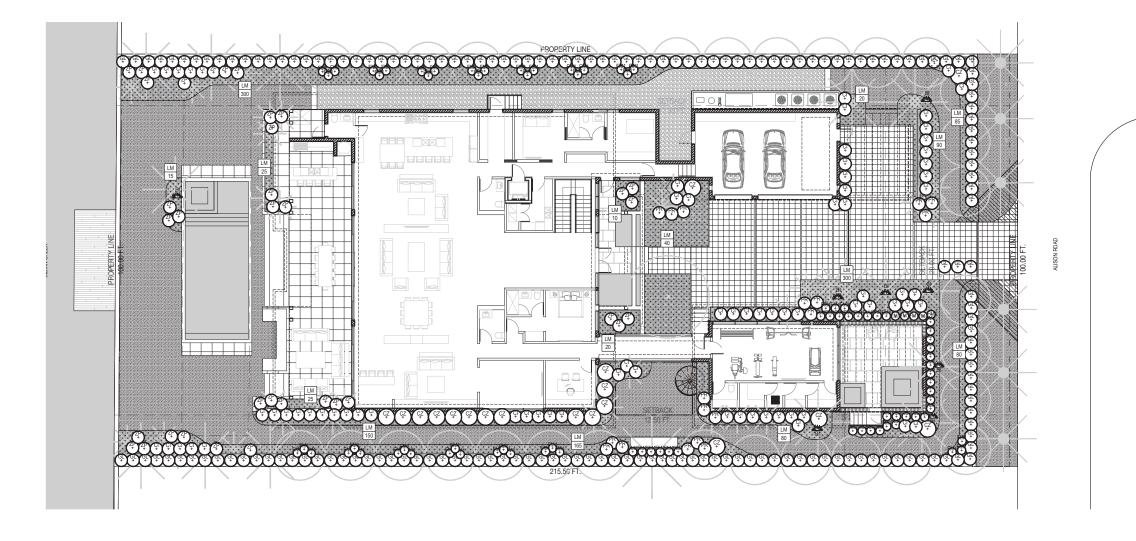

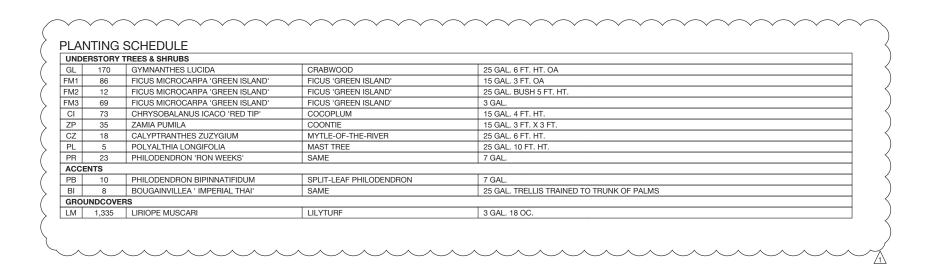



www.nielsenlandarch.com

THE SALTER GARDEN


PLANTING LEGEND









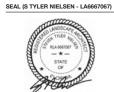

 04.06.2022

 UNDERSTORY PLANTING PLAN

 DATE
 ISSUE

03.21.2022

COORDINATION

REVISION 1






PROPOSED SHRUB / ACCENT




PROPOSED VINE



PROPOSED GROUNDCOVER

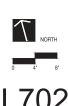

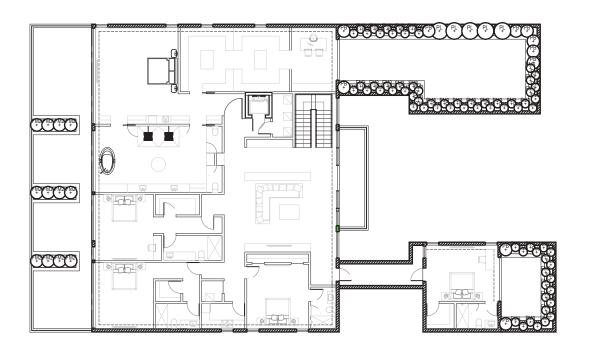

PLANTING SCHEDULE

I PANTING SOURDOLL								
UNDERSTORY TREES & SHRUBS								
GL	170	GYMNANTHES LUCIDA	CRABWOOD	25 GAL. 6 FT. HT. OA				
FM1	86	FICUS MICROCARPA 'GREEN ISLAND'	FICUS 'GREEN ISLAND'	15 GAL. 3 FT. OA				
FM2	12	FICUS MICROCARPA 'GREEN ISLAND'	FICUS 'GREEN ISLAND'	25 GAL. BUSH 5 FT. HT.				
FM3	69	FICUS MICROCARPA 'GREEN ISLAND'	FICUS 'GREEN ISLAND'	3 GAL.				
CI	73	CHRYSOBALANUS ICACO 'RED TIP'	COCOPLUM	15 GAL. 4 FT. HT.				
ZP	35	ZAMIA PUMILA	COONTIE	15 GAL. 3 FT. X 3 FT.				
CZ	18	CALYPTRANTHES ZUZYGIUM	MYTLE-OF-THE-RIVER	25 GAL. 6 FT. HT.				
PL	5	POLYALTHIA LONGIFOLIA	MAST TREE	25 GAL. 10 FT. HT.				
PR	23	PHILODENDRON 'RON WEEKS'	SAME	7 GAL.				
ACC	ACCENTS							
PB	10	PHILODENDRON BIPINNATIFIDUM	SPLIT-LEAF PHILODENDRON	7 GAL.				
BI	8	BOUGAINVILLEA ' IMPERIAL THAI'	SAME	25 GAL. TRELLIS TRAINED TO TRUNK OF PALMS				
GROUNDCOVERS								
LM	1,335	LIRIOPE MUSCARI	LILYTURF	3 GAL. 18 OC.				

357 cypress drive, 10 tequesta, fl 33469 561.402.9414

www.nielsenlandarch.com

THE SALTER GARDEN on GAPOR 10 FOUND BLOW BEACH FORD BASH 31

PLANTING LEGEND



RELOCATED PALM









03.21.2022 COORDINATION 04.06.2022 REVISION 1




PROPOSED TREE







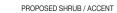







PROPOSED GROUNDCOVER



- LOOSEN & SCORE

REMOVE POT AND RECYCLE

- 3" PINE NEEDLE MULCH

(NO CYPRESS, NO RED)

BOUND ROOTS

3" CONTINUOUS

SOIL SAUCER RIM

EXISTING SOIL OR

APPROVED BACKFILL

SPECIFIED PLANTING

MOUND AND COMPACT SOIL

ROOT BALL EVEN WITH GRADE

NO LESS THAN 6". ADJUST








04.06.2022

PLANTING DETAILS ISSUE

03.21.2022 COORDINATION 04.06.2022 REVISION 1

SCALE AS NOTED:

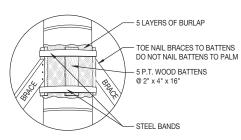

3 PAINTED BRACES @ 4" x 4" FOR ROYAL AND CHARACTER PALMS. 3 PAINTED BRACES @ 2" x 4" FOR 3" PINE NEEDLE MULCH -SMALL PALMS, (COLOR TO BE (NO CYPRESS, NO RED) HUNTER GREEN - 2041-10 BY BENJAMIN MOORE). 4" CONTINUOUS SOIL SAUCER RIM

PALM PLANTING AND STAKING DETAIL

SPECIFIED PLANTING

EXISTING SOIL OR

APPROVED BACKFILL

MIXTURE

SCALE: 3/32" = 1'- 0"

SCALE: 3/32" = 1'- 0"

3 STAKES @ 2" x 4" x 24" - TOP OF STAKE 6" ABOVE GRADE 2" x 4" STAKES PAD BURIED 3" BELOW GRADE, (PAINT TO MATCH BRACES).

MOUND AND COMPACT SOIL NO LESS THAN 12" ADJUST HEIGHT TO PLACE TOP OF ROOT BALL EVEN WITH GRADE, (REFER TO GRADING PLAN)

PALM & TREE BRACE PAINT CHIP:

SECURE BATTENS WITH 2-3/4" HI CARBON STEEL BANDS TO HOLD BATTENS IN PLACE DURING PLANTING PROCESS. DO NOT NAIL BATTENS TO PALM. THE HEIGHT OF BATTENS SHALL BE LOCATED IN RELATION TO THE HEIGHT OF THE PALM FOR ADEQUATE BRACING. PAINT ALL EXPOSED WOOD SURFACES, (COLOR TO BE HUNTER GREEN - 2041-10 BY BENJAMIN MOORE).

UNDERSTORY TREE PLANTING AND STAKING DETAIL

2x BALL DIA.

3" PINE NEEDLE MULCH -

(NO CYPRESS, NO RED)

4" CONTINUOUS

SPECIFIED PLANTING

APPROVED BACKFILL

EXISTING SOIL OR -

MIXTURE

SOIL SAUCER RIM

SHRUB PLANTING DETAIL SCALE: 3/32" = 1'- 0"

2x BALL DIA.

SCALE: 3/32" = 1'- 0"

GUY-WIRE TO HAVE PROTECTIVE RUBBER SLEEVE WHEN IN

CONTACT WITH PLANT MATERIAL

LOCATE BLACK GUY-WIRE

ADJUSTABLE SLIP KNOT

SAFETY BLACK GUYING

LINE-FASTING TO STAKE

- 3 STAKES @ 2" x 4" x 24"

TOP OF STAKE 6" ABOVE GRADE

MOUND AND COMPACT SOIL

ROOT BALL EVEN WITH GRADE

NO LESS THAN 12", ADJUST HEIGHT TO PLACE TOP OF

