


SACOTA Jungles III ORSINI DESIGN ASSOCIATES INC.

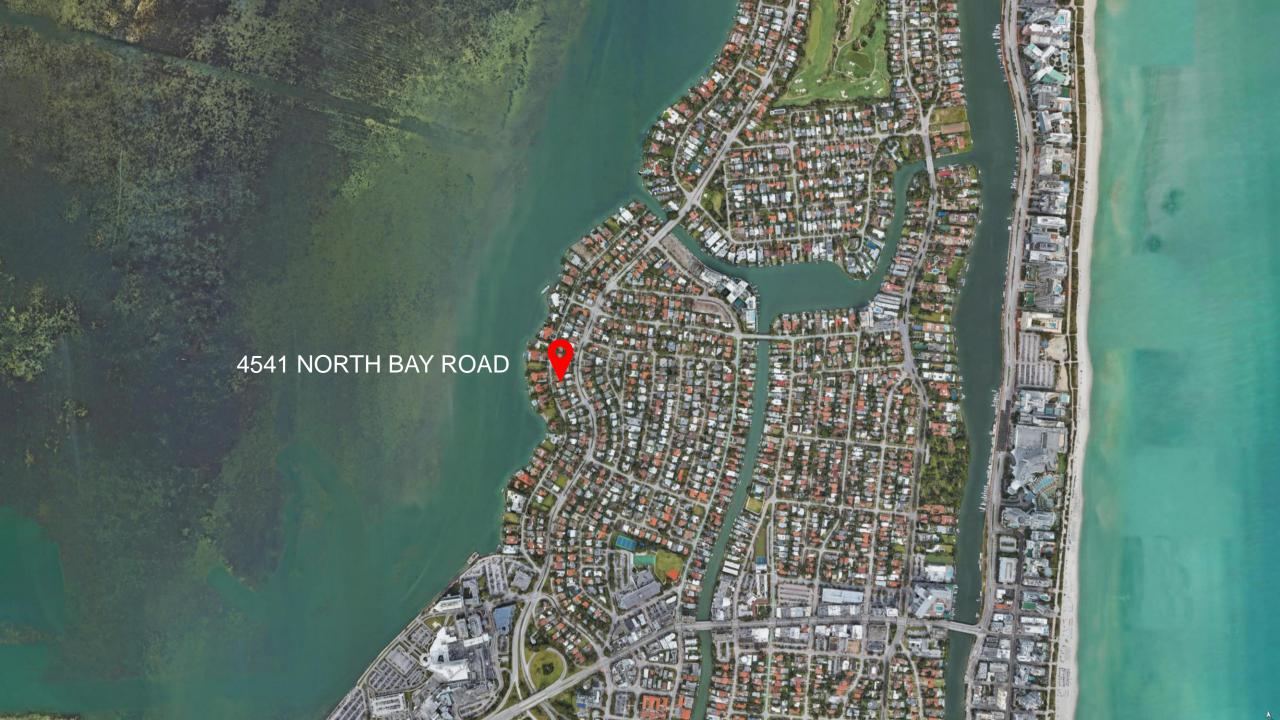




Neighbor Outreach & Support 4541 North Bay Road DRB File No. DRB22-0795



No.	Property Address	Owner
1.	4555 N Bay Rd	Alexander P. & Tiffany Z. Heckler
2.	4540 N Bay Rd	4540 NBR LLC
3.	4570 N Bay Rd	Mag NBR LLC Howard D. Komisar
4.	4580 N Bay Rd	Mag NBR LLC Howard D. Komisar



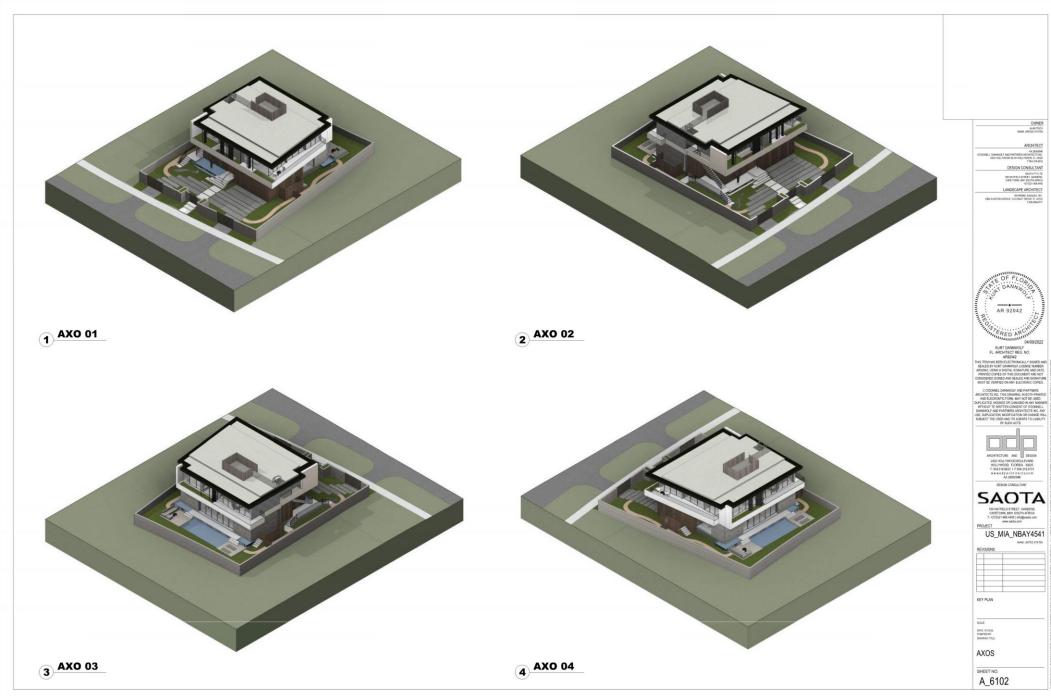

.



SAOTA

SHATTELD STREET, CARDENS,
CAPTOWN 800 SOUTH AFRICA
T1-278(017 ARE A400) Introgrand acres

4541 NORTH BAY RD

EXISTING STREET VIEW







DESIGN COMBILITIANT

SAOTA

150 HINTERED, STREET, GARDENS,
DUETONN SIDT SOUTH AFRICA
17 - 1700 HAND 100 Indignation com
PROJECT

4541 NORTH BAY RD


04-11-2022	DRB FINAL SUB

PROPOSED STREET MONTAGE VIEW

SHEET NO.





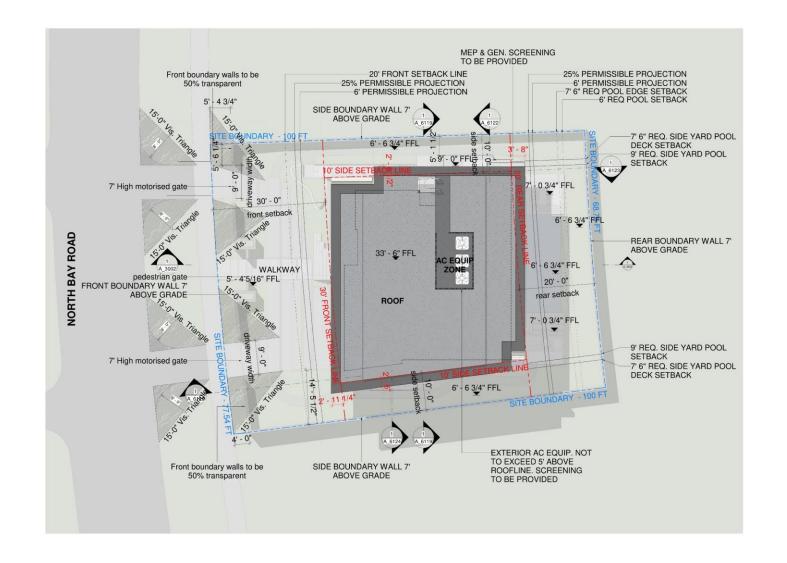


DESIGN CONSULTANT LANDSCAPE ARCHITECT ARCHITECTURE AND DESIGN **SAOTA** PROJECT US_MIA_NBAY4541 KEY PLAN SCALE, NET 1 T-O" SITE PLAN

1 SITE PLAN
1/8" = 1'-0"








A_6106

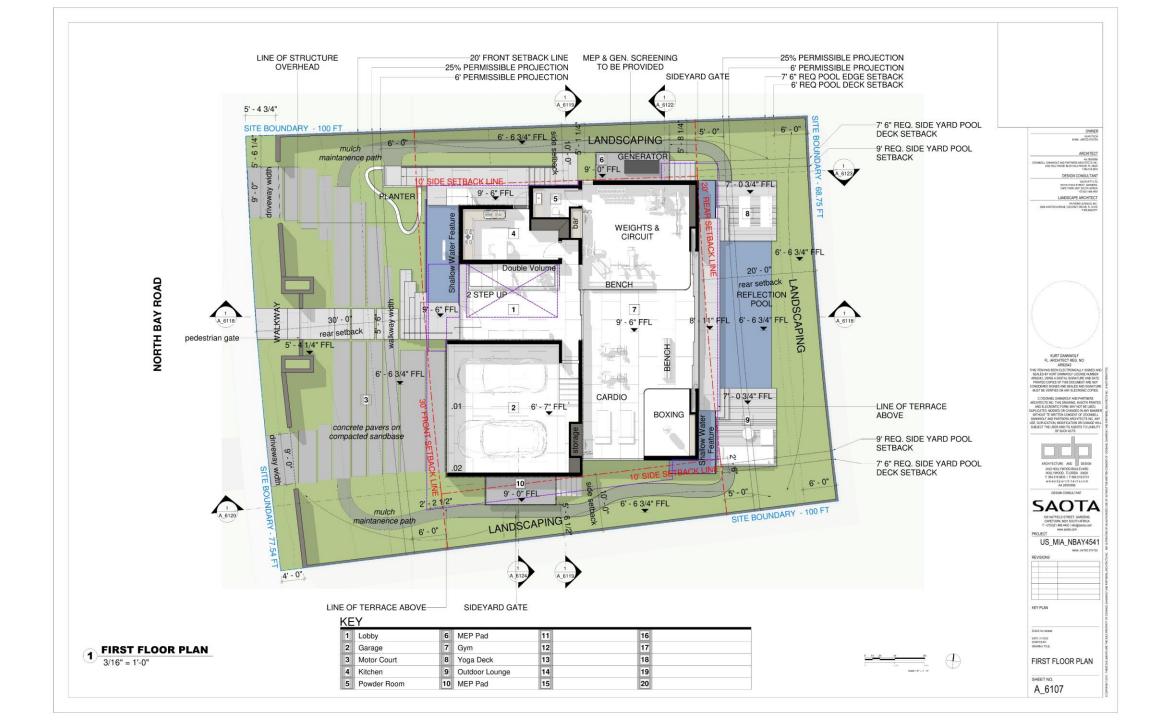




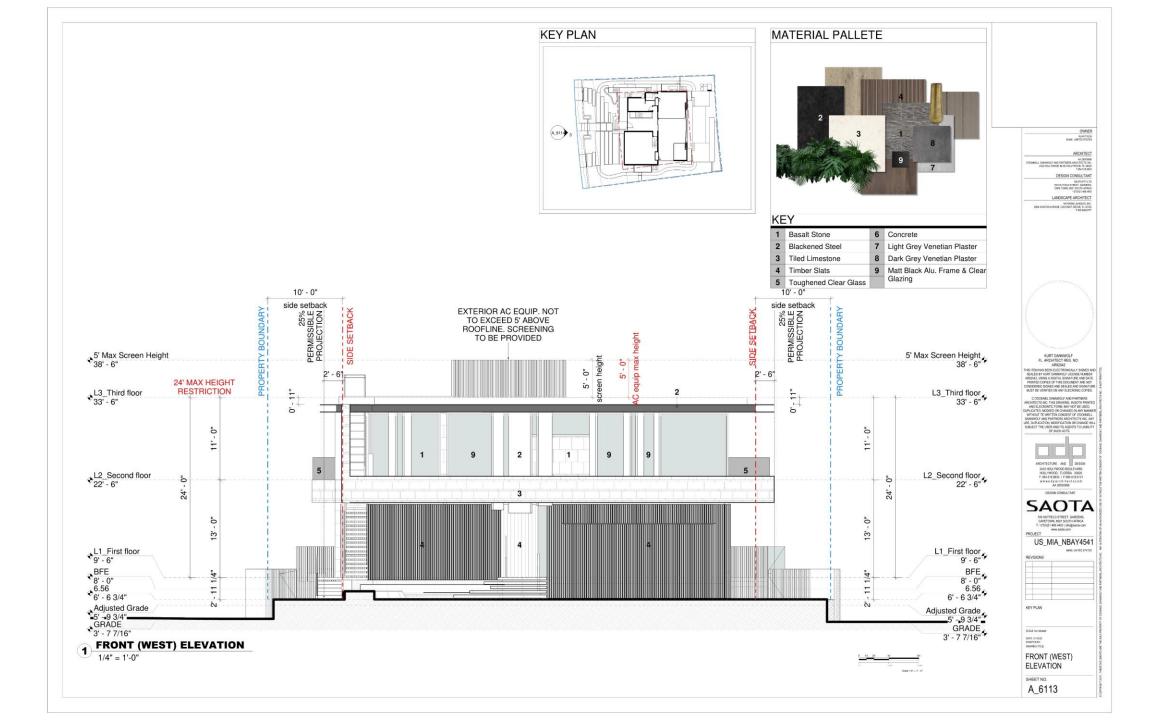

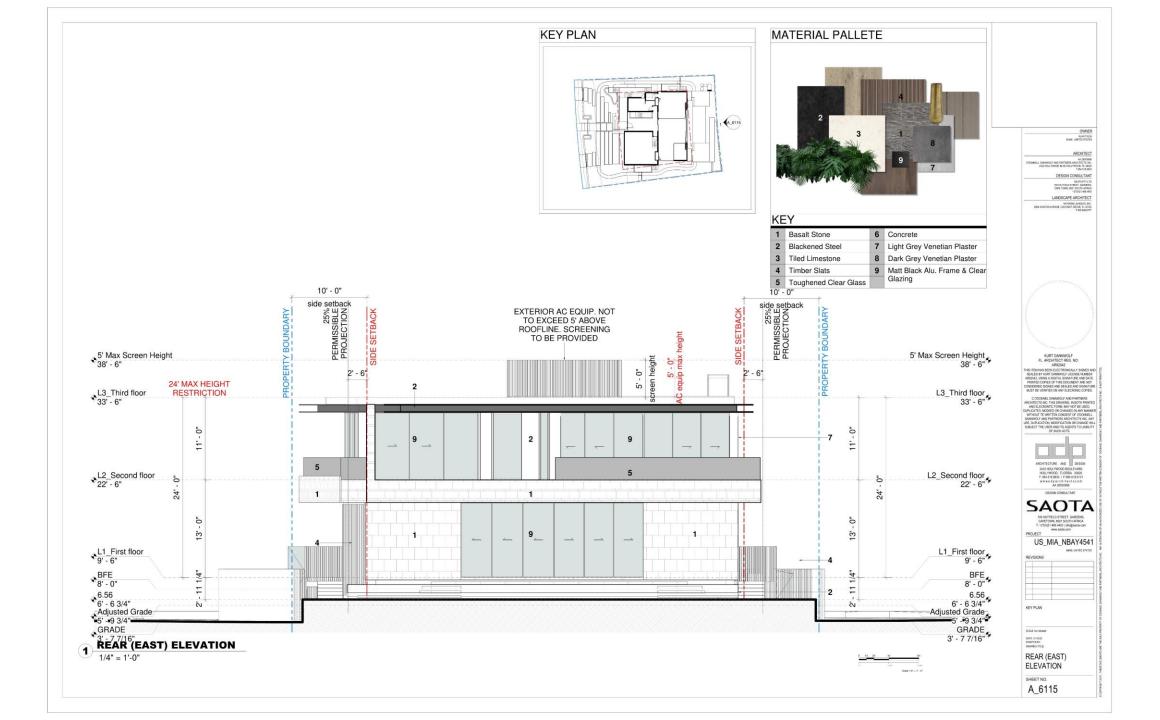

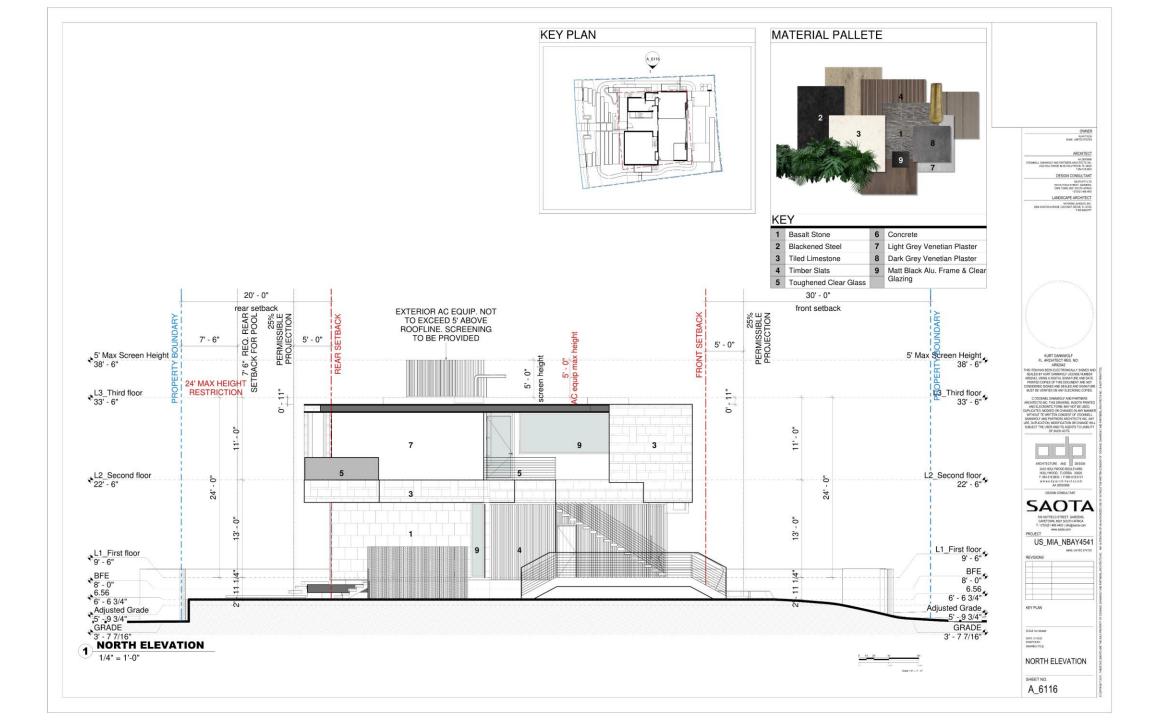

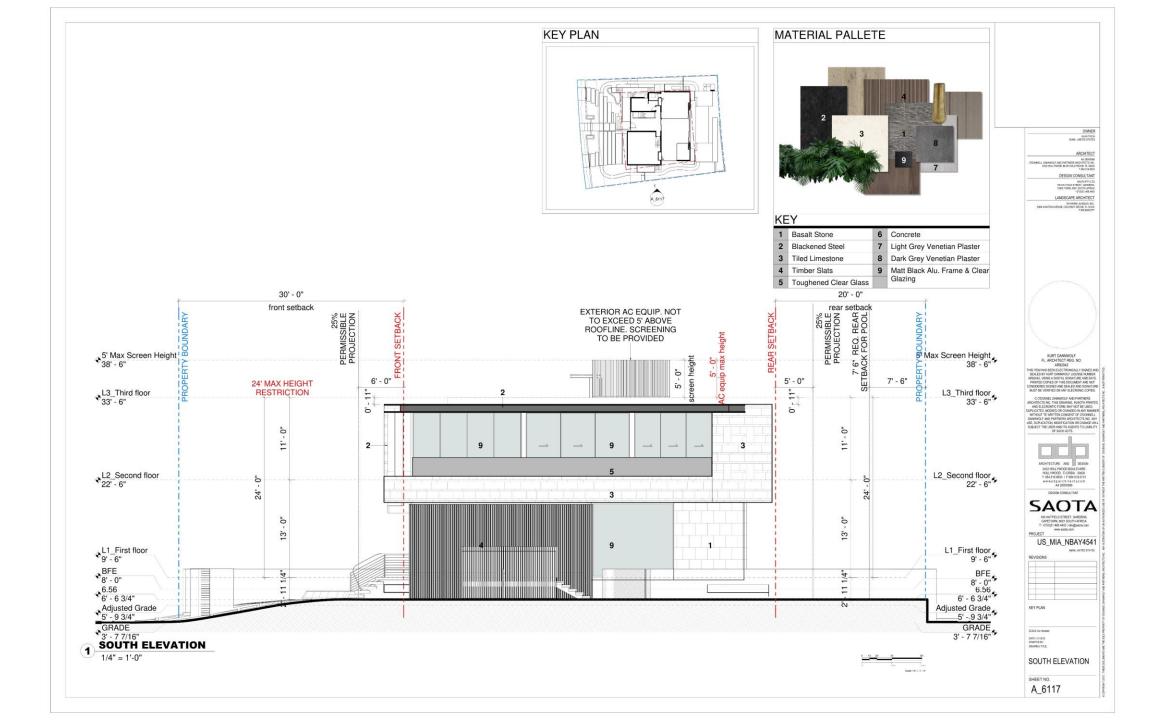

LANDSCAPE PLANS





PROPERTY LINE

SETBACK

- 1 Eugenia rhombea Red Stopper
- ② T.B.D. Sculptural Accent Canopy Tree
- 3 Polyalthia longifolia False Ashoka Tree
- Myrcianthes fragrans Simpson's Stopper
- ⑤ Clusia rosea Autograph Tree
- 6 T.B.D. Misc. Native Canopy Tree
- Sabal domingensis Dominican Sabal Palm
- ® Cocos nucifera Coconut Palm relocated from on-site
- Dypsis pembana Pemba Palm
- Misc. Native Understory Tree
- Thrinax radiata Green Thatch Palm
- Thrinax radiata Green Thatch Palm relocated from on-site

SCALE: 1/16" = 1'- 0"



FL. LANDSCAPE ARCHITECT Lic. # LA0000856

THIS ITEM HAS BEEN ELECTRONICALLY SIGNED AND SEALED BY RAYMOND JUNGLES LICENSE NUMBER LAQUORDS, USING A DIGITAL SIGNATURE AND DATE. PRINTED COPIES OF THIS DOCUMENT ARE NOT CONSIDERED SIGNED AND SEALED AND SIGNATURE MUST BE VERIFIED ON ANY ELECTRONIC COPIES.

Jungles
RAYMOND JUNGLES INC
Landscape Architect FASLA



2432 HOLLYWOOD BOULEVARD HOLLYWOOD, FLORIDA 33020 T: 954.518.0833 | F-954.518.0131 w.w.w.odparchitects.com AA 26000996

DESIGN CONSULTANT

4541 NORTH BAY RD


4541 NORTH BAY ROAD, MIAMI BEACH, FL 33140

SCALE: AS NOTED

CANOPY PLANTING PLAN

SHEET NO.

L-104

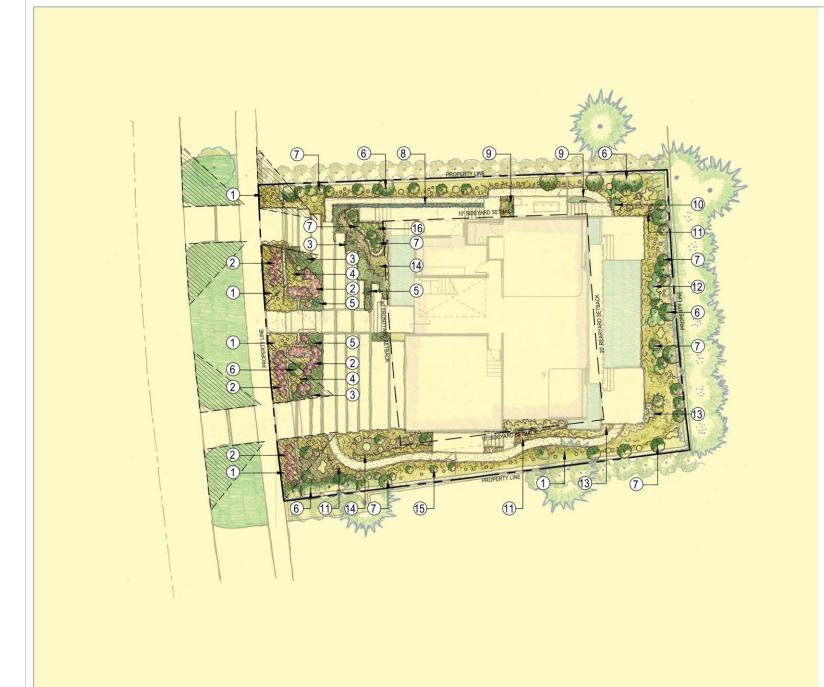

LEGEND


PROPERTY LINE

SETBACK

- 1 Microsorum scolopendrium Wart Fern
- 2 Portea petropolitana 'Jungles' Portea Bromeliad 'Jungles'
- ③ Peperomia obtusifolia Baby Rubber Plant
- Philodendron 'Burle Marx' Same
- ⑤ Monstera adansonii Swiss Cheese Philodendron
- 6 T.B.D. Misc. Large Native Shrub
- T.B.D. Misc. Low Native Shrub
- 8 Pilea glauca Same
- ¶ Trachelospermum jasminoides

 § Trachelospermum jasminoid Confederate Jasmine
- Zamia floridana Coontie
- Tarfugium japonicum 'Gigantea' Giant Leopard plant
- Philodendron gloriosum Anthurium Gloriosum
- 3 Begonia odorata Sweet Begonia
- Hymenocallis latifolia Spider Lily
- (5) Eranthemum pulchellum Blue Sage
- 6 Phyllanthus myrtifolius Mousetail Plant

SCALE: 1/16" = 1'- 0"

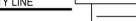



FL. LANDSCAPE ARCHITECT Lic. # LA0000856

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2432 HOLLYWOOD BOULEVARD HOLLYWOOD, FLORIDA 33020 T: 954.518.0833 I F:954.518.0131 www.odparchitects.com AA 28000996

DESIGN CONSULTANT


4541 NORTH BAY RD

4541 NORTH BAY ROAD, MIAMI BEACH, FL 33140

SCALE: AS NOTED

UNDERSTORY PLANTING PLAN - GROUND LEVEL

L-105

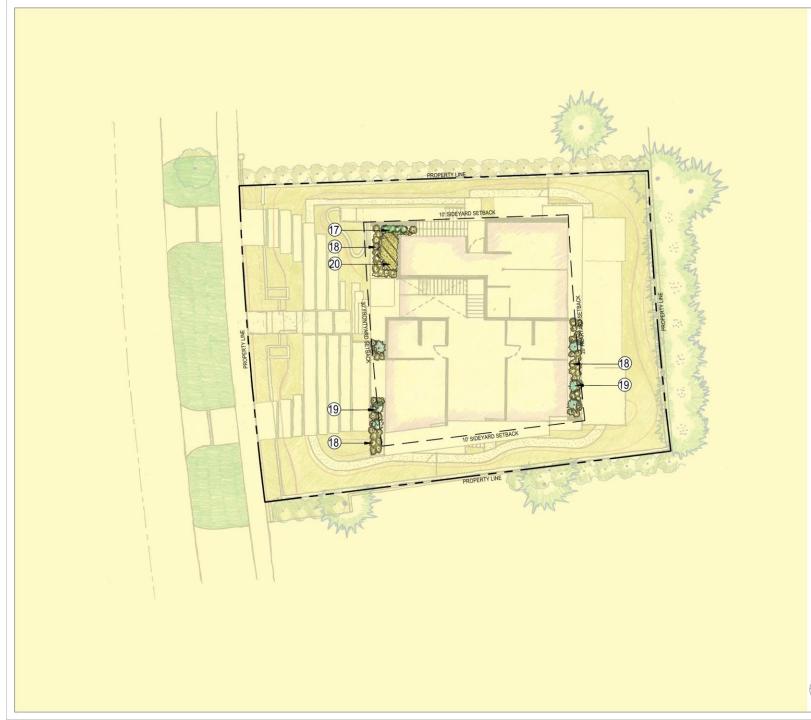

LEGEND

PROPERTY LINE

____SETBACK

Stephanotis floribunda Madagascar Jasmine

- Ernodea littoralis
 Golden Beach Creeper
- Alcantarea 'Odorata'
 Same
- 20 Nephrolepis exaltata Boston Fern

SCALE: 1/16" = 1'- 0"

Y LINE

4541 NORTH BAY ROAD, MARK BEACH, RU ARCHIT

TOOMMELL DAWNINGER AND PARTMERS ARCHITECTS INC. \$455 HOLLYWOOD FIT. 3000 T 394.51

DESIGN CONSULT

SAOTA PTY 09 HATTIELD STREET, GARDENS, CAPE TOWN, ROST SOUTH AT +27/001 ASS

RAYMOND ANGLES INC.
284 AVATOLANGUE COCOMUT SPOVE PL 33132



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UTECTURE AND DESIGN

2432 HOLLYWOOD BOULEVARD HOLLYWOOD, FLORIDA 33020 T: 954.518.0833 I F:954.518.0131 www.adparchitects.com AA 25000996

DESIGN CONSULTANT

SAOTA

09 HATFIELD STREET, GARDENS, CAPETOWN, 8001 SOUTH AFRICA +27(0)21.468.4400 | info@saota.com

PROJECT

4541 NORTH BAY RD

4541 NORTH BAY ROAD, MIAMI BEACH, FL 33140



SCALE: AS NOTED

DATE: 04/11/22 DRAWN BY: JS

UNDERSTORY PLANTING PLAN - SECOND LEVEL

SHEET NO.

L-106







CLIENT

4541 NBR LLC ADDRESS: 655 MADISON AVE 11 FL NEW YORK, NY 10065

SAOTA

DESIGN CONSULTANT

ADDRESS: 109 HATFIELD STREET, GARDENS, CAPETOWN, 8001 SOUTH AFRICA PHONE: +27(0)21.468.4400



ARCHITECT OF RECORD

O'DONNELL DANNWOLF AND PARTNERS ARCHITECTS INC ADDRESS: 2432 HOLLYWOOD BOULEVARD, HOLLYWOOD, FL 33020 PHONE: 954.518.0833

jungles

LANDSCAPE ARCHITECT

RAYMOND JUNGLES, INC.

ADDRESS: 2964 AVIATON AVENUE, COCONUT GROVE, FL 33133 PHONE: 305.858.6777

DESIGN REVIEW BOARD APPLICATION: DRB22-0795 FINAL SUBMITTAL: 04-11-2022

4541 NORTH BAY ROAD

MIAMI BEACH, FLORIDA 33140

DRB Final Submittal 04-11-22 DRB 1st Submittal 03-21-22

LANDSCAPE

L-000	COVER		•
L-100	TREE DISPOSITION PLAN	•	
L-101	TREE DISPOSITION SCHEDULE		•
L-102	TREE DISPOSITION NOTES & DETAILS		
L-103	HARDSCAPE PLAN		
L-104	CANOPY PLANTING PLAN	•	
L-105	UNDERSTORY PLANTING PLAN - GROUND LEVEL	•	
L-106	UNDERSTORY PLANTING PLAN - SECOND LEVEL	•	
L-107	PLANT LIST & MITIGATION CHART		
L-108	LANDSCAPE LEGEND		
L-109	PLANTING DETAILS	•	
L-110	PLANTING NOTES & SPECIFICATIONS		
L-111	LANDSCAPE LIGHTING SPECIFICATIONS		

SI	

BOLINDARY SLIRVEY	

DRB Final Submittal 04-11-22 DRB 1st Submittal 03-21-22

ARCHITECTURE

A-00	COVER		
A-01	DRAWING INDEX		•
A-02	PROJECT INFO & CITY ZONING DATA	•	
A-03	ZONING ANALYSIS		
A-10	EXISTING SOUTH-WEST NEIGHBOR PHOTOS		
A-11	EXISTING NORTH-WEST NEIGHBOR PHOTOS		
A-12	EXISTING SOUTH NEIGHBOR PHOTOS		•
A-13	EXISTING NORTH NEIGHBOR PHOTOS		•
A-14	EXISTING NORTH BAY ROAD PHOTOS		
A-20	EXISTING SITE PHOTOS		
A-21	EXISTING HOUSE PHOTOS		
A-30	EXISTING STREET VIEW		
A-31	PROPOSED STREET MONTAGE VIEW		

DESIGN AF	RCHITECTURE		
A_6101	MATERIAL PALLETE		
A_6102	AXOS		
A_6103	UNIT SIZE		•
A_6104	COVERAGE		
A_6105	PERVIOUS YARDS		
A_6106	SITE PLAN	•	•
A_6107	FIRST FLOOR PLAN	•	
A_6108	SECOND FLOOR PLAN	•	
A_6109	ROOF PLAN		
A_6110	L1 DIMENSIONED PLAN		•
A_6111	L2 DIMENSIONED PLAN		•
A_6112	L3 DIMENSIONED PLAN		
A_6113	FRONT (WEST) ELEVATION		
A_6114	35% FRONT SETBACK		
A_6115	REAR (EAST) ELEVATION		•
A_6116	NORTH ELEVATION		•
A_6117	SOUTH ELEVATION		•
A_6118	SECTION AA		•
A_6119	SECTION BB		•
A_6120	SECTION CC		
A_6121	SECTION DD		
A_6122	SECTION EE		•
A_6123	SECTION FF		•
A_6124	SECTION GG		•
A_6125	FRONT VIEW 01		•
A_6126	FRONT VIEW 01		•
A_6127	FRONT VIEW 02		
A_6128	FRONT VIEW 02		
A_6129	INTERNAL VIEW		•
A_6130	REAR VIEW 01		•
A_6131	PERSPECTIVE SECTION 01	•	•
A_6132	PERSPECTIVE SECTION 02	•	•

APPLIANT INC.

APPLIA



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SUSTAINANT STOREST CAMBRIDGE
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WAND OF ASSAURCE ASSEST
CAMBRID AND THE ASSAURCE
CAMBRID

DRAWING INDEX

JOHN IBARRA & ASSOCIATES, INC.

TITLE COMMITMENT NOTES:

THAT I HAVE REVIEWED THE COMMITMENT AND ALL ITEMS ARE SHOWN ON THE SURVEY.


THE ITEMS SHOWN HERE FORTH ARE PER SCHEDULE BIJ OF FIRST AMERICAN TITLE INSURANCE COMPANY, COMMITMENT FILE NUMBER 1062-5580754, ISSUING OFFICE FILE NUMBER: 21-451 NBR, DATED AUGUST 0, 2021, AT 8:00 A.M.;

ITEM 9. RESTRICTIONS, DEDICATIONS, CONDITIONS, RESERVATIONS, EASEMENTS AND OTHER THEM RESTRICTIONS, DEDUCATIONS, CONDITIONS, RESERVATIONS, EASEMENTS AND OTHER MATTERS SHOWN ON THE PLAT OF MAINTLES SUBDISHOODS, A RECORDED IN PAIR BOOK 8, WAS THE RESERVE THAT BOOK 8, PREFERENCE LIMITATION OF DESCRIMMATION HASSO ON PRACE COLOR RELIGION, SICK HARDICAP, PRACE STRICTIONS OF RESTRICTIONS WORLD FOR THE SUBJECT PROPERTY AND SEARCH FOR THE SUBJECT PROPERTY FOR THE SUBJECT PROPE


Professional Land Surveyors & Mappers



MAP OF BOUNDARY SURVEY

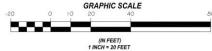



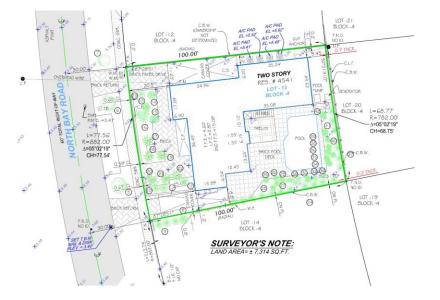

TREE TABLE						
No.	Name	Diameter (Ft.	Height (Ft.) Spread (ft		
	TRZE	0.3	13.0	10.0		
2	TREE	1.5	20.0	5.0		
3	TREE	0.8	20.0	20.0		
4	TREE	0.4	20.0	12.0		
5	TREE	1.5	25.0	30.0		
6	TREE	1.5	35.0	25.0		
7	TREE	0.4	20.0			
8	PALM	1.5	20.0	8.0		
9	EDGE	4.0	10.0	5.0		
10	PALM	0.5	10.0	5.0		
	PALM	0.5		5.0		
	PALM	0.6		6.0		
13	PALM	0.7	25.0	12.0		
14	PALM	0.8	30.0	12.0		
15	PALM	0.8	25.0	12.0		
	PALMS CLUSTER (3)	1.5				
	PALM	1.7	45.0			
10	PALM	2.0	45.0	15.0		
19	PALM	1.6	45.0	15.0		
	PALM	1.6	40.0			
	PALM	2.0	45.0	15.0		
	PALM	2.0	30.0			
	PALM	1.6	15.0			
24	EDGE	4.0	10.0	5.0		
25	PALM	0.6	20.0	3.0		
26	PALM	0.6	20.0	8.0		
	PALM	0.7		3.0		
28	PALM	0.3	30.0	8.0		
29	PALM	0.4	12.0	3.0		
	PALMS CLUSTER (6)	5.0	40.0	20.0		
31	COCONUT PALM	0.6	45.0	13.0		
32	PALM	0.2	5.0	2.0		
	PALM		7.0	3.0		
34	PALM	0.7	35.0	13.0		
35	PALM	1.0	20.0	10.0		
36	PALM	0.3	8.0	5.0		
37	PALM	0.3	15.0	2.0		
38	PALM	1.0	20.0			
39	COCONUT PALM	0.6	30.0	10.0		
40	PALM	0.6	13.0	10.0		
41	COCONUT PALM	0.7	40.0	15.0		
42	COCONUT PALM	0.7	38.0	15.0		

SURVEYORS NOTE:
AN ARBORIST MUST CONFRM ALL THE TREE NAMES, CONDITION AND
SPECIES, WHAT IS SHOWN ON THE SURVEY
MAY NOT BE THE CORRECT NAME OF THE TREES. LAND SURVEYORS ARE NOT ARBORIST.





LEGAL DESCRIPTION:
THE LAID REPRED TO HEREN BELOW IS SITUATED IN THE COUNTY OF MIAVI-DADE,
STATE OF PLORIDA, AND DESCRIBED AS FOLLOWS:
LOT 13, BLOCK 4 OF NAUTILUS SUBDIVISION, ACCORDING TO THE PLAT THEREOF AS
RECORDED IN PLAT BOOK 8, PRACES) 95, OF THE PUBLIC RECORDS OF MIAMI-DADE

PROPERTY ADDRESS:

ABBREVIATIONS

LEGAL DESCRIPTION:

MIAMI BEACH, FLORIDA 33140

CERTIFICATION: 454 I NBR LLC; STACI J. RUTIMAN, P.A. D/B/A RUTIMAN LAW; FIRST AMERICAN TITLE INSURANCE COMPANY, ITS SUCCESSORS AND OR ASSIGNS, AS THEIR

FLOOD ZONE INFORMATION:

THE WIPP FLOOR MAYS HAVE DESIGNATED THE HEREM DESCRIBED LAND TO BE SITUATED BY FLOOR ZOON MAYS HAVE DESIGNATED THE HEREM DESCRIBED LAND TO BE SITUATED BY FLOOR ZOON THE STATE OF THE STATE

- SURVEYOR'S NOTES:

 1. IF SHOWN, BEARNINGS ARE REFERRED TO AN ASSUMED MERIDIAN, BY SAID PLAT IN THE DESCRIPTION OF THE PROPERTY of NOT, BEARNINGS AND THEN REFERRED TO COUNTY, TOWNSHIP MAPS.

 2. THE CLOSINGS IN THE BOUNDARY SURVEY IS ABOVE 1.7500 FT.

- CERTIFICATE OF AUTHORIZATION LB # 7806.
 ALL ELEVATIONS SHOWN ARE REFERRED TO NATIONAL GEODETIC VERTICAL DATUM OF 1929 MIAMI DADE COUNTY BENCH MARK RD-157-R. LOCATOR NO. 3223 SW @ 44TH STREET & ALTON ROAD; ELEVATION IS 4.93 FEET OF N.G.V.D. OF 1929.

Digitally signed by
AULO FUREZ
Date: 2022/02/08
14,9731-05'90' 11/01/2021

JULIO E. PEREZ SWIG PROTESTORAL UNIS SURVIVOR NO. 6029 STATE OF FLORIDA

REVISED ON: ADD TREES 11-01-21 REVISED ON: ORIGINAL SURVEY 08-26-21

	O-H			= OVERHEAD UTILITY LINES = CONCRETE BLOCK WALL
×	×	×	×	= CHAIN LINK FENCE
0	-0	-0-	-0-	= IRON FENCE
-11	- //		-11	= WOOD FENCE
_	_	_	_	= BUILDING SETBACK LINE
_	_	_	_	= UTILITY EASEMENT
W	Ш	111	·III	= LIMITED ACCESS R/W
		1	,	= NON-VEHICULAR ACCESS I
			× 0.00	= EXISTING ELEVATIONS

	(1.0)	
RAWN BY:	LK	O C. Pane
ELD DATE:	11/01/2021	(220)
URVEY NO:	21-003099-3	Digitally signed by JULIO E PEREZ
HEET:	1 OF 1	Date: 2022.02.08 14:38:04 -05'00'



Planning Department, 1700 Convention Center Drive Miami Beach, Florida 33139, www.miamibeachfl.gov 305.673.7550

SINGLE FAMILY RESIDENTIAL - ZONING DATA SHEET

ITEM #	Zoning Information						
1	Address:	4541 NORTH BAY ROAD, MIAMI	4541 NORTH BAY ROAD, MIAMI BEACH, FL 33140				
2	Folio number(s):	02-3222-011-0840	02-3222-011-0840				
3	Board and file numbers :	DESIGN REVIEW BOARD - DRB	22-0795				
4	Year built:	1928	Zoning District:	RS-4			
5	Base Flood Elevation:	+8' NGVD (per 54-35)	Grade value in NGVD:	+3.62' NGVD			
6	Adjusted grade (Flood+Grade/2):	+5.81' NGVD	Free board:	1'-6"			
7	Lot Area:	7,314 SF					
8	Lot width:	75.79 FT (@20' front setback)	Lot Depth:	100.00 FT			
9	Max Lot Coverage SF and %:	2,194.2 SF / 30%	Proposed Lot Coverage SF and %:	2,163 SF / 29.57%			
10	Existing Lot Coverage SF and %:	4,548 SF / 62.18%	Lot coverage deducted (garage-storage) SF:	N/A			
11	Front Yard Open Space SF and %:	2,286 SF / 50%	Rear Yard Open Space SF and %:	1,391 SF / 72%			
12	Max Unit Size SF and %:	3,657 SF / 50%	Proposed Unit Size SF and %:	3,597 SF / 49%			
15	Min Additional 5' Setback for 35% of Front 2nd Story:	35% of 57.71 FT = 20.20 FT	Proposed Additional 5' Setback of Front 2nd Story:	23.46' + 3.24' = 26.70 FT / 46.27%			
16	Max Roof Deck Area SF and % (Note: Maximum is 25% of the enclosed floor area immediately below):	N/A	Proposed Roof Deck Area SF and %:	N/A			

		Required	Existing	Proposed	Deficiencies
17	Height:	24 FT	24.0'	24'-0"	
18	Setbacks:				
19	Front First level:	30 FT	20.5'	30'-0"	
20	Front Second level:	30 FT	20.5'	30'-0"	
21	Side 1:	10 FT	5.2'	10'-0"	
22	Side 2 or (facing street):	10 FT	8.8'	10'-0"	
23	Rear:	20 FT	9.45'	20'-0"	
	Accessory Structure Side 1:	N/A	N/A	N/A	
24	Accessory Structure Side 2 or (facing street):	N/A	N/A	N/A	
25	Accessory Structure Rear:	N/A	N/A	N/A	
26	Sum of Side yard :	18.88' (25% lot width)	14.0'	20'-0"	
27	Located within a Local Historic District?		NO		
28	Designated as an individual Historic Single Family Residence Site?		NO		
29	Determined to be Architecturally Significant?		YES - BASED ON AGE (1928)		

Notes:

If not applicable write N/A

All other data information should be presented like the above format



PROPERTY INFORMATION AND DATA

PROPERTY ADDRESS: 4541 NORTH BAY ROAD

MIAMI BEACH, FLORIDA 33140

02-3222-011-0840

FOLIO NUMBER:

SUB-DIVISION: NAUTILUS SUB

LEGAL DESCRIPTION: LOT 13, OF BLOCK 4, OF NAUTILUS SUBDIVISION, PLATBOOK 8, PAGE 95.

ZONING LOT DISTRICT: RS-4 SINGLE-FAMILY RESIDENTIAL DISTRICT

FLOOD ZONE: ZONE AE-8



AA 290

DESIGN CONSULTANT

SACIA 100 HATRELD STREET, G CAPE TOWN, 8001 SOUTH

+27/0.21 HBL ARIAN LANDSCAPE ARCHITECT SWINGOM JAMES NO. 2984 ANATON AVENUE, COCCHUT GROVE, PI, 20120 7 100:566-6777



KURT DANNWOLF FL. ARCHITECT REG. NO:

THIS ITEM HAS BEEN ELECTRONICALLY SIGN SEALED BY KURT DANNINOLF LICENSE MU ARIODAZ, USING A DOMINAL SIGNATURE AND PRINTED COPIES OF THIS DOCUMENT ARE CONSIDERED SIGNED AND SEALED AND SIGN MERITED VIGINETION MAY BE DEAD SIGN.

C O'DONNEL DANNIOLF AND PARTNERS
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DUPLICATED, MICHELD OR CHANGED IN ANY MANNER
WITHOUT TE WHITTEN COMBINET OF CROINNELL
DANNINGLY AND PARTNERS ARCHITECTS INC. ANY



ARCHTECTURE AND DESIGN
25/21-POLLYWOOD BOLLEVARD
HOLLYWOOD, FLORIDA 33026
T: 894-5/18.0731
WWW.00 par Shi Tects.com
AA 20000998

DESIGN CONSULTAN



CAPETOWN, 8001 SOUTH AFRI T: +27(0)21 A68 4400 | Info@sacta www.nacta.com

4541 NORTH BAY RD

ASIA CORTIS BOY ROOM, AWAR BEACH, FLISH
REVISIONS
04-11-2022 DISS FINAL SUBMITTAL

KEY PLAN

SOUE: 12" + 1"4"

PROJECT INFO & CITY ZONING DATA

SHEET NO.

4541 NORTH BAY ROAD 4



4540 NORTH BAY ROAD 3



4520 NORTH BAY ROAD



4462 NORTH BAY ROAD



SAOTA

109 HATFIELD STREET, GARDENS,
CAPETOWN 8001 SOUTH AFRICA
T + 270021 ANS A000 1 Individuals are

4541 NORTH BAY RD

SOUR UP - 1-0"
Date cassor interest or consumer or con

4580 NORTH BAY ROAD



4570 VACANT LOT



4550 NORTH BAY ROAD



4540 NORTH BAY ROAD 1



SAOTA

109 HATFIELD STREET, GARDENS,
DAFFORM, BOST SOUTH AFRICA

1. 47/10/21 ABLASO) INSEASSANCE

4541 NORTH BAY RD

DORE DY FOR DATE ORDER O

4541 NORTH BAY ROAD 4



4531 NORTH BAY ROAD



4515 NORTH BAY ROAD



4501 NORTH BAY ROAD



SAOTA

100 HATHELD STREET, GARDENS,
OMETION, BOST SOUTH AFRICA
TI *270(21 All AUIO) LINEARS

4541 NORTH BAY RD

EXISTING SOUTH NEIGHBOR PHOTOS



4591 NORTH BAY ROAD



4575 NORTH BAY ROAD



4565 NORTH BAY ROAD



4555 NORTH BAY ROAD



SAOTA

109 HATFIELD STREET, GARDENS,
CAPETOWN, 8001 SOUTH AFRICA
T. +270[GLI ABB. 400] I holigaseda cen

4541 NORTH BAY RD

EXISTING NORTH NEIGHBOR PHOTOS



LOOKING NORTHWEST

3

LOOKING NORTH 1

LOOKING WEST 4





SAOTA

109 HATFIELD STREET, GARDENS,
CAPETOWN, 8809 SOUTH AFRICA 4541 NORTH BAY RD

EXISTING NORTH BAY ROAD PHOTOS

LOOKING EASTERLY TO THE BACKYARD



LOOKING TOWARDS NW CORNER OF PROPERTY 5



LOOKING NORTHERLY FROM FRONT YARD 4



LOOKING SOUTH FROM FRONT YARD 3



LOOKING SOUTH FROM THE BACKYARD 2



LOOKING SOUTH TO SW CORNER OF PROPERTY 1

OWNER
HIM MORTH BUT ROME,
MINISTER PLANT PLANT
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DESIGN CONSULTANT

BACITA-PTY LTS

108 HATFIELD STREET, GARDENS

LANDSCAPE ARCHITECT



KURT DANNWOLF FL. ARCHITECT REG. NO:

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ARCHTECTURE AND DESIGN
2422 HOLLYWOOD BULLEVARD
HOLLYWOOD, FLORING 13003
T 1645-18 62111
www.od.plar.fb.fleet.sc.om
Accompress
42000996

SAOTA

109 Ha TFIELD STREET, GARDENS,
CAPETOWN 8001 SOUTH AFRICA

4541 NORTH BAY RD

691 NORTH BET FROM BARRE FROM FLESH
REVISIONS
04-11-2022 DRB FINAL SUBMITTAL

KEY PLAN

SOLE

EXISTING SITE PHOTOS

SHEET NO.







WEST ELEVATION 2 SOUTHWEST ELEVATION 3



SAOTA


158 HATFIELD STREET, GARDENS,
CAPETOWN 8001 SOUTH AFRICA

4541 NORTH BAY RD


EXISTING HOUSE PHOTOS

A-21

UNIT SIZE ALLOWANCE ALLOWABLE UNIT SIZE = LOT AREA X 50% (For CITY Compliance) 7 314 SF X 50% ALLOWABLE UNIT SIZE 3 657 SF GROSS INTERNAL AREA L1 FIRST FLOOR 1618 SF (Air Conditioned) 1 949 SF **L2** SECOND FLOOR GARAGE 30 SF 500 SF EXEMPT (530 - 500) (Not Air Conditioned) 3 597 SF TOTAL UNIT SIZE 49 % PERCENTAGE ACHIEVED

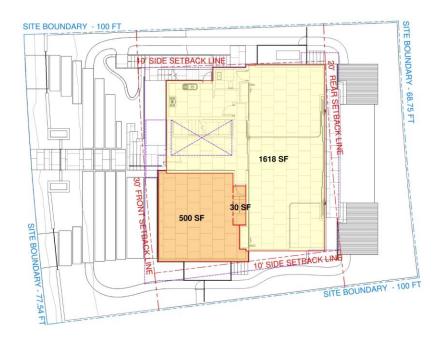

1) UNIT SIZE: FIRST FLOOR
1/8" = 1'-0"

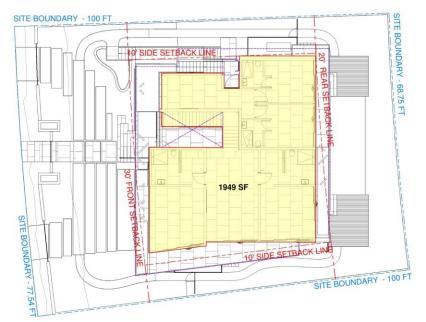

2 UNIT SIZE: SECOND FLOOR





SADIA PTV LTD 18HATFELD STREET, GARDONS, CAPE TOWN, 8001 SOUTH AFRICA +27/10/1 HE AREO LANDSCAPE ARCHITECT AR 92042 04/09/2022 ARCHITECTURE AND DESIGN SAOTA US_MIA_NBAY4541 KEY PLAN **UNIT SIZE** A_6103


DESIGN CONSULTANT

COVERAGE ALLOWANCE ALLOWABLE COVERAGE = LOT AREA X 30% (For CITY Compliance) 7 314 SF X 30% 2 194 SF ALLOWABLE COVERAGE FIRST FLOOR 2 120 SF SECOND FLOOR 8 SF 35 SF > 5FT PROJECTIONS TOTAL COVERAGE 2 163 SF PERCENTAGE ACHIEVED 29.57 %

COVERAGE EXEMP	TION	
< 5FT PROJECTIONS		762 SF

DESIGN CONSULTANT SACTA PTV LTD
158 WATERLD STREET, CARRENS,
CAPE TOWN, ROTE SOUTH APPICA
+27101 HE AREN
LANDSCAPE ARCHITECT AR 92042 ARDHITECTURE AND DESIGN SAOTA PROJECT US_MIA_NBAY4541 KEY PLAN COVERAGE SHEET NO.

A_6104

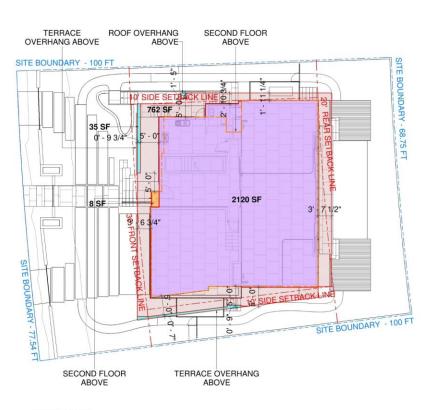

2 COVERAGE 1/8" = 1'-0"



FRONT YARD PERVIOUS ALLOWANCE (For CITY Compliance) MINIMUM PERVIOUS FRONT YARD 50% PERVIOUS 1144 SF 1142 SF HARDSCAPE TOTAL FRONT YARD 2 286 SF **PERVIOUS** 1144 SF 1144 SF TOTAL PERMEABLE

PERCENTAGE ACHIEVED	50 %
	00 /0

REAR YARD PERVIOUS ALLOWANCE (For CITY Compliance)	
MINIMUM PERVIOUS REAR Y	/ARD 70%
PERVIOUS	750 SF
POOL BELOW ADJUSTED GRADE	241 SF
POOL ABOVE ADJUSTED GRADE	22 SF
HARDSCAPE	378 SF
TOTAL REAR YARD	1 391 SF

50% POOL ABOVE ADJ GRADE	11 SF
100% POOL BELOW ADJ. GRADE	241 SF
PERVIOUS	750 SF

PERCENTAGE ACHIEVED	72 %

DESIGN CONSULTANT SADIA PTV LTD
189 HATFELD STREET, GARDONS,
CAPE TOWN, 8001 SOUTH AFRICA
+27/10/1 HE AREO
LANDSCAPE ARCHITECT



ARCHITECTURE AND DESIGN

SAOTA

REVIS	IONS	Т	
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KEY P	LAN		

PERVIOUS YARDS

A_6105





PERVIOUS YARDS


1/8" = 1'-0"






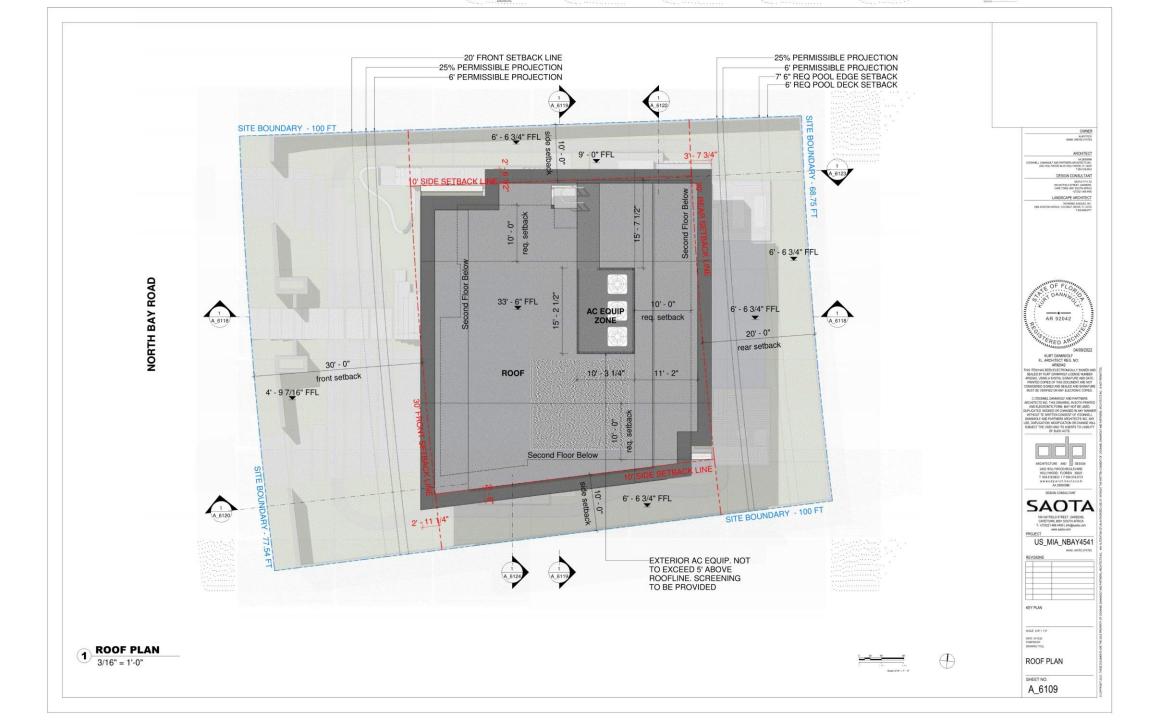

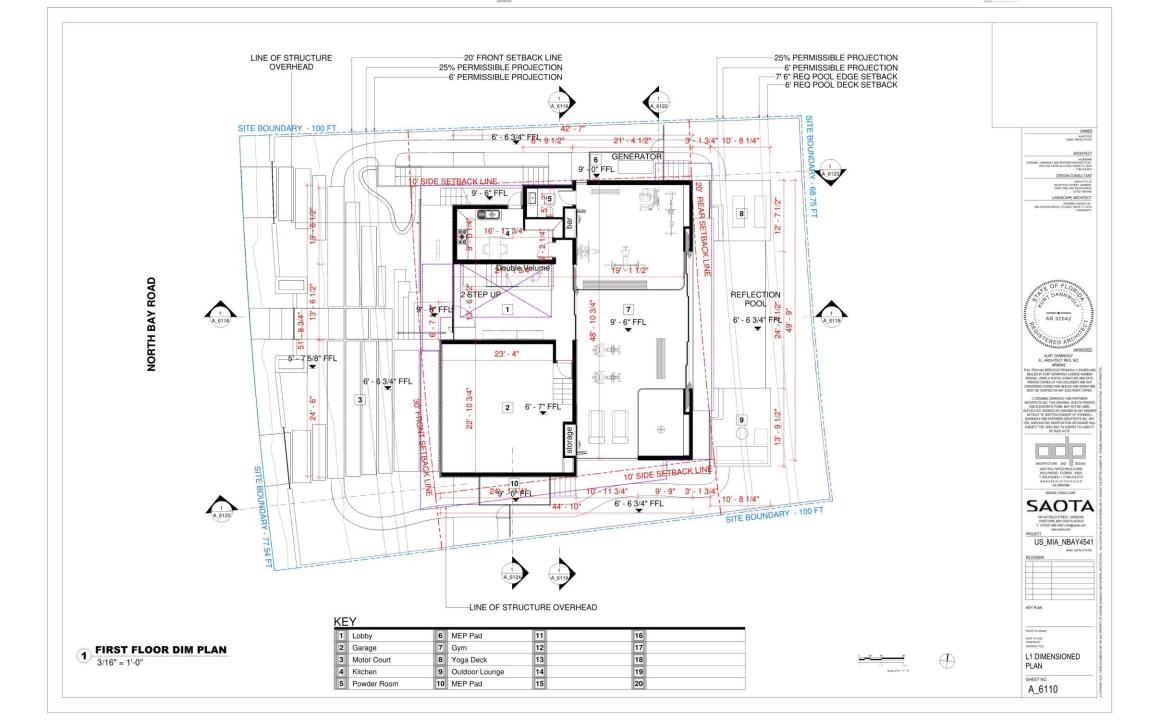

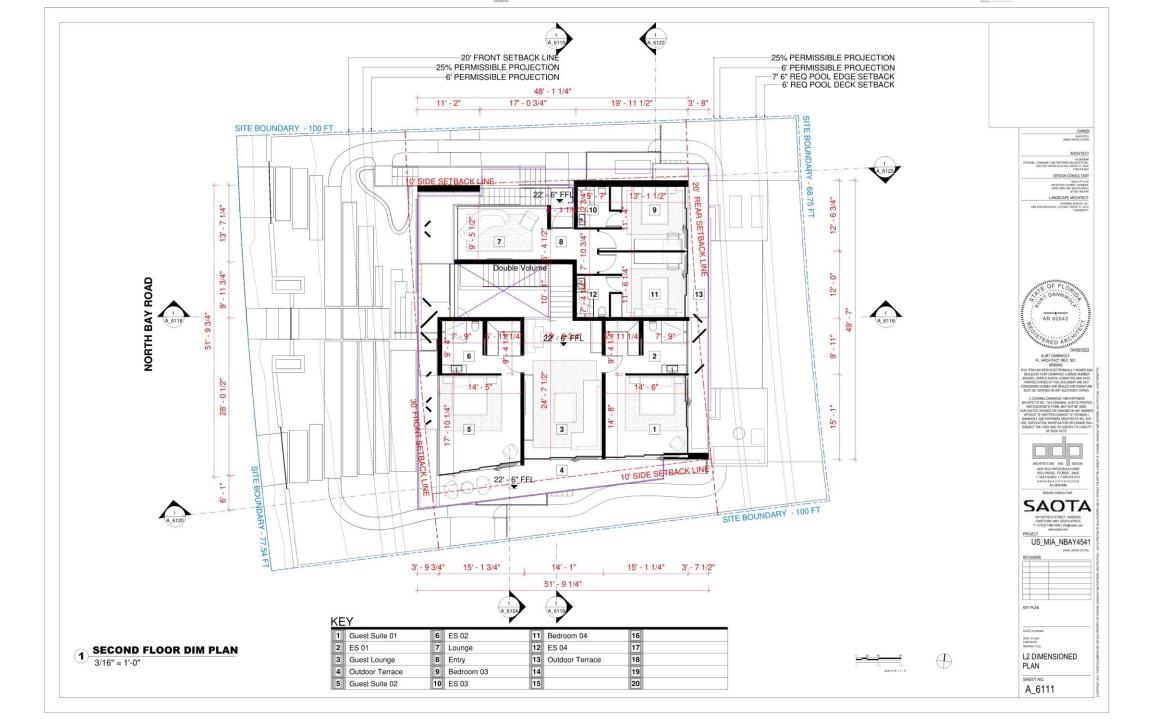

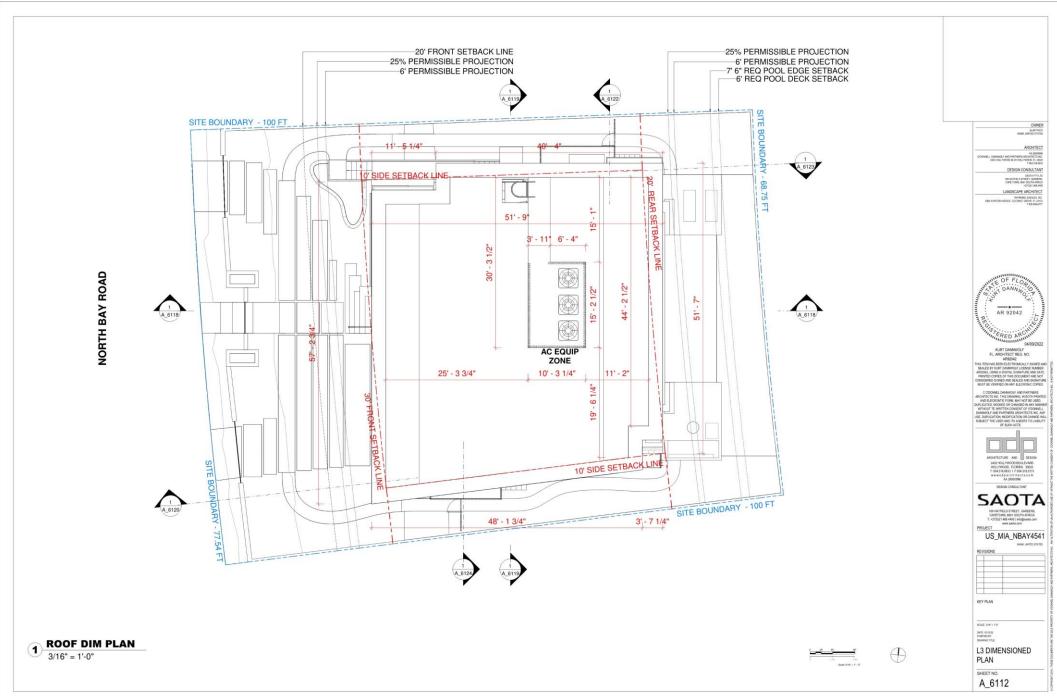





FRONT VIEW 01




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FRONT VIEW 01 - No boundary wall for visual reference only

SAOTA

100 HATFIELD STREET, GARDENS,
CAPETONS, BOTT SOUTH APRICA
1: 470 (2)21 466 4460) viring-axion com
www.sacta.com PROJECT
US_MIA_NBAY4541 FRONT VIEW 01 SHEET NO. A_6126



REAR VIEW

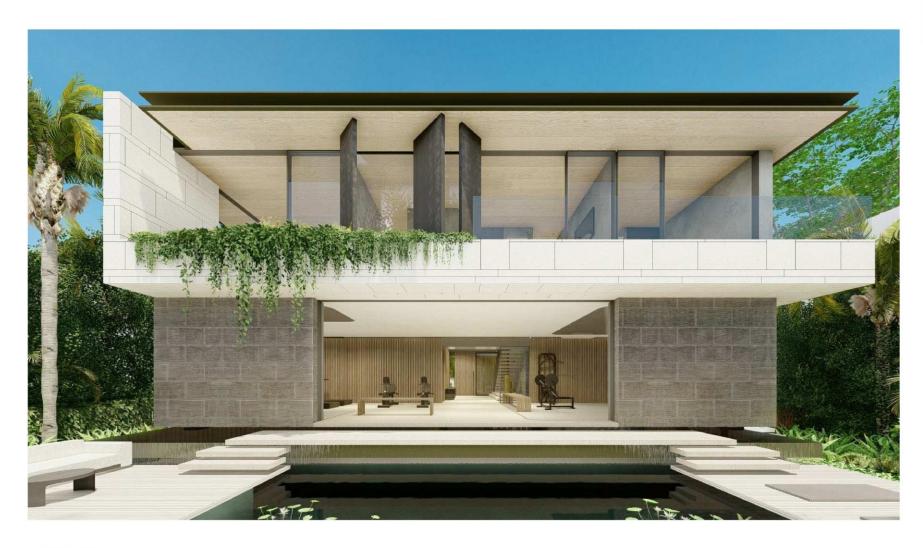

SAOTA

100 HATFIELD STREET, GARDENIS,
CAPETIONA, 8001 SOUTH A PRICA
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PROJECT

PROJECT US_MIA_NBAY4541

MIGILIANTED STATES

REAR VIEW

A_6130




PERSPECTIVE SECTION 01



PERSPECTIVE SECTION 01 SHEET NO. A_6131



PERSPECTIVE SECTION 02

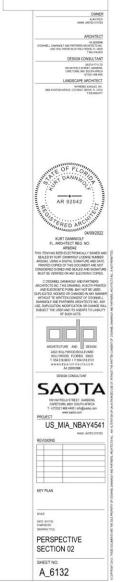

4541 NORTH BAY ROAD GARDEN 4541 North Bay Road, Miami Beach, FL 33140

FINAL SUBMITTAL 4/11/2022 DRB File. No. DRB22-0795

Prepared for:


4541 NBR LLC

655 MADISON AVE., 11TH FLOOR NEW YORK, NY 10065



2964 Aviation Ave. Coconut Grove, FL 33133 P: 305.858.6777 www.raymondjungles.com Florida License No. LC 000258

Sheet #	Drawing Index	DRB22-0795 FINAL SUBMITTAL (04-11-22)
L-000	COVER	•
L-100 L-101 L-102	TREE DISPOSITION PLAN TREE DISPOSITION SCHEDULE TREE DISPOSITION NOTES & DETAILS	
L-103	HARDSCAPE PLAN	
L-104 L-105 L-106 L-107 L-108 L-109	CANOPY PLANTING PLAN UNDERSTORY PLANTING PLAN - GROUND LEVEL UNDERSTORY PLANTING PLAN - SECOND LEVEL PLANT LIST & MITIGATION CHART LANDSCAPE LEGEND PLANTING DEFAILS	i
L-110	PLANTING NOTES & SPECIFICATIONS	•
L-111	LIGHTING SPECIFICATIONS	•

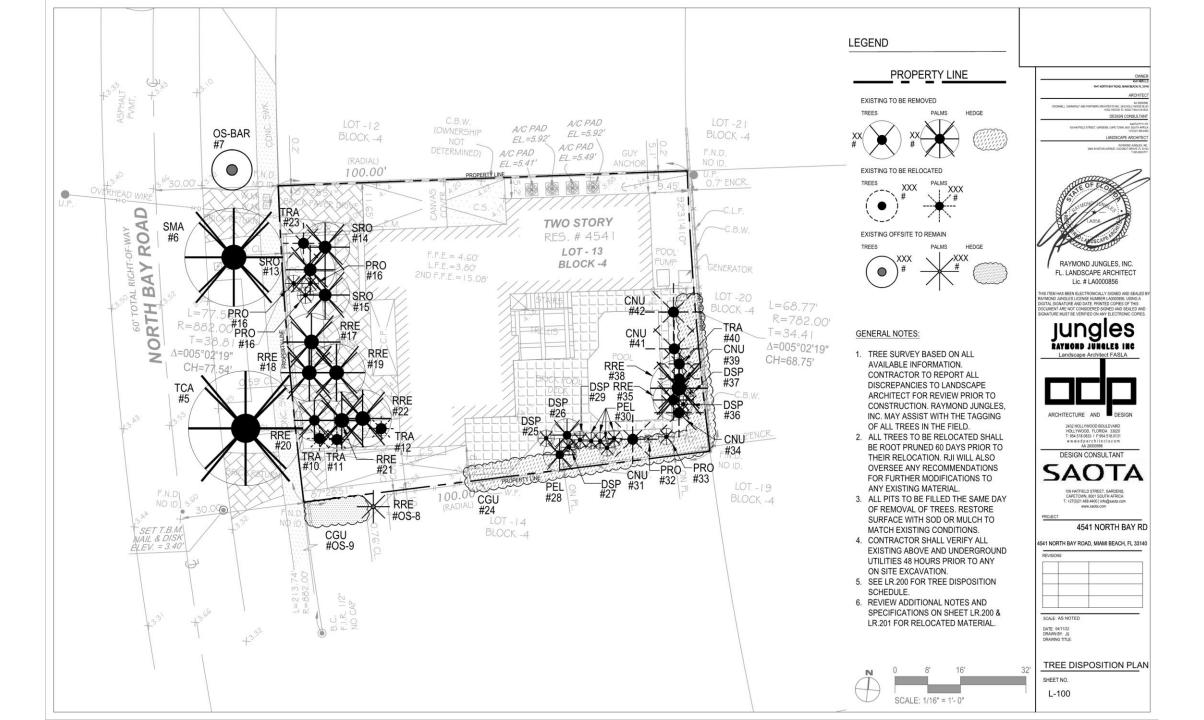

4541 North Bay Road Garden 4541 North Bay Road, Miami Beach, FL 33140

TREE DISPOSITION SCHEDULE

Per Survey Date 11/01/2021

	ees and Pain			D.B.H.	O.A. Height	Canopy Diameter			Mitigation
Iden.	Symbol	Scientific Name	Common Name	(inch)	(feet)	(feet)	Notes	Disposition	Required
#1	Tree does n								0
#2	Tree does n								0
#3	Tree does n	CONTROL OF THE PARTY OF THE PAR							0
#4	Tree does n	T	I						0
#5	TCA	Tabebuia caraiba	Yellow Trumpet Tree	18	25	30		Remove	18
#5	SMA	Swietenia mahagani	Mahogany Tree	18	35	25		Remove	18
#7	BAR	Bulnesia arborea	Verawood	4.8	20	10	Offsite	Remain	0
#8	RRE	Roystonea regia	Royal Palm	18	20	8	Offsite	Remain	0
#9	CGU	Clusia sp.	Small Leaf Clusia	hedge	10	5	Offsite	Remain	0
#10	TRA	Thrinax radiata	Green Thatch Palm	6	10	5		Relocate	0
#11	TRA	Thrinax radiata	Green Thatch Palm	- 6	10	5		Relocate	0
#12	TRA	Thrinax radiata	Green Thatch Palm	7.2	15	6		Relocate	0
#13	SRO	Syagrus romanzoffiana	Queen Palm	8.4	25	12		Remove	(1) Tree
#14	SRO	Syagrus romanzoffiana	Queen Palm	9.6	30	12		Remove	(1) Tree
#15	SRO	Syagrus romanzoffiana	Queen Palm	9.6	25	12		Remove	(1) Tree
#16	PRO	Phoenix roebelenii	Pygmy Date Palm	6 x (3)	12	10	Mitigation not required; Specs do not meet minimum requirements	Remove	0
#17	RRE	Roystonea regia	Royal Palm	20.4	45	15		Remove	(1) Tree
#18	RRE	Roystonea regia	Royal Palm	24	45	15		Remove	(1) Tree
#19	RRE	Roystonea regia	Royal Palm	19.2	45	15		Remove	(1) Tree
#20	RRE	Roystonea regia	Royal Palm	19.2	40	10		Remove	(1) Tree
#21	RRE	Roystonea regia	Royal Palm	24	45	15		Remove	(1) Tree
#22	RRE	Roystonea regia	Royal Palm	24	30	15		Remove	(1) Tree
#23	TRA	Thrinax radiata	Green Thatch Palm	19.2	15	10		Relocate	0
#24	CGU	Clusia sp.	Small Leaf Clusia	hedge	10	5	Mitigation not required; Hedge	Remove	0
#25	DSP	Dracaena sp.	Same	7.2	20	3	Mitigation not required; Shrub	Remove	0
#26	DSP	Dracaena sp.	Same	7.2	20	8	Mitigation not required; Shrub	Remove	0
#27	DSP	Dracaena sp.	5ame	8.4	25	3	Mitigation not required; Shrub	Remove	0
#28	PEL	Ptychosperma elegans	Solitaire Palm	3.6	30	8	Mitigation not required; Specs do not meet minimum requirements	Remove	0
#29	DSP	Dracaena sp.	Same	4.8	12	3	Mitigation not required; Shrub	Remove	0
#30	PEL	Ptychosperma elegans	Solitaire Palm	2.5	40	20	Mitigation not required; Specs do not meet minimum requirements	Remove	0
#30	PEL	Ptychosperma elegans	Solitaire Palm	2.5	40	20	Mitigation not required; Specs do not meet minimum requirements	Remove	0
#30	PEL	Ptychosperma elegans	Solitaire Palm	2.5	40	20	Mitigation not required; Specs do not meet minimum requirements	Remove	0
#30	PEL	Ptychosperma elegans	Solitaire Palm	2.5	40	20	Mitigation not required; Specs do not meet minimum requirements	Remove	0
#31	CNU	Cocos nucifera	Coconut Palm	7.4	45	13		Relocate	0
#32	PRO	Phoenix roebelenii	Pygmy Date Palm	2.4	5	2	Mitigation not required; Specs do not meet minimum requirements	Remove	0
#33	PRO	Phoenix roebelenii	Pygmy Date Palm	2.4	7	3	Mitigation not required; Specs do not meet minimum requirements	Remove	0
#34	CNU	Cocos nucifera	Coconut Palm	8.4	35	13		Relocate	0
#35	RRE	Roystonea regia	Royal Palm	12	20	10		Remove	(1) Tree
#36	DSP	Dracaena sp.	Same	3.6	8	5	Mitigation not required; Shrub	Remove	0
#37	DSP	Dracaena sp.	Same	3.6	15	2	Mitigation not required; Shrub	Remove	0
#38	RRE	Roystonea regia	Royal Palm	12	20	15		Remove	(1) Tree
#39	CNU	Cocos nucifera	Coconut Palm	7.2	30	10		Relocate	0
#40	TRA	Thrinax radiata	Green Thatch Palm	7.2	13	10		Relocate	0
#41	CNU	Cocos nucifera	Coconut Palm	8.4	40	15		Relocate	0
#42	CNU	Cocos nucifera	Coconut Palm	8.4	38	15		Relocate	0
/	3,10		100000000000000000000000000000000000000		1				
	1				-	-	Total Tree D.B.H. Removed Re	guiring Mitigation (inch	es) 36
								emoved Requiring Mitigati	

4541 North Bay Roa 4541 North Bay Roa			L 331 4	0		
EXISTING TREES						
Total # of Existing Trees:	2	To remain:	0	To be reloaced:	0 To be removed:	2
EXISTING PALMS						
Total # of Existing Palms:	21	To remain:	0	To be reloaced:	10 To be removed:	11

OWNER
4541 NORTH BAY ROAD, MARK BEACH, IT, 35140 ARCHITECT
ODCHMELL DANNINGEF AND PARTMERS ARCHITECTS INC. (ALSI HOLLY MODE) HOLLY WIDGE R. 38502 Y 5964 349 383 DESIGN CONSULTANT
DESIGN CONSULTANT SAOTA PYLTD 109 HATRILD STREET, GARDINIS, CAPE TOWN, SIGN SOUTH ARRICA 477(07) 488 400.
LANDSCAPE ARCHITECT BANKING JANKES, INC. 284 AVAITOR AVERAGE COCONUT GROVE PL 31333 334 AVAITOR AVERAGE COCONUT GROVE PL 31333 344 AVAITOR AVERAGE COCONUT GROVE PL 31333
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Lic. # LA0000856
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Landscape Architect FASLA
ARCHITECTURE AND DESIGN
2432 HOLLYWOOD BOULEVARD HOLLYWOOD, FLORIDA 33020 T: 954.518.0833 F:954.518.0131
www.adparchitects.com AA 26000996 DESIGN CONSULTANT
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SAUTA
109 HATFIELD STREET, GARDENS, CAPETOWN, 8001 SOUTH AFRICA T: +27(0)21 488 4400 info@saota.com www.saota.com
PROJECT 4541 NORTH BAY DO
4541 NORTH BAY RD 41 NORTH BAY ROAD, MIAMI BEACH, FL 33140
REVISIONS

SCALE: AS NOTED

DATE: 04/11/22
DRAMA DV. 10

DRAWN BY: JI DRAWNG TITL

TREE DISPOSITION SCHEDULE

SHEET NO

TREE / PALM PROTECTION NOTES

- CONTRACTOR MUST BE A LICENSED LANDSCAPE CONTRACTOR.
- CONTRACTOR MUST HAVE A MINIMUM OF 10 YEARS OF PROVEN EXPERIENCE RELOCATING LARGE
- SPECIMENT TREES AND PALMS IN SOUTH FLORIDA.

 1.3. CONTRACTOR MUST HAVE PROVEN EXPERIENCE RELOCATING TREES AND PALMS OF THE SAME SPECIES AND SIZE AS THOSE TO BE RELOCATED FOR THE CURRENT PROJECT.
- 1.4. CONTRACTOR MUST HAVE A CERTIFIED ARBORIST ON STAFF.

- CONTRACTOR MUST VISIT THE JOBSITE AND INSPECT ALL TREES AND PALMS TO BE RELOCATED AS WELL AS EXISTING SITE CONDITIONS AND RESTRICTIONS PRIOR TO PREPARING BID. 2.2. CONTRACTOR MUST VERIFY AND RESURE THAT ALL TREES AND PALMS IDENTIFIED ON THE PLANS AND
- TUDGE TAGGED ON THE IDEGITE CORRESPOND AS TO MINNER AND DESCRIPTION AN ISCREPANCIES MUST BE BROUGHT TO THE ATTENTION OF THE LANDSCAPE ARCHITECT
- 2.3. CONTRACTOR MUST CONDUCT ALL WORK ASSOCIATED WITH RELOCATION AND MAINTENANCE OF TREES AND PALMS TO BE RELOCATED. NO WORK IS TO BE SUBCONTRACTED WITHOUT PRIOR WAITTEN CONSENT OF THE OWNER ANDIOR LANDSCAPE ARCHITECT.

 2.4. CONTRACTOR MUST DESIGNATE A COMPETENT, ENGLISH-SPEAKING SUPERVISOR OR FOREMAN TO OVERSEE AND DIRECT ALL RELOCATION AND MAINTENANCE ACTIVITIES AS OUTLINED IN THESE
- **SPECIFICATIONS** 2.5. CONTRACTOR MUST SCHEDULE ROOT PRUNING TO PROVIDE THE MAXIMUM POSSIBLE TIME FOR NEW
- ROOT GROWTH. EVEN TREES AND PALMS THAT TYPICALLY DO NOT REQUIRE LONG (OR ANY) ROOT THAT THE PROMINENT FROM MORE ROOT PRUNNING TIME. THEREPORE, ALL TREES AND PALMS TO BE RELOCATED MUST BE ROOT PRUNED. CONTRACTOR MUST PROVIDE A ROOT PRUNE SCHEDULE FOR EACH TREE OR PALM TO BE RELOCATED AS AN ATTACHMENT TO THE BID. CONTRACTOR MUST CALL SUNSHINE 811 TO HAVE ALL UNDERGROUND UTILITIES LOCATED UNDER OR
- IN THE VICINITY OF THE CURRENT OR FUTURE LOCATIONS OF ALL TREES AND PALMS TO BE RELOCATED PRIOR TO WORK COMMENCING.
 2.7. CONTRACTOR NUST VERIFY WITH THE GENERAL CONTRACTOR THE ABSENCE OF ANY UNDERGROUND CONSTRUCTION OR OBSTRUCTIONS (£.G. BULNHEADS, SEPTIC SYSTEMS, ETC.) IN THE CURRENT AND
- FUTURE LOCATIONS OF ALL TREES AND PALMS TO BE RELOCATED. CONTRACTOR MUST ALERT THE LANDSCAPE ARCHITECT OF ANY TREES OR PALMS THAT WILL NOT
- 2.8. CONTINUO DI MINISTI ALERT I DANISSIONE RICCHIELT DI MATTRESS OFFILIAIS THAT W SUCCESSIVILLY RELOCATE DUE TO POOR HEALTH PRIOR TO BEGINNING ROOT PRUNNOS. 2.9. CONTRACTOR MUST FLAG ALL PROPOSED TRANSPLANT LOCATIONS FOR THE LANDSCAPE ARCHITECTS APPROVAL A MINISMOM OF 15 DAYS PRIOR TO RELOCATION.
- 2.10. CONTRACTOR MUST ENSURE THAT ALL TREES AND PALMS TO BE RELOCATED ARE INSTALLED AT THE
- CORRECT GRADE OR ELEVATION, ACCORDING TO THE GRADING PLAN.
 211. CONTRACTOR MUST ENSURE THAT ALL ROOT FLARES ARE EXPOSED AFTER RELOCATION.
 212. CONTRACTOR MUST REMOVE ALL RESIDUAL ROOTS, STUMPS, AND PORTIONS THEREOF AND BACKFILL. PITS FROM WHICH RELOCATED TREES AND PALMS WERE REMOVED WITH CLEAN FILL FLUSH WITH THE
- 2.13 CONTRACTOR MUST REPAIR ANY DAMAGE TO OTHER PLANTS LAWN, HARDSCAPES, OR NEW CONSTRUCTION WITHIN THE RELOCATION AREA AT CONTRACTOR'S EXPENSE. HARDSCAPES INCLUDE BUT ARE NOT LIMITED TO CURBS, WALKS, ROADS, PENCES, SITE FURNISHINGS, ETC. 2.14. CONTRACTOR MUST PHOTOGRAPHICALTY DOCUMENT NEW ROOT GROWTH FOLLOWING EACH ROOT
- PRUNE AND SUBMIT THIS DOCUMENTATION TO THE LANDSCAPE ARCHITECT. THE PURPOSE OF THIS REQUIREMENT IS TO ENSURE THAT SUFFICIENT POOT GROWTH HAS OCCURRED PRIOR TO THE SECOND AND SUBSEQUENT ROOT PRUNES AND FOLLOWING THE FINAL ROOT PRUNE PRIOR TO 2.15. CONTRACTOR MUST INSTALL AND MAINTAIN PROTECTION FENCING AROUND EACH TREE AND PALM TO
- BE RELOCATED BOTH DURING ROOT PRUNING AND AFTER RELOCATION, PROTECTION FENCING MUST CONSIST OF GALVANIZED WELDED WIRE FABRIC OR PLASTIC MESH ATTACHED TO 4" X.4" POSTS INSERTED AROUND THE PERMIETER OF THE DIRPLINE OF THE TREE OF RALM PROTECTION FEMIONS MUST BE PLUMB, TAUT, AND STURDY AT ALL TIMES AND MUST REMAIN IN PLACE THROUGHOUT THE ROOT PRUNING AND WARRANTY PERIODS, OR AS DIRECTED BY THE LANDSCAPE ARCHITEC 2.16 CONTRACTOR MUST ORTAIN ALL NECESSARY OR REQUIRED PERMITS FOR THE RELOCATION AND TRANSPORTATION OF THE TREES AND PALMS TO BE RELOCATED.
- TRANSPORTINION THE INTERS AND PAGINST OF BREADCASTED.

 2.17. CONTRACTOR MUST REPLACE ANY TREES OR PALMS SCARRED OR DAMAGED DURING RELOCATION.

 AT THE CONTRACTOR'S EXPENSE, WITH THE SAME OR SIMILAR SPECIES, SIZE, AND QUALITY.

 REPLACEMENT TREES OR PAUMS MUST BE APPROVED BY THE LAMBSCAPE ARCHITECT PRIOR TO PROCUREMENT, PREPARATION, AND/OR INSTALLATION, REPLACEMENT TREES AND PALMS MUST BE
- 2.18. CONTRACTOR BUST GUARANTEE ALL RELOCATED TREES AND PALMS FOR ONE YEAR FROM THE DATE OF RELOCATION TO THE FINAL LOCATION, GUARANTEE MUST INCLUDE TREE HEALTH AND SETTLING. 2.19. CONTRACTOR MUST PROVIDE ALL MATERIAL NECESSARY TO PERFORM THE WORK COVERED HEREIN, INCLUDING BUT NOT LIMITED TO BACKFILL MATERIAL PROTECTION FENCING FLAGGING ADDITIVES AND SUPPLEMENTS, TEMPORARY IRRIGATION, BURLAP, WIRE, SHRINK WRAP, AND ALL NECESSARY

ROOT PRUNING SPECIFICATIONS

INSTALLED WITHIN SO DAYS OF NOTICE

- 3.1.1. ALL TREES AND PALMS TO BE RELOCATED MUST BE WATERED DAILY FOR AT LEAST 2-3 DAYS PRIOR TO MAY ROOTS BEING OUT TO ENSURE THAT THEY ARE FULLY HYDRATED. EACH WATERING MUST THOROUGHLY SATURATE THE ROOTBALL TO ITS FULL DEPTH.
- 3.1.2. EACH TREE AND PALM MUST THEN BE WATERED EVERY OTHER DAY, NOT RELYING ON RAIN, DURING THE ENTIRE ROOT PRUNING PROCESS ETHER BY A TEMPORARY IRRIGATION SYSTEM OR BY HAND. EACH WATERING MUST THOROUGHLY SATURATE THE ROOTBALL TO ITS PULL DEPTH. 3.1.3. TREE AND PAUM RELOCATION ACTIVITIES MUST BE SCHEDULED SO THAT REMOVAL AND REPLANTING TAKE PLACE IN THE SAME 24-HOUR PERIOD. NO TREES OR PALMS MAY BE "STOCKPILED" ONSITE OR DESSITE FOR ANY PERIOD OF TIME WITHOUT PRIOR WRITTEN APPROVAL OF THE LANDSCAPE
- OPPOSITE FOR MY PERIOD OF THE WITHOUT PRIOR WITH THE REPPOSIT OF THE METHOD OF THE MET MACHINERY WILL BE ALLOWED. PRUNING OF ROOTS MUST BE DONE BY HAND WITH CLEAN, SHARI TOOLS, DO NOT PAINT OUT ROOTS WITH TREE PAINT OR ANY KIND OF SEALANT.
- 3.1.5. MYCORRHIZA (ROOTS® TRANSPLANT OR EQUIVALENT) MUST BE INCORPORATED INTO THE BACKFILL SOIL PRIOR TO BACKFILLIANG AS PER MAJURFACTURER'S RECOMMENDATIONS.
 3.1.6. AFTER EACH ROOT PRUNE, EACH SECTION OF ROOTBALL THAT IS PRUNED MUST BE WRAPPED WITH
- BLACK PLASTIC AND THE TRENCH BACKFILLED WITH ORIGINAL EXCAVATED SOIL. A TREE RING WITH A MINIMUM HEIGHT OF 6" MUST BE CONSTRUCTED 6-12" OUTSIDE THE OUTERMOST EDGE OF THE "ROOTBALL AND AROUND THE REPREMETER OF THE ROOTBALL TO RIFECT RERIGATION WATER AND ANY ADDED SUPPLEMENTS DOWN INTO THE ROOTBALL DURING ROOT REGENERATION.
- 3.1.7. ONCE THE TREE RING IS CONSTRUCTED AFTER EACH ROOT PRUNE, A HIGH-PHOSPHORUS ROO STIMULANT MUST BE LIBERALLY APPLIED TO THE SURFACE OF THE ROOTBALL AND THOROUGHLY WATERED IN TO ENCOURAGE NEW ROOT GROWTH

- 3.2.1. PRIOR TO ANY ROOTS BEING CUT, ALL MAJOR ROOTS MUST BE IDENTIFIED TO DETERMINE THE ROOTBALL DIAMETER BASED ON THE RELATIVE LOCATION AND SIZE OF THE ROOTS.
- 3.2.2. MANY TREE RELOCATION SPECIFICATIONS USE "GENERAL RULES" TO CALCULATE MINIMUM ROOTBALL DIAMETER, SUCH AS MULTIPLYING THE DIAMETER AT BREAST HEIGHT (DBH) OF THE TREE BY A FACTOR OF 10 OR ALLOWING A MINIMUM OF 9"-12" OF ROOTBALL FOR EVERY 1" OF TREE CALIFER OTHERS LIST UNREALISTIC MINIMUM SIZES FOR THE ROOTBALLS OF VARIOUS TREE CALIFERS OR HEIGHTS. IN MANY CASES, SUCH APPROACHES RESULT IN ROOTBALLS THAT ARE EITHER TOO LARGE OR TOO SMALL FOR A GIVEN TREE. THE FOLLOWING TABLE LISTS MINIMUM ROOTBALL DIAMETERS BASED ON REAL-WORLD EXPERIENCE OF TREE RELOCATION SPECIALISTS IN SOUTH FLORIDA

CALIPER (inches)	MIN. ROOTBALL DIA. (feet)	CALIPER (inches)	MIN. ROOTBALL DIA. (feet)
1-4	3	12 - 14	8
4-5	4	15 - 17	10
6-7	5	18 - 24	12 - 15
8-9	6	25 - 30	15 - 25

- 3.2.3. WHENEVER POSSIBLE, ROOTBALLS MUST BE CIRCULAR IN SHAPE WITH AN EQUAL DISTANCE FROM THE TRUNK TO THE EDGE OF THE POOTBALL ALL APOLINO
- 3.2.4. MINIMUM ROOTBALL DEPTH MUST BE 24"-38" FOR ALL TREES TO BE RELOCATED, WITH THE ACTUAL DEPTH TO BE OFFERMINED ONLY AFTER A THOROUGH EXAMINATION OF ALL ROOTS DURING THE INITIAL ROOT INSPECTION AND BASED ON THE ABSENCE OF MAJOR ROOTS AT THE BOTTOM OF THE ROOTBALL, ROOTBALLS DEEPER THAN 36" MAY BE REQUIRED FOR LARGE SPECIMEN TREES. EPENDING ON THE RELATIVE LOCATIONS AND DEPTHS OF THE MAJOR ROOTS AS OBSERVED DURING

- 3.2.5. AS A GENERAL RULE, MINIMUM ROOT PRUNE TIME FOR TREES WITH A DBH OF LESS THAN 10" IS 12 WEEKS, THE FIRST ROOT PRUNE MUST BE ON TWO OPPOSING SIDES OF THE ROOTBALL. WITH THI SECOND ROOT PRUNE ON ONE OF THE OTHER TWO SIDES DONE A MINIMUM OF 6 WEEKS LATER, AND A THIRD ROOT PRUNE ON THE LAST SIDE DONE A MINIMUM OF 3 WEEKS AFTER THAT. THE SECOND AND THIRD ROOT PRUNES MAY ONLY BE DONE WHEN HEALTHY NEW ROOT GROWTH FROM BEARLER. ROOT PRUNES IS EVIDENT (SEE SECTION 2.14 ABOVE FOR SPECIFICATIONS ON PHOTOGRAPHICALLY DOCUMENTING NEW ROOT GROWTH DURING THE ROOT PRUNE PROCESS), MORE TIME MAY BE
- DOCUMENTING NEW ROOT GROWTH DURING THE ROOT PROME PROCESS), MORE TIME MAY BE NEEDED DURING THE COOLER MONTHS OF THE YEAR.

 3.26. AS A GENERAL RULE, MINIMUM ROOT PRUNE TIME FOR TREES WITH A DBH OF 10' OR GREATER IS 24 WEEKS. THE FIRST ROOT PRUNE MUST BE ON TWO OPPOSING SIDES OF THE ROOTBALL, WITH THE SECOND ROOT PRUNE ON ONE OF THE OTHER TWO SIDES DONE A MINIMUM OF 12 WEEKS LATER, AND A THIRD ROOT PRUNE ON THE LAST SIDE DONE A MINIMUM OF 6 WEEKS AFTER THAT. THE SECOND AND THIRD ROOT PRUNES MAY ONLY BE DONE WHEN HEALTHY NEW ROOT GROWTH FROM EARLIER ROOT PRUNES IS EVENTY ISSESSED AT 14 ABOVE FOR SPECIFICATIONS ON PHOTOGRAPHICALLY DOCUMENTING NEW ROOT GROWTH DURING THE ROOT PRUNE PROCESS, MORE TIME MAY BE NEEDED DURING THE COOLER MONTHS OF THE YEAR.
- 3.2.7. CERTAIN HARDWOOD TREES AND GYMNOSPERMS REQUIRE LONGER ROOT PRUNING TIMES. THESE NCLUDE, BUT ARE NOT LIMITED TO, THE FOLLOWING:
 - AVOCADO (PERSEA AMERICANA) BLACK OLIVE (BUCIDA BUCERAS)
 - BRIDALVEIL (CAESALPINIA GRANADILLO)
 - CASSIAS (ALL SPECIES OF CASSIA) LIGNUM VITAE (GUAIACUM SANCTUM & G. OFFICINALE)
- LIVE OAK (QUERCUS VIRGINIANA MAHOGANY (SWIETENIA MAHAGONI
- MANGO (MANGIFERA INDICA)
- PIGEON PLUM (COCCOLOBA DIVERSIFOLIA) SWEET ACACIA (ACACIA FARNESIANA) /ERAWOOD (BULNESIA ARBOREA)
- WILD TAMARIND (LYSILOMA LATISILIQUUM & L. SABICU)

FOR THESE TREES. THE MINIMUM ROOT PRUINE TIMES DISCUSSED IN SECTIONS 3.2.5 AND 3.2.6 AROVE FOR THESE IREES, THE MINIMUM ROUT PROME TIMES DISCUSSED ITS SECTIONS 2.22 AND 3.2.2 AND 4.2.2 AN RELOCATED (SEE SECTION 2.14 ABOVE FOR SPECIFICATIONS ON PHOTOGRAPHICALLY DOCUMENTING NEW ROOT GROWTH DURING THE ROOT PRUNE PROCESS).

3.3. PALMS
3.3.1. THE FOLLOWING TABLE LISTS MINIMUM ROOTBALL DIAMETERS FOR VARIOUS SPECIES OF PALMS BASED ON REAL-WORLD EXPERIENCE OF RELOCATION SPECIALISTS IN SOUTH FLORIDA

ROOTBALL SPECIFICATIONS PALM SPECIES 12" from trunk in all directions 18 - 24" from trunk in all directions 24" from trunk in all directions QUEEN & FOXTAIL PALMS ROYAL & COCONUT PALMS CANARY DATE PALM SLOW-GROWING PALMS 24* from trunk in all direction

- 3.3.2. PALM ROOTBALLS MUST BE A MINIMUM OF 24" DEEP. WHENEVER POSSIBLE, ROOTBALLS MUST BE CIRCULAR IN SHAPE WITH AN EQUAL DISTANCE FROM THE TRUNK TO THE EDGE OF THE ROOTBAL ALL AROUND
- 3.3.3 AS A GENERAL RULE MINIMUM BOOT PRUNE TIME FOR PALMS IS 6-8 WEEKS. THE FIRST BOOT PRUNE MUST BE ON TWO OPPOSING SIDES OF THE ROOTBALL, WITH THE SECOND ROOT PRUNE ON ONE OF THE OTHER TWO SIDES DONE A MINIMUM OF 3-4 WEEKS LATER, AND A THIRD ROOT PRUNE ON THE LAST SIDE DONE A MINIMUM OF 4-5-9 WEEKS AFTER THAT. THE SECOND AND THIRD ROOT PRUNES MAY ONLY BE DONE WHEN HEALTHY NEW ROOT GROWTH FROM EARLIER ROOT PRUNES IS EVIDENT (SEE SECTION 2.14 ABOVE FOR SPECIFICATIONS ON PHOTOGRAPHICALLY DOCUMENTING NEW ROOT GREE SECTION. AT MEMORY FOR PECHINALITIONS ON PROTOCOMPHICALT DECOURSE IN INSIGHT WOULD GROWNH DURING THE ROOT PRUME PROCESS, MOIRE TIME MAY BE NEEDED DURING THE COOLER MONTHS OF THE YEAR.

 3.4.4. CERTAIN PAINS, IN PARTICULAR THOSE THAT ARE SLOW GROWING, REQUIRE LONGER ROOT PRUNING
- TIME. THESE INCLUDE, BUT ARE NOT LIMITED TO, THE FOLLOWING
 - ALL SPECIES OF ARCHONTOPHOENIX
- ALL SPECIES OF CORYPHA AMERICAN OIL PALMS (ALL SPECIES OF ATTALEA)
- BISMARCK PALM (BISMARCKIA NOBILIS)
- CUBAN & CARIBBEAN COPERNICIA CURAN RELLY PALM (GASTROCOCOS CRISPA
- GINGERBREADIDOUM PALMS (ALL SPECIES OF HYPHAENE) PALMYRA PALMS (ALL SPECIES OF BORASSUS)
- SAW PALMETTO (SERENOA REPENS
- BILVER PALM (COCCOTHRINAY ARGENTATA) ZOMBIE PALM (ZOMBIA ANTILLARUM)
- FOR THESE PALMS. THE MINIMUM ROOT PRUNING TIME IS 4-6 MONTHS OR GREATER. ONLY WHEN SUFFICIENT NEW ROOT GROWTH HAS TAKEN PLACE FOLLOWING AN EARLIER ROOT PRUNE CAN THE NEXT ROOT PRUME BE DONE, AND ONLY WHEN SUFFICIENT NEW ROOT GROWTH HAS TAKEN PLACE FOLLOWING THE FINAL ROOT PRUME MAY THE TIES BE RELOCATED (SEE SECTION 2.14 ABOVE FOR SPECIFICATIONS ON PHOTOGRAPHICALLY DOCUMENTING NEW ROOT GROWTH DURING THE ROOT TO SECTION OF THE PROPERTY OF THE PRO PRUNE PROCESS)

CANOPY PRUNING SPECIFICATIONS

4.1. TREES

- 4.1.1 PRIOR TO RELOCATION THE CANOPY OF EACH TREE TO BE RELOCATED MIST BE SELECTIVELY PRIVATE TO REBOVE CROSSING, DEAD, DISEASED, BROKEN, AND LOW-HANGING BRANCHES THAT MAY INTERFERE WITH CONSTRUCTION ACTIVITIES, OR THAT MAY INTERFERE OR RESTRICT STRAPPING OR LIFTING THE TREE DURING RELOCATION.
- 4.12. FOR TREES BEING RELOCATED ONSITE, THE CANOPY MAY BE SELECTIVELY THINNED AND REDUCED BY NO MORE THAN 1/3 OF THE OVERALL CANOPY MASS, AT THE DIRECTION OF THE LANDSCAPE ARCHITECT: HOWEVER, THE BASIC SHAPE, FORM, AND CHARACTER OF THE TREE MUST BE
- 4.1.3. FOR TREES BEING RELOCATED OFFSITE. THE CANOPY MUST BE PRUNED. AT THE DIRECTION OF THE LANDSCAPE ARCHITECT, TO FIT ON THE TRAILER FOR TRANSPORT, EVERY EFFORT MUST BE MADE TO RETAIN AS MANY LANGE BRANCHES AS POSSIBLE AND TO PRESENVE AS MUCH OF THE SHAPE, FORM, AND CHARACTER OF THE TREE AS POSSIBLE TO THE WIDEST LOAD WIDTH ALLOWABLE BY THE AND CHARACTER OF THE TREE AS FLORIDA DEPARTMENT OF TRANSPORTATION, CONTRACTOR MUST OBTAIN ALL NECESSARY PERMITS AND ESCORTS TO TRANSPORT WIDE LOADS, PER FLORIDA LAW.
- 4.1.4. ALL CANOPY PRUNING MUST BE CONDUCTED FOLLOWING ANSI A-300 TREE PRUNING STANDARDS AND BEST MANAGEMENT PRACTICES.
- 4.1.5 ALL DEBRIS GENERATED DURING CANOPY PRUNING MUST BE REMOVED OFFSITE AND DISPOSED

- 4.2.1. IT IS WELL KNOWN THAT SOME PALMS SURVIVE RELOCATION BETTER WHEN ALL OF THE LEAVES ARE REMOVED (F.G. CARRAGE PALM SARAL PALMETTO), AND THAT OTHER PALMS RENEFIT FROM HAVING NEMOVED I.E.S., CABBAGE FAM. SABAL PALMETTOI, AND THAT OTHER MAJUS BENEFIT FROM HIVING THERE REAVES OUT IN HALF DURING RELOCATION (E.G., COOOMUT PAUM, COCOS MUCIFERA), BOTH OF THESE HORTICULTURAL PRACTICES, WHILE TRUE ARE ONLY APPLICABLE WHEN PALMS ARE NOT ROOT PRINED. LEAVES DO NOT NEED TO BE CUT IN HALF OR REMOVED FROM PALMS THAT ARE ADEQUATELY ROOT PRINED. ON OCCASION WHEN SUFFICIENT ROOT PRUNING TIME IS NOT AVAILABLE, PALMS TO BE RELOCATED MAY HAVE THEIR LEAVES CUT IN HALF OR REMOVED ENTIRELY AT THE DIRECTION OF THE LANDSCAPE ARCHITECT.
- 4.2.2. PALM LEAVES MUST BE TIED UP WITH 2-PLY BIODEGRADABLE TWINE PRIOR TO RELOCATION TO PREVENT MECHANICAL DAMAGE DURING THE RELOCATION PROCESS
- 4.2.3 PALM TRUNKS SHALL ONLY BE 'CLEANED UP' ACCORDING TO THE LANDSCAPE ARCHITECT'S SPECIFICATIONS SPECIFIC TO EACH PALM

RELOCATION SPECIFICATIONS

5.1. GENERAL

- 5.1.1. LANDSCAPE CONTRACTOR TO FLAG ALL PROPOSED PLANT LOCATIONS FOR LANDSCAPE ARCHITECTS PPROVAL PRIOR TO INSTALLATION. NOTIFY LANDSCAPE ARCHITECT A MINIMUM OF 15 DAYS PRIOR
- 5.1.2. ALL TREES AND PALMS TO BE RELOCATED MUST BE WATERED DAILY FOR AT LEAST 5 DAYS PRIOR TO ANY RELOCATION TO ENSURE THAT THEY ARE FULLY HYDRATED. EACH WATERING MUST. THOROUGHLY SATURATE THE ROOTBALL TO ITS FULL DEPTH
- SALIGNARY LARGO TRALLED THE WIGAPPED IN BURLAP AND THEN TIGHTLY WIRE-WRAPPED (USING REDLINE HORSE WIRE OR EQUIVALENT) TO KEEP THE ENTIRE OR TO THAN THAT TO DURING RELOCATION. TREES AND PAILMS GROWING BY LIMESTONE MUST BE DUIG AND ELOCATED WITH THE ROTOST ATTACHED TO A SECTION. OF ROCK AS PART OF THE ROOTBALL, SUCH THAT THE ROOTS REMAIN INTACT, ROOTBALLS COMING FROM SAND OR SANDY SOIL MAY ALSO NEED TO BE BOXED PRIOR TO RELOCATION. AT THE DISCRETION OF THE
- TREES AND PALMS BEING RELOCATED OFFSITE MUST HAVE THEIR ENTIRE ROOTBALLS THOROUGHLY AND TIGHTLY WRAPPED WITH PLASTIC SHRINK WRAP ON THE OUTSIDE OF THE WIRE WRAP, AND THE ENTIRE TREE OR PALM (INCLUDING CANOPY, TRUNK, AND ROOTBALL) MUST BE COVERED WITH A BREATHABLE TARK IF G. SHADE CLOTH) DURING TRANSPORT
- (E.G.) SPROUCCOUNTER OF THE PROPERTY OF THE STAND PALMS MUST BE PREPARED PRIOR TO LIFTING THE ST. 15. NEW PRANTING PITS FOR ELECTATED TREES AND PALMS MUST BE PREPARED PRIOR TO LIFTING THE PALM OR TREE FROM ITS CURRENT LOCATION AND MUST BE AT LEAST SET FEET WIDER THAN THE ROOTBALL AND THE SAME DEPTH AS THE ROOTBALL SUCH THAT THE FINAL ELECTATION OF THE TOP OF THE ROOTBALL IS AT OR SLIGHTLY ABOVE (NO MORE THAN 2" HIGHER) FINAL GRADE 5.1.6. TREES AND PALMS TO BE RELOCATED MUST BE LIFTED BY THE ROOTBALL ONLY, USING
- 5.16. TREES AND PAULOT DE RELOCATED MUST BE LIFTED BY THE ROOTBALL ONLY, USING APPROPRIATE YSLED TO BE RELOCATED MUST BE BUT AND THE TREE OR PAUL MUST BE BUL ANCED IN A MORE-OR-LESS UPRIGHT POSITION, WITH THE STRAP ON THE TRUMK USED ONLY FOR BULLANDIA AND MANEUVERING THE TREE OR PAUL MINTO POSITION NO CHAINS MAY BE USED AROUND OR AGAINST THE TRUMK AT ANY TIME. AT NO TIME SHALL 100% OF THE WEIGHT OF THE TREE OR AROUND ON BOARDS THE TROUGH AT ART TIME. AT NOT TIME. STACE LOVE OF THE WEBSTLOF THE RECE OR PAUME ON THE STAPP ATTACHED FOT THE TRUME. TRUKES MUST BE HEAVILY PADDED WITH 36-60 LAYERS (DEPENDING ON SIZE AND WEIGHT) OF BURLAY BENEATH THE BALANCING STRAP. 5.17. TREES AND PAUMS MUST BE UTED WITH A CASHOC OR BACKHOE PAPPORPRIATELY SIZED FOR THE SIZE AND WEIGHT OF THE TREE OR PALM AND LIFTED OR CARRIED DIRECTLY TO THE FINAL INSTALL LOCATION OR
- RANSPORT TRAILER 5.1.8 ONCE LIFTING REGINS, ANY LINCLIT ROOTS LINDER OR AROUND THE ROOTBALL THAT MAY YET REMAIN. 5.1.6. UNIVELED HIM SEGISTIS, ANY UNIVELED HOUSE SHORT CON ACCOUNT HE ROCI BALL THE HIM HAY LET PARAMENT. AND ROOT DAMAGE BURST BE IMMEDIATELY SEVERED WITH HAAD PROVING TOOLS TO MINIMIZE TEARING AND ROOT DAMAGE. 5.1.9. AGRIFORM PLANTING TABLETS, (OR APPROVED EQUIVALENT) MUST BE EVEN. TO STRIBUTED AROUND THE PERMETER OF THE PLANTING PLAT THE RATE OF 2 TABLETS PER 1. TRUNK CALIPER PRIOT DE THE PERMETER OF THE PLANTING PLAT THE RATE OF 2 TABLETS PER 1. TRUNK CALIPER PRIOT DE 1.1. THE PERMETER OF THE PLANTING PLAT THE RATE OF 2 TABLETS PER 1. TRUNK CALIPER PRIOT DE 1.1. THE PERMETER OF THE PLANTING PLAT THE PRIOR THE
- 1.10. MYCORRHIZA (ROOTS® TRANSPLANT OR EQUIVALENT) MUST BE INCORPORATED INTO THE BACKFILL
- SOIL PRIOR TO BACKFILLING.

 5.01.1 PRIOR TO BACKFILLING.

 5.1.1.1 RELOCATED TREES AND PALMS MUST BE CENTERED IN THE PLANTING PIT, AND THE PIT BACKFILLED

 USING A 1: MAYURE OF EXISTING SOIL AND 80/20 (DOT SAND MUCK) SOIL MIX THOROUGHLY BLENDED TOGETHER, DO NOT USE MUDDY SOIL AS BACKFILL, ISEE 5.2.2 BELOW FOR SPECIAL CONDITIONS.
- REGARDING DATE PALM BACKFILL SPECIFICATIONS REGINATIONS DATE PAILS BECKELL STEEDIFICATIONS.)

 5.11.2 SIMLAL TREES AND PALIS MUST BE FIRMLY. SPRACED USING A MINIMUM OF FOUR 4" X 4" WOODEN
 BRACES ATTACHED TO 2" X 4" WOODEN BATTERS HELD IN PLACE WITH TWO STEEL BANDS. LARGER
 MAY REQUIRE 5" X" WOODEN POSTS OR EVEN TELEPHONE POLES TO PROVIDE SUFFICIENT
 BRACIN
 STRENGTH TO PREVENT TOPPLING QURING WIND EVENTS. A SUFFICIENT MUNIBER OF BATTENS MUS STREAM TO FREEWIN TO PHILAD CORRESS AND THE TRUNK SUCH THAT THE STEEL BANDS NEVER CONTACT THE TRUNK SUCH THAT THE STEEL BANDS NEVER CONTACT THE TRUNK ON DIRLAY IS TO REMAIN MOBER THE WOODEN BATTEMS ON TREES UNING BRACING, BUT SEVERAL LAYERS OF BURNES PHOLD BE LEFT UNDER THE WOODEN BATTEMS WHEN SHALL MINIMUM OF ONE YEAR.
- 1.13. A TREE RING WITH A MINIMUM HEIGHT OF 6" MUST BE CONSTRUCTED 6-12" OUTSIDE THE OUTERMOS EGGE OF THE ROOTBALL AND ARQUIND THE ENTIRE PERIMETER OF THE ROOTBALL TO DIRECT WATER AND ANY SUPPLEMENTS THAT ARE ADDED DOWN INTO THE ROOTBALL DURING ROOT REGENERATION.
- 1.14. ONCE THE TREE RING IS CONSTRUCTED. A HIGH-PHOSPHORUS ROOT STIMULANT MUST BE LIBERALLY IPPLIED TO THE SURFACE OF THE ROOTRALL AND THOROUGHLY WATERED IN AFFLEED TO THE SURFACE OF THE ROOLDHLY WATERED IN USING A MOSE AND A JOHNSON BAR INSERTED TO 5.1 15. ROOTSHEED AND THE ROOTSHLY MATERED IN USING A MOSE AND A JOHNSON BAR INSERTED TO THE VERY BOTTOM OF THE ROOTSHLL AND SWUNG BACK AND FORTH TO PREVENT FORMATION OF AIR POCKETS. THE JOHNSON BAR TECHNIQUE MUST BE REPEATED AT LEAST NOCE MORE WITHIN ONE WEEK.
- AFTER RELOCATION, AND AGAIN IF ANY SIGNS OF STRESS BECOME APPARENT APIEZN RECOGNICIA, KIND JOANNIE PART GIOSEN D'S PISSES SECUEI APPRICENT.

 5.1.16. DEGAINO RIULCH PIEZLEUCIA IS PREFERRED JIMIST BE APPLIED WITHIN 48 HOURS OF RELOCATION
 AT A DEPTH OF 3-7 OVER THE ENTIRE TOP OF THE ROOTBALL FROM THE TREE RING TO WITHIN 6' OF THE
 TRUME, MULCH MIST NOT BE APPLIED OR ALLOWED TO ACCUMULATE DEPICTLY AGAINST THE TRUME,
 5.1.17. PITS FROM WHICH THE RELOCATED TREES AND PALMS WERE REMOVED MUST BE CLEANED OF ALL RESIDUAL ROOTS, STUMPS, AND PORTIONS THEREOF AND BACKFILLED WITH CLEAN FILL FLUSH WITH THE SURROUNDING GRADE
- 5.1.18. RESTORET HE SURPACE WITH MATERIAL TO MATCH ADJACENT AREAS. MATERIAL TO BE APPROVED BY LANDSCAPE ARCHITECT. CONTRACTOR TO PROVIDE A INIMIMIA OF ONE YEAR WARRANTY ON SETTLING AND PLANT MATERIAL FROM TIME OF SUBSTANTIAL COMPLETION.
- 5.2. SPECIAL CONDITIONS
- 5.2.1. MULTI-TRUNK TREES AND PALMS MUST BE RELOCATED AS ONE UNIT WITH A SINGLE ROOTBALL.
 5.2.2. PLANTING PITS FOR EDIBLE DATE PALMS (PHOENIX DACTYLIFERA) MUST BE BACKFILLED WITH PURE

6. MAINTENANCE SPECIFICATIONS

6.1. GENERAL

- 6.1.1. ALL RELOCATED TREES AND PALMS MUST BE MAINTAINED FOR ONE YEAR FROM THE DATE OF RELOCATION TO THEIR FINAL LOCATIONS.
- 6.1.2. CONTRACTOR MUST MAINTAIN ALL RELOCATED TREES AND PALMS FOR ONE FULL YEAR FROM THE DATE OF RELOCATION TO THE FINAL LOCATION.
- 6.1.3. WHENEVER POSSIBLE, EACH TREE AND PALM MUST BE WATERED BY A PERMANENT AUTOMATIC IRRIGATION SYSTEM FOLLOWING RELOCATION, EACH WATERING MUST THOROUGHLY SATURATE THE ROOTBALLT OT IS FULL DEPTH; THIS WILL REQUIRE 25-50 GALLONS OF WATER FOR SMALL TREES AND PALMS, DEPENDING ON ROOTBALL SIZE, WHILE LARGE TREES WILL REQUIRE A MINIMUM OF 10 GALLONS PER FOOT OF ROOTBALL DIAMETER (IE. A TO DIAMETER ROOTBALL WILL REQUIRE A MINIMUM OF 100 GALLONS PER WATERING EVENT). WATERING PROUBLEY MUST BE EVERY DAY FOR THE FIRST TWO WEEKS, EVERY OTHER DAY FOR THE NEXT THREE WEEKS, AND EVERY THIRD DAY FOR THE NEXT 6-8 WEEKS.
- 6.1.4. WHEN AN AUTOMATIC IRRIGATION SYSTEM IS NOT POSSIBLE, CONTRACTOR IS RESPONSIBLE FOR HAND WATERING RELOCATED TREES AND PALMS THROUGHOUT THE MAINTENANCE PERIOD AND UNTIL FINAL ACCEPTANCE BY THE LANDSCAPE ARCHITECT AND/OR CLIENT. 6.1.5. IMMEDIATELY AFTER RELOCATION TO THE FINAL LOCATION A HIGH-PHOSPHORUS ROOT STIMULANT
- IMMEDIATELY APPEAR RECOGNISOR OF THE PROOF DATE OF THE RECOMMENDED LABEL RATE AND WATERED IN WITH A DREINCH CONSISTING OF A SYSTEMIC INSCRIDE AND A CONTACT ROOT ROT FUNGICIE. FOLLOWING LABEL INSTRUCTIONS, AS INITIAL PREVENTATIVE MAINTENANCE. 6.1.6. EVERY THREE MONTHS THEREAFTER, A HIGH-PHOSPHORUS ROOT STIMULANT MUST BE APPLIED TO THE SURFACE OF THE ROOTBALL AT THE RECOMMENDED LABEL RATE AND WATERED IN WITH A
- DRENCH CONSISTING OF A SYSTEMIC INSECTICIDE AND A BROAD-SPECTRUM SYSTEMIC FUNGICIDE FOLLOWING LABEL INSTRUCTIONS, AS CONTINUING PREVENTATIVE MAINTENANCE
- 6.1.7. IRRIGATION AND BRACING MUST BE CHECKED AND EACH TREE OR PALM THOROUGHLY INSPECTED FOR SIGNS OF STRESS, DISEASE, OR PEST PROBLEMS ON A MONTHLY BASIS.

6.2. SHADE TREES

- 6.2.1. IMMEDIATELY AFTER RELOCATION TO THE FINAL LOCATION AND EVERY THREE MONTHS THEREAFTER. A HIGH-QUALITY. SLOW-RELEASE 15-2-15 GRANULAR FERTILIZER MUST BE APPLIED. AT THE RECOMMENDED LABEL RATE, SPREAD EVENLY ACROSS THE SURFACE OF THE ROOTBALL
- 6.2.2 FOLIAR FEED FOLIR TIMES PER YEAR

6.3. FLOWERING TREES

- 6.3.1 IMMEDIATELY AFTER RELOCATION TO THE FINAL LOCATION AND EVERY THREE MONTHS THEREAFTER A HIGH-OLIALITY SLOW-RELEASE 5-10-15 GRANULAR FERTILIZER MUST BE APPLIED, AT THE RECOMMENDED LABEL RATE, SPREAD EVENLY ACROSS THE SURFACE OF THE ROOTBALL
- 6.3.2. FOLIAR FEED FOUR TIMES PER YEAR.


6.4. PALMS

- 6.4.1 STRING MUST BE REMOVED FROM THE TIED UP LEAVES IMMEDIATELY AFTER RELOCATION TO THE STRING MOST DE REMOVED FROM THE TIES OF LEAVES MINIMEDIATELY AFTER RELOCATION TO THE FINAL LOCATION IF THE PALM WAS ROOT PRUNED OR WITHIN 30-45 DAYS AFTER RELOCATION ON TO OCCASION THE LANDSCAPE ARCHITECT APPROVED RELOCATION WITHOUT ROOT PRUNING DUE TO TIME CONSTRAINTS
- 6.4.2. IMMEDIATELY AFTER RELOCATION TO THE FINAL LOCATION AND EVERY THREE MONTHS THEREAFTER A HIGH-QUALITY, SLOW-RELEASE 8-4-12 GRANULAR PALM FERTILIZER WITH MINORS MUST BE APPLIED AT THE RECOMMENDED LABEL RATE, SPREAD EVENLY ACROSS THE SURFACE OF THE ROOTBALL
- 6.4.3. FOLIAR FEED SIX TIMES PER YEAR.

TREE PROTECTION SPECIFICATIONS

- 7.1. TREE PROTECTION FENCES SHALL BE CONSTRUCTED PRIOR TO ANY CONSTRUCTION ACTIVITY INCLUDING GRUBBING FOR ALL TREES / PALMS TO REMAIN OR BE RELOCATED
- 7.2. FENCES SHOULD BE OF STURDY CONSTRUCTION STURDY TEMPORARY BARRIERS SHALL BE INSTALLED AROUND ALL TREE PROTECTION ZONES. BARRIERS SHALL BE A MINIMUM OF FOUR FEET HIGH, AND SHALL BE CONSTRUCTED OF CONTINUOUS CHAIN LINK FENCE WITH METAL POSTS AT EIGHT-FOOT SPACING, OR OF TWO-BY-FOUR INCH POSTS WITH THREE EQUALLY SPACED TWO-BY-FOUR INCH RAILS POSTS MAY BE SHIFTED TO AVOID BOOTS.
- 7.3. FENCES MUST BE MAINTAINED INTACT UNTIL THE PROJECT IS COMPLETED. THEY SHOULD NOT BE REMOVED OR DROPPED FOR ANY REASON WITHOUT AUTHORIZATION FROM THE CITY'S URBAN FORESTER
- 7.4. NO ACTIVITY OR DISTURBANCE SHOULD OCCUR WITHIN THE FENCED AREAS, INCLUDING VEHICLE USE, STORAGE OF MATERIALS, DUMPING OF LIQUIDS OR MATERIALS, GRADE CHANGES, GRUBBING, MECHANICAL TRENCHING FOR IRRIGATION, ELECTRICAL LIGHTING, ETC.

- 8.1. ALL RELOCATED TREES AND PALMS MUST BE GUARANTEED FOR ONE YEAR FROM THE DATE OF RELOCATION TO THEIR FINAL LOCATIONS.
- 8.2. IF A TREE OR PALM DIES WITHIN THE 1-YEAR WARRANTY PERIOD, IT MUST BE REMOVED AND REPLACED AT CONTRACTOR'S EXPENSE.
- 8.3. IF A TREE OR PALM PERFORMS POORLY WITHIN THE 1-YEAR WARRANTY PERIOD, IT MUST BE REMOVED AND REPLACED AT THE CONTRACTOR'S EXPENSE. THE DECISION TO REPLACE BASED ON POOR HEALTH IS AT THE DISCRETION OF THE LANDSCAPE ARCHITECT.
- 8.4. IF A TREE OR PALM SETTLES TO AN UNHEALTHY DEPTH WITHIN THE 1-YEAR WARRANTY PERIOD, AS DEEMED BY THE LANDSCAPE ARCHITECT. IT MUST BE RAISED TO THE CORRECT GRADE AT CONTRACTOR'S EXPENSE

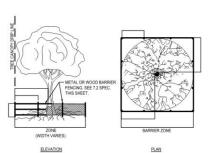

TREE BARRICADE DETAIL



TREE TRUNK PROTECTION DETAIL

DESIGN CONSULTANT



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DESIGN CONSULTANT

CAPETOWN, 8001 SOUTH AFRICA

4541 NORTH BAY ROAD, MIAMI BEACH, FL 33140 PEVISIONS

SCALE: AS NOTED

DRAWING TITLE


NOTES & DETAILS

L-102

4541 NORTH BAY RD

TREE DISPOSITION

SHEET NO.

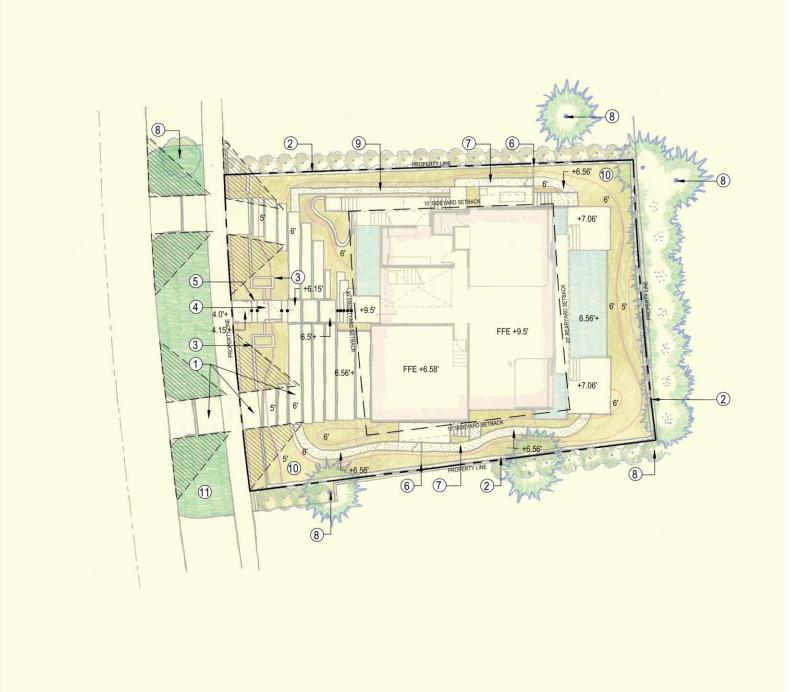

LEGEND

PROPERTY LINE

SETBACK

- ① Concrete pavers on compacted sand base
- 2 Masonry property wall at max. allowed
- 3 7'-0" HT Masonry planters with stone veneer to match architecture. To be planted with accents and cascading plants.
- 4 Pedestrian Entrance
- ⑤ Concrete steps
- 6 Maintenance gate / pool safety gate
- Maintenance path
- ® Existing off-site vegetation to remain

SCALE: 1/16" = 1'- 0"

- Mulch path
- 10 Planting area, TYP.
- 11 Lawn, TYP.



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DESIGN CONSULTANT

4541 NORTH BAY RD

4541 NORTH BAY ROAD, MIAMI BEACH, FL 33140

SCALE: AS NOTED

HARDSCAPE PLAN

SHEET NO.

4541 North Bay Road Garden | Proposed Plant List

Miami Beach, Fl.

8-Apr-22

GROUND LEVEL

	RELOCATED TREES & PALMS						
QTY	Botanical Name	Common Name	Native	Specifications			
5	Thrinox radiata	Green Thatch Palm	Yes	Relocated from on-site (#10, 11, 12, 23, 40)			
5	Cocos nucifera	Coconut Palm	No	Relcoated from on-site (#31, 34, 39, 41) and to be laid out in the field by landscape architect (#42)			
	TREES						
QTY	Botanical Name	Common Name	Native	Specifications			
3	Clusia rosea	Autograph Tree	Yes	200 Gal., 16' HT. x 8' SPR.; Character trunk			
3	Eugenia rhombea	Red Stopper	Yes	12' HT. x 6' SPR.; 2" DBH (minimum), Character branching, multi trunk			
3	Myrcianthes fragrans	Simpson's Stopper	Yes	12' HT. x 6' SPR.; 2" DBH (minimum), Character branching, multi trunk			
4	T.B.D.	Misc. Native Canopy Tree	Yes	16' HT. x 8' SPR.; 4" DBH (minimum)			
1	T.B.D.	Sculptural Accent Canopy Tree	Yes	16" HT. x 8" SPR.; 4" DBH (minimum)			
	-Mottes (co.tt):						

	PALMS			
QTY	Botanical Name	Common Name	Native	Specifications
4	Dypsis pembana	Pemba Palm	No	F.G.; 16'-20' HT.; 5 trunks min.
2	Sabal domingensis	Dominican Sabal Palm	No	20'-25' CT.; Heavy
8	Thrinox radiato	Green Thatch Palm	Yes	13'-21' WD; Staggered heights; Character trunks

	UNDERSTORY TREES / LARGE SHRUBS	S		
QTY	Botanical Name	Common Name	Native	Specifications
14	Polyalthia longifolia	False Ashoka Tree	No	24' HT.
4	T.B.D.	Misc. Native Understory Trees	Yes	12' HT. x 6' SPR.; 2" DBH (minimum)
15	T.B.D.	Misc. Large Native Shrub	Yes	45 Gai.: 6'-8' HT. x 4'-5' SPR.: Bush

	UNDERSTORY SHRUBS			
QTY	Botanical Name	Common Name	Native	Specifications
33	T.B.D.	Misc. Low Native Shrub	Yes	7 Gal.; 24"-36" HT.; Full
19	Begonia odorata	Sweet Begonia	No	3 Gal.; Full
5	Franthemum pulchelium	Blue Sage	No	3 Gal.: 3' HT.

- 1							
		ACCENTS					
	QTY	Botanical Name	Common Name	Native	Specification		
ı	6	Alcantarea 'Odorata'	Same	No	3 Gal.		
	2	Monstera adansonii	Swiss cheese Philodendron	No	3 Gal.		
	8	Philodendron gloriosum	Anthurium Gloriosum	No	7 Gal.		
	60	Portea petropolitana 'Jungles'	Portea Bromeliad 'Jungles'	No	3 Gal.; Full		
	2	Zamia floridana	Coontie	Yes	7 Gal.; 18" HT.; Full		

Ŷ	GROUNDCOVERS			
QTY	Botanical Name	Common Name	Native	Specification
50	Ernodea littoralis	Golden Beach Creeper	No	1 Gal.
22	Farfugium japonicum 'Gigantea'	Giant Leopard Plant	No	3 Gal.
28	Hymenocailis latifolia	Spider Lily	Yes	3 Gal. @ 24" O.C.; Full
597	Microsorum scolopendrium	Wart Fern	No	1 Gal. @ 18" O.C.; Full
20	Nephrolepis exaltata	Boston Fern	Yes	1 Gal. @ 18" O.C.; Full
93	Peperomia obtusifolia	Baby Rubber Plant	Yes	1 Gal. @ 18" O.C.; Full
13	Philodendron 'Burle Marx'	Same	No	3 Gal. @ 24" O.C.; Full
7	Phylianthus myrtifolius	Mousetail Plant	No	3 Gal. @ 24" O.C.; Full
35	Pilea glauca	Same	Nο	1 Gal. @ 12" O.C.; Full
18	SOD			
QTY	Botanical Name	Common Name	Native	Specification
1,069	Zoysia japonica 'Empire'	Zoysia Grass 'Emprire'	No	Solid Sod; Quantity shown in square feet

		VINE			
	QTY	Botanical Name	Common Name	Native	Specification
[4	Stephanotis floribunda	Madagascar Jasmine	No	3 Gal.
	2	Trachelospermum jasminoides	Confederate Jasmine	No	7 Gal.; Trellis

4541 North Bay Road Garden | Mitigation Chart

Miami Beach, Fl. 8-Apr-22

Mitigation Chart	
Total Tree D.B.H. Removed Requiring Mitigation	36 inches
Total Palms Removed Requiring Mitigation Tree Replacement on a 1:1 basis	11 (12' HT.; 2" DBH)
Proposed Trees with 16' HT. x 8' SPR.; 4" D.B.H. (minimum)	8 (refer to Trees category in plant list)
Proposed Trees with 12' HT. and 2" D.B.H. (minimum)	10 (refer to tees /understory trees category in

Sec. 46-61. - Tree replacement.

(1) Tree replacement chart. The tree replacement chart below, shall be used to determine the total number and size of trees that shall be planted as replacement trees for all trees permitted for removal. The replacement tree calculations are based on the total diameter in inches of all trees approved for removal. To determine the required replacement trees, calculate the total sum in inches of the diameters of all trees to be removed. This sum will result in one single number in inches that represents the combined total of the diameters of all trees to be removed. Diameter measurement shall be rounded up to the nearest inch.

TREE REPLACEMENT CHART

Total diameter of tree(s) to be removed (sum of inches at DBH)	Total number of replacement trees required (where each replacement tree is a minimum of 2" DBH x 6' spread in canopy x 12' in height)	OR	Total number of replacement trees required (where each replacement tree is a minimum of 4" DBH x 8" spread in canopy x 16' in height)	OR	Contribution to Tree Trust Fund
2"-3"	1	or	0	or	\$1,000.00
4"-6"	2	or	1	or	\$2,000.00
7"-12"	4	or	2	or	\$4,000.00
13"-18"	6	or	3	or	\$6,000.00
19"-24"	8	or	4	or	\$8,000.00
25"-30"	10	or	5	or	\$10,000.00
31"-36"	12	or	6	or	\$12,000.00
37"-42"	14	or	7	or	\$14,000.00
43"-48"	16	or	8	or	\$16,000.00
49"-60"	20	or	10	or	\$20,000.00

- (a) If the sum of the diameter of trees to be removed exceeds a total of 60 inches, the additional inches shall be added cumulatively from the top of the chart, down to the bottom of the chart, to calculate the number of trees required as replacement trees.
- (b) Up to 30 percent of the two-inch DBH replacement tree requirement may be met by planting native species within private property, with a minimum height of ten feet and a minimum DBH of one and one-half inches at time of planting.
- (c) The removal of a palm shall be replaced with one canopy tree at 12 feet overall height with a



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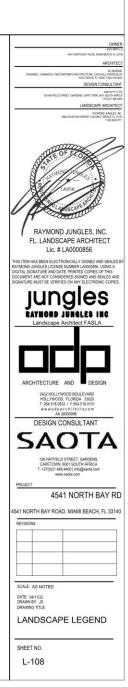
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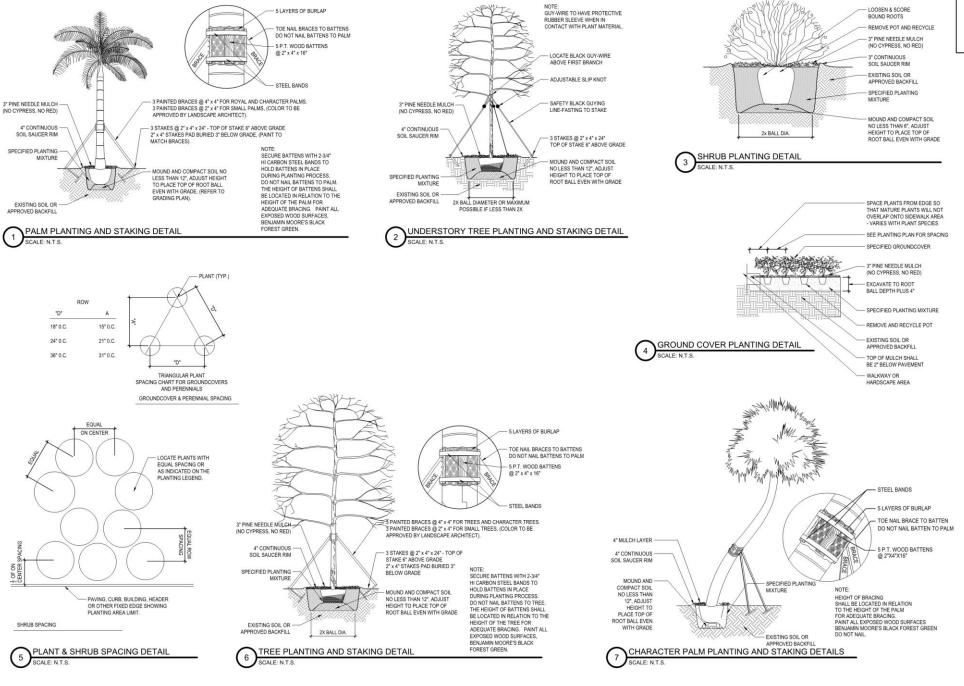
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PLANT LIST & MITIGATION CHART

SHEET NO.

	INFORMATION REQUIRED TO BE PERMANENTLY AFFIXED TO PLANS	0.17	
	ZONING DISTRICT RS-4 LOT AREA 7,314 SF ACRES	0.17	
	OPEN SPACE	REQUIRED/ ALLOWED	PROVIDED
A.	SQUARE FEET OF REQUIRED OPEN SPACE AS INDICATED ON SITE PLAN: LOT AREA = $\frac{7.314}{5}$ S.F. X $\frac{50\%}{3}$ % = $\frac{3.657}{5}$ S.F.	3,657 SF	3,717 SF
В.	SQUARE FEET OF PARKING LOT OPEN SPACE REQUIRED AS INDICATED ON SITE PLAN:	N/A	N/A
	NUMBER OF PARKING SPACES X 10 S.F. PARKING SPACE =	N/A	N/A
C.	TOTAL SQUARE FEET OF LANDSCAPED OPEN SPACE REQUIRED: A+B=	3,657 SF	3,717 SF
	COVERAGE EXEMPTION (5'-0" F	PROJECTIONS-7	762 SQ.FT.)
	LAWN AREA CALCULATION		
A.	SQUARE FEET OF LANDSCAPED OPEN SPACE REQUIRED 3,657	3,657 SF	3,717 SF
В.	MAXIMUM LAWN AREA (SOD) PERMITTED= 50 % X 3,657 S.F.=1,828 SF	1,828 SF	0 SF
	TREES		
A.	TREES REQUIRED PER NET LOT ACRE		
	TREES ON FRONT YARD	2	4
	TREES ON BACK YARD	3	5
	TREES IN EXCESS OF 6,000 SF LOT (1 TREE X 1,000 SF)	2	
	TOTAL TREES ON LOT	7	28
В.	30% NATIVES REQUIRED: 7 X 30% = 2.1	2	15
C.	50% LOW MAINTENANCE / DROUGHT AND SALT TOLERANT REQUIRED: 7 X 50% = 3.5	4	15
D.	STREET TREES (MAXIMUM AVERAGE SPACING OF 20' O.C.) 77 LF / 20' = 3.8	4	4
E.	STREET TREE SPECIES ALLOWED DIRECTLY BENEATH POWER LINES: (MAXIMUM AVERAGE SPACING OF 20' O.C.):	N/A	N/A
	SHRUBS		
A.	NUMBER OF SHRUBS REQUIRED: SUM OF LOT AND STREET TREES REQUIRED 11 X 12 = 132	132	170
В.	50% NATIVE SHRUBS REQUIRED: 132 X 50% = 66	66	70
	LARGE SHRUBS OR SMALL TREES		
A.	LARGE SHRUBS OR SMALL TREES (10% OF REQUIRED SHRUBS) 132 X 10% = 13.2	13	19
В.	50% NATIVE LARGE SHRUBS OR SMALL TREES REQUIRED: 13.2 X 50% = 6.6	7	19





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SHEET NO.

GENERAL LANDSCAPE NOTES AND SPECIFICATIONS

- LANDSCAPE CONTRACTOR SHALL BECOME FAMILIAR WITH THE SCOPE OF WORK AS WELL AS THE SITE, DIGGING CONDITIONS, AND ANY OBSTACLES PRIOR TO SUBMITTING A BID.
- LANDSCAPE CONTRACTOR SHALL PROVIDE AN INSTALLATION SCHEDULE TO THE GENERAL CONTRACTOR AND LANDSCAPE ARCHITECT FOR REVIEW AND APPROVAL.
- LANDSCAPE CONTRACTOR SHOULD VERIFY ALL ESTIMATED QUANTITIES OF MATERIAL SHOWN ON THE LANDSCAPE ARCHITECT'S DRAWINGS PRIOR TO SUBMITTING A BID.
- 4. PLANTING PLAN SHALL TAKE PRECEDENCE OVER PLANT LIST IN CASE OF DISCREPANCIES.
- ALL PLANT MATERIAL SYMBOLS SHOWN ON LANDSCAPE PLANS SHALL BE CONSIDERED DIAGRAMMATIC AND SHOULD BE ADJUSTED IN THE FIELD BY LANDSCAPE CONTRACTOR TO AVOID ALL UTILITIES AND ALL OTHER OBSTRUCTIONS. AFTER CONSULTING THE LANDSCAPE ARCHITECT.
- 6. ALL SIZES SPECIFIED FOR PLANT MATERIAL ON THE PLAN AND PLANT LIST SHALL BE CONSIDERED
- ALL PLANT MATERIAL MUST MEET OR EXCEED THE SPECIFIED MINIMUM REQUIREMENTS FOR BOTH HEIGHT AND SPREAD.
- ANY SPECIFIC REQUIREMENTS SUCH AS SPECIFIC SHAPE, CHARACTER, NUMBER OF TREE TRUNKS, PLANT SOURCE, TRANSPORTING, AND OR SPECIAL BRACING NOTED ON THE PLAN OR PLANT LIST, WILL REQUIRE APPROVAL AND OR COORDINATION WITH THE LANDSCAPE APCHITECT.
- NO CHANGE OR SUBSTITUTION SHALL BE MADE WITHOUT PRIOR APPROVAL OF THE LANDSCAPE ARCHITECT. ANY REVISION OR MODIFICATIONS TO THE LANDSCAPE PLAN MUST HAVE PRIOR APPROVAL BY THE THE LANDSCAPE ARCHITECT & OWNER
- ALL MATERIAL SHALL BE SUBJECT TO AVAILABILITY AT TIME OF INSTALLATION. SUBSTITUTIONS MAY BE MADE AFTER CONSULTATION WITH THE LANDSCAPE ARCHITECT.
- ALL TREES, PALMS, SHRUBS AND GROUND COVERS SHALL BE GUARANTEED FOR A PERIOD OF 12 MONTHS FROM DATE OF FINAL ACCEPTANCE.
- 12. CHANGES MAY OCCUR DURING THE NORMAL COURSE OF IMPLEMENTATION. VERBAL CHANGE ORDERS WILL NOT BE HONGRED. ANY CHANGES MUST BE SUBMITTED TO THE LANDSCAPE ARCHITECT IN WRITING AS A CHANGE ORDER TO BE REVIEWED AND APPROVED IN WRITING BY CHANGED LIGHT.
- 13. LANDSCAPE CONTRACTOR SHALL LOCATE AND VERIFY ALL UNDERGROUND UTILITIES OR STRUCTURES PRIOR TO DIGGING LANDSCAPE CONTRACTOR SHALL REPAIR ALL DAMAGES TO UNDERGROUND UTILITIES, AND OR CONSTRUCTION CAUSED BY LANDSCAPE INSTALLATION, AT NO COST TO THE OWNER.
- 14. LANDSCAPE CONTRACTOR SHALL COORDINATE WITH THE GENERAL CONTRACTOR, THE REMOVAL OF ALL BUILDING CONSTRUCTION DEBRIS AND FOREIGN MATERIAL PRIOR TO INSTALLATION OF ANY DEATH OF THE PRIOR OF THE PRIOR OF THE PRIOR OF T
- 15. SITE PREPARATION SHOULD INCLUDE THE ERADICATION AND REMOVAL OF ANY WEEDS OR GRASS, REMOVAL AND CLEAN UP OF ANY DEAD MATERIAL AND ROUGH AND FINISH GRADING PER SPECS AND OR LANDSCASE DIL AND.
- FOR PLANT MATERIAL DESIGNATED TO BE REMOVED, THE ENTIRE ROOT SYSTEM SHALL BE DUG AND REMOVED FROM THE SITE.
- 17. ALI PLANTING AREAS SHALL BE EXCAVATED TO A MINIMUM OF 3' FOR GROUNDCOVER'S AND MORE THAN 3' FOR SHRUBS, TREES, AND PALMS, AND SHOULD RECEIVE A SPECIFIED PLANTING SOIL MIXTURE. PLANTING SOIL SHALL BE 70% COARSE SAND, 20% FLORIDA PEAT, AND 10% PINE BARK AS MANUFACTURED BY ATLAS PEAT & SOIL OR APPROVED EQUAL. CONTRACTOR TO SUBMIT PLANTING SOIL SAMPLE FOR LANDSCAPE ARCHITECTS APPROVAL.
- 18. ALL PLANT MATERIAL SHALL BE FLORIDA NO. 1 OR BETTERAS SET FORTH IN THE FLORIDA DEPARTMENT OF AGRICULTURE GRADES AND STANDARDS FOR NURSERY PLANTS' SECOND EDITION FEB. 1988 INCLUDING REVISIONS AND WHICH MEET OR EXCEED THE SIZES INDICATED IN THE PLANTING SCHEDILIE AND DETAILS.
- ALL TREES SHALL BE STAKED IN A GOOD WORKMANLIKE MANNER. NO NAIL STAKING PERMITTED. (REFER TO BRACING NOTES AND PLANTING DETAILS)
- AFTER REMOVAL OR RELOCATION OF EXISTING TREES AND PALMS, ALL REMAINING HOLES SHALL BE BACK FILLED AROUND AND UNDER ROOT BALL WITH WASHED BEACH SAND. SOD DISTURBED AREA, IF REQUIRED. ALL SHRUB BEDS TO BE INSTALLED WITH WASHED BEACH SAND. (SEE SPEC.)
- ALL TREES, PALMS, SHRUBS AND GROUND COVER PLANTS SHALL BE FERTILIZED AT INSTALLATION, WITH LONG LASTING FERTILIZER, ACCORDING TO MANUFACTURERS' RECOMMENDATIONS AND BASED ON SOIL TESTS OF EXISTING ON-SITE SOILS.
- 22. ALL EXISTING PLANT MATERIAL TO REMAIN, SHALL BE PROTECTED DURING ALL CONSTRUCTION PHASES. ANY PLANT MATERIAL SCARRED OR DESTROYED DESIGNATED TO REMAIN MUST BE REPLACED AT THE CONTRACTOR'S EXPENSE WITH SIMILAR SPECIES SIZE AND QUALITY.
- ALL TREES ON SOD AREA SHALL RECEIVE A HARDWOOD / PINE NEEDLE MULCH MIX RING 2"IN DIAMETER TYPICAL. MULCH TO BE APPROVED BY LANDSCAPE ARCHITECT PRIOR TO PURCHASE AND/OR INSTALLATION.
- ALL PLANTING AREAS SHALL BE MULCHED WITH SHREDDED ORGANIC MULCH TO A MINIMUM OF 3";
 WITH THE EXCEPTION OF BEACH PLANTING. DO NOT USE CYPRESS OR RED MULCH.
- ALL TREES SHALL HAVE 2" CALIPER AT D.B.H. MINIMUM FOR A 10' HEIGHT TREE, UNLESS NOTED OTHERWISE.
- ALL 1 GALLON MATERIAL SHALL HAVE 12" SPREAD MINIMUM, ALL 3 GALLON MATERIAL TO HAVE 20-24" SPREAD MINIMUM.
- 27. ALL PLANTING AREAS WITHIN THE LIMITS OF WORK SHALL RECEIVE 100% COVERAGE BY AUTOMATIC IRRIGATION SYSTEM (DRIP PREFERRED) UNLESS OTHERWISE DIRECTED BY OWNER. SEE

IRRIGATION PLANS FOR ADDITIONAL SPECIFICATIONS.

- 28. LANDSCAPE CONTRACTOR TO COORDINATE INSTALLATION OF IRRIGATION SYSTEM WITH IRRIGATION CONTRACTOR. IRRIGATION TIME CLOCK TO BE <u>HARD WIRED</u> ON COMPLETION. RESPONSIBILITY OF IRRIGATION CONTRACTOR. LANDSCAPE CONTRACTOR SHALL HAND WATER OR ARRANGE FOR WATERING DURING PLANTING UNTIL IRRIGATION SYSTEM IS 100% OPERABLE. THIS IS THE RESPONSIBILITY OF THE LANDSCAPE CONTRACTOR.
- 29. LANDSCAPE CONTRACTOR SHALL COORDINATE HIS WORK WITH ALL OTHER APPROPRIATE CONTRACTORS.
- THE LANDSCAPE CONTRACTOR SHALL AT ALL TIMES KEEP THE JOB SITE CLEAN AND FREE FROM ACCUMULATION OF WASTE MATERIAL, DEBRIS, AND RUBBISH.
- 31. LANDSCAPE PLAN SHALL BE INSTALLED IN COMPLIANCE WITH ALL LOCAL CODES.
- ON-SITE LAYOUT OF PLANT MATERIAL SHALL BE COORDINATED WITH LANDSCAPE ARCHITECT AT THE TIME OF INSTALLATION.
- 33. ALL PLANTS, MATERIALS, WORKMANSHIP, AND INVOICE APPROVAL ARE SUBJECT TO THE APPROVAL
- 34. CONTRACTOR TO FLAG ALL PROPOSED TREE AND PALM LOCATIONS FOR OWNER AND LANDSCAPE ARCHITECTS APPROVAL PRIOR TO EXCAVATION OR INSTALLATION. PLAN LOCATIONS ARE SUBJECT TO FIELD ADJUSTMENTS BY THE LANDSCAPE ARCHITECT.
- 35. LANDSCAPE ARCHITECT TO APPROVE ALL SHRUB AND GROUNDCOVER PLANTING LOCATION AND LAYOUT PRIOR TO INSTALLATION.
- CONTRACTOR SHALL PROVIDE DIGITAL PHOTOGRAPHIC DOCUMENTATION DURING INSTALLATION FOR LANDSCAPE ARCHITECT'S REVIEW, DAILEY.
- 37. LANDSCAPE CONTRACTOR TO INSURE ALL PLANT MATERIAL IS INSTALLED AT THE CORRECT ELEVATION, REFER TO GRADING PLAN.
- 38. THE LANDSCAPE CONTRACTOR SHALL MAINTAIN OR COORDINATE WITH THE IRRIGATION CONTRACTOR AND LANDSCAPING MAINTENANCE SERVICES ALL PLANTING INCLUDING WATERING, MOWING, MULCHING, WEED, AND PEST CONTROL UNTIL FINAL ACCEPTANCE BY THE LANDSCAPE ARCHITECT AND OWNER.
- 39. THE AWARDED LANDSCAPE CONTRACTOR SHALL SUBMIT A PROPOSED BID / CONTRACT WITH PRICING FOR ALL PLANT MATERIAL INCLUDING (WARRANTY, LABOR, TRANSPORTATION, RELOCATION, SITE MAINTENANCE AND PREPARATION) AS PER THE LANDSCAPE ARCHITECT'S SPECIFICATIONS AND OR PLANTING PLANS.
- THE LANDSCAPE CONTRACTOR'S CONTRACT SHALL ACKNOWLEDGE ALL TERMS AND CONDITIONS SET FORTH UNDER THESE GENERAL LANDSCAPE NOTES AND SPECIFICATIONS.
- 41. THESE DRAWINGS, DOCUMENTS, AND ALL CONTENTS ARE THE PROPERTY OF RAYMOND JUNGLES, INC. ALL RIGHTS ARE RESERVED. UNAUTHORIZED USE OR PRODUCTION, IN PART OR WHOLE, FOR ANY PURPOSE IS UNLAWFUL AND PROHIBITED EXCEPT BY EXPRESS WRITTEN CONSENT.
- 42. THE CONTRACTOR IS RESPONSIBLE FOR OBTAINING ANY PERMITS OR APPROVALS FROM THE FEDERAL, STATE OR LOCAL GOVERNMENT REQUIRED FOR THE WORK INCLUDED IN THIS CONTRACT AND ON THESE DEBUNGS
- 43. PLANT SHRUBS IN CIRCULAR PITS WITH A DIAMETER 16" GREATER THAN ROOTBALL OR CONTAINER. PLANT TREES IN CIRCULAR PITS WITH A DIAMETER 36" GREATER THAN ROOTBALL OR CONTAINER.. PLACE PLANTS WITH BEST "FACE" FORWARD.
- 44. BACKFILL ALL PLANTING PITS WITH THE FOLLOWING MIXTURE: ¹/₂ ONSITE SOIL, ¹/₂ CLEAN FRIABLE TOPSOIL. SUBMIT TOPSOIL SAMPLE AND SOIL TEST ANALYSIS FOR APPROVAL BY LANDSCASPE ARCHITECT, (SEE PLANTING DETAILS), REMOVE EXCESS SOIL EXCAVATED FROM PLANT PIT FROM THE SITE OR DISTRIBUTE ON-SITE AS DIRECTED BY LA.
- 45. VERIFY ALL QUANTITIES IN THE PLANTING SCHEDULE AND INSTALL ALL PLANTS AND MATERIALS AS INDICATED IN THE PLAN. PROVIDE COMPOSITE UNIT PRICES FOR EACH PLANT, WHICH INCLUDE ALL OTHER INCIDENTAL MATERIALS, (I.E. MULCH, FERTILIZER, TOPSOIL, LABOR, ETC.)
- 46. NOTIFY THE OWNER AND LANDSCAPE ARCHITECT OF ANY UNFORESEEN CONDITIONS, I.E., COMPACTED SOIL / SUBGRADE, POOR DRAINAGE, UNCONSOLIDATED SOIL, EROSION, UTILITY CONFLICTS, EXCESSIVE SUN OR SHADE, ETC., PRIOR TO PROCEEDING WITH LANDSCAPE INSTALLATION.
- 47. ALL PLANTS, MATERIALS AND WORKMANSHIP ARE SUBJECT TO THE APPROVAL OF THE LANDSCAPE ARCHITECT AND OWNER.

GENERAL TREE BRACING NOTES AND SPECIFICATIONS:

TREES AND PALMS GREATER THAN 6" DBH TO BE BRACED WITH PROPS

- CHOOSE THE CORRECT SIZE, LENGTH, AND NUMBER OF PROPS TO BE USED (PRESSURE TREATED (PT), TIMBER BAMBOO (GUADUA ANGUSTIFOLIA) 3" DIA.).
- 2. ALL (PRESSURE TREATEO (PT) 2"X4", 4"X4"). STAKES SHALL BE PAINTED AS SPECIFIED BY THE LANDSCAPE ARCHITECT. WRAP AT LEAST 5 LAYERS OF BURLAP AROUND TRUNK OF THE PALM AT LEAST 4 INCHES WIDER THAN THE BATTENS BEING USED. BATTENS SHOULD BE MOUNTED AT A POINT 1/3 OF THE DISTANCE FROM GROUND TO THE CLEAR TRUNK OF THE TREE OR PALM. BUT NOT LESS THAN 4 FEET. WHICHEVER IS GREATER.
- 3. SELECT THE PROPER LENGTH AND SIZE OF BATTENS (PT 2"X4"X12"-16")
- 4. USE THE SAME NUMBER OF BATTENS AS PROPS BEING USED.
- 5. PLACE THE BATTENS VERTICALLY AND EVENLY SPACED AGAINST THE BURLAP.
- SECURE THE BATTENS IN PLACE WITH METAL OR PLASTIC BANDING STRAPS. DO NOT NAIL TREE.
- 7. WEDGE LOWER END OF PROP INTO SOIL AND SECURE WITH A 2"X4"X30" STAKE. PROPS SHOULD BE INSTALLED AT A 30 TO 40 DEGREE ANGLE FROM THE BATTENS AND OF SUFFICIENT LENGTH TO REACH THE GROUND. NOTE: ON STRAIGHT TREES OR PALMS OR TREES, SPACE PROPS EQUAL DISTANCE. AROUND TREE OR PALM ON CURVED (CHARACTER) PALMS OR TREES, SPACE PROPS AGAINST THE FRONT OF THE CURVE OF THE PALM.
- CUT A SMOOTH ANGLE AT THE END OF THE PROPS. ALIGN WITH AND NAIL INTO BATTENS. DO NOT PENETRATE TREE OR PALM WITH NAILS.
- IF IT APPEARS THAT ADDITIONAL CONSTRUCTION WORK WILL TAKE PLACE NEAR TO OR IN THE VICINITY OF THE NEWLY BRACED TREES OR PALMS, THEN PROPS ARE TO BE CLEARLY LABELED WITH THE STATEMENT "TO NOT REMOVE"
- 10. PROPS ARE NOT TO BE REMOVED UNTIL APPROVED BY THE LANDSCAPE CONTRACTOR.

TREES AND PALMS LESS THAN 6" DBH TO BE BRACED BY GUYING:

- CHOOSE THE CORRECT SIZE AND NUMBER OF STAKES AND SIZE OF SLEEVE AND WIRE GUYING SHALL BE COMPLETED WITHIN 48 HOURS OF PLANTING THE TREE.
- 2. CUT LENGTHS OF STAKING SLEEVE TO EXTEND 2 INCHES PAST TREE TRUNK WHEN WEAPPING AROUND.
- SPACE STAKES EVENLY ON OUTSIDE OF WATER RING AND DRIVE EACH FIRMLY INTO THE GROUND. STAKES SHOULD BE DRIVEN AT A 30 DEGREE ANGLE WITH THE POINT OF THE STAKE TOWARD THE TREE UNTIL 4 TO 5 INCHES ARE LEFT SHOWING.
- 4. PLACE THE SLEEVE AROUND THE TRUNK JUST ABOVE THE LOWEST BRANCH.
- THREAD THE WIRE THROUGH THE SLEEVE AND PAST THE STAKE, ALLOWING APPROXIMATELY 2 FEET OF EACH OF THE TWO ENDS BEYOND THE STAKE BEFORE CLITTING THE WIFE
- 6. TWIST WIRE AT RUBBER SLEEVE TO KEEP IT IN PLACE
- PULL WIRE DOWN AND WIND BOTH ENDS AROUND STAKE TWICE. TWIST WIRE BACK ONTO ITSELF TO SECURE IT BEFORE CUTTING OFF THE EXCESS.
- THE ABOVE PROCEDURES ARE TO BE FOLLOWED FOR EACH STAKE, KEEPING THE TREE STRAIGHT AT ALL TIMES.
- THERE SHOULD BE A 1 TO 3 INCH SWAY IN THE TREE (THE WIRES SHOULD NOT BE PULLED TIGHT) FOR BEST ESTABLISHMENT.
- 10. FLAG THE GUY WIRES WITH SURVEYOR'S FLAGGING OR APPROVED EQUAL FOR SAFETY.
- 11. ANY WIRES ARE NOT TO BE REMOVED UNTIL APPROVED BY LANDSCAPE ARCHITECT

OV 4987

APCHI

DESIGN CONSULTANT

DONNELL DAWNWOLF AND PARTNERS ARCHITECTS INC. 2432 HOLLYWOOD HOLLYWOOD, FL 3000 T-994 ST

SACTARTY

109 HATFIELD STREET, GARDENS, CAPE TOWN, BIRT SOUTH A *27Y0301-88

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PROJECT

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PLANTING NOTES & SPECIFICATIONS

SHEET NO.





UP LIGHT







RECESSED STEP LIGHT



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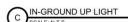
SCALE: AS NOTED

DRAWING TITLE

LANDSCAPE LIGHTING **SPECIFICATIONS**

SHEET NO.

L-111











GENERAL NOTES

BEAM ANGLES.

- PROPOSED LANDSCAPE LIGHTING IS TO BE SUBTLE ACCENTUATE SPECIMEN AND OTHER KEY PLANT MATERIAL AND PROVIDE WAYFINDING LIGHTING FOR SPORTS COURTS OR OTHER ATYPICAL FEATURE LIGHTING IS NOT PROPOSED.
- 2. ALL FIXTURES TO BE INSTALLED PER THE NATIONAL ELECTRICAL CODE (N.E.C.). THE N.E.C. SHALL GOVERN AND SUPERCEDE ALL SPECIFICATIONS.
- 3. CONTRACTOR TO COORDINATE EXACT FIXTURE LOCATION WITH LANDSCAPE ARCHITECT PRIOR TO INSTALLATION.
- 4. CONTRACTOR TO VERIFY TRANSFORMER QUANTITIES AND LOCATIONS PRIOR TO INSTALLATION 5. ALL VISIBLE HARDWARE CONNECTIONS TO BE APPROVED BY LANDSCAPE
- ARCHITECT. 6. NO LAMP SUBSTITUTIONS SHALL BE PERMITTED UNLESS APPROVED BY
- LANDSCAPE ARCHITECT. 7. PERFORMANCE ENHANCING LENSES TO BE SPECIFIED AND APPROVED BY LANDSCAPE ARCHITECT. PRISMATIC SPREAD LENSES TO BE USED FOR WIDE
- 8. TRANSFORMERS SHALL BE MULTI-MATIC MAGNETIC STAINLESS STEEL.
- PRIOR TO PURCHASING MATERIALS, CONTRACTOR SHALL PROVIDE SUBMITTALS TO LANDSCAPE ARCHITECT FOR REVIEW AND APPROVAL
- 10. WIRE SHALL BE UV RESISTANT DIRECT BURIAL LIGHTING CABLE INSTALLED A MINIMUM OF 6" BELOW GRADE. CONTRACTOR SHALL ALLOW FOR AN

- ADDITIONAL 15% LOAD ON EACH CIRCUIT
- 11. DIRECT BURIAL WIRE SHALL BE PROTECTED BY 2' LENGTH PVC SLEEVE AT EDGE OF EVERY LANDSCAPE BED LINE.
- 12. ALL CONNECTORS USED SHALL BE KING INNOVATION SILICONE WATER-RESISTANT WIRE NUT CONNECTORS.
- 13. CONTRACTOR SHOULD VERIFY ALL ESTIMATED QUANTITIES OF MATERIAL SHOWN ON THE LANDSCAPE ARCHITECT'S DRAWINGS PRIOR TO SUBMITTING A BID.
- 14. NO CHANGE OR SUBSTITUTION SHALL BE MADE WITHOUT PRIOR APPROVAL OF THE LANDSCAPE ARCHITECT, ANY REVISION OR MODIFICATIONS TO THE LIGHTING PLAN MUST HAVE PRIOR APPROVAL BY THE LANDSCAPE ARCHITECT & OWNER.
- 15. CHANGES MAY OCCUR DURING THE NORMAL COURSE OF IMPLEMENTATION VERBAL CHANGE ORDERS WILL NOT BE HONORED. ANY CHANGES MUST BE SUBMITTED TO THE LANDSCAPE ARCHITECT IN WRITING AS A CHANGE ORDER TO BE REVIEWED AND APPROVED IN WRITING BY OWNER/CLIENT.
- LIGHTING CONTRACTOR SHALL LOCATE AND VERIFY ALL UNDERGROUND UTILITIES OR STRUCTURES PRIOR TO DIGGING, LIGHTING CONTRACTOR SHALL REPAIR ALL DAMAGES TO UNDERGROUND UTILITIES. AND OR CONSTRUCTION CAUSED BY LIGHTING INSTALLATION, AT NO COST TO THE
- 17. LIGHTING CONTRACTOR SHALL COORDINATE HIS WORK WITH ALL OTHER

- APPROPRIATE CONTRACTORS
- 18. LIGHTING PLAN SHALL BE INSTALLED IN COMPLIANCE WITH ALL LOCAL CODES
- 19. ON-SITE LAYOUT OF LIGHT FIXTURES SHALL BE COORDINATED WITH LANDSCAPE ARCHITECT AT THE TIME OF INSTALLATION. 20. THE CONTRACTOR IS RESPONSIBLE FOR OBTAINING ANY PERMITS OR
- APPROVALS FROM THE FEDERAL, STATE OR LOCAL GOVERNMENT REQUIRED FOR THE WORK INCLUDED IN THIS CONTRACT AND ON THESE DRAWINGS 21. THESE DRAWINGS, DOCUMENTS, AND ALL CONTENTS ARE THE PROPERTY
- OF RAYMOND JUNGLES, INC. ALL RIGHTS ARE RESERVED, UNAUTHORIZED USE OR PRODUCTION, IN PART OR WHOLE, FOR ANY PURPOSE IS UNLAWFUL AND PROHIBITED EXCEPT BY EXPRESS WRITTEN CONSENT.
- 22. CONTRACTOR SHALL POWER, AND CONFIRM VIA TESTING THE VOLTAGE OF EACH FIXTURE TO ENSURE THAT IT MEETS MANUFACTURER'S SPECIFICATIONS.
- 23. ANY AND ALL WATER FEATURE LIGHTING FIXTURES SHALL BE 12 VOLT MAXIMUM AND BE GROUNDED.
- 24. CONTRACTOR SHALL FURNISH ALL WARRANTY DOCUMENTATION TO OWNER AT COMPLETION OF JOB.
- 25. CONTRACTOR SHALL HAVE LIGHTING INSTALLATION PERMITTED AND INSPECTED BY THE GOVERNING REGULATORY AGENCY, APPROVAL

- DOCUMENTATION SHALL BE FURNISHED TO THE LANDSCAPE ARCHITECT & OWNER
- 26. CONTRACTOR SHALL DISCUSS OWNER PREFERENCES FOR SCENE OPTIONS
- AND DIMMING CONTROLS PRIOR TO LIGHTING INSTALLATION. 27. TRANSFORMER CAPACITY TO BE DETERMINED BY CONTRACTOR AND
- APPROVED BY LANDSCAPE ARCHITECT. 28. TRANSFORMERS SHALL BE COMPATIBLE WITH IN-HOUSE CONTROLS.
- 29. LAMP TYPES SHALL BE AN LED LIGHT SOURCE, UNLESS NOTED OTHERWISE, AND APPROVED BY LANDSCAPE ARCHITECT
- 30. ALL FIXTURES SHALL BE ON A DIMMER CONTROL MODULE WITH SCENE
- 31. INDIVIDUAL FIXTURE TYPES SHALL BE ON DEDICATED/SEGREGATED CIRCUITS AND TRANSFORMERS.





PROPOSED STREET MONTAGE VIEW EXISTING STREET VIEW

SAOTA

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