

		NOTES	Disposition					
Number	Symbol	Scientific Name		·				
1	PCA	Phoenix canariensis	CANARY DATE PALM	2'	15'	7'		RELOCATE
2	AME	Adonidia merrillii	CHRISTMAS PALM	1'	30'	10'	TOO CLOSE TO STRUCTURE	DEMO
3	AME	Adonidia merrillii	CHRISTMAS PALM	1'	30'	10'	TOO CLOSE TO STRUCTURE	DEMO
4	AME	Adonidia merrillii	CHRISTMAS PALM	1'	30'	10'	TOO CLOSE TO STRUCTURE	DEMO
5	AME	Adonidia merrillii	CHRISTMAS PALM	1'	30'	10'	TOO CLOSE TO STRUCTURE	DEMO
6	LCH	Livistona chinensis	CHINESE FAN PALM	1'	30'	10'	TOO CLOSE TO STRUCTURE	DEMO
7	PEL	Ptychosperma elegans	ALEXANDER PALM	0.6'	35'	10'		REMAIN
8	PEL	Ptychosperma elegans	ALEXANDER PALM	0.6'	35'	10'		REMAIN
9	PEL	Ptychosperma elegans	ALEXANDER PALM	0.6'	35'	10'		REMAIN
10	PEL	Ptychosperma elegans	ALEXANDER PALM	0.6'	35'	10'		REMAIN
11	CNU	Cocos nucifera	COCONUT PALM	1.5'	50'	12'		REMAIN
12	PEL	Ptychosperma elegans	ALEXANDER PALM	1.5'	50'	12'		REMAIN
13	PEL	Ptychosperma elegans	ALEXANDER PALM	1.5'	50'	12'		REMAIN
14	PEL	Ptychosperma elegans	ALEXANDER PALM	1.5'	50'	12'		REMAIN
15	PEL	Ptychosperma elegans	ALEXANDER PALM	0.4'	30'	5'		remain
16	PEL	Ptychosperma elegans	ALEXANDER PALM	0.4'	30'	5'		REMAIN
17	PEL	Ptychosperma elegans	ALEXANDER PALM	0.4'	30'	5'		REMAIN
18	CNU	Cocos nucifera	COCONUT PALM	0.6'	30'	5'		REMAIN
19	PEL	Ptychosperma elegans	ALEXANDER PALM	0.6'	30'	5'		REMAIN

Required number of trees	Required minimum number of species
01—10	2
11—20	3
21—30	4
31—40	5
41 or greater	6

Provided Tree Size and Species							
2" DBH   None							
4" DBH   Seagrape (8), Green Buttonwood (3), Live Oak (4)							
Species Diversity: 3 Species Total Trees: 15 Trees							

Mitigation Calculations Palm Removal: 5 palms = 5 trees

3

Total Mitigation Trees Required: 5 Trees Total Trees Proposed: 15 Trees

Deficiency in required number of trees will be made up for by complying with Miami Beach Code Section 46-61 (6) or (7). Please advise Landscape Architect of City preference.

4

50	5					
30'	5'					REMAIN
Total diameter of tree(s) to be removed (sum of inches at DBH)	Total number replacement t required (whe each replacen tree is a minin 2" DBH x 6' sp canopy x 12' in height)	rees re nent num of read in	OR	Total number of replacement trees required (where each replacement tree is a minimum of 4" DBH x 8' spread in canopy x 16' in height)	OR	Contribution to Tree Trust Fund
2"—3"	1		or	0	or	\$1,000.00
4"—6"	2		or	1	or	\$2,000.00
7"—12"	4		or	2	or	\$4,000.00
13"—18"	6		or	3	or	\$6,000.00
19"—24"	8		or	4	or	\$8,000.00
25"—30"	10		or	5	or	\$10,000.00
31"—36"	12		or	6	or	\$12,000.00
37"—42"	14		or	7	or	\$14,000.00
43"—48"	16		or	8	or	\$16,000.00
49"—60"	20		or	10	or	\$20,000.00
TREE/	PALM PROTECTION	FENCES SH	ALL BE	CONSTRUCTED PRIOR TO ANY CONST IS THAT ARE TO REMAIN BE PROTECT	RUCTIO	N ACTIVITY



OR ALL TREES / PALMS THAT ARE 'TO REMAIN, BE PROTECTED, or BE RELOCATED

NO ACTIVITY OR DISTURBANCE SHOULD OCCUR WITHIN THE FENCED AREAS, INCLUDING VE STORAGE OF MATERIALS, DUMPING OF LIQUIDS ORMATERIALS, GRADE CHANGES, GRUBBIN MECHANIGAL RENOBING FOR IRRIGATION. ELECTRICAL, LIQTING, FLO.






Tree + Palm protection barriers to extend beyond the 'dripline' or to the 'critical root zone area' of all trees/palms to be protected. Extend where necessary to protect tree canopy roots

Barriers shall be a minimum of four feet high, and shall be constructed of continuous chain link fence with metal posts at eight-foot spacing, or of two-by-four-inch posts with three equally spaced two-by-four-inch rails. Posts may be shifted to avoid roots.

OF THE PROJECT



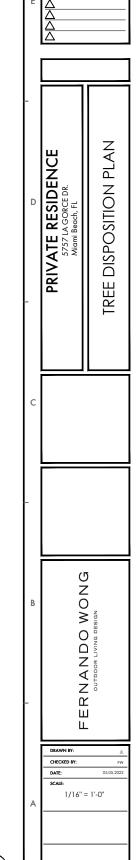


TD-100


NORTH

SCALE: 1/16" = 1'-0"

6

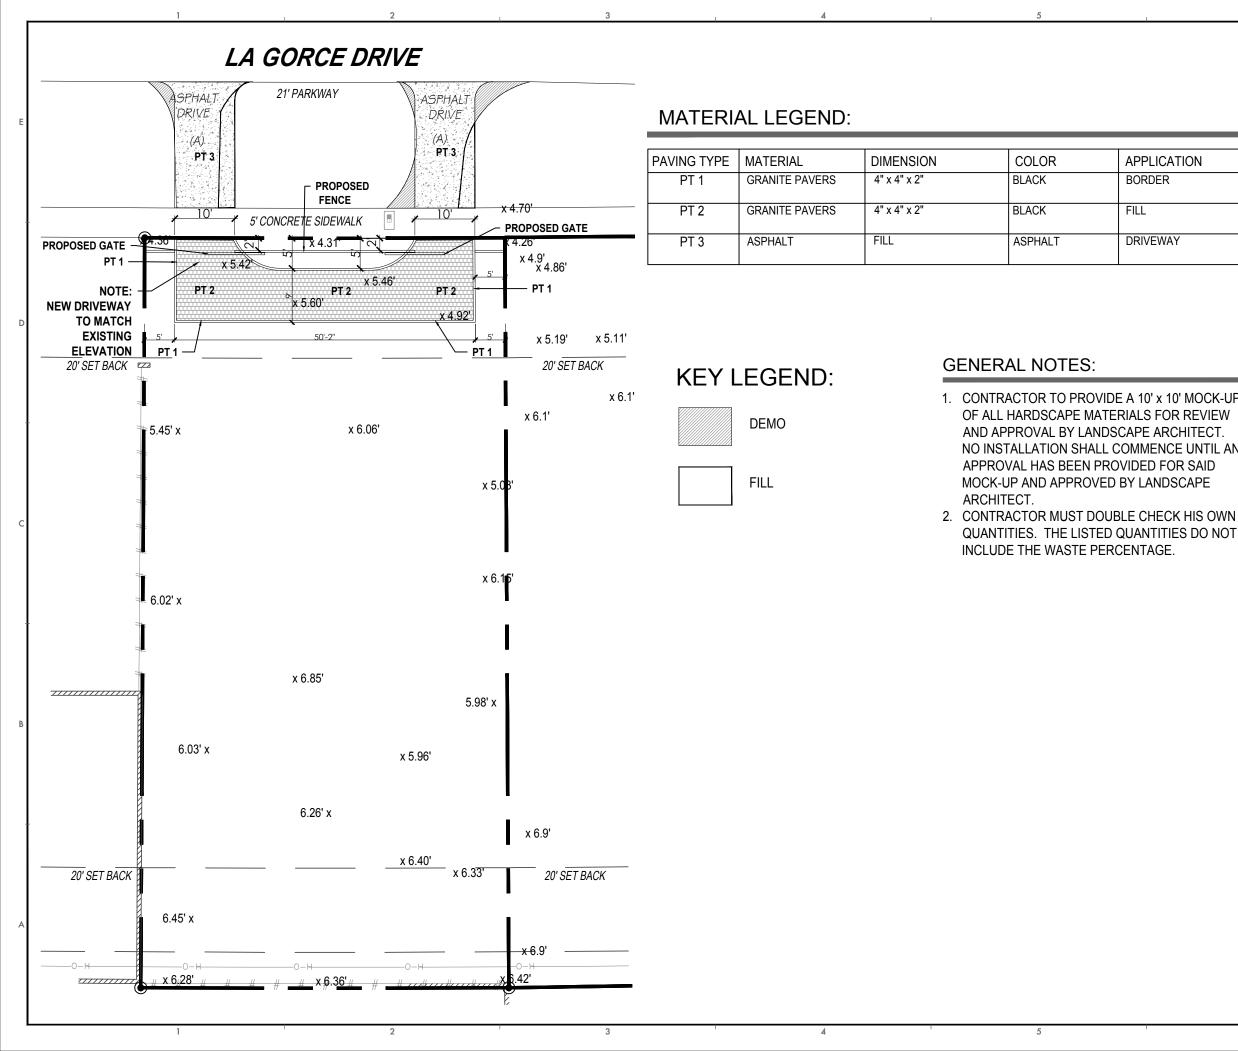

Ν	NOTES	QTY
	SET ON CONCRETE SLAB	45 SQ FT
	SET ON CONCRETE SLAB	529 SQ FT
		428 SQ FT

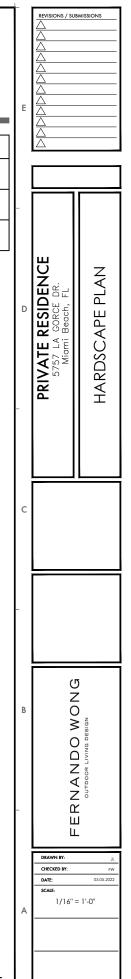

H-100

NORTH

)CK-UP VIEW
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SCALE: 1/16" = 1'-0"



## GATE - FRONT ELEVATION


N.T.S.

PROPOSED GATE TO MATCH **EXISTING GATE ON** 5774 PINE TREE DR. + 5777 LA GORCE DR. AT 5' TALL.




GATE VIEW 1


N.T.S.

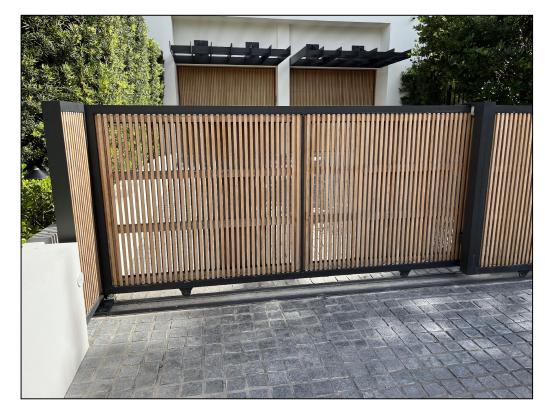

### GATE VIEW 2 N.T.S.

NOTE:

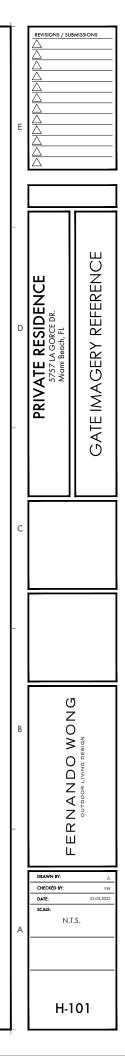

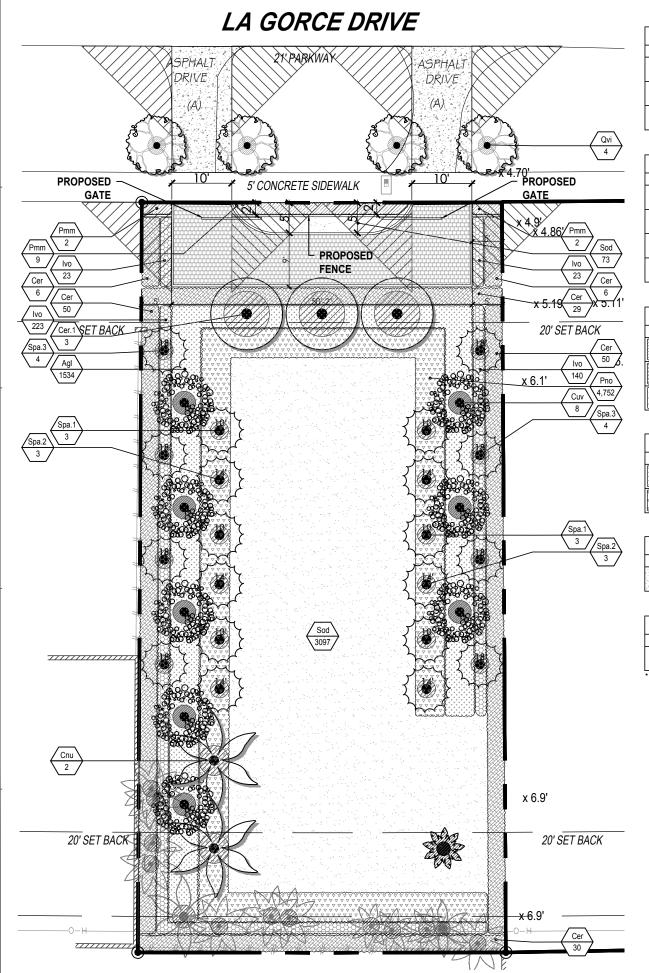

LANDSCAPE LIST

			TREES		
SYMBOL	KEY	QUAN.	PROPOSED MATERIAL	DESCRIPTION	
1997 a	CUV 8	<b>C</b> 111/	, o *Coccoloba uvifera	*Coccoloba uvifera	14' HT. 10' SPR. 3 - 4" CAL. STD.
		0	SEAGRAPE	100 GAL. FLORIDA GRADE #1	
	CER.1	R.1 3	*Conocarpus erectus	16'-18' HT. 6-8" SPR. STANDARD 4" CAL.	
I			GREEN BUTTONWOOD	100 GAL. FLORIDA GRADE #1	
	QVI	QVI 4	*Quercus virginiana	12'-13" HT. 4' SPR. 5' CT. 2"-3" CAL. STD.	
1 Card			LIVE OAK	45 GAL. GRADE #1	

			PALMS	
SYMBOL	KEY	QUAN.	PROPOSED MATERIAL	DESCRIPTION
¢	CNU	2	Cocos nucifera	16' CT.
20	CINU	2	COCONUT PALM	F.G.
ر ۱۹۰۶ ۱۹۰۶	2 @ { SPA.1	6	*Sabal palmetto	10' CT.
1. J.	SFA. I		CABBAGE PALM	F.G.
ر ۱	SPA.2	6	*Sabal palmetto	14' CT.
SPA.Z	0	CABBAGE PALM	F.G.	
{ <b>●</b> } SP.	SPA.3	8 *Sabal palmetto CABBAGE PALM	*Sabal palmetto	18' CT.
1.	JrA.J		CABBAGE PALM	F.G.

			HEDGES	
SYMBOL	KEY	QUAN.	PROPOSED MATERIAL	DESCRIPTION
	CER	171	*Conocarpus erectus	8' HT 30" O.C. FULL TO BASE
	CER		GREEN BUTTONWOOD	30 GAL.
IVO	N/O	409	*Ilex vomitoria	12" HT. 12" O.C.
	409	YAUPON HOLLY	3 GAL.	
/////	DAAAA	13	Podocarpus macrophyllus "Maki"	8' HT. 30" O.C.
PMM	F /Y\/Y\	13	PODOCARPUS MAKI	30 GAL.

	GROUND COVERS					
[	SYMBOL	KEY	SQ. FT	PROPOSED MATERIAL	DESCRIPTION	
		AGL	1.534	Arachis glabrata	10" O.C.	
		AGL	1,554	PERENNIAL PEANUT	1 GAL.	
			io 4,752	*Phyla nodiflora	6" O.C.	
l		FINO		FROGFRUIT	1 GAL.	

			SOD	
SYMBOL	KEY	SQ. FT	PROPOSED MATERIAL	DESCRIPTION
	100	2 170	Empire zoysia	
		3,170	EMPIRE GRASS	

			MULCH	
BAGS	SQ. FT	PROPOSED MATERIAL		DESCRIPTION
144		Mini Pine Bark		2" THICK
144				2 CU FT. BAGS


- 4

ATIVE PLANTS SPECIES


OVERALL PERVIOUS AREA MAXIMUM LAWN AREA

TREES

### SHRUBS

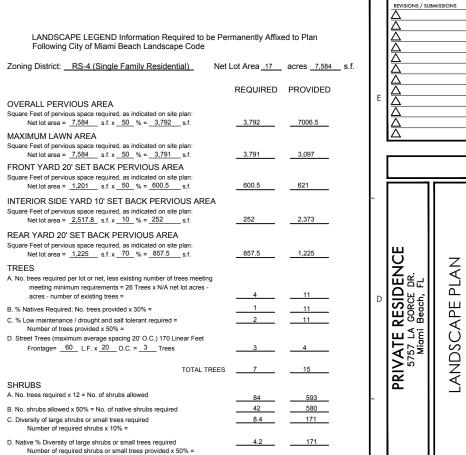

SEE LANDSCAPE LIST

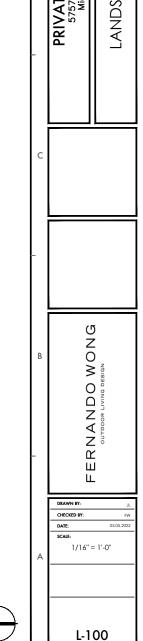

NORTH

SCALE: 1/16" = 1'-0"

## TREES



Coccoloba uvifera Seagrae

Conocarpus erectus GREEN BUTTOMWOOD







Cocos nucifera COCONUT PALM



Sabal palmetto

CABBAGE PALM

### HEDGES





Conocarpus erectus GREEN BUTTOMWOOD



llex vomitoria STOKES DWARF

2



Podocarpus macrophyllus 'Maki' PODOCARPUS MAKI

4

3

## **GROUND COVERS**



Arachis glabrata 'Golden Glory' Phyla nodiflora PERRENIAL PEANUT

5

## SOD



Empire zoysia



FROGFRUIT

E				
D	PRIVATE RESIDENCE 5757 LA GORCE DR. Miami Beach, FL	PLANT MATERIAL		
С				
-	FERNANDO WONG			
A	Z         5           Image: Constraint of the state of the stat			





# EXISTING CONDITIONS



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PROPOSED PROPERTY

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EXISTING PROPERTY

2

## STREET ELEVATION

SCALE: 1/16" = 1'-0"



EXISTING PROPERTY

5


	E	A		
l				
	D	PRIVATE RESIDENCE 5757 LA GORCE DR. Miami Beoch, FL	STREET ELEVATIONS	
	с			
	в	FERNANDO WONG		
	A	DRAWN BY: CHECKED BY: DATE: SCALE:		
		L-103		



A

PROPOSED FRONT DRIVEWAY - RENDERING

E	REVISIONS / SUBMISSIONS       A			
D	PRIVATE RESIDENCE 5757 LA GORCE DR. Miomi Beach, FL	FRONT DRIVEWAY RENDERING		
С				
_				
B	FERNANDO WONG			
A	L DRAWN BY: J CHECKED BY: FR DATE: 0505 202 SCALE: N.T.S. A L-104			

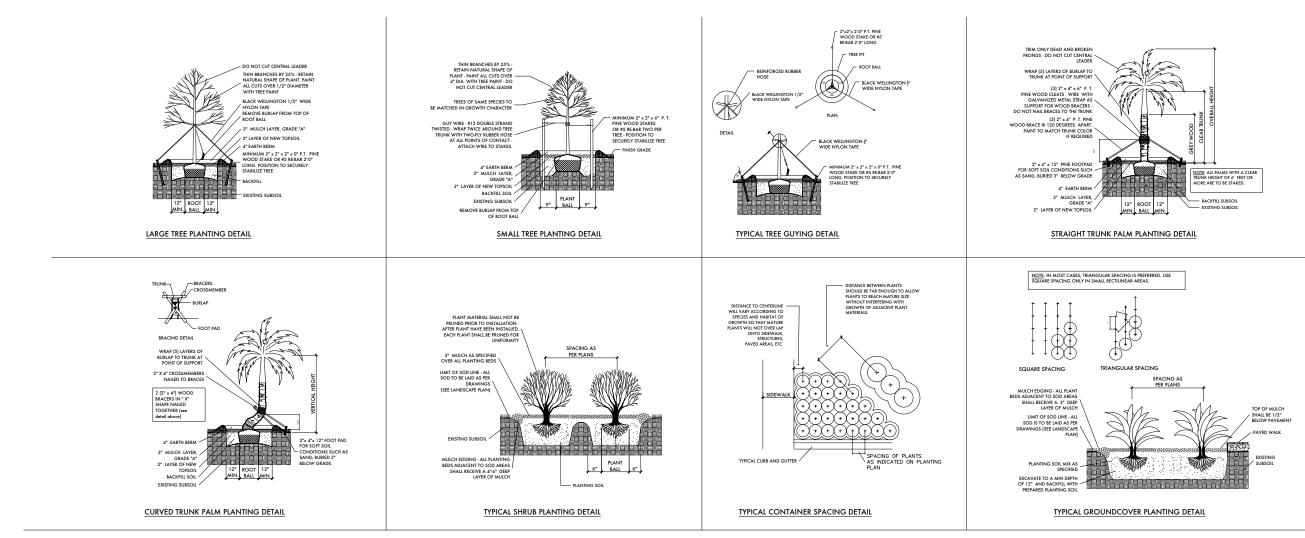

### PLANTING NOTES (See plant specification and details for additional standards)

-All plant material is to be Florida Number 1 or better pursuant to the Florida Department of Agriculture's Grades and Standards for Nursery Plants.

-All plants are to be top dressed with a minimum 3" layer of Melaleuca mulch, Eucalyptus mulch or equal.

-Planting plans shall take precedence over plant list in case of discrepancies.

-No changes are to be made without the prior consent of the Landscape Architect and Owner. Additions and or deletions to the plant material must be approved by the project engineer.

-Landscape Contractor is responsible for providing their own square footage takeoffs and field verification for 100% sod coverage for all areas specified.

- All landscape areas are to be provided with automatic sprinkler system which provide 100% coverage, and 50% overlap.

- All trees in lawn areas are to receive a 24" diameter mulched saucer at the base of the trunk.

- No mulch, fill or soil will be placed over the rootballs or within 4" of the trunks of the newly installed trees, and the trees will be installed at or slightly above the soil grade.

-Nursery Support Poles shall be removed at the Nursery, prior to delivery, and trees with the nursery poles will not be accepted and therefore rejected, with the exception of the following species: Clusea rosea and Silver Buttonwood trees.

- All straps, poles and braces shall be removed from all of the installed trees and palms within the 1-year of planting.

- No changes are to be made without the prior consent of the Landscape Architect, owner, City Urban Forester and City Planning Department. Additions and or deletions to the plant material must be approved per the Project Engineer, City Urban Forester and City Planning Department.

- Trees are to be planted within parking islands after soil is brought up to grade. Deeply set root balls are not acceptable.

- Planting soil for topsoil and backfill shall be 50/50 mix, nematode free. Planting soil for annual beds to be comprised of 50% Canadian peat moss, 25% salt free coarse sand and 25% Aerolite.

- Tree and shrub pits will be supplemented with "Agriform Pells", 21 gram size with a 20-10-5 analysis, or substitute application accepted by Landscape Architect. Deliver in manufacturer's standard containers showing weight, analysis and name of manufacturer.

- Tree protection fences shall be constructed prior to any construction activity including grubbing for all trees/palms to remain or be relocated. The fences should be of sturdy construction, 4x4 posts with wire mesh. Fences must be intact until the project is completed. They should not be removed or dropped for any reason without authorization from the city Urban Forester. No activity or disturbance should occur within the fenced areas, including vehicle use, storage of materials, dumping of liquids or materials, grade changes, grubbing and mechanical trenching for irrigation, electrical and liahtina, etc.

### **GENERAL NOTES**

-The Landscape Contractor is to locate and verify all underground and overhead utilities prior to beginning work. Contact proper utility companies and / or General Contractor prior to digging for field verification. The Owner and the Landscape Architect shall not be responsible for any damages to utility or irrigation lines (see Roadway Plans for more utility notes).

-Landscape Contractor is to verify all current drawings and check for discrepancies and bring to the attention of the Landscape Architect prior to commencing with the work.

-All unattended and unplanted tree pits are to be properly barricaded and flagged during installation.

-All planting plans are issued as directives for site layout. Any deviations, site changes, etcetera are to be brought to the attention of the Landscape Architect for clarification prior to installation.



