HPB21-0495 Final Submittal

City of Miami Beach Historic Preservation Board

Date= January 03, 2022

PROPOSAL

It is the intent of this proposal to present a strategy to convert the long-abandoned Fourplex and grounds at 622 15th Street into an attractive historically accurate, and economically viable enterprise. In order to achieve this overriding goal, the Applicant requests that the Board reclassify the garage building at the back of the site from contributing to non-contributing, allow its demolition, and approve the site plan lillustrted in the drawings herein.

It is also the Applicant's intent to replace the garage structure in the back of the site with a new building containing three two-bedroom apartments. The proposed new construction to replace the garage building shall adhere to modern methods of structure and design while honoring the existing Fourplex in scale, color, materials, fenestration, and composition.

PROFFERS

The property at 622 15th Street has been uninhabited since the current owner bought it in 2012. For numerous reasons the Owner, who lives abroad, has been unable to renovate the property per his original intention. As such the condition of the buildings and grounds are in a state of advanced neglect and present an eyesore on a block where every other property has

Ancient roofs and broken tiles, leaking windows and doors, pipe penetrations and lack of proper drainage have all combined to allow significant water infiltration into the structure of the building. Subsequent rot and damage to wooden structural members, advanced mold, falling plaster, and lack of attention to any mechanical and life safety systems have created, in the Applicant's opinion, a threat to public safety

It is the Applicant's goal to see the existing Fourplex and the site returned to a condition that is an asset to the street, the neighborhood, the City, and the Owner. Within the proposed plans for the restoration of this historic structure it is proposed to;

01. Recreate the arcaded front porch, arched entryway and portecochere that appear in the original drawings but were never built (see Historic Resources Report).

02. Restore all existing roofs as well as the wood bracketing, barrel tile, eaves, and roof detailing that give the building its character.

03. Replace all existing windows and doors with impact rated products to match the original microfilm drawings in size, general style and composition. All replacement exterior doors shall be full height with single lights.

04. Relocate all existing AC compressors at grade to the roof, shielding them behind the existing parapet walls.

05. Relocate all accumulated exterior plumbing pipes, electrical conduits,

06. Repair and patch all existing exterior stucco as required and repaint the entire structure

07. Provide professionally designed and coordinated landscape and hardscape plans-based on resiliency and storm water management- to augment the design intent of the site and building composition.

08. Reduce the existing 22' two-way curb cut to a 12' one-way curb cut.

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PROPERTY INFORMATION

PROPERTY ADDRESS:

MIAMI BEACH, FL 33139

FOLIO # 02-3234-002-1880

LEGAL DESCRIPTION: LINCOLN SUB PB9-69 LOT 3 BLK 73

LOT SIZE 60.000 X 100 OR 20709-2796 09 2002 1 COC 25129-4936 11 2006

TOWANER/ESTMENTS, LLC

C/O MANNY VADILLO, ESQ 11402 NW 41 ST #202 MIAMI FI 33178

NEAL DEPUTY ARCHITECT 1446 JEFFERSON AVENUE

MIAMI BEACH, FL 33139

ZONING DISTRICT: RM-1

HISTORIC DISTRICT: FLAMINGO PARK CONTRIBUTING STATUS: CONTRIBUTING

6,000 SQUARE FEET (60' x 100') SITE AREA:

MULTIFAMILY

ARCHITECT NEAL DEPUTY ARCHITECT

1446 JEFFERSON AVENUE MIAMI BEACH, FL 33139

RITUPARNA SIMLAI, RLA LANDSCAPE ARCHITECT: STUDIO ARTH LLC

2754 SW 36 AVENUE MIAMI, FL 33133

CONSULTANT

ARCHITECT PC, PA

DEPUTY

NEAL



ģ Improvements ĊĎ (1)**Building I** ach, Flori

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Site

Proposed

DRAWING ISSUES

30 NOV 21 CITY STAFF REVIEW

SCALE: AS NOTED

COVER SHEET

C-01

SHEET 01 OF 28

70

MAP OF BOUNDARY, TOPOGRAPHIC & TREE SURVEY Survey Pros, Inc.

Tel: 305.767.6802

2

STREET

LOT 3, BLOCK 73, OF LINCOLN SUBDIVISION, ACCORDING TO THE PLAT THEREOF, AS

RECORDED IN PLAT BOOK 9, PAGE 69, OF THE PUBLIC RECORDS OF MIAMI-DADE

THE GRAPHICALLY DEPICTED BUILDING(S) SHOWN ON THIS MAP OF SURVEY IS WITHIN ZONE AE

1. ELEVATIONS WHEN SHOWN REFER TO 1929 NATIONAL GEODETIC VERTICAL DATUM

2. NO ATTEMPT WAS MADE TO LOCATE FOOTINGS/FOUNDATIONS, OR UNDERGROUND

UTILITIES UNLESS OTHERWISE NOTED.

3. THE LANDS SHOWN HEREON HAVE NOT BEEN ABSTRACTED IN REGARDS TO MATTERS OF INTEREST BY OTHER PARTIES, SUCH AS EASEMENTS, RIGHTS OF WAYS,

RESERVATIONS, ETC. ONLY PLATTED EASEMENTS ARE SHOWN.
4. THIS SURVEY WAS PREPARED FOR AND CERTIFIED TO THE PARTY(IES) INDICATED

HEREON AND IS NOT TRANSFERABLE OR ASSIGNABLE WITHOUT WRITTEN CONSENT OF

6. THE BOUNDARY LIMITS ESTABLISHED ON THIS SURVEY ARE BASED ON THE LEGAL DESCRIPTION PROVIDED BY THE CLIENT OR ITS REPRESENTATIVE.
7. FENCE OWNERSHIP IS NOT DETERMINED.

8. ADDITIONS OR DELETIONS TO THIS SURVEY MAP AND/OR REPORT BY SOMEONE

OTHER THAN THE SIGNING PARTY(IES) IS PROHIBITED WITHOUT WRITTEN CONSENT OF

THE CENTERLINE OF 15TH STREET BEARS N88*07'18"E.

09/14/2021 - TOPOGRAPHIC + TREE SURVEY, JOB#21097059

5. ALL BOUNDARY LIMIT INDICATORS SET ARE STAMPED LB# 8023

LOCATION MAP:

PROPERTY ADDRESS:

LEGAL DESCRIPTION:

BASE FLOOD ELEVATION 8

CERTIFIED TO:

TOA INVESTMENT, LLC

C/O MANNY VADILLO ESQ.

(NGVD 1929).

FLOOD ZONE INFORMATION:

MAP & PANEL NUMBER 12086C0317 SUFFIX L

SURVEYOR'S NOTES:

COMMUNITY NAME & NUMBER CITY OF MIAMI BEACH 120651

18

19

www.survey-pros.com



ABBREVIATIONS:

A = ARC DISTANCE AC = AIR CONDITIONER PAD BCR = BROWARD COUNTY RECORDS

BLDG = BUILDING BM = BENCH MARK

BM = BENCH MARK
BOB = BASIS OF BEARINGS
CBS = CONCRETE BLOCK & STUCCO
(C) = CALCULATED
C&G = CURB & GUTTER
CLF = CHAIN LINK FENCE
COL = COLUMN
D.E. = DRAINAGE EASEMENT
D.E. = DRAINAGE & MAINTENANCE

D.M.E. = DRAINAGE & MAINTENANCE EASEMENT

D/W = DRIVEWAY

D/W = DRIVEWAY
EB = ELECTRIC BOX
ENC. = ENCROACHMENT
EP = EDGE OF PAVEMENT
EW = EDGE OF WATER
FDH = FOUND DRILL HOLE
FFE = FINISHED FLOOR ELEVATION
FINE FOUND DRILL BORE (NO. 12)

FIP = FOUND IRON PIPE (NO ID)

FIR = FOUND IRON ROD (NO ID)

FN = FOUND NAIL (NO ID) FPL = FLORIDA POWER & LIGHT TRANSFORMER PAD

L.E. = LANDSCAPE EASEMENT

L.M.E. = LAKE MAINTENANCE EASEMENT
(M) = MEASURED

MDCR = MIAMI-DADE COUNTY RECORDS MH = MAN HOLE
ML = MONUMENT LINE

(P) = PLAT PB = PLAT BOOK PC = POINT OF CURVATURE PCP = PERMANENT CONTROL POINT

PE = POOL EQUIPMENT PAD PG = PAGE PI = POINT OF INTERSECTION

PI = PI ANTER

POB = POINT OF BEGINNING
POC = POINT OF COMMENCEMENT
PRC = POINT OF REVERSE CURVATURE

PRM = PERMANENT REFERENCE

MONUMENT PT = POINT OF TANGENCY

R = RADIUS DISTANCE (R) = RECORD

R/W = RIGHT-OF-WAY

RES RESIDENCE SIP = SIP LB#8023 SND = SET NAIL & DISK LB#8023

STL = SURVEY TIE LINE

(TYP) = TYPICAL

UB = UTILITY BOX
U.E. = UTILITY EASEMENT

W/F = WOOD FENCE

SYMBOLS:

T = TELEPHONE RISER

= CABLE TV RISER

 ■ WATER METER X 0.00 = FIFVATION

(00') = ORIGINAL LOT DISTANCE

 Δ = CENTRAL ANGLE

= WATER VALVE = CURB INLET

= FIRE HYDRANT

= LIGHT POLE

- CATCH BASIN

= UTILITY POLE (D) = DRAINAGE MANHOLE

S = SEWER MANHOLE

= WOOD FENCE * * * = CHAIN LINK FENCE

— — = EASEMENT = BOUNDARY LINE






— = OVERHEAD UTILITY LINE









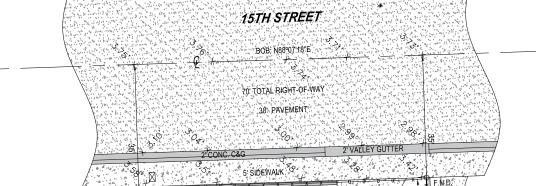

60.00

TWO STORY C.B.S.

BLDG.#622

LOWEST F.F.E.=5.12'

ELECTRIC

ROOM

60.00

TWO STORY C.B.S.

BUILDING

LOWEST F.F.E.=3.93'

4

EXISTING BUILDING

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.ري[,]

WALL

E

11^C

19.3'

.9 2' C.B.S.

SOD

LOT - 3

BLOCK - 73

SOD

19.8'

WAEK

NO CAI

0.32

120.00'

LOT - 4

BLOCK - 73

BLOCK

CORNER

TREE TABLE:


LOT - 2

BLOCK - 73

NO	COMMON NAME	DBH(ø)	HEIGHT	CANOPY
1	KING PALM	38"	15'	10'
2	PALM	22"	25'	10'
3	PALM CLUSTER	44"	20'	7'
4	PALM	9"	20'	7'
5	PALM	9"	20'	7'
6	PALM	9"	20'	7'
7	PALM	9"	20'	7'
8	PALM	9"	20'	7'
9	PALM CLUSTER	32"	10'	5'
10	PALM	9"	20'	7'
11	PALM	9"	20'	7'
12	CONIFER	21"	50'	10'

IN CASE OF DISPUTE AN ARBORIST REPORT WILL GOVERN



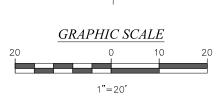

SURVEYOR'S CERTIFICATE:

HEREBY CERTIFY THAT THIS SURVEY IS TRUE AND CORRECT TO THE BEST OF MY KNOWLEDGE AND BELIEF AS RECENTLY SURVEYED AND DRAWN UNDER MY DIRECTION AND MEETS THE MINIMUM TECHNICAL STANDARDS SET FORTH BY THE FLORIDA STATE BOARD OF SURVEYORS AND MAPPERS IN CHAPTER 5J-17 FLORIDA ADMINISTRATIVE CODE PURSUANT TO SECTION 472 027 FLORIDA STATUE

SEAL

AUTHENTIC COPIES OF THIS SURVEY SHALL BEAR THE ORIGINAL SIGNATURE AND SEAL OF REGISTERED ATTESTING SURVEYOR AND MAPPER


FIELD WORK: 07/28/2021 JOB#: 21076895


DATE OF ORIGINAL


DRAWN BY: ADRIEL

CAD FILE: TOA SHEET 1 OF 1

NICOLAS DEL VENTO PROFESSIONAL SURVEYOR & MAPPER STATE OF FLORIDA LIC. # 6945

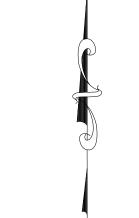

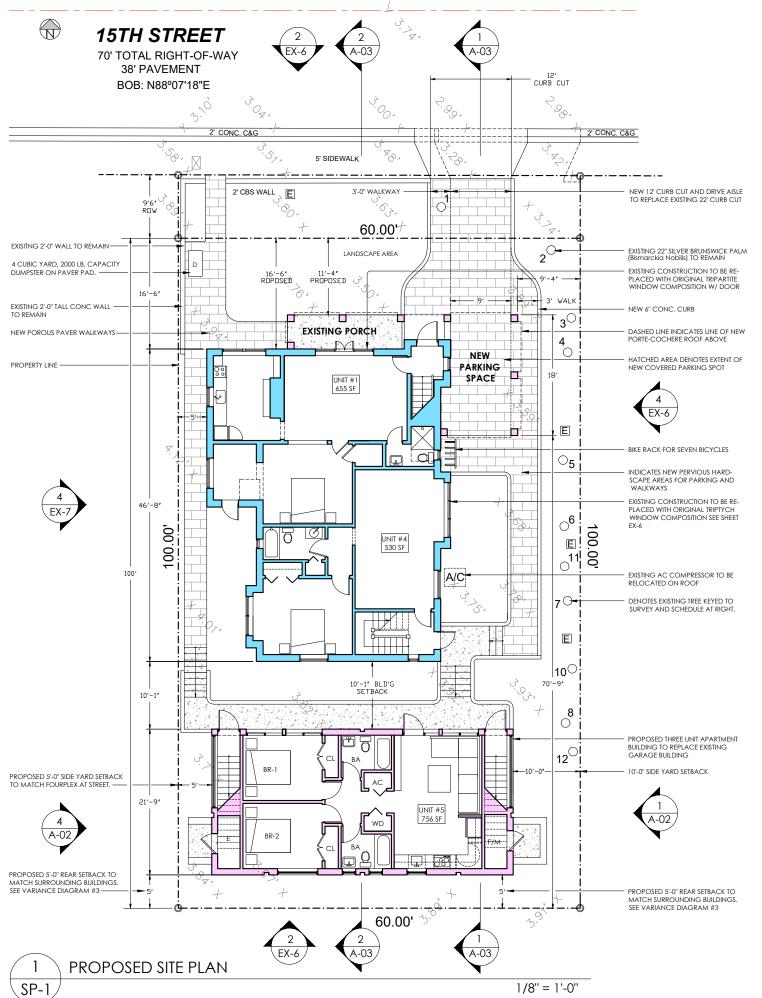

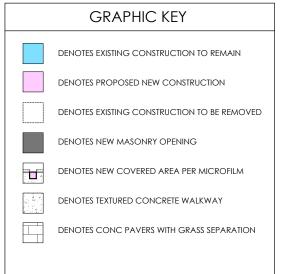

TREE TA	ABLE		
NO COMMON NAME	DBH	HT.	CANOPY
1 CANARY DATE PALM	38"	15'	10'
2 SILVER BRUNSWICK PALM	22"	25'	10'
3 CHRISTMAS PALMS	44"	20'	7'
4 CHRISTMAS PALM	9"	20'	7'
5 CHRISTMAS PALM	9"	20'	7'
6 CHRISTMAS PALM	9"	20'	7'
7 CHRISTMAS PALM	9"	20'	7'
8 CHRISTMAS PALM	9"	20'	7'
9 PYGMY DATE PALM	32"	10'	5'
10 CHRISTMAS PALM	9"	20'	7'
11 CHRISTMAS PALM	9"	20'	7'
12 NORFOLK ISLAND PALM	21"	50'	10'

*SEE ARBORISTS REPORT FOR MORE DETAIL ON TREE TYPES SIZES, CONDITIONS AND DISPOSITION.

OPEN SPACE CALCULATIONS

TOTAL SITE AREA = 60.00' X 100.00' = 6,000 SF

EXST'G MAIN BUILDING FOOTPRINT = 1,512 SI
PROPOSED REAR BLD'G FOOTPRINT = 1,005 SI

 TOTAL BUILDING FOOTPRINT=
 2,517 SF

 TOTAL HARDSCAPE AREA=
 1,467 SF

 3,516 SF (47% OPEN)

REQUIRED OPEN SPACE % = NOT SPECIFIED FOR LOTS < 65'

PROPOSED APARTMENT SIZES

APT #1= 655 SF EXISTING
APT #2= 581 SF EXISTING
APT #3= 489 SF EXISTING
APT #4= 530 SF EXISTING

AVERAGE SIZE

REHAB UNIT

564 SF

2,255 SF TOTAL BLDG 1

APT #5= 722 SF NEW BUILDING
APT #6= 788 SF NEW BUILDING
APT #7= <u>802 SF</u> NEW BUILDING

APT #7= 802 SF NEW BUILDING

2,326 SF TOTAL BLDG 2

4,581 SF TOTAL PROPOSED

PROPOSED FAR= **0.61**

ZONING DATA SHEET

MULTIFAMILY - COMMERCIAL - ZONING DATA SHEET

TEM #	Project Information				
1	Address:	622 15th Street, Miami	Beach, FL 33139		
2	Board and file numbers :				
3	Folio number(s):	02-3234-002-1880			
4	Year constructed:	1925	Zoning District:	RI	VI-1
5	Based Flood Elevation:	8'-0"	Grade value in NGVD:	3'-0" at	Sidewalk
6	Adjusted grade (Flood+Grade/2):	9'-6"	Lot Area:	6,000 sq	uare feet
7	Lot width:	60'-0"	Lot Depth:	100	0'-0"
8	Minimum Unit Size	Ren=400 New=800	Average Unit Size	Ren= 564	New= 771
9	Existing use:	Multifamily	Proposed use:	Mult	ifamily
	Zoning Information / Calculations	Maximum	Existing	Proposed	Deficiencie
10	Height	35'-0"	32'-8" (NGVD)	34'-6"	
11	Number of Stories	3	2	3	
12	FAR	1.25	0.43	0.61	
13	Gross square footage	N/A	5,563	7,476	
14	Square Footage by use	N/A			
15	Number of units Residential	10	6	7	
16	Number of units Hotel	N/A			
17	Number of seats	N/A			
18	Occupancy load	N/A		****	
	Setbacks	Required	Existing	Proposed	Deficiencie
	Subterranean:				
19	Front Setback:	N/A			
20	con con l	A174			

	Setbacks	Required	Existing	Proposed	Deficiencie
	Subterranean:				
19	Front Setback:	N/A			
20	Side Setback:	N/A			
21	Side Setback:	N/A			
22	Side Setback facing street:	N/A			
23	Rear Setback:	N/A			
	At Grade Parking:				
24	Front Setback:	20'-0"	0'-0"	11'-4"	8'-8"
25	Side Setback: (East)	5'-0"	10'-2"	9'-4"	1
26	Side Setback: (West)	5'-0"	N/A	N/A	
27	Side Setback facing street:	5'-0"	N/A	N/A	
28	Rear Setback:	10'-0"	46'-2"	70'-8"	
	Pedestal:				
29	Front Setback:	20'-0"	15'-0"	11'-4"	8'-8"
30	Side Setback: (East)	Min. 7'-6"	5'-0"	10'-0"	
31	Side Setback: (West)	5'-0" & 7'-6"	5'-0"	5'-0" & 7'-6"	
32	Side Setback facing street:	N/A	N/A	N/A	
33	Rear Setback:	10'-0"	4'-7"	5'-0"	5'-0"
	Tower:			T	T
34	Front Setback:	N/A			
35	Side Setback:	N/A			
TEM	Setbacks	Required	Existing	Proposed	Deficiencie:
36	Side Setback:				
37	Side Setback facing street:				1
38	Rear Setback:				L
	Parking	Required	Existing	Proposed	Deficiencie
39	Parking district				I
40	Total # of parking spaces	0	0	1	
41	# of parking spaces per use (Provide a	N/A			
-					-

Valet drop off and pick up	N/A			
		1		1
Loading zones and Trash collection area	See Site Plan	1 Dumpster		
Bicycle parking, location and # of racks	See Site Plan	7 Bicycles		
Restaurants, Cafes, Bars, Lounges,	Required	Existing	Proposed	Deficiencie
Type of use	N/A			
Number of seats located outside on	N/A			
Number of seats inside	N/A			
Total number of seats	N/A			
Total number of seats per venue	N/A			
Total occupant content	N/A			
Occupant content per venue (Provide a	N/A		***************************************	L
Proposed hours of operation	N/A			*************
Is this an NIE? (Neighboot Impact	N/A			
Is dancing and/or entertainment	N/A			
Is this a contributing building?		YE	S	
Located within a Local Historic District?		YE	S	
Additional data or information must be pr	esented in the forma	t outlined in this section	n	
	Restaurants, Cafes, Bars, Lounges, Type of use Number of seats located outside on Number of seats inside Total number of seats Total number of seats Total ocupant content Occupant content Occupant content per venue (Provide a Proposed hours of operation Is this an NIE? (Neighboot Impact Is dancing and/or entertainment Is this a contributing building? Located within a Local Historic District?	Restaurants, Cafes, Bars, Lounges, Type of use NyA Number of seats located outside on NyA Number of seats inside Total number of seats Total occupant content Occupant content Proposed hours of operation St dancing and/or entertainment St dancing and/or entertainment St his a contributing building? Located within a Local Historic District?	Bicycle parking, location and # of racks Restaurants, Cafes, Bars, Lounges, Type of use N/A Number of seats located outside on N/A Number of seats inside N/A Total number of seats per venue N/A Total oumber of seats per venue N/A Occupant content per venue (Provide a N/A Proposed hours of operation St this an NIE? (Neighboot Impact Is dancing and/or entertainment St his a contributing building? VE Located within a Local Historic District? Required Existing N/A N/A N/A St His a contributing building? YE Located within a Local Historic District?	Bicycle parking, location and # of racks Restaurants, Cafes, Bars, Lounges, Type of use N/A Number of seats located outside on N/A Number of seats inside N/A Total number of seats Total number of seats per venue N/A Total occupant content N/A Total occupant content per venue (Provide a N/A Total occupant content per venue (Provide a N/A St his a n NIE? (Neighboot Impact is dancing and/or entertainment N/A Is this a contributing building? YES

of parking spaces per level (Provide a

Parking Space configuration (45o, 60o, 45 ADA Spaces

Parking Space Dimensions

Tandem Space

Drive aisle widt

FAL R. DEPUTY ARCHITECT GODO URAL R. DEPUTY PC. PA

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Proposed Site & Building Improvements 622 15th Street

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DRAWING ISSUES

30 NOV 21 CITY STAFF REVIEW
03 JAN 22 FINAL HPB SUBMITTA

SCALE: 1/8" = 1'-0"


PROPOSED SITE PLAN

SP-1

SHEET 03 OF 28

15TH STREET BOB: N88°07'18"E 70' TOTAL RIGHT-OF-WAY 38' PAVEMENT 5' SIDEWALK DENOTES EXISTING EXTERIOR CONCRETE SLAB ON GRADE TO BE REMOVED IN ALL LOCATIONS. EXISTING CONSTRUCTION TO BE REPLACED WITH ORIGINAL TRIPARTITE WINDOW COMPOSITION W/ DOOR. SEE EX-6 16'-4' Ε ALL EXISTING WINDOWS IN FOURPLEX TO BE REMOVED & REPLACED WITH HURRICANE RATED PRODUCTS IN STYLES, SIZES, & COMPO-STIONS DERIVED FROM ORIGINAL DRAWINGS AS SHOWN ON ELEVATION SHEETS EX-6 & EX-7. TWO STORY C.B.S. BLDG.#622 EXISTING NON-HISTORIC STEEL STAIR TO BE E E is EXISTING DOOR AND NON-HISTORIC STAIRS TO BE REMOVED AND REPLACED PER ELEVATIONS SEE SHEET EX-6 EXISTING ELECTRICAL SHED TO BE REMOVED. ALL ELECTRICAL EQUIPMENT TO BE RELOCATED ABOVE BASE FLOOD ELEVATION EXISTING GARAGE BUILDING PROPOSED FOR DEMOLITION TWO STORY C.B.S. PROPÓSED FOR DEMOLÍTIONM

EXISTING GARAGE BUILDING PROPOSED FOR RECLASSIFICATION & DEMOLITION

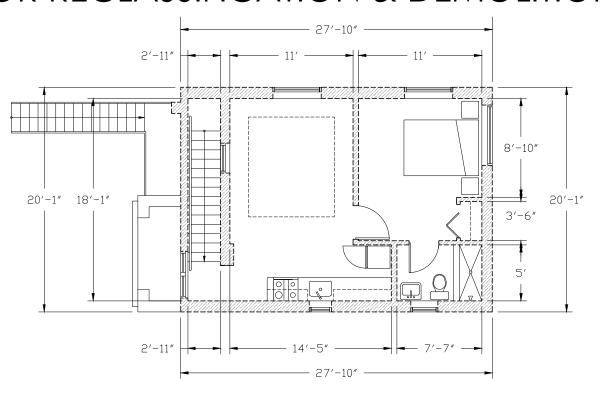

2 EXISTING SECOND FLOOR PLAN - GARAGE BUILDING

EX-1

27'-10'
27'-10'

19'

19'

8'-4"

12'-7"

9'-6"

31'-8"

3 EXISTING FIRST FLOOR PLAN - GARAGE BUILDING EX-1

JEAL R. DEPUTY ARCHIT ddo neal r. Deputy Pc. pa

CONSULTANT

R OF FLORO

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Existing Conditions Drawings For 622 15th Street

1/4" = 1'-0"

1/4" = 1'-0"

DRAWING ISSUES

0 NOV 21 CITY STAFF REVI 3 JAN 22 FINAL HPB SUBMITI

SCALE: AS NOTED


GARAGE BLD'G PLANS



SHEET 04 OF 28

60.00'

EXISTING GARAGE BUILDING PROPOSED FOR RECLASSIFICATION & DEMOLITION

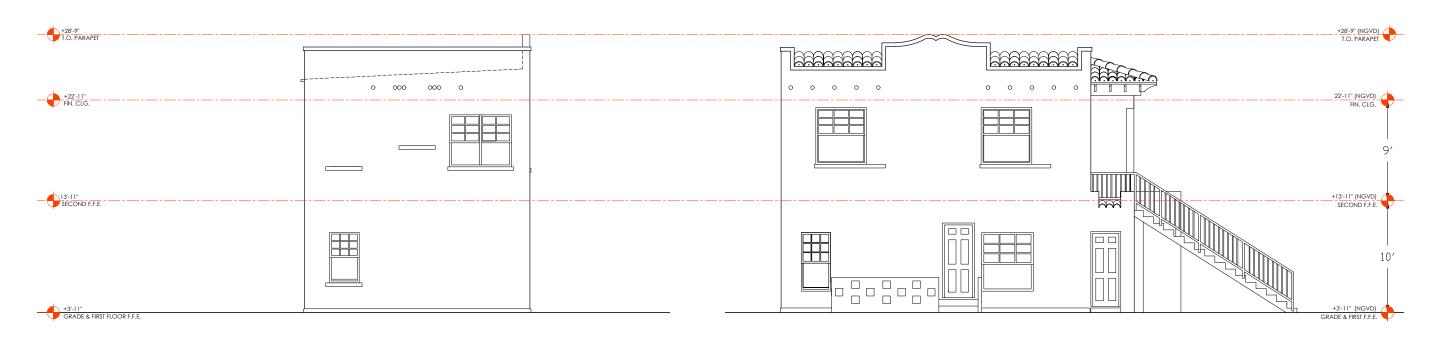

1 EXISTING EAST ELEVATION - GARAGE BUILDING

1/4" = 1'-0"

2 EXISTING NORTH ELEVATION - GARAGE BUILDING

1/4" = 1'-0"



3 EXISTING SOUTH ELEVATION - GARAGE BUILDING

1/4" = 1'-0"



EXISTING WEST ELEVATION - GARAGE BUILDING

1/4" = 1'-0"

NEAL R. DEPUTY ARCHITECT




Existing Conditions Drawings For 622 | 5th Street

DRAWING ISSUES
30 NOV 21 CITY STAFF REVIEW
03 JAN 22 FINAL HPB SUBMITTAL

SCALE: AS NOTED

GARAGE ELEVATIONS

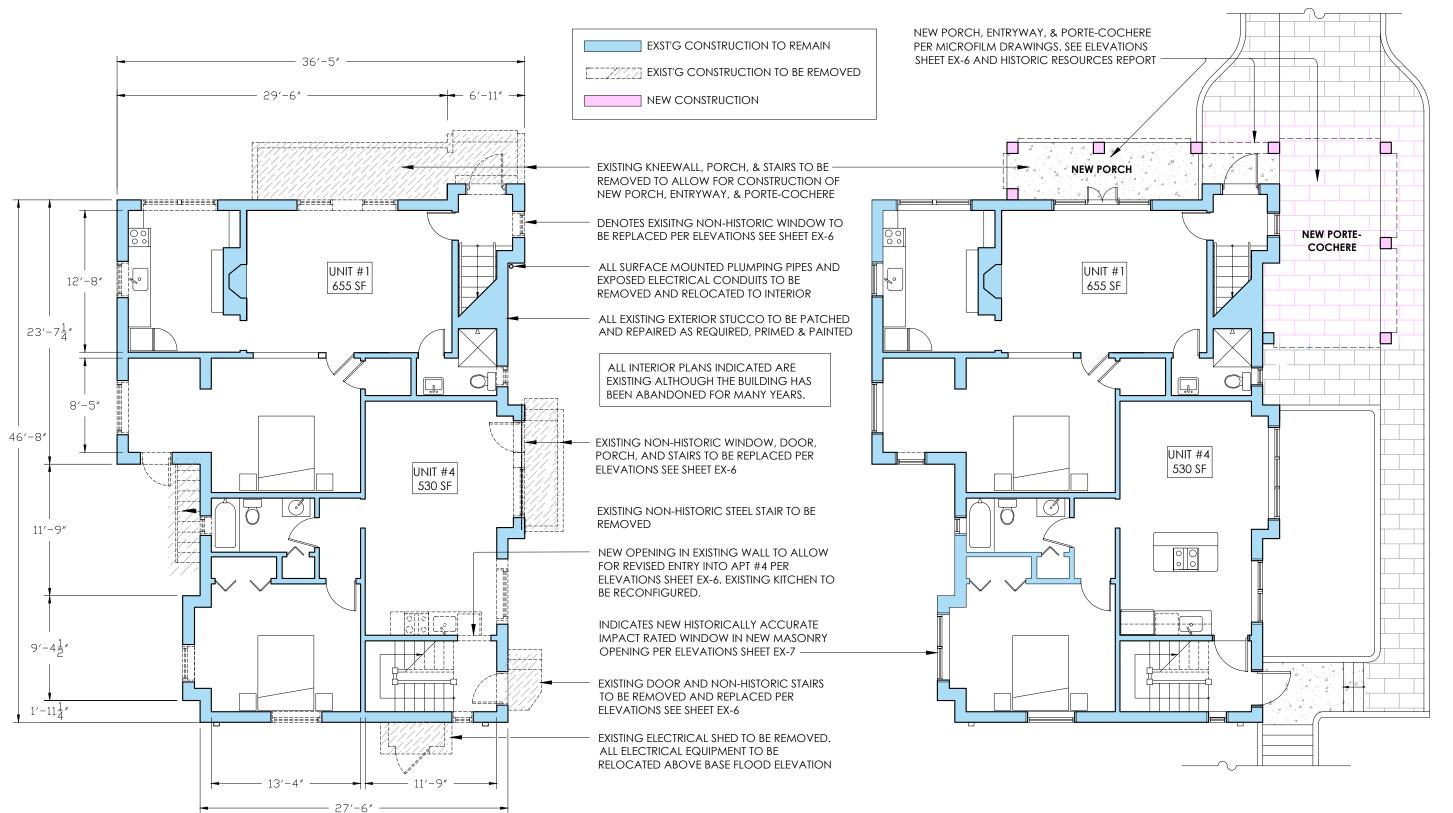

SAL R. DEPUTY ARCHITECT ABO NEAL R. DEPUTY PC, PA

CONSULTANT

SE OF FLORIDA

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ents for

Proposed Site & Building Improvements for 622 15th Street

DRAWING ISSUES
30 NOV 21 CITY STAFF REVIEW
03 JAN 22 FINAL HPB SUBMITTAL


SCALE: AS NOTED

EX-3

1 PROPOSED DEMOLITION- FIRST FLOOR PLAN

EX-3

PROPOSED RENOVATIONS- FIRST FLOOR PLAN

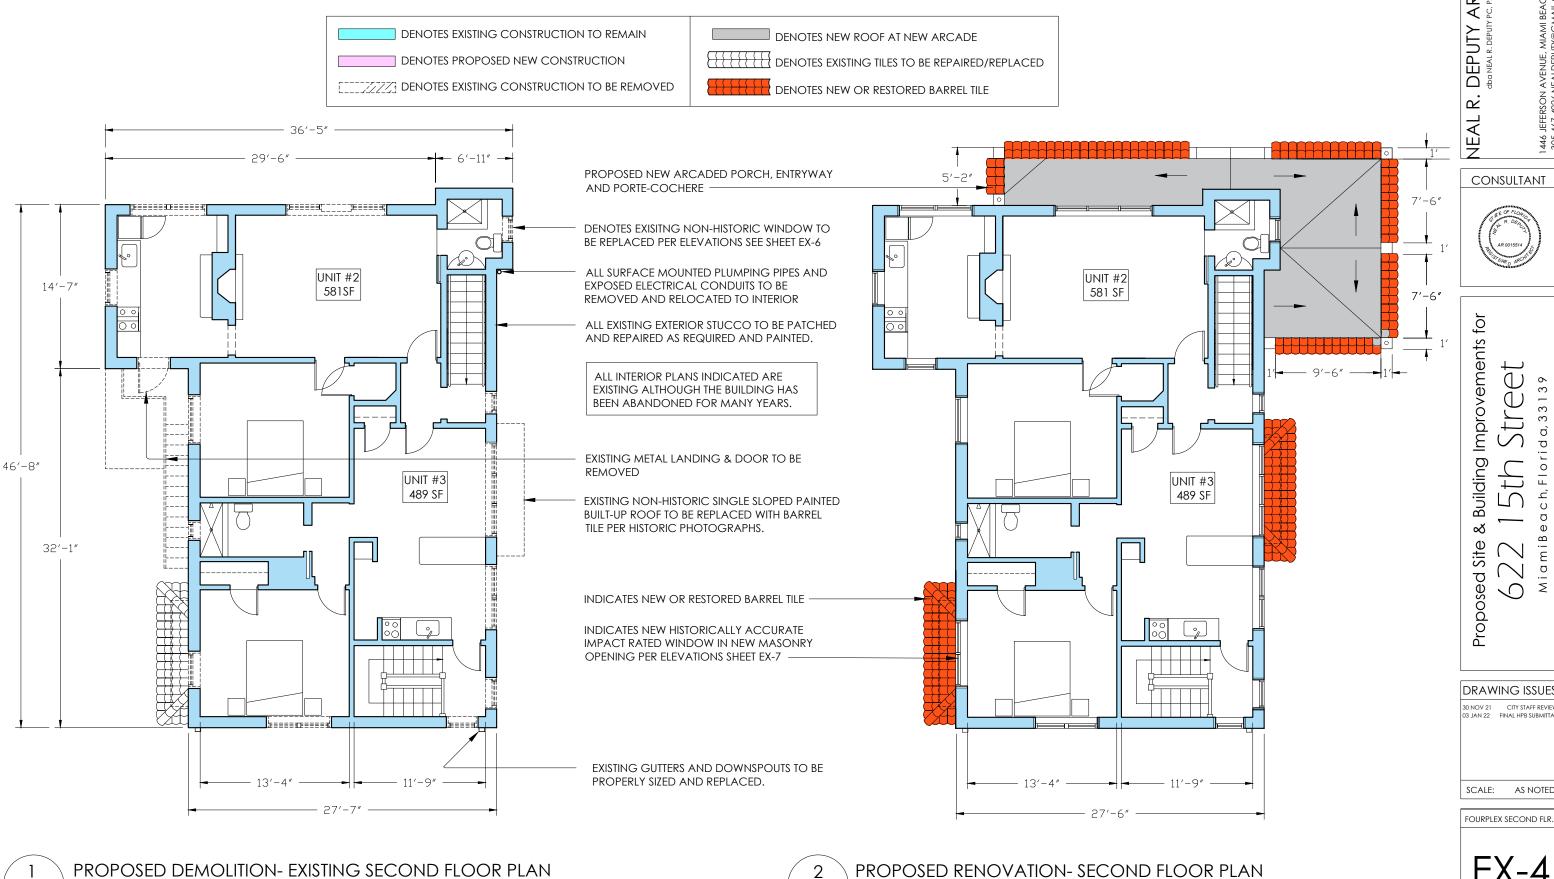


ARCHITECT DEPUTY, CONSULTANT for **Building Improvements** Ū


∞ Site Proposed

DRAWING ISSUES 30 NOV 21 CITY STAFF REVIEW 03 JAN 22 FINAL HPB SUBMITTAL

SCALE: AS NOTED

1/8" = 1'-0"

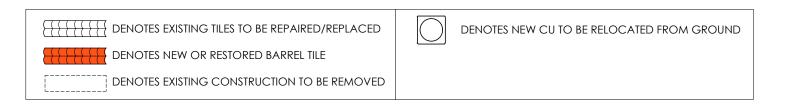

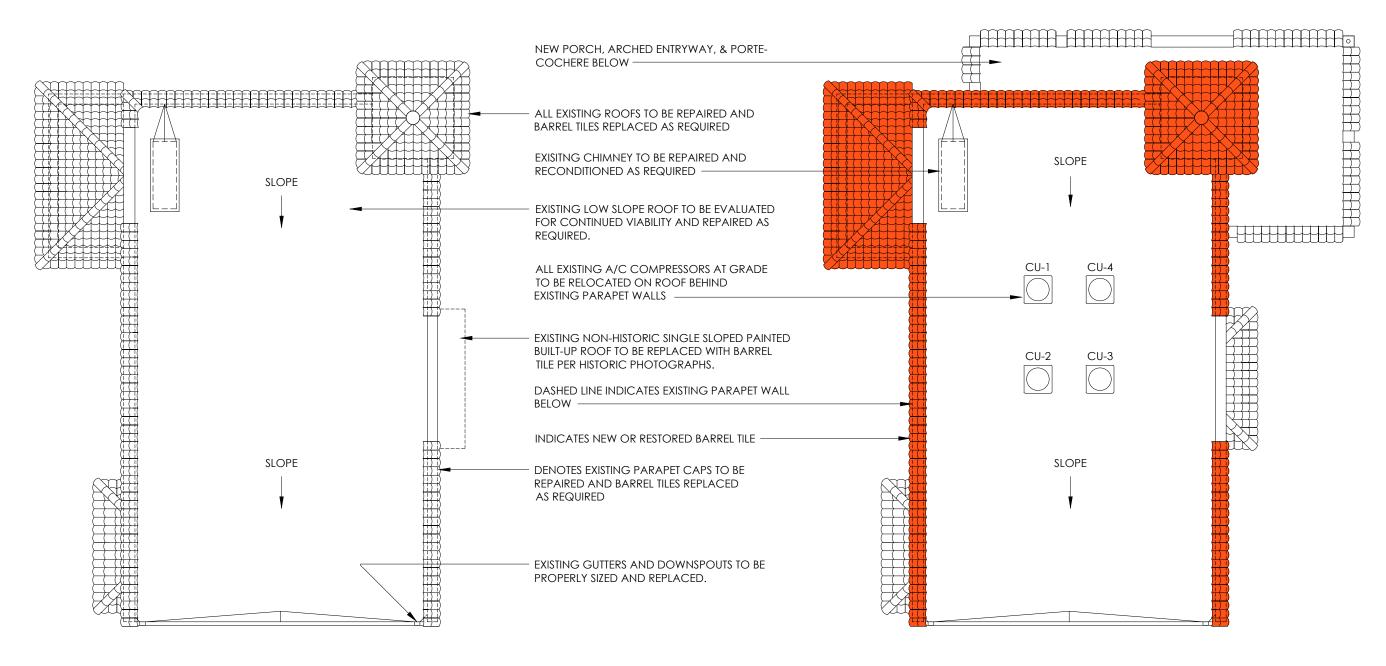

Ď Improvements th Street 7, Florida, 33139 **Building** I ∞ Proposed Site

ch,

ARCHITECT PC, PA

R. DEPUTY

CONSULTANT

PROPOSED DEMOLITION- ROOF PLAN EX-5

1/8" = 1'-0"


PROPOSED RENOVATION- ROOF PLAN

1/8" = 1'-0"

DRAWING ISSUES 30 NOV 21 CITY STAFF REVIEW

SCALE: AS NOTED

FOURPLEX ROOF PLAN

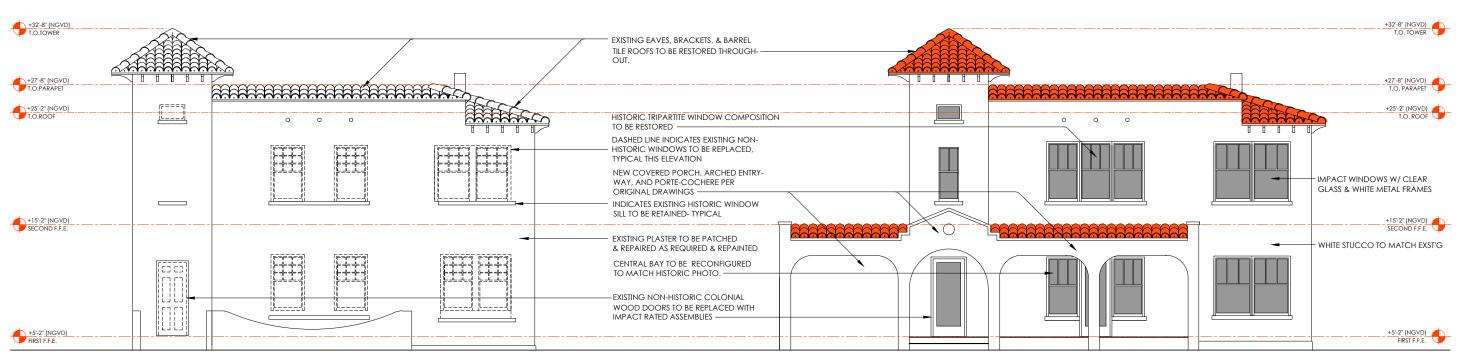


1 EXISTING NORTH ELEVATION - FOURPLEX

1/8" = 1'-0"

PROPOSED NORTH ELEVATION - FOURPLEX

1/8" = 1'-0"

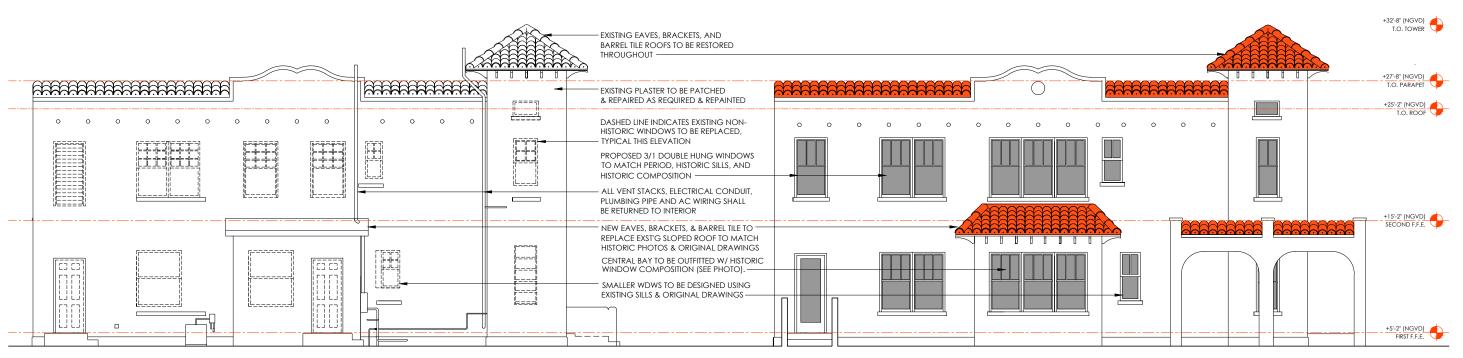

3 EXISTING EAST ELEVATION - FOURPLEX EX-6

EX-6

1/8" = 1'-0"

PROPOSED EAST ELEVATION - FOURPLEX

1/8'' = 1'-0''

NEAL R. DEPUTY ARCHITECT

1446 JEFERSON AVENUE, MIAMI BEACH, FLORIDA 33139 305-467-4026 NEALDEPUTY®GMAIL.COM FL# 0015514

CONSULTANT

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Proposed Site & Building Improvements fo 622 15th Street

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ch, Flor

MiamiB

DRAWING ISSUES

30 NOV 21 CITY STAFF REVIEW
03 JAN 22 FINAL HPB SUBMITTAL

SCALE: 1/4" =

EX-6

EXISTING ELEVATIONS



1 EXISTING SOUTH ELEVATION - FOURPLEX


EX-7

1/8" = 1'-0"

PROPOSED SOUTH ELEVATION - FOURPLEX

EX-7

1/8" = 1'-0"

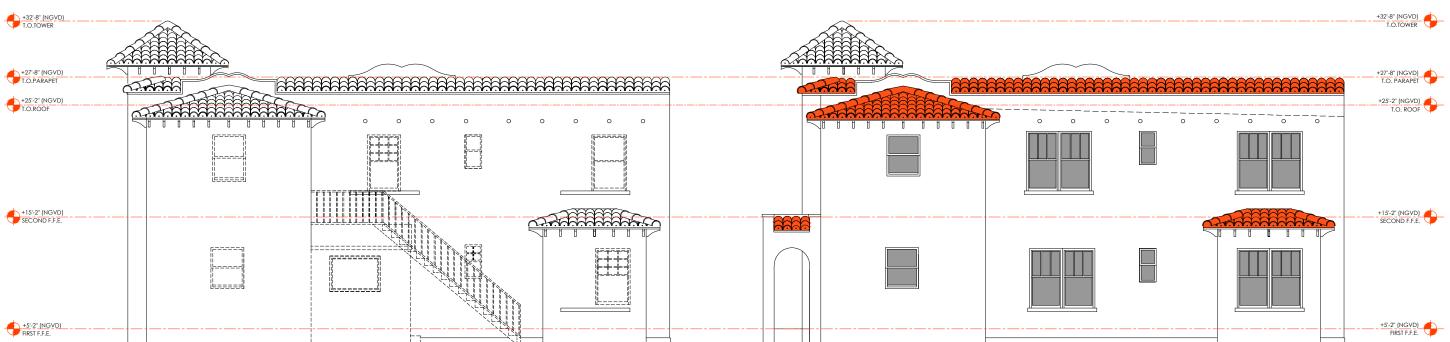

EX-7

3 EXISTING WEST ELEVATION - FOURPLEX EX-7

'-0''

PROPOSED WEST ELEVATION - FOURPLEX

1/8" = 1'-0"

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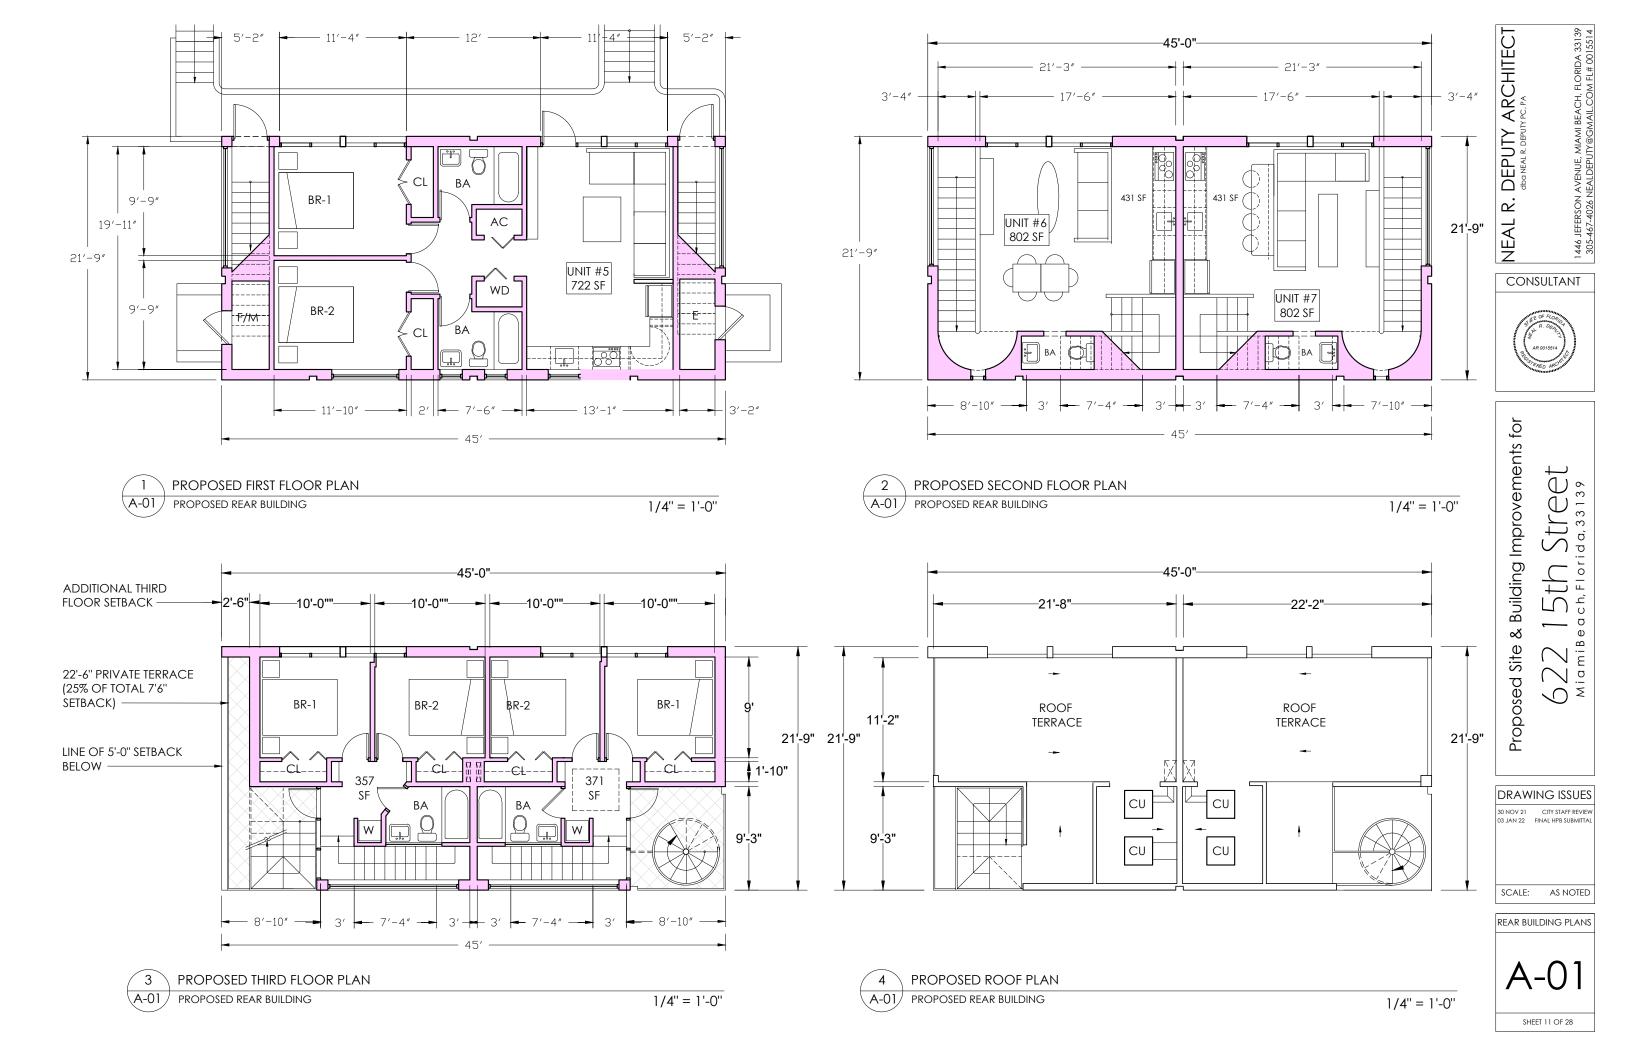
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Proposed Site & Building Improvements fo 622 15th Street


DRAWING ISSUES
30 NOV 21 CITY STAFF REVIEW
03 JAN 22 FINAL HPB SUBMITTAL


SCALE: 1/4" = 1'-0"


EXISTING ELEVATIONS






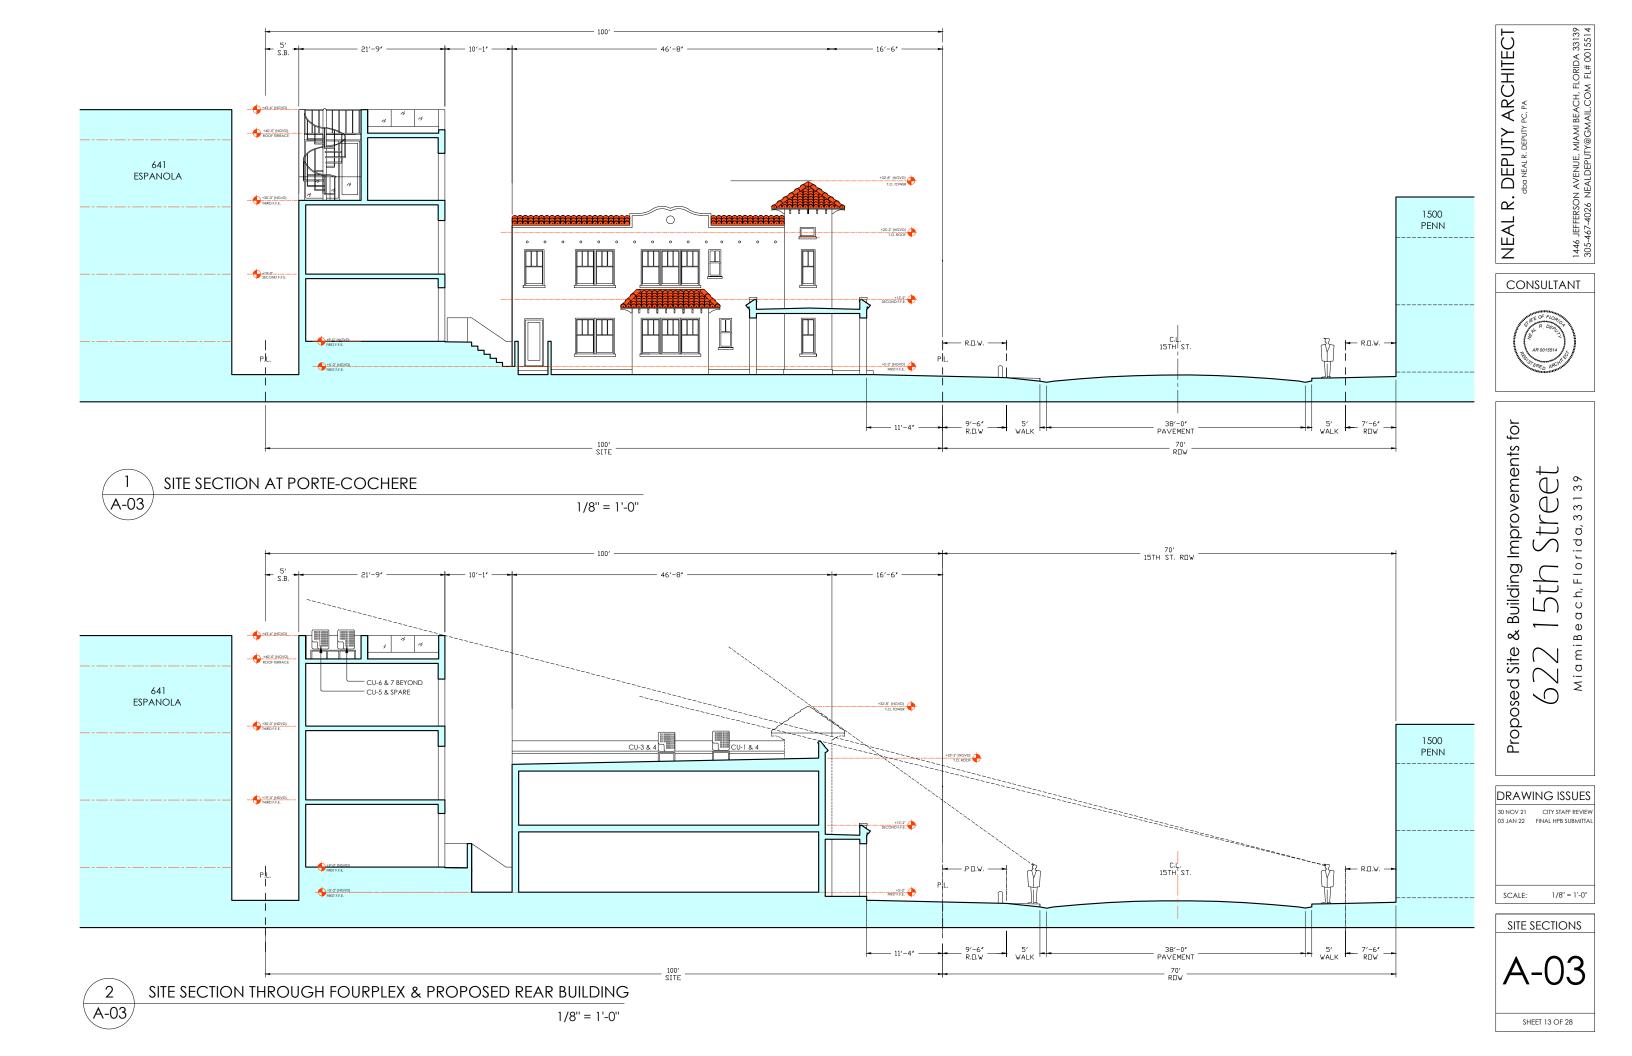

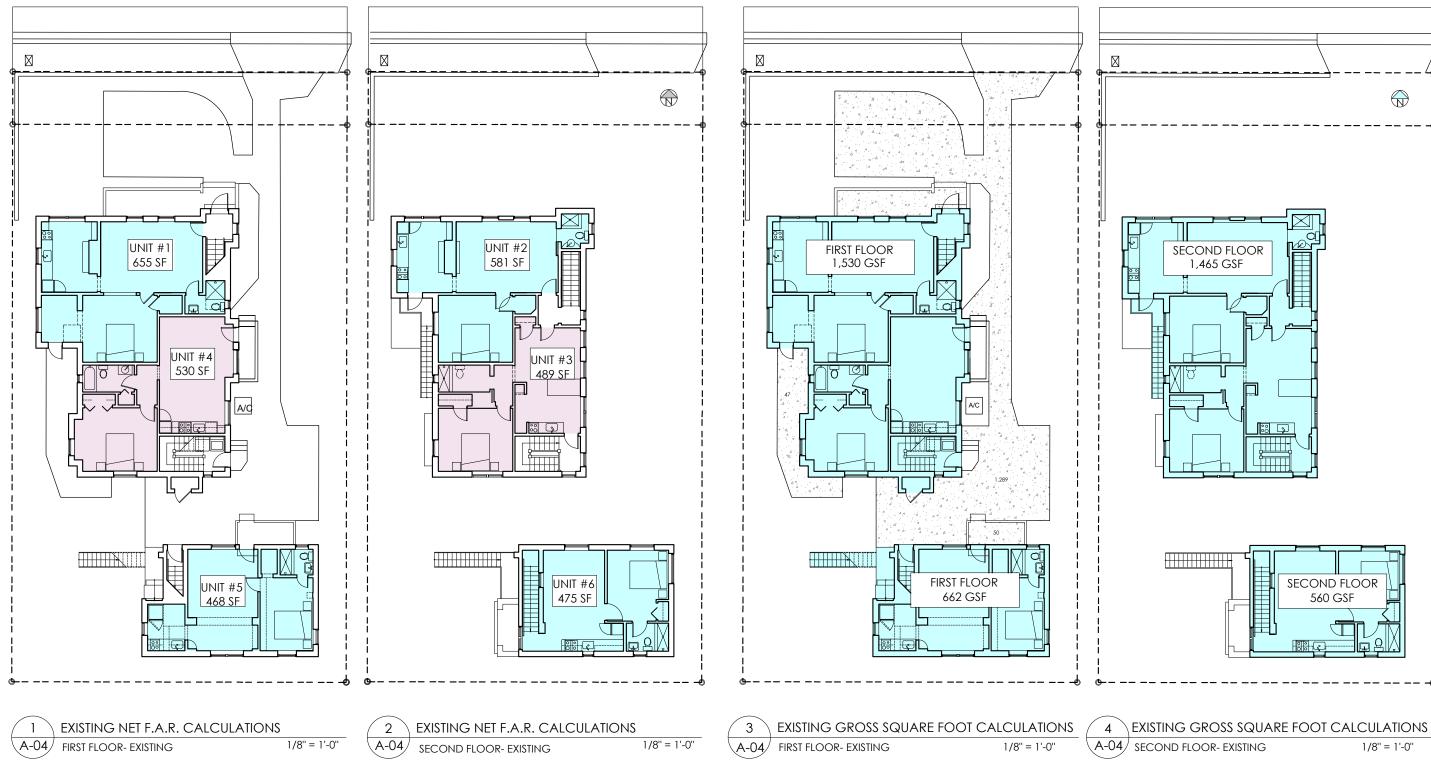

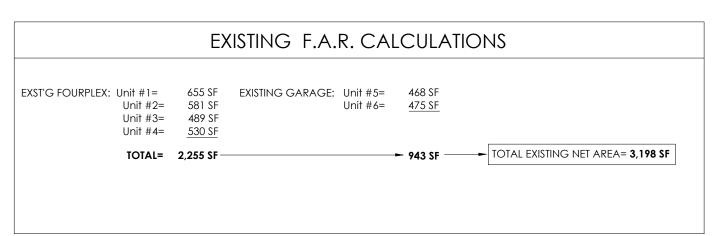

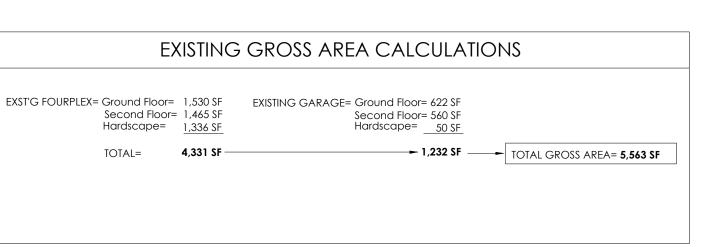

ARCHITECT DEPUTY, œ

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Building Improvements for ∞ Proposed Site 9

SECOND FLOOR

560 GSF

1/8" = 1'-0"


DRAWING ISSUES

SCALE: AS NOTED

BLD'G AREA DIAGRAMS

SHEET 14 OF 28



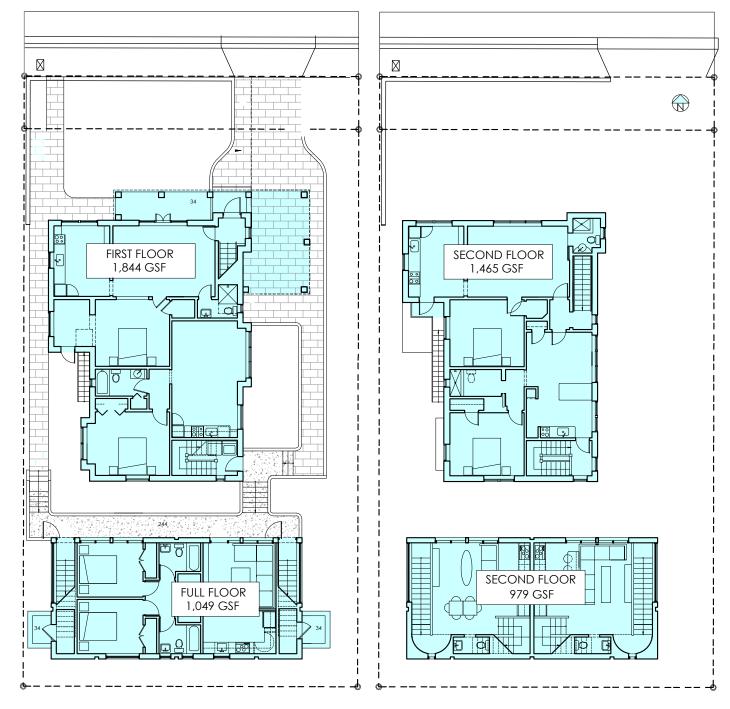

PROPOSED NET F.A.R. CALCULATIONS

GROUND FLOOR- PROPOSED

\A-05

PROPOSED NET F.A.R. CALCULATIONS

SECOND & THIRD FLOOR -PROPOSED

PROPOSED GROSS SF CALCULATIONS A-05 GROUND FLOOR- PROPOSED

SECOND FLOOR- PROPOSED

PROPOSED GROSS SF CALCULATIONS

1/8" = 1'-0"

POPOSED F.A.R. CALCULATIONS

RENO FOURPLEX= Unit #1= 655 SF 581 SF Unit #2=

PROPOSED BUILDING= Unit #5= 722 SF 788 SF Unit #6= Unit #7= 802 SF PROPOSED NET FLOOR AREA = 4,581 SF

PROPOSED F.A.R= 4,581/7,500= **0.61**

TOTAL= 2,255 SF

Unit #3=

Unit #4=

Average Renovated Unit =

489 SF

530 SF

Average New Unit Size=

771 SF

TOTAL= 2,312 SF

SEE DRAWING SHEET A-04 FOR EXISTING FAR CALCULATIONS

PROPOSED GROSS AREA CALCULATIONS

PROPOSED BUILDING= Ground Floor= 1,049 SF RENO FOURPLEX= Ground Floor= 1,844 SF Second Floor= 1,465 SF Second Floor= 979 SF Hardscape= 34 SF Third Floor=

974 SF 819 SF Roof = Hardscape= 312 SF

3,343 SF TOTAL=

4,133 SF TOTAL=

TOTAL GROSS AREA= 7,476 SF

SEE DRAWING SHEET A-04 FOR EXISTING GROSS AREA CALCULATIONS

DRAWING ISSUES

ARCHITECT PC.PA

NEAL R. DEPUTY

for

Building Improvements

∞

Proposed Site

CONSULTANT

BLD'G AREA DIAGRAMS



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STUDIO ARTH
Tel: 857-928-1937
email: info@studioarth.com
www.studioarth.com

TOA INVESTMENT LLC

PROPOSED SITE REDEVELOPMENT

622 15 TH STREET, MIAMI BEACH, FLORIDA 33139

Revision No. Description Date

Project Status: HPB21-0495 FIRST SUBMITTAL 03-08-2022



Rituparna Simlai LA6667403 Drawing Name

LANDSCAPE PLAN

Scale	
Project Number	20101
Issue Date	11/11/2021
Checked By	RS
Drawing No	



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TOA INVESTMENT LLC

PROPOSED STE REDEVELOPMENT

622 15 TH STREET, MIAMI BEACH, F_ORIDA 33139

No.	Description	Date

Project Status: HPB21-0495 FIRST SUBMITTAL 03-08-2022



Rituparna Simlai LA6667403 Drawing Name

PLANTING PLAN

Scale	
Project Number	20101
Issue Date	11/11/2021
Cnecked By	RS
Drawing No	



Myrcianthes fragrans Simpson's Stopper




Caesalpinia ferrea Leopard Tree




Simarouba glauca Paradisa Tree




Gymnanthes lucida Crabwood

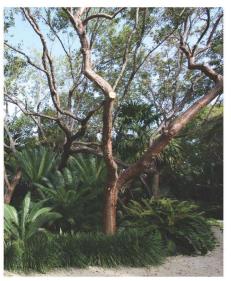

Bursera simaruba Gumbo Limbo

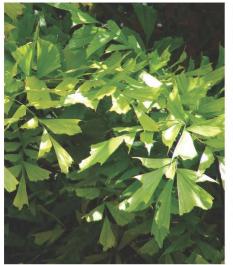

Caryota mitis Fishtail Palm

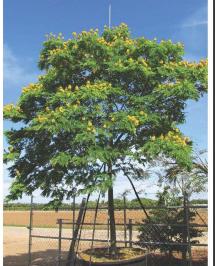

Bulnesia arborea Verawood



Alpinia purpurata Red Ginger

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TOA INVESTMENT LLC

PROPOSED SITE REDEVELOPMENT

622 15 TH STREET, MIAMI BEACH, FLORIDA 33139

No.	Description	Date

Project Status: HPB21-0495 FIRST SUBMITTAL 03-08-2022

Digitally signed by RITUPARNA



Drawing Name


Date: 2021.12.29 11:37:00 -05'00' Ritupama Simlai LA6667403

Scale Project Number 20101 11/11/2021 Issue Date

Checked By Drawing No





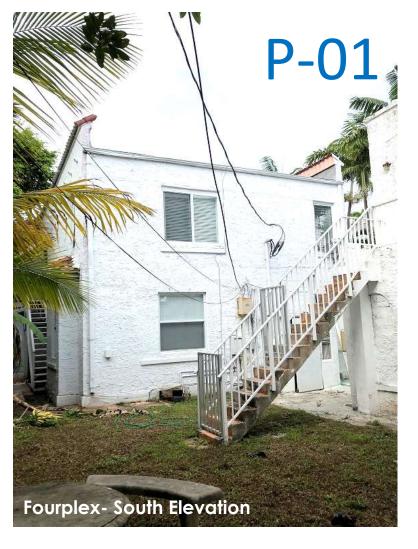




Fourplex- West Elevation


Existing Fourplex at Street- Photos
Proposed for Renovation







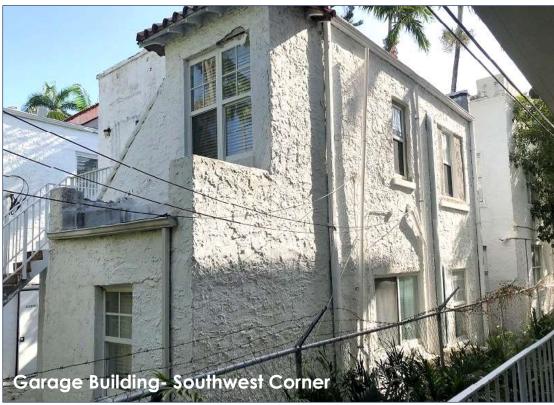

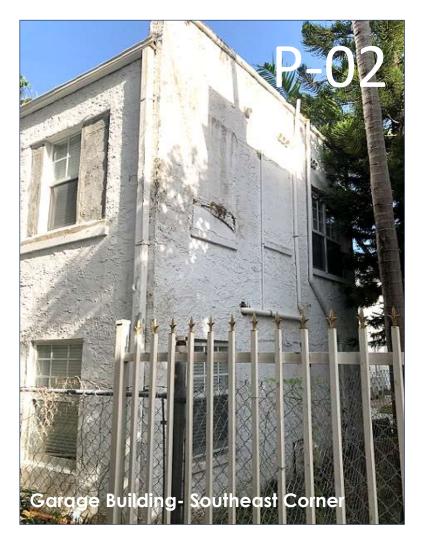




Existing Garage Building at Rear-Photos
Proposed for Reclassification, Demolition, & Replacement





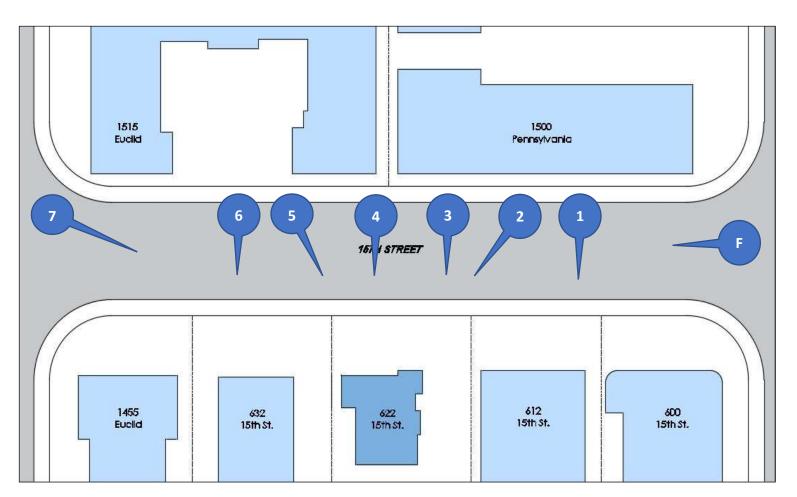













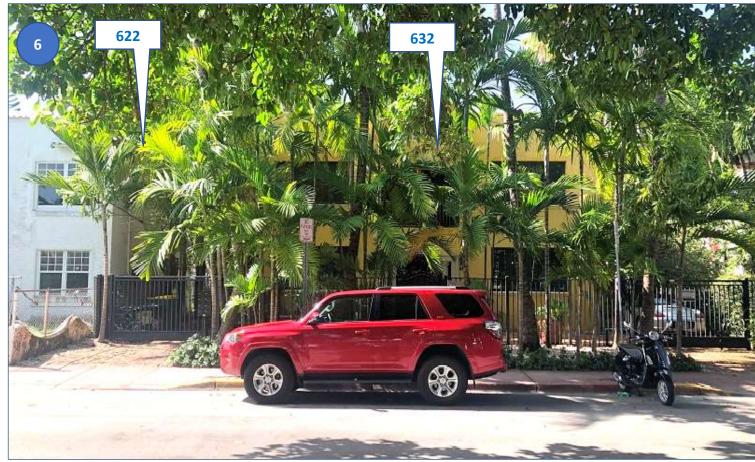



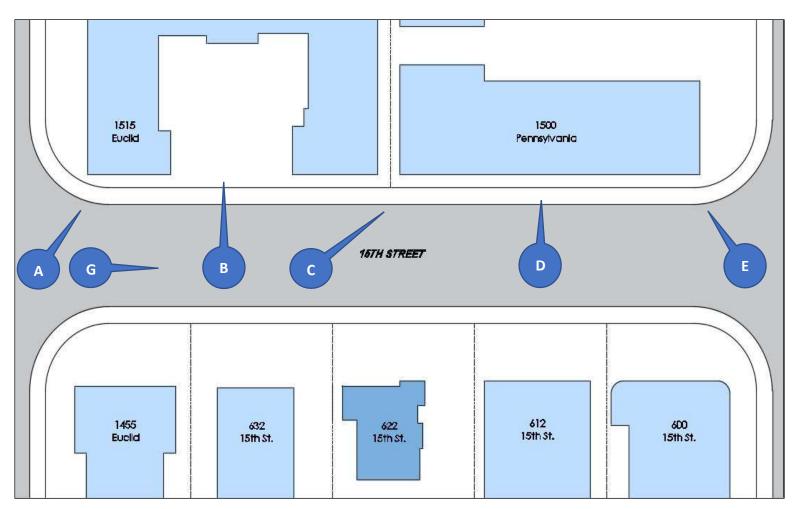















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& Building Improvements for

DRAWING ISSUES

SCALE: AS NOTED

3D SITE DIAGRAMS

T-01

SHEET 27 OF 30

T-01



VIEW FROM NORTHEAST SHOWING PROPOSED RENOVATIONS TO 622 15TH ST & NEW BUILDING AT REAR

NO SCALE

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DRAWING ISSUES

SCALE: N.T.S.

PERSPECTIVE RENDERING

T-02

SHEET 25 OF 28



NO SCALE

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Proposed Site & Building Improvements for eet Miami

DRAWING ISSUES

SCALE:

PERSPECTIVE RENDERING

N.T.S

SHEET 27 OF 28

VIEW OF ENTRY PROMENADE SHOWING PROPOSED RENOVATIONS TO 622 15TH ST & NEW BUILDING AT REAR T-03

NEAL R. DEPUTY ARCHITECT abo NEALR. DEPUTY PC, PA

CONSULTANT

DRAWING ISSUES

PERSPECTIVE RENDERING

T-04

SHEET 28 OF 28

PRIMARY ELEVATION FROM 15TH ST SHOWING PROPOSED ARCADED PORCH, ENTRYWAY, AND PORT-COCHERE NO SCALE