## SIDELNIK-CUNIOLO RESIDENCE

## 2360 ALTON ROAD MIAMI BEACH, FL 33140

# DESIGN REVIEW BOARD FINAL LANDSCAPE SUBMITTAL (DRB22-0789) 03/07/2022

	INDEX OF DRAWINGS							
	DESCRIPTION							
	(DESIGN REVIEW BOARD LANDSCAPE SUBMITTAL)							
1	L-0.00	LANDSCAPE INDEX						
2	L-0.01	LANDSCAPE NOTES						
3	L-0.02	LANDSCAPE CALCULATIONS						
4	L-0.03	LANDSCAPE IMAGES						
5	L-1.00	TREE DISPOSITION PLAN						
6	L-1.01	TREE MITIGATION PLAN						
7	L-1.10	GROUND LEVEL RENDERED PLAN						
8	L-1.11	GROUND LEVEL LANDSCAPE PLAN						
9	L-5.00	GROUND LEVEL PLANTING DETAILS						
10	L-6.00	DISPOSITION AND MITIGATION SCHEDULES						
11	L-6.10	GROUND LEVEL LANDSCAPE SCHEDULES						
12	IR-1.00	GROUND LEVEL IRRIGATION PLAN						
13	IR-5.00	GROUND LEVEL IRRIGATION DETAILS						



Alberti Studio
Architecture
+
Planning
+
Interiors

www.albertistudio.com

copies, transmissions, reproductions, or electronic manipulation of any portion of these drawings in whole or in part are to be made ithout the express written permission of Alberti Studio. All designs indicated in these drawings are property of Alberti Studio. DESIGN REVIEW BOARD SUBMITTAL

SIDELNIK-CUNIOLO RESIDENCE

2360 ALTON RD. MIAMI BEACH FL. 33140



DRAWING TITLE

LANDSCAPE INDEX

DATE DRB FINAL SUBMITTAL (DRB22-0789) MARCH 7,

SCALE Drawing No.

L-0.00

#### GENERAL NOTES

- These plans reflect the scope of the Landscape Architect external services. For Architectural, Civil, Lighting please refer to the appropriate consultant documents.
- The locations of all site amenities are approximate and may be adjusted in the field with owner and/or their representatives approval. See plans for locations of fixed amenities.
- The locations of plants, as shown in these plans, are approximate. The final locations may be adjusted to accommodate unforeseen field conditions to comply with safety criteria, to avoid creating unsafe sight conditions, or as otherwise directed by or approved by the landscape architect or owner's representative.
- 4. Construction shall comply with all local building codes
- All dimensions shall be verified in the field prior to construction. Written dimensions shall take precedence over scaled drawings.
- 6. If a discrepancy should arise between layout geometry and design intent, design intent shall take precedence
- 7. A Tree Protection Plan shall be provided prior to the issuance of a building permit.
- 8. A Tree Care & Watering plan shall be submitted prior to the issuance of a building permit.
- All existing and proposed utilities will be verified prior to the issuance of a building permit, and will be adequately screened from sight by landscape materials.

#### GENERAL GRADING NOTES

- All grading information outside the below grade parking decks provided is intended for aesthetic purposes and to show relationships only. For detailed grading information see Civil Engineers drawings.
- Rough grading and site preparation shall be completed for review by Landscape Architect / or owners representative prior to final grading.
- 3. Roadway grading and transition areas to be reviewed and approved by Civil / Traffic Engineer.
- 4. Grading and calculations for retention areas to be provided by Civil Engineers.
- Contractor shall not substantially modify grading plan without the approval of designer. All site aesthetic grading is subject to review and approval of the landscape architect or owner's representative.
- Contours for earth mounds shall be smooth, continuous arcs. Side slopes shall be smooth and even in transition and void of depressions. Careful attention should be given to the grading plans concerning the shapes and formations of proposed slopes.
- 7. All graded areas shall be dragged with a drag mat or hand radeel to blend in small imperfections and round off any sharp lines that may have been constructed by equipment. All areas to be planted shall have no water holding pockets.

#### IRRIGATION NOTES

- All landscaped areas within the property shall be irrigated with automatic irrigation system which shall utilize well and/or domestic water supply.
- Irrigation system shall be equipped with rain sensor.
- Irrigation system shall provide 100% coverage. Plans will be submitted prior to the issuance of a building permit.

#### GENERAL LANDSCAPE NOTES

- 1. The Contractor shall be responsible for verifying all underground utilities prior to digging in any area. The contractor shall notify all necessary utility companies 48 hours minimum prior to digging for verification of all underground utilities, irrigation and all other obstructions and coordinate with Owner's Representative prior to initiating operations. Drawings are prepared according to the best information available at the time of preparing documents.
- The contractor is responsible to ensure proper watering and maintenance of new and relocated plant materials during the one year warranty period.
- Contractor is to report any discrepancies between the construction drawings and field conditions to the Owner's Persecutative immediately.
- 4. Landscape Contractor shall coordinate all work with related contractors and with the general construction of the project in order not to impede the progress of the work of others or the contractor's own work. Landscape contractor shall provide schedule of his/her work two weeks in advance, beginning two weeks prior to commencing landscape trade construction.
- 5. The location of the landscape holding area will be identified by the Owner or Owner's Representative. The Contractor shall adhere to the access routes to and from the holding area without disrupting or impeding access to the site by others. Contractor is responsible for the maintenance of all plant materials, including temporary irrigation and fertilization if necessary during construction, while being held in landscape holding areas.
- The Contractor shall bear all costs of testing of soils, amendments, etc. associated with the work and included in the specifications. Prior to commencement of the landscape planting work the Contractor shall provide complete soil tests with recommendations for soil treatment in the construction area.
- 7. Landscape Contractor shall field stake the location of all plant material or field stake the plants prior to initiating installation for the review and approval of the Owner's representative and/or Landscape Architect. Note: No planting shall commence until there is a functional irrigation system in the area to be planted. No trees shall be planted on top of irrigation lines.
- Landscape Contractor shall field adjust location of plant material as necessary to avoid damage to all
  existing underground utilities and/ or existing above ground elements. All changes required shall be
  completed at the Contractor's expense and shall be coordinated with Owner's Representative and the
  landscape Architect.
- 9. Any substitutions in size and/or plant species must be approved by the Landscape Architect or Owner's Representative prior to modification of the contract, purchasing and delivery of plants. All plants will be subject to approval by Landscape Architect and/or Owner's Representative before planting can begin. All plant materials will not include any olants considered to be invasive by the City of Miami Beach.
- Contractor shall refer to the landscape planting details, general notes and the project manual and/or specifications for further and complete landscape planting instructions.
- 11. Landscape Contractor shall coordinate all planting work with permanent or temporary irrigation work. Landscape Contractor shall be responsible for all hand watering as required by Owner's Representative to supplement irrigation watering and rainfall. Landscape Contractor shall be responsible for hand watering in all planting areas, regardless of the status of existing or proposed irrigation.
- 12. Landscape Contractor shall clean the work areas at the end of each working day. Rubbish and debris shall be collected and deposited off-site or in an approved disposal area daily. All materials, products and equipment shall be stored in an organized fashion as directed by the Owner's Representative.
- 13. Landscape Contractor shall re-grade all areas disturbed by plant removal, relocation and/or installation work. Landscape Contractor shall replace (by equal size and quality) any and all existing or new plant material disturbed or damaged by plant removal, relocation, and/or installation work.
- 14. Site distance concerns must be maintained for clear site visibility from thirty (30) inches to seventy-two (72) inches, tree trunks are excluded as specified in appropriate municipal codes.
- 15. Guying / staking practices shall not permit nails, screws, wires, etc., to penetrate outer surface of any tree or palm. Trees or palms rejected due to this practice shall be replaced at the Contractor's expense
- 16. Burlap material, wire cages, plastic straps, etc., must be cut and removed from top one-third (1/3) of root ball
- 17. Trees grown in grow bags or grow bag type material are not allowed.
- 18. All planting materials shall meet or exceed local requirements as specified by local plant standards.
- All landscape installations shall meet or exceed the minimum requirements as shown in appropriate municipal codes.
- 20. The Contractor shall be responsible for the guarantee of all plant material for a period of twelve (12) months from the date of substantial completion. Substantial completion constitutes the beginning of ouarantee period.
- 21. Plant size specifications take precedence over container size.
- 22. Contractor to verify quantities and report any discrepancies to Owners representative and/or Landscape Architect.
- 23. All plant material shall be graded Florida #1 or better.

#### SOIL PREPARATION AND SOIL MIX

- All plants noted for removal shall be relocated as shown on plans or removed and properly disposed of
  offsite at contractors expense unless otherwise noted.
- Before finishing top soil grading, scarify & rake subsoil clear of stones (1" diameter and larger), debris rubbish, and remaining roots from removed plant material to a depth of 6".
- 3. Plant holes should be dug and the sides and bottom of the hole should be stable, regardless of depth. Soil scarification is necessary if sides of the hole are compacted.
- Contractor to apply approved pre-emergent herbicide in accordance with manufacturer's rate and specifications. Contractors to provide manufacturer's specifications for approval.
- Planting soil mix for planters, trees, shrubs, and ground cover & grasses shall be determined by soil analysis prior to planting landscape.

The planting soil mix should be what comes out of the hole so the plant adapts to the surrounding/existing soil and grows into it. This is why the sides and the bottom of the planting hole should never be compacted with the digging implements. Never fertilize newly planted plants and trees. Please note that peat moss will eventually decompose and clog soil pores thereby inhibiting the plants water and oxygen consumption.

- 6. Topsoil shall be natural, fertile, agricultural soil capable of sustaining vigorous plant growth. It shall be of uniform composition throughout, with admixture of subsoil, it shall be free of stones, lumps, live plants and their roots, sticks, and other extraneous material. Top soil brought in should match as well as possible the existing soil texture and Ph. Planted material should never be "mounded" or raised; the soil will eventually wash away exposing the roots and it will be difficult to establish the plant material due to drought and excessive soil transpiration. All plant/tree material should be installed with the root collar exposed (approximately 1/2" to1"). Landscape contractor should find the uppermost lateral root and plant that just below the soil surface.
- 7. Smooth topsoil without compaction to two inches (2") below finish grade in areas to be sodded without compaction
- Finish grade all topsoil areas to a smooth non-compacted, even surface assuring positive drainage away from the structures and eliminate any low areas except in retention areas where water may collect.
- 9. Contractor to remove debris and excess material immediately from job site while keeping in mind that heavy equipment will compact soil to the detriment of water drainage and the health of the newly installed plants. All planting areas with compacted soil will have surfaces scarified to a min. of 6" in depth.


#### PLANTING SPECIFICATIONS

- The contractor is responsible for maintaining, in full, all planting areas (including watering, spraying, mulching, mowing, fertilizing, etc.) Until the job is accepted, in full, by the owner, its representative and Landscape Architect.
- 2. All plant material shall be protected during transport and delivery to final location with shade cloth or other acceptable means of windburn prevention. Plant/tree material shall conform to Florida # 1 as described in Florida grades & standards, the lastest issue.
- 3. All trees must be guyed or staked as shown in details.
- 4. When plant material is delivered onsite, it shall not be laid down for more than two hours. Plant material when stored onsite shall be placed and maintained in good condition in a vertical position. All plants held onsite shall be kept watered regularly in sufficient amounts to permit continuous and vigorous growth.
- 5. Installation of all plant material shall be installed in a sound, workmanlike manner and according to accepted good planting and tree relocation procedures with the quality of plant materials as hereinafter described. All elements of landscaping shall be installed so as to meet all applicable ordinances and code requirements.
- There shall be no chains or cables used directly on trees or palms, handle with 2" minimum width nylon straps or equal.
- 7. Contractor shall assure drainage and percolation of all planting pits. Prior to installation of plant material, contractor shall fill all tree pits with water before planting to assure that proper drainage and percolation is available. Correct if required to assure percolation. Contractor is responsible for replacement of all plants lost due to inadequate drainage conditions. Plant/tree material that has bark scraped off due to shipping, handling, and installation issues may be rejected upon inspection by the L.A.
- Contractor to request inspection of project in writing. If all work is satisfactory and complete in accordance with conditions of contract documents, then the owner, its representative, and landscape architect shall declare the project substantially complete.
- $9. \ Substantial \ completion \ constitutes \ the \ beginning \ of \ guarantee \ period.$
- 10. Contractor to replace rejected plant within two (2) weeks of notice.
- 11. Crown pruning of any trees or palms is generally not approved by the national arborist association standards. When it is approved, it must be done in writing.
- 12. Xeriscaping principles as outlined in the South Florida Water Management District Xeriscape Plant Guide 2 shall be applied throughout landscape installation and maintenance.

#### DRAWING ORGANIZATION

1. DRAWING NUMBERING SYSTEM

THE DRAWING NUMBER FOR EACH SHEET CONSISTS OF THE FOLLOWING:

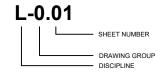

#### 2. DRAWING GROUP

LANDSCAPE DRAWINGS ARE ORGANIZED INTO THE FOLLOWING GROUPS:

L-0 = GENERAL

L-1 = PLANS L-2 = ELEVATIONS

L-2 = ELEVATION

L-3 = SECTIONS L-4 = ENLARGEMENTS

L-5 = DETAILS

L-6 = SCHEDULES

#### 3. SHEET NUMBER

EACH DRAWING SHEET WITHIN EACH GROUP/MULTIPLE SHALL BE NUMBERED SEQUENTIALLY FROM 01 TO 99.

4. DRAWING NUMBER EXAMPLES:

L-0.01 LANDSCAPE INDEX

DESIGN REVIEW BOARD SUBMITTAL

SIDELNIK-CUNIOLO RESIDENCE

2360 ALTON RD. MIAMI BEACH FL. 33140



LANDSCAPE NOTES

DATE DRB FINAL SUBMITTAL (DRB22-0789) MARCH 7, 2022 SCALE

\_-0.01

Alberti Studio

Architecture

Planning

Interiors

www.albertistudio.com



Zoning District:	RS 4	Lot Area:	0.17 Acres	7,305 s.f.							
OPEN SPACE				REQUIRED/	PROVIDED						
A. Square feet of requ	A. Square feet of required Open Space, as indicated on site plan:										
Lot Area = 7,305			·.	5,114	5,115						
LAWN AREA CALCU	II ATION										
A. Maximum lawn are	a (sod) permitted	50 % x <u>5,</u>	115 s.f.	2,558	2,043						
TREES											
A. Number of trees re	quired per lot, less e	existing number of trees									
meeting minimum	•	7 Lot trees minimum									
	lot (front yard)		isting trees	2	3						
3 trees per	lot (backyard)	minus <u>0</u> ex	isting trees	3	4						
B. Palms allowed in ac	ddition to tree requi	rement:		0	0						
C. % Natives required:	: Number of trees p	rovided x 30% =		2	6						
D. % Drought tolerant	and low maintenan	ce:									
Number of trees pr	ovided x 50% =			4	7						
E. Street Trees (maxin	num average spacin	g of 20' o.c.):									
60 linear fee	et along street /	20 =		3	3						
Palms permitted to	count in addition to	street trees on 1:1 bas	s:	0	0						
F. Street trees located	d directly beneath po	ower lines: (maximum a	verage								
spacing of 20' o.c.):	0 linear fe	et along street / 20	) =	0	0						
G. Diversity of tree spe	ecies required:			2	3						
<u>SHRUBS</u>											
A. Number of shrubs r	required: Number of	f site + street trees requ	ired x 12 =	120	160						
B. % Native shrubs red	quired: Number of s	hrubs provided x 50% =		80	157						
LADGE CUDURG (CA	AALL TREEC										
LARGE SHRUBS/SM											
A. Number of large sh	rubs/small trees red	quired: 10% of required:	shrubs	12	64						
B. % Native large shru	bs/small trees requi	ired: 50% or provided		32	64						

Alberti Studio
Architecture
+
Planning
+
Interiors

www.albertistudio.com

opies, transmissions, reproductions, or electronic manipulation of y portion of these drawings in whole or in part are to be made out the express written permission of Alberti Studio. All designs indicated in these drawings are property of Alberti Studio. DESIGN REVIEW BOARD SUBMITTAL

SIDELNIK-CUNIOLO RESIDENCE

2360 ALTON RD. MIAMI BEACH FL. 33140



DRAWING TITLE

LANDSCAPE CALCULATIONS

DATE DRB FINAL SUBMITTAL (DRB22-0789) MARCH 7, 1

ALE wing No.

L-0.02



COCOS NUCIFERA COCONUT PALM



EXISTING TREE - 30' HEIGHT SWIETENIA MAHAGONI WEST INDIAN MAHOGANY



VEITCHIA MERRILLII CHRISTMAS PALM



TREE - 20' HEIGHT BURSERA SIMARUBA **GUMBO LIMBO** 



TREE - 16' HEIGHT COCCOLOBA DIVERSIFOLIA PIGEON PLUM



TREE - 12' HEIGHT MYRCIANTHES FRAGRANS SIMPSONS STOPPER



SHRUB - 2.5' HEIGHT AGAVE AMERICANA CENTURY PLANT



SHRUB - 2.5' HEIGHT ALCANTAREA ODORATA SILVER BROMELIAD



SHRUB - 6' HEIGHT EUGENIA FOETIDA SPANISH STOPPER



SHRUB - 2' HEIGHT PSYCHOTRIA LIGUSTRIFOLIA BAHAMA COFFEE



GROUNDCOVER - 1' HEIGHT ZAMIA PUMILA COONTIE



GROUNDCOVER - 1' HEIGHT NEPHROLEPIS EXALTATA **BOSTON FERN** 



GROUNDCOVER - 1' HEIGHT MUHLENBERGIA CAPILLARIS MUHLY GRASS



GROUNDCOVER - 1' HEIGHT PEPEROMIA OBTUSIFOLIA BABY RUBBER PLANT



GROUNDCOVER - 1' HEIGHT SPARTINA PATENS CORDGRASS



STENOTAPHRUM SECUNDATUM 'PALMETTO' ST. AUGUSTINE PALMETTO



MULCH TYPE: MINI PINE BARK COLOR: NATURAL



AGGREGATE TYPE: SLATE CHIPS COLOR: GRAY

Alberti Studio Architecture Planning Interiors


www.albertistudio.com

DESIGN REVIEW BOARD SUBMITTAL SIDELNIK-CUNIOLO RESIDENCE 2360 ALTON RD. MIAMI BEACH FL. 33140



LANDSCAPE IMAGES

L-0.03

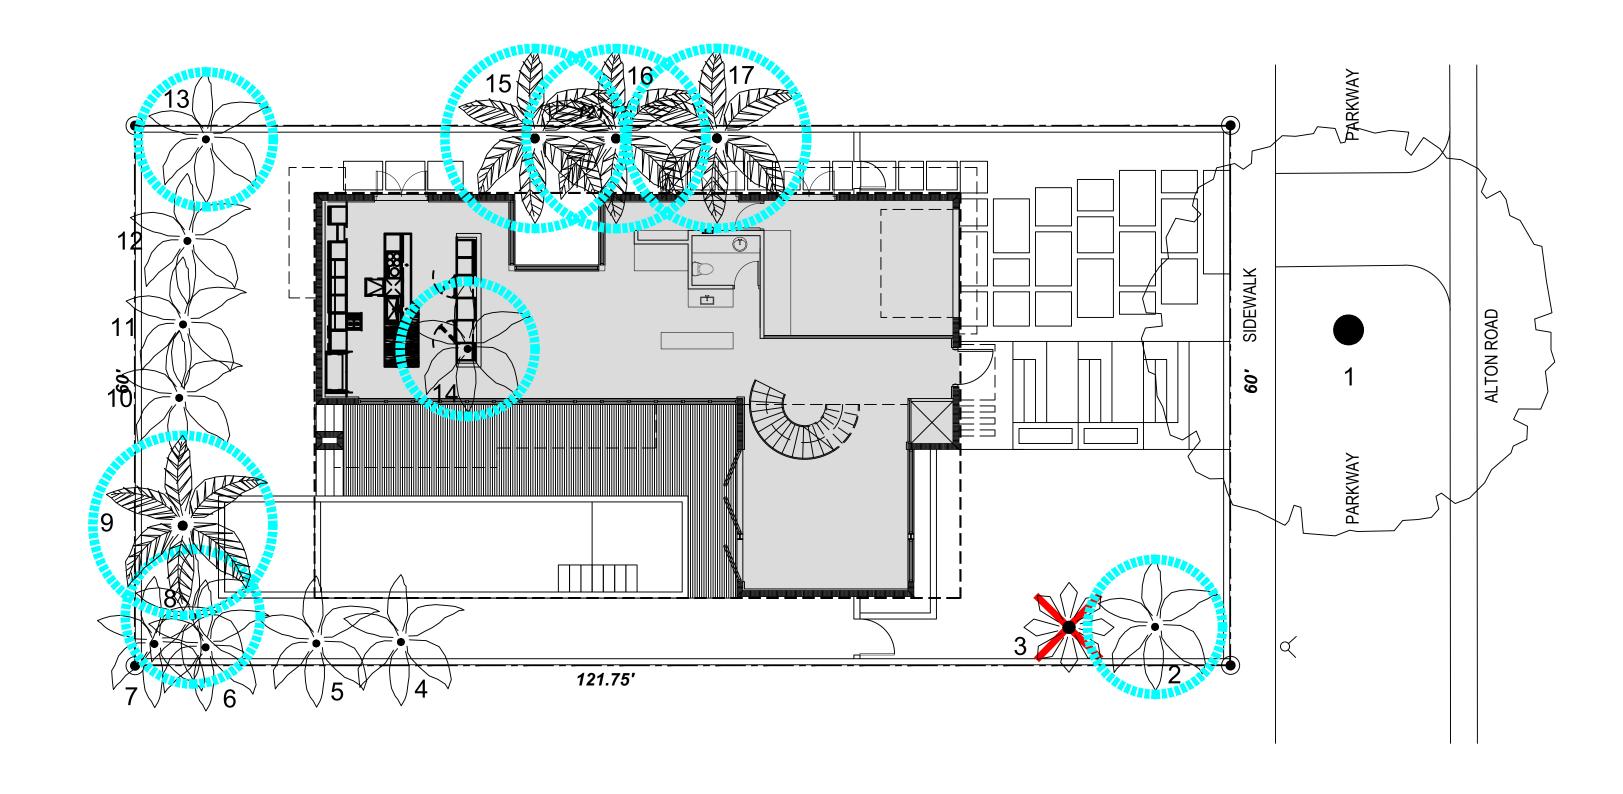

Alberti Studio

+

Planning +

Interiors

www.albertistudio.com

copies, transmissions, reproductions, or electronic manipulation any partian of these drawings in whole or in part are to be made tithout the express written permission of Alberti Studio. All designs indicated in these drawings are property of Alberti Studio. DESIGN REVIEW BOARD SUBMITTAL

SIDELNIK-CUNIOLO RESIDENCE

2360 ALTON RD. MIAMI BEACH FL. 33140




DRAWING HILE

TREE DISPOSITION PLAN

DATE DRB FINAL SUBMITTAL (DRB22-0789) MARCH 7

CALE gwing No

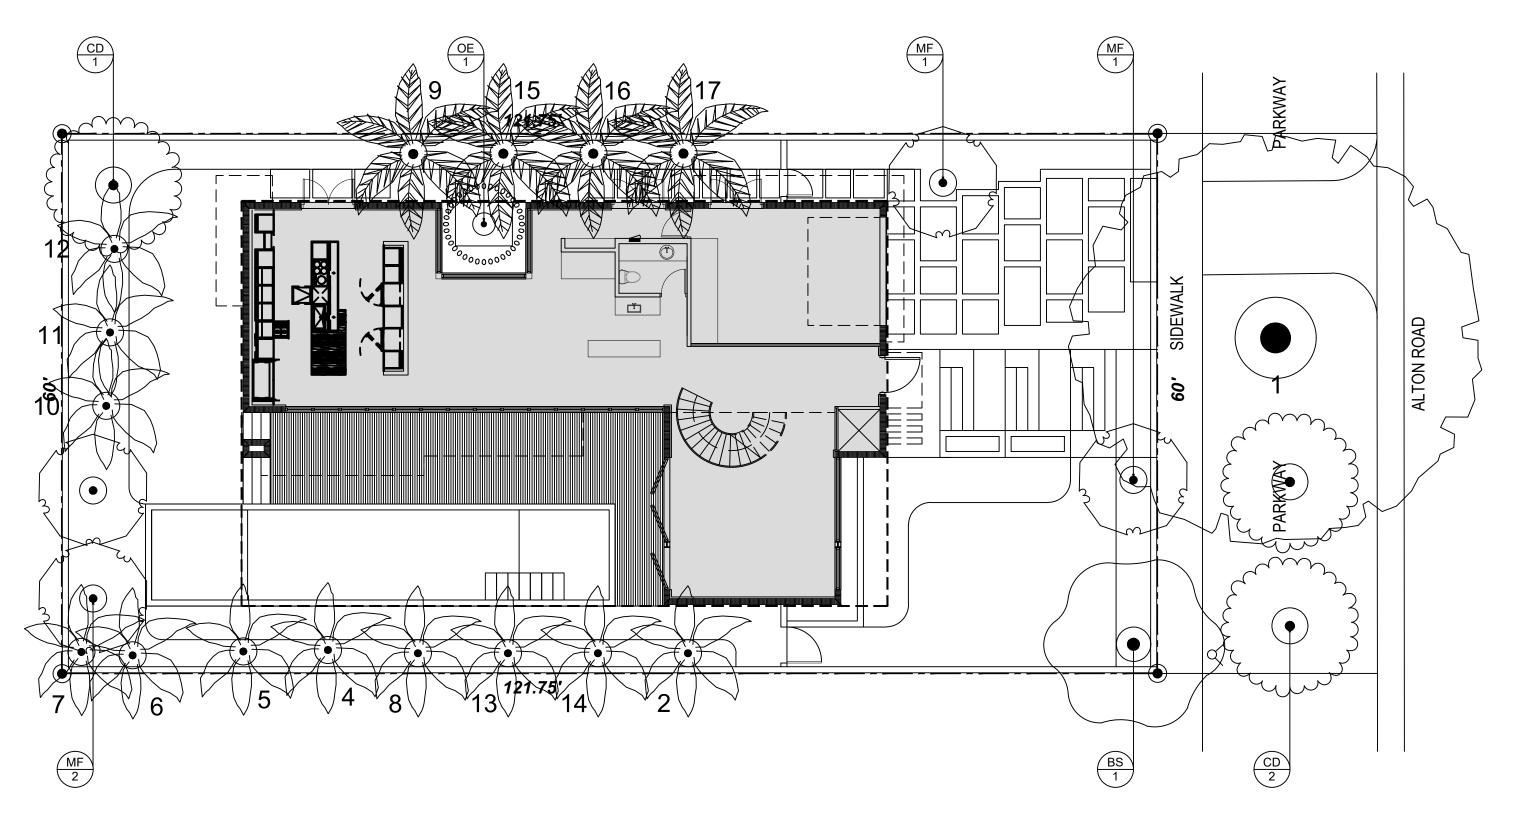

Alberti Studio

Architecture

Planning

Interiors

www.albertistudio.com


DESIGN REVIEW BOARD SUBMITTAL

SIDELNIK-CUNIOLO RESIDENCE

2360 ALTON RD. MIAMI BEACH FL. 33140



TREE MITIGATION PLAN

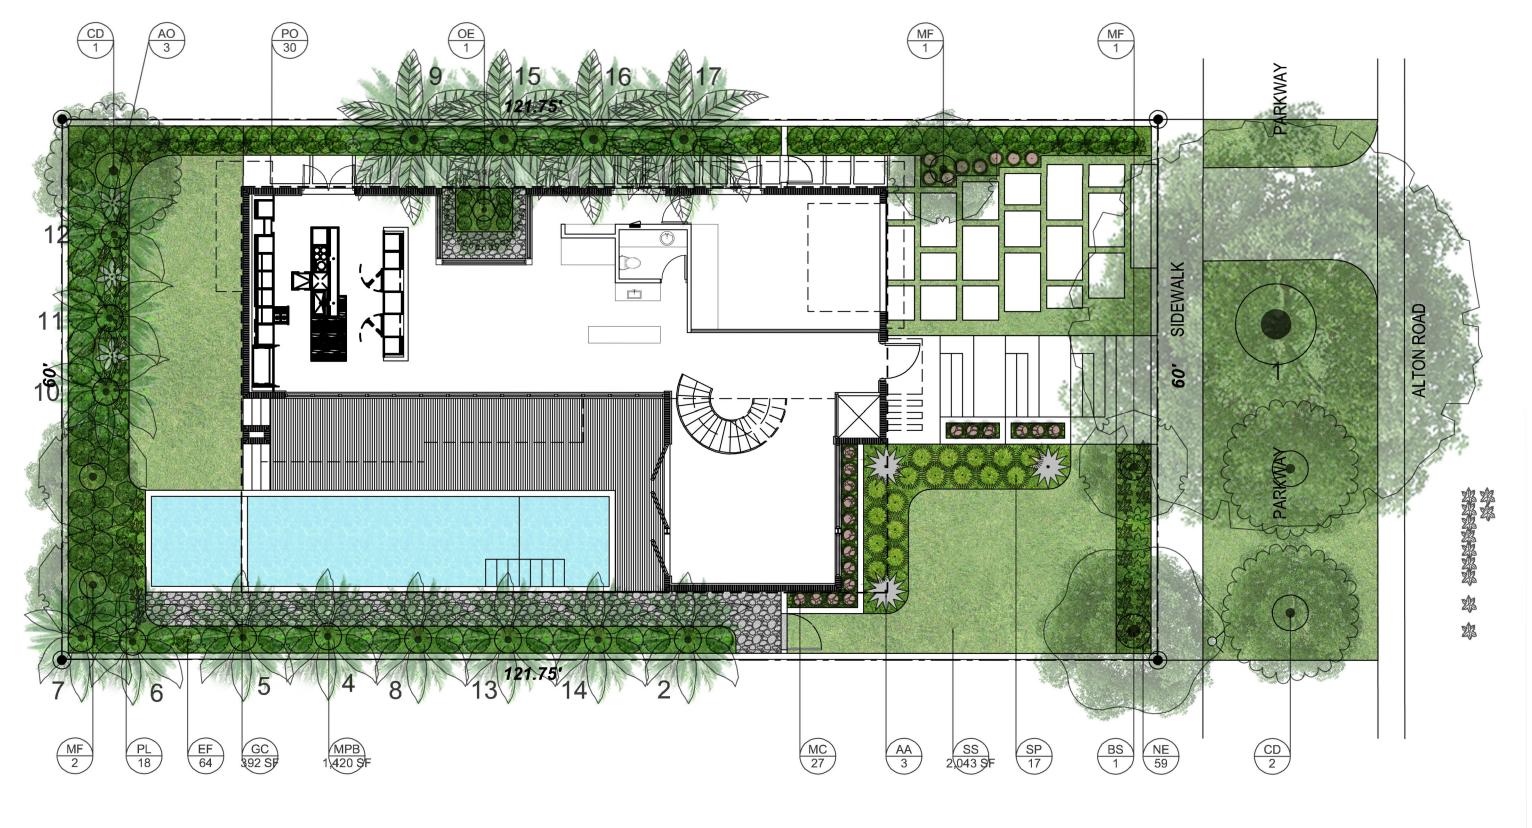

Alberti Studio
Architecture

Planning + Interiors

www.albertistudio.com

copies, transmissions, reproductions, or electronic manipulation or any portion of these drawings in whole or in part are to be made ithout the express written permission of Alberti Studio. All designs indicated in these drawings are property of Alberti Studio. DESIGN REVIEW BOARD SUBMITTAL

SIDELNIK-CUNIOLO RESIDENCE

2360 ALTON RD. MIAMI BEACH FL. 33140




DRAWING TITLE

RENDERED PLAN

DRB FINAL SUBMITTAL (DRB22-0789) MARCH 7,

CALE

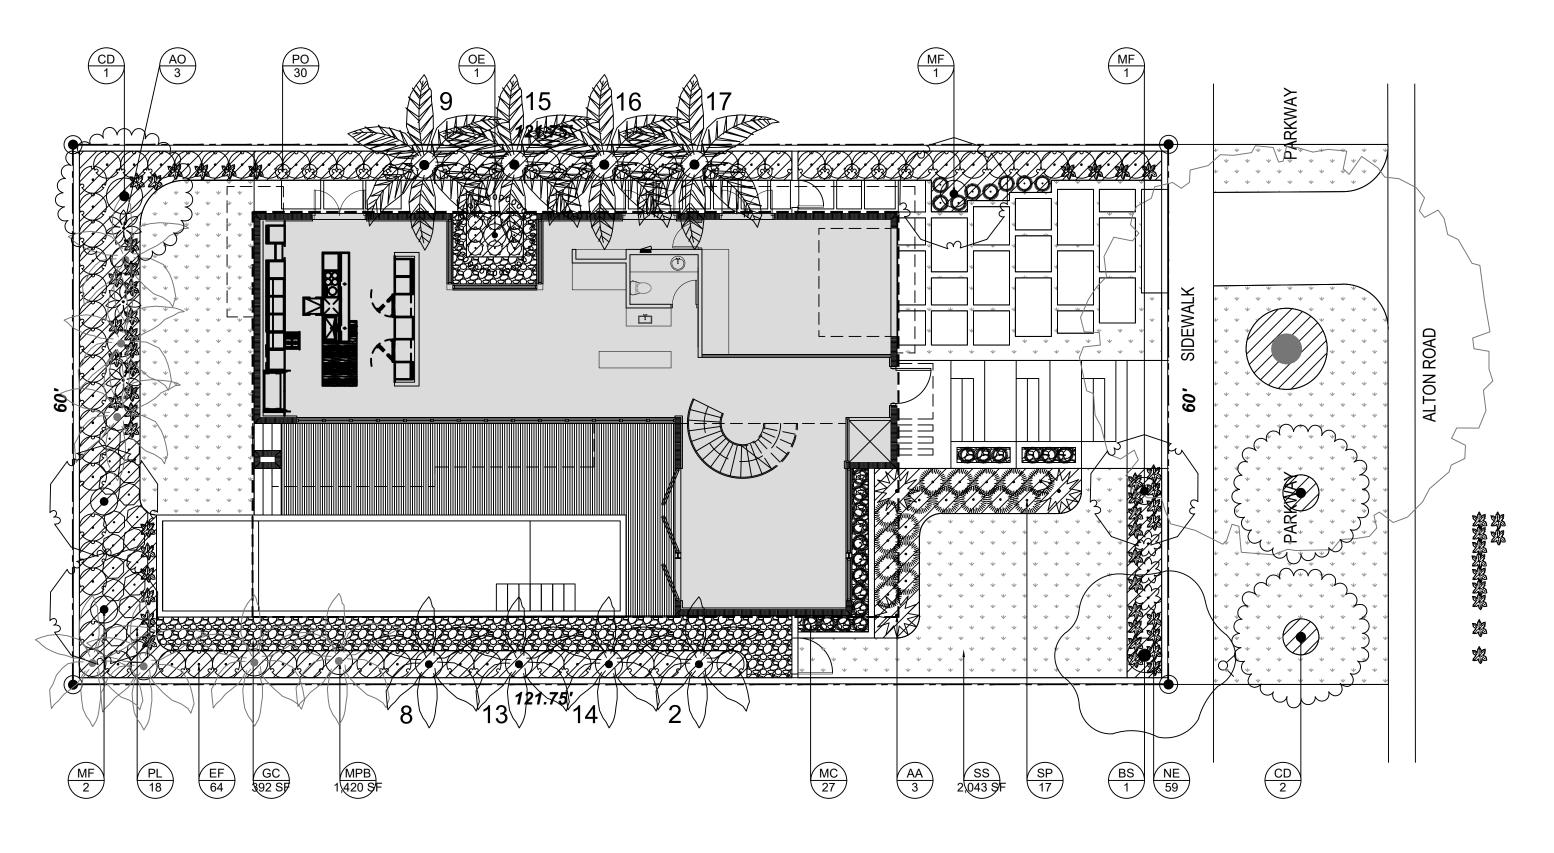

Alberti Studio

Planning
+
Interiors

www.albertistudio.com

copies, transmissions, reproductions, or electronic manipulation my partian of these drawings in whole or in part are to be made ithout the express written permission of Alberti Studio. All design indicated in these drawings are property of Alberti Studio. DESIGN REVIEW BOARD SUBMITTAL

SIDELNIK-CUNIOLO RESIDENCE

2360 ALTON RD. MIAMI BEACH FL. 33140




DRAWING TITLE


LANDSCAPE PLAN


ATE DRB FINAL SUBMITTAL (DRB22-0789) MARCH 7

LE

, 110.

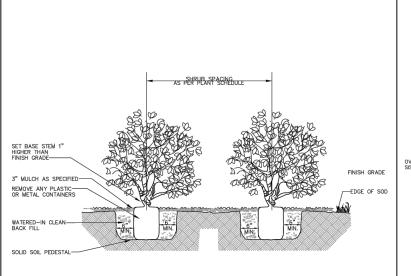

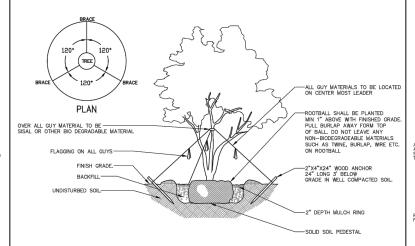


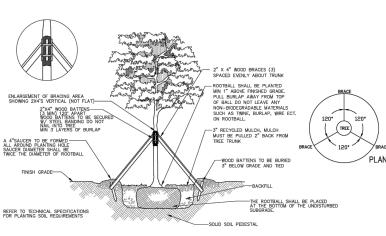



**\SHRUB PLANTING** 

MULTI-TRUNK TREE PLANTING SCALE: NTS

LARGE TREE PLANTING > 4" CALIPER

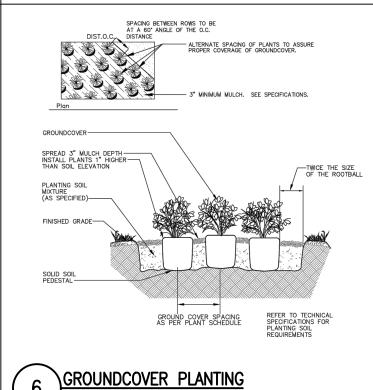

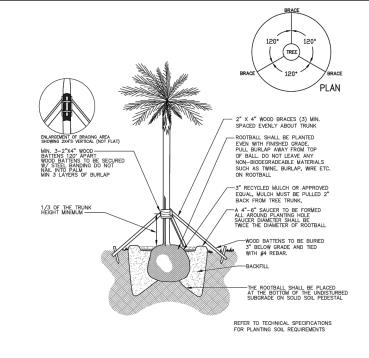

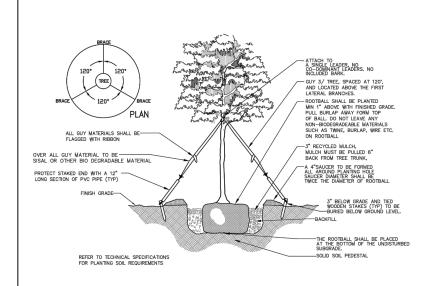

SCALE: NTS

\PALM PLANTING SCALE: NTS

LARGE TREE PLANTING < 4" CALIPER SCALE: NTS

Alberti Studio Architecture Planning Interiors

www.albertistudio.com

DESIGN REVIEW BOARD SUBMITTAL SIDELNIK-CUNIOLO RESIDENCE

2360 ALTON RD. MIAMI BEACH FL. 33140



PLANTING DETAILS

DRB FINAL SUBMITTAL (DRB22-0789) MARCH 7, 2022

SCALE

L-5.00

TREE DISPOSITION SCHEDULE											
SYMBOL	CODE	BOTANICAL NAME	COMMON NAME	SPREAD	DBH	CANOPY	CONDITION	DISPOSITION	COMMENTS		
$\odot$	1	Swietenia mahagoni	Mahogany	30'	45'	60"		Good	Remain		
*	2	Veitchia merrillii	Christmas Palm	16'	15'	2 x 8"		Good	Relocate	Double	
	3	Neodypsis decaryi	Triangle Palm	12'	10'	12"	79	Poor	Remove		
*	4	Veitchia merrillii	Christmas Palm	20'	15'	2 x 6"		Good	Remain	Double	
*	5	Veitchia merrillii	Christmas Palm	20'	15'	2 x 6"		Good	Remain	Double	
* The state of the	6	Veitchia merrillii	Christmas Palm	20'	15'	3 x 4"		Good	Remain	Triple	
	7	Veitchia merrillii	Christmas Palm	20'	15'	3 x 4"		Good	Remain	Triple	
*	8	Veitchia merrillii	Christmas Palm	20'	15'	2 x 6"		Good	Remain	Double	
	9	Cocos nucifera	Coconut Palm	30'	20'	24"		Good	Relocate		
***	10	Veitchia merrillii	Christmas Palm	20'	15'	2 x 6"		Good	Relocate	Double	
*	11	Veitchia merrillii	Christmas Palm	20'	15'	6"		Good	Remain	Single	
*	12	Veitchia merrillii	Christmas Palm	20'	15'	2 x 6"		Good	Remain	Double	
***************************************	13	Veitchia merrillii	Christmas Palm	20'	15'	3 x 6"		Good	Relocate	Triple	
***	14	Veitchia merrillii	Christmas Palm	20'	15'	2 x 6"		Good	Relocate	Double	
	15	Cocos nucifera	Coconut Palm	30'	20'	12"		Good	Relocate		
	16	Cocos nucifera	Coconut Palm	30'	20'	12"		Good	Relocate		
	17	Cocos nucifera	Coconut Palm	30'	20'	12"		Good	Relocate		
74 24	1 1	TOTAL REMOVE	D DBH	12"			1				

SECTION 46-61 TREE REPLACEMENT CHART									
Total diameter of tree(s) to be removed (sum of inches at DBH)	Total number of replacement trees required (minimum of 2" DBH x 6' spread in canopy x 12' in height)	OR	Total number of replacement trees required (minimum of 4" DBH x 8' spread in canopy x 16' in height)	OR	Contribution to Tree Trust Fund				
2"-3"	1	or	0	or	\$1,000.00				
4"-6"	2	or	1	or	\$2,000.00				
7"-12"	4	or	2	or	\$4,000.00				
13"-18"	6	or	3	or	\$6,000.00				
19"-24"	8	or	4	or	\$8,000.00				
25"-30"	10	or	5	or	\$10,000.00				
31"-36"	12	or	6	or	\$12,000.00				
37"-42"	14	or	7	or	\$14,000.00				
43"-48"	16	or	8	or	\$16,000.00				
49"-60"	20	or	10	or	\$20,000.00				

SECTION 46-61 TREE SPECIES DIVERSITY CHART								
REQUIRED NUMBER OF TREES	REQUIRED MINIMUM NUMBER OF SPECIES							
01-10	2							
11-20	3							
21-30	4							
31-40	5							
41 OR GREATER	6							

	TREE MITIGATION SCHEDULE											
TREES	CODE	QTY	BOTANICAL NAME	COMMON NAME	HEIGHT	SPREAD	DBH	CLEAR TRUNK	NATIVE	DROUGHT	TOTAL DBH	
$\bigcirc$	BS	1	Bursera simaruba	Gumbo Limbo	20'	10'	6"	6'	Yes	Yes	6"	
£ .	CD	3	Coccoloba diversifolia	Pigeon Plum	16'	8'	4"	5'	Yes	Yes	12"	
	MF	4	Myrcianthes fragrans	Simpson's Stopper	12'	6'	2"	4'	Yes	Yes	8"	
	TOTAL PROPOSED DBH										26"	
	TOTAL REMOVED DBH										12"	
	MITIGATION SURPLUS DBH										14"	
				MITIGATION REQ	UIREMEN	ΓS					MET	

Alberti Studio
Architecture
+
Planning
+
Interiors

www.albertistudio.com

capies, transmissions, reproductions, or electronic manipulation of sny parties of these drawings in whole or in part are to be made though the express written permission of Alberti Studio. All designs indicated in these drawings are properly of Alberti Studio. All expensives the reserved (#. 970). DESIGN REVIEW BOARD SUBMITTAL

SIDELNIK-CUNIOLO RESIDENCE

2360 ALTON RD. MIAMI BEACH FL. 33140



DRAWING TITLE

DISPOSITION AND MITIGATION SCHEDULES

DATE DRB FINAL SUBMITTAL (DRB22-0789) MARCH 7, 202 SCALE

Drawing No.

L-6.00

	TREE SCHEDULE											
SITE TREES	CODE	QTY	BOTANICAL NAME	COMMON NAME	HEIGHT	SPREAD	DBH	CLEAR TRUNK	NATIVE	DROUGHT		
$\overline{}$	BS	1	Bursera simaruba	Gumbo Limbo	20'	10'	6"	6'	Yes	Yes		
	CD	1	Coccoloba diversifolia	Pigeon Plum	16'	8'	4"	5'	Yes	Yes		
- N	MF	4	Myrcianthes fragrans	Simpson's Stopper	12'	6'	2"	4'	Yes	Yes		
00000000000000000000000000000000000000	OE	1	Olea europaea	European Olive	12'	6'	2"	4'	No	Yes		
STREET TREES	CODE	QTY	BOTANICAL NAME	COMMON NAME	HEIGHT	SPREAD	DBH	CLEAR TRUNK	NATIVE	DROUGHT		
•	CD	2	Coccoloba diversifolia	Pigeon Plum	16'	8'	4"	5'	Yes	Yes		

	SHRUB & GROUNDCOVER SCHEDULE										
SHRUBS	CODE	QTY	BOTANICAL NAME	COMMON NAME	HEIGHT	SPREAD	GAL	NATIVE	DROUGHT		
SINOBS	AA	3	Agave americana	Century Plant	2.5'	3'	7G	Yes	Yes		
Z Z											
- W											
	AO	3	Alcantarea odorata	Silver Bromeliad	2.5'	3'	7G	No	Yes		
700							150		.,		
	EF	64	Eugenia foetida	Spanish Stopper	6'	3'	15G	Yes	Yes		
( • )											
	PL	18	Psychotria ligustrifolia	Bahama Coffee	2'	2'	3G	Yes	Yes		
			1 Sychotha ligadi lidia	Banama Conce	-		00	100	100		
( ' )											
	ZP	3	Zamia pumila	Coontie	2.5'	3'	7G	Yes	Yes		
1 5.7											
GROUNDCOVERS	CODE	QTY	BOTANICAL NAME	COMMON NAME	HEIGHT	SPREAD	GAL	NATIVE	DROUGHT		
- An	NE	59	Nephrolepis exaltata	Boston Fern	1'	1'	1G	Yes	Yes		
ENN											
	МС	27	Muhlenbergia capillaris	Muhly Grass	1'	1'	1G	Yes	Yes		
WWW.	PO	30	Donoromio obtugitalia	Daby Bubbar Blant	41	41	10	Yes	Vaa		
	PO	30	Peperomia obtusifolia	Baby Rubber Plant	1'	1'	1G	res	Yes		
(•)											
	SP	17	Spartina patens	Cordgrass	1'	1'	1G	Yes	Yes		
SOD	CODE	QTY	BOTANICAL NAME	COMMON NAME	HEIGHT	SPREAD	GAL	NATIVE	DROUGHT		
300		2,043 sf	Stenotaphrum	St. Augustine	Flat	JI INLAD	OAL	No	Yes		
			secundatum 'Palmetto'	Palmetto							
			i aiiilello								
MULCH	CODE	QTY	TYPE	DEPTH	SIZE						
	MPB	1,420 sf	Mini Pine Bark Nuggets	2" - 3"	3/4" - 1 3/4"						
AGGRÉGATÉ	CODE	QTY	TYPE	DEPTH	SIZE						
	GC	392 sf	Granite Chips	2" - 3"	$\frac{3}{4}$ " - 1 $\frac{3}{4}$ "						

Alberti Studio
Architecture
+
Planning
+
Interiors

www.albertistudio.com

DESIGN REVIEW BOARD SUBMITTAL

SIDELNIK-CUNIOLO RESIDENCE

2360 ALTON RD. MIAMI BEACH FL. 33140




DRAWING TITLE

LANDSCAPE SCHEDULES

DATE DRB FINAL SUBMITTAL (DRB22-0789) MARCH 7, 2022
SCALE

ng No.

L-6.10

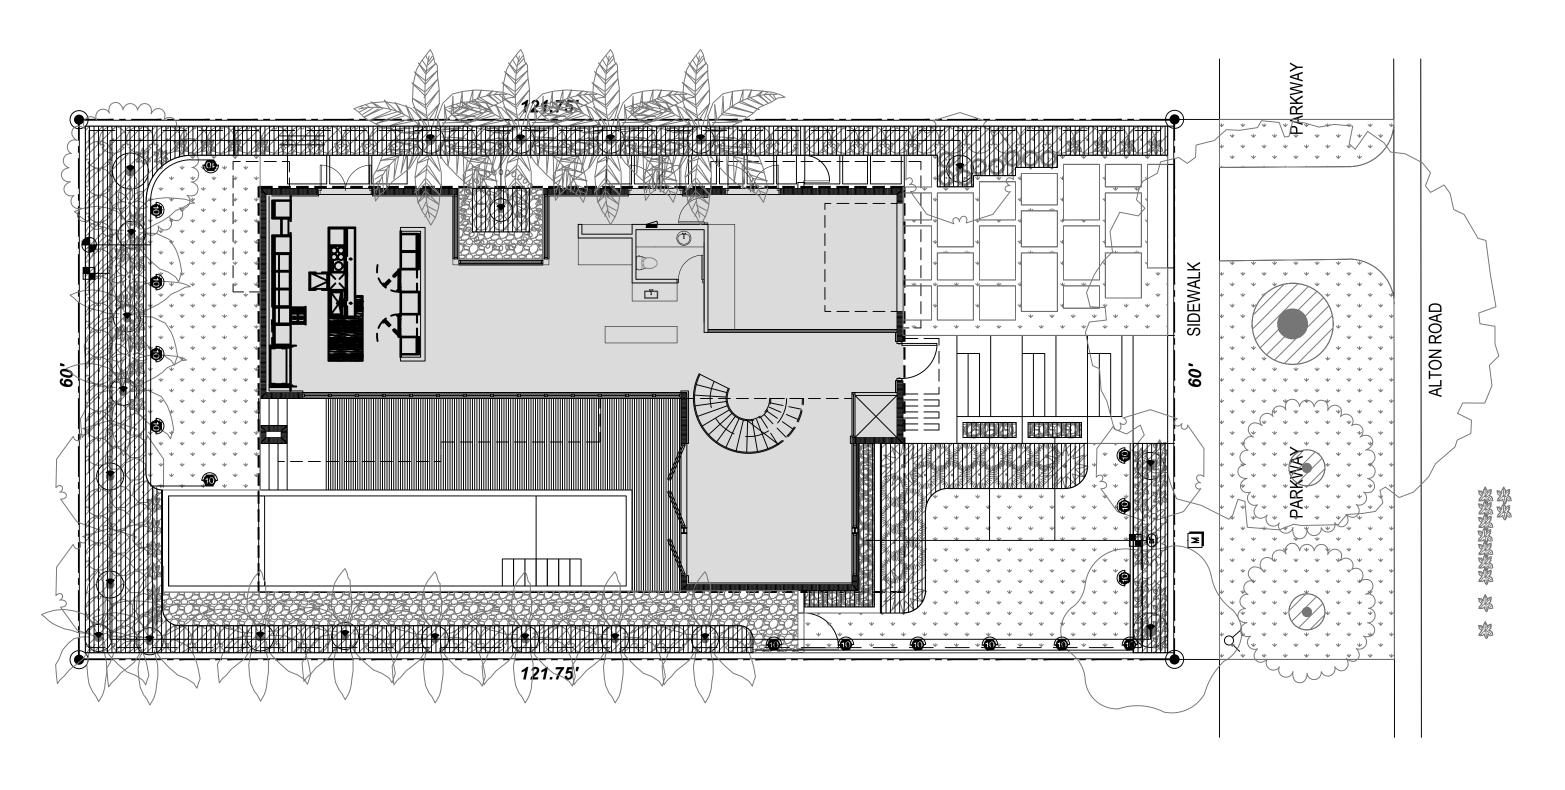

NOTE: FINAL IRRIGATION DESIGN TO BE PROVIDED AT TIME OF BUILDING PERMIT SUBMITTAL

Alberti Studio
Architecture
+
Planning
+
Interiors

www.albertistudio.com

DESIGN REVIEW BOARD SUBMITTAL

SIDELNIK-CUNIOLO RESIDENCE

2360 ALTON RD. MIAMI BEACH FL. 33140



IRRIGATION PLAN

DATE DRB FINAL SUBMITTAL (DRB22-0789) MARCH 7

LE

IR-1.00

#### OR EQUIVALENT

#### IRRIGATION SCHEDULE MANUFACTURER/MODEL/DESCRIPTION SYMBOL ♣ ♠ ♠ ♠ ♦ Hunter PROS-12 5' strip spray ES LCS RCS CS SS Shrub Spray, 12.0" Pop-Up. Co-molded wiper seal with UV Resistant Material. Hunter PROS-12 8' radius Shrub Spray, 12.0" Pop-Up. Co-molded wiper seal with UV Resistant Material. Hunter PROS-12 10' radius Shrub Spray, 12.0" Pop-Up. Co-molded wiper seal with UV Resistant Material Hunter PROS-12 12' radius Shrub Spray, 12.0" Pop-Up. Co-molded wiper seal with UV Resistant Materia Hunter PROS-12 15' radius Shrub Spray, 12.0" Pop-Up. Co-molded wiper seal with LIV Resistant Material Hunter PROS-12 ADJ Shrub Spray, 12.0" Pop-Up. Co-molded wiper seal with UV Resistant Material. Hunter PCB Flood Bubbler, 1/2" FIPT.

#### SYMBOL

#### MANUFACTURER/MODEL/DESCRIPTION

Hunter PGP-AD.I

40 3.00 38' Turf Rotor, 4.0" Pop-Up, Adjustable and Full Circle. Standard Angle Red Nozzle. Lower Precipitation Rate

#### SYMBOL

#### MANUFACTURER/MODEL/DESCRIPTION

Hunter ICV-G 1", 1-1/2", 2", and 3" Plastic Electric Remote Control Valves, Globe Configuration, with NPT Threaded Inlet/Outlet, for Commercial/Municipal

C Hunter PC-0900 Modular Controller, 9 stations, outdoor model, two PCM-300 modules included, plastic cabinet. Residential/Light Commercial Use.



Hunter MINI-CLIK Rain Sensor, mount as noted


2" Well and 2 Horse Power Pump/Pump Start Relay Electrician Shall Wire the 220 Volt Equipment


Irrigation Lateral Line: PVC Schedule 40


Irrigation Mainline: PVC Schedule 40 PVC Schedule 40 irrigation pipe.

Pine Sleeve: PVC Schedule 40 Typical pipe sleeve for irrigation pipe. Pipe sleeve size shall allow for irrigation piping and their related couplings to easily slide through sleeving material. Extend sleeves 18 inches beyond edges of paving or construction.

Valve Callout

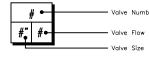

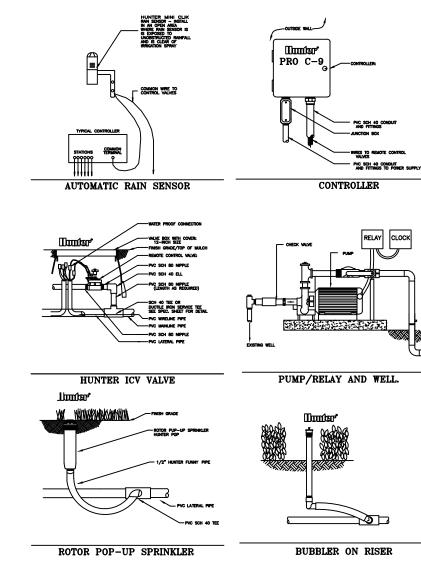

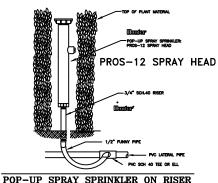

### GENERAL NOTES

- 1. Pipe sizes shall conform to those shown on the drawings. No substitutions of smaller pipe sizes shall be permitted, but substitutions of larger sizes may be approved. All damaged and rejected pipe shall be removed from the site at the time of said rejection.
- 2. All mainline, lateral line and control wire conduit under paving shall be installed in separate sleeves. Sleeves shall be a minimum of twice (2X) the diameter of the pipe to
- 3. Install all backflow prevention devices and all piping between the point of connection and the backflow preventer as per local codes.
- 4. Final location of the backflow preventer and automatic controller shall be approved by the owner's authorized representative.
- 5. 120 VAC electrical power source at controller location shall be provided by others. The electrical contractor shall make the final connection from the electrical source to
- 6. All sprinkler heads shall be set perpendicular to finish grade unless otherwise specified.
- 7. The irrigation contractor shall flush and adjust all sprinkler heads and valves for optimum spray with minimal overspray onto walks, streets, walls, etc.
- 8. This design is diagramatic. All piping, valves, etc., shown within paved areas is for design clarification only and shall be installed in planting areas wherever possible. The contractor shall locate all valves in shrub areas where
- 9. It is the responsibility of the irrigation contractor to familiarize himself with all grade differences, location of walls, retaining walls, structures and utilities. The irrigation contractor shall repair or replace all items damaged by his work. He shall coordinate his work with other contractors for the location and installation of pipe sleeves through walls, under roadways and paving, etc.
- 10. Do not willingly install the sprinkler system as shown on the drawings when it is obvious in the field that unknown obstructions, grade differences or differences in the area dimensions exist that might not have been considered in the engineering. such obstructions or differences should be brought to the attention of the owner's authorized representative. In the event this notification is not performed, the irrigation contractor shall assume full responsibility for any revisions necessary.
- 11. All sprinkler equipment not otherwise detailed or specified shall be installed as per manufacturer's recommendations and specifications.
- 12. The irrigation contractor shall install check valves on all heads in areas where finish grade exceeds 4:1, where post valve shut—off draining, of the irrigation head occurs or as directed by the owner's authorized representative.
- 13. The contractor shall provide 1800 PCS (pressure compensating screens) as necessary to reduce or eliminate overspray onto streets, walks or other areas as directed by the owner's authorized representative.
- 14. All control wires shall be installed in PVC conduit.
- 15. All remote control valves, gate valves, quick couplers, control wire and computer cable pull points shall be installed in approved valves boxes with covers.
- 16. The installation devices are to be guaranteed for the period of (1) year from the date of final acceptance.

Alberti Studio Architecture

> Planning Interiors

www.albertistudio.com

DESIGN REVIEW BOARD SUBMITTAL SIDELNIK-CUNIOLO RESIDENCE 2360 ALTON RD. MIAMI BEACH FL. 33140



**IRRIGATION DETAILS** 

DRB FINAL SUBMITTAL (DRB22-0789) MARCH 7, 2022 SCALE

IR-5.00