## GENERAL ELECTRICAL NOTES:

- 1. SITE INVESTIGATION: PRIOR TO BIDDING THE CONTRACTOR SHALL VISIT THE JOBSITE AND BECOME ACQUAINTED WITH ALL OF THE EXISTING CONDITIONS WHICH WILL AFFECT HIS WORK. FAILURE TO DO SO WILL NOT BE ACCEPTED AS A REASON FOR REQUESTING EXTRA PAY WHERE THE EXISTING CONDITION RESULTS IN EXTRA MATERIAL OR LABOR. THE CONTRACTOR SHALL SUBMIT IN HIS BID AN AMOUNT THAT WOULD BE SET ASIDE FOR UNIDENTIFIED ITEMS.
- 2. ALL WORK SHALL BE PERFORMED BY A LICENSED CONTRACTOR IN A FIRST CLASS MANNER AND SHALL BE A COMPLETED AND FULLY OPERATIVE TO THE ACCEPTANCE OF THE OWNER, GENERAL CONTRACTOR, AND ENGINEER.
- 3. THE CONTRACTOR SHALL FURNISH ALL LABOR, MATERIALS AND EQUIPMENT NECESSARY FOR THE COMPLETE INSTALLATION OF THE ELECTRICAL SYSTEMS, ALL IN ACCORDANCE WITH THESE CONSTRUCTION DOCUMENTS. ALL WORK PERFORMED UNDER THIS CONTRACT SHALL COMPLY WITH THE FLORIDA BUILDING CODE (2017) FLORIDA FIRE PREVENTION CODE (2014) AND NFPA CODES INCLUDING, BUT NOT LIMITED TO NFPA 70 - (2014 NEC), NFPA 72 (2013) - (FIRE ALARM).
- 4. THIS CONTRACTOR SHALL PAY FOR ALL FEES, INSPECTIONS, TESTS, FINES, ETC., AS REQUIRED.
- 5. MINIMUM STANDARDS: THE MATERIAL, EQUIPMENT, INSTALLATION, AND WORKMANSHIP FURNISHED UNDER THIS SECTION SHALL CONFORM AT LEAST TO THE REQUIREMENTS OF THE REGULATING AGENCIES AS LISTED ABOVE.
- 6. RESPONSIBILITIES: CONTRACTOR SHALL BE RESPONSIBLE TO PROVIDE A COMPLETE OPERATIONAL ELECTRICAL SYSTEM INCLUDING ALL REQUIRED WIRING, RACEWAYS, CONNECTIONS, ETC. INCLUDING COORDINATION WITH OTHER TRADES.
- 1. GUARANTEE: THE CONTRACTOR SHALL FURNISH A WRITTEN GUARANTEE THAT ALL WORK EXECUTED UNDER THIS CONTRACT SHALL BE FREE FROM DEFECTS OF WORKMANSHIP AND MATERIALS FOR A PERIOD OF ONE YEAR FROM THE DATE OF FINAL ACCEPTANCE AND THAT HE, AT HIS OWN EXPENSE, WILL REPAIR OR REPLACE ALL WORK WHICH BECOMES DEFECTIVE DURING THE TIME OF THE GUARANTEE.
- 8. ALL EQUIPMENT, SYSTEMS AND SYSTEM COMPONENTS SHALL BE FROM THE SAME MANUFACTURER AND SHALL BE INSTALLED IN ACCORDANCE WITH THE MANUFACTURERS RECOMMENDATIONS AND
- 9. OBTAIN FULL INFORMATION REGARDING RESTRICTIONS AND LIMITATIONS OF SPACE AVAILABLE FOR INSTALLATION OF THE EQUIPMENT AND MATERIALS UNDER CONTRACT, AND PROVIDE READY ACCESSIBILITY TO ELECTRICAL EQUIPMENT, INCLUDING ANY PART OF SYSTEM REQUIRED TO BE
- 10. PROVIDE ACCURATE LAYOUT, GRADES AND ELEVATIONS. TAKE PROPER PRECAUTIONS TO PROTECT WORK AND EQUIPMENT FROM DAMAGE.

REACHED FOR MAINTENANCE AND OPERATION.

- PROVIDE CODE APPROVED FIRE STOPPING AT ALL CONDUIT PENETRATIONS THROUGHOUT BUILDING CONSTRUCTION TO MAINTAIN FIRE, SMOKE AND SOUND RATING. FIRE SEAL ALL PENETRATIONS. SEAL TELECOMMUNICATION SLEEVES AFTER CABLES HAVE BEEN INSTALLED.
- 12. RACEWAYS AND FITTINGS: CONDUIT RUNS SHALL BE CONCEALED IN CEILING SPACES AND WALL PARTITIONS. NO CONDUIT SHALL BE EXPOSED IN INTERIOR SPACES. CONCEALED CONDUITS ARE
- 13. THIS CONTRACTOR SHALL BE RESPONSIBLE FOR COORDINATION WITH ALL OTHER TRADES AS WELL AS PROVIDING TEMPORARY POWER AS REQUIRED FOR THE PROJECT.
- 14. VERIFY EQUIPMENT SIZES, VOLTAGE AND CURRENT CHARACTERISTICS, ETC., BEFORE THE ORDERING OF ANY EQUIPMENT AND PRIOR TO ROUGHING-IN FOR EQUIPMENT SUPPLIED BY OTHERS. NOTIFY ENGINEER OF ANY CONFLICT.
- 15. PROVIDE COMPLETE POWER CIRCUIT WIRING AND CONNECTIONS FOR EACH AND EVERY ITEM OF PERMANENT MECHANICAL EQUIPMENT, PRIOR TO ANY ROUGH-IN, VERIFY HVAC AND PLUMBING EQUIPMENT NAME PLATES TO OBTAIN CORRECT WIRE SIZE AND OVER CURRENT PROTECTION RATINGS. IF THE NAME PLATE REQUIRES THE OVER CURRENT PROTECTION DEVICE TO BE FUSES, PROVIDE A FUSED SWITCH WITH PROPER SIZE FUSES AT THE EQUIPMENT LOCATION.
- 16. CONDUCTOR: ALL WIRES AND CABLES SHALL CONSIST OF 98% CONDUCTIVE COPPER ALL CABLES SHALL BE SINGLE CONDUCTOR, 600 VOLT, THERMOPLASTIC INSULATION, SUITABLE FOR CONTINUOUS OPERATION AT 15 DEGREES C. TEMPERATURE IN BOTH WET AND DRY LOCATIONS. THESE CABLES SHALL BE N.E.C. INSULATION TYPE THUN/THHN. MINIMUM SIZE SHALL BE #12. ALL CONDUCTOR INSULATION SHALL BE COLOR CODED. COLORED INSULATION SHALL BE USED FOR AUG SIZES % AND SMALLER AND APPROVED COLOR TAPES SHALL BE USED FOR AUG SIZES \*4 AND LARGER ALL POWER AND CONTROL CIRCUITS SHALL CARRY EQUIPMENT GROUNDING CONDUCTOR SIZE PER NEC 250-122.
- 17. THE NATURE OF THIS TYPE OF CONSTRUCTION POSES SPECIAL PROBLEMS FOR THE DESIGN ENGINEER AS WELL AS THE CONTRACTOR EVERY EFFORT HAS BEEN MADE BY THE ENGINEER TO SHOW AND VERIFY WHERE POSSIBLE THE LOCATION OF THE EXISTING ELECTRICAL SYSTEMS. THE MAJOR PORTION OF THE ELECTRICAL SYSTEMS ARE AS SHOWN ON THE DRAWINGS. HOWEVER, MINOR DEVIATIONS MAY BECOME EVIDENT AS THE JOB PROGRESSES. NO ADVANTAGE IS TO BE TAKEN BY THE CONTRACTOR BECAUSE OF THESE MINOR DIFFERENCES.
- 18. CORRECTION OF ANY DEFECTS, REPAIRS OR DAMAGE DURING CONSTRUCTION AS WELL AS ANY MINOR CHANGES IN OUTLET LOCATIONS SHALL BE MADE WITHOUT ADDITIONAL COST TO THE
- 19. GUTTERS, PULL BOXES, ETC., SHALL BE GALVANIZED STEEL SIZED PER NATIONAL ELECTRICAL CODE, ARTICLE 312 AND SUITABLE FOR THE ENVIRONMENTAL CONDITIONS PRESENT.
- 20. ALL FLOORS, WALLS AND ROOF PENETRATIONS SHALL BE PROPERLY SEALED-OFF, IF FIRE RATED, AN APPROVED FIRE RETARDANT SEALANT SHALL BE USED.
- 21. ALL WIRING SHALL BE INSTALLED IN RACEWAYS.
- A. OUTDOORS USE THE FOLLOWING:
- EXPOSED: RIGID GALVANIZED STEEL CONDUIT OR INTERMEDIATE METALLIC CONDUIT. UNDERGROUND: SCHEDULE 40 PYC
- 22. BOXES AND ENCLOSURES
- A. OUTDOORS USE THE FOLLOWING:
- NEMA 3R MALLEABLE IRON OR STEEL NEMA 4X - STAINLESS STEEL FOR WET OR CORROSIVE ENVIRONMENTS
- 23. THESE DRAWINGS ARE A GUIDE FOR THE INSTALLATION OF THE RACEWAY SYSTEM AND EQUIPMENT. THEY ARE INTENDED TO SHOW THE GENERAL ARRANGEMENT, DESIGN AND EXTENT OF THE WORK AND ARE PARTLY DIAGRAMMATIC. THE CONTRACTOR IS RESPONSIBLE FOR PROVIDING A COMPLETE AND OPERATIONAL INSTALLATION.
- 24. CIRCUIT NUMBERS ARE FOR IDENTIFICATION PURPOSES ONLY. THE CONTRACTOR IS RESPONSIBLE FOR CORRECTLY PHASING THE CIRCUITS IN THE PANEL AND SHALL BALANCE THE LOAD ON THE PHASES UNDER NORMAL OPERATING CONDITIONS, PROVIDE TYPE WRITTEN PANEL BOARD DIRECTORIES IN EXISTING PANEL BOARDS AFFECTED BY THIS PROJECT ELECTRONICALLY TRACING ALL CIRCUITS.

- 25. ANY DEVIATION FROM THESE DRAWINGS AND SPECIFICATIONS MUST BE AUTHORIZED IN WRITING BY THE ENGINEER PRIOR TO MAKING ANY CHANGES. THE CONTRACTOR SHALL BE HELD LIABLE FOR ANY DEVIATIONS WITHOUT SUCH AUTHORIZATION.
- 26. ALL POWER AND LIGHTING CIRCUITS SHALL HAVE A GREEN EQUIPMENT GROUNDING CONDUCTOR SIZED AS PER NEC 250-122.
- 27. PROVIDE NYLON PULL STRINGS IN ALL EMPTY CONDUITS FOR FUTURE USE.
- 28. COLOR CODING FOR CONDUCTORS:
- A. WIRING FOR 120/208 VOLT SYSTEM SHALL BE CODED AS FOLLOWS:

PHASE A - BLACK PHASE B - RED PHASE C - BLUE NEUTRAL - WHITE GROUND - GREEN

B. WIRING FOR 120/240 YOLT SYSTEM SHALL BE AS FOLLOWS:

PHASE A - BLACK PHASE B - ORANGE (HIGH LEG) PHASE C - RED NEUTRAL - WHITE GROUND - GREEN

COMPLIANCE WITH NEC 110.16.

C. WIRING FOR 277/480 VOLT SYSTEM SHALL BE CODED AS FOLLOWS:

PHASE A - BROWN PHASE B - ORANGE PHASE C - YELLOW NEUTRAL - GRAY GROUND - GREEN

- D. COLORS ON CONDUCTORS SIZE \*6 AUG AND SMALLER SHALL BE AN INTEGRAL PART OF INSULATION. ON CONDUCTORS SIZE \*4 AUG. AND LARGER CONDUCTORS SHALL BE COLOR CODED BY MEANS OF IDENTIFYING TAPE.
- 29. ANY WORK NOT SHOWN OR SPECIFICALLY MENTIONED ON THESE PLANS BUT CONSIDERED NECESSARY FOR COMPLETION OF WORK IN THE PROPER MANNER SHALL BE PROVIDED BY THE CONTRACTOR WITHOUT ADDITIONAL CHARGE TO THE OWNER.
- 30. CONTRACTOR SHALL VERIFY SPACE CONDITIONS AND DIMENSIONS AT JOB SITE PRIOR TO FABRICATION AND INSTALLATION OF MATERIALS AND EQUIPMENT.
- 31. ALL ELECTRICAL EQUIPMENT SUCH AS PANELS, PULL AND JUNCTION BOXES, FEEDERS, ETC. SHALL BE PROPERLY IDENTIFIED WITH A PERMANENT LABEL AFFIXED TO THE EQUIPMENT. IDENTIFY CIRCUITS IN PANELS BY MEANS OF A TYPED, PLASTIC COVERED DIRECTORY.
- 32. SPOT PAINT CONDUITS AND BOXES, IDENTIFY CONDUITS WITHIN 6 INCHES (6") OF BOX OR ENCLOGURE. USE COLOR CODE PER OWNER'S REQUIREMENTS/STANDARDS.
- 33. ALL SERVICE INTERRUPTIONS AND ALL REMOVAL AND DISPOSAL WORK SHALL BE SCHEDULED AND COORDINATED WITH THE AUTHORIZED OWNER REPRESENTATIVE.
- 34. CONTRACTOR SHALL SECURE AND PAY FOR ALL PERMITS, FEES, TAXES, INSPECTIONS, TESTS AND OTHER ITEMS INCLUDING REQUIRED INSURANCE FOR PROTECTION AGAINST PUBLIC LIABILITY AND PROPERTY DAMAGE FOR THE DURATION OF THE WORK.
- WORK PROGRESSES. AT THE COMPLETION OF THE WORK, THE CONTRACTOR SHALL DELIVER A SET OF AS-BUILT DRAWINGS TO THE OWNER IN REPRODUCIBLE FORM. CONTRACTOR SHALL STAMP AS-BUILT ON EACH DRAWING AND INCLUDE SIGNATURE AND DATE.

36. CONTRACTOR IS RESPONSIBLE FOR REPLACING SURFACES, WALLS, CEILINGS, FLOORS, PARTITIONS,

PAVEMENT, ETC. AFFECTED BY THE IMPLEMENTATION OF WORK SHOWN ON THESE DRAWINGS. UPON

35. CONTRACTOR SHALL MAINTAIN A COMPLETE SET OF PRINTS FOR INDICATING ALL CHANGES AS

COMPLETION OF WORK, RESTORE ALL AFFECTED SURFACES MATCHING SURROUNDING SURFACE. 31. TELECOM RACEWAYS, EMPTY BOXES AND PULL STRINGS TO BE INSTALLED BY CONTRACTOR.

WIRING AND WIRING DEVICES AND FINAL CONNECTION IS TO BE BY INSTALLED BY OWNER'S

- CONTRACTOR UNDER SEPARATE PERMIT. 38. ELECTRICAL EQUIPMENT TO BE PROVIDED WITH A WARNING LABEL FOR ARC FLASH HAZARDS IN
- 39. PROJECT TO COMPLY WITH THE REQUIREMENTS OF THE CURRENT EDITION OF NFPA 241 "STANDARDS FOR SAFE GUARDING CONSTRUCTION, ALTERATION, AND DEMOLITION OPERATIONS."
- 40. CONTRACTOR SHALL PROVIDE THE REQUIRED MEASURES FOR THE SAFEGUARDING OF THE EXISTING FACILITY AND SYSTEMS THEREIN DURING THE PERFORMANCE OF THE WORK SHOWN ON THESE DRAWINGS PER NFPA 241.
- 41. CONTRACTOR SHALL RETURN SURFACE CONDITIONS (GRASS, SIDEWALKS, PAVING) TO LIKE NEW CONDITION AFTER INSTALLATION OF WORK.
- 42. THE CONTRACTOR SHALL COMPLY WITH ALL APPLICABLE FEDERAL, STATE AND LOCAL CODES APPLICABLE TO THIS PROJECT, INCLUDING BUT NOT LIMITED TO FLORIDA BUILDING CODE AND HEALTH AND SAFETY CODES.

A. ALL CONSTRUCTION SHALL BE ACCOMPLISHED IN A SAFE MANNER AND STRICT COMPLIANCE WITH ALL THE REQUIREMENTS OF THE FEDERAL OCCUPATIONAL SAFETY AND HEALTH AND ALL STATE AND LOCAL SAFETY AND HEALTH REGULATION.

B. UPON THE RECEIPT OF THE 'NOTICE TO PROCEED", THE CONTRACTOR SHALL CONTACT THE ENGINEER OF RECORD AND ARRANGE A PRE-CONSTRUCTION MEETING TO INCLUDE ALL INVOLVED GOVERNMENTAL AGENCIES, UTILITY OWNERS, THE CITY OF MIAMI REPRESENTATIVE AND THE ENGINEER OF RECORD.

C. THE CONTRACTOR SHALL OBTAIN A SUNSHINE STATE ONE CALL OF FLORIDA, INC. CERTIFICATION NUMBER AND FIELD MARKINGS AT LEAST 48 HOURS PRIOR TO BEGINNING AND EXCAVATION. CALL *800-4*32-477*0* D. THE CONTRACTOR SHALL BE RESPONSIBLE FOR VISITING THE SITE PRIOR TO BIDDING AND

FAMILIARIZING ITSELF WITH ALL EXISTING CONDITIONS AFFECTING THE WORK, INCLUDING BUT NOT LIMITED TO, UTILITIES AND OTHER SUPPORT FACILITIES. E. THE CONTRACTOR SHALL BE RESPONSIBLE FOR INCLUDING IN ITS BID, WORK MATERIAL COSTS

CONSTRUCTION. THIS INCLUDES ANY AREA DAMAGED BECAUSE OF STAGING, DUMPSTER, AND

FOR ANY CHANGES OR ALTERATIONS OF ADJACENT AREAS TO BE DISTURBED DURING

SODDING DISTURBED BY CONSTRUCTION ACTIVITY.

## ELECTRICAL SYMBOL LEGEND

## LICHTIMO BOXES & FITTINGS CEILING MOUNTED JUNCTION BOX Lig WALL MOUNTED JUNCTION BOX , 18" A.F.F. OR AS OTHERWISE NOTED. CEILING MOUNTED JUNCTION BOX, 12"X12"X6" DEEP MINIMUM UNLESS OTHERWISE INDICATED FOR DISTRIBUTION OF TELEPHONE/DATA PULLBOX, SIZED AS INDICATED OR AS REQUIRED BY N.E.C. PANELBOARDS POWER, LIGHTING OR DISTRIBUTION PANELBOARD. (NEW) FIRE ALARM CEILING MOUNTED SMOKE DETECTOR. DUCT MOUNTED SMOKE DETECTOR. EXIT DOOR SECURITY ALARM WITH MONITOR MODULE TIED TO FIRE ⊢0— CEILING MOUNTED HEAT DETECTOR. MANUAL FIRE ALARM PULL STATION, 48" A.F.F. FIRE ALARM STROBE LIGHT, A.D.A. TYPE. FIRE ALARM HORN, & STROBE LIGHT 80' A.F.F. A.D.A. TYPE. OC SHUT DOWN RELAY. FAP FIRE ALARM PANEL FLOW SWITCH TAMPER SWITCH **SWITCHES** FIRE ALARM HORN, 80" A.F.F. SINGLE POLE TOGGLE SWITCH, 20A., KEY OPERATED 120/271 VAC. FIRE ALARM SPEAKER & STROBE LIGHT 80' AFF. A.D.A. TYPE FIRE ALARM SYSTEM SPEAKER SINGLE POLE TOGGLE SWITCH, 20A,, 120/277 VAC, MOUNTED 48" AFF. "a" SWITCH LEG. **WIRING** THREE-WAY AND FOUR WAY TOGGLE SWITCHES 20A, 120/277 YAC. MOUNTED 48" A.F.F. HOMERUN TO PANEL "A".1-3-5 ARE CIRCUIT NO'S. TICKS ARE NO. OF

CONDUCTORS (/)INDICATES GROUND WIRE SIZED AS PER N.E.C. ART.

INDICATES A CONDUIT RUN CONCEALED IN A CEILING OR WALL.

CONCRETE OR UNDERGROUND AT 24' BELOW GRADE MINIMUM.

INDICATES A FLEXIBLE METAL CONDUIT CONNECTION, USE LIQUID

TIGHT CONDUIT IN WET, DAMP OR OILY LOCATIONS.

INDICATES A CAPPED CONDUIT.

FLEXIBLE EQUIPMENT CONNECTION.

CONDUIT RUN TURNED DOWN.

CONDUIT RUN TURNED UP.

CONDUIT EXPANSION JOINT

INDICATES A CONDUIT RUN CONCEALED IN FLOOR. EMBEDDED IN

LIGHTING		MISCELLANEOUS
IGHTING FIXTURE TYPE. SEE LTG. FIXTURE SCHEDULE THIS SHEET	•	TELEPHONE OUTLET
RECESSED, SEMI RECESSED, SURFACE OR PENDANT MOUNTED IXTURE ON NORMAL CIRCUIT 2 IS CIRCUIT NO± "a" DENOTES SWITCH EG	◁	ADMINISTRATIVE TELEPHONE OUTLET, MTD. 48" AFF.
URFACE OR PENDANT MOUNTED FLUORESCENT FIXTURE.	CS	COMBINATION CLOCK SPEAKER
URFACE OR PENDANT MOUNTED FLUORESCENT FIXTURE	HTV	TELEVISION TAP THRU OUTLET, MTD. 6'-8" AFF.
LUORESCENT RECESSED OR LAY-IN FIXTURE.	HII	CLASSROOM CALL BACK BUTTON.
LUORESCENT RECESSED OR LAY-IN FIXTURE	H	P.A. PRIVACY SWITCH.
	D	DATA OUTLET
URFACE MOUNTED SINGLE FACE EXIT LIGHT FIXTURE WITH ARROWS INCLUDED, 1'-6' AFF.	MD	MOTION DETECTOR
	<b>©</b>	DOOR CONTACT
	CR	PROXIMITY CARD READER
URFACE MOUNTED DOUBLE FACE EXIT LIGHT FIXTURE WITH ARROWS AS INDICATED	MAG	MAGNETIC DOOR LOCK
	KP	SECURITY SYSTEM KEY PAD
IALL MOUNTED DOUBLE FACE EXIT LIGHT FIXTURE WITH ARROWS AS INDICATED. 7'-6" AFF.		
	<u>CCTV</u> ✓	CEILING MOUNTED CLOSED CIRCUIT TV CAMERA
URFACE MTD. STRIP FLUORESCENT FIXTURE		
URFACE MTD. STRIP FLUORESCENT FIXTURE,	H <u>cctv</u> ✓	WALL MOUNTED CLOSED CIRCUIT TV CAMERA
COMBINATION EXIT SIGN - EMERGENCY LIGHT		
		RECEPTACLES
MERGENCY LIGHT		
	$\ominus$	120V, I PHASE 60 HZ 20 AMP SINGLE RECEPTACLE
OCCUPANCY SENSOR (CEILING MOUNTED) WITH 20 AMP RELAY	$\ominus$	120V.,1 PHASE, 60 HZ., 20 AMP. DUPLEX RECEPTACLE MTD. 18' AFF.
RM MOUNTED POLE LIGHT		SAME AS ABOVE EXCEPT MTD. AT 6" ABOVE COUNTER
	$\bigoplus$	120V.,1 PHASE, 60 HZ., 20 AMP. DUAL DUPLEX RECEPTACLE MTD. 18" A.F.F.
OST TOP MOUNTED POLE LIGHT	<b>———</b>	DOUBLE DUPLEX RECEPTACLES MOUNTED AS PART OF SURFACE RACEWAY

FLOOR OUTLET WITH (1) 120Y, I PHASE 60 Hz, 20 AMP DUPLEX RECEPT. SPECIAL PURPOSE RECEPTACLE.

MOTORS & CONTROLS MOTOR, 5 = 5 H.P. OR AS OTHERWISE INDICATED.  $\boxtimes$ MOTOR MAGNETIC STARTER. MANUAL MOTOR STARTER TOGGLE SWITCH WITH OVERLOADS. 48' A.F.F. VAY WITH DUCT HEATER, CONTACTOR AND SAFETY DISCONNECT. THERMOSTAT

SAFETY SWITCH, 3P = NO. OF POLES. 60 = SWITCH SIZE, 50 = FUSE

OCCUPANCY TYPE WALL SWITCH



MAURICE GIBB'S MEMORIAL PARK

COASTAL SYSTEMS INTERNATIONAL, INC. 464 South Dixie Highway, Coral Gables, Florida 33146
Tel: 305-661-3655 Fax: 305-661-1914 www.CoastalSystemsInt.com



A-1,3,5

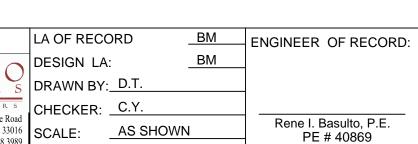
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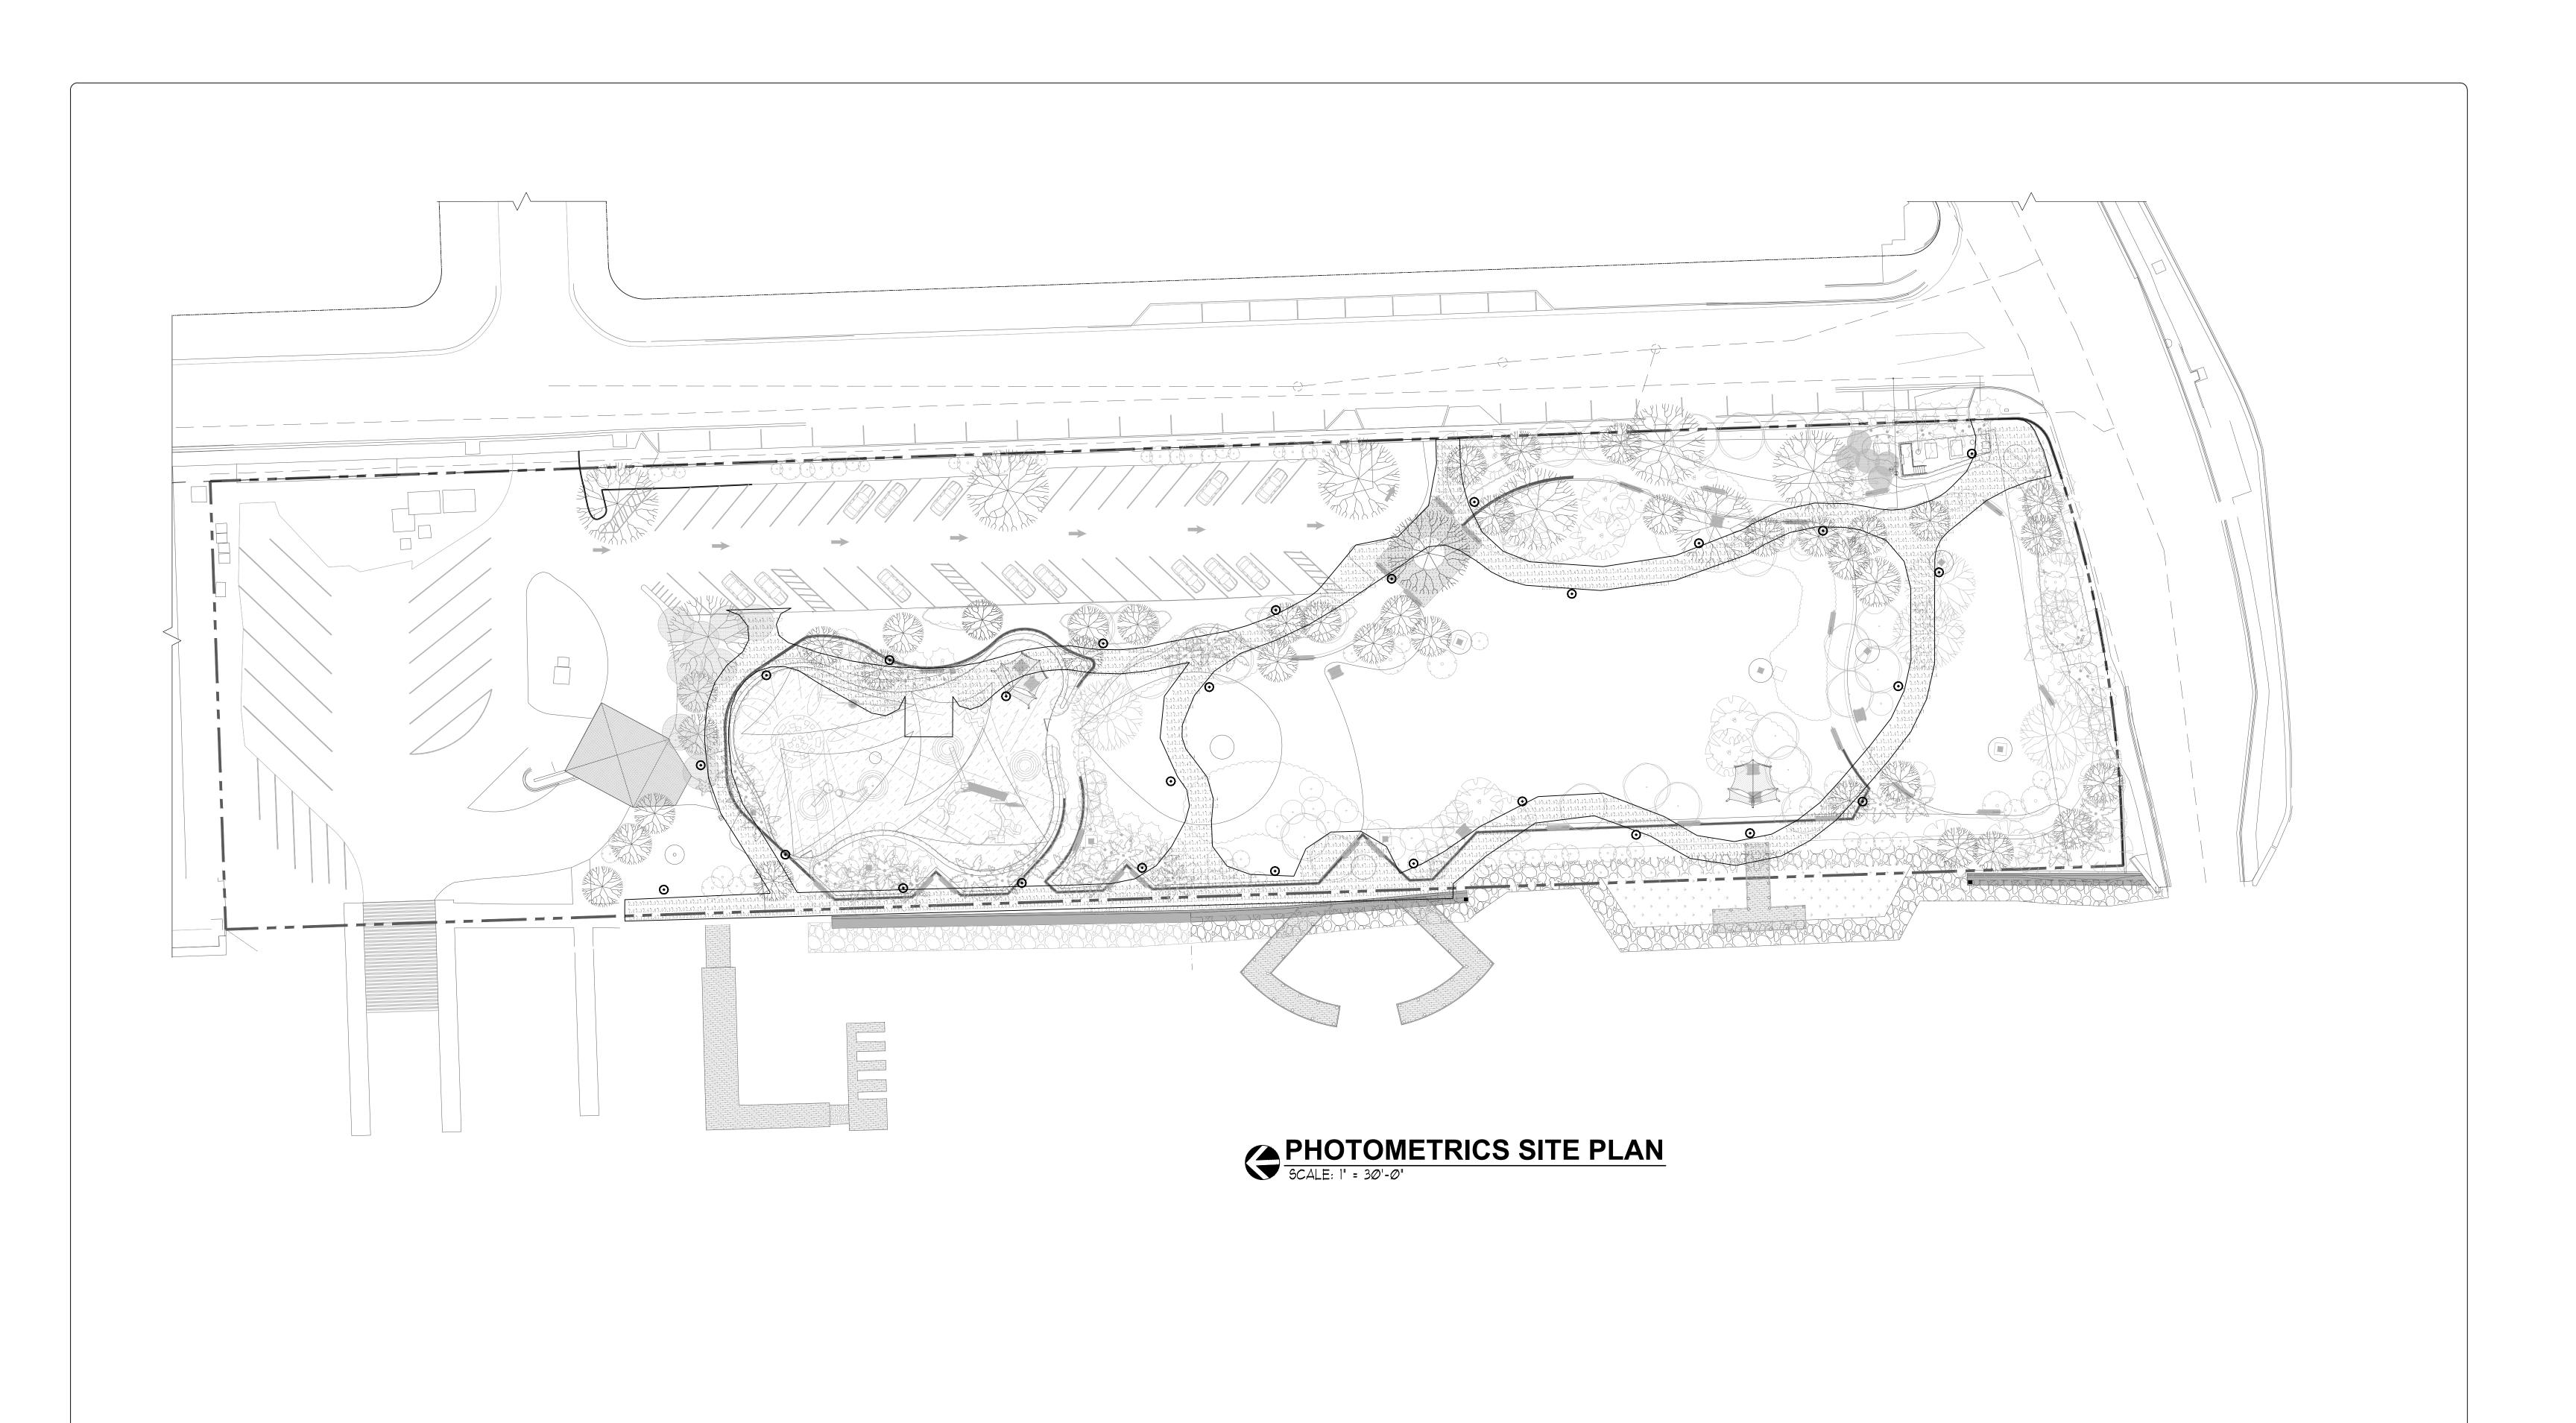
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OFFICE OF CAPITAL IMPROVEMENT PROJECTS
1701 MERIDIAN AVENUE, MIAMI BEACH, FL.33139

MAURICE GIBB'S MEMORIAL PARK

ADDRESS:

1700 PURDY AVENUE MIAMI BEACH, FL 33139-1424



B A S I L T E S DESIGN LA:

A S S O L A T E S DESIGN LA:

DRAWN BY: D.T.

CONSULTING ENGINEERS

René I. Basulto, PE 14160 Palmetto Frontage Road
PE 40869 - FL CA06722 Suite 22, Miami Lakes, FL 33016
www.basulto.com 305.698.3988, fax: 305.698.3989

Drawing No.:

LA OF RECORD BM ENGINEER OF RECORD:

DESIGN LA: BM

DRAWN BY: D.T.

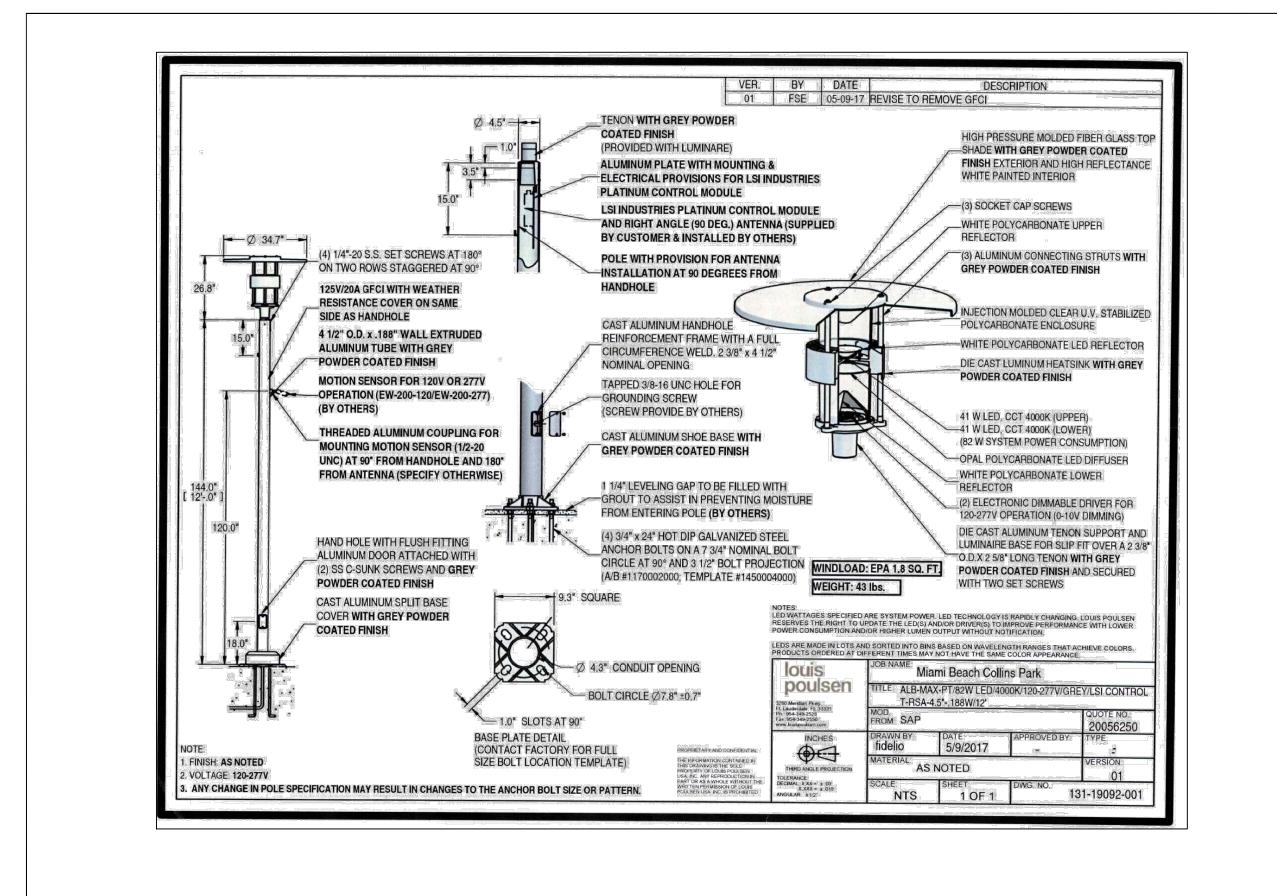
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Rene I. Basulto, P.E.

PE # 40869

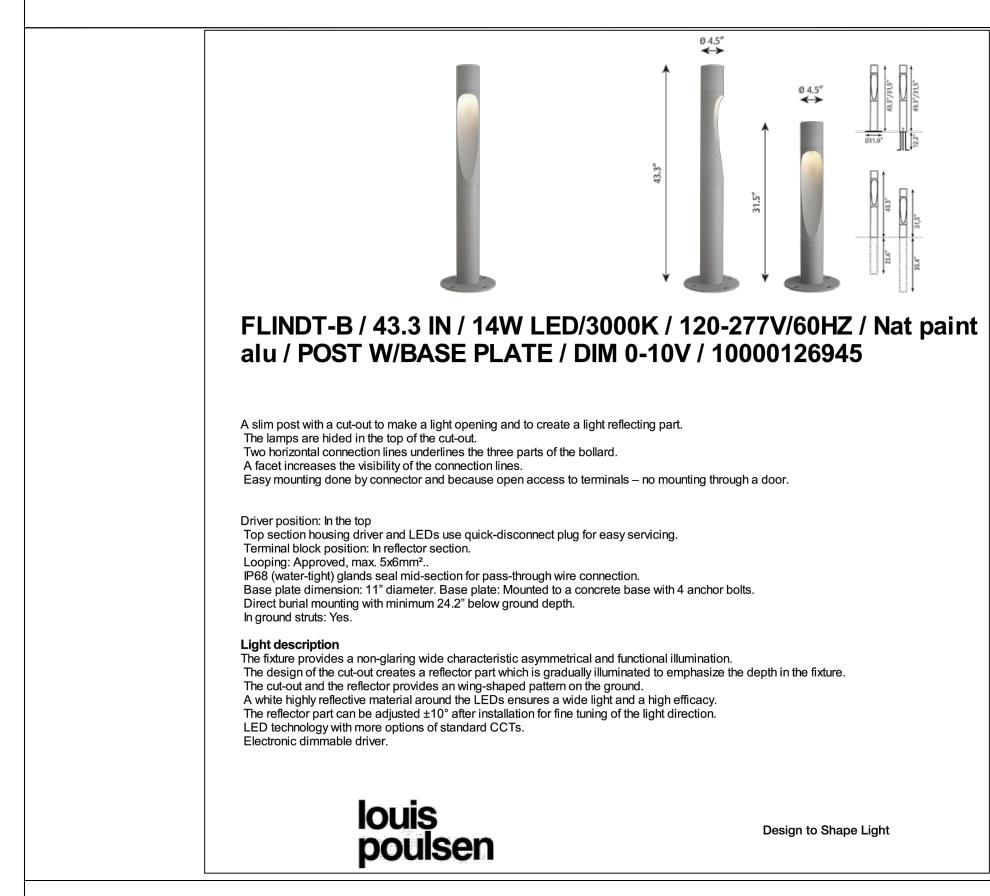
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LIGHTING FIXTURE (A)

LIGHTING FIXTURE B



Arcluce **INGROUND260** round trim above the ground O-IG7124US-30S Arcluce Code 0779000D+840+30US Code Ref. TECHNICAL INFORMATION IP67 LED, 4000K, 12W, 1800lm, CRI>80 Light efficiency: > 50000h - L80 - B20 (Ta 25°C) LED life time: IK10 High colour consis 120-277V 60Hz 0-10V flood 38° Stainless Steel - 30 15.43 lb A: Ø 10" 13/16 B: 16" 3/8 - AISI 316L stainless steel body. - Die-cast aluminium body (EN 47100). - AISI 316L stainless steel counter-ring. - Double layer polyester powder paint resistant to corrosion and salt spray fog. 11000 - Silicone rubber gaskets. - AISI 316 stainless steel external screws. - PMMA lenses for LEDs. - Reflector made of 99,85 anodized aluminium with satin or non-iridescent specular finishing. - Screen made of 19/32"thermal-shock resistant tempered glass. - 11000-13200lb static load capacity. - Can be driven over at maximum speed 12 mph. - Double PG16 cable gland for through wiring. - Supplied with recessed installation box. - Supplied with power cable (2' 3" 9/16). - Recessed installation box made of engineering plastic. - FIXTURES WITH STAINLESS STEEL TRIM ARE SUGGESTED FOR WALK-OVER OR DRIVE-OVER APPLICATIONS. - UPON REQUEST FIXTURES CAN BE SUPPLIED WITH ANTI-SLIP GLASS.

LIGHTING FIXTURE C

LIGHTING FIXTURE D

MAMBEACH

OFFICE OF CAPITAL IMPROVEMENT PROJECTS

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LA OF RECORD BM ENGINEER OF RECORD:

DESIGN LA: BM

DRAWN BY: D.T.

CHECKER: C.Y.

SCALE: AS SHOWN

Rene I. Basulto, P.E.
PE # 40869

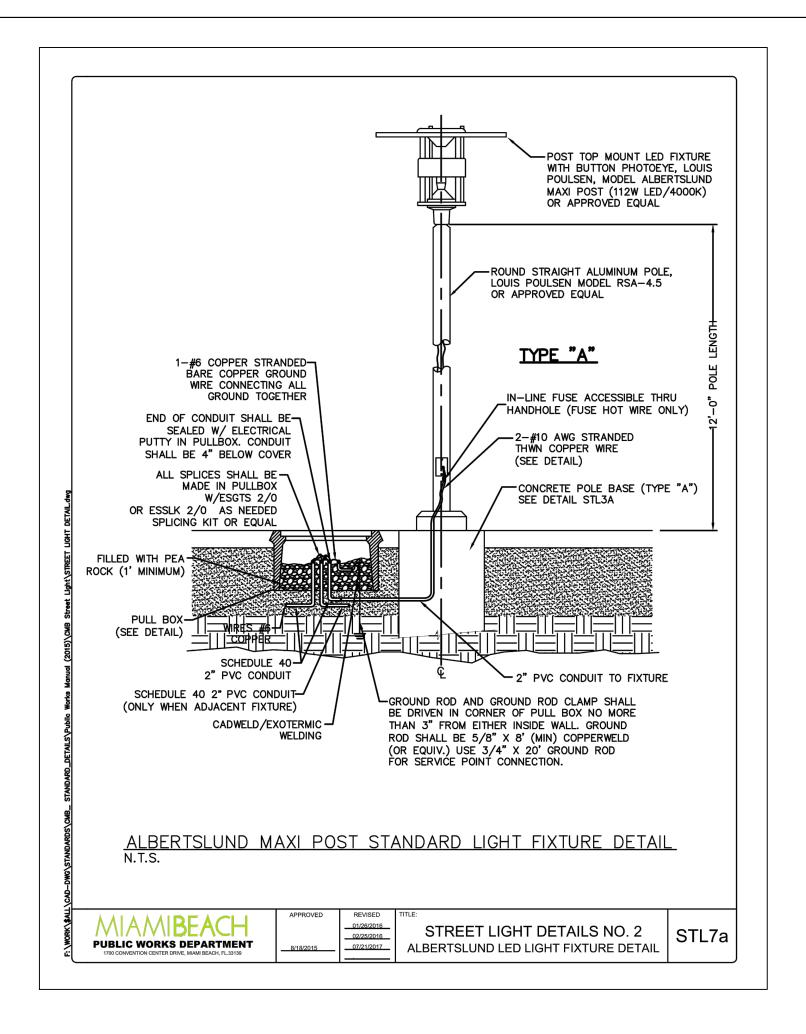
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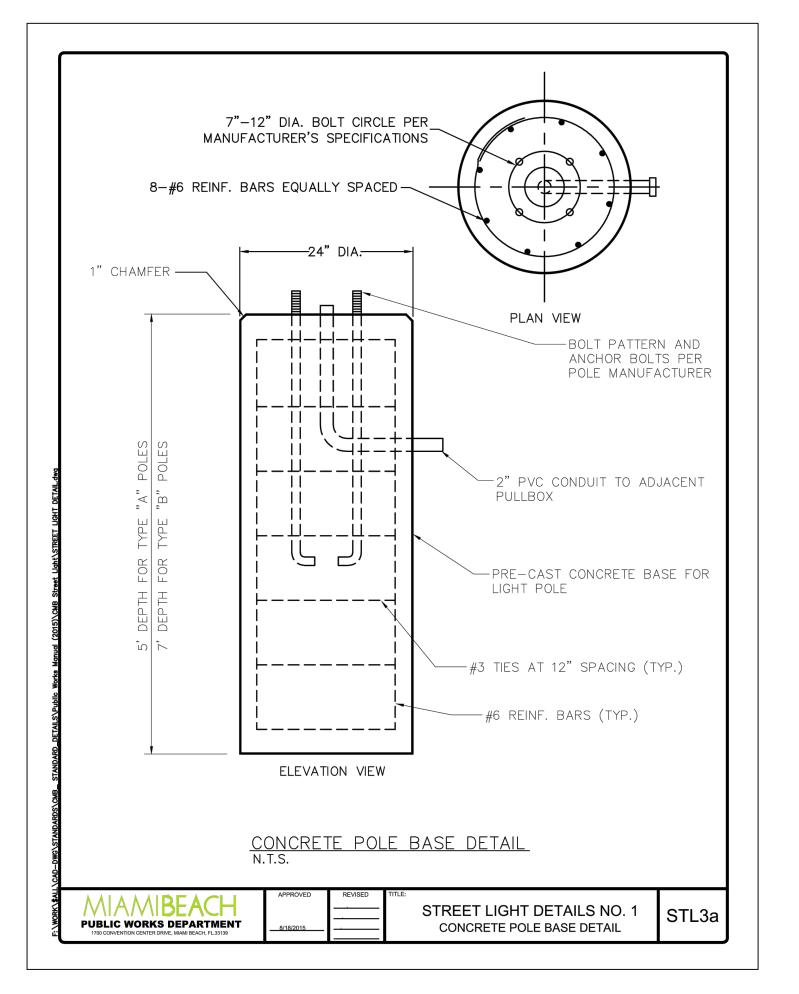
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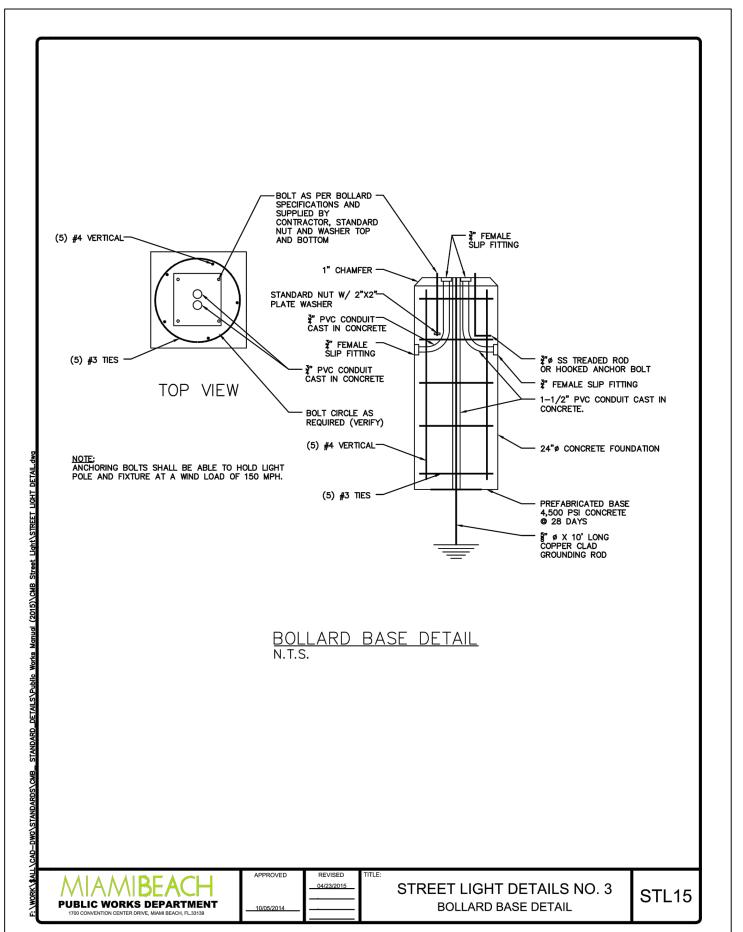
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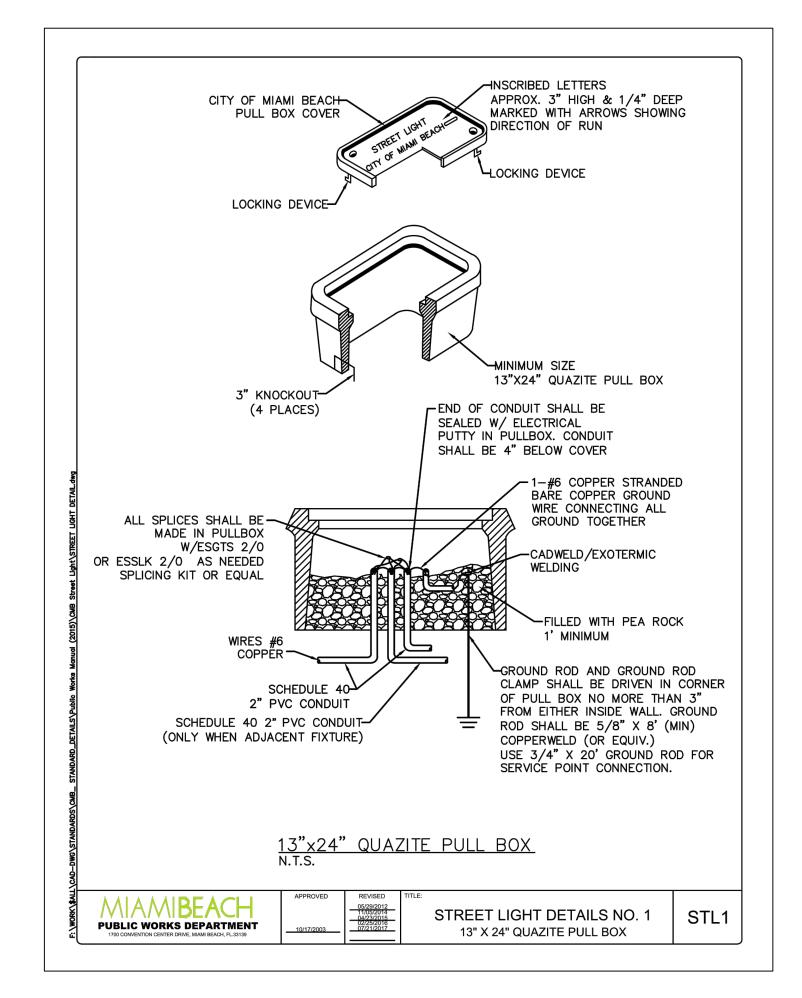
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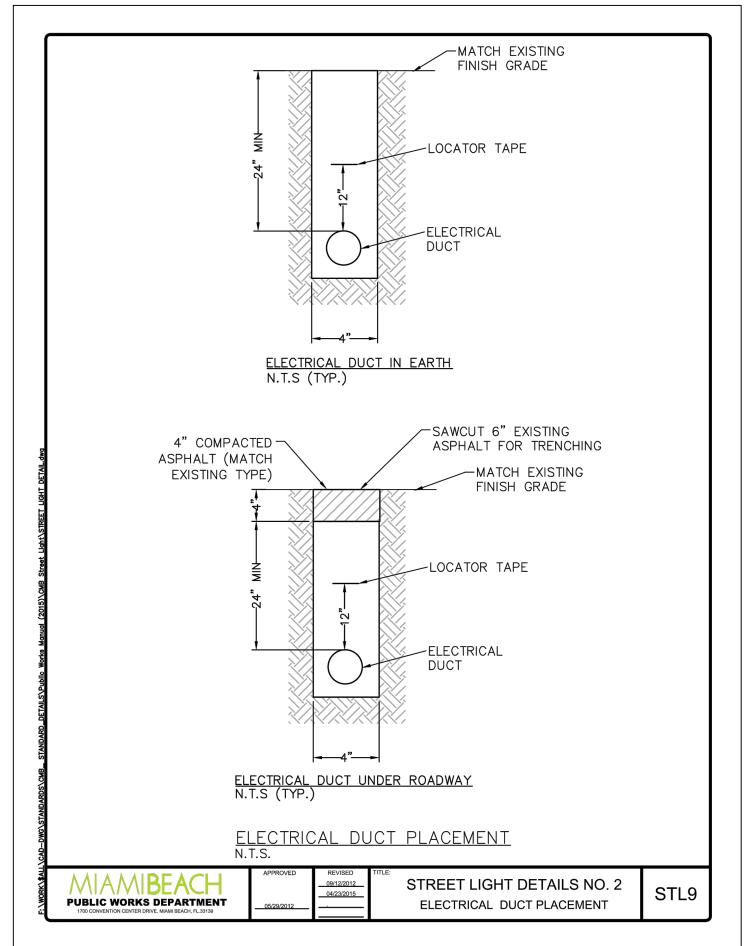
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 4
 ELECTRICAL DETAILS

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 ELECTRICAL DETAILS

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